HISTORIC LANDMARK COMMISSION AUGUST 22, 2011 PERMITS IN NATIONAL REGISTER HISTORIC DISTRICTS NRD-2011-0066 1212 W. 9th Street West Line

PROPOSAL

Construct a new single-family home on vacant lot.

PROJECT SPECIFICATIONS

The applicant proposes to construct a new 2,293 sf house on an existing vacant lot. The new 2 1/2-story, L-shaped house is a contemporary design with craftsman-style architectural features. The lot has a steep downward slope to the northwest that will accommodates a front-facing garage below the main level. The house has multiple, cross-gabled roofs with exposed rafter ends and brackets. There are dormers with two windows on either side of the cross gabled wing.

The proposed exterior wall materials are limestone ("Austin brown and white rock") veneer on the foundation and garage level, 5" exposure Hardiplank lap siding on the first level, and Hardiplank shingle siding on the tower and front facing gable ends.

There are numerous casement, awning and fixed sash windows and a shed roofed front porch with 6 x 6 cedar columns.

STAFF COMMENTS

The property is located in the West Line National Register District. The West Line National Register District has no design guidelines for new construction. Design guidelines in other historic districts address size, scale, massing, fenestration patterns, and materials. Applicable general design review guidelines state:

• Contemporary designs for alterations and additions to existing properties are appropriate when such alterations and additions do not destroy significant historic, architectural, or cultural material and are compatible with the size, scale, color, material, and character of the property, neighborhood, or environment.


The demolition permit for a c. 1917, 1,216 sf, 1-story single family residence previously located on this property was approved by the Historic Landmark Commission in January 2010. The building permit for the new building has already been released and construction has begun.

Properties on either side of the lot are contemporary designs of similar or larger size and scale as the proposed design and across the street is a large multi-family apartment complex.

STAFF RECOMMENDATION

Staff recommends approving the project as proposed.

LOCATION MAP

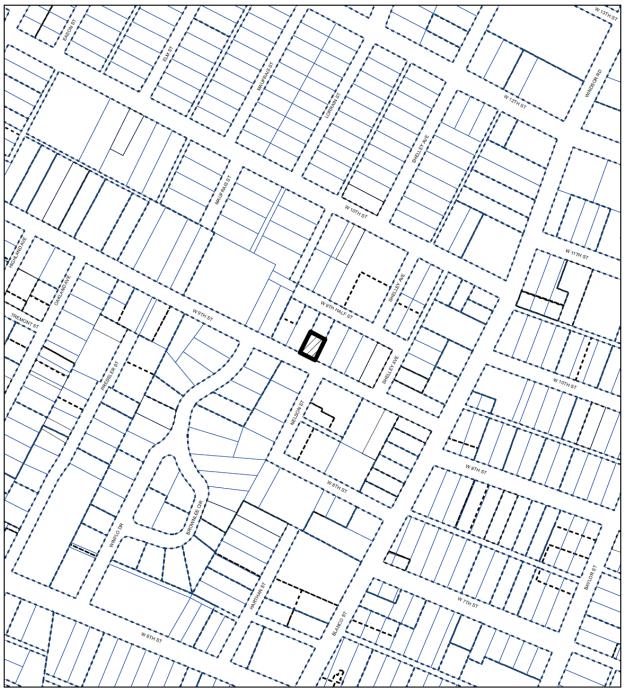



NATIONAL REGISTER DISTRICT

CASE#: NRD-2011-0066 LOCATION: 1212 W 9TH STREET GRID: H23 MANAGER: ALYSON MCGEE



This map has been produced by the Communications Technology Management Dept. on behalf of the Planning Development Review Dept. for the sole purpose of geographic reference. No warranty is made by the City of Austin regarding specific accuracy or completeness.

OWNER

Oam Parkash 2901 Gem Circle Austin, TX 78704

ARCHITECT


Nick Mehl Architecture Nick Mehl, AIA 1002 West Avenue, Ste. 302 Austin, TX 78701 512.473.8228

STRUCTURAL ENGINEER

Green Earth Engineering Tim Zhang, P.E.

GENERAL CONTRACTOR

Ramirez Homes Andrew Ramirez 512.200.6173

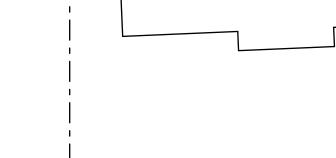


1216 West 9th Street


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WEST AUSTIN PARK



in the drawings to Architect prior to commencement of construction.



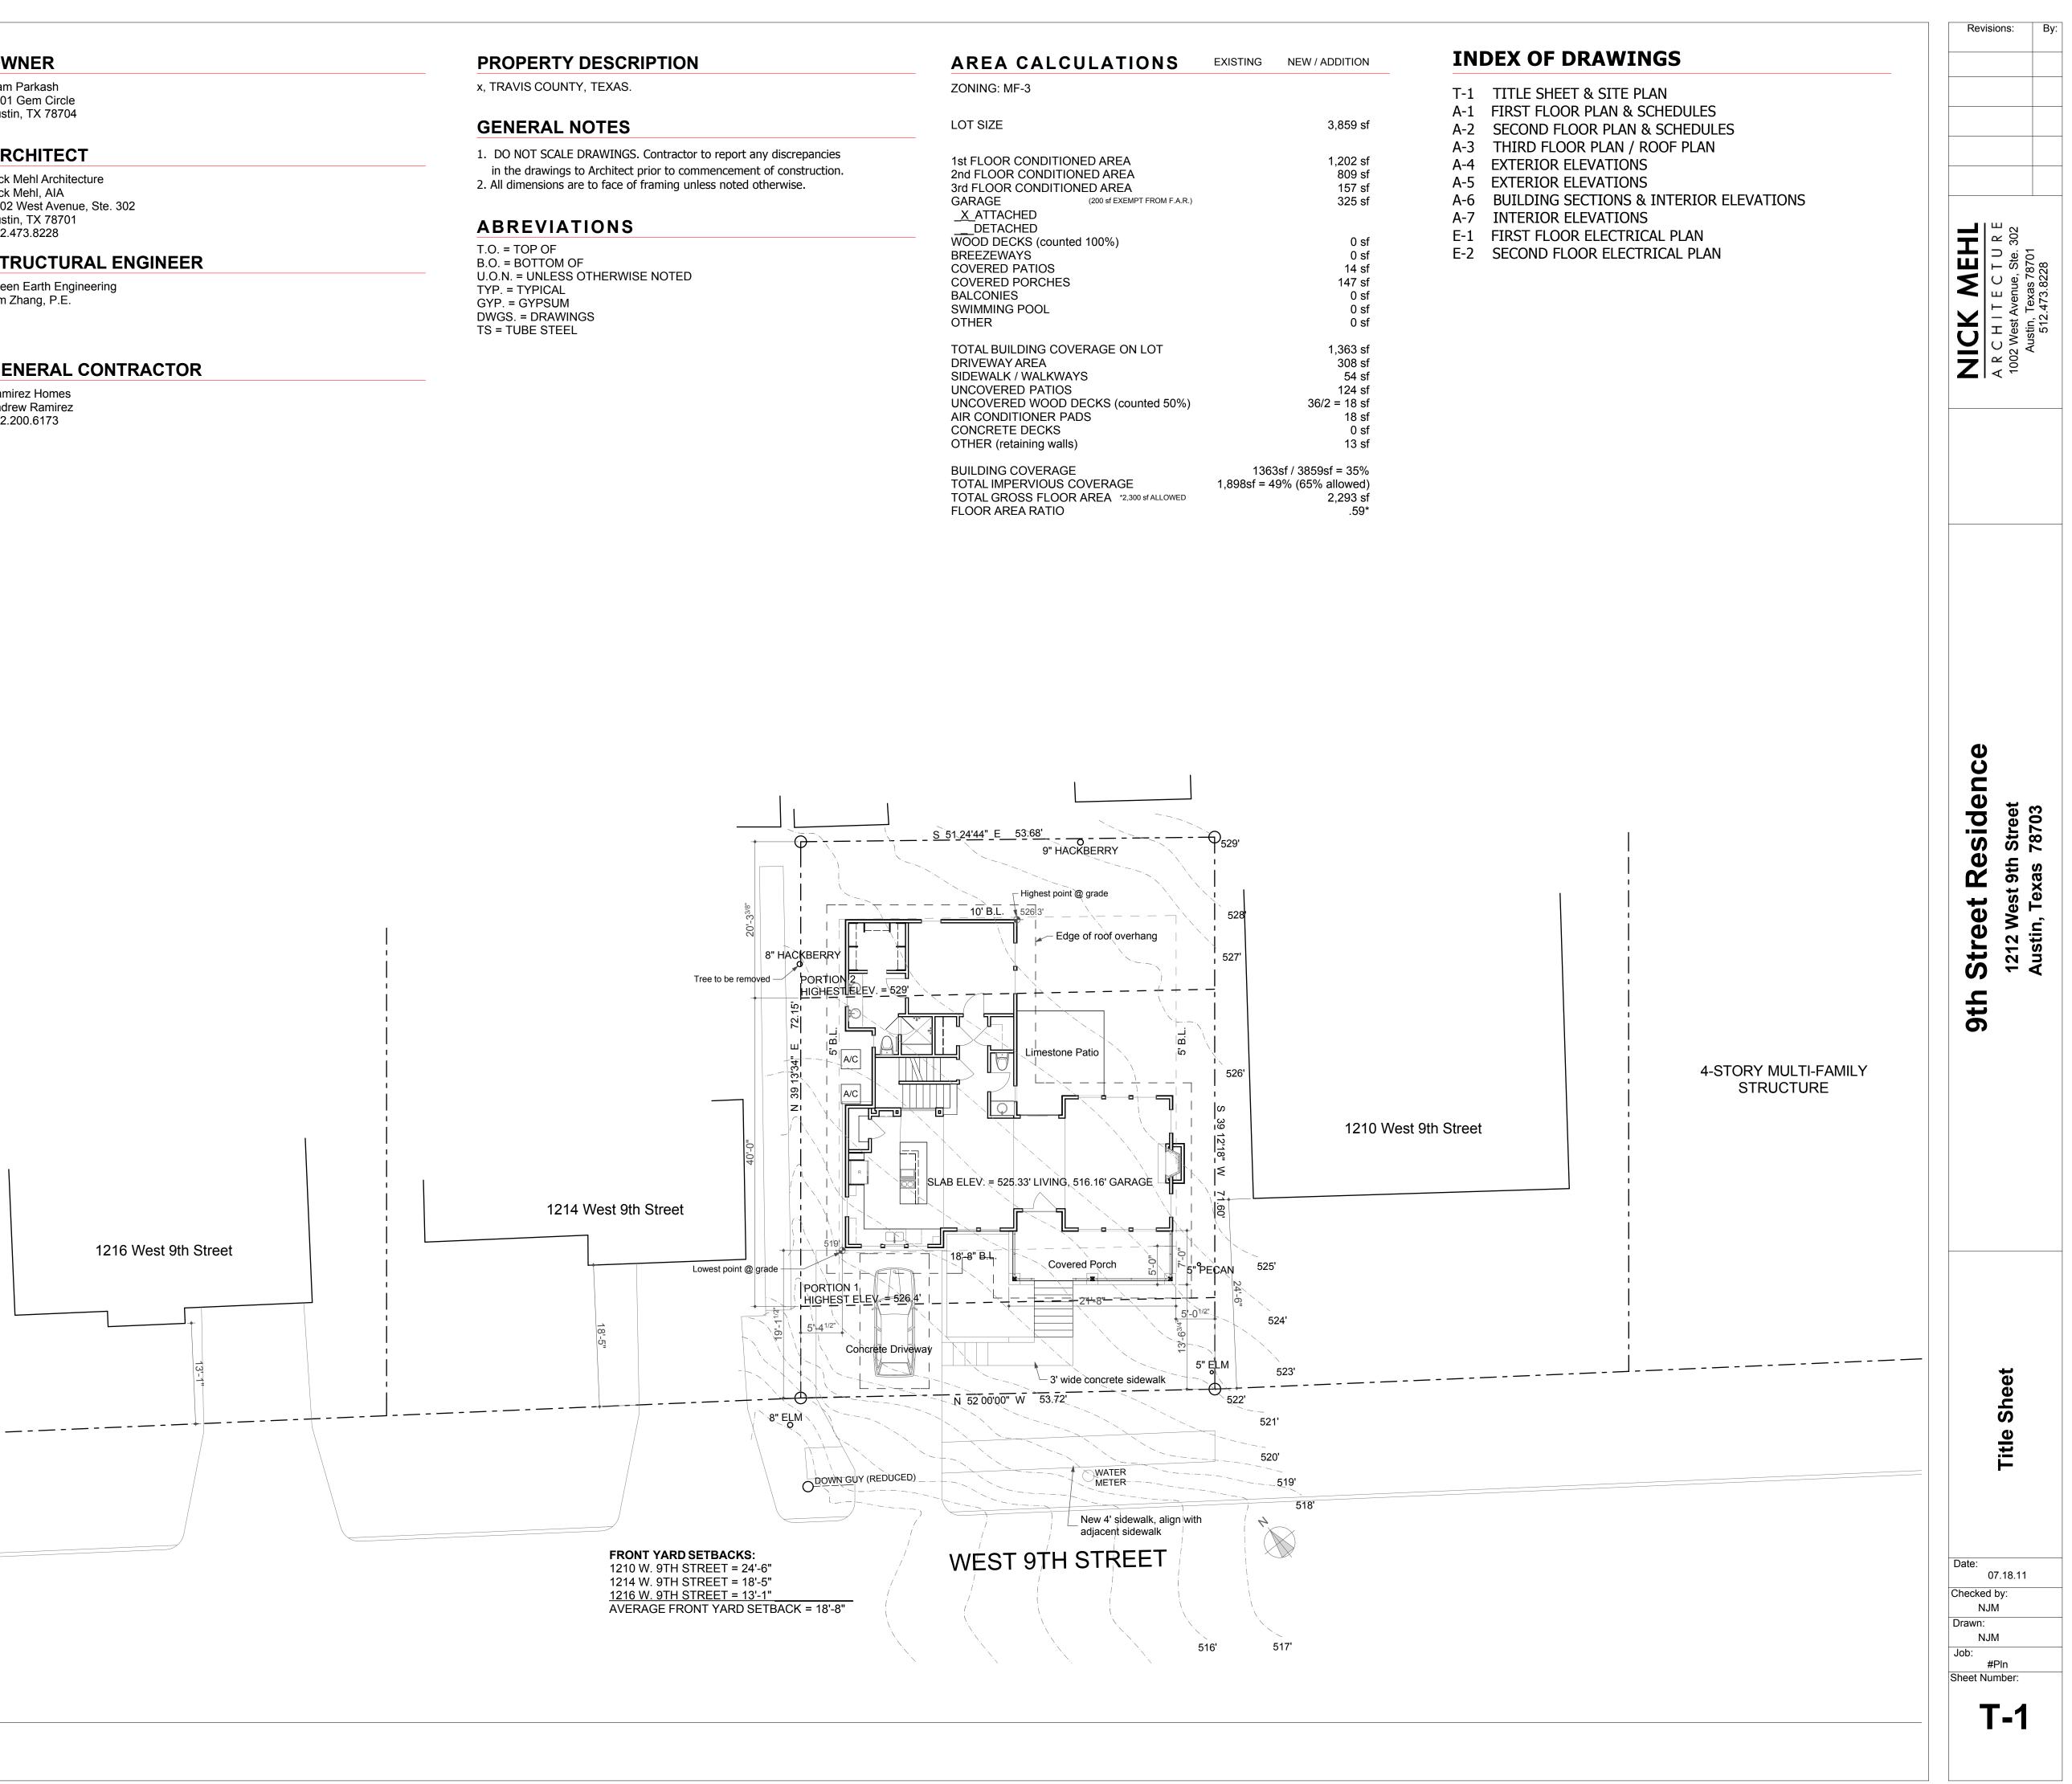

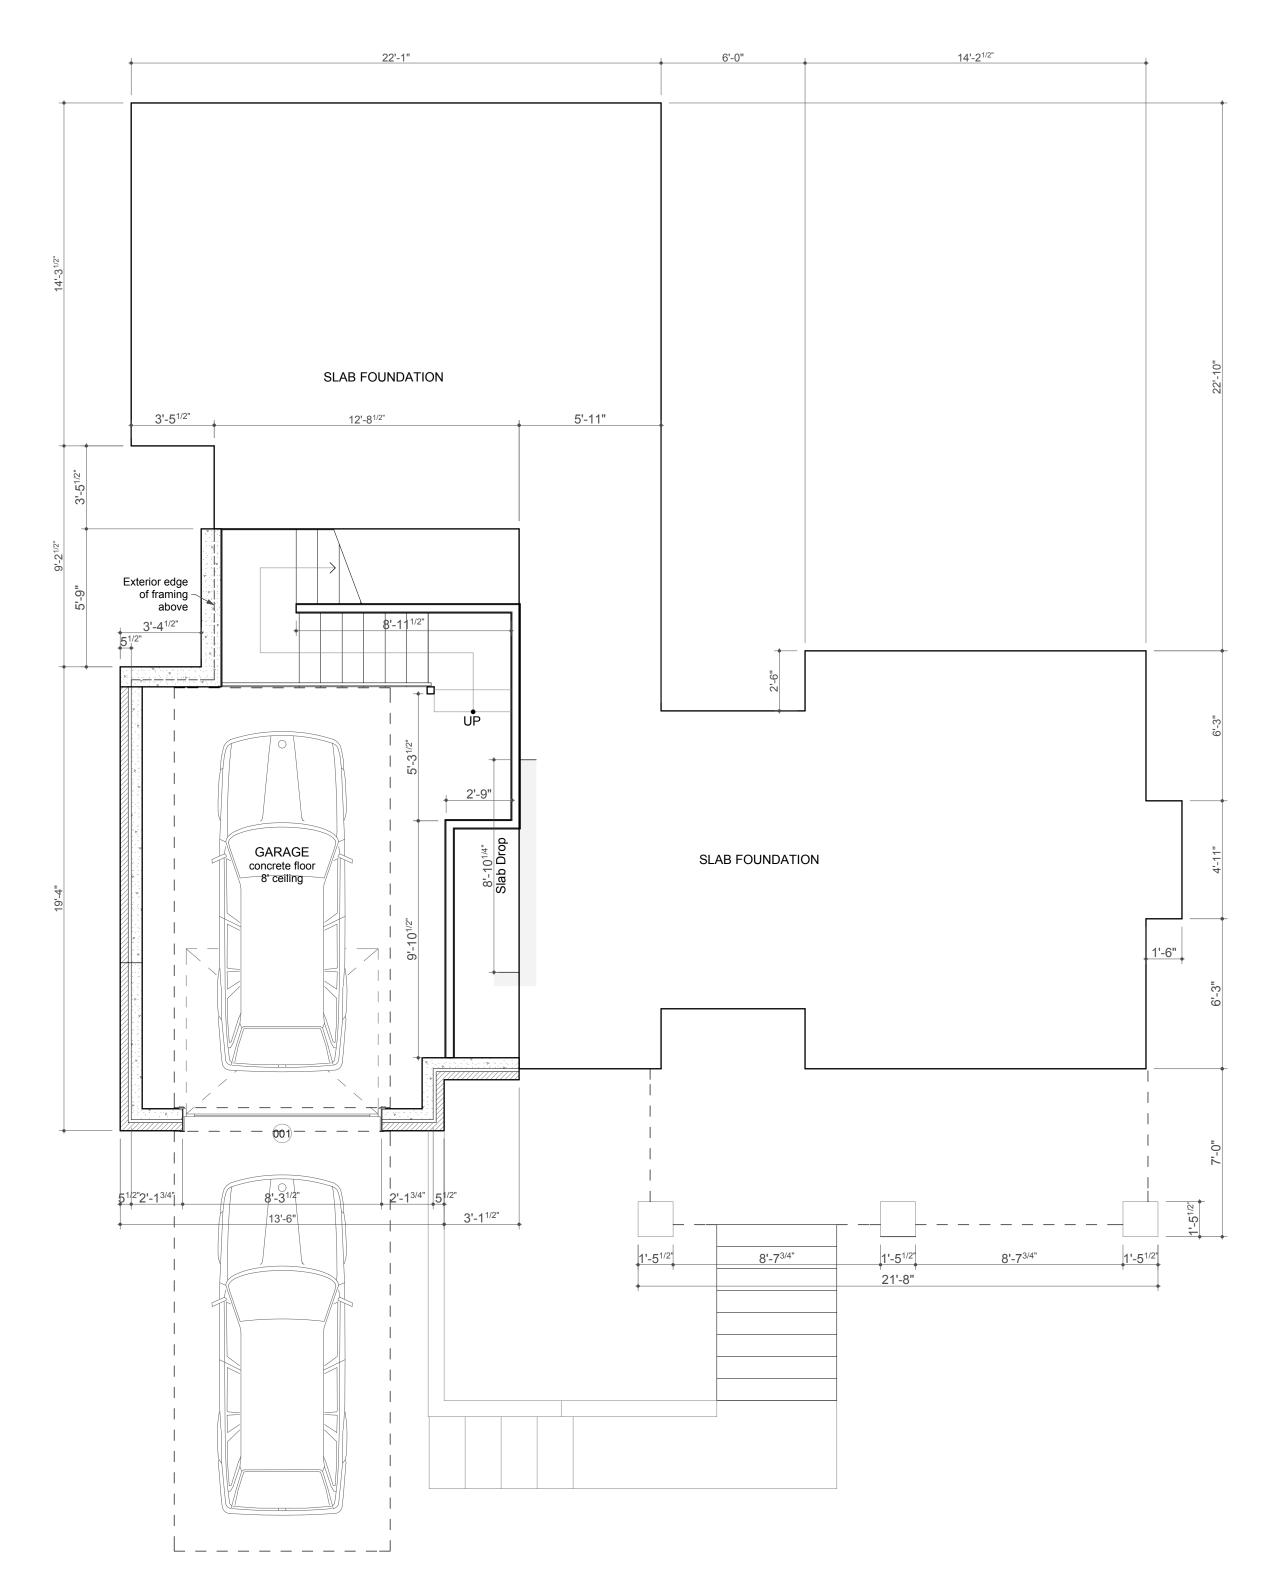


INDOW SCHEDULE

NOTES

MUST BE EGRESS WINDOW

MUST BE EGRESS WINDOW

MARK	SIZ
	V
001 8'-	-0"
101 3'-	-0"
102 5'-	-0"
103 2'-	-6"
104 2'-	-8"
105 2'-	-6"
106 2'-	-6"
107 2'-	-6"
108 2'-	-8"
109 2'-	-6"
201 2'-	-8"
202 2'-	-6"
203 2'-	-6"
204 2'-	-8"
205 2'-	-8"
206 2'-	-6"
207 2'-	-8"
208 2'-	-4"
209 2'-	-4"
210 2'-	-8"

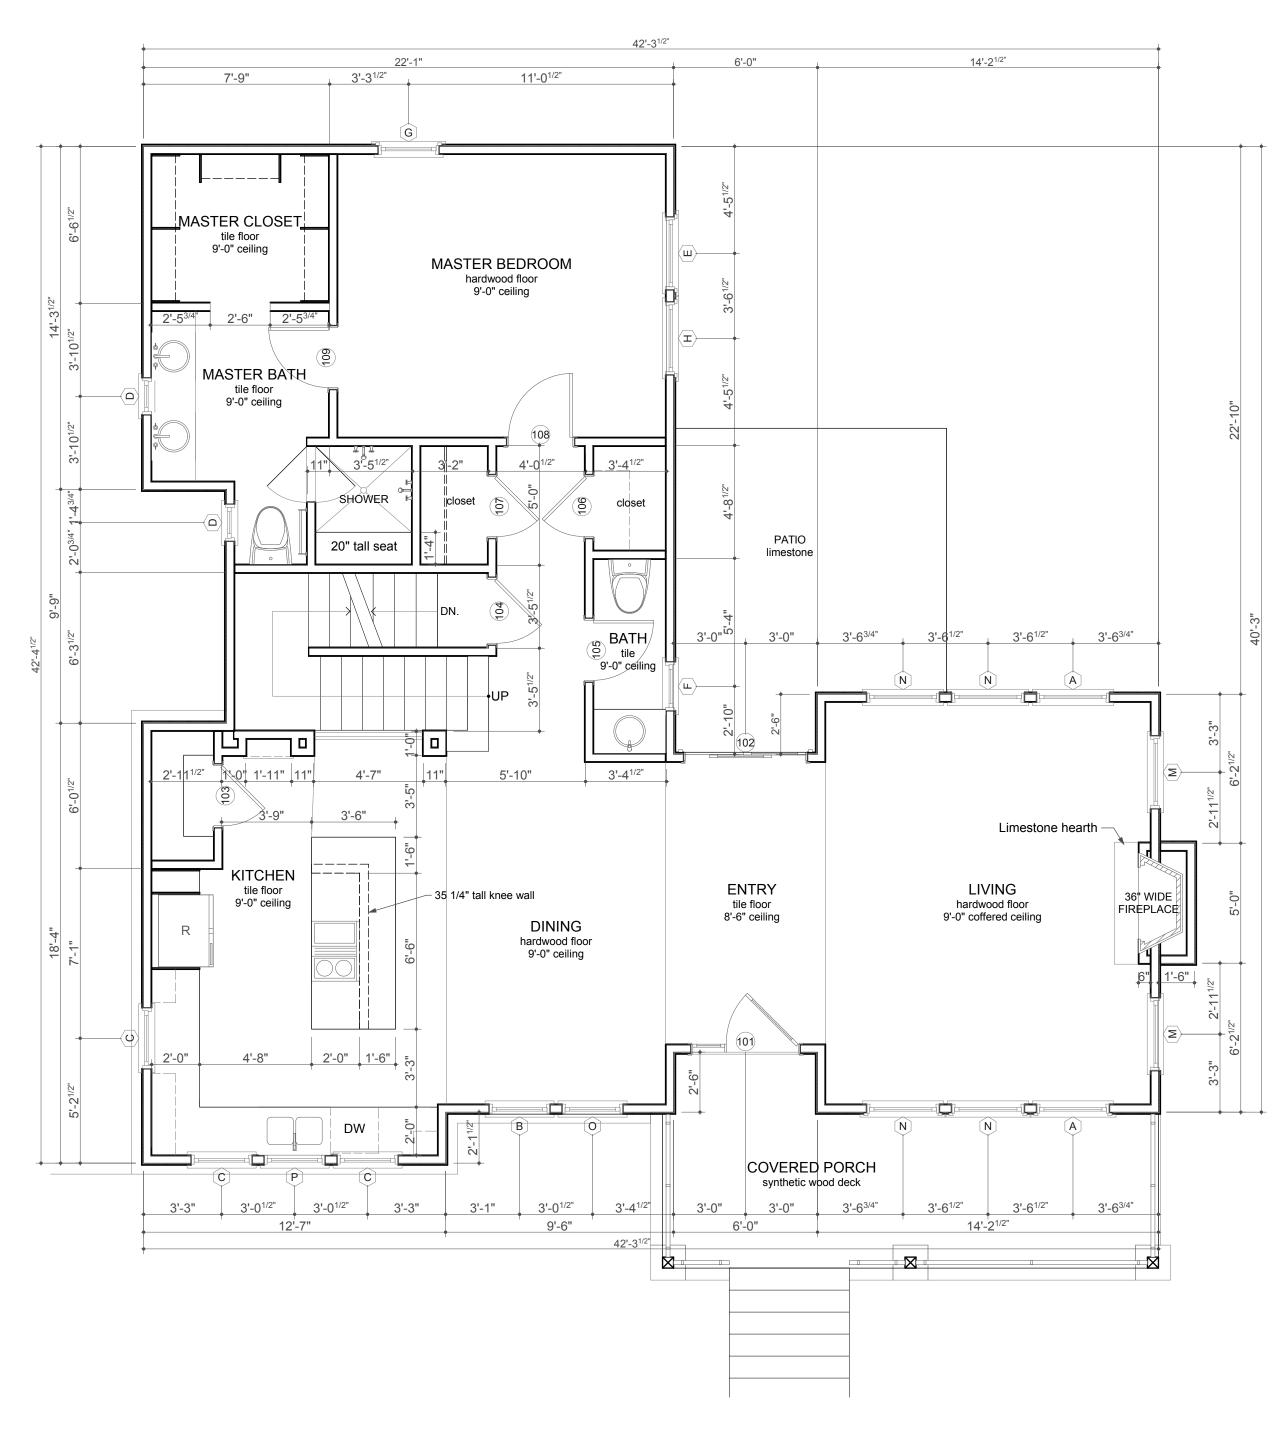


WIND							
MARK	Quantity	SI	ZE	OPERATION			
	Quantity	WIDTH	HEIGHT				
А	2	3'-0"	6'-0"	CASEMENT			
В	1	2'-6"	6'-0"	CASEMENT			
С	5	2'-6"	4'-0"	CASEMENT			
D	2	1'-6"	2'-6"	CASEMENT			
Е	1	3'-0"	5'-0"	CASEMENT			
F	1	2'-0"	3'-0"	CASEMENT			
G	9	2'-6"	2'-6"	AWNING			
Н	2	3'-0"	5'-0"	FIXED			
I	2	3'-0"	4'-6"	CASEMENT			
К	3	4'-0"	3'-6"	AWNING			
L	1	8'-0"	3'-6"	SLIDER			
М	2	3'-0"	2'-0"	FIXED			
Ν	4	3'-0"	6'-0"	FIXED			
0	1	2'-6"	6'-0"	FIXED			
Р	1	2'-6"	4'-0"	FIXED			
R	1	3'-0"	4'-6"	FIXED			



DOOR SCHEDULE							
DOOR							
			SET NO	NOTES			
ΗT	MATL	GLZ					
7'-0"	WOOD	SINGLE PANE		GARAGE DOOR			
6'-8"	WOOD	INSUL. LOW-E		FRONT DOOR BY SIMPSON DOOR CO.			
6'-8"	CLAD WOOD	INSUL. LOW-E		SLIDING DOOR BY PELLA			
6'-8"	HOLLOW CORE	-					
6'-8"	SOLID CORE	-		W/ WEATHERSEAL & SELF-CLOSER			
6'-8"	SOLID CORE	-					
6'-8"	HOLLOW CORE	-					
6'-8"	HOLLOW CORE	-					
6'-8"	SOLID CORE	-					
6'-8"	SOLID CORE	-					
6'-8"	SOLID CORE	-					
6'-8"	SOLID CORE	-					
6'-8"	SOLID CORE	-					
6'-8"	SOLID CORE	-					
6'-8"	HOLLOW CORE	-					
6'-8"	HOLLOW CORE						
6'-8"	SOLID CORE						
4'-0"	HOLLOW CORE						
6'-8"	HOLLOW CORE						
3'-6"	SOLID CORE						




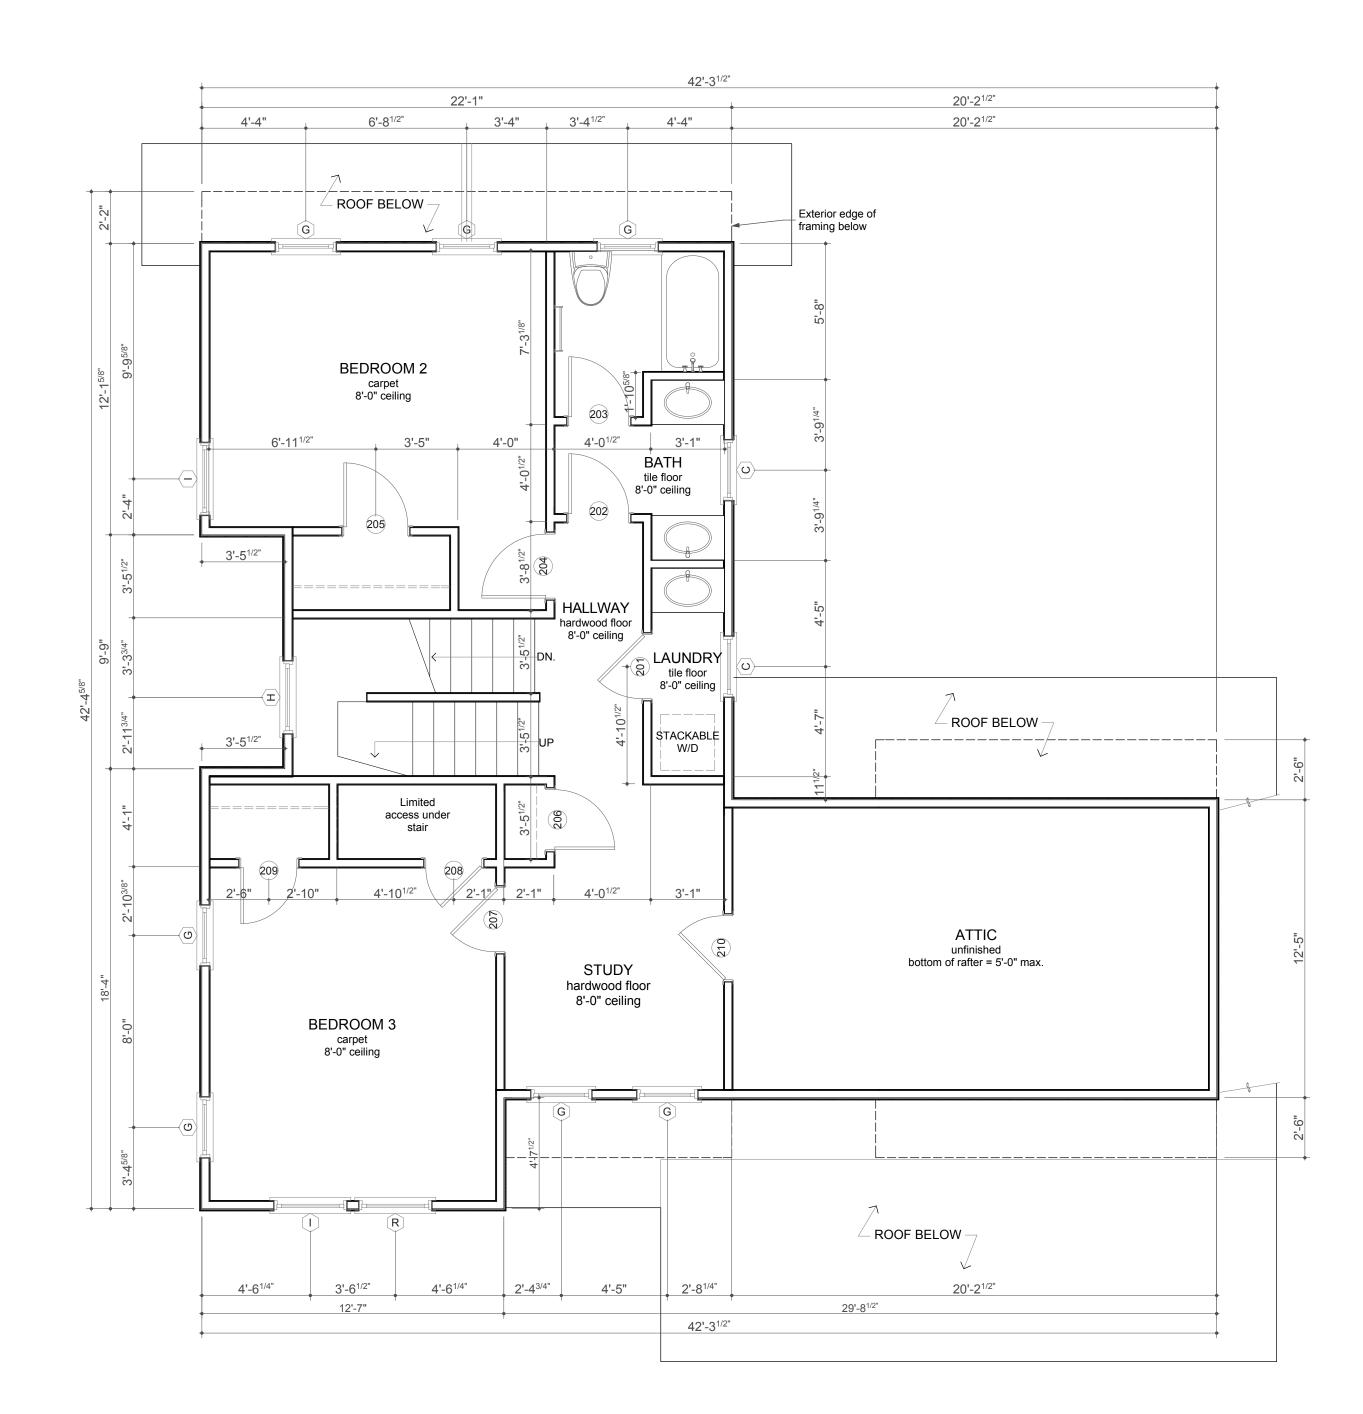



Scale: 1/4" = 1'-0"


WINDOW SCHEDULE							
MARK Quantity	SIZI	ZE	OPERATION NOTES	NOTES			
	Quantity WIDTH HEIGH	HEIGHT		NOTES	MARK	,	
А	2	3'-0"	6'-0"	CASEMENT		PIAKN	•
В	1	2'-6"	6'-0"	CASEMENT		001	
С	5	2'-6"	4'-0"	CASEMENT		101	
D	2	1'-6"	2'-6"	CASEMENT		102	
E	1	3'-0"	5'-0"	CASEMENT	MUST BE EGRESS WINDOW	103	
F	1	2'-0"	3'-0"	CASEMENT		104	T
G	9	2'-6"	2'-6"	AWNING		105	T
Н	2	3'-0"	5'-0"	FIXED		106	T
I	2	3'-0"	4'-6"	CASEMENT	MUST BE EGRESS WINDOW	107	T
К	3	4'-0"	3'-6"	AWNING		108	
L	1	8'-0"	3'-6"	SLIDER		109	
М	2	3'-0"	2'-0"	FIXED		201	
N	4	3'-0"	6'-0"	FIXED		202	
0	1	2'-6"	6'-0"	FIXED		203	
Р	1	2'-6"	4'-0"	FIXED		204	T
R	1	3'-0"	4'-6"	FIXED		205	Ť
		<u> </u>	1			206	+

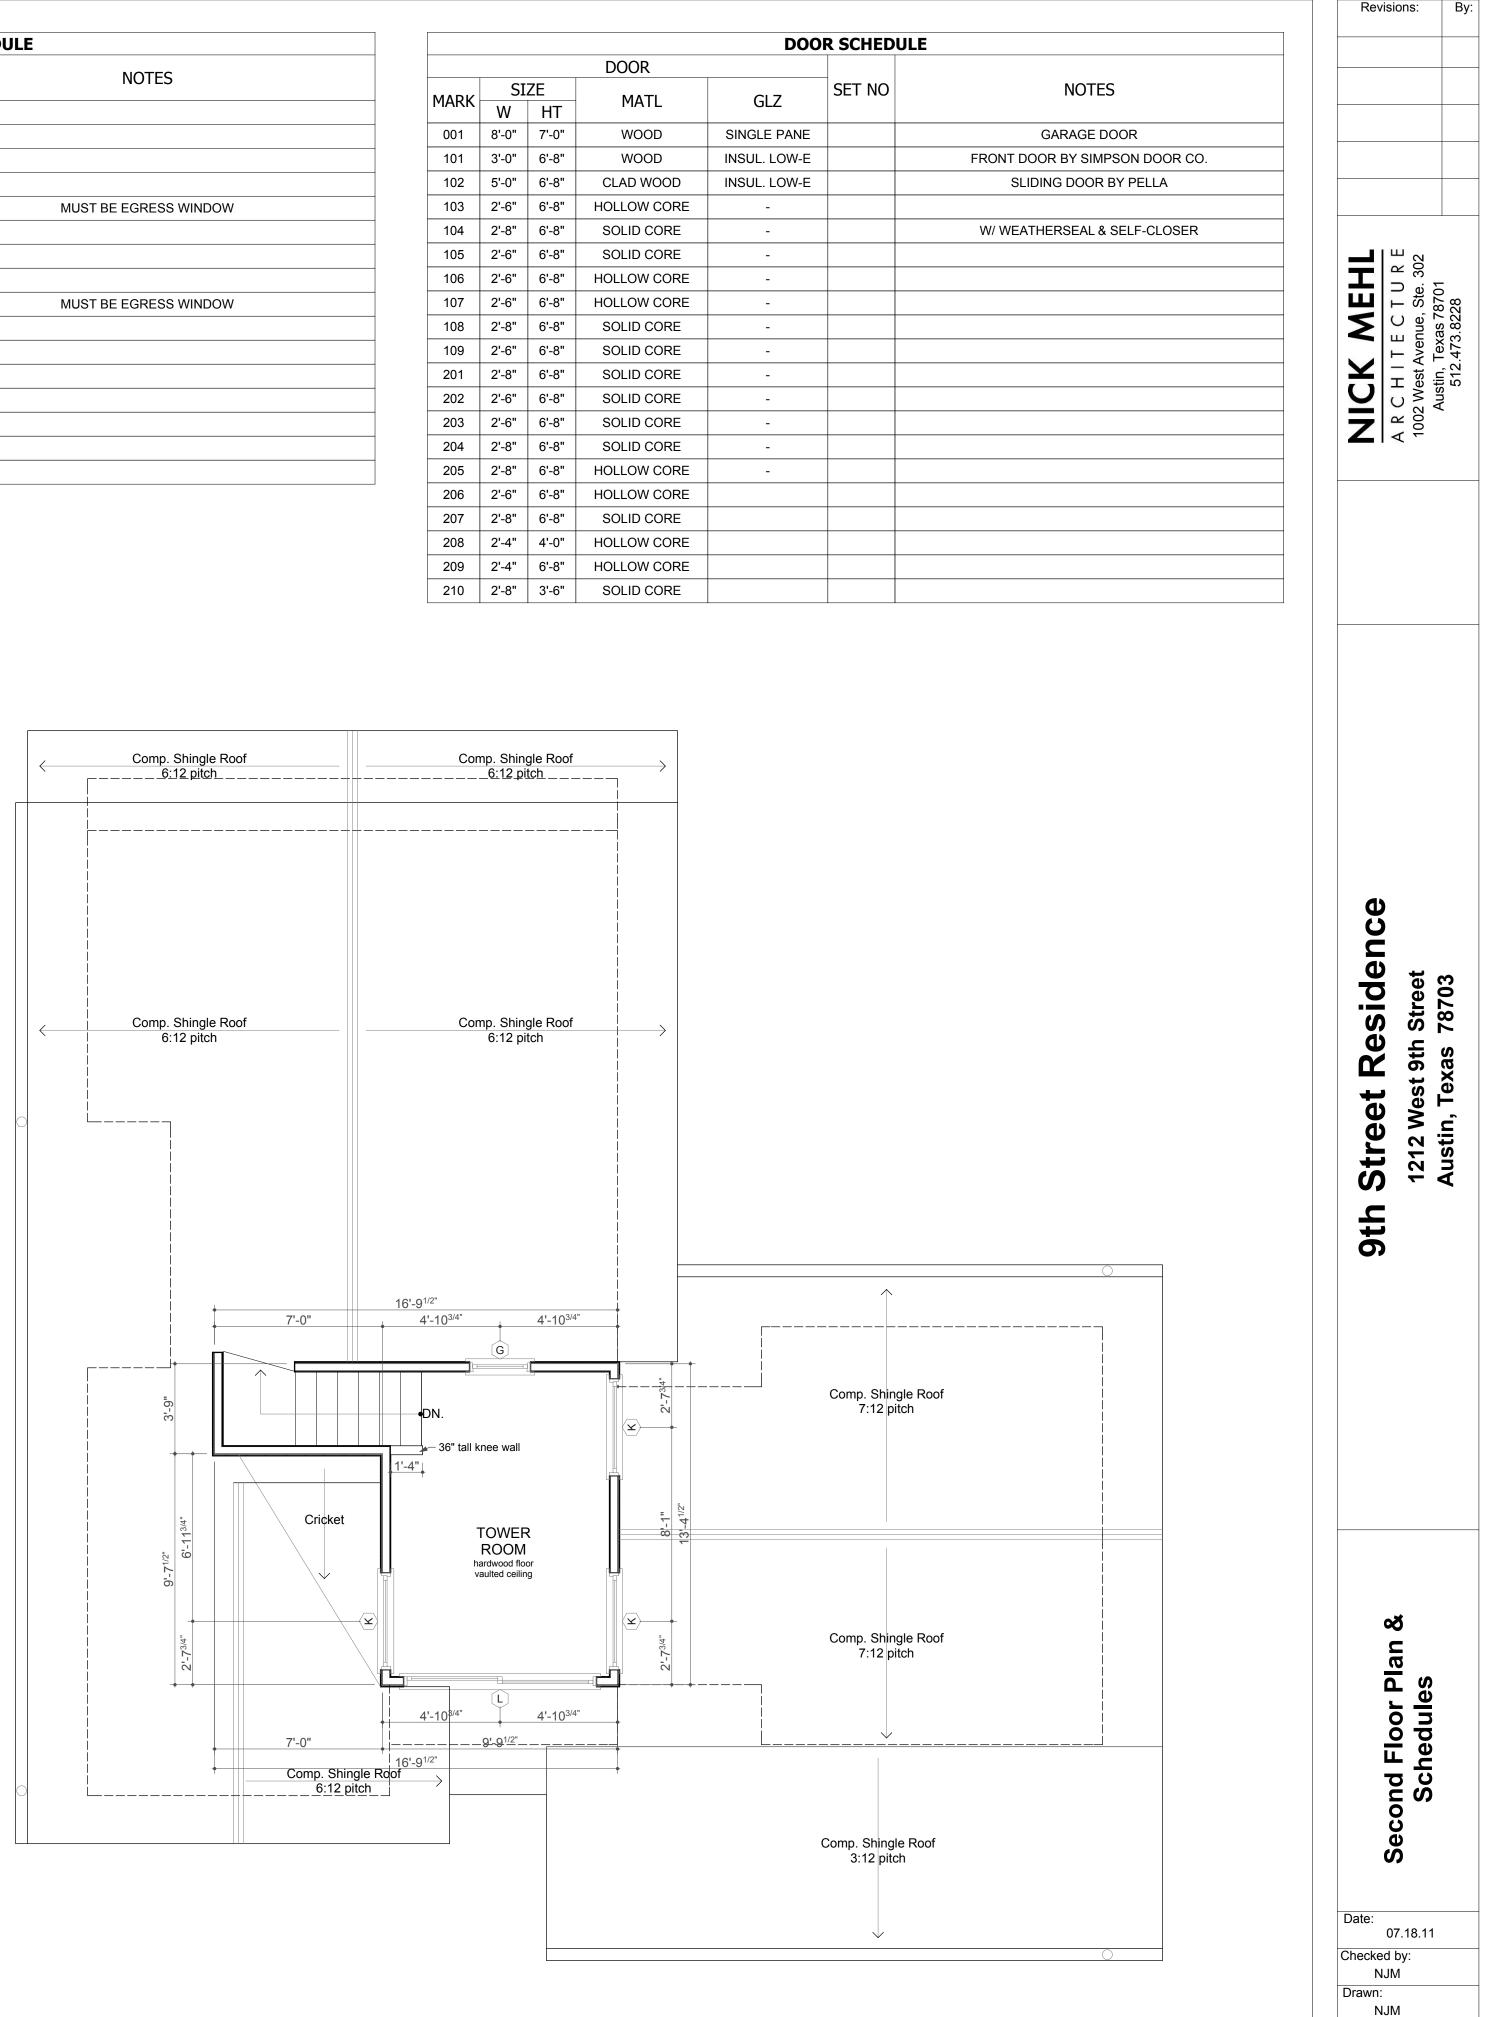


2 Third Floor / Roof Plan SCALE: 1/4" = 1'-0" Sheet Number:


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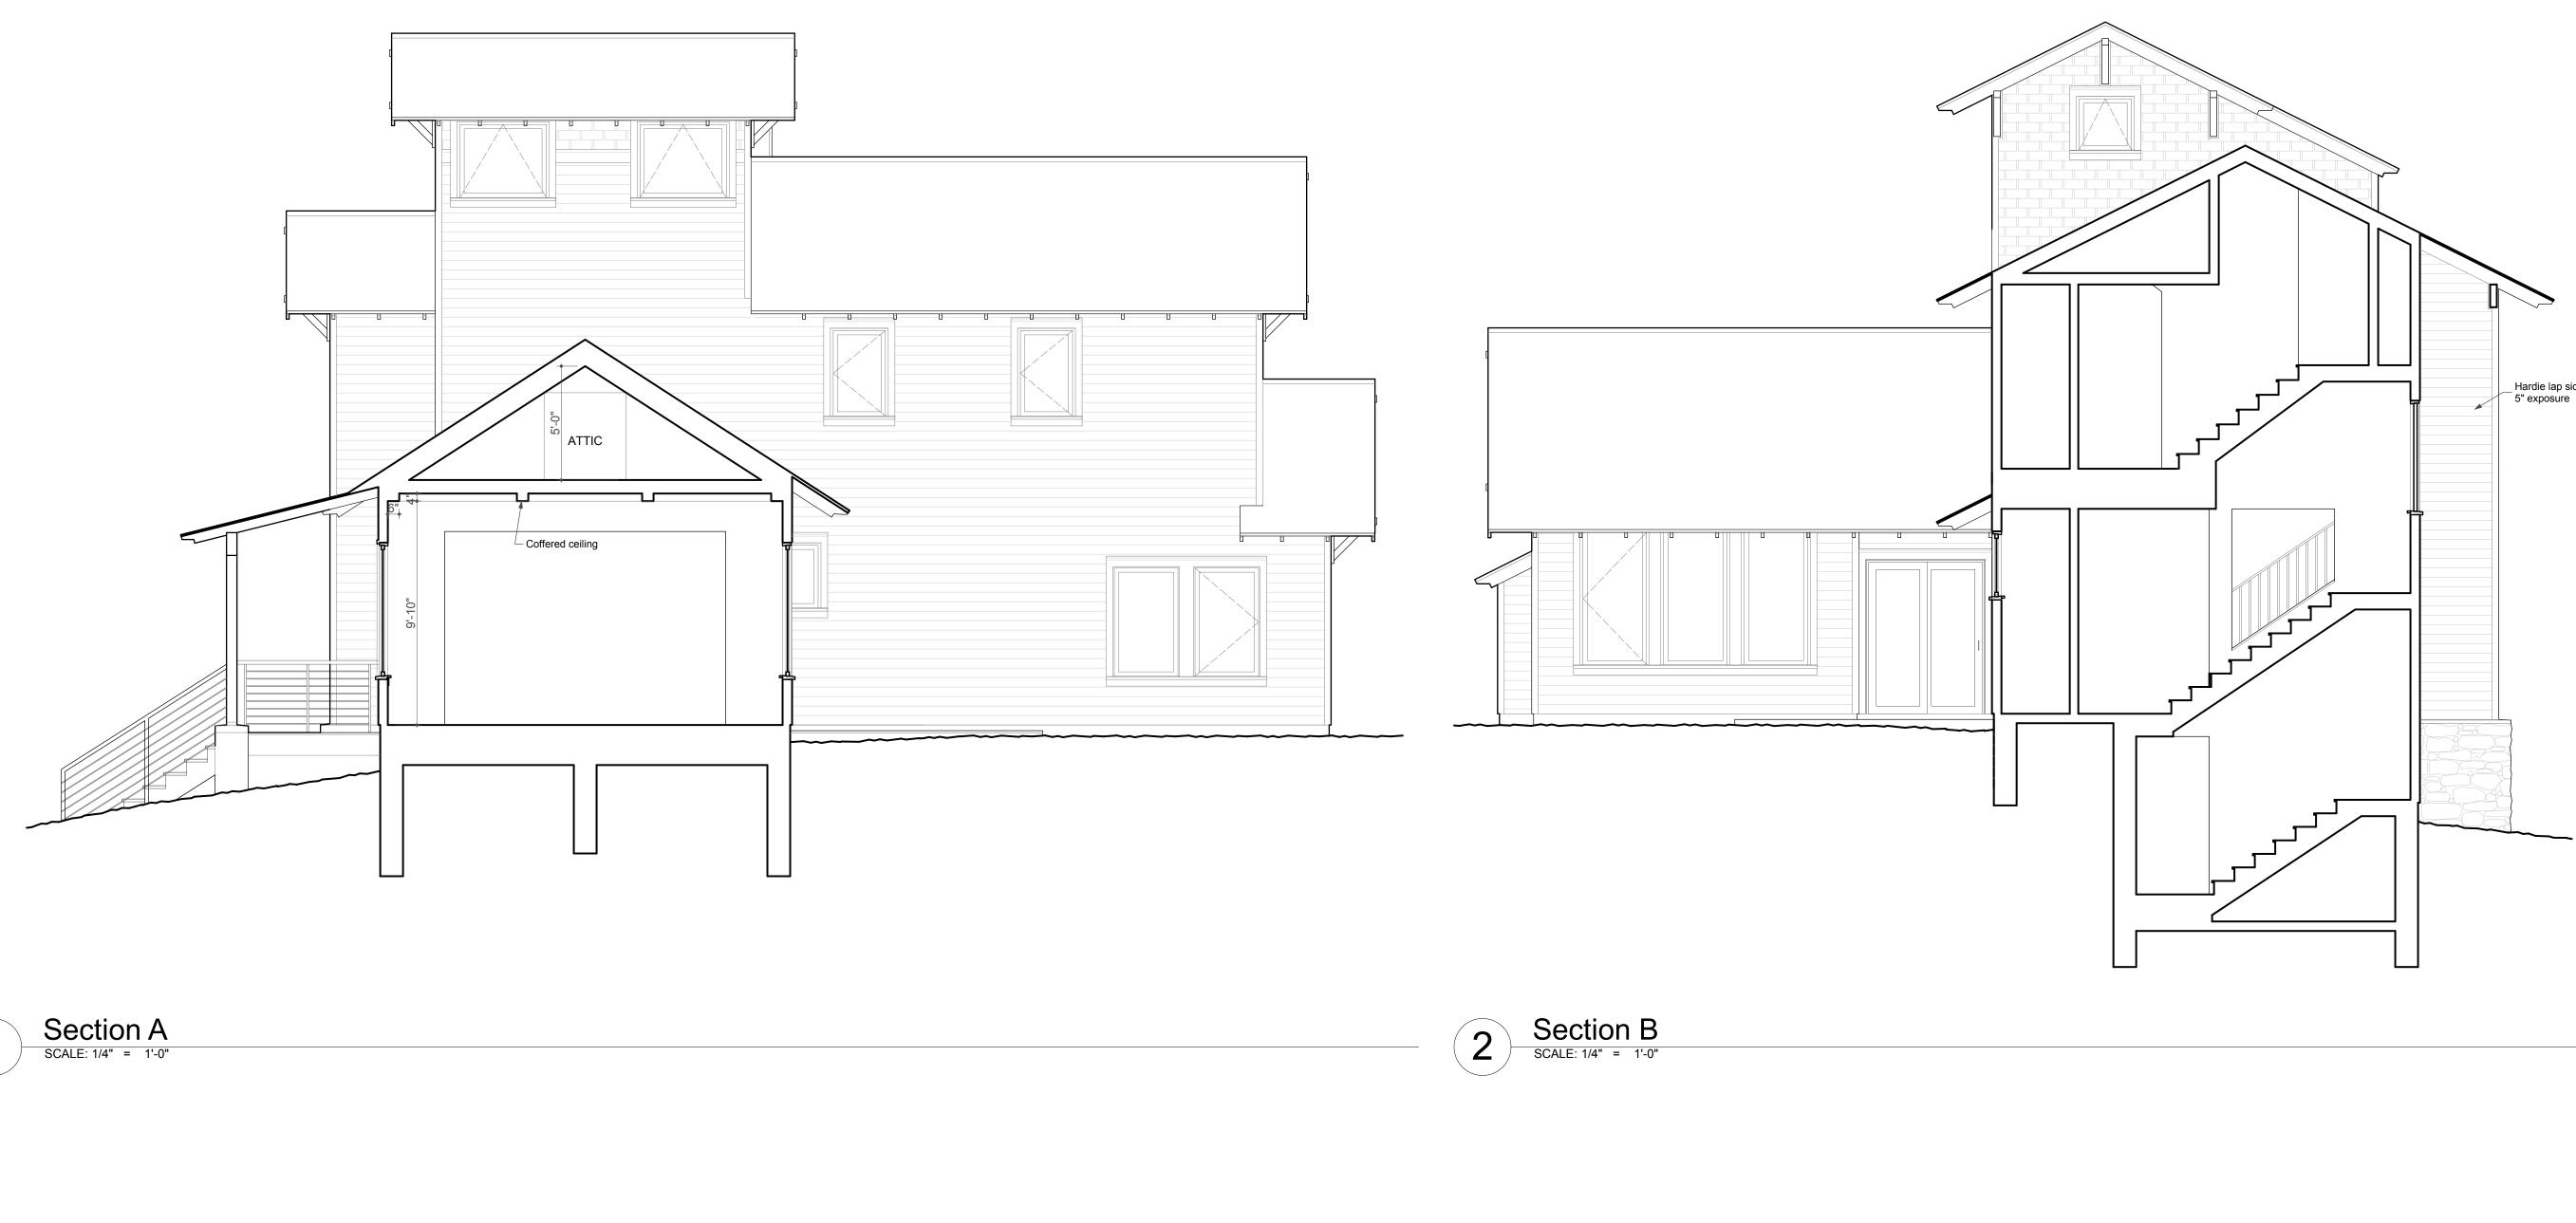
Job:




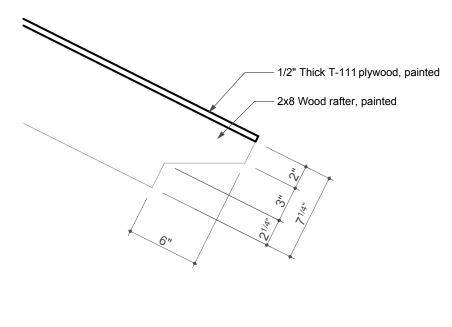




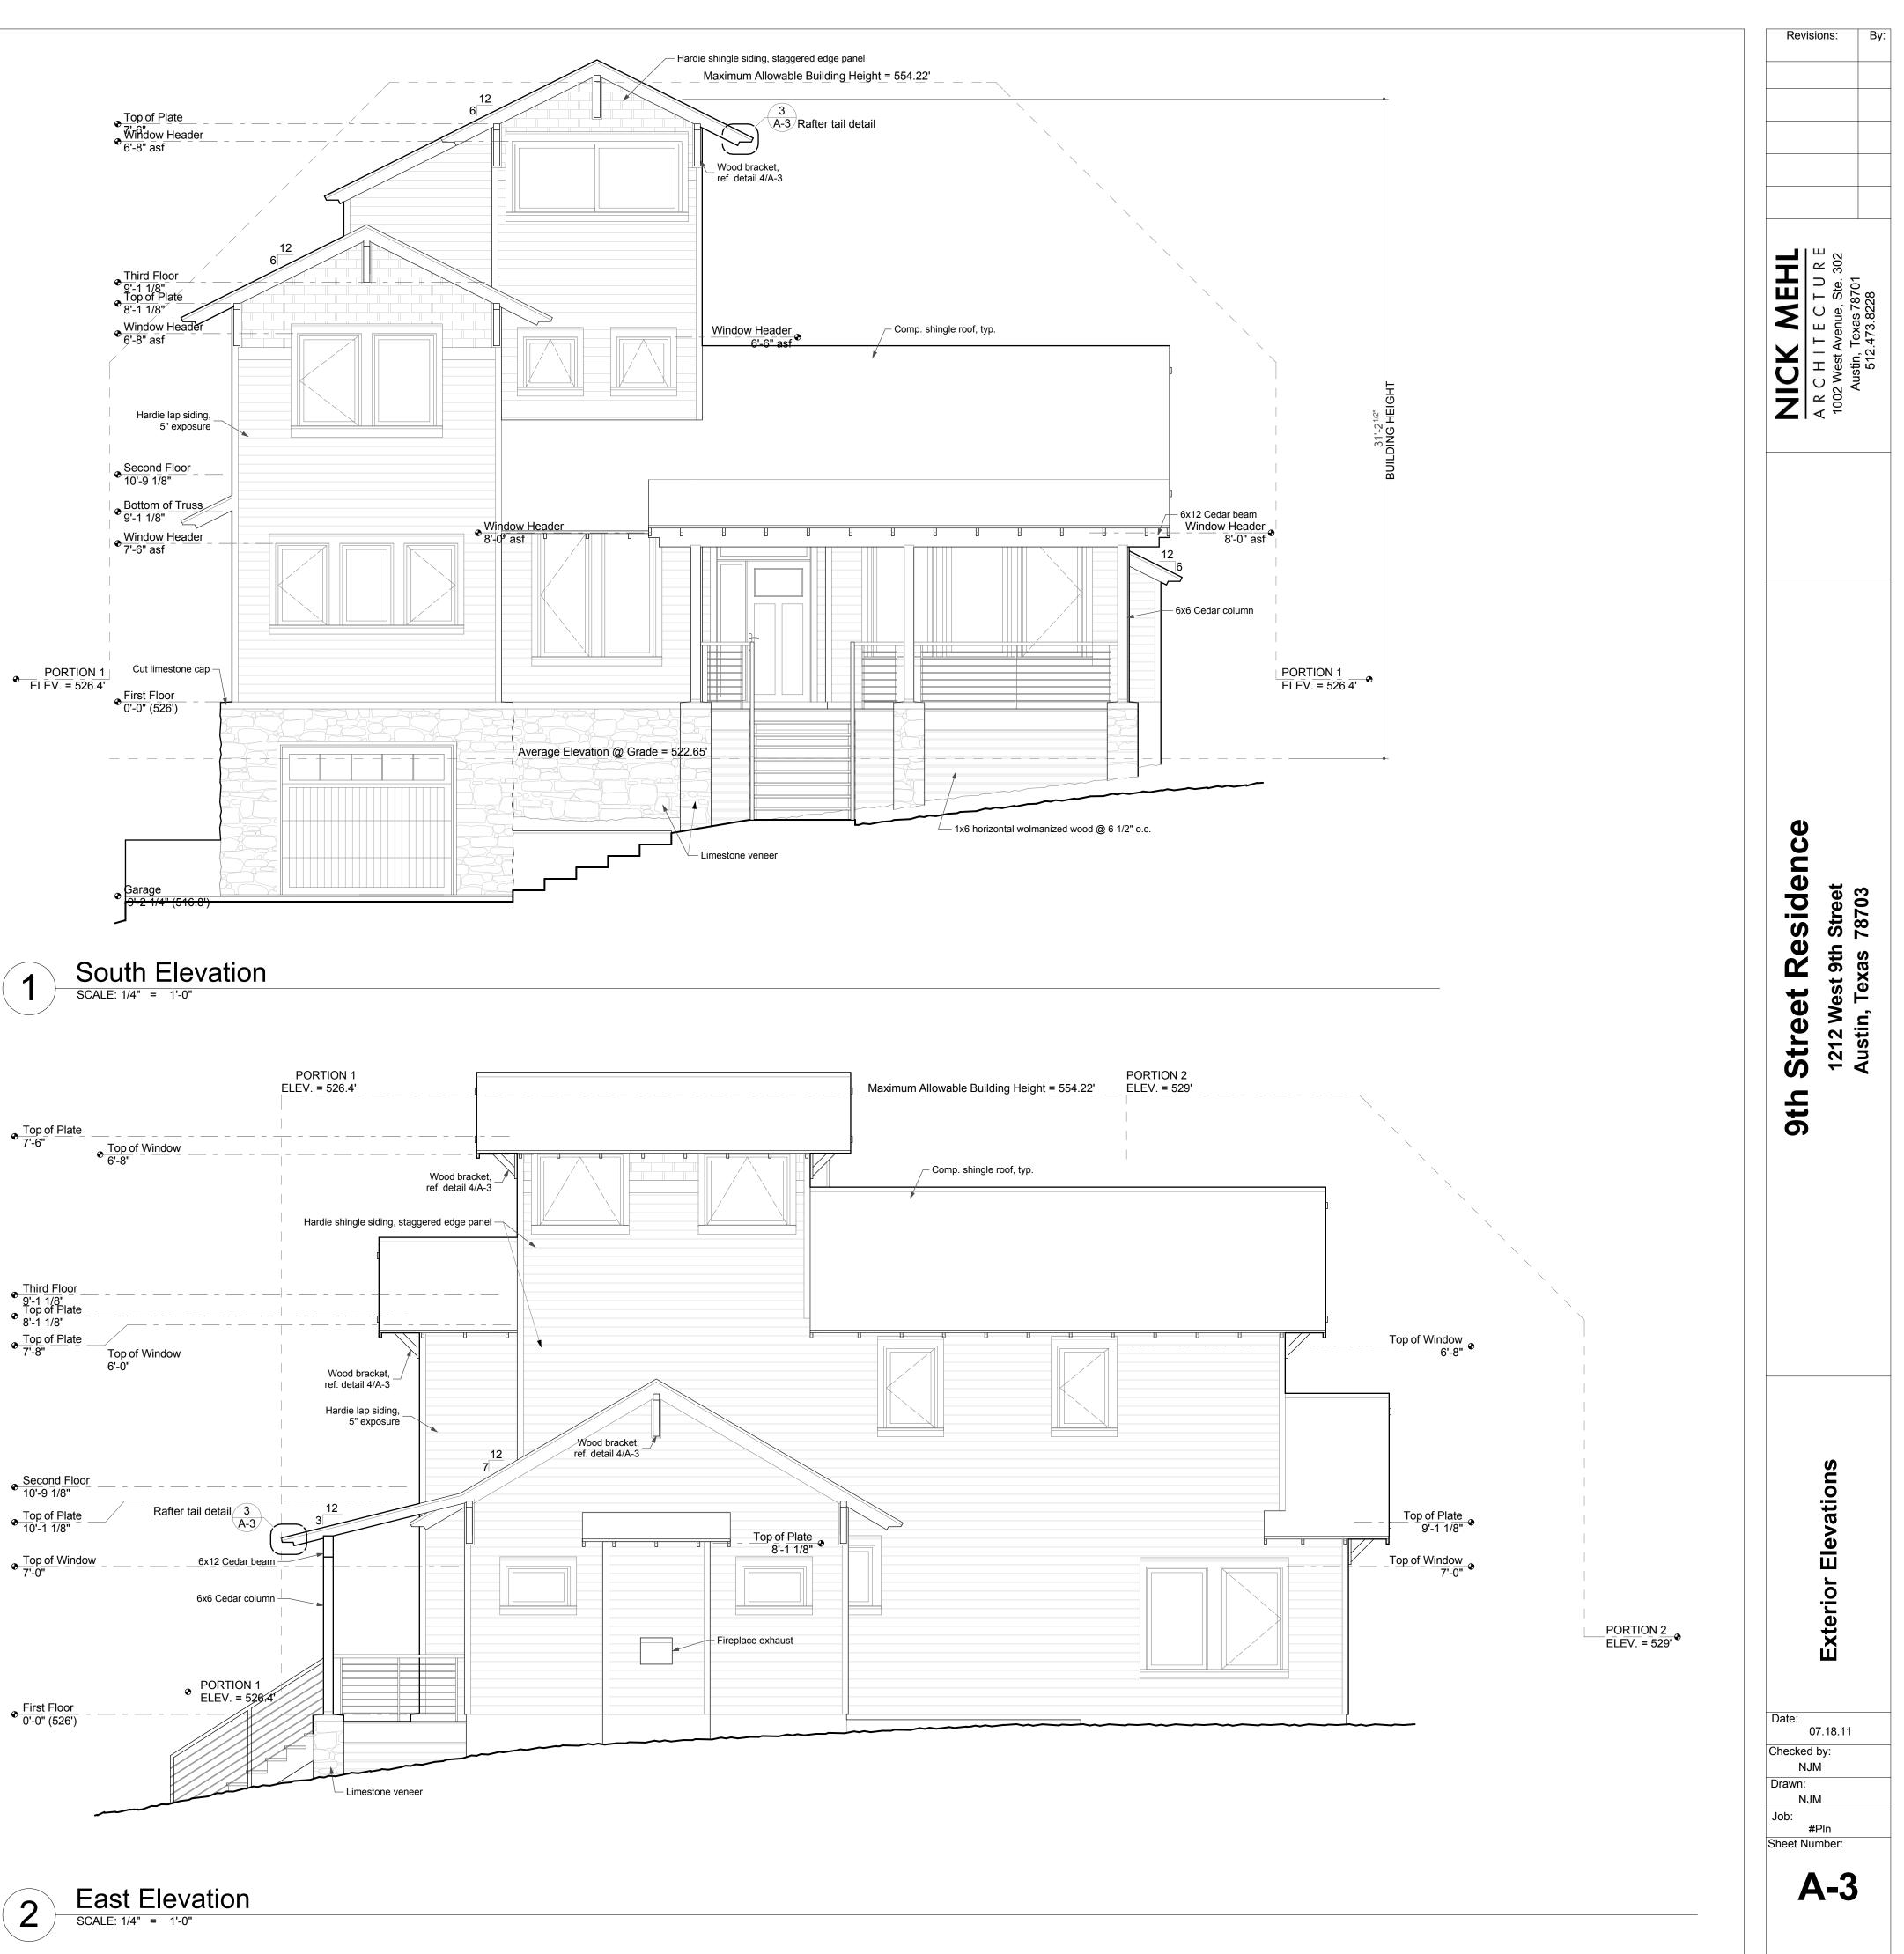


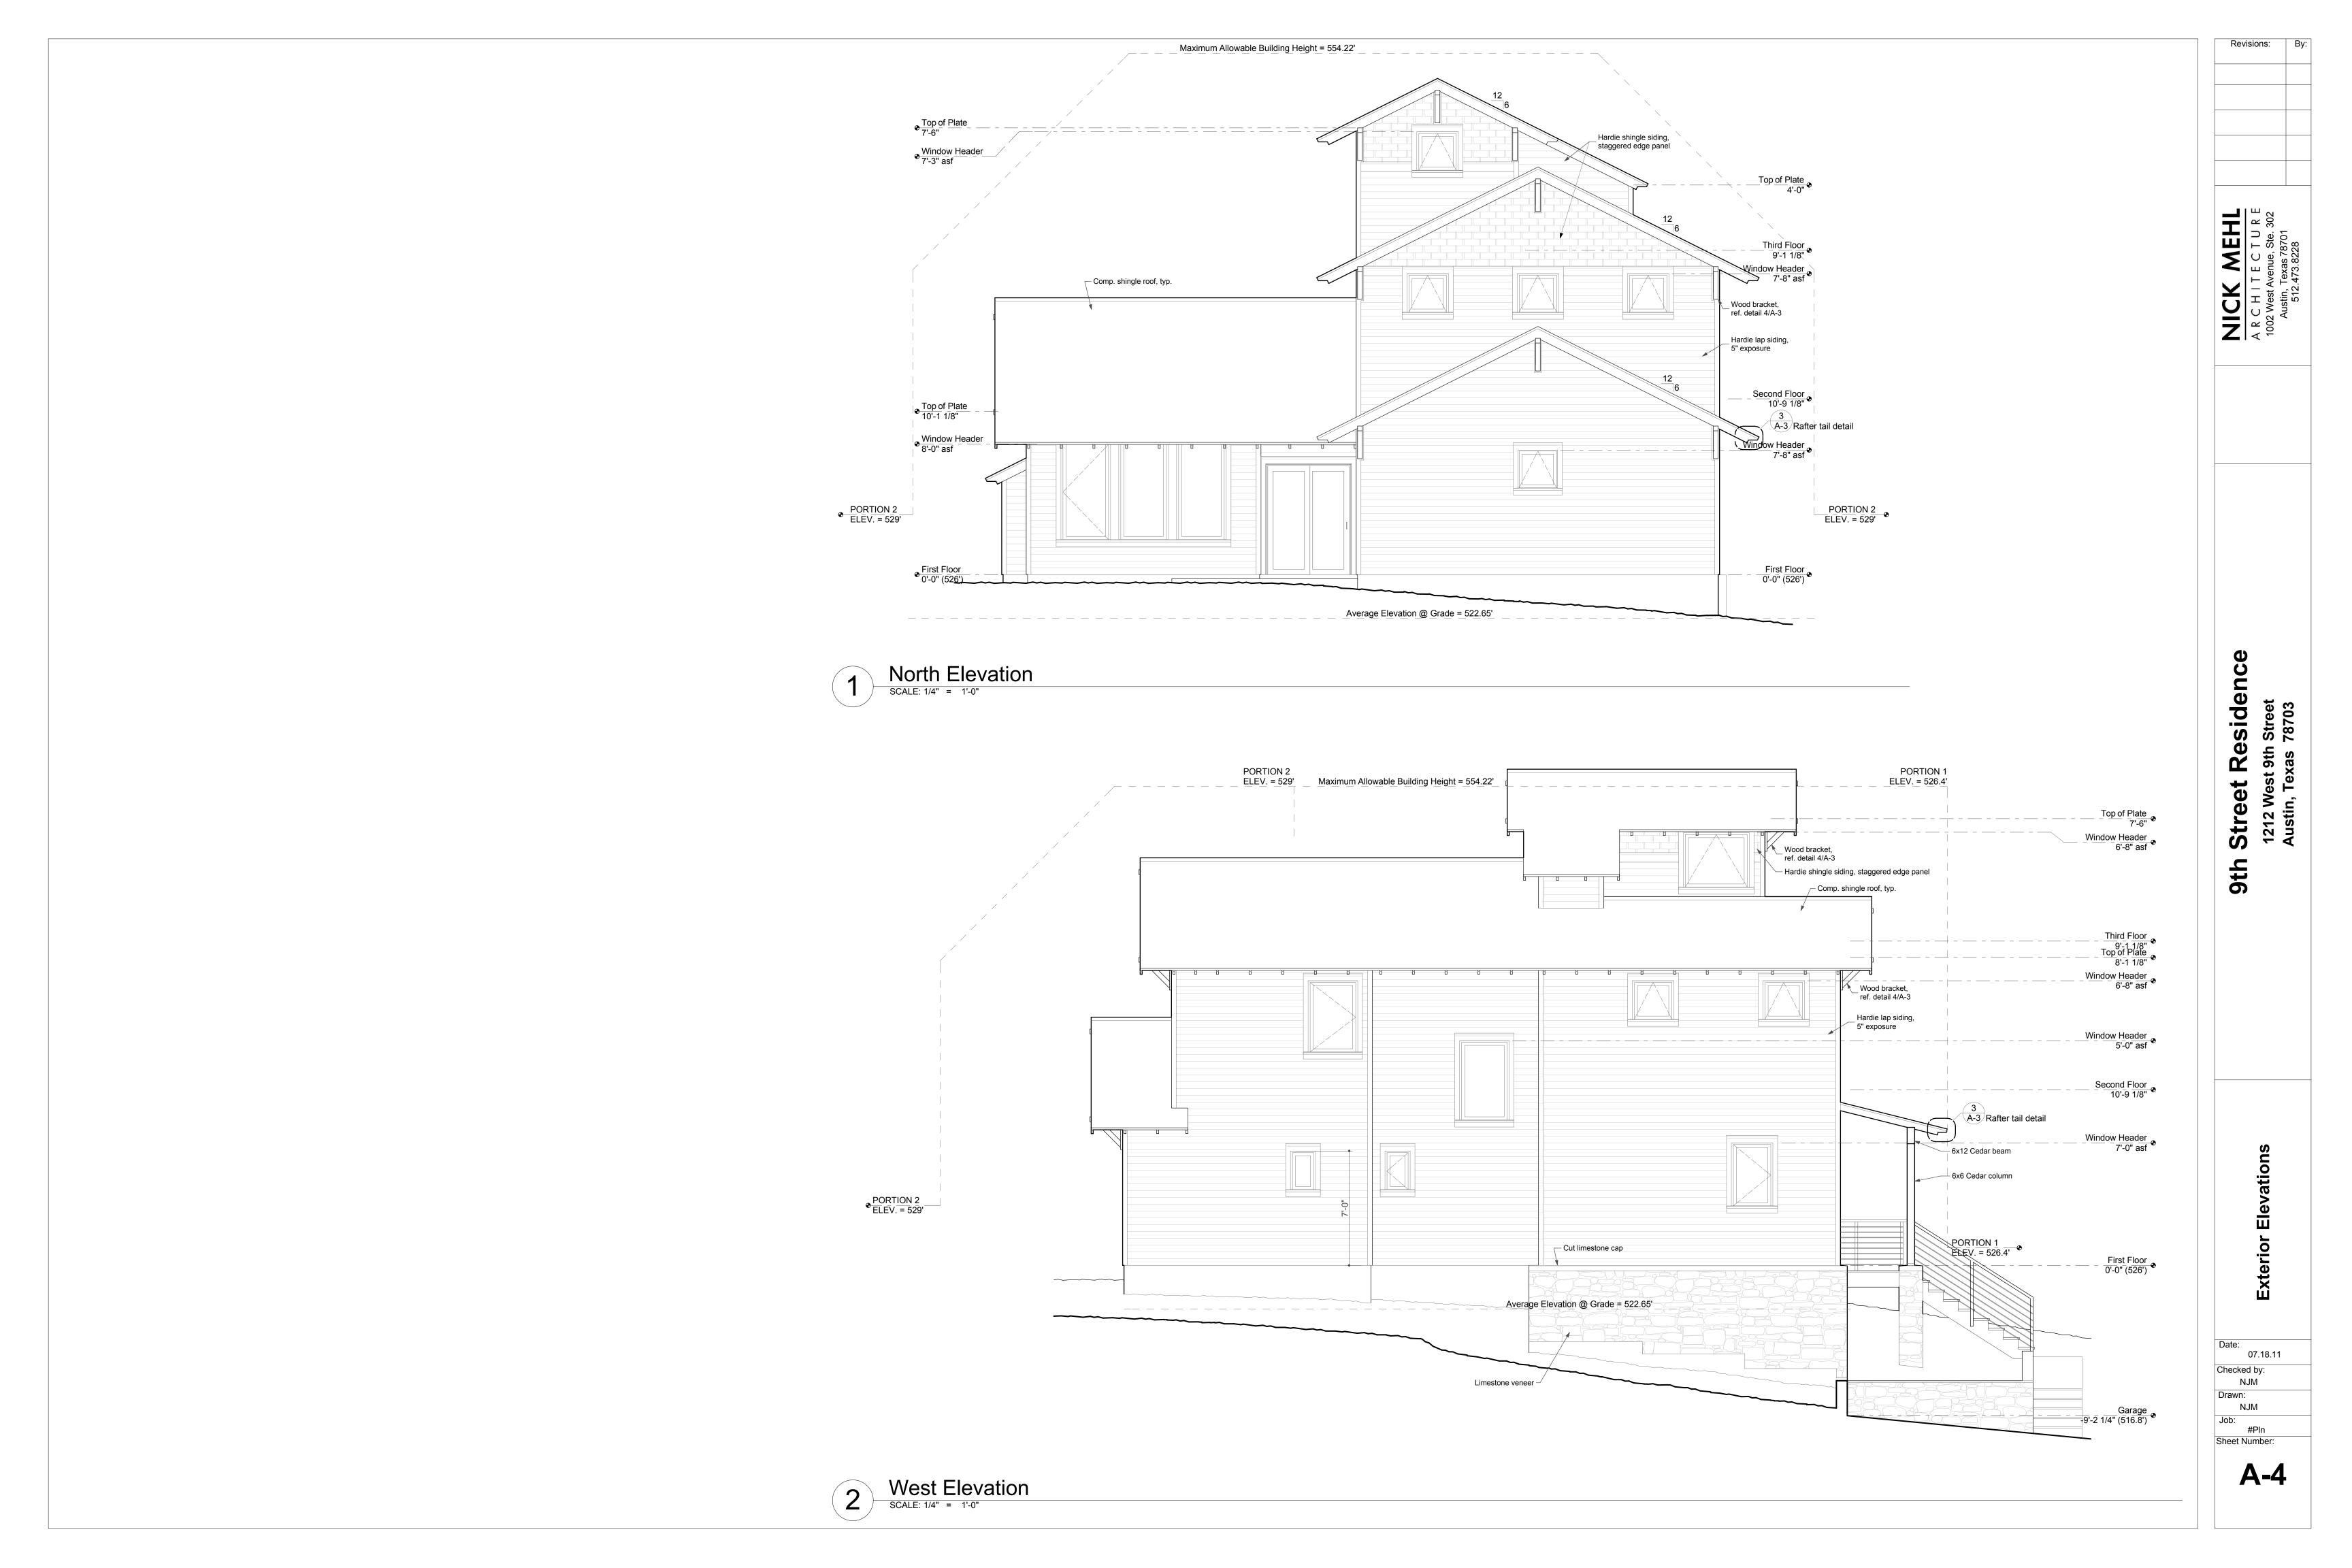

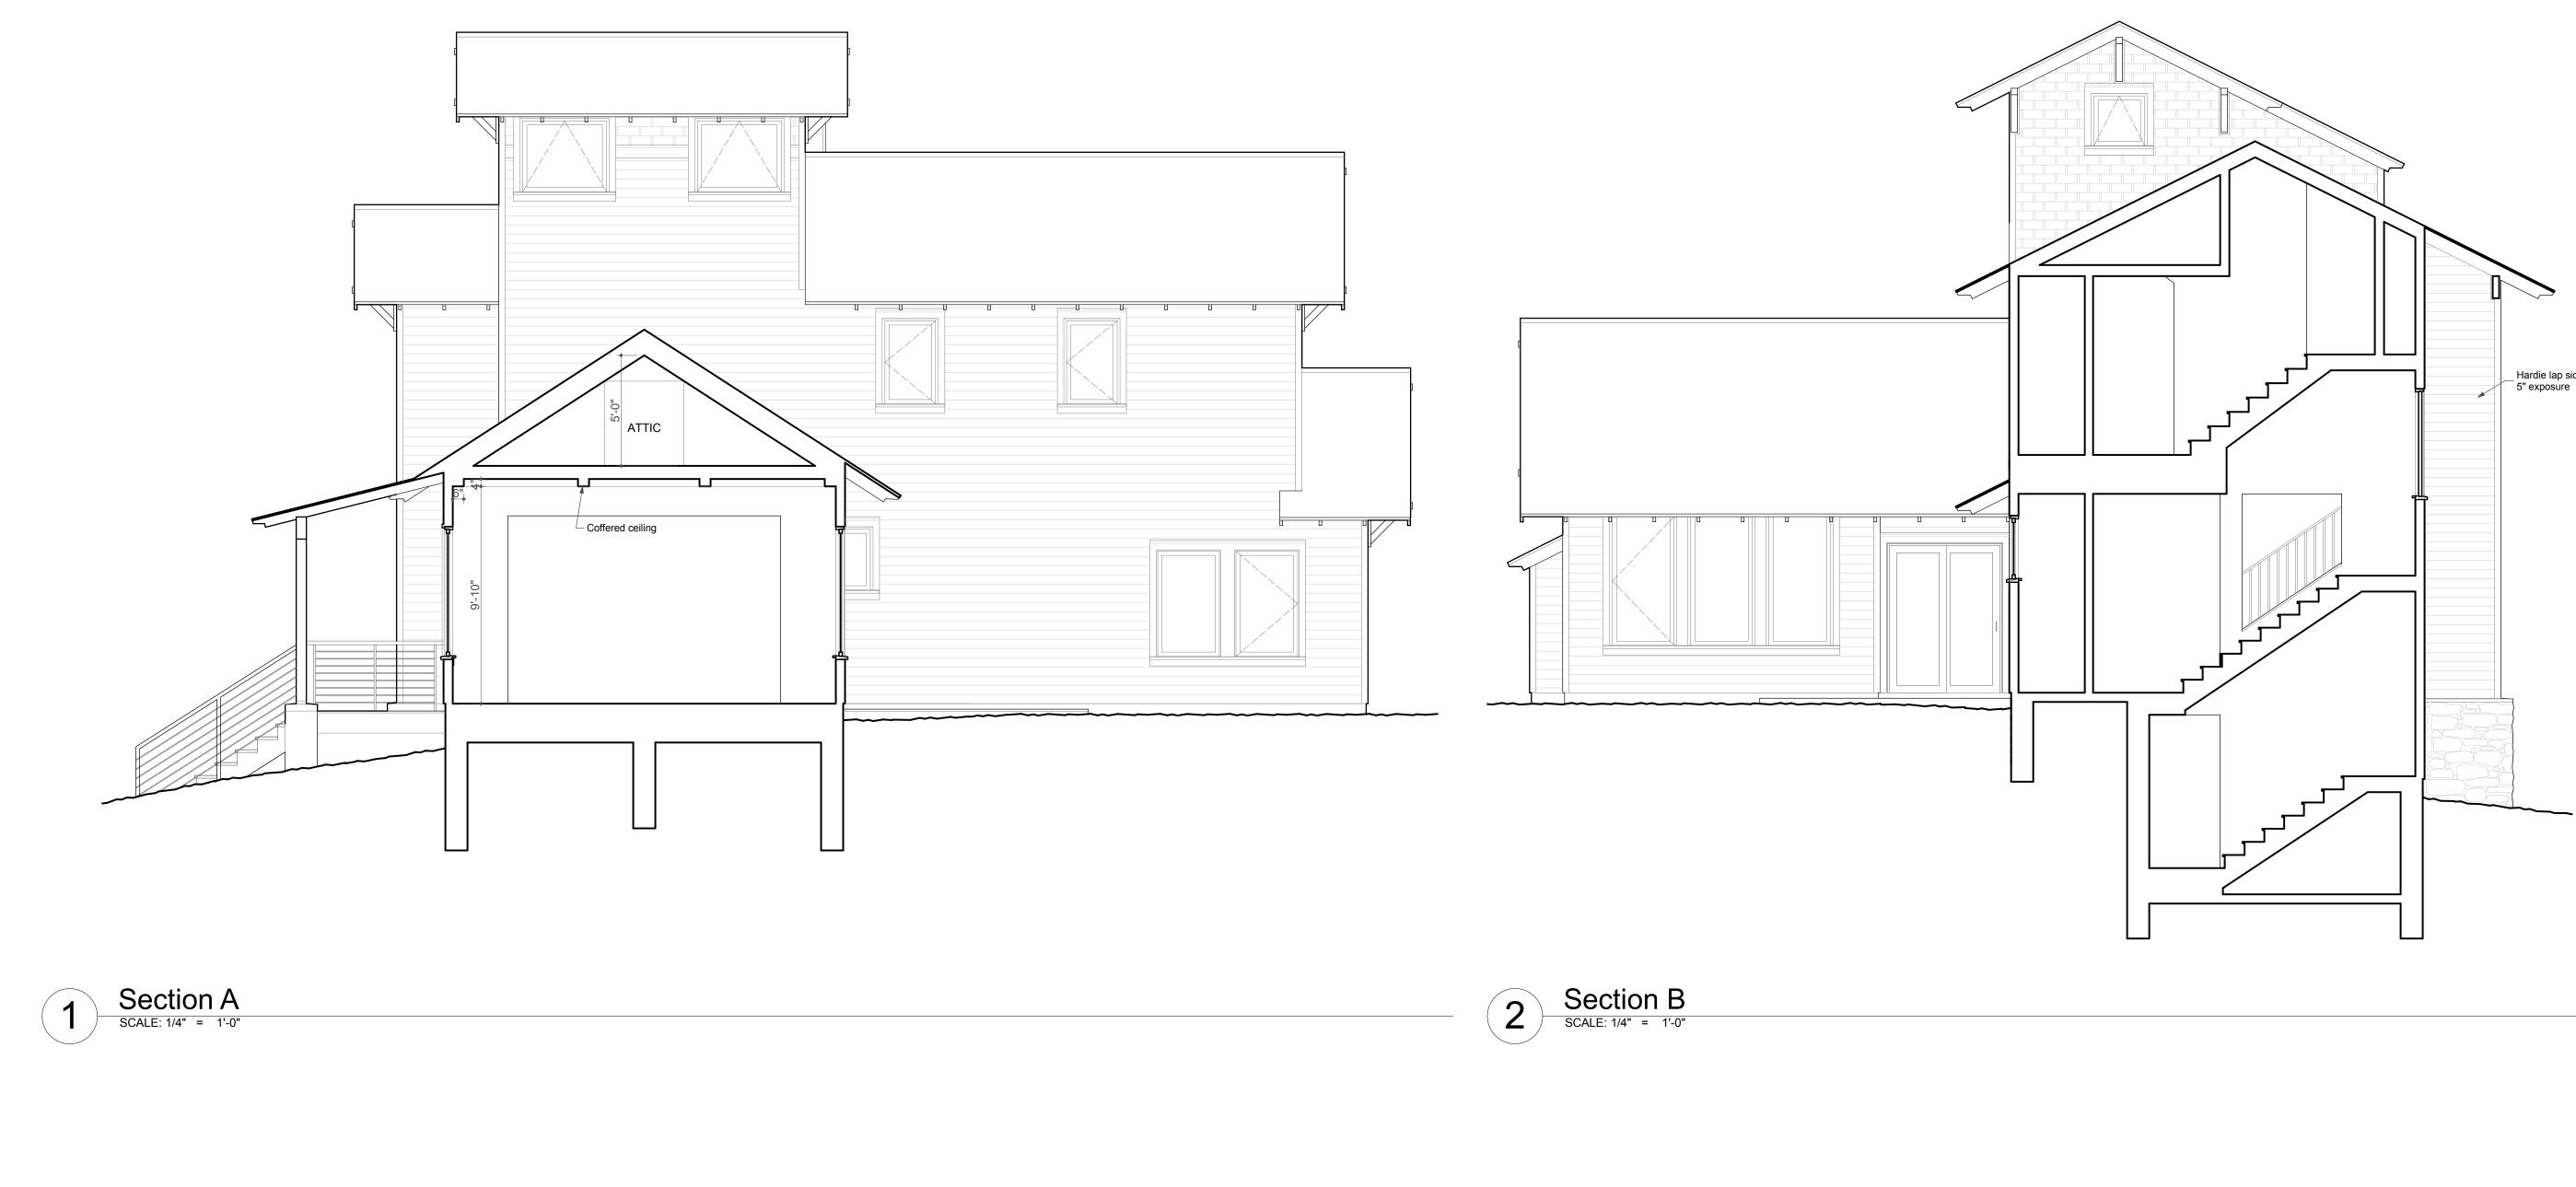



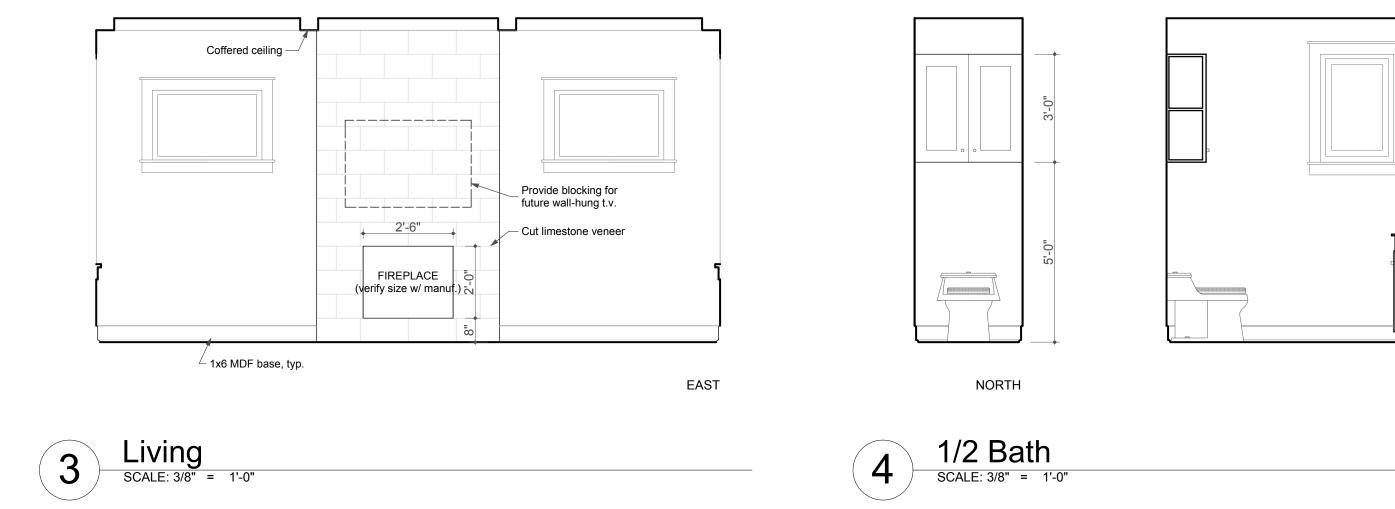

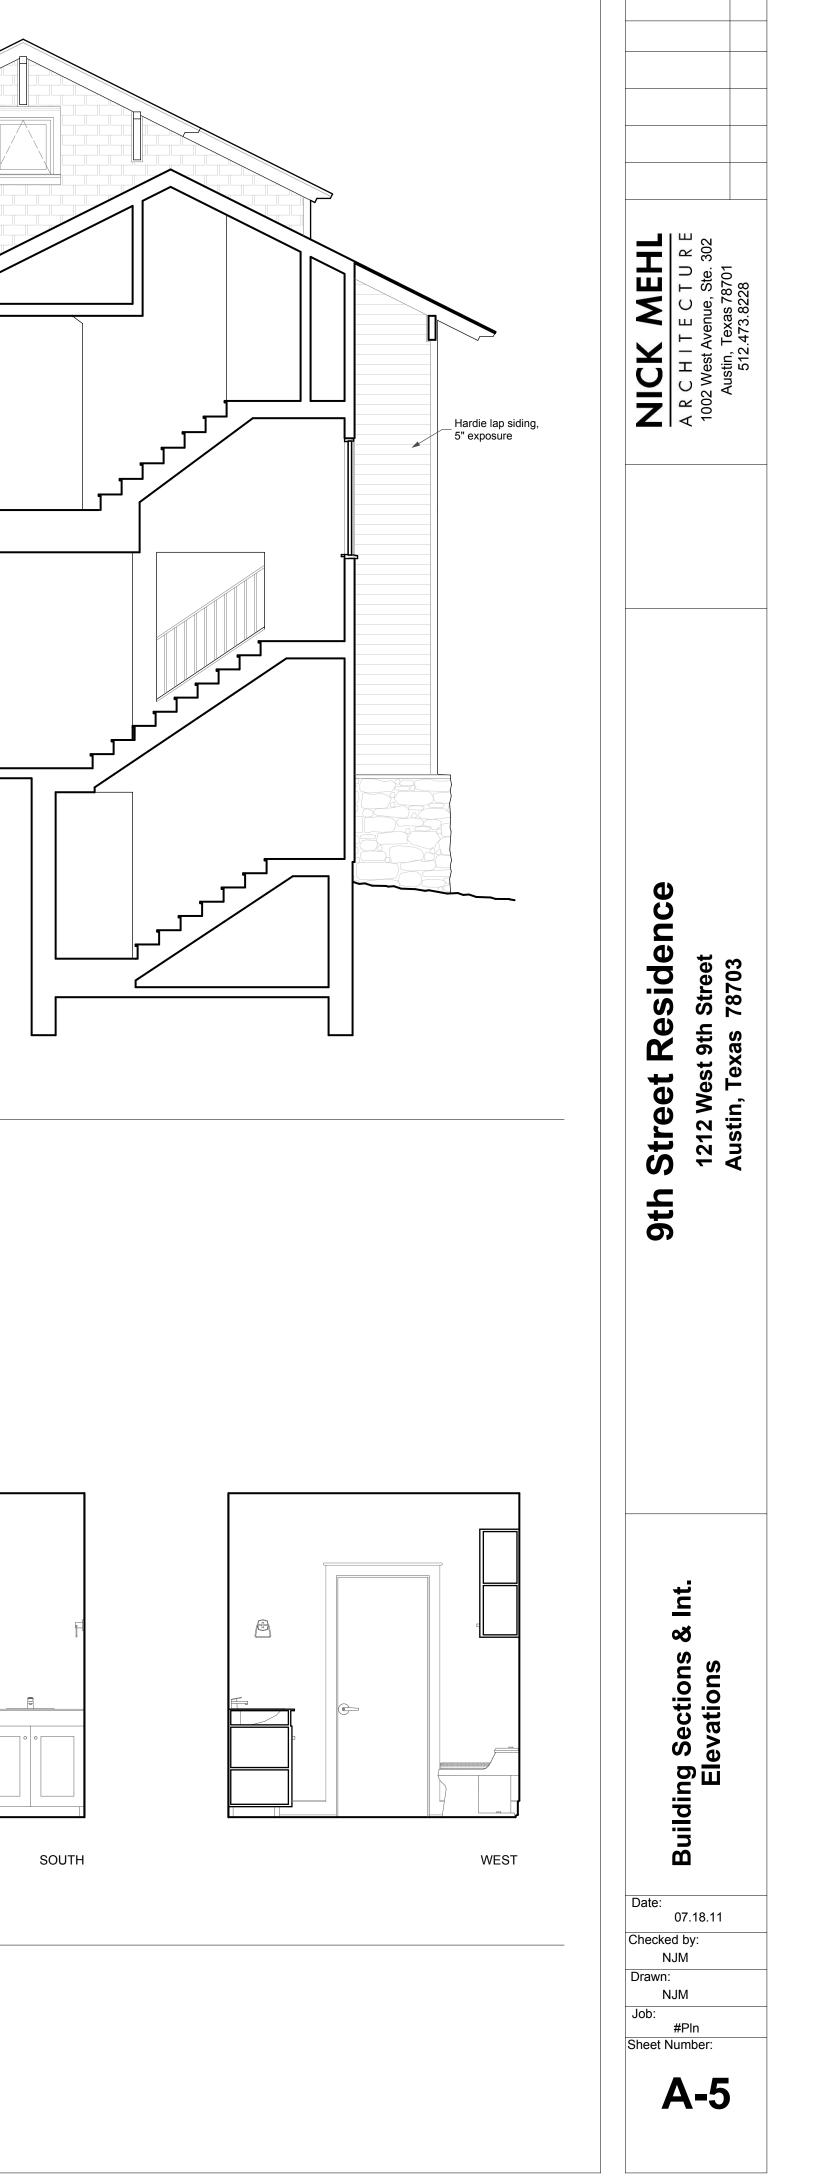

Revisions: By:



EAST

