


DEMOLITION & BUILDING RELOCATION SITE PLAN Scale: 1" = 20' - 0"

## SITE DEMOLITION PLAN KEYED NOTES:

- EXISTING OVERHEAD UTILITY LINE (ELECTRIC AND OR TELEPHONE LINE). REMOVE AS REQUIRED TO ALLOW NEW SERVICE CONNECTIONS FROM JUNIPER ST. ROW/PUE. BUILDING DESIGNATION.
- EXISTING REAR ADDITION TO BE DEMOLISHED TO LIMITS DESIGNATED (CROSS HATCHED).
  - EXISTING BUILDING LOCATION.
- EXISTING TREES & SHRUBS TO GE REMOVED AND GRUBBED TO A DEPTH
- 5. INSTALL 4-INCH DIA, WASTE WATER LINE, CONNECT TO EXISTING WW STUB AT PROPERTY LINE, REFER TO UTILITY AND PLUMBING PLANS.
- EXISTING CARPORT PAD AND OR CONCRETE SIDEWALKS TO BE
- EXISTING CONCRETE RETAINING WALL TO REMAIN, SAWCUT & REMOVE
- PORTION TO RECEIVED TRANSITION TO NEW CONCRETE STEPS.
- REMOVE EXISTING FENCE POST FOOTINGS & BACKFILL TO GRADE. EXISTING CHAIN LINK FENCE, REMOVE AT COMPLETION AND STORE FOR OWNER'S SALVAGE & FUTURE USE.
- 10. GAS LANTERN (REMOVE AND DISPOSE) INSTALL PERMANENT CAP AT
- 11. INSTALL 1-INCH WATER LINE W/ 5/8-INCH WATER METER AND VALVE. CONNECT LINE TO EXISTING WATER STUB AT PROPERTY LINE, REFER TO UTILITY AND PLUMBING PLANS.
- 12. DISCONNECT AND CAP ALL UTILITIES AT PROPERTY LINE BEFORE RELOCATING BUILDING.
- 13. DISCONNECT AND PERMANENTLY CAP ALL BELOW GRADE SERVICE CONNECTIONS TO BUILDING PRIOR TO BUILDING RELOCATION.
- 14. PERMANENTLY CAP ALL UNDERGROUND SERVICE IN ACCORDANCE WITH CITY CODE OR UTILITY REQUIREMENTS.
- 15. EXISTING DRIVEWAY TO BE DEMOLISHED. INSTALL CONCRETE CURB & GUTTER AND SIDEWALK PER CITY OF AUSTIN STANDARD SPECIFICATION MATCH PROFILE AND WALK WIDTHS OR EXISTING ADJACENT
- 16. PATCH STREET PAVEMENT TO CITY OF AUSTIN STANDARD SPECIFICATION AT AFFECTED AREAS, REFER TO CIVIL DRAWINGS.
- 17. VERIFY ACTIVE STATUS WITH UTILITY AND REPORT FINDINGS TO
- EXISTING PROPERTY LINE.
- EXISTING RUBBLE STONE RETAINING WALL TO REMAIN.
- EXISTING GAS STUB TO REMAIN.
- SALVAGE "NO PARKING SIGN" FOR RE-USE, RE-INSTALL
- 15'-0" (BUILDING FACE TO PROPERTY LINE) LYDIA ST)..
- LIMIT OF CONSTRUCTION, REFER ALSO TO CIVIL DRAWINGS.
- MOONLIGHT TOWER DOWN-GUY TO REMAIN (PROTECT DURING
- CONSTRUCTION).
- 25. 10'-0" (BUILDING FACE TO PROPERTY LINE JUNIPER ST.).
- MOON POST TO REMAIN (PROTECT DURING CONSTRUCTION).
- EXISTING DRIVEWAY TO REMAIN (N.I.C.).
- 28. VIEW CORRIDOR LINE
- BUILDING LOCATION CONTROL POINT EXISTING PROPERTY LINE CORNER.
- REMOVE EXISTING CONCRETE PAVEMENT AND WALKS.
- REMOVE EXISTING CONCRETE PAVEMENT & FOUNDATIONS IN THESE AREAS TO LIMITS ONLY REQUIRED FOR NEW SITE WORK CONSTRUCTION; SEE CIVIL AND LANDSCAPE SITE PLANS.



AS100

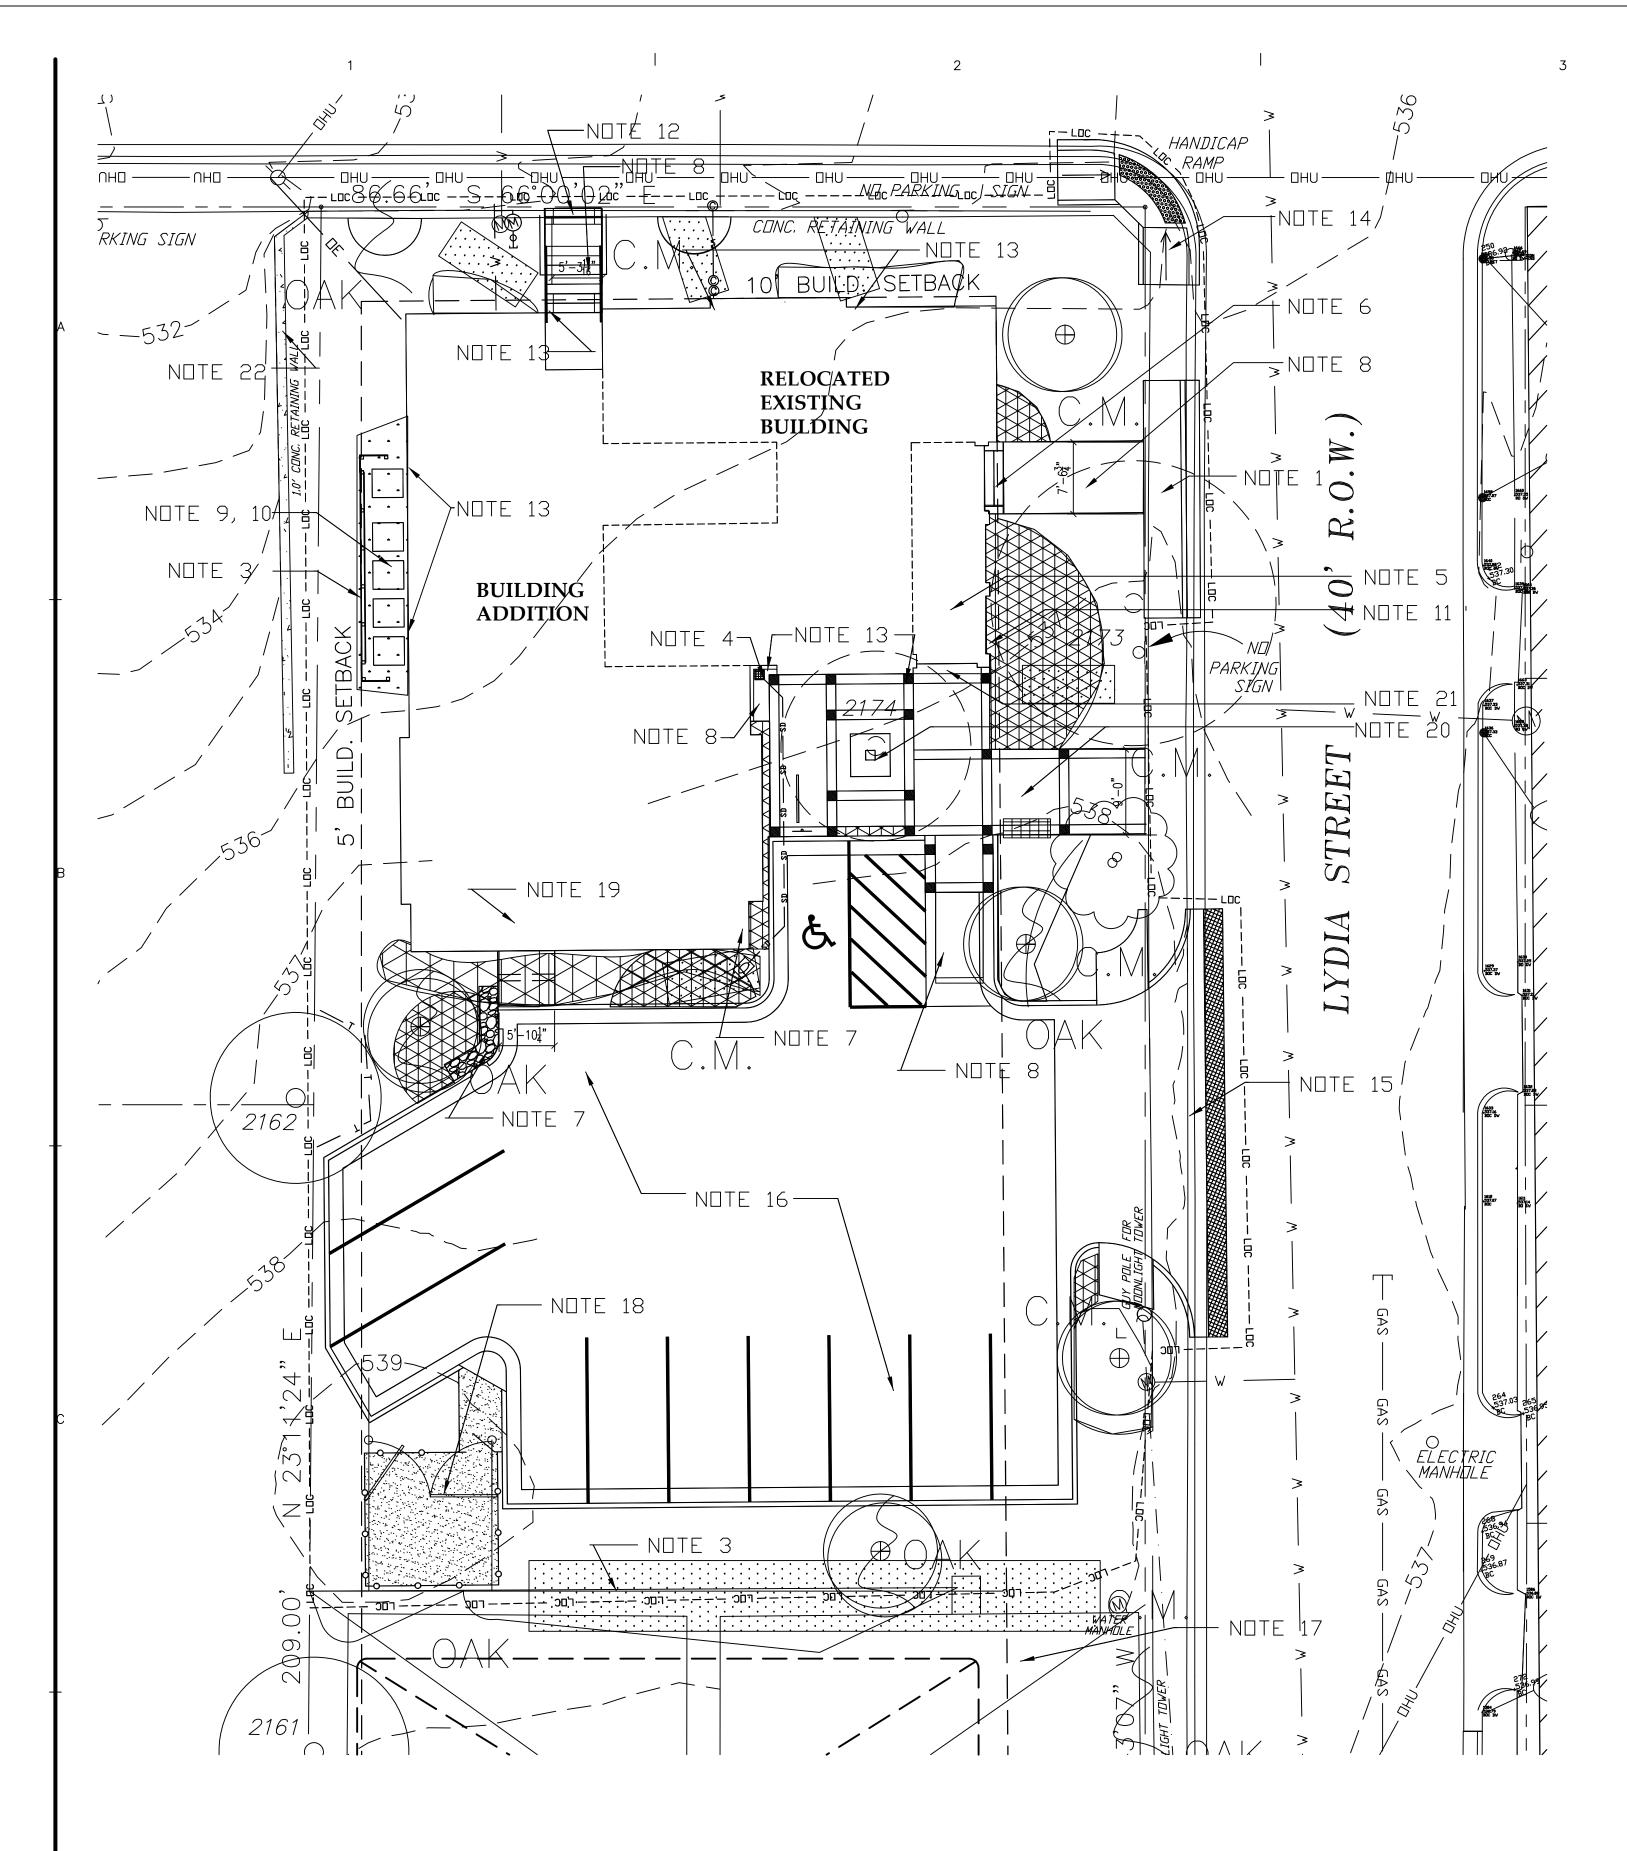

SITE PLAN Scale: 1" = 10' - 0"


## **SITE PLAN KEYED NOTES:**

- REMOVE ALL UNLEVEL SECTIONS OF CONCRETE SIDEWALK, REPLACE WITH 4-INCH REINFORCED CONCRETE [3,000 psi @ 28 days] WALK WITH 2.9X2.9 (6/6) WWF ON 2-INCH SAND CUSHION (TYPICAL AT LYDIA ST. PROPERTY FRONTAGE). INSTALL CURB AND GUTTER AS SHOWN ON CIVIL DRAWINGS IN ACCORDANCE WITH CITY OF AUSTIN STANDARD SPECIFICATIONS.
- BUILDING LOCATION CONTROL POINT EXISTING PROPERTY LINE CORNER [at corner of Lydia St. & Juniper St.].
- 3. 6 FT HIGH WOOD FENCE (VISUAL SCREEN PER CITY CODE); SEE LANDSCAPE PLAN. WOOD FENCE SHALL RECEIVE HORIZONTAL FENCE FABRIC PATTERN USING 1X6, 1X4, AND 1X2 HORIZONTAL BOARDS ON TREATED 4X4 POSTS SPACED AT NOMINAL 6 FT O.C. AS DIRECTED BY ARCHITECT, REFER TO DWG. 2/A305
- CAST IRON DRAIN GRATE, REFER ALSO TO CIVIL DRAWING FOR DRAINAGE PLAN.
- SCORING PATTERN AT NEW PORCH FLOOR TO MATCH EXISTING AS APPROVED BY
- NEW CONCRETE STEPS TO PORCH AND SIDEWALK TO STREET.
- 3" TO 4" DIA ROCK RIP-RAP SPILL-PAD [MIN, 8" DEPTH] @ DRAINAGE FLUME
- NEW CONCRETE SIDEWALK (AND/OR STEPS) [3,000 psi @ 28 days].
- AIR CONDITIONING EQUIPMENT SCREEN; 5 FT HIGH; HORZ. SLAT PATTERN FENCE FABRIC ON 4X4 TREATED POSTS AS APPROVED BY ARCHITECT. EQUIPMENT
- SUPPORTED BY STEEL RAILS [W6X8.5] SET ON 6" DIA. CONC. FOOTINGS [MIN. 18" BURY DEPTH, REINFORCE W/ 4 #4 BARS W/ #3 SPIRAL CAGE; EQUIPMENT AREA ABOVE 8" DEPTH OF 3" TO 4" ROCK RIIP RAP AT DESIGNATED LAWN AREA. CONSTRUCT SALVAGED AND/OR REPLICATED PORCH RAILING; SEE FLOOR PLAN.

CUT EXISTING CONCRETE RETAINING WALL; INSTALL CONCRETE STEPS WITH 1&1/2"

- DIA. STEEL HANDRAIL [34-INCHES A.F.F.] AT EACH SIDE PER TDLR/TAS 2012 ADA STANDARDS
- 13. ROOF DOWNSPOUT; SEE ROOF PLAN. INSTALL CONCRETE SPLASHBLOCK WITH POSITIVE DRAINAGE DISCHARGE AWAY FROM BUILDING AT EACH DOWNSPOUT.
- NEW CURB & SIDEWALK CONSTRUCTION; SEE CIVIL DRAWING.
- 15. NEW CONCRETE DRIVE APPROACH & CURB RAMPS AND SIDEWALK; SEE CIVIL
- 16. NEW ASPHALT PAVEMENT WITH 4-INCH WIDE PAINT STRIPING AT SPACES; SEE CIVIL DRAWING. 17. EXISTING ELECTRICAL SERVICE PANELS TO REMAIN FOR SERVICE TO ADJACENT
- EXISTING DEVELOPMENT, PROTECT FROM DAMAGE TRASH RECEPTACLE SCREEN FENCE; SEE NOTE 3 ABOVE FOR WOOD FENCE
- SPECIFICATION, PROVIDE TWO (2) 4-FT WIDE GATE LEAFS WITH CANE BOLT AND HASP TO RECEIVE OWNER FURNISHED PADLOCK.
- CONCRETE SIDEWALK WITH THREE (3) 3-INCH DIA, PVC UNDER-DRAINS (CULVERTS). BROOM FINISH CONCRETE AT SIDEWALK.
- 20. POROUS PAVERS INSTALLED OVER CRUSHED GRAVEL BASE AND GEOTEXTILE FABRIC; TWO (2) COLORS FOR PRIMARY FIELD AND ACCENT BANDS/MEDALLIONS.
- 21. PROVIDE FLUSH TRANSITION FROM POROUS PAVERS TO NEW PORCH CONCRETE FLOOR ELEVATION.
- 22. EXISTING RUBBLE MASONRY RETAINING WALL TO REMAIN.
- 23. COORDINATE WORK SCOPE SHOWN ON THIS DRAWING WITH CIVIL CONSTRUCTION DRAWINGS.

AS101

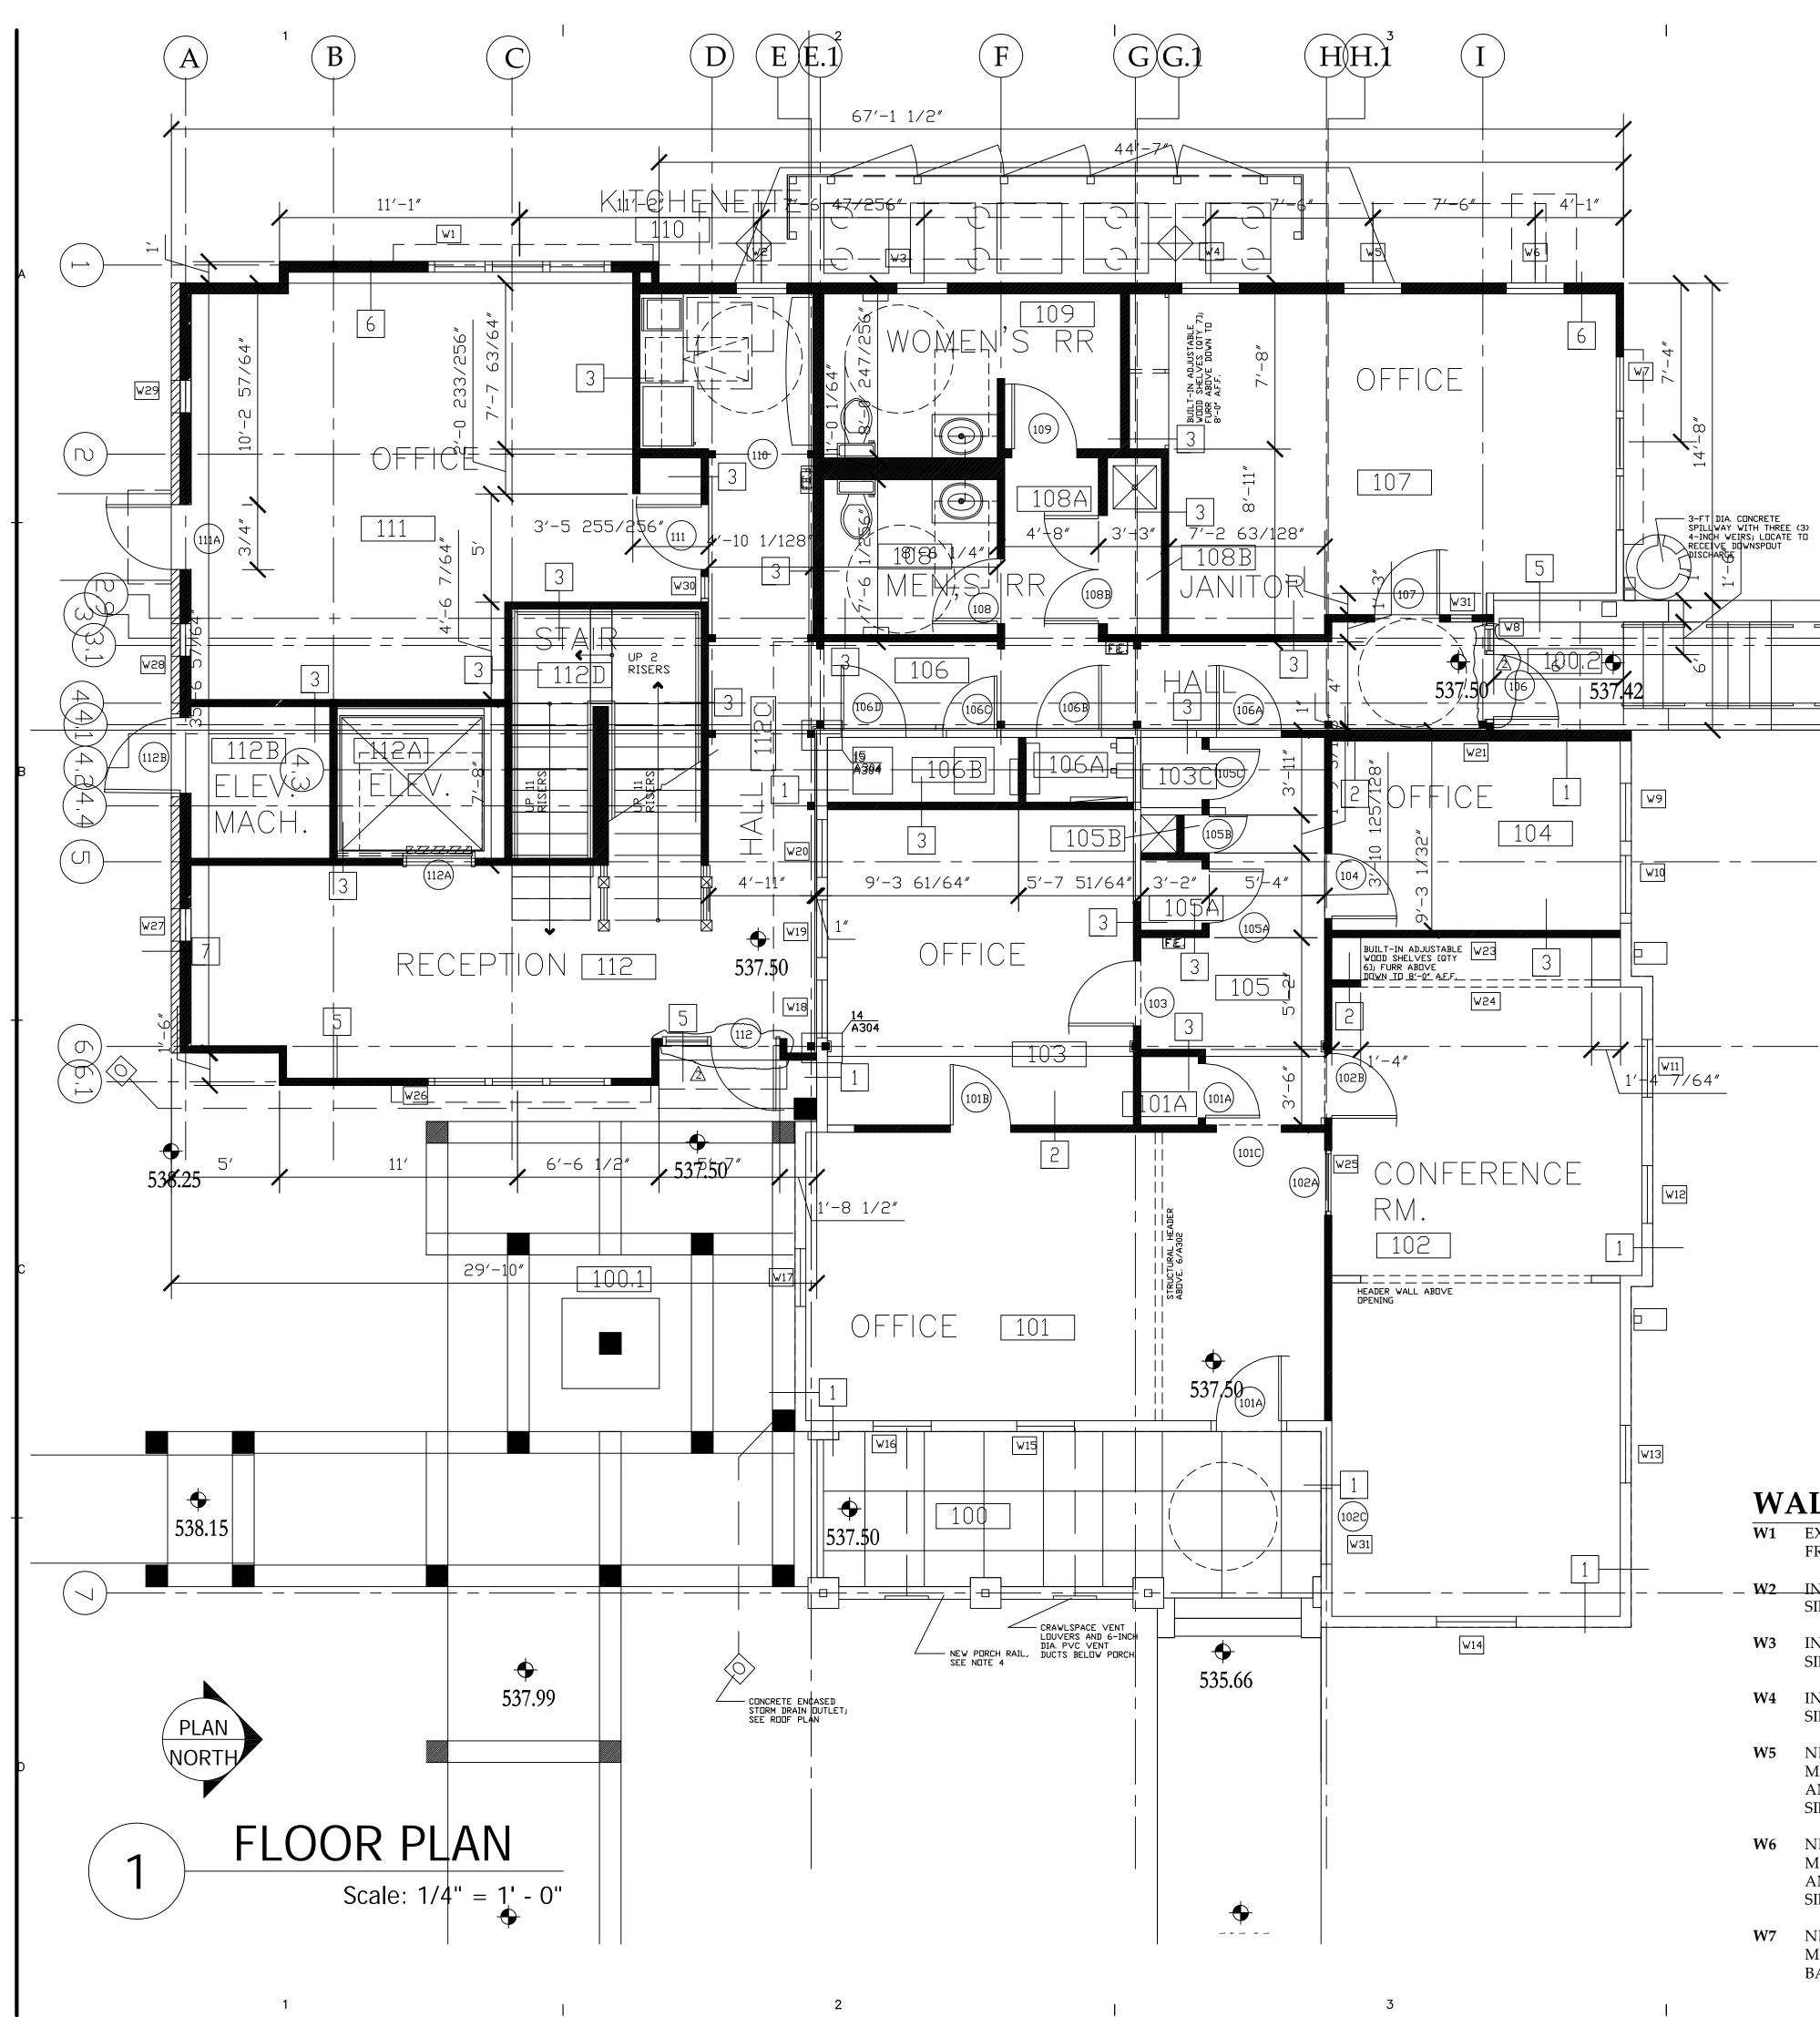

- BUILDING AREA CALCULATION: EXISTING GSF = 1,401.74; PROPOSED ADDN GSF = 2,018; FOR TOTAL GSF = 3,403; PORCH SF = 168 GSF.
- ALL WORK SHALL CONFORM TO LOCAL BUILDING CODE: IBC 2009 AND IBCEB 2009.
- SALVAGE EXISTING BEAD BOARD PORCH CEILING FOR REINSTALLATION; SUPPLEMENT ADDITIONAL QUANTITY OF NEW AND/OR REPLACEMENT BEAD BOARDS FOR NEW INSTALLATION.
- CAREFULLY DISASSEMBLE EXISTING PORCH RAILING, INVENTORY CONSTRUCTION. CONSTRUCT REPLACEMENT PORCH RAILING TO MATCH EXISTING SIZE, SPACING, PROFILES, ETC.
- CAREFULLY DEMOLISH EXISTING RAISED FLOOR (FORMER STAGE) AT ROOM 101. SALVAGE EXISTING WOOD TONGUE AND GROOVE ("T&G") FLOORING FOR REFINISH AND/OR RELOCATION AS DIRECTED BY ARCHITECT IN FIELD. INSTALL NEW REPLACEMENT FLOORING IN THE ENTIRE AREA OR ROOM 101 IF CONTRACTOR DETERMINES THAT EXISTING FLOORING REVEALED DURING DEMOLITION IS DAMAGED.
- CONTRACTOR MAY USE RECLAIMED WOOD FLOORING IF MATCHING IN QUALITY, SPECIE, AND/OR APPEARANCE TO REPLACE EXISTING FLOORS DESIGN INTENT IS TO ACHIEVE A UNIFORM APPEARANCE FOR EACH ROOM ALTHOUGH THERE MAY BE DIFFERENCES ACROSS THE ROOMS RECEIVING WOOD FLOORS.
- NEW REINFORCED CONCRETE PORCH (REPLACEMENT OF HISTORICAL APPEARANCE) SHALL RECEIVE SAWN JOINT SCORING TO MATCH EXISTING PATTERN DOCUMENTED AT THE EXISTING PORCH PRIOR TO DEMOLITION AND RELOCATION OF THE BUILDING.
- INSTALL 2X WOOD BRACING IN WALL TO RECEIVE DISPLAY BOARDS SUPPLIED BY OWNER.
- POROUS CONCRETE PAVERS [TWO COLORS MAIN AND ACCENT ARE INCLUDED IN THE WORK SCOPE]; INSTALLED OVER AGGREGATE BASE AND GEOTEXTILE LINER.
- FABRICATE MECHANICAL EQUIPMENT PLATFORM PLENUM USING ¾-INCH STRUCTURAL GRADE PLYWOOD OVER FIRE-PROOF FRAMING.
- INSTALL THERMAL BATT INSULATION [R-19] AT UNDERSIDE OF HISTORIC BUILDING FLOOR; SUSPEND WITHIN FLOOR FRAMING TO ALL AREAS OF FLOOR PLAN FOOTPRINT.
- 12. REMOVE EXISTING PORCH RAIL; CONSTRUCT REPLICA RAIL PILASTER; MATCH RAIL PROFILE/SIZE AS APPROVED BY ARCHITECT.
- 13. THE CONTRACTOR SHALL ASSESS AND DETERMINE THE INTEGRITY OF EXISTING MATERIALS DESIGNATED FOR RETENTION, SALVAGE, AND/OR REINSTALLATION. CONTRACTOR DETERMINATION SHALL INCLUDE RESPONSIBILITY OF DETERMINING SOUND QUALITY AND SERVICEABLE CONDITION OF ALL SUCH MATERIALS AND/OR COMPONENTS.


## SIGNAGE AND GRAPHICS SCHEDULE

- ALL INTERIOR ROOMS AND SPACES SHALL RECEIVE WALL MOUNTED PHENOLIC ROOM NUMBER SIGNS.
- 2. INSTALL STREET ADDRESS NUMERAL [10-INCH HIGH METAL LETTERS] AT LOCATION DESIGNATED AND APPROVED BY ARCHITECT: QTY 3 LOCATIONS.

## WALL/PARTITION TYPE LEGEND:

- W1 EXISTING HISTORIC STRUCTURE EXTERIOR WALL: STUCCO OVER LATH OVER WOOD SIDING ON WOOD STUD FRAMING.
- W2 INTERIOR WALL/PARTITION: 2X4 WOOD STUD AT 16-INCH O.C.; ½-INCH TYPE X GYPSUM BOARD AT ONE OR BOTH SIDES. REFER TO ROOM FINISH SCHEDULE FOR WAINSCOT AND/OR PANELING FINISH DESIGNATIONS.
- W3 INTERIOR WALL/PARTITION: 2X4 WOOD STUD AT 16-INCH O.C. 5/8-INCH TYPE X GYPSUM BOARD AT ONE OR BOTH SIDES; REFER TO ROOM FINISH SCHEDULE FOR WET LOCATION REQUIREMENTS.
- W4 INTERIOR WALL/PARTITION: 2X6 WOOD STUD AT 16-INCH O.C. 5/8-INCH TYPE X GYPSUM BOARD AT ONE OR BOTH SIDES; REFER TO ROOM FINISH SCHEDULE FOR WET LOCATION REQUIREMENTS.
- W5 NEW EXTERIOR WALL: 2X4 WOOD STUD AT 16-INCH O.C., 1/2-INCH SHEATHING, TYVEK MOISTURE RESISTANT MEMBRANE, ICE&WATER SHIELD MEMBRANE WRAP AT ALL BASE FLASHING, PARAPET WALL CONDITION FLASH, AND WINDOW/DOOR FRAME OPENINGS, R-13 KRAFT FACED BATT INSULATION AT WALL CAVITY, WOOD-FIBER SIDING SIMILAR TO "J. HARDIE" PRODUCTS OR AS APPROVED BY ARCHITECT.
- **W6** NEW EXTERIOR WALL: 2X6 WOOD STUD AT 16-INCH O.C., 1/2-INCH SHEATHING, TYVEK MOISTURE RESISTANT MEMBRANE, ICE&WATER SHIELD MEMBRANE WRAP AT ALL BASE FLASHING, PARAPET WALL CONDITION FLASH, AND WINDOW/DOOR FRAME OPENINGS, R-19 KRAFT FACED BATT INSULATION AT WALL CAVITY, WOOD-FIBER SIDING SIMILAR TO "J. HARDIE" PRODUCTS OR AS APPROVED BY ARCHITECT.
- NEW EXTERIOR WALL: 2X6 WOOD STUD AT 16-INCH O.C., 1/2-INCH SHEATHING, TYVEK MOISTURE RESISTANT MEMBRANE, ICE&WATER SHIELD MEMBRANE WRAP AT ALL WINDOW/DOOR FRAME OPENINGS, R-13 KRAFT FACED BATT INSULATION AT WALL CAVITY, 2-INCH AIR CAVITY AND BRICK VENEER WALL FINISH.

A1.00

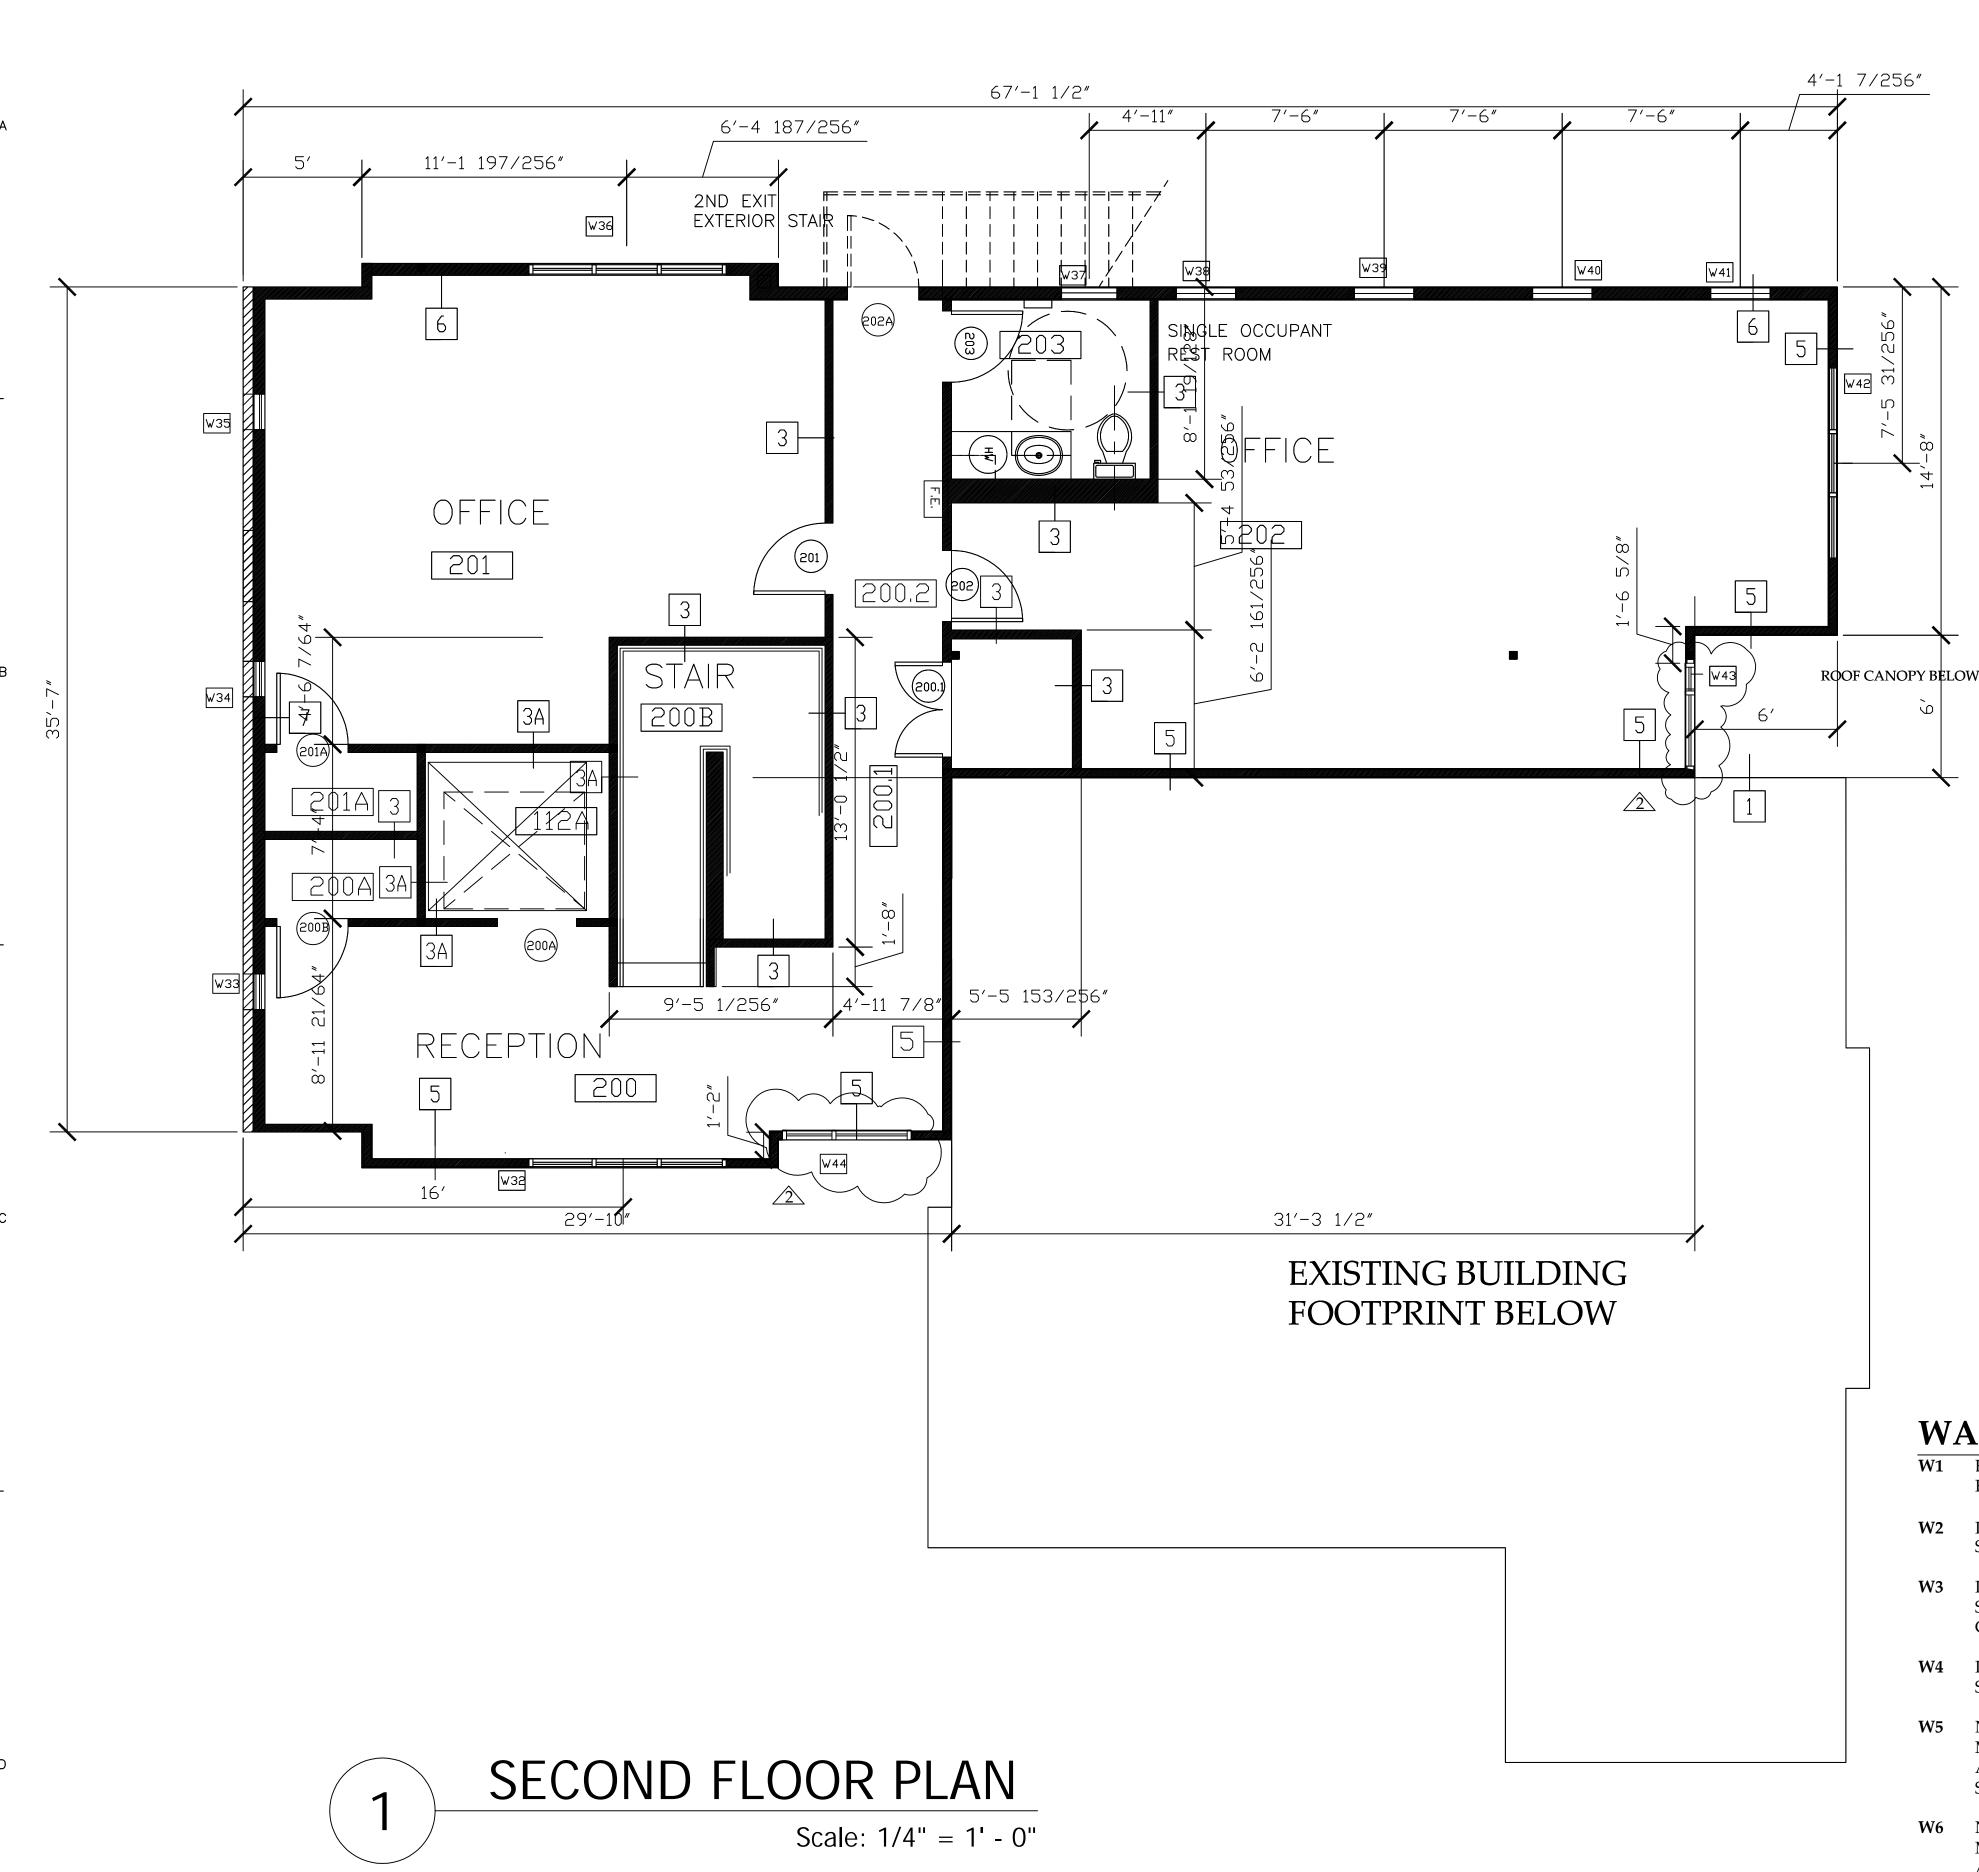

- BUILDING AREA CALCULATION: EXISTING GSF = 1,401.74; PROPOSED ADDN GSF = 2,018; FOR TOTAL GSF = 3,403; PORCH SF = 168 GSF.
- 2. ALL WORK SHALL CONFORM TO LOCAL BUILDING CODE: IBC 2009 AND IBCEB 2009.
- 3. FABRICATE MECHANICAL EQUIPMENT PLATFORM PLENUM USING ¾-INCH STRUCTURAL GRADE PLYWOOD OVER FIRE-PROOF FRAMING.
- E. SECOND FLOOR CONSTRUCTION SHALL INCLUDE SOUND ATTENUATION
  BATTS [R11 UNFACED]; ¾-INCH THICK STRUCTURAL GRADE
  TONGUE&GROOVE PLYWOOD; GLUED AND SCREWED TO FLOOR FRAMING.

# Herman Schieffer House "East Room" 1154 Lydia Straustin, Texas, Relocation, Rehabilitation Ph II PARSHALL + ASSOCIATES ARCHITE

## B OF TELLO

## REVISION DATE DESCRIPTION 2 5/6/13 LANDMARK COMM RVW REVISION COMMANDED COMM RVW REVISION COMMANDED COMM RVW REVISION COMMANDED COMMANDED COMM RVW REVISION COMMANDED COMMANDD COMMAND COMMANDD COMMAND COMMAND COMMAND COMMA

## SIGNAGE AND GRAPHICS SCHEDULE

1. ALL INTERIOR ROOMS AND SPACES SHALL RECEIVE WALL MOUNTED PHENOLIC ROOM NUMBER SIGNS.

### WALL/PARTITION TYPE LEGEND:


- W1 EXISTING HISTORIC STRUCTURE EXTERIOR WALL: STUCCO OVER LATH OVER WOOD SIDING ON WOOD STUD FRAMING.
- W2 INTERIOR WALL/PARTITION: 2X4 WOOD STUD AT 16-INCH O.C.; ½-INCH TYPE X GYPSUM BOARD AT ONE OR BOTH SIDES. REFER TO ROOM FINISH SCHEDULE FOR WAINSCOT AND/OR PANELING FINISH DESIGNATIONS.
- W3 INTERIOR WALL/PARTITION: 2X4 WOOD STUD AT 16-INCH O.C. 5/8-INCH TYPE X GYPSUM BOARD AT ONE OR BOTH SIDES; REFER TO ROOM FINISH SCHEDULE FOR WET LOCATION REQUIREMENTS. PARTITION '3A' SHALL BE CONSTRUCTED AS ONE-HOUR RATED2X4 STUD AT 16" O.C. SHAFT WALL.
- W4 INTERIOR WALL/PARTITION: 2X6 WOOD STUD AT 16-INCH O.C. 5/8-INCH TYPE X GYPSUM BOARD AT ONE OR BOTH SIDES; REFER TO ROOM FINISH SCHEDULE FOR WET LOCATION REQUIREMENTS.
- W5 NEW EXTERIOR WALL: 2X4 WOOD STUD AT 16-INCH O.C., 1/2-INCH SHEATHING, TYVEK MOISTURE RESISTANT MEMBRANE, ICE&WATER SHIELD MEMBRANE WRAP AT ALL BASE FLASHING, PARAPET WALL CONDITION FLASH, AND WINDOW/DOOR FRAME OPENINGS, R-13 KRAFT FACED BATT INSULATION AT WALL CAVITY, WOOD-FIBER SIDING SIMILAR TO "J. HARDIE" PRODUCTS OR AS APPROVED BY ARCHITECT.
- NEW EXTERIOR WALL: 2X6 WOOD STUD AT 16-INCH O.C., 1/2-INCH SHEATHING, TYVEK MOISTURE RESISTANT MEMBRANE, ICE&WATER SHIELD MEMBRANE WRAP AT ALL BASE FLASHING, PARAPET WALL CONDITION FLASH, AND WINDOW/DOOR FRAME OPENINGS, R-19 KRAFT FACED BATT INSULATION AT WALL CAVITY, WOOD-FIBER SIDING SIMILAR TO "J. HARDIE" PRODUCTS OR AS APPROVED BY ARCHITECT.
- W7 NEW EXTERIOR WALL: 2X6 WOOD STUD AT 16-INCH O.C., 1/2-INCH SHEATHING, TYVEK MOISTURE RESISTANT MEMBRANE, ICE&WATER SHIELD MEMBRANE WRAP AT ALL WINDOW/DOOR FRAME OPENINGS, R-13 KRAFT FACED BATT INSULATION AT WALL CAVITY, 2-INCH AIR CAVITY AND BRICK VENEER WALL FINISH.

D FLOOR PLAN - NEW

| PROJECT#: | DRAWN BY: | PAA\_2010.003 | UCP

ISSUE: CD PF PDATE: DATE: DATE:

A1.01

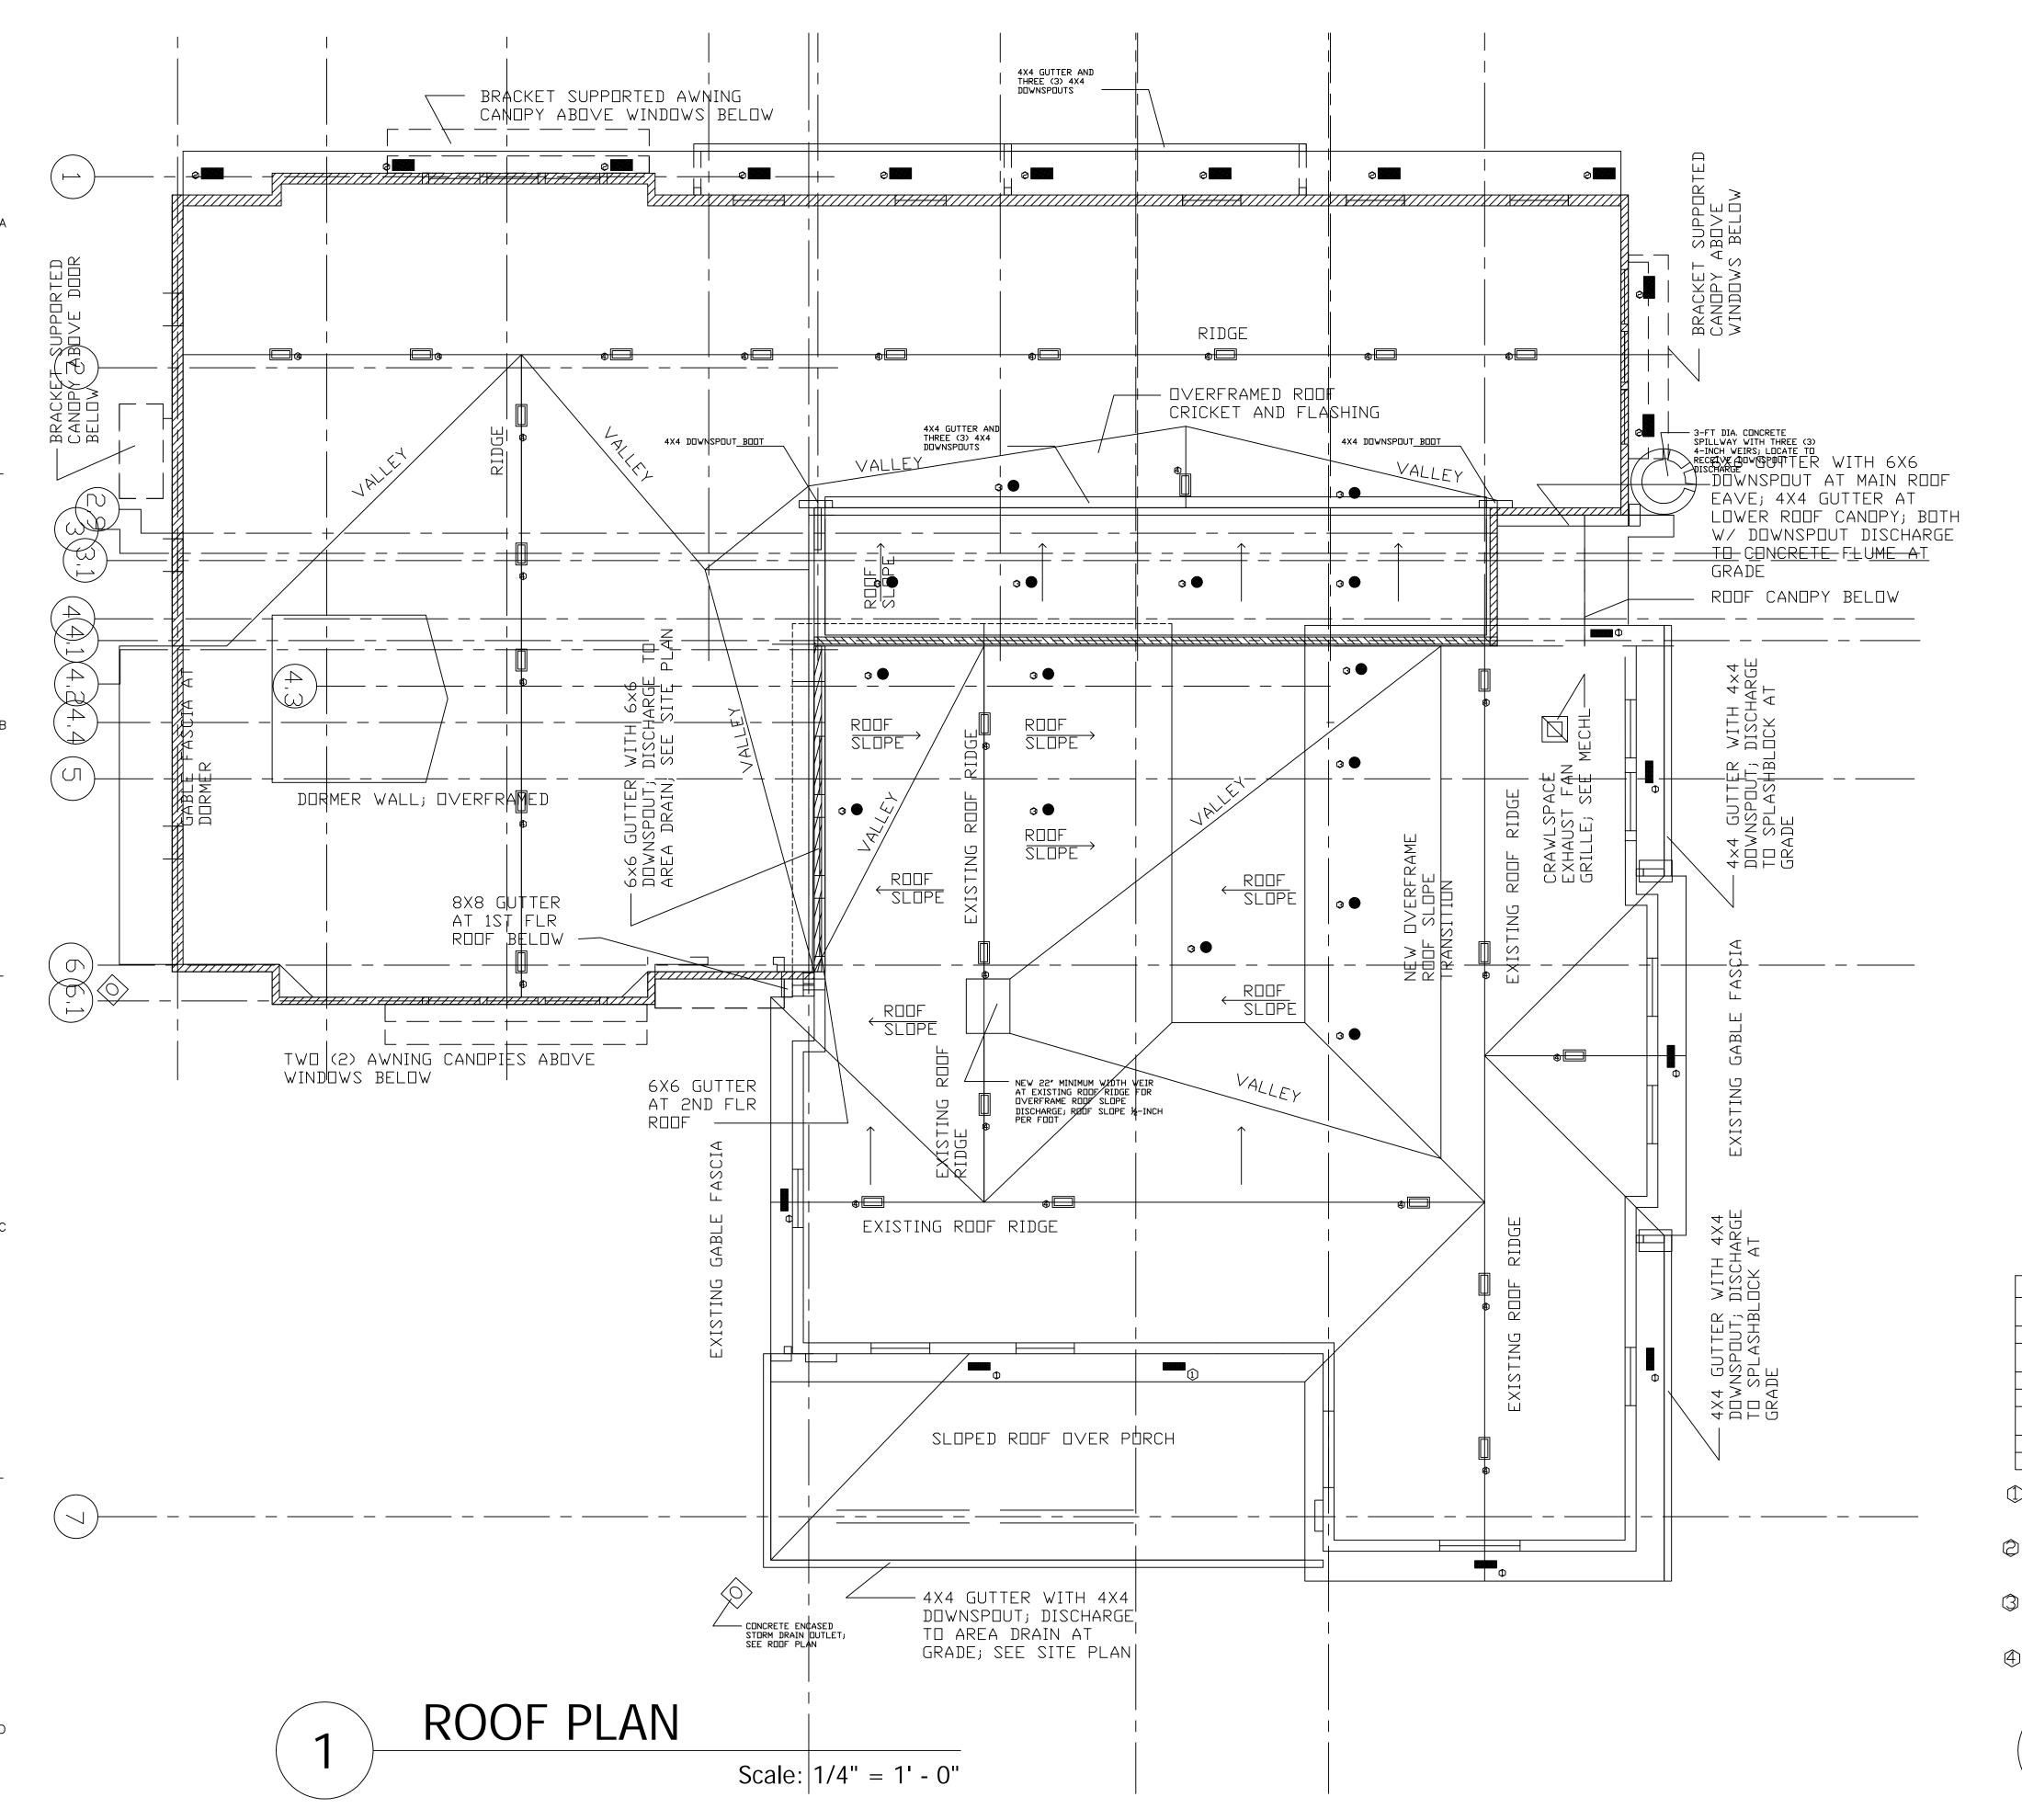

- EXISTING ROOF AREA: REMOVE EXISTING ROOFING LAYERS DOWN TO SUBSTRATE. CONTRACTOR TO DETERMINE AND REPLACE ALL DETERIORATED ROOF LATH/DECKING; REPLACE WITH NEW STRUCTURAL SHEATHING AS SPECIFIED. INSTALL NEW ROOFING AT EXISTING BUILDING AND NEW ADDITION ROOF AREAS WITH COMPOSITION ASPHALT SHINGLES.
- EXISTING ROOF FASCIA/EAVE/SOFFIT: ASSESS AND REMOVE DETERIORATED WOOD FASCIA, EAVE, AND SOFFIT MATERIALS DOWN TO SUBSTRATE FRAMING; INSTALL REPLACEMENT MATERIAL MATCHING EXISTING HISTORICAL MATERIALS, PROFILES AT HISTORIC BUILDING COMPONENTS.
- EXISTING GABLE FASCIA AND TRIM ARE INCLUDED IN WORK SCOPE OF 'NOTE 2' ABOVE.
- REMOVE EXISTING DETERIORATED SLOPED ROOF OVER PORCH; INSTALL NEW WOOD FRAMING AND SLOPED FLAT ROOF (3-PLY MODIFIED BITUMEN ROOFING "MBR") AT PORCH AT RELOCATED
- NEW ROOFING SHALL INCLUDE COMPOSITION ASPHALT SHINGLE OVER 30# FELT OVER ICE&WATER SHIELD MEMBRANE OVER THE ENTIRE ROOFED AREAS.
- BRACKET SUPPORTED AWNING CANOPIES SHALL INCLUDE TYPICAL 24" OVERHANG AT WINDOWS. REFER TO WINDOW CANOPY DETAIL.
- SLOPED SLAT ROOF (3-PLY MBR) OVER 30# FELT OVER ICE AND WATER SHIELD MEMBRANE OVER ½"-THICK STRUCTURAL GRADE PLYWOOD
- SLOPED ROOF CANOPY (STANDING SEAM COPPER) AT EXTERIOR DOORS; SEE CANOPY DETAIL.

		RVW REV			
	DESCRIPTION	LANDMARK COMM RVW REV			
С	DATE	5/6/13			
		ı l			

Not To Scale

	R□□F V	'ENT CALCUL	LATIONS	
ROOF AREA	LOCATION	NFA REQ'D	ND, of SDFFIT VENTS	ND, of RIDGE VENTS
ROOF AREA 'A'	EXISTING BLDG.	1sf	7 # 1	7 # 4
ROOF AREA 'B'	□VERFRAME CRICKET	6.7sf	4 # 2	2 #3
ROOF AREA 'C'	RM 204	2.24sf	8 # 2	8 #3
ROOF AREA 'D'	BLDG ADDN	11.6sf	23 #2	15 # 4
ROOF AREA 'E'	ELEVATOR SHAFT		2 # 2	1 # 4

① TYPE 1 = .33'X1': 75% FA = .2475 NFA EA.


② TYPE 2 = .5'X1': 75% FA = .375 NFA EA.

TYPE 3 = .5'X1': 75% FA = .147 NFA EA.

1 TYPE 4 = 6" X 12" RIDGE VENT W/ .375 NFA EA.

ROOF VENTING TABLE

A102

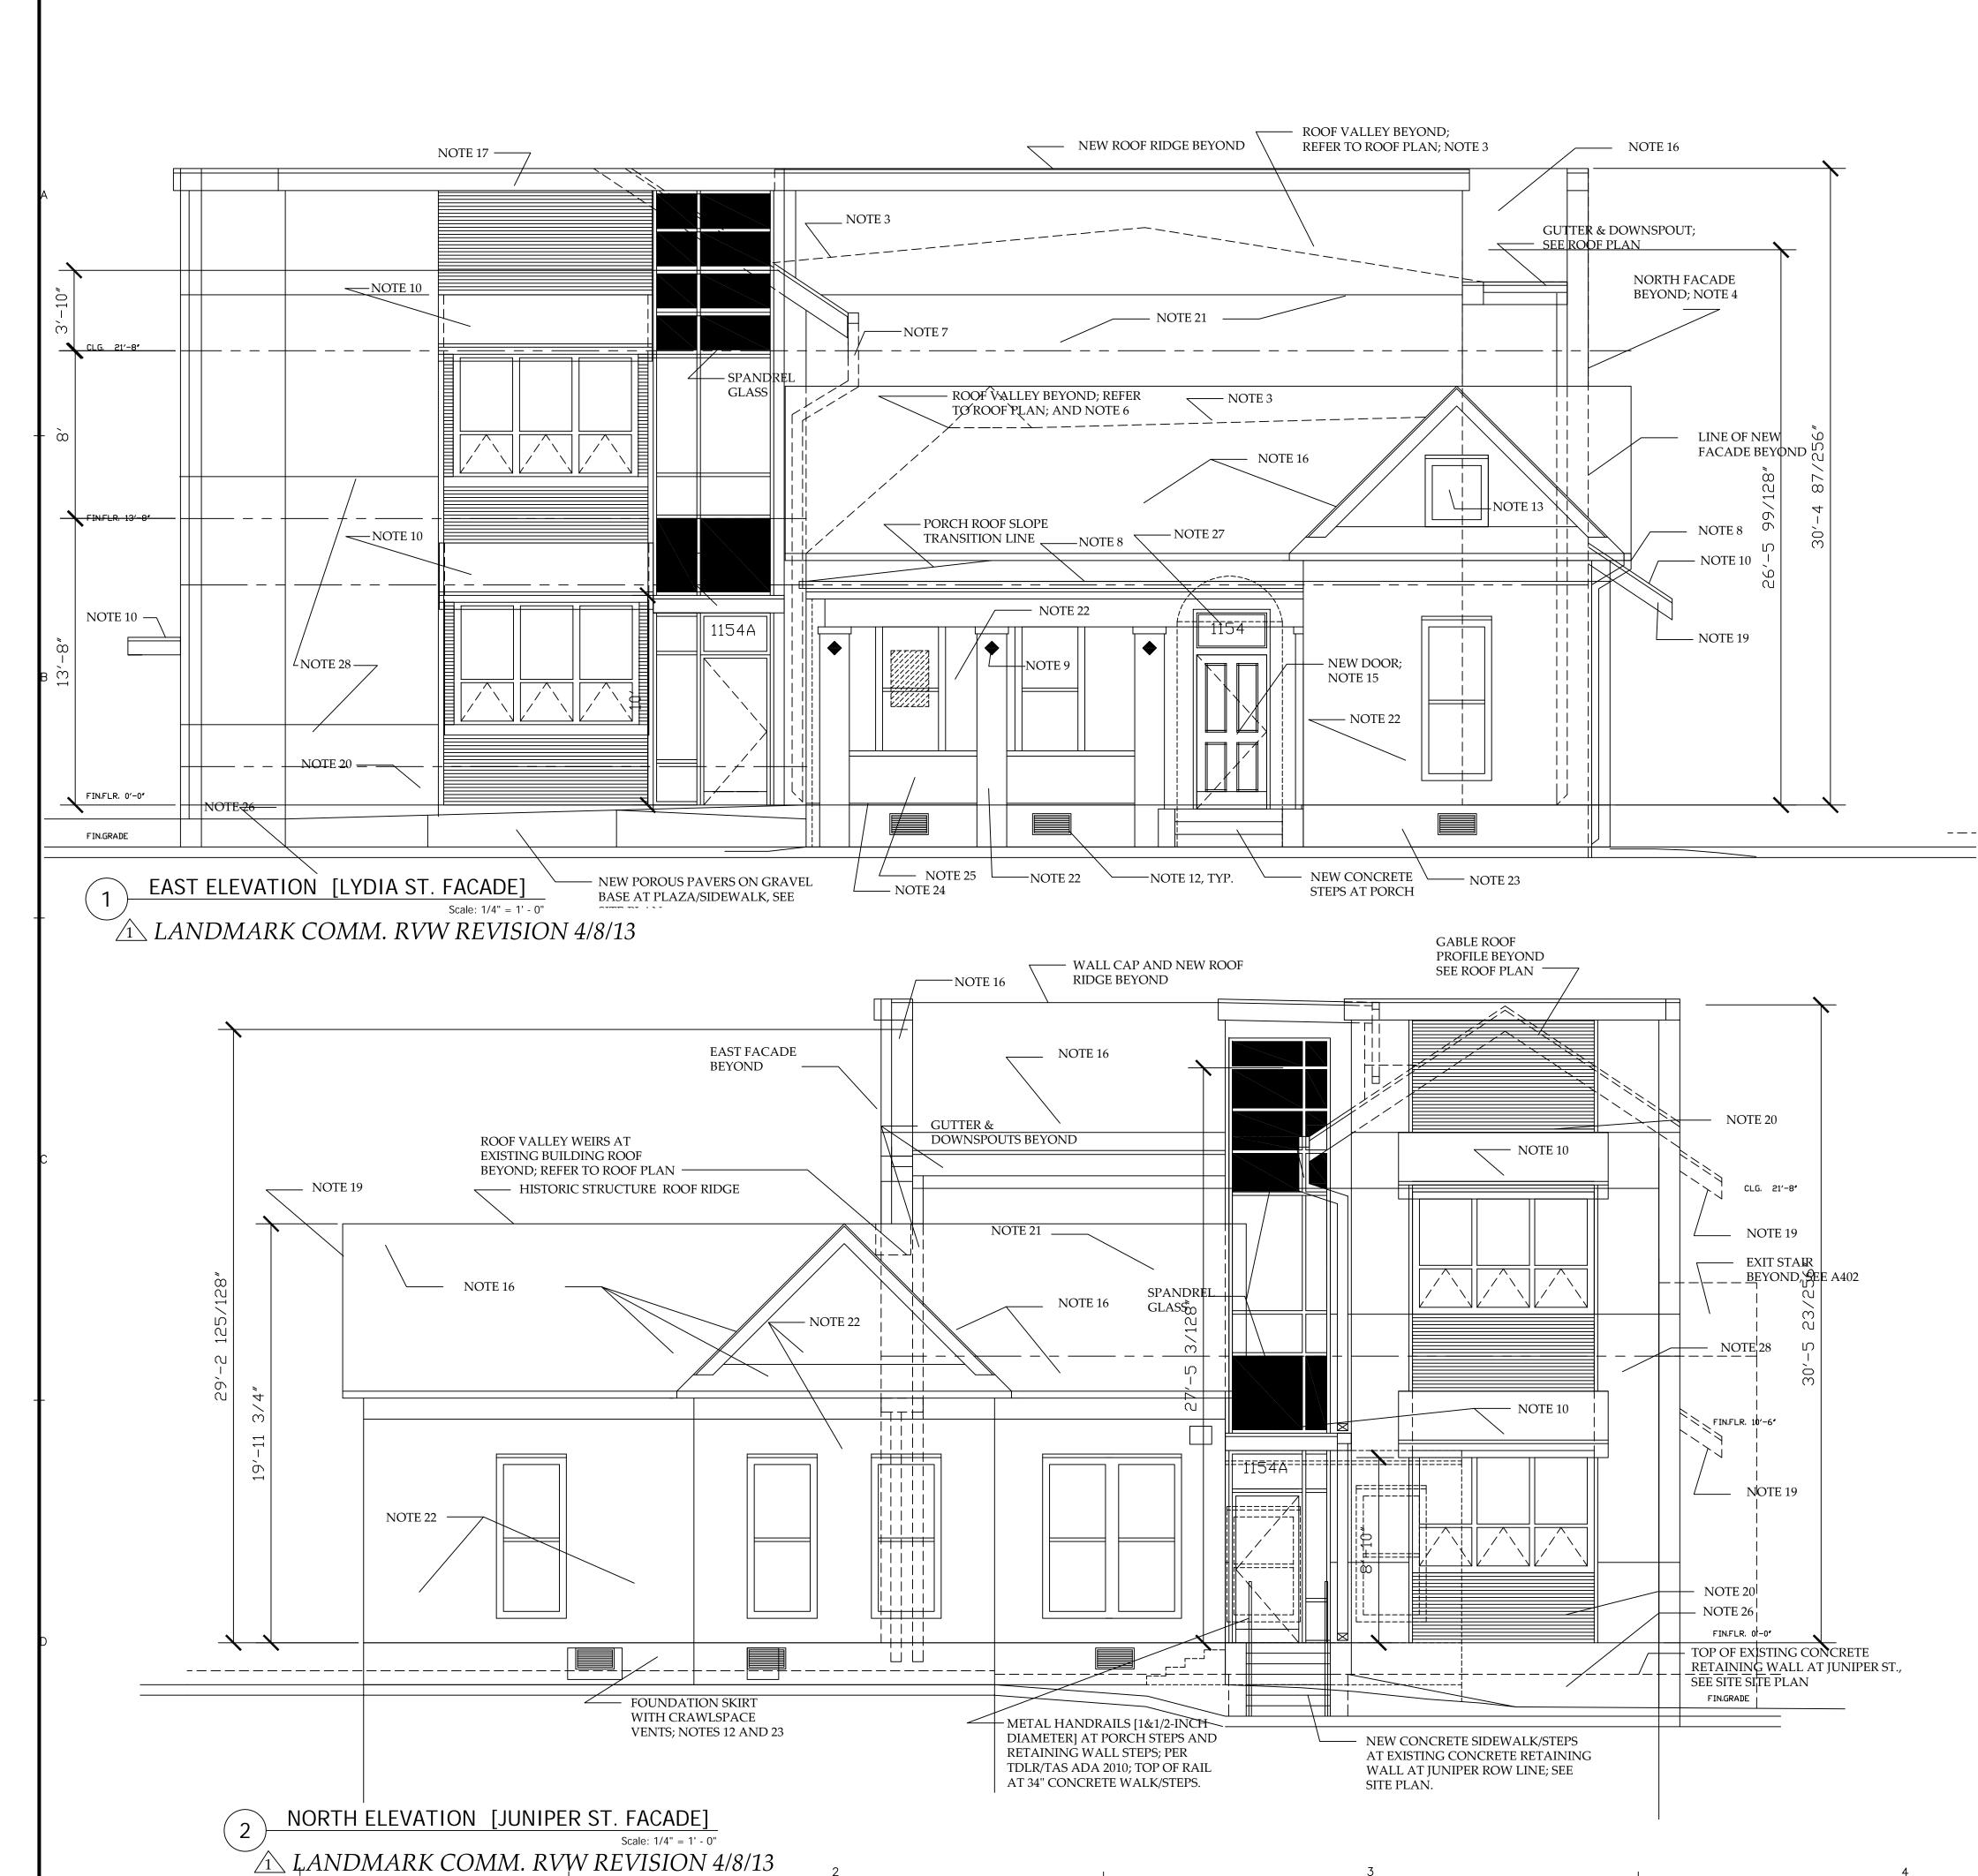

- 1. SOUTH FACADE BEYOND
- 2. BUILDING ADDITION FACADE FACING EAST; WITH SHADING CANOPY EACH FLOOR ABOVE WINDOWS.
- 3. HIDDEN ROOF LINES BEYOND; REFER TO ROOF PLAN.
- 4. TWO-STORY NORTH FACADE BEYOND.
- 5. SECONDARY GABLE ROOF BEYOND; REFER TO ROOF PLAN.
- 6. ROOF DRAINAGE LEVEL BEYOND; REFER TO ROOF PLAN FOR WEIR AND OVERFRAME ROOF SLOPE [3-PLY MBR OVER 2-INCH RIGID INSULATION].
- 7. NEW 24 GA. GALVANIZED GUTTER [6X6] WITH 6X6 DOWNSPOUT TO DISCHARGE AT SPLASHBLOCK AT FINISH GRADE. SEE ROOF PLAN.
- 8. NEW 24 GA. GALVANIZED GUTTER [4X4] WITH 4X4 DOWNSPOUT TO DISCHARGE AT SPLASHBLOCK AT FINISH GRADE. SEE ROOF PLAN.
- REINSTALL SALVAGED CERAMIC MEDALLION AT NEW PORCH COLUMNS.
- 10. BRACKET SUPPORTED SHADING CANOPY/AWNING ABOVE WINDOWS AND DOOR OPENINGS.
- 11. NEW CONCRETE STEPS AT PORCH; REPLICATE HISTORIC SCORING PATTERN AT CONCRETE FLOOR SURFACE.
- 12. NEW CRAWLSPACE VENTS; 24GA, NOMINAL 12X22-INCH SIZE; PAINTED TO MATCH WALL SURFACE.
- 13. EXISTING WOOD TRIM; REPAIR AS NECESSARY FOR ACCEPTABLE CONDITION AS APPROVED BY ARCHITECT.
- 14. NEW WINDOW AT HISTORIC STRUCTURE; REFER TO WINDOW SCHEDULE.
- 15. INSTALL SALVAGED/REPAIRED ENTRANCE DOOR, REFER TO DEMOLITION PLAN AND DOOR SCHEDULE.
- 16. COMPOSITION ASPHALT SINGLE ROOFING ON 30-LB ASPHALT FELT OVER 1/2-INCH STRUCTURAL PLYWOOD DECKING.
- 17. WOOD FASCIA & TRIM W/ 26GA. GALVANIZED METAL EDGE
- FLASHING.

  8. METAL LOUVER W/ WOOD TRIM & GALVANIZED FLASHING
- 9. WOOD FASCIA & TRIM; BOXED SOFFIT AT EAVES [3/8-INCH PERFORATED PLYWOOD].
- 0. WOOD SIDING ON MOISTURE VAPOR BARRIER ON 1/2-INCH
- SHEATHING; WOOD SIDING [2-INCH LAP PATTERN].
- . WOOD SIDING [10-INCH LAP PATTERN].
- 2. STUCCO WALL FINISH ON GALVANIZED METAL LATH ON 15-LB FELT; INSTALLED OVER EXISTING HISTORIC BUILDING FACADE TO MATCH EXISTING CONDITIONS OR AS APPROVED BY ARCHITECT.
- 3. 3/4-INCH THICK PLASTER ON GALVANIZED METAL LATH & METAL FRAMING ["FOUNDATION SKIRT"]; EXTEND TO FINISH GRADE.
- 24. MAINTAIN 2-INCH AIR GAP BELOW PORCH BALUSTRADE RAIL
- 25. NEW BALUSTRADE INCLUDING WOOD FRAMING WITH STUCCO ON LATH FINISH; SIMILAR TO EXISTING HISTORIC CONDITION.
- 26. NEW FOUNDATION GRADE BEAM [EXPOSED CONCRETE WITH GROUT -RUBBED FINISH AS APPROVED BY ARCHITECT].
- 27. 10 " HIGH METAL LETTERING/NUMERALS WITH CONCEALED ANCHORS SECURED TO BUILDING FACADE; FINAL LOCATION AS DIRECTED BY ARCHITECT.
- 28. STUCCO WALL FINISH ON GALVANIZED METAL LATH ON 15-LB FELT; INSTALLED OVER BLDG WRAP "TYVEK" OVER 1/2-INCH THICK EXTERIOR SHEATHING. PROVIDE EXPANSION AND CONTROL JOINTS AS REQUIRED AND STIPULATED BY PRODUCT MANUFACTURER.

EXISTING FAÇAD	E REPAIR/REPLA	CEME	NT SCHED	ULE						
COMPONENT	MATERIAL	UNIT	Existing Qty		SPECIFIE	D MINIMU	M % REP	LACEMENT		REMARKS
				N	E	s	w	Porch N Wall	Porch W Wall	
EAVE SOFFIT	1/2-inch plywood	SF	301	84	80	84	53			
FASCIA BOARD	1x10 wood	LF	226	32	30	19	15	10	15	
FASCIA TRIM	1x4 wood [O.G.]	LF	226	32	30	32	15	10	30	Match existing O.G. profile
WINDOW TRIM:										
Head Cornice Trim	1x3 wood	LF	65	20	15	20	5	5		Match existing trim profile
Head	1x4 wood	LF	65	20	15	20	5	5		
Jamb	1x4 wood	LF	247	38	29	29	10	19		
Sill	2x8 wood [treated]	LF	65	20	15	20	5	5		Match existing size & profile
Sill Apron Trim	1x4 wood	LF	65	20	15	20	5	5		
GABLE FAÇADE PANEL	1/2-inch plywood & 1x4 trim	SF			10					Match existing trim profile
WINDOW SCREEN	Wood frame, aluminum insect screen	EACH		4	3	3	1			Match existing size

Herman Schieffer House "East Room" 1154 Lydia Stransin, Texas, Relocation, Rehabilitation Ph II

PARSHALL + ASSOCIATES ARCHITE

PROJECT#:

PAA\_2010.003

CHECKED BY:

CHECKED BY:


EXTERIOR ELEV.


PROJECT#:

CDS PAA\_2010.0

DWG. FILE:

A201

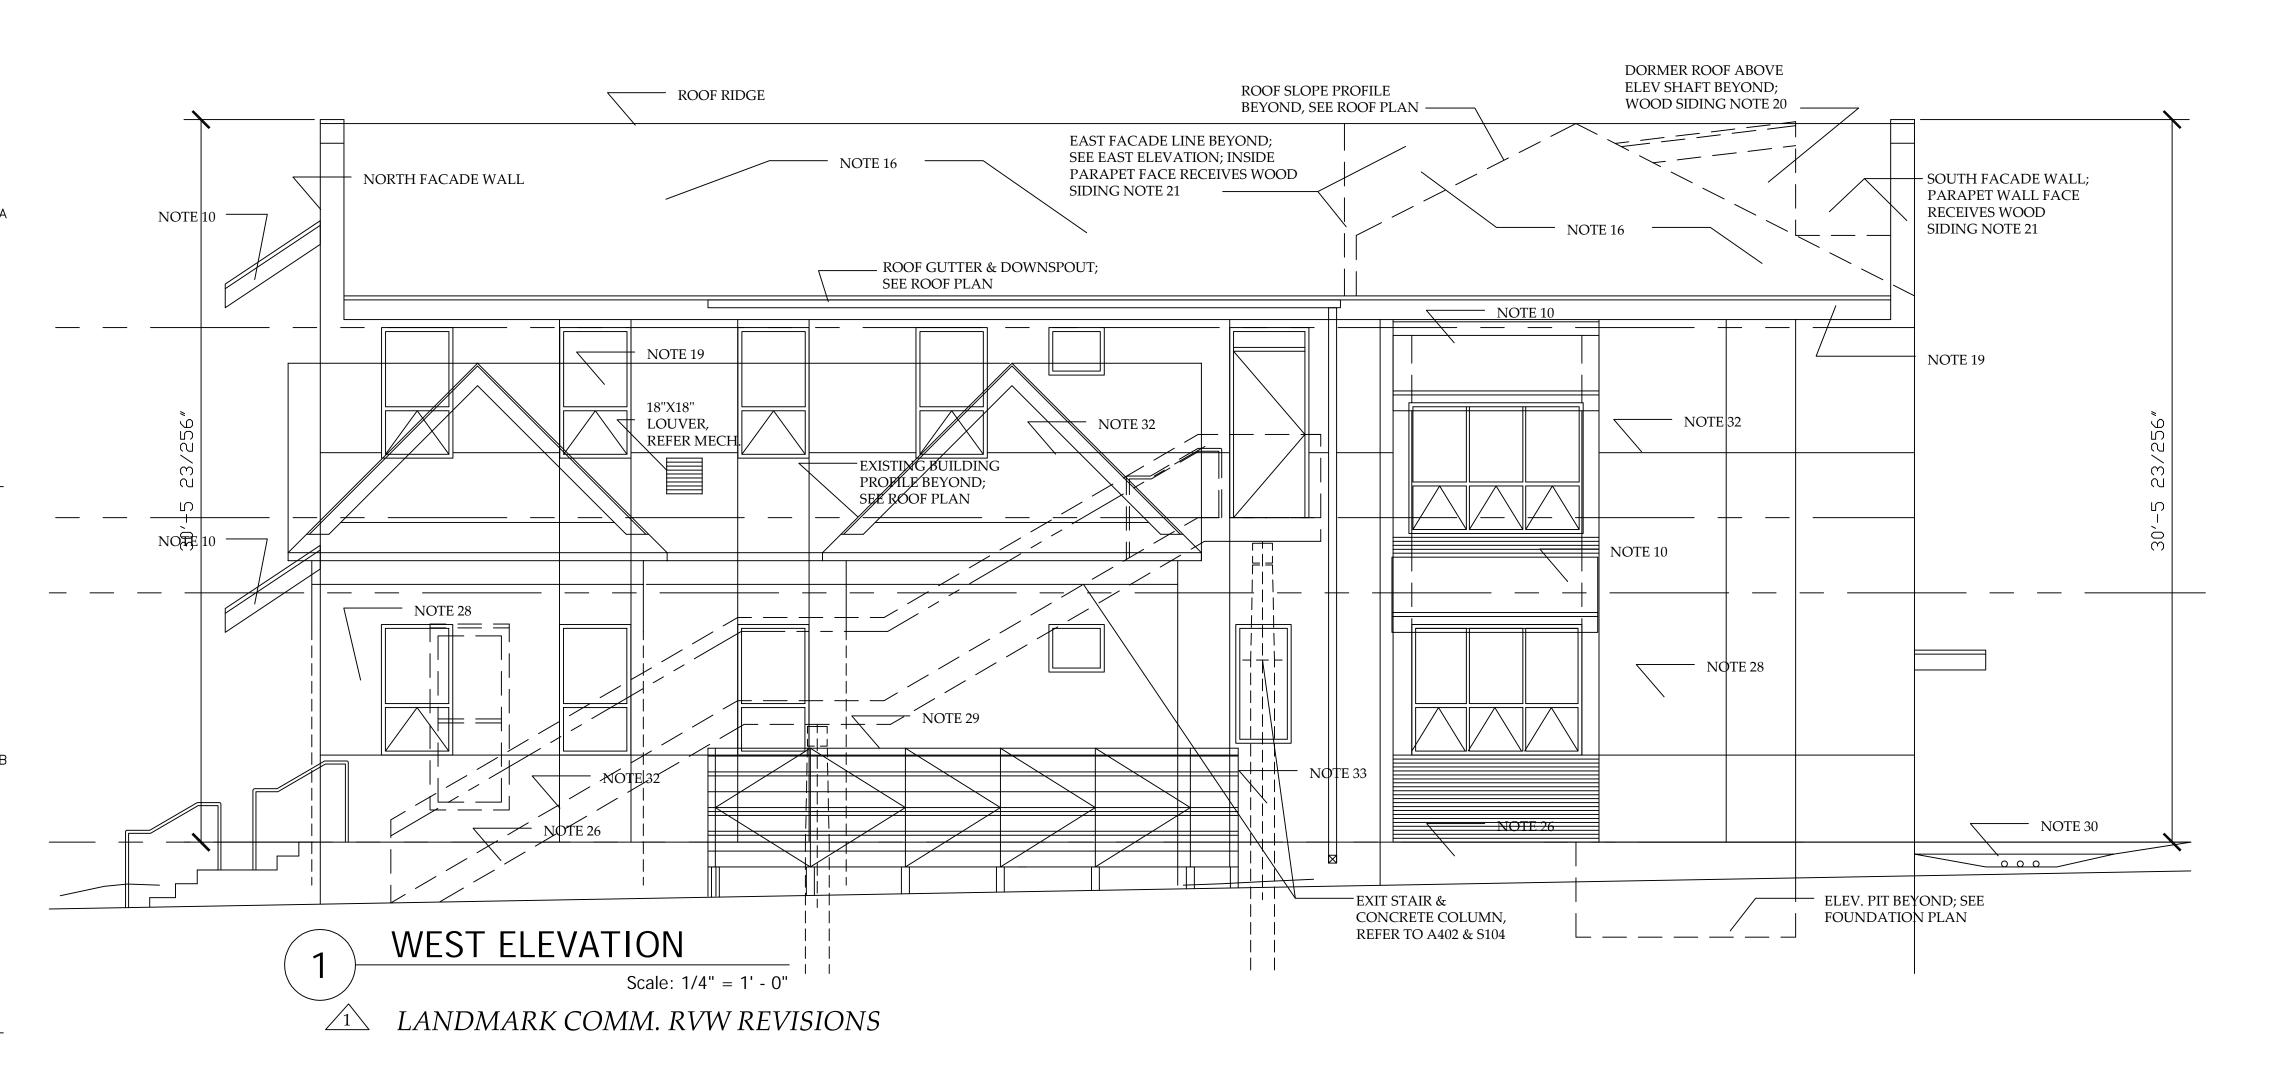

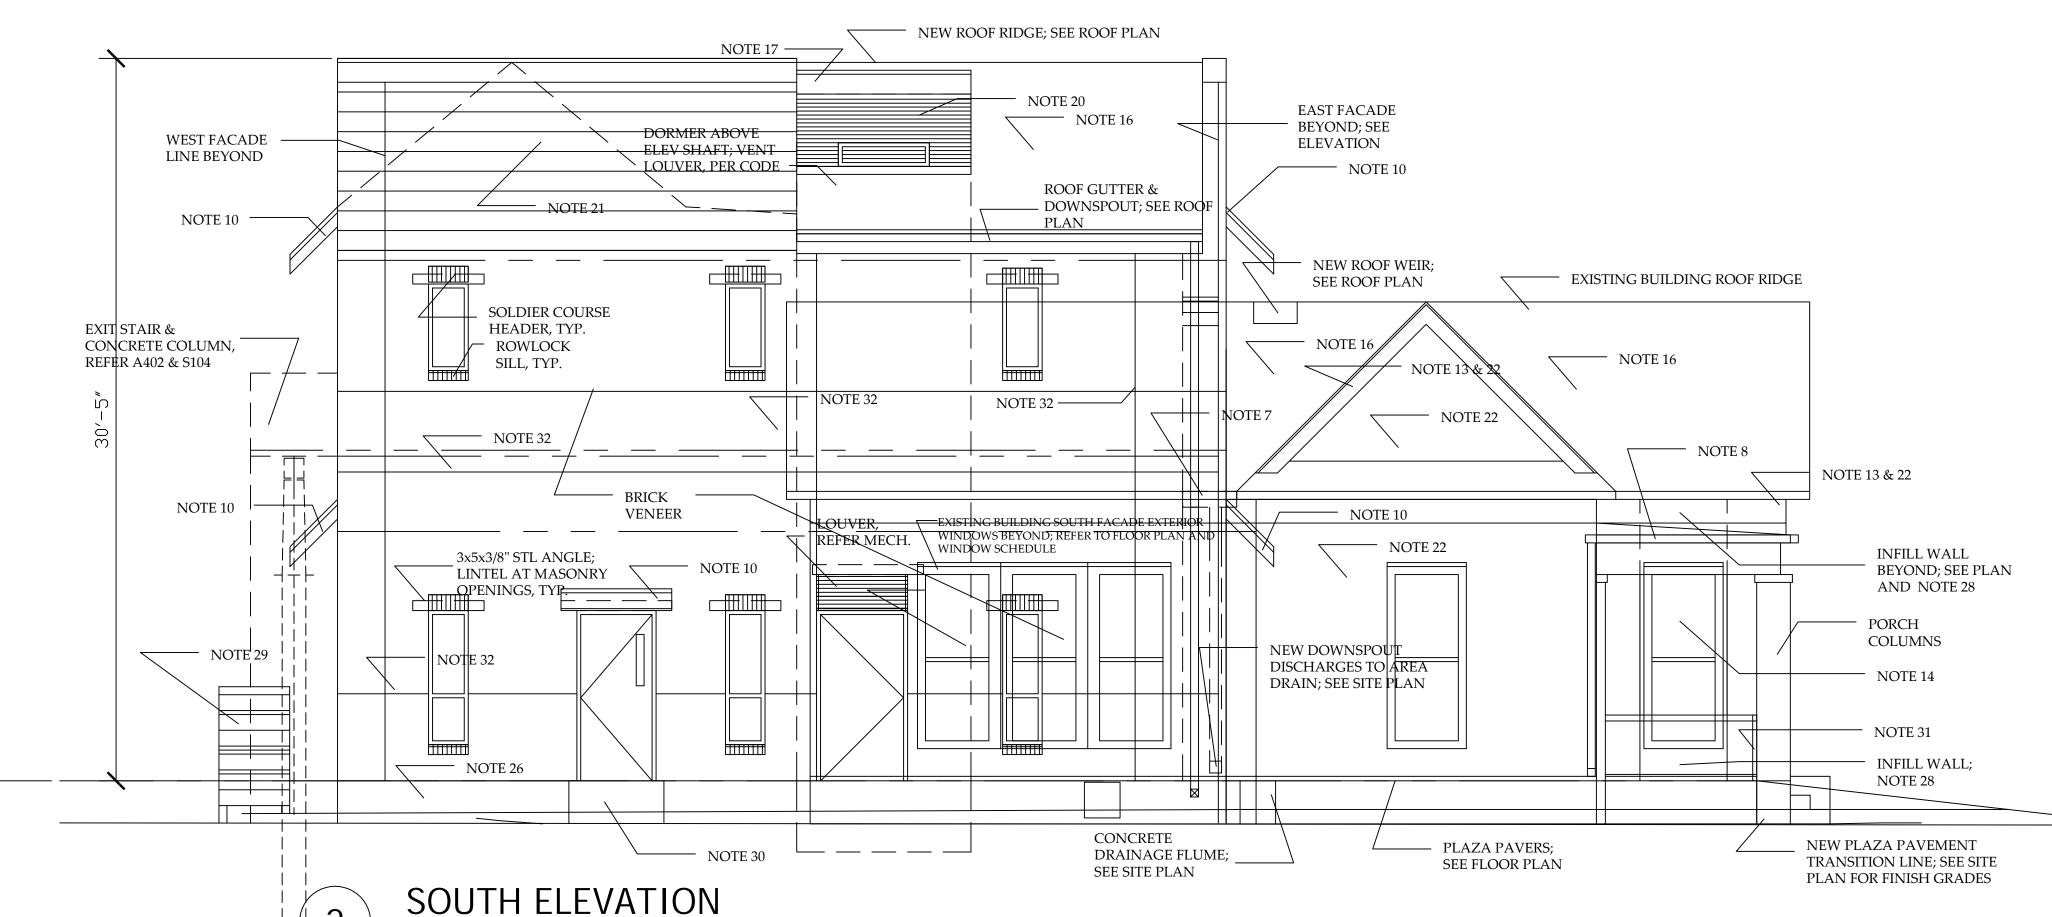

Scale: 1/4" = 1' - 0"

LANDMARK COMM. RVW REVISIONS

## **GENERAL NOTES:**

- 1. SOUTH DORMER GABLE BEYOND
- 2. BUILDING ADDITION GABLE FACING EAST; WITH SHADING CANOPY EACH FLOOR ABOVE WINDOWS.
- R HIDDEN ROOF I INES REVOND: REFER TO ROOF PLAN
- 3. HIDDEN ROOF LINES BEYOND; REFER TO ROOF PLAN.
- TWO-STORY NORTH FACADE GABLE BEYOND.
  SECONDARY GABLE ROOF BEYOND; REFER TO ROOF PLAN.
- 6. ROOF DRAINAGE LEVEL BEYOND; REFER TO ROOF PLAN FOR WEIR AND OVERFRAME ROOF SLOPE [3-PLY MBR OVER 2-INCH RIGID INSULATION].
- 7. NEW 24 GA. GALVANIZED GUTTER [6X6] WITH 6X6 DOWNSPOUT TO DISCHARGE AT SPLASHBLOCK AT FINISH GRADE. SEE ROOF PLAN
- 8. NEW 24 GA. GALVANIZED GUTTER [4X4] WITH 4X4 DOWNSPOUT TO DISCHARGE AT SPLASHBLOCK AT FINISH GRADE. SEE ROOF PLAN
- P. REINSTALL SALVAGED CERAMIC MEDALLION AT NEW PORCH COLUMNS.
- 10. BRACKET SUPPORTED SHADING CANOPY/AWNING ABOVE WINDOWS AND DOOR OPENINGS.
- 11. NEW CONCRETE STEPS AT PORCH; REPLICATE HISTORIC SCORING PATTERN AT CONCRETE FLOOR SURFACE.
- 12. NEW CRAWLSPACE VENTS; 24GA, NOMINAL 12X22-INCH SIZE; PAINTED TO MATCH WALL SURFACE.
- 13. EXISTING WOOD TRIM; REPAIR AS NECESSARY FOR ACCEPTABLE CONDITION AS APPROVED BY ARCHITECT.
- 14. NEW WINDOW AT HISTORIC STRUCTURE; REFER TO WINDOW SCHEDULE.
- 15. INSTALL SALVAGED/REPAIRED ENTRANCE DOOR, REFER TO DEMOLITION PLAN AND DOOR SCHEDULE.
- 16. COMPOSITION ASPHALT SINGLE ROOFING ON 30-LB ASPHALT FELT OVER 1/2-INCH STRUCTURAL PLYWOOD DECKING.
- 17. WOOD FASCIA & TRIM W/ 26GA. GALVANIZED METAL EDGE FLASHING.
- 8. METAL LOUVER W/ WOOD TRIM & GALVANIZED FLASHING
- 19. WOOD FASCIA & TRIM; BOXED SOFFIT AT EAVES [3/8-INCH
- PERFORATED PLYWOOD].
- 20. WOOD SIDING ON MOISTURE VAPOR BARRIER ON 1/2-INCH SHEATHING; WOOD SIDING [2-INCH LAP PATTERN].
- WOOD SIDING [10-INCH LAP PATTERN].
- 22. STUCCO WALL FINISH ON GALVANIZED METAL LATH ON 15-LB FELT; INSTALLED OVER EXISTING HISTORIC BUILDING FACADE TO MATCH EXISTING CONDITIONS OR AS APPROVED BY ARCHITECT.
- 23. 3/4-INCH THICK PLASTER ON GALVANIZED METAL LATH & METAL FRAMING ["FOUNDATION SKIRT"]: EXTEND TO FINISH GRADE.
- FRAMING ["FOUNDATION SKIRT"]; EXTEND TO FINISH GRADE.

  MAINTAIN 2-INCH AIR GAP BELOW PORCH BALUSTRADE RAIL.
- 25. NEW BALUSTRADE INCLUDING WOOD FRAMING WITH STUCCO
- ON LATH FINISH; SIMILAR TO EXISTING HISTORIC CONDITION.
  26. NEW FOUNDATION GRADE BEAM [EXPOSED CONCRETE WITH
- GROUT -RUBBED FINISH AS APPROVED BY ARCHITECT].

  10" HIGH METAL LETTERING/NUMERALS WITH CONCEALED
- ANCHORS SECURED TO BUILDING FACADE; FINAL LOCATION AS DIRECTED BY ARCHITECT.

  28. STUCCO WALL FINISH ON GALVANIZED METAL LATH ON 15-LB
- FELT; INSTALLED OVER BLDG WRAP "TYVEK" OVER 1/2-INCH
  THICK EXTERIOR SHEATHING. PROVIDE EXPANSION AND
  CONTROL JOINTS AS REQUIRED AND STIPULATED BY PRODUCT
  MANUFACTURER..
- 29. WOOD FENCE SCREEN WITH FIVE (5) GATES AT A/C EQUIPMENT; 5-FT HIGH, HORIZONTAL FENCE FABRIC PATTERN [including 1x6s, 1x4s, and 1x2s on 4x4 treated wood posts; see floor plan and Dwg 2/A305].
- 30. NEW CONCRETE LANDING AT ENTRY DOOR; LANDING TO RECEIVE THREE (3) SIX-INCH DIAMETER PVC SLEEVES AT DRAINAGE SWALE; SEE SITE PLAN.
- 31. CONSTRUCT BALUSTRADE PILASTER AT NEW OPENING AT SOUTH EDGE OF PORCH; MATCH ADJACENT BALUSTRADE SIZES AND PATTERN AS APPROVED BY THE ARCHITECT.
- 32. CONTROL JOINT IN STUCCO OR BRICK VENEER WALL FINISH; LAYOUT AND SPACING AS RECOMMENDED BY MANUFACTURER AND AS APPROVED BY ARCHITECT.
- 33. EXTERIOR STAIR SUPPORT CONCRETE COLUMNS, SEE A402 & S104.

EXISTING FAÇAL	E REPAIR/REPLA	CEME	NT SCHED	ULE						
COMPONENT	MATERIAL	UNIT	Existing Qty		SPECIFIEI	) MINIMU	IM % REP	LACEMENT		REMARKS
				N	E	S	w	Porch N Wall	Porch W Wall	
EAVE SOFFIT	1/2-inch plywood	SF	301	84	80	84	53			
FASCIA BOARD	1x10 wood	LF	226	32	30	19	15	10	15	
FASCIA TRIM	1x4 wood [O.G.]	LF	226	32	30	32	15	10	30	Match existing O.G. profile
WINDOW TRIM:										
Head Cornice Trim	1x3 wood	LF	65	20	15	20	5	5		Match existing trim profile
Head	1x4 wood	LF	65	20	15	20	5	5		
Jamb	1x4 wood	LF	247	38	29	29	10	19		
Sill	2x8 wood [treated]	LF	65	20	15	20	5	5		Match existing size & profile
Sill Apron Trim	1x4 wood	LF	65	20	15	20	5	5		
GABLE FAÇADE PANEL	1/2-inch plywood & 1x4 trim	SF			10					Match existing trim profile
WINDOW SCREEN	Wood frame, aluminum insect screen	EACH		4	3	3	1			Match existing size

Herman Scl
Austin
PARSH
4210 A

TONS

TONS

TONS

1 5/6/13 LANDMARK COMM RVW REVISION


CHECKED BY:

TERIOR ELEVATIONS


PROJECT#: DRAWN BY:
PAA\_2010.003 JCP

A202

EX

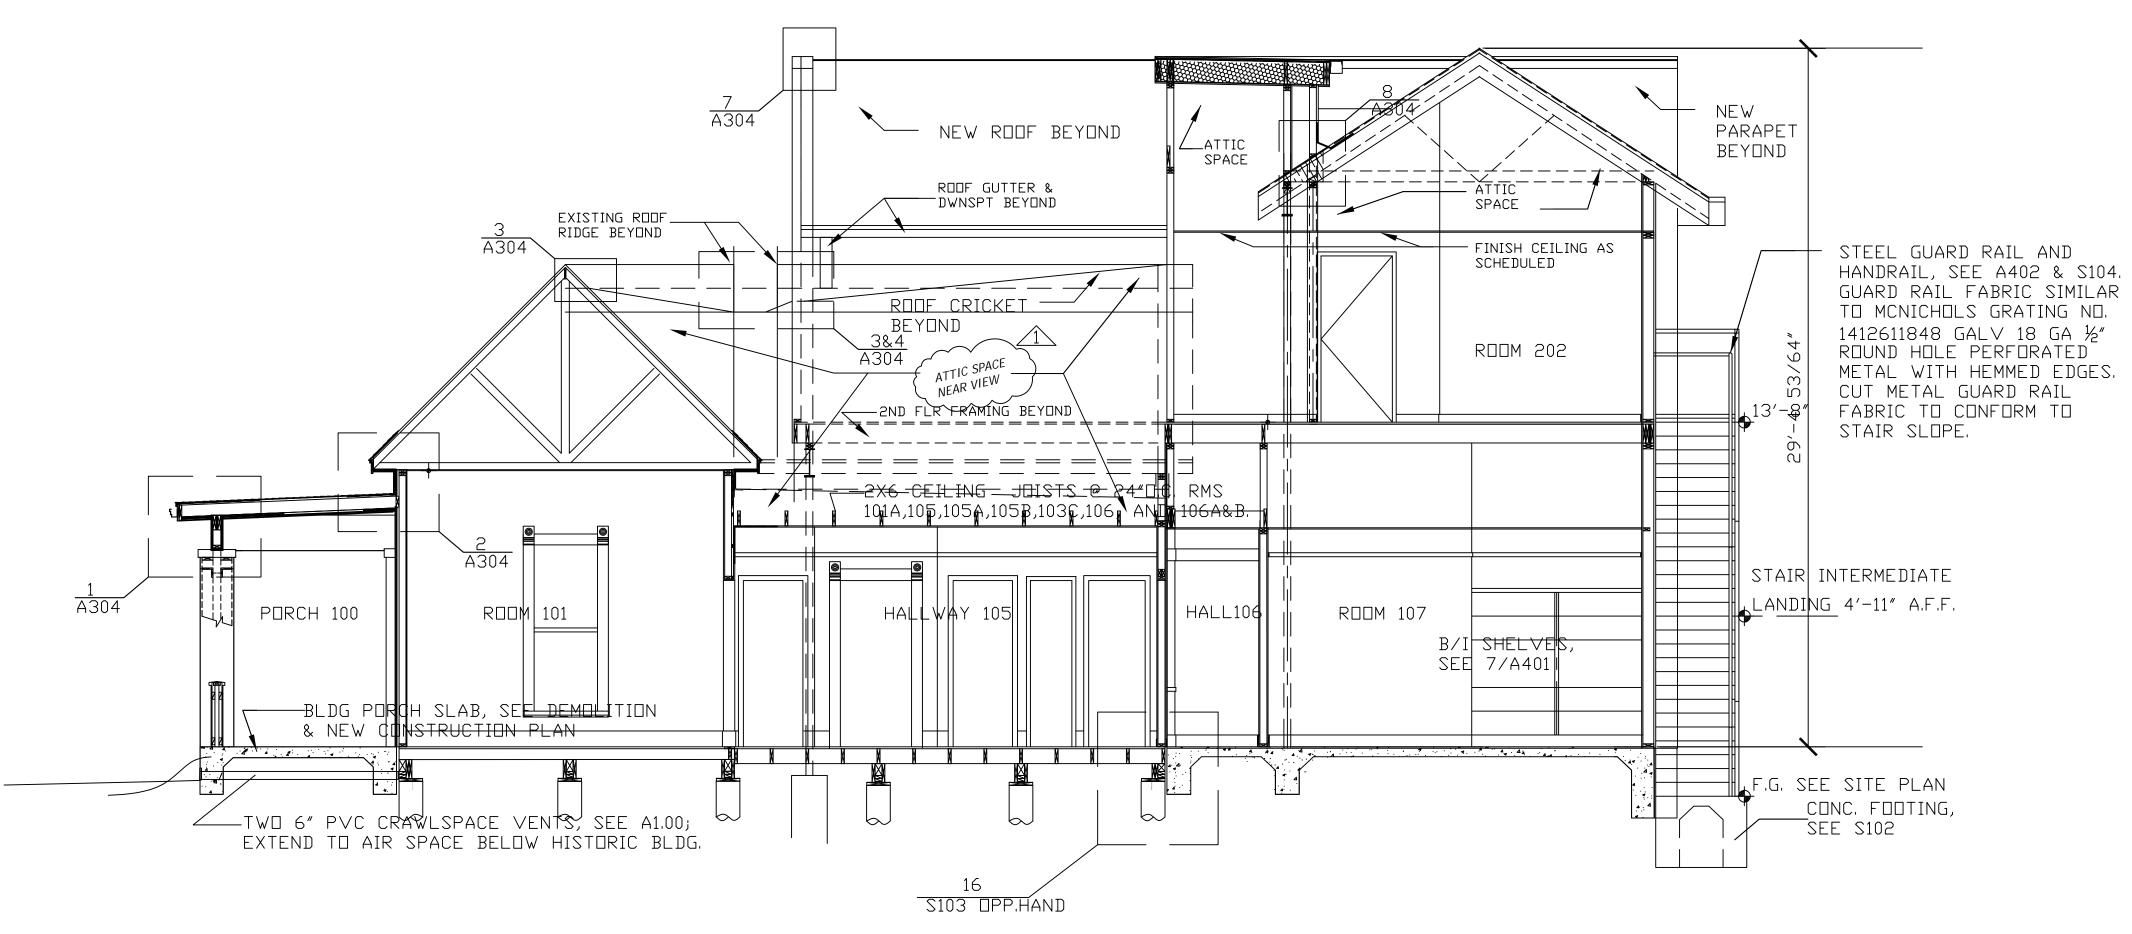

## BUILDING SECTION [View Looking South]

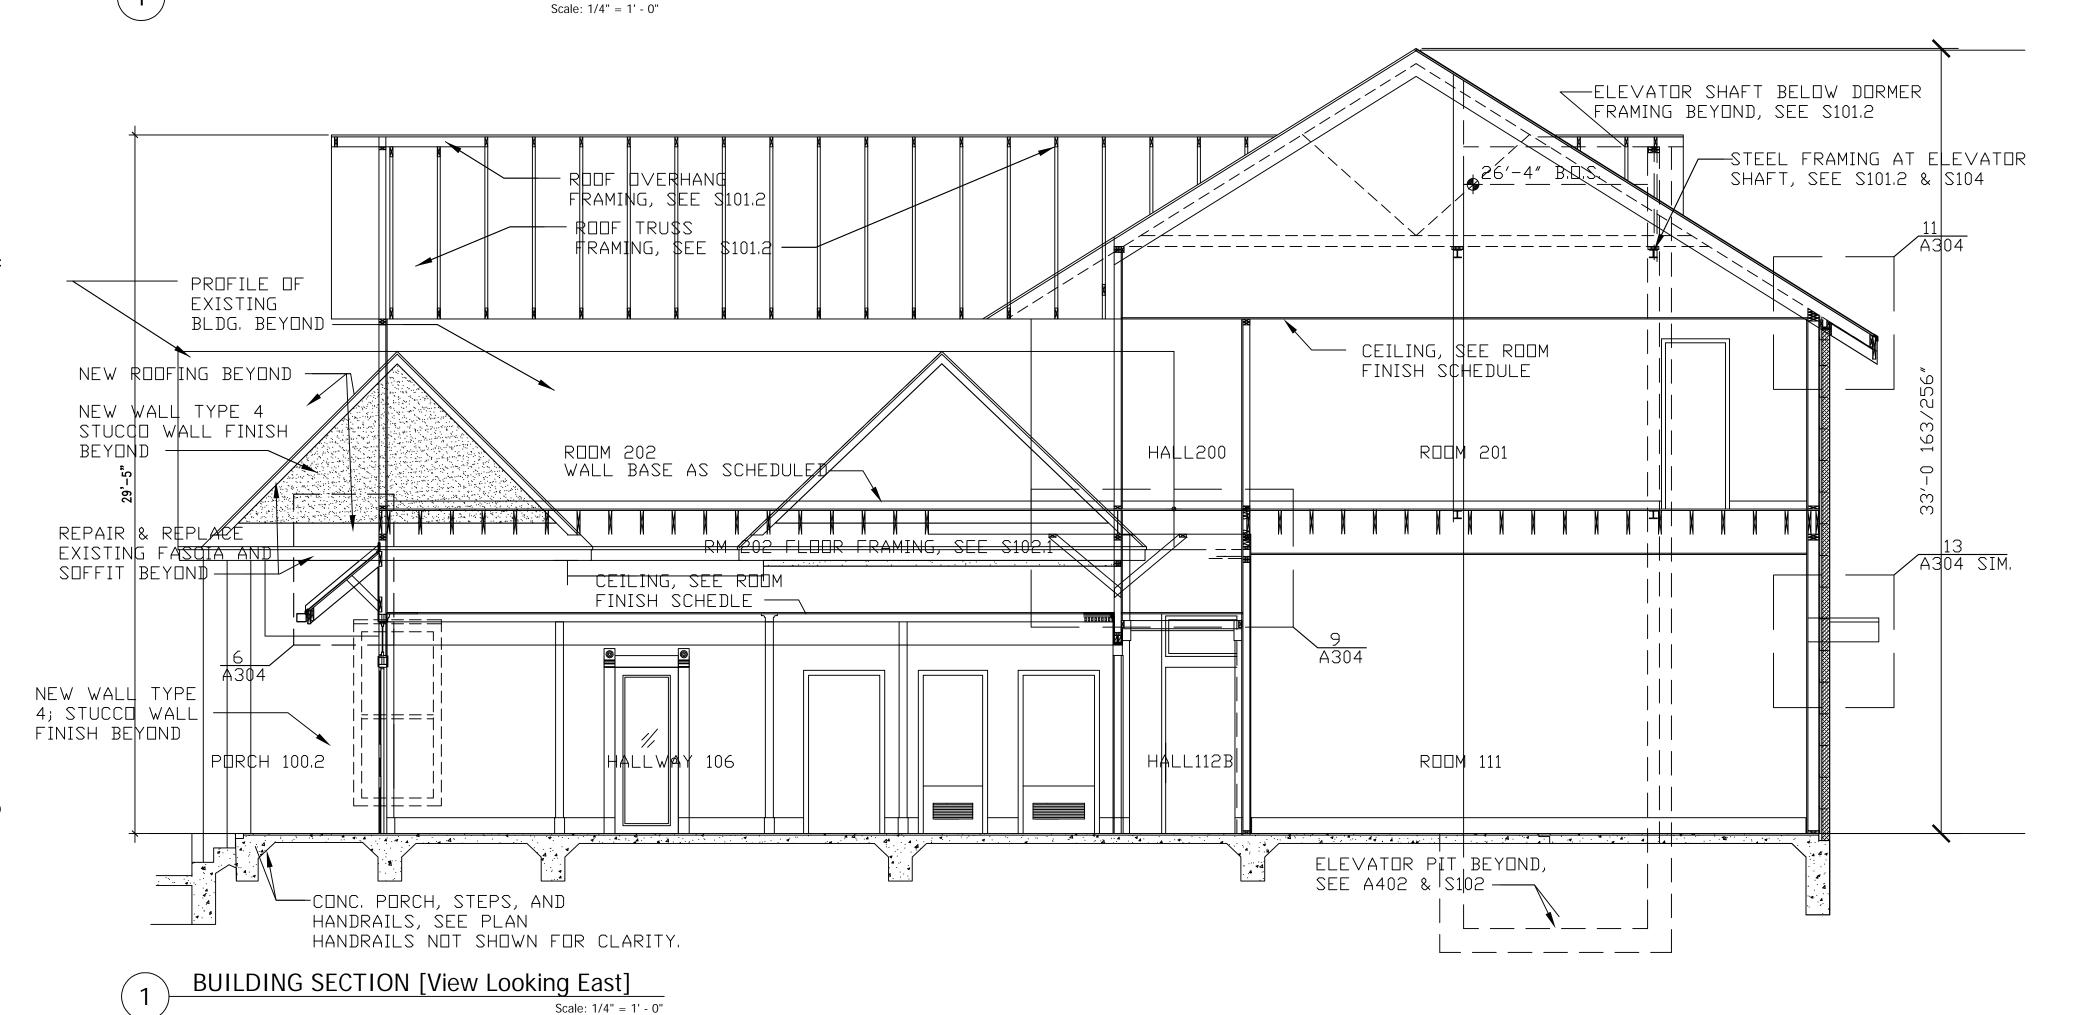

## GENERAL NOTES:

- 1. REFER TO STRUCTURAL DWGS FOR ROOF AND FLOOR FRAMING SPECIFICATIONS.
- 2. REFER TO FINISH SCHEDULE FOR FLOOR, WALL, AND CEILING FINISHES.

AUSTIN REVITALIZATION AUTHORITY
Herman Schieffer House "East Room" 1154 Lydia Street,
Austin, Texas, Relocation, Rehabilitation Ph II

PARSHALL + ASSOCIATES ARCHITFCT



		С	_
	REVISION   DATE	DATE	DESCRIPTION
のフ	$\leftarrow$	5/6/13	5/6/13 LANDMARK COMM RVW REVISION
BY:			
A.O			
ED BY:			

T#: | DRAWN BY: JCP | JC

BUILDING SECTION PROJECT#: DR PAA\_2010.003 DR

ISSUE:
CDs
PROJECT;
PAA.
DATE:
DATE:
A30

A300