

SITE PLAN 1"= 10'-0" (22x34), 1"= 20'-0" (11x17)

RESIDENTIAL DESIGN STANDARDS AS THEY APPLY TO THIS PROJECT

3.2 PROPOSED EXIT DOORS FOR THE ADDITION WILL MATCH EXISTING BACK DOOR (TO BE REMOVED) EXCEPT IT WILL CONTAIN GLASS. 1.2 NO MODIFICATIONS TO THE EXISTING FACADE ARE PROPOSED, WITH THE EXCEPTION OF REMOVAL OF WINDOW UNITS, AND ALL ELEMENTS SUCH AS SIDING, TRIM, DOOR AND WINDOW STYLE, ROOF EDGE DETAILS, ETC. WILL MATCH EXISTING. 3.1 THE FRONT OF THE HOUSE WILL REMAIN UNCHANGED.

3.3 NO ORIGINAL WINDOWS FACING THE STREET OR SIDES OF THE HOUSE ARE PROPOSED TO BE REMOVED. NEW WINDOWS SHALL MATCH EXISTING.

4.4 ADDITION WILL HAVE SAME FLOOR TO CEILING HEIGHT.

3.5 NEW ROOF MATERIAL AND PITCH SHALL MATCH EXISTING.

SITE INFORMATION
SOUTH 60' OF LOT 54, SHADOW LAWN ZONING: SF-3-H-HD-NCCD-NP
LOT SF: 8,220 SF

DUPLEX TOTAL:

GARAGE

ADDITION:

PROPOSED BUILDING COVERAGE: 2,198 SF

BUILDING COVERAGE: 2,198 / 8,220 = 26.7%

MAXIMUM BUILDING COVERAGE

40% OR 3,288 SF

MAXIMUM IMPERVIOUS COVERAGE

MAXIMUM F.A.R.	IMPERVIOUS COVER: 2,414/8,220 = 29%	TOTAL:	AC PADS:	BACK STEPS (24+30=54 SF):	FRONT PORCH:	FRONT SIDEWALK:	DIRT DRIVEWAY:	GARAGE	DUPLEX TOTAL:	45% OR 3,699 SF
	= 29%	2,414 SF	18 SF	54 SF	76 SF	68 SF	- SF	393 SF	1,805 SF	

LIST OF DRAWINGS

DUPLEX:
ADDITION:
GARAGE
GARAGE EXEMPTION:
TOTAL:
AREA: 1,748 / 8,220 = 0

40% OR 3,288 SF

ARCHITECTURAL
G1.1 COVER SHEET & SITE PLAN
AD1.1 DEMOLITION PLAN
A1.1 FLOOR PLAN
A1.2 CEILING PLAN
A1.3 ROOF PLAN
A2.1 EXTERIOR & INTERIOR ELEVATIONS

ARCHITECT

STRUCTURAL
S-1 FOUNDATION AND ROOF FRAMING PLANS

BISHOP ARCHITECTS 5300 MAGDELENA DRIVE AUSTIN, TEXAS 78735 JAMES V. RYAN STRUCTURAL ENGINEERING 5428 SCHERTZ ROAD SAN ANTONIO, TEXAS 78233 STRUCTURAL

PHONE: 210-599-7484

CONSULTANT INFORMATION

OWNER MAULIK PANDYA 9908 CHARTHOUSE COVE AUSTIN, TEXAS 78730

PHONE: 512-342-2767 CONTACT: MAULIK PANDYA


PHONE: 512-653-1467

COVER SHEET & SITE PLAN

CONTACT: JAMES RYAN





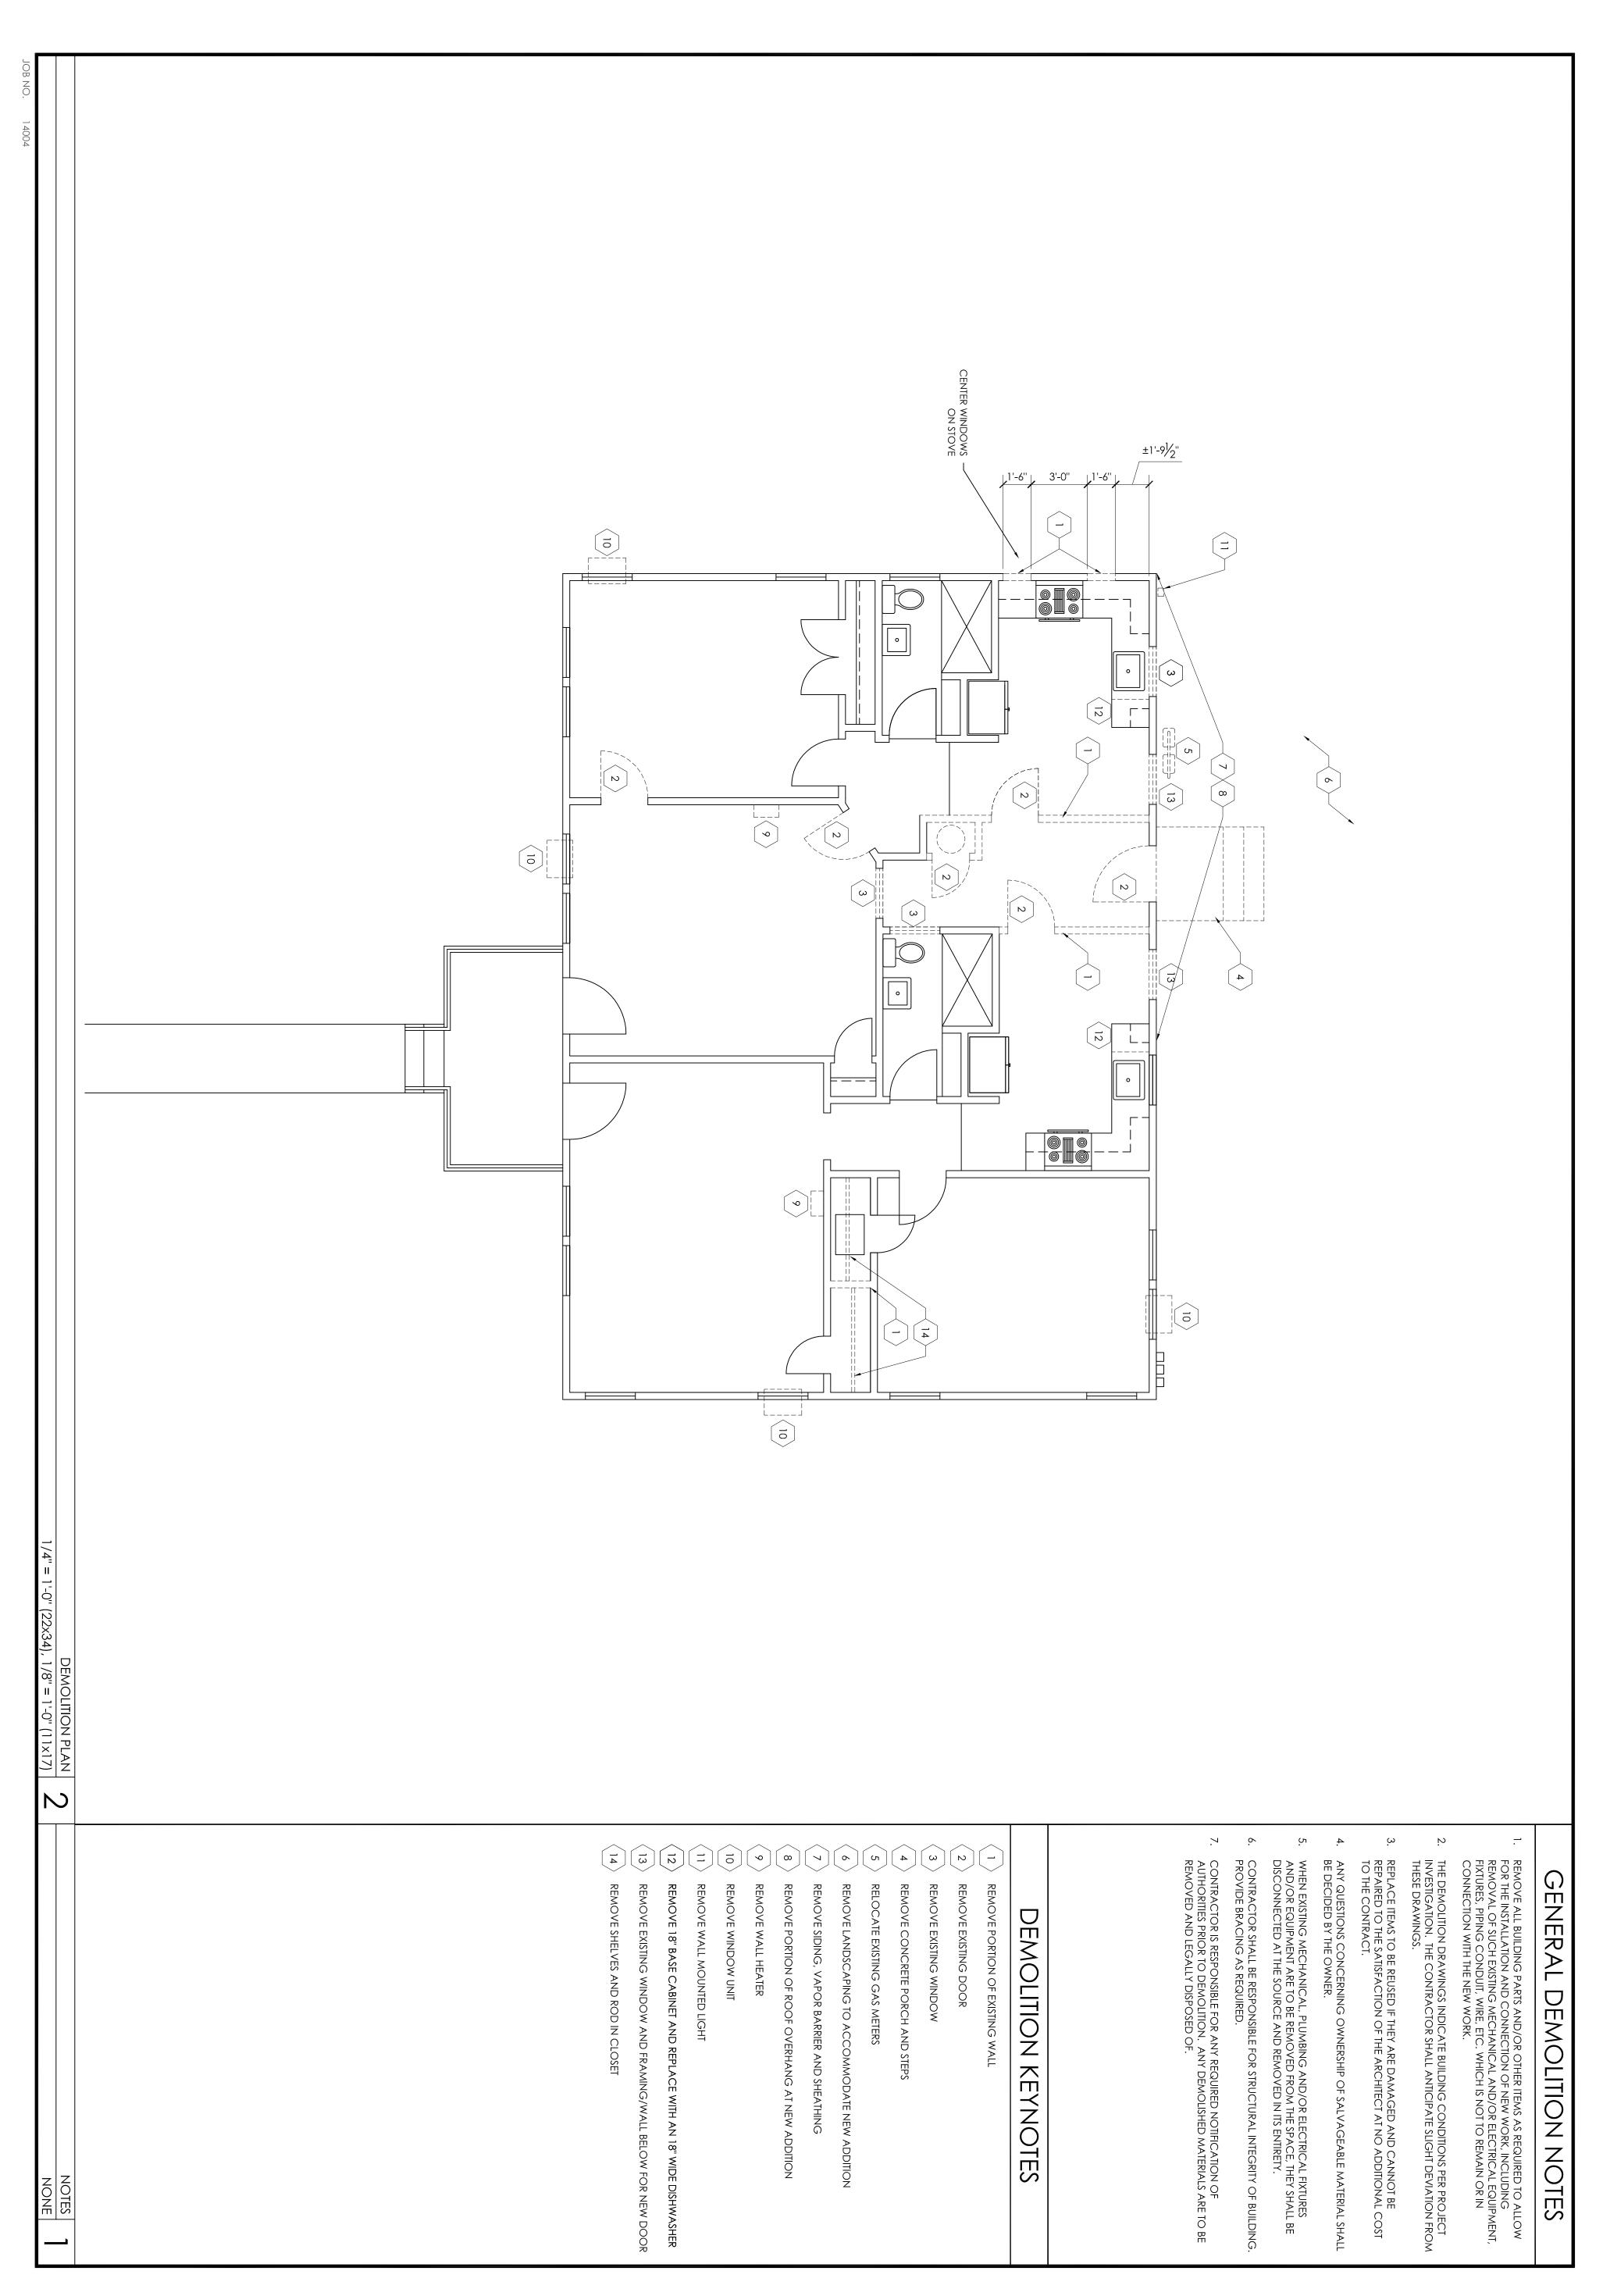






DEMOLITION PLAN



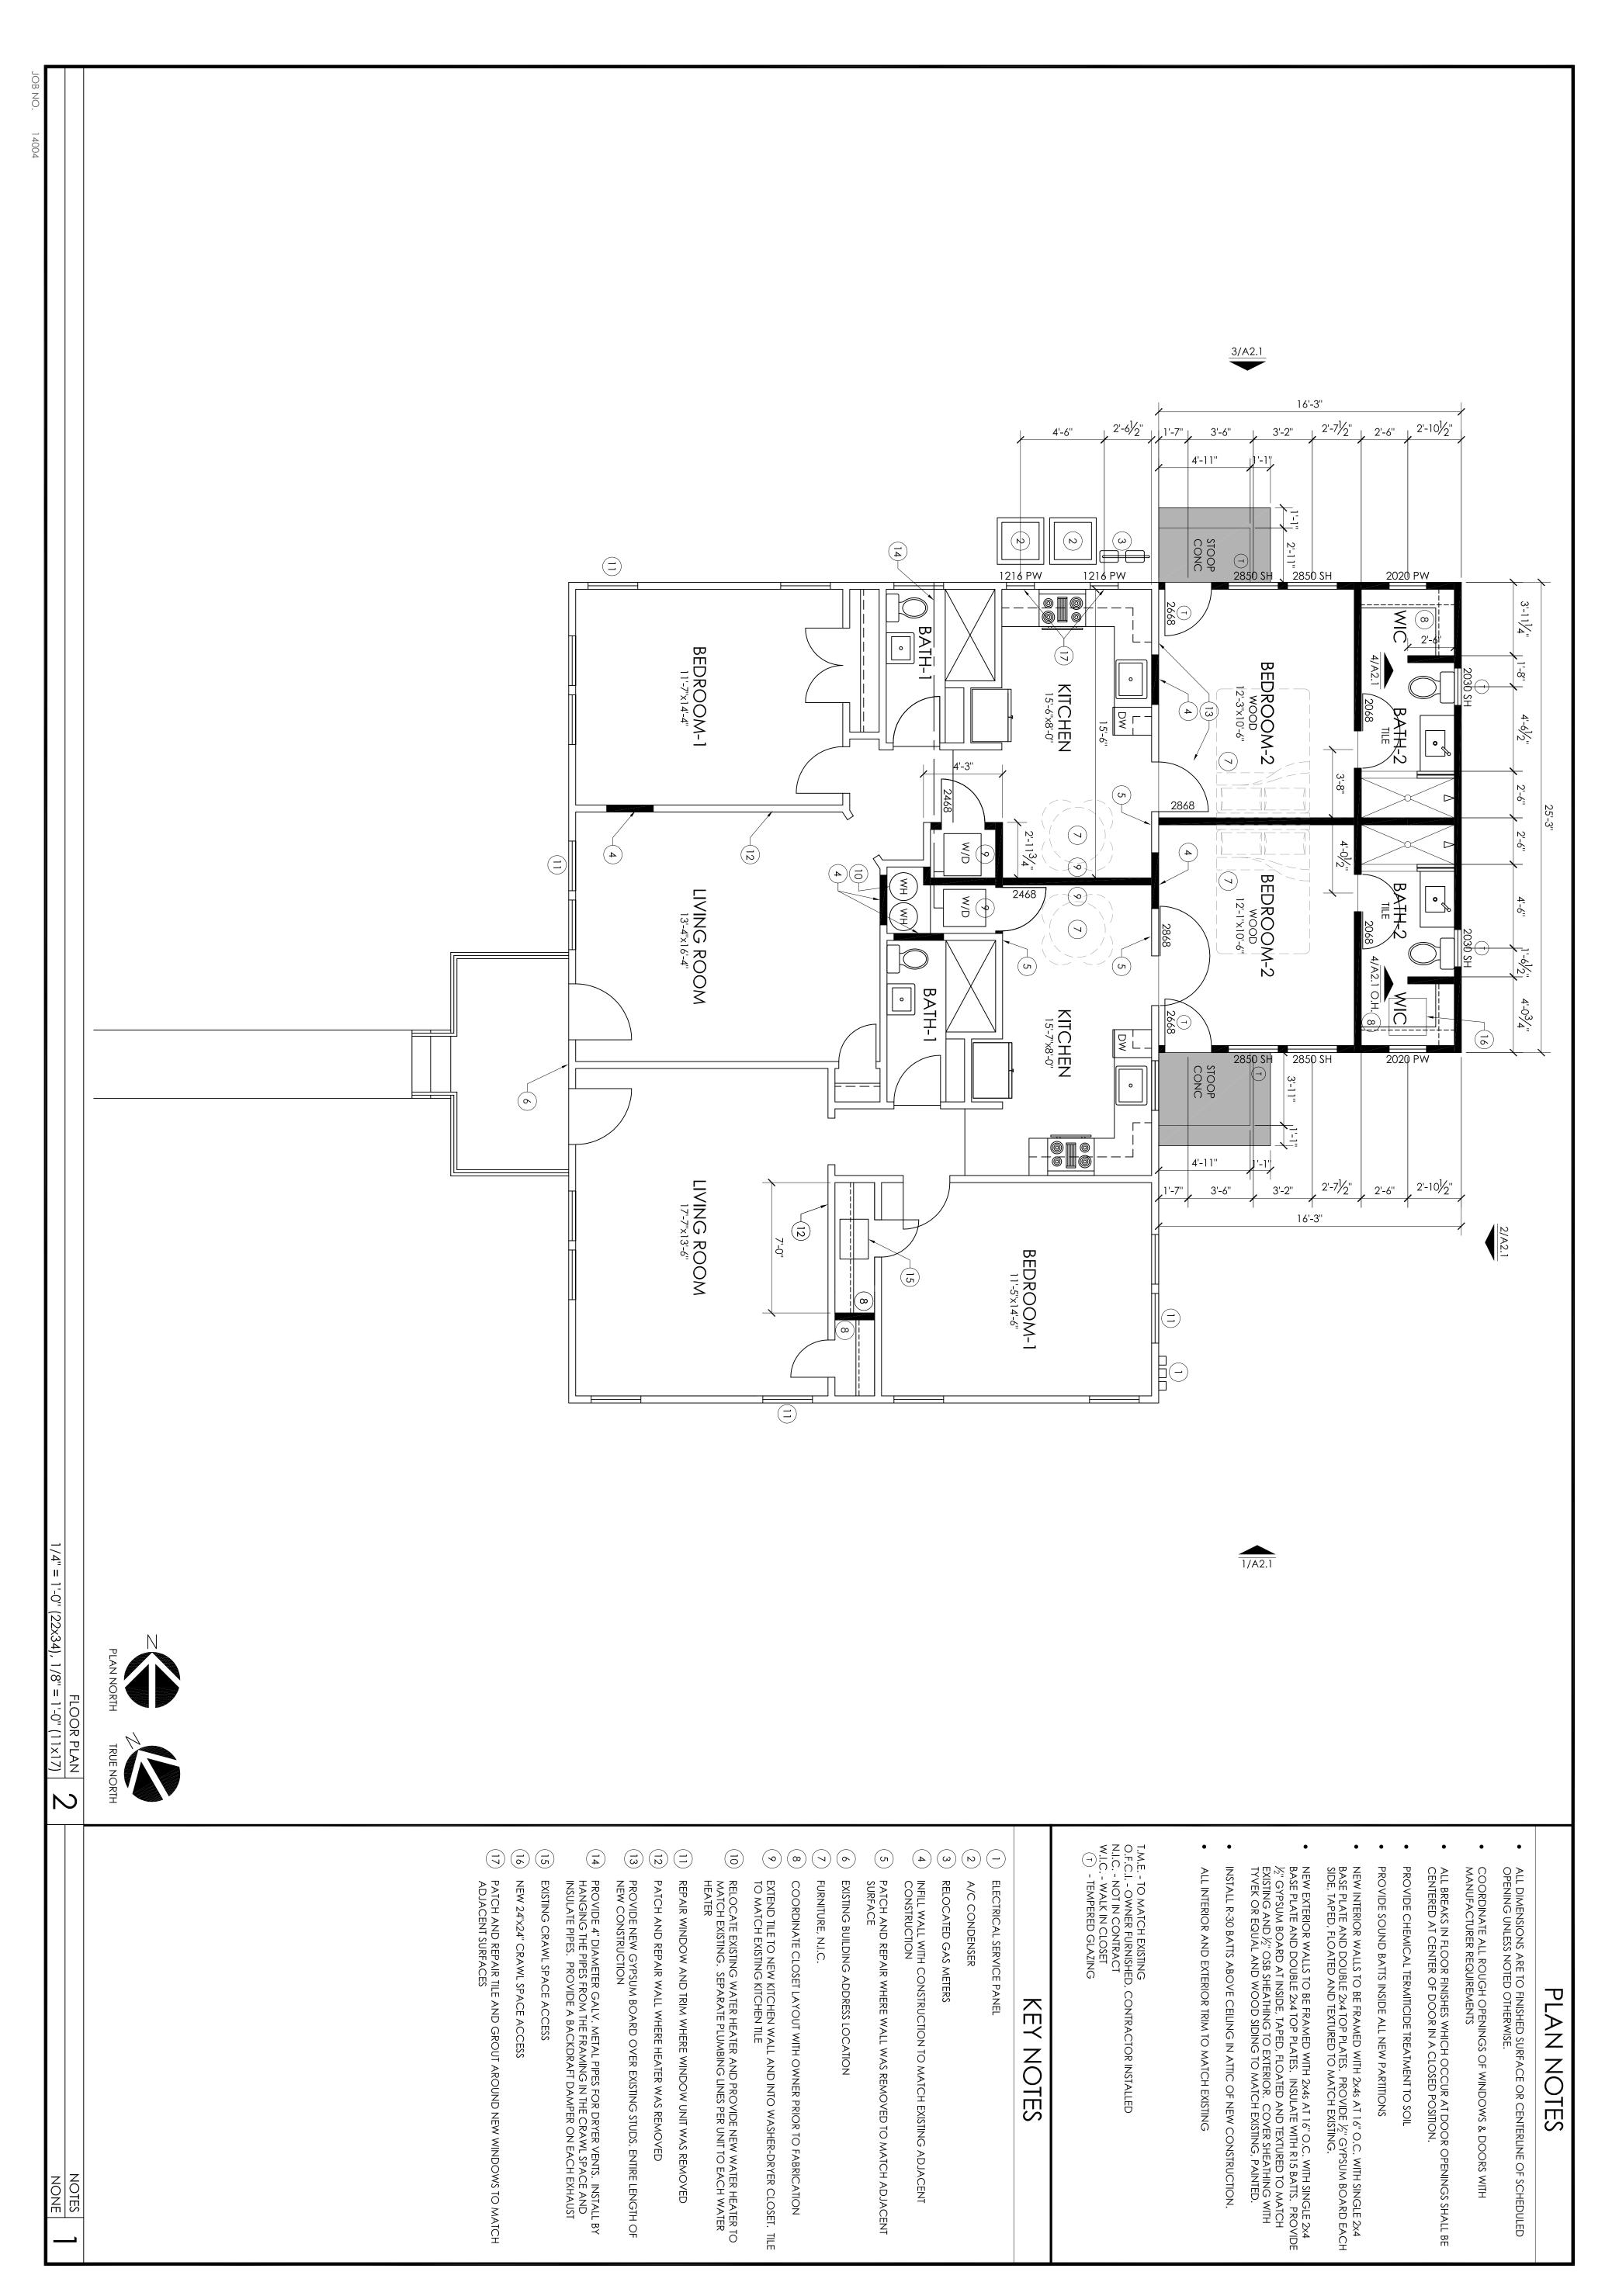






FLOOR PLAN





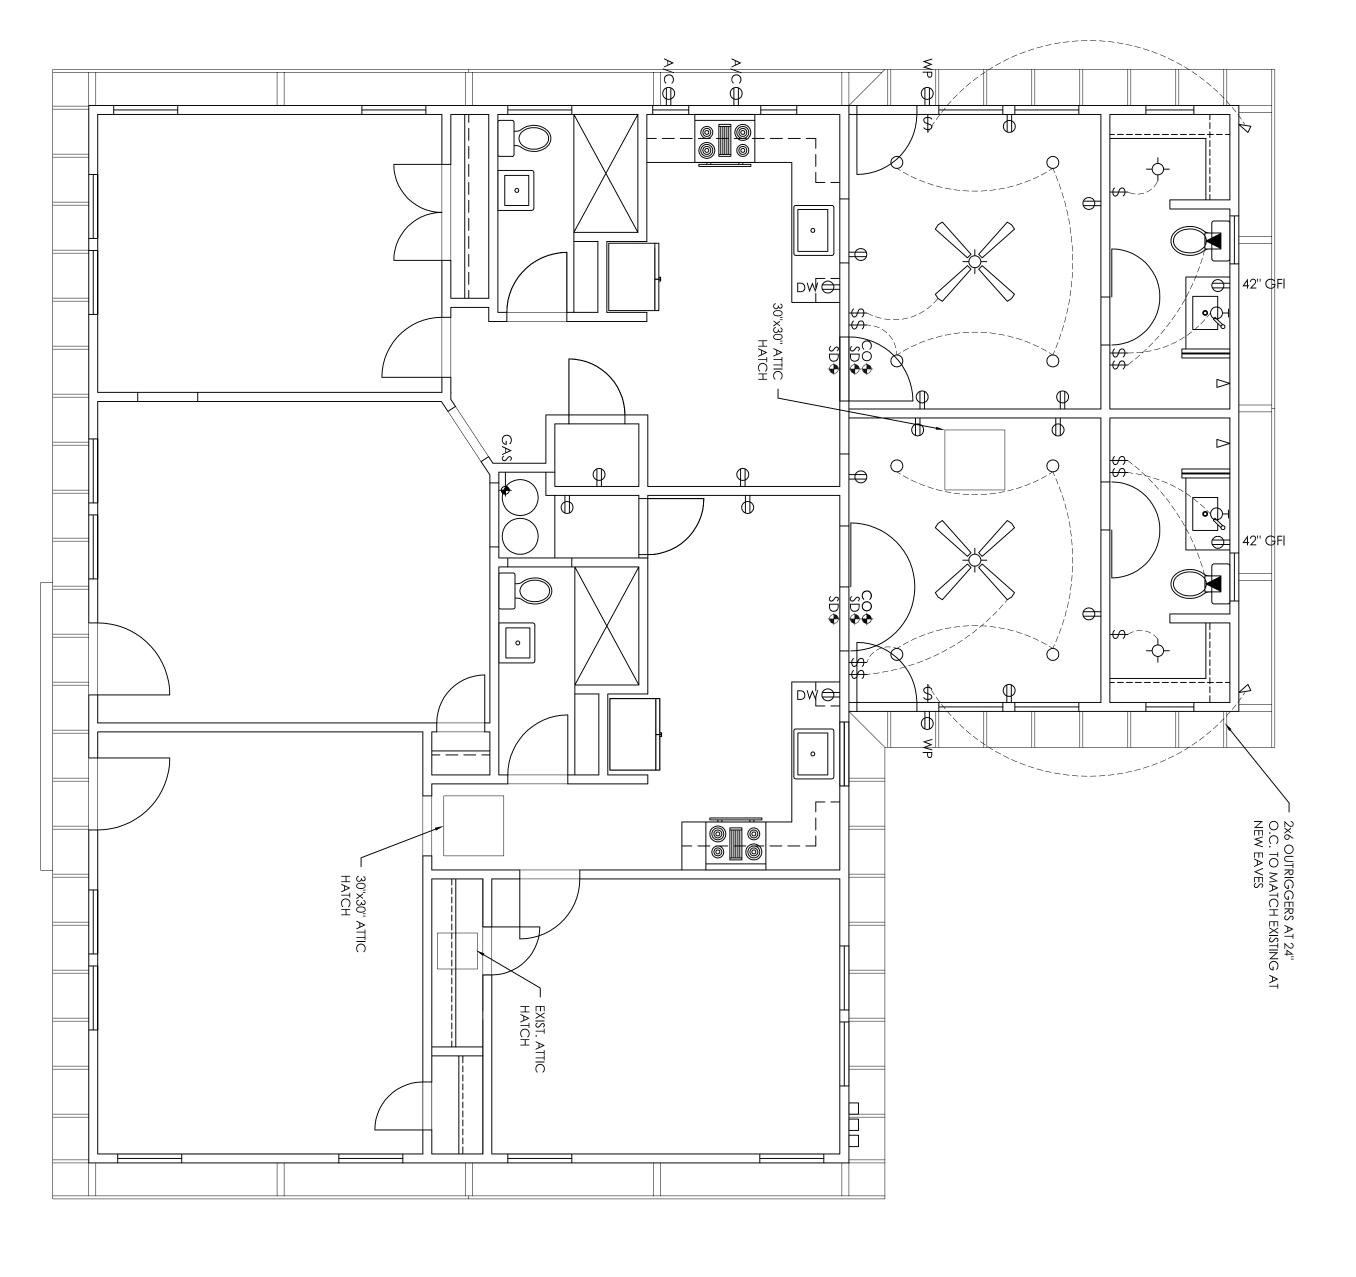

SMOKE DETECTOR NOTES

PROVIDE NEW CENTRAL AIR AND HEAT TO BOTH UNITS. LOCATE FANS IN ATTIC. INSULATE SUPPLY DUCTS TO R-8 AND RETURN TO R-6.

SMOKE DETECTORS REQUIRED IN EACH SLEEPING ROOM AND OUTSIDE EACH SLEEPING ROOM IN THE IMMEDIATE VICINITY AS SHOWN.

SMOKE AND CARBON MONOXIDE DETECTOR SHALL BE INTERCONNECTED, SUCH THAT WHEN ONE DETECTOR IS ACTIVATED, ALL DETECTORS WILL EMIT AN AUDIBLE ALARM. SMOKE AND CARBON MONOXIDE DETECTORS SHALL RECEIVE POWER FROM BUILDING WIRING AND EQUIPPED WITH BATTERY BACKUP.

CEILING PLAN



ELECTRICAL & RCP **NOTES**

FLUORESCENT LIGHT FIXTURE W/ PLASTIC LENS COVER:
- SURFACE MOUNTED
- 2', 4' OR 8' LENGTH
(AS NOTED)

CARBON MONOXIDE DETECTOR

FLOOD LIGHT

SUSPENDED LIGHT FIXTURE: COORDINATE W/ OWNER

SUSP.

SUSPENDED

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WALL MOUNTED

CONFIRM TYPE, STYLE AND LOCATION OF ALL ELECTRICAL FIXTURES WITH OWNER. INSTALL PER CODE AND MANUFACTURER'S RECOMMENDATIONS. Confirm power requirements and power locations to all equipment and appliances.

A DEDICATED 20-AMP CIRCUIT SHALL SERVE THE REQUIRED BATHROOM OUTLETS. BATH LIGHTING SHALL NOT BE AN OUTLET CIRCUIT.

ALL OUTLETS TO MATCH EXISTING STYLE AND HEIGHT ABOVE FINISH FLOOR UNLESS NOTED OTHERWISE. all switches to match existing style and height above finish floor unless noted otherwise.

ALL BRANCH CIRCUITS THAT SUPPLY OUTLETS INSTALLED IN BEDROOMS SHALL BEARC FAULT CIRCUIT INTERRUPTED. ELECTRICAL SERVICE AMPERAGE TO BE COORDINATED WITH FINAL ELECTRICAL LOAD. ELECTRICAL CONTRACTOR TO VISIT SITE & TO VERIFY PANEL CAPACITY PRIOR TO BIDDING.

AT RECESSED LIGHTS IN INSULATED CEILINGS PROVIDE IC RATED, ELECTRONIC BALLAST AND AIR TIGHT (AT). BATH FAN SHALL EXHAUST 1 CUBIC FOOT PER MINUTE PER SF OF SPACE AND HAVE A SOUND RATING BELOW 1.0 SONES. FAN TO BE BROAN ULTRA SILENT MODEL OR APPROVED EQUAL. INSULATE ALL HOT WATER PIPES TO R-4 MIN.

GENERAL CEILING NOTES

ALL INTERIOR CEILING FINISHES TO BE 5/8" MINIMUM GWB, MOUNTED DIRECTLY TO UNDERSIDE OF FRAMING ABOVE, UNLESS NOTED OTHERWISE: TAPE & FLOAT, TEXTURE & PAINT ELECTRICAL RCP LEGEND

CEILING FAN:
COORDINATE W/ OWNER
PROVIDE ADDITIONAL
SWITCH FOR OPTIONAL
LIGHT KIT SURFACE MOUNTED LIGHT

GFI⊕

OUTLET - 110V DUPLEX - G.F.I.

OUTLET - 220V

TELEVISION OUTLET

RECESSED CANLIGHT W/ EXHAUST FAN AND HEAT

TELEPHONE OUTLET

OUTLET - QUADRUPLEX

OUTLET - 110V DUPLEX

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WALL SCONCE: COORDINATE W/ OWNER

A.F.F.

ABOVE FINISH FLOOR

GFI

GROUND FAULT INTERRUPT

RECESSED CANLIGHT, ADJUSTABLE BEAM

S.M.

SURFACE MOUNTED

SURFACE MNTD. SPEAKER

RECESSED FLUORESCENT CANLIGHT, U.N.O.

DOOR BELL CHIME

DOOR BELL PUSHBUTTON

LOW-VOLTAGE, RECESSED CANLIGHT


SMOKE DETECTOR RE: NOTES THIS SHEET

CHIMES DB O

DATA OUTLET

Contractor shall provide wiring for smoke and carbon monoxide detectors.

INSTALL ALL DETECTORS PER MANUFACTURER'S RECOMENDATIONS.

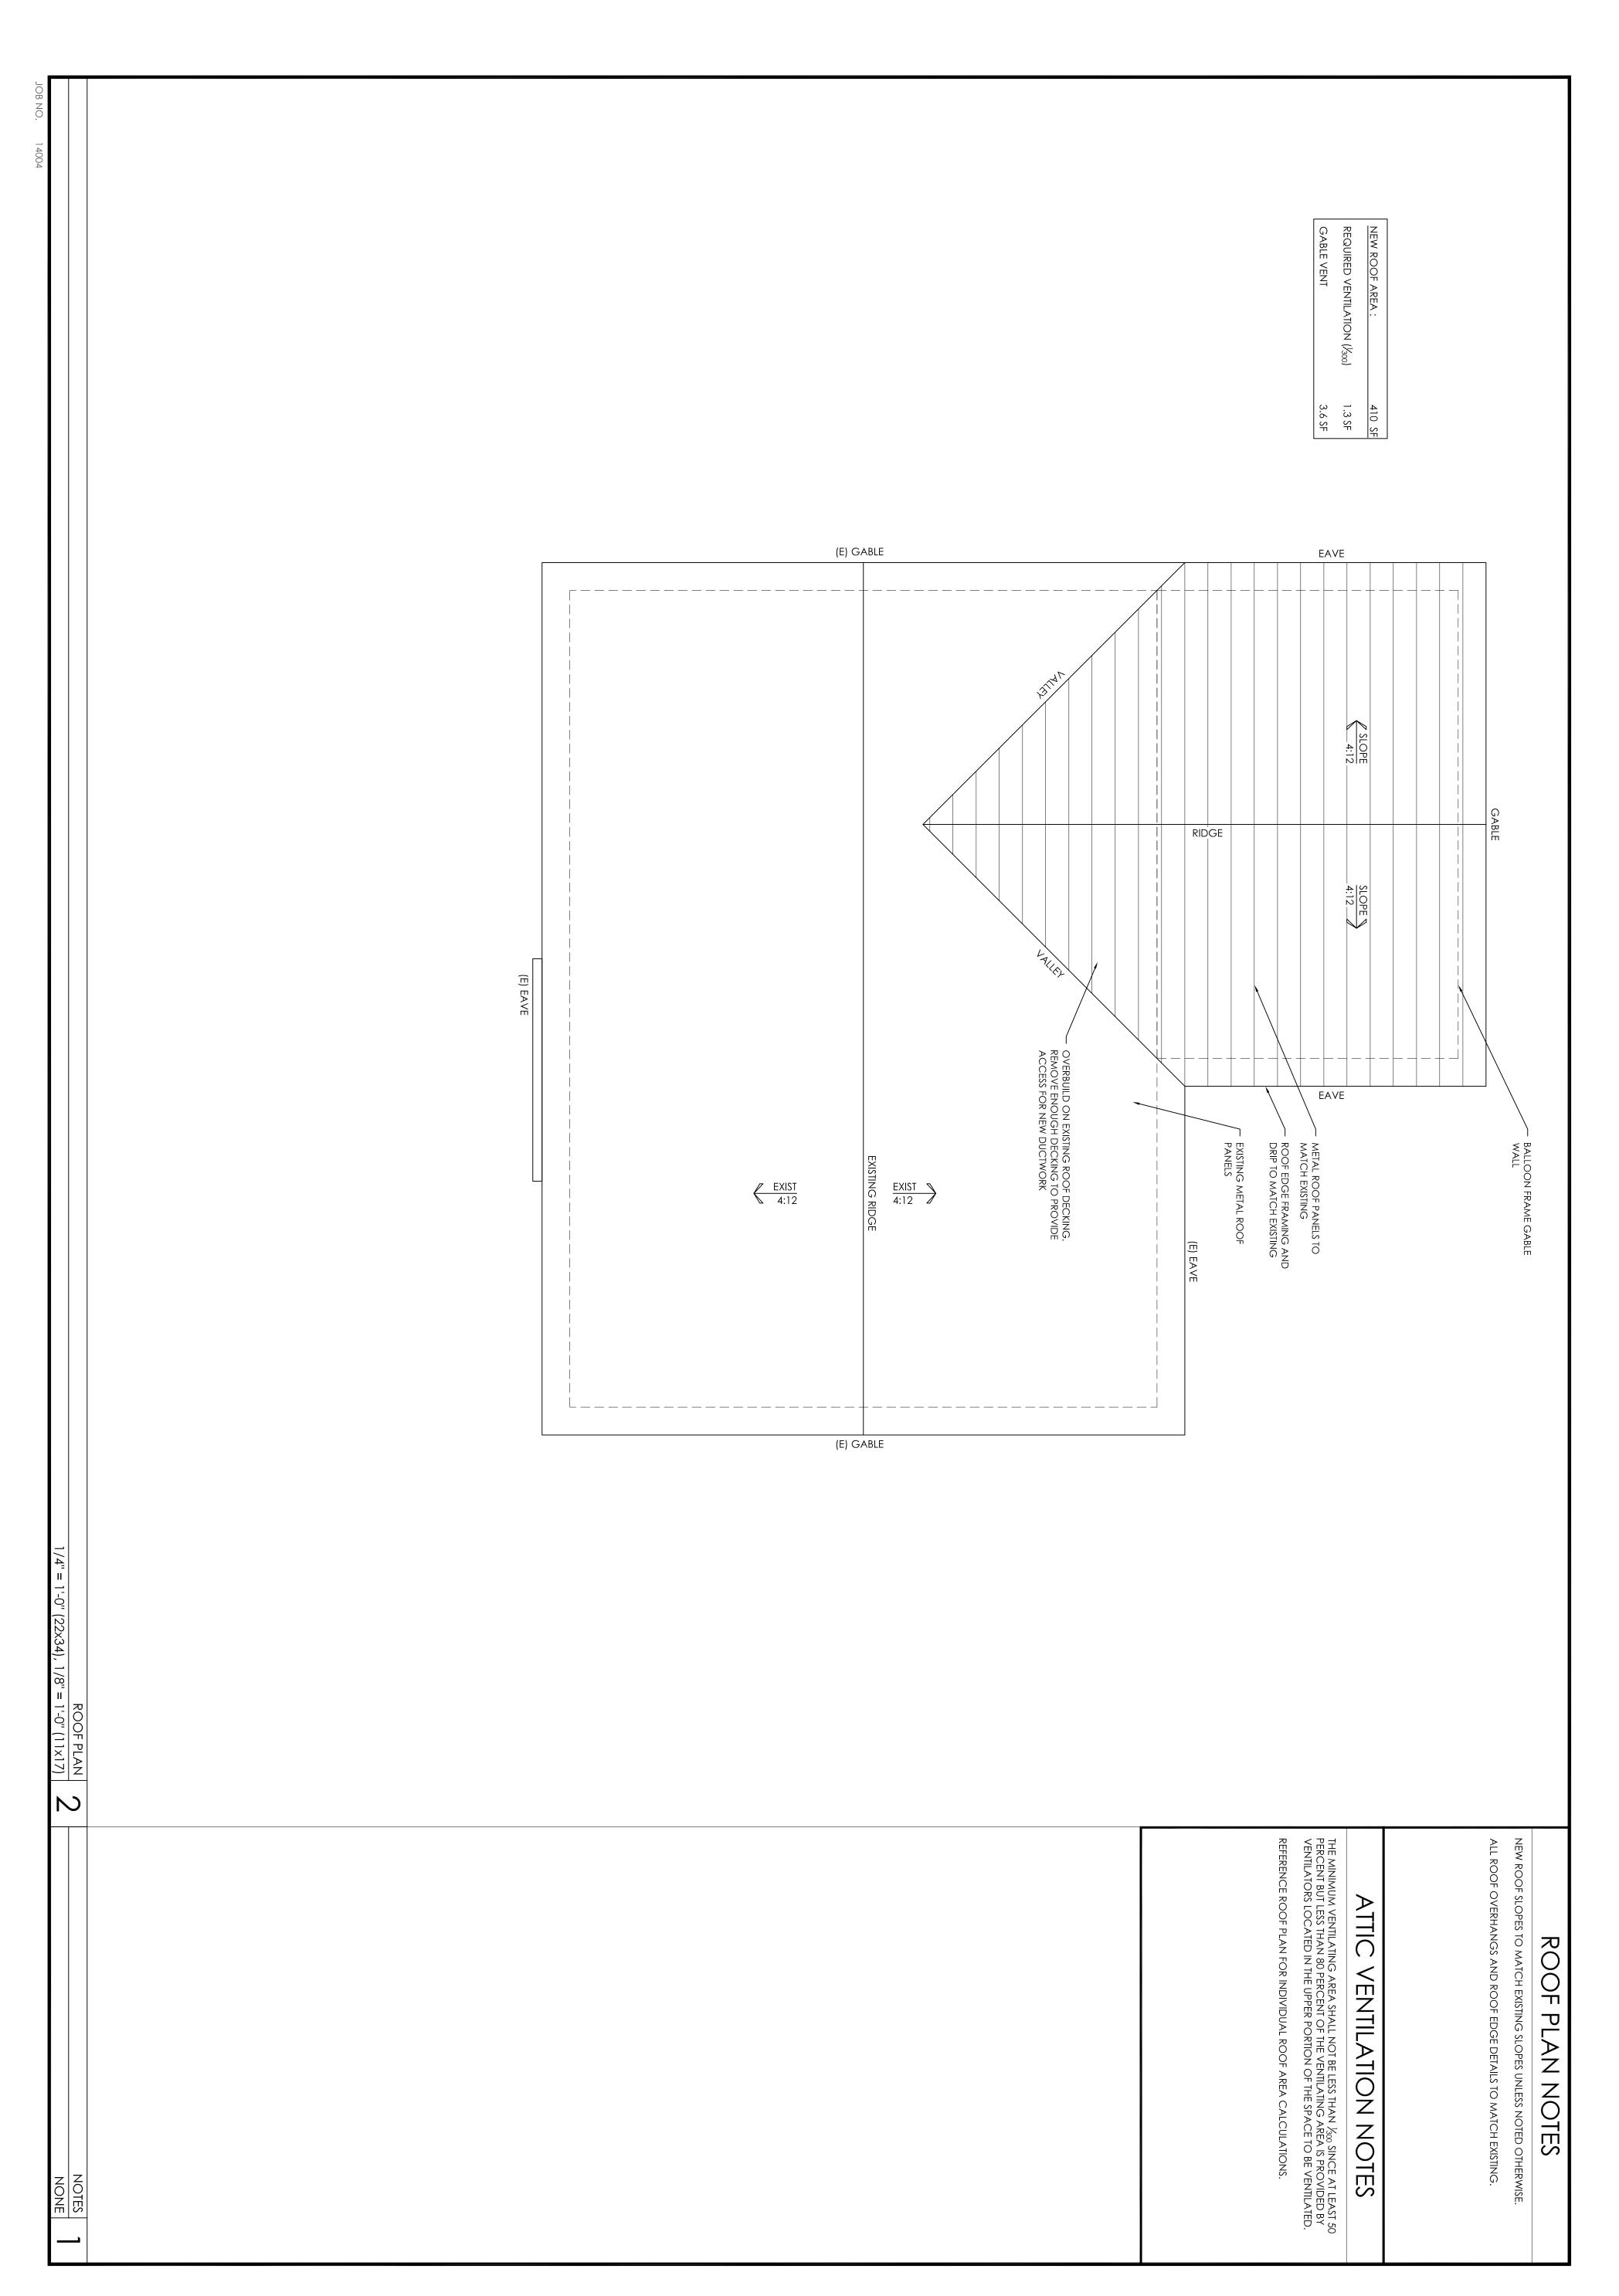



ROOF PLAN










EXTERIOR & INTERIOR ELEVATIONS





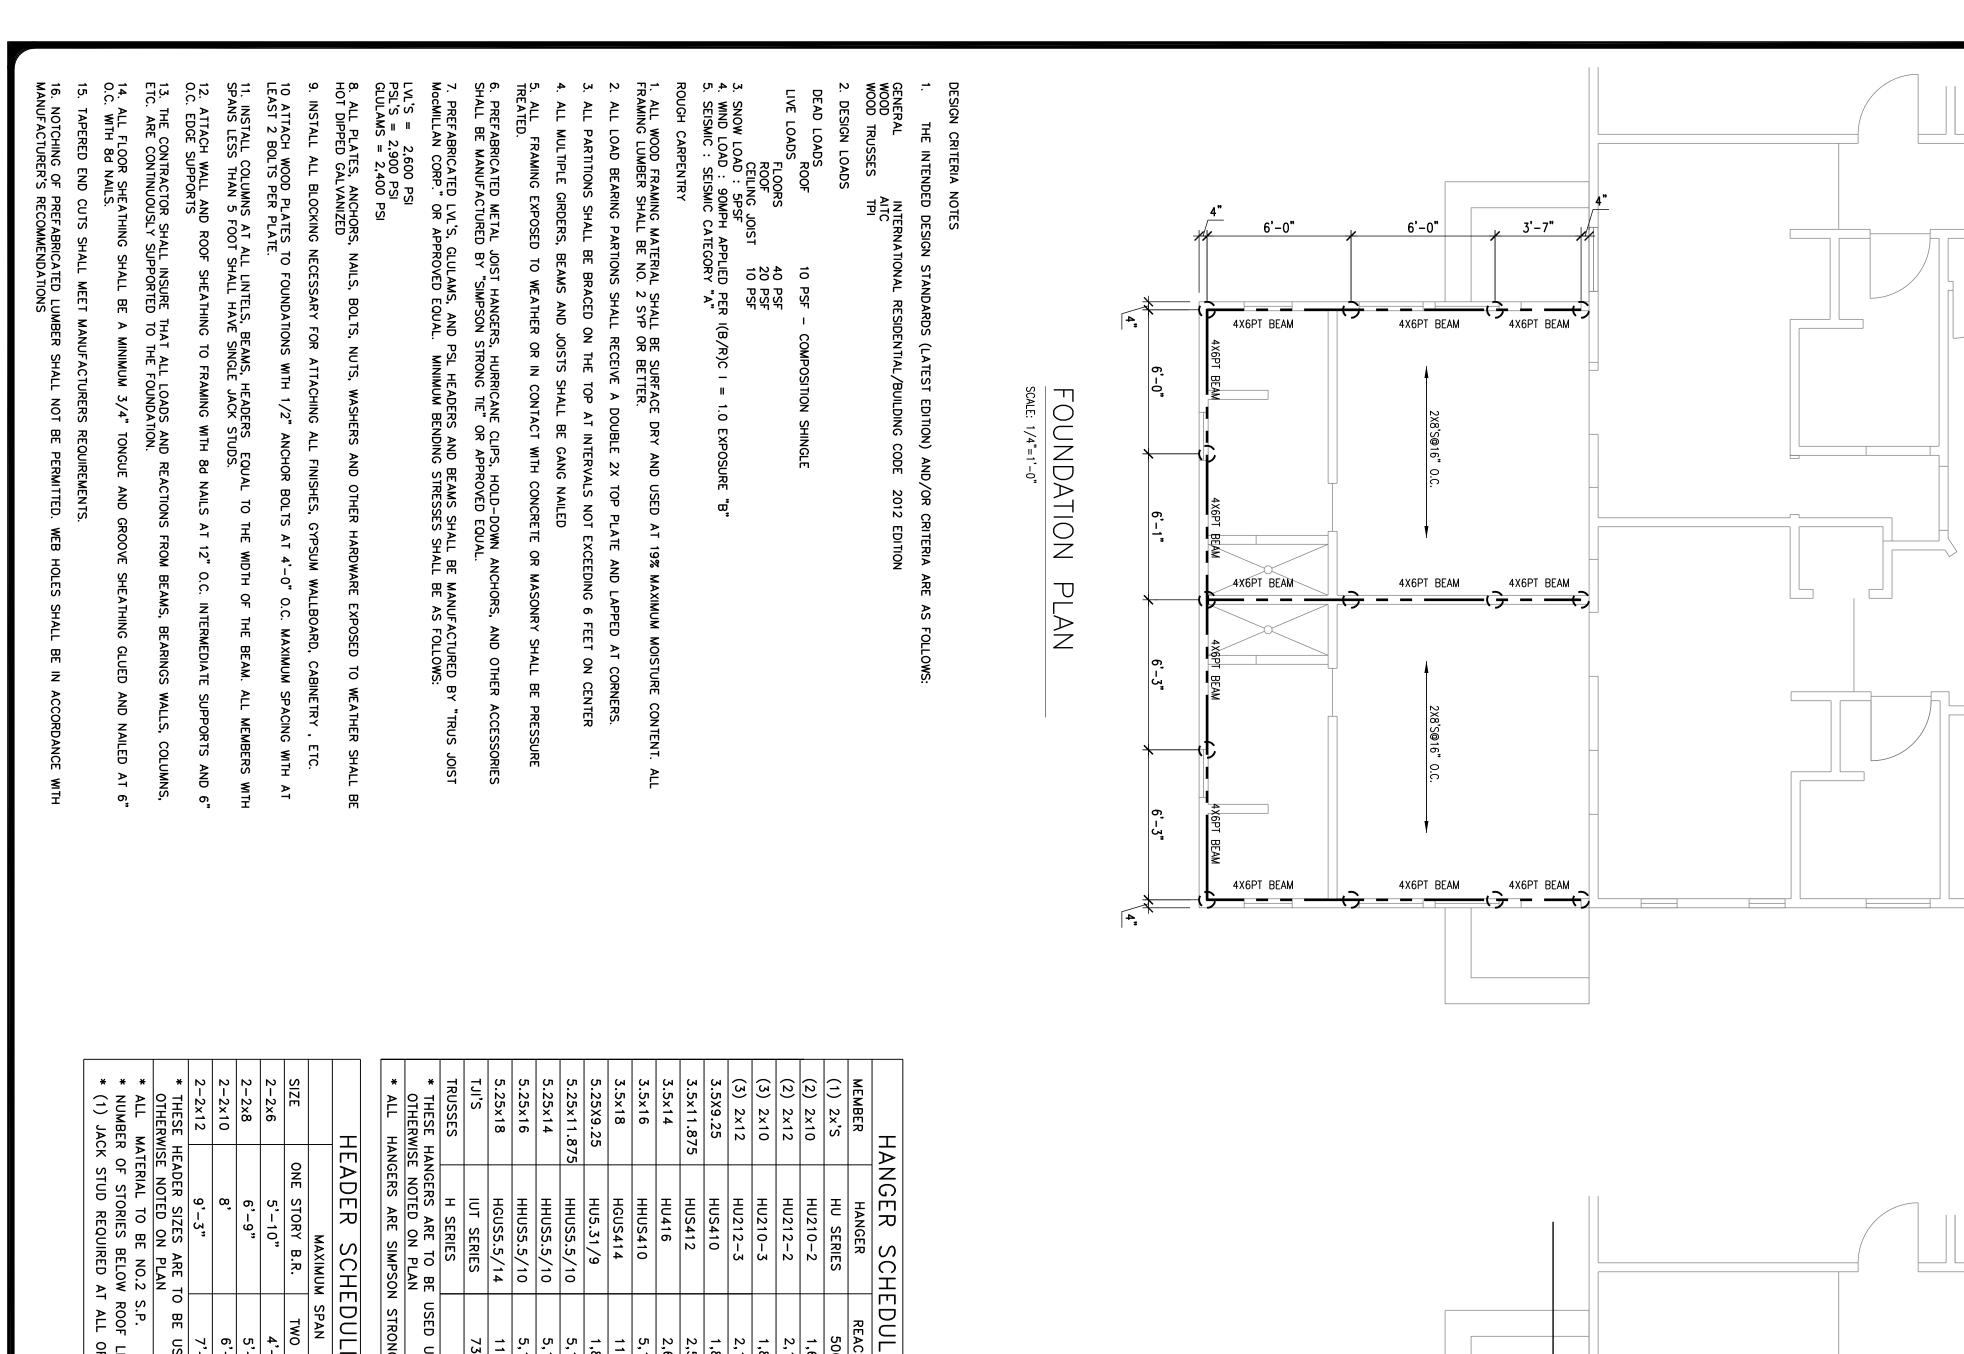

RAFTERS

AND

CEILING

JOIST

2X6@2

4

0.0


PURLIN

ROOF

RAMING

PLAN

SCALE: 1/4"=1'-0"

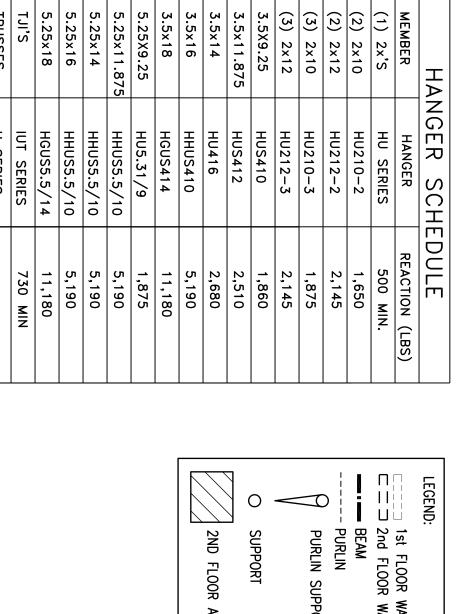

	2ND FLOOR AREA	O SUPPORT	PURLIN SUPPORT	PURLIN	BEAM	□□□ 2nd FLOOR WALLS	1st FLOOR WALLS	LEGEND:

SCHEDULE	
	JACK STUDS
3/4" X 11 1/4" LVL	(2) 2 X 4/6
3/4" X 14" LVL	(2) 2 X 4/6
3/4" X 16" LVL	(2) 2 × 4/6
3/4" X 18" LVL	$(3) 2 \times 4/6$
3/4" X 11 1/4" LVL	(2) 2 X 6
3/4" X 14" LVL	(2) 2 X 6
3/4" X 16" LVL	(2) 2 X 6
3/4" X 18" LVL	(3) 2 X 6
24 GLULAM	(4) 2 X 6

TBPE FIRM F-7750

HEADER

SCHEDULE

SPAN

USED UNLESS

STRONG

ONE

MAXIMUM \$

1E STORY B.R.

5'-10"

6'-9"

B.R.

TWO STORY

4'-8"

5'-5"

6'-4"


7'-5"

USED

MARK L2 L2 L5 L5 L5 L9 L9

(2) 1 3/4"; (2) 1 3/4"; (2) 1 3/4"; (2) 1 3/4"; (3) 1 3/4"; (3) 1 3/4"; (3) 1 3/4"; (3) 1 3/4";

OPENINGS

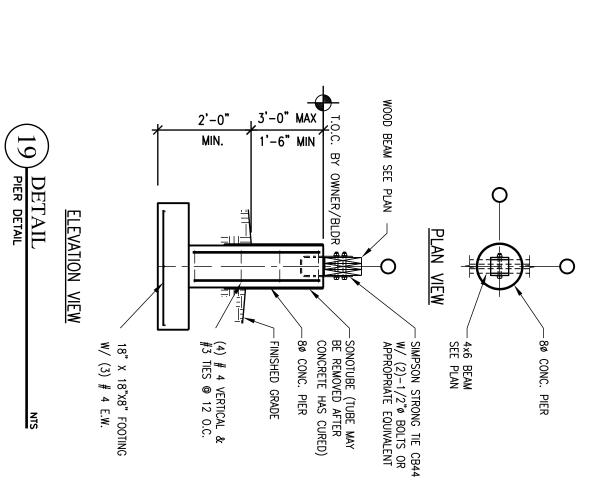

SHEET:	DRAWN:	CHECKED:	DESIGNER:	DATE:	JOB NO:	FOUNDATION PLAN	
	jvr			1/28/13	14-021	3807 AVENUE H AUSTINITX The use of this drawing is limited to the property described in the title block. Any other use of this drawing is prohibited without the expressed written consent of James V. Ryan, P.E.	7750

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