(15-2014-0090

BRADLEY RESIDENCE

1900 W. 40TH STREET / AUSTIN, TEXAS 78731

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AREA CALCULATIONS

- · LOT SIZE: 6,316 SQUARE FEET
- ALLOWABLE BUILDING COVERAGE (F.A.R. 0.40:1.0): 2,526 SQUARE FEET
- PROPOSED BUILDING COVERAGE (F.A.R. -.26:1.0): 1,630 SQUARE FEET
- ALLOWABLE IMPERVIOUS COVER AREA (0.45:1.0): 2,842 SQUARE FEET
- PROPOSED IMPERVIOUS COVER AREA (.37:1.0): 2,221 SQUARE FEET

El responsible for

RESIDENCE

BRADLEY
1900 W. 40TH STREET | AUSTIN, TE

1315 DATE: 07.30.2014

BOA VARIANCE

PROJECT INFO & SCHEDULES

mf architecture

COUNTY, TEXAS,

TO THIS PROPERTY.

TREE TABLE:

T1 - 14" PECAN T2 - 15" HACKBERRY T3 - 8"9"/10" SYCAMORE T4 - 13" PECAN

FIELD WORK DATE: 3/14/2014

BOUNDARY SURVEY

TRAVIS COUNTY

1403.1346

TABLE:

1.1 N 73°26' W 63.00' (C\$M)

DERRICK L. MAYFIELD

L2 5 47°53'07" E 121.39' (M)

REVISION DATE(S): (REV.0 3/15/2014)

NOTES:

I.) SUBJECT TO APPLICABLE RESTRICTIVE COVENANTS

RECORDED IN VOL. 5, PG. 142 OF THE PLAT RECORDS OF

TRAVIS COUNTY, TEXAS AND THOSE FILED OF RECORD IN

VOL. 1184, PG. 298 OF THE DEED RECORDS OF TRAVIS

2.) SUBJECT TO BUILDING SETBACK LINES AS SET FORTH IN THAT CERTAIN DECLARATION RECORDED IN VOL. 1184,

TEXAS; SAID DOC. STATES THAT IT DOES "HEREBY

PG. 298 OF THE DEED RECORDS OF TRAVIS COUNTY,

IMPRESS EACH OF SAID LOTS WITH THE FOLLOWING RESTRICTIONS", BUT THEN DESCRIBES THE SETBACK REQUIREMENTS FOR "ANY RESIDENTIAL BUILDING PLOT"

(BUT DOES NOT DEFINE THE INTENTION OF A "BUILDING

THE LACK OF FURTHER CLARIFICATION; THERE MAY BE ADDITIONAL CITY OF AUSTIN SETBACKS THAT MAY APPLY

EASEMENT ALONG THE REAR, HOWEVER, THERE ISN'T A

N 15°27'54" E 130.21' N 15°36' E 130.21'

FF=634.70

LOT 9

SAVE & EXCEPT

3.) THE SUBD. PLAT STATES THAT THERE WILL BE A 5 FOOT

DISCERNABLE REAR LINE, FOR THIS PROPERTY.

PLOT"), THEREFORE THE SETBACKS FROM SAID DOC. ARE

BASED UPON THE ORIGINAL LOT CONFIGURATION, DUE TO

C-1

R= 15.00'(P\$M)

L = 33.51'(P) 32.72'(M)

5 42°33' W, 26.97'(P)

5 43°05'55" W, 26.61'(M)

 $\Delta = 128^{\circ}O1'OO''(P) 124^{\circ}59'16''(M)$

LEGAL DESCRIPTION:

LOT 10 SAVE AND EXCEPT THE W 5', OAKMONT HEIGHTS ANNEX NO 3, SECTION 1 ACCORDING TO THE PLAT THEREOF, AS RECORDED IN PLAT BOOK 5, PAGE 142 OF THE PLAT RECORDS OF TRAVIS COUNTY, TEXAS.

JOB SPECIFIC SURVEYOR NOTES:

GENERAL SURVEYOR NOTES:

- 1. The Legal description used to perform this survey was supplied by others. This survey does not determine or imply ownership.
- 2. Due to varying construction standards, house dimensions are approximate.
- 3. This survey is exclusively for the use of the parties to whom it is certified. It is not transferable to additional institutions or subsequent owners.
- 4. This property subject to any and all recorded and unrecorded easements. Surveyor has made no investigation or independent search for easements of record, encumbrances, restrictive covenants or ownership title evidence.
- 5. Surveying services performed by the Austin branch of Exacta Texas Surveyors, Inc., 7416 Canal Drive, Lake Worth, FL 33467.
- 6. If there is a septic tank, well or drain field on this survey, the location of such items was showed to us by others and are not verified.
- 7. Any additions or deletions of this 2 page survey document are strictly prohibited. Use of this survey beyond the purpose of the transfer of title without written authorization of the signing surveyor is prohibited.
- 8. Any FEMA flood zone data contained on this survey if for informational purposes only. Research to obtain such data was performed at www.fema.gov
- 9. Dimensions are in feet and decimals thereof.
- 10. All pins marked as set are 1/2" or 5/8" diameter, 18" iron rebar.
- 11. This survey only shows improvements found above ground. Underground footings, utilities and encroachments are not located on this survey map.
- 12. The information contained on this survey has been performed exclusively, and is the sole responsibility, of Exacta Surveyors. Additional logos or references to third party firms are for informational purposes only.
- 13. Points of Interest (POI's) are selected above- ground improvements which may be in conflict with boundary, building setbacks or easement lines, as defined by the parameters of this survey. There may be additional POI's which are not shown, not called-out as POI's, or which are otherwise unknown to the surveyor. These POI's may not represent all items of interest to the viewer.
- 14. House measurements should not be used for new construction or planning. Measurements should be verified prior to such activity.

LEGEND:

SURVEYOR'S LEGEND

UNETYPES: (0	LESS OTHERWASE NOTED)	A/C B.R.	AIR CONDITIONING BEARING REFERENCE	ID. ILL.	IDENTIFICATION ILLEGIBLE	sec. Sep.	SECTION SEPTIC TANK
DOURDA	INI LING	B.C.	BLOCK CORNER	inst.	INSTRUMENT	SEW.	SEWER
STRUCTI		B.F.F.	BACKFLOW PREVENTOR	INT.	INTERSECTION	SIGD	SET GLUE DISC
		BLK.	BLOCK	L	LENGTH	5IRC	SET IRON ROD & CAP
CENTERLIN	Ę	BLDG.	BUILDING	LB#	LICENSE # - BUSINESS	SN#D	SET NAIL # DISC
CHAMILIAN	or WIRE PENCE	ВМ	BENCHMARK	L5#	LICENSE # - SURVEYOR	50.FT.	SQUARE FEET
ÇI Min-Bri	OF WINE LENGE	B.R.L.	BUILDING RESTRICTION LINE	(M)	MEASURED	STY.	STORY
EASEMENT	-	BSMT.	BASEMENT	M.B.	MAP BOOK	5.T.L.	SURVEY TIE LINE
		BW	BAY/BOX WINDOW	M.E.S.	METERED END SECTION	5¥	SEWER VALVÉ
EDGE OF W	ATER	(C)	CALCULATED	M,F.	METAL FENCE	SW	SIDEWALK
IRON FENC	F	c	CURVE	N.R.	NON RADIAL	5.W.	SEAWALL
		CATV	CABLE TV. RISER	N.T.S.	NOT TO 5CALE	TBM	TEMPORARY BENCHMARK
OVERHEAD	UNES	C.B.	CONCRETE BLOCK	O.C.S.	ON CONCRETE SLAB	TEL.	TELEPHONE FACILITIES
—OnL-	-on	CHIM.	CHIMNEY	O.G.	ON GROUND	T.O.B.	TOP OF BANK
SURVEY T	É LINÉ	C.L.F.	CHAIN LINK FENCE	OFF	OUTSIDE OF SUBJECT PARCEL	TWP.	TOWNSHIP
		C.O.	CLEAN OUT	OH.	OVERHANG	TX	TRANSFORMER
WALL OK I	ARTY WALL	CONC.	CONCRETE	OHL	OVERHEAD LINES	TYP.	TYPICAL
WOOD FEE	NCE	COR.	CORNER	ON	INSIDE OF SUBJECT PARCEL	U.R.	UTILITY RISER
	· · · · · · · · · · · · · · · · · · ·	CSAV	CONCRETE SIDEWALK	Q.R.B.	OFFICIAL RECORD 500K	W/C	WITNESS CORNER
VINYL FENO		C.V.G.	CONCRETE VALLEY GUTTER	O.R.V.	OFFICIAL RECORD VOLUME	W/F	WATER FILTER
		C/L	CENTER LINE	O/A	OVERALL	W.F.	WOODEN FENCE
CHINE ACE TAR	ES: (UNLESS OTHERWISE NOTED)	C/P	COVERED PORCH	0/5	OFFSET	ww	WATER METERIVALVE BOX
	ED: (UNLESS DIRECKE HOIED)	C/S	CONCRETE SLAB	(P)	PLAT	WV	WATER VALVE
ASPHALT	or THE	(D)	DEED	P.B.	PLAT BOOK	V.F.	VINYL FENCE
	COVERED	p.r.	DRAIN FIELD	P.C.	POINT OF CURVATURE		
CONCRETE	AREA .	DAV	DRIVEWAY	P.C.C.	POINT OF COMPOUND CURVATURE		
		ELEV.	ELEVATION	P.C.P.	PERMANENT CONTROL POINT	4.5	ACCESS EAGENSN
WATER	WOOD /	ENCL.	ENCLOSURE	P/E	POOL EQUIPMENT	AN L	ANERGI: PAGEMENT
SYMBOLS	NUMBER OF THE PROPERTY.	ENT.	ENTRANCE	PG.	PAGE	CALE	CASA: MAINTENANCE ESME
+		EM.	ELECTRIC METER	P.I.	POINT OF INTERSECTION	C.J.5.	COUNTY BUILTY ESM!
�	BENCH MARK	E.O.P.	EDGE OF PAVEMENT	PLS	PROFESSIONAL LAND SURVEYOR	0.5	DRAINAGE SASSMENT
E	CENTERLINE	E.O.W.	EDGE OF WATER	PLT	PLANTER	0.07	DRAINAGE AND UTILITY ESW"
Δ	CENTRAL ANGLE or DELTA	EUB	ELECTRIC LITEUTY BOX	P.O.B.	POINT OF BEGINNING	75V7	EASEVEN:
. 1	COMMON OWNERSHIP	(f)	FIFLD	P.O.C.	POINT OF COMMENCEMENT	1.5.6.5.	NORTHER CRESS EDAG
<i>\(\begin{array}{c}\\\\\\\\\\\\\\\\\\\\\\\\\\\\\\\\\\\</i>	CONTROL POINT	FCM	FND. CONCRETE MONUMENT	2.6-	PINCHED PIPE	:85.E	BIRIGAL ON FASCIMENT
•	**	F/DH	FOUND DRILL HOLE	P.R.C.	POINT OF REVERSE CURVATURE	CAE.	EMPTED ACCESSE FORM
	CONCRETE MONUMENT	F.F.	FINISHED FLOOR	P.R.M.	PERMANENT REFERENCE MONUMENT	UB 5	TARES RETRUB LEACHBALL
خرى 📖	CATCH BASIN	FIP	FOUND IRON PIPE	PSM .	PROFESSIONAL SURVEYOR	v.£.	LANDSCAPE ESIZE
	ELEVATION	FIPC	FOUND IRON PIPE # CAP		AND MAPPER	1.35.E.	JAKE OF JANUSCAPT
70"	FIRE HYDRANT	FIR	FOUND IRON ROD	P.T.	POINT OF TANGENCY	1,	MAINTENANCE EASEMENT
•	FND OR SET MONUMENT	FIRC	FOUND IRON ROD 4 CAP	R,	RADIUS or RADIAL	56 E.	MAINTENENCE EASEMENT
_			FOUND NAIL	(R)	RECORD		
	GUYWIRE OR ANCHOR	FN				200	Possibility of EASEMENT
<u></u>		FN#D	FOUND NAIL & DISC	RGE.	RANGE	P.U.1 R.O.E	
•	MANHOLE	FN¢D FND.	FOUND NAIL & DISC FOUND	RGE. RES.	range Residence	S.O.E.	ROOF DIVERMANG SSMIT.
	MANHOLE TREE	fn¢d fnd, fpkn	FOUND NAIL & DISC FOUND FOUND PARKER-KALON NAIL	RGE. RES. RW	RANGE RESIDENCE RIGHT OF WAY	S.O.E. S.W.F	ROOF OVERHANG SSMIT. SIDEWALK SAGEMENT
	MANHOLE TREE UTILITY OR LIGHT POLE	FN¢D FND. FPKN FPKN¢D	FOUND NAIL & DISC FOUND FOUND PARKER-KALON NAIL FOUND PK NAIL & DISK	RGE. RES. RW (5)	RANGE RESIDENCE RIGHT OF WAY SURVEY	S.O.E. S.W.F	ROOF DVERHANG BSMT. SIDEWALK BASEMENT STOKM WATER
⊗ \$\$ \$\$	MANHOLE TREE	FN¢D FND. FPKN FPKN¢D FRRSPK	FOUND NAIL & DISC FOUND FOUND PARKER-KALON NAIL FOUND PK NAIL & DISK FOUND RAILROAD SPIKE	RGE. RES. RW (5) S.B.L	RANGE RESIDENCE RIGHT OF WAY SURVEY SETBACK UNE	8.0.E. 5.W.F 5.W.V.E	ROOF DIVERHANG BEMT. SIDEWALK BASEMENT STOKM WATER MANAGEMENT ESMT
	MANHOLE TREE UTILITY OR LIGHT POLE	FN¢D FND. FPKN FPKN¢D	FOUND NAIL & DISC FOUND FOUND PARKER-KALON NAIL FOUND PK NAIL & DISK	RGE. RES. RW (5)	RANGE RESIDENCE RIGHT OF WAY SURVEY	S.O.E. S.W.F	ROOF DVERHANG BSMT. SIDEWALK BASEMENT STOKM WATER

Exacta Texa LB# 10193731

Exacta Texas Surveyors, Inc.

www.exacta365.com P (281) 763-7766 · F (281)763-7767 7416 Canal Drive, Lake Worth, Ft 33467

POINTS OF INTEREST NONE VISIBLE

FLOOD INFORMATION:

BUYER: Sabrina Bradley

SELLER: SABRINA BRADLEY

CERTIFIED TO: Sabrina Bradley .

SURVEY OF EXISTING SITE

W. 40TH STREET (50' RW)

FENCE OWNERSHIP NOT DETERMINED CVE - CONTROL VALVE BOX

NOT TO SCALE





ESIDENCE

LEY

4 α

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CONSTRUCTION **EGULATORY O**B PERMITTING, NOT

1315

BOA VARIANCE

EXISTING SITE

ENCROACHMENTS OR OVERLAPPING OF IMPROVEMENTS EXCEPT AS SHOWN HEREON; THE PROPERTY HAS ACCESS TO AND FROM A PUBLIC ROADWAY: THIS SURVEY WAS CONDUCTED WITHOUT THE BENEFIT OF A FULL TITLE REPORT, THEREFORE THE PROPERTY MAY BEAR ENCUMBERANCES NOT SHOWN Use of This Survey for Purposes other than Intended, Without Written Verification, will be at the User's Sole Risk and Without Liability to the Surveyor. Nothing hereon shall be Construed to Give ANY Rights or Benefits to Anyone Other than those Certified. DATE: 3/15/2014

I HEREBY CERTIFY THAT: THIS PLAT REPRESENTS THE RESULTS OF A SURVEY MADE ON THE GROUND ON THE 22nd DAY OF JUNE 2013 AND UPDATED ON THE 14th

RIGHTS-OF-WAY SHOWN ON THE PLAT ARE SHOWN OR

OF MARCH 2014; ALL EASEMENTS AND

NOTED HEREON; THERE ARE NO VISIBLE


GRAPHIC SCALE (In Feet) 1 inch = 30' ft.

PORTION

BENCHMARK: SET "X" CUT ELEVATION=628.238 (STATIC GPS RUN,

PROJECT NUMBER

07.30.2014 **SURVEY OF**

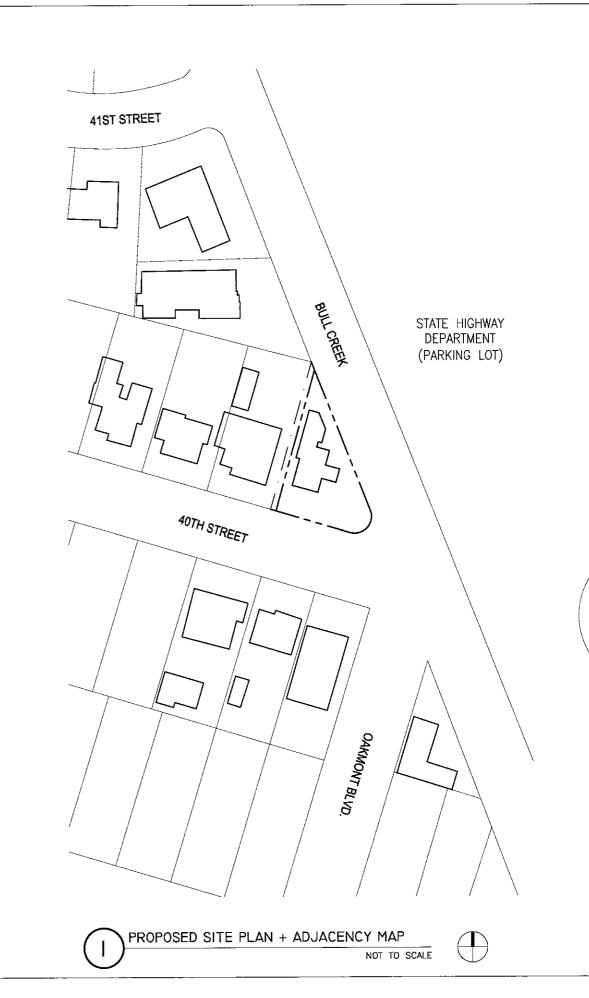


RESIDENCE


BRADLEY
1900 W. 40TH STREET I AUSTIN, TEX

PROJECT NUMBER: 1315

07.30.2014 BOA VARIANCE DRAWING TITLE:
CONTEXT MAP

A0.3 **mf**archnecture

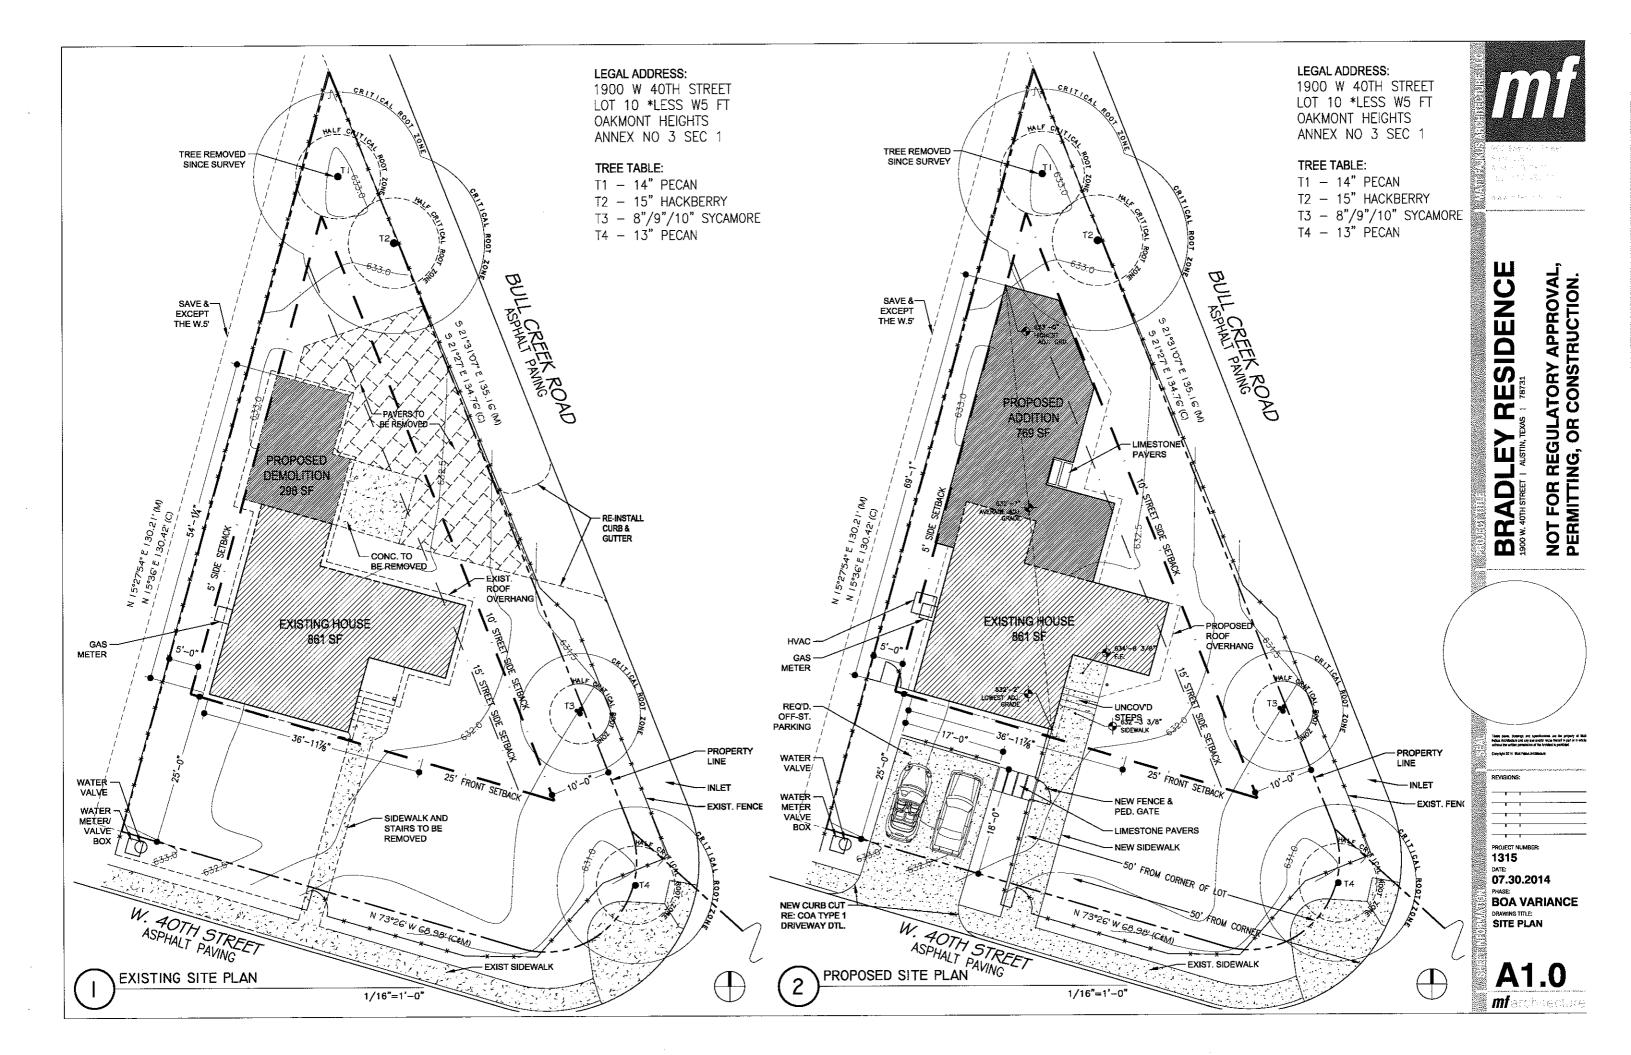

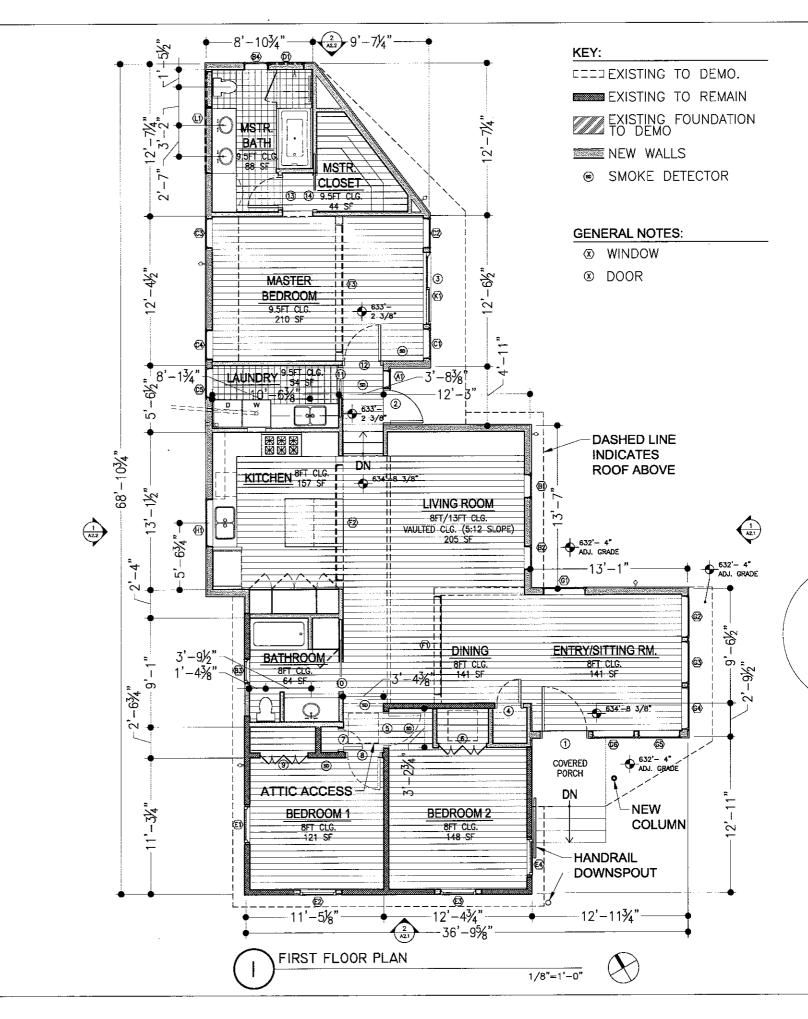



RESIDENCE BRADLEY 1900 W. 40TH STREET 1 ALL

NOT FOR REGULATORY APPROVAL PERMITTING, OR CONSTRUCTION.

These piece, develops and appointations are the property of Matt.

Federal Architecture and any seasonable reason flower in part or in whole


whose the window commercial of the Architect is probabled.


1315 07.30.2014

BOA VARIANCE

DRAWING TITLE:
DEMO PLAN & FLOOR PLAN

mfarchitecture

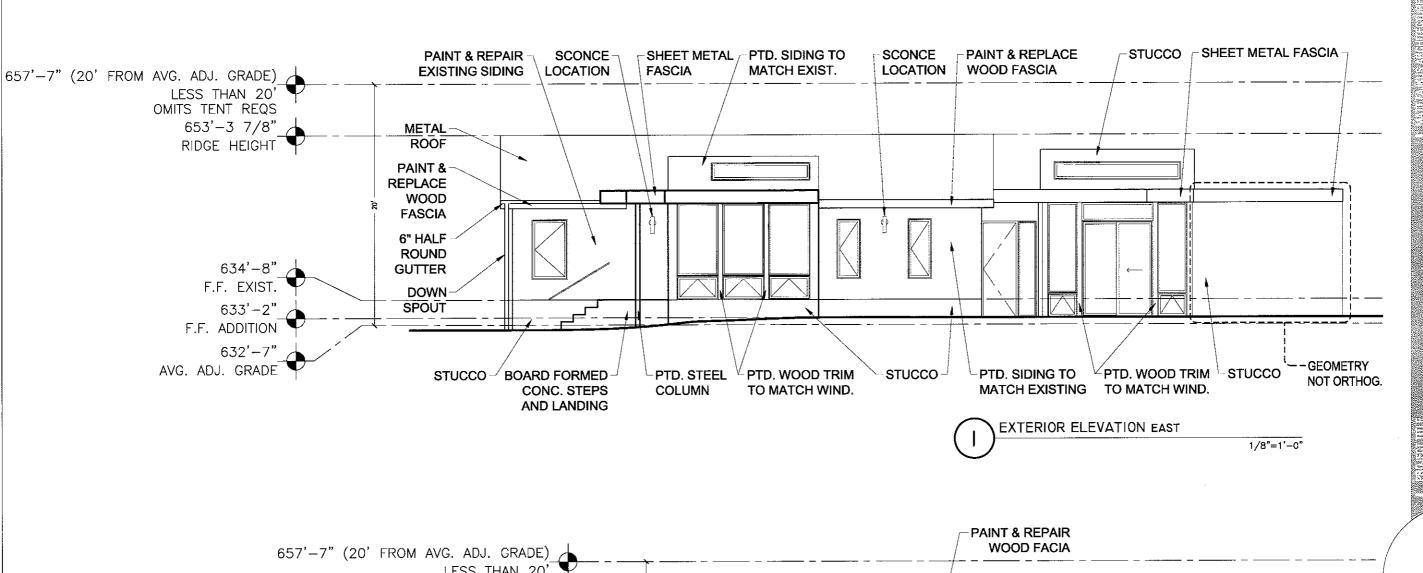

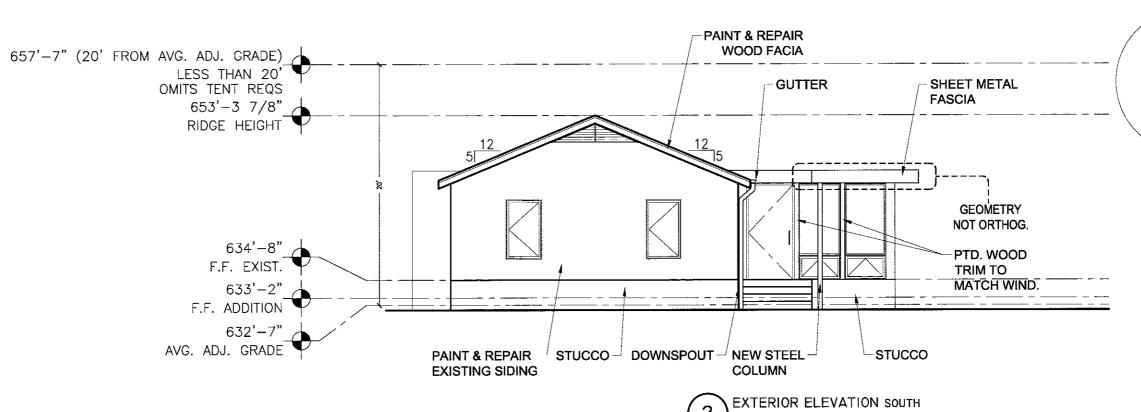


RESIDENCE NOT FOR REGULATORY APPROVAL PERMITTING, OR CONSTRUCTION. BRADLEY
1900 W. 40TH STREET | AUSTIN, TE


PROJECT NUMBER: 1315 07.30.2014 BOA VARIANCE DRAWING TITLE: EXTERIOR


ELEVATIONS

mfaichteaure

1/8"=1'-0"

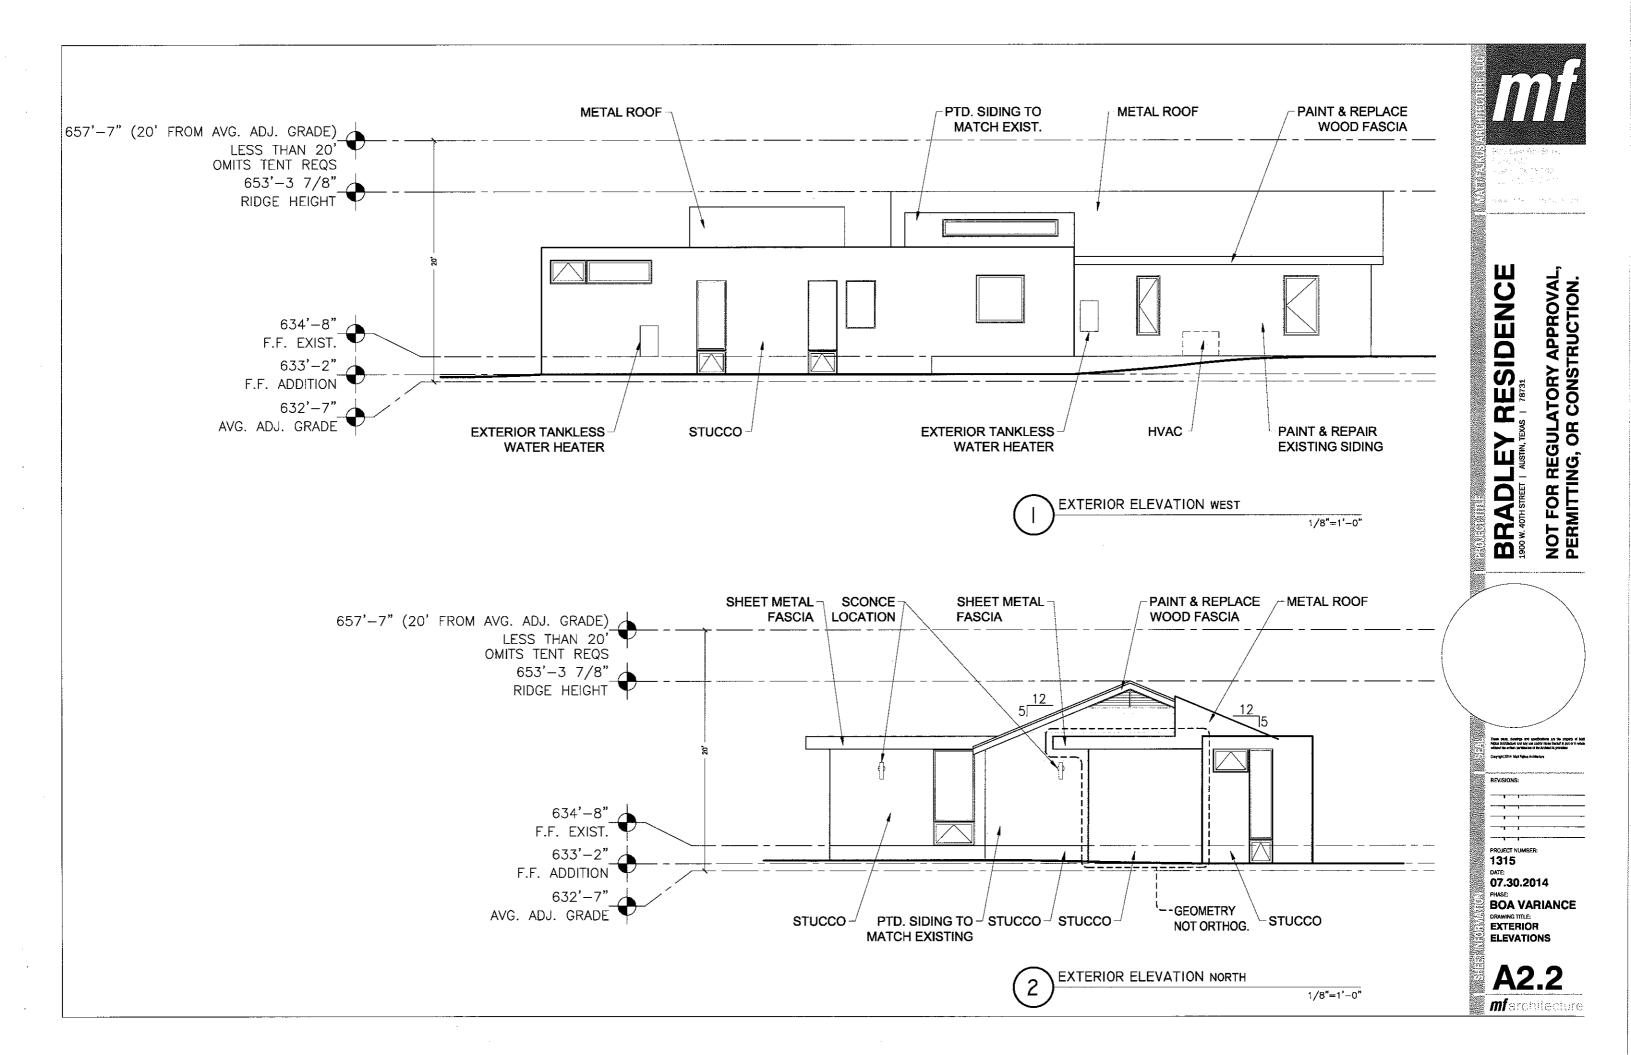

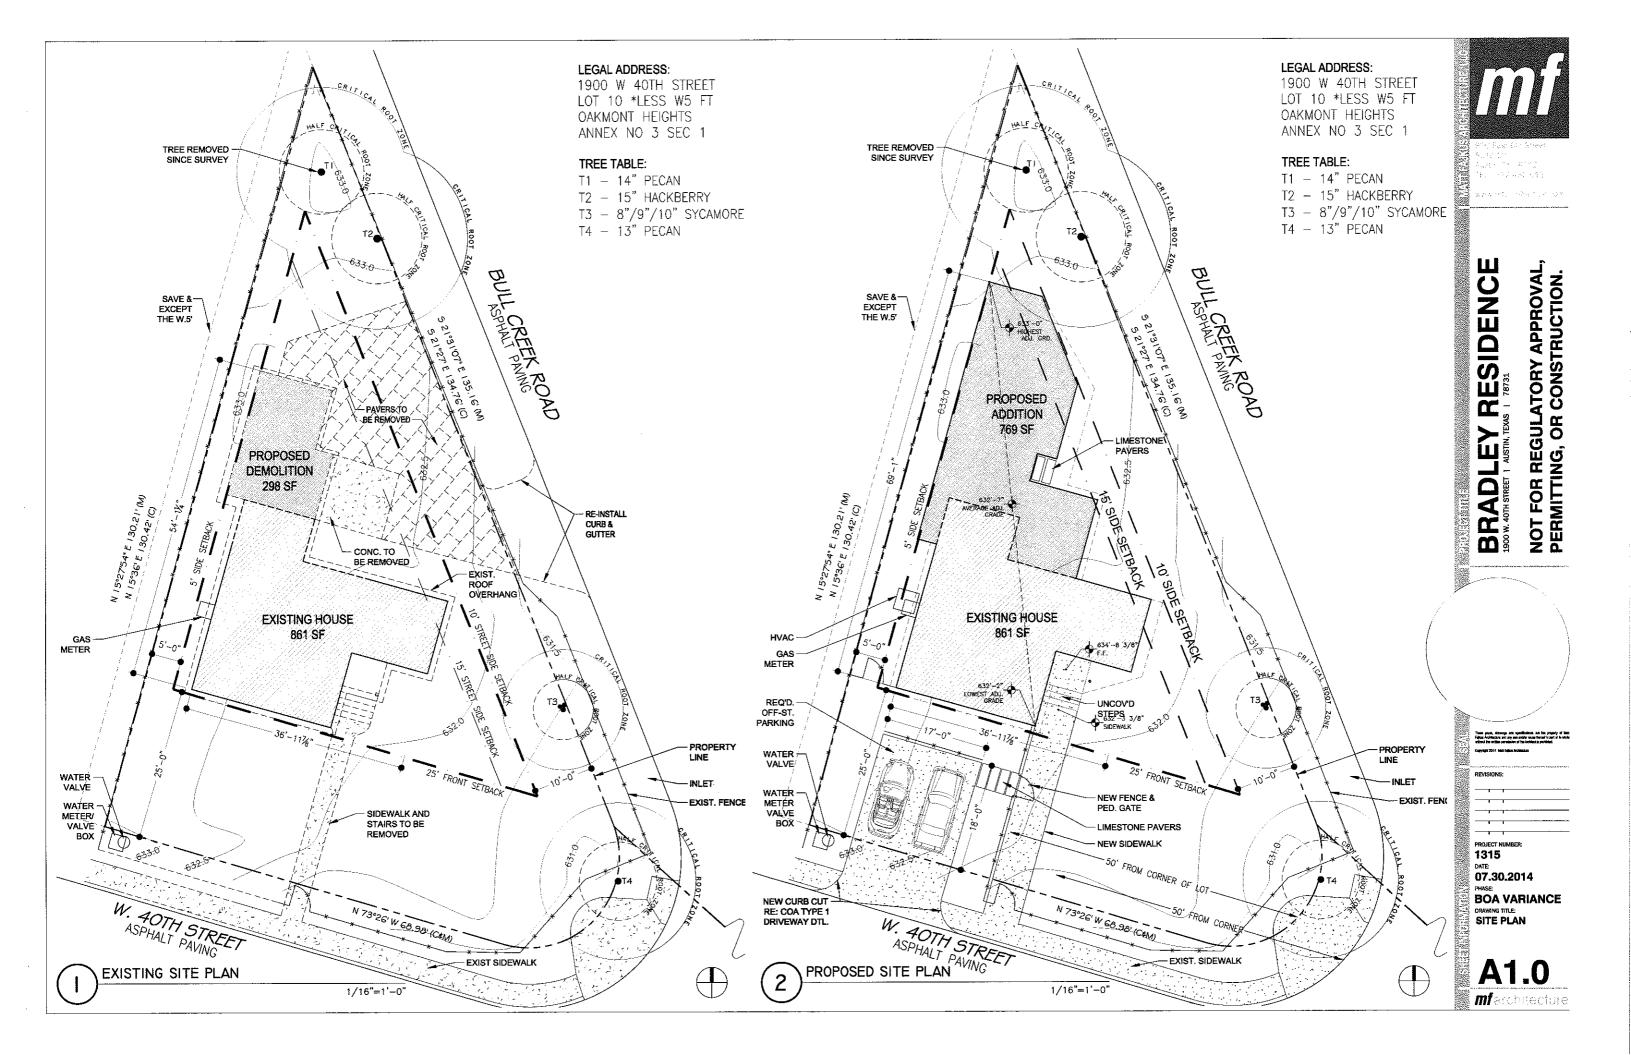

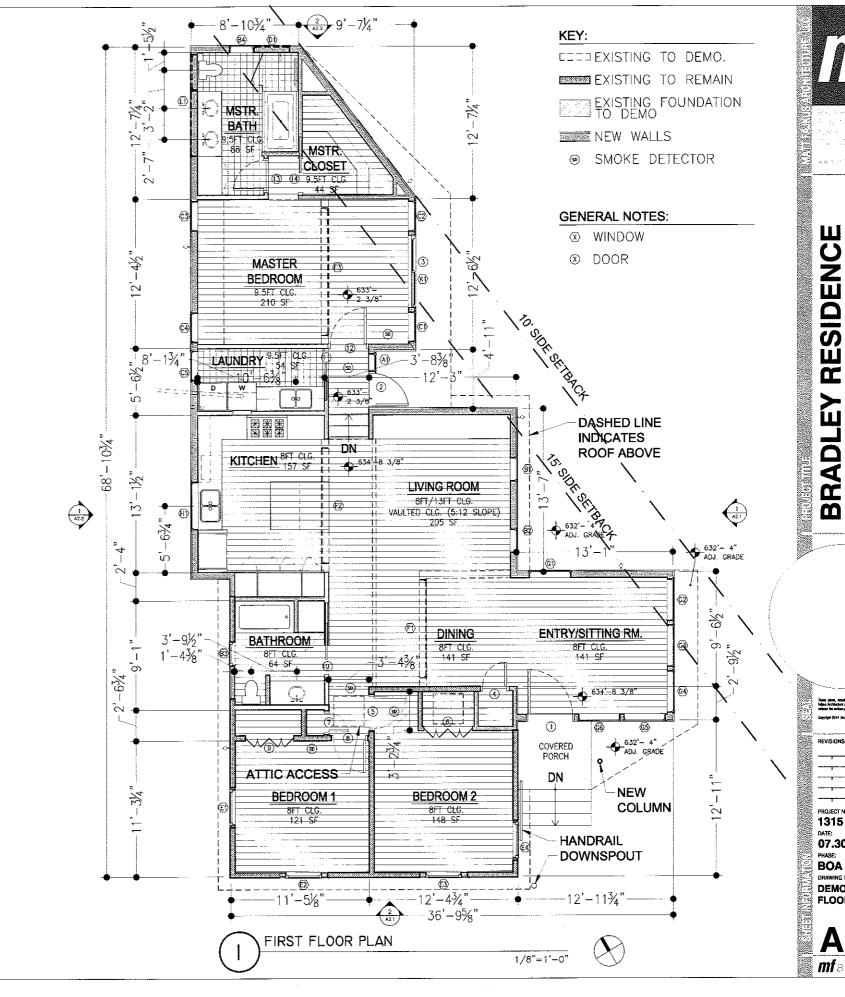

NOT FOR REGULATORY APPROVAL PERMITTING, OR CONSTRUCTION. BRADLEY

PROJECT NUMBER:

DATE: 07.30.2014 BOA VARIANCE

DEMO PLAN & FLOOR PLAN

mf architecture



RESIDENCE

BRADLEY
1900 W. 40TH STREET | AUSTIN, TEX

REASONABLE USE:

15' setback does not allow for reasonable addition to property because of unique lot shape; original house exceptionally small at 861 SF, far below neighborhood average of 1534 SF.

HARDSHIP:

- Angled lot virtually unusable with 15' setback
- · Majority of lots in neighborhood are rectangular

AREA CHARACTER:

SQUARE FOOTAGE in keeping with neighborhood

- Neighborhood Average: 1534 SF
- Proposed Total: 1630 SF

SINGLE-STORY

- · Unobtrusive, maintains the look and feel of area
- Desirable for accessibility

MATERIALS

Renovation involves clean up and re-use of many existing materials

ADJACENCY

- Side yard adjacency where variance is requested is commercial surface parking
- No residential occupancy of TXDOT property

DEGREE:

129 SF total area in violation

PRECEDENCE:

Existing house violates 15' setback, obeys 10'; closest similar lot condition (Southeast, triangular) violates 15' setback, obeys 10'

VISIBILITY:

Does not reduce visibility for cars on 40th Street turning onto Bull Creek

PROJECT NUMBER: 1315


07.30.2014

PHASE: BOA VARIANCE


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SUPPLEMENTAL
INFORMATION

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mf architectore

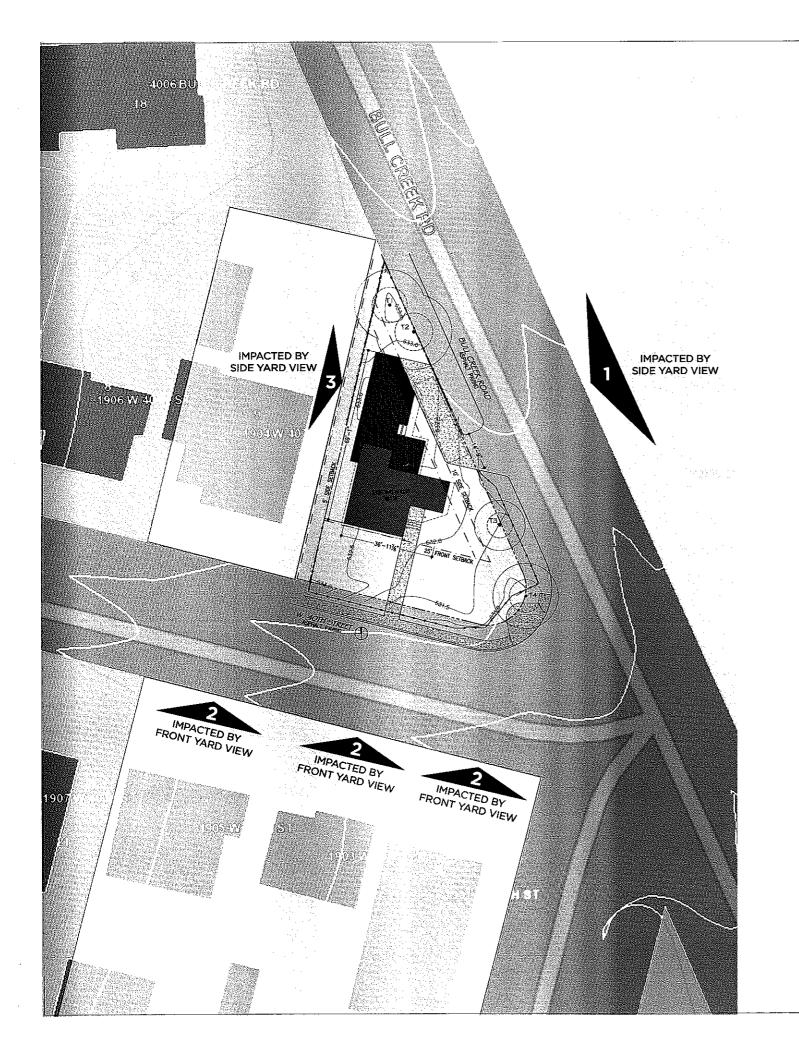


PROPOSED ONE-STORY ADDITION, **SEEKS 10' SETBACK VARIANCE**

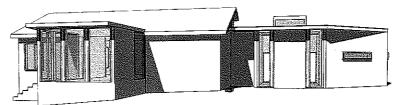

Side yard facing Bull Creek Road; addition maintains height of existing house, mostly hidden by fence




DASHED LINE INDICATES PROPOSED NEW ELEVATION

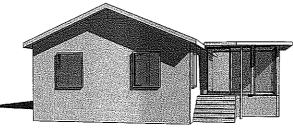

Front yard facing 40th Street, addition not visible from street



DASHED LINE INDICATES PROPOSED NEW ELEVATION

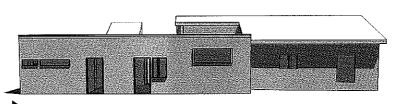

Side yard facing neighbor to the West



RESIDENCE

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1900 W. 40TH STREET | AUSTIN, TEX

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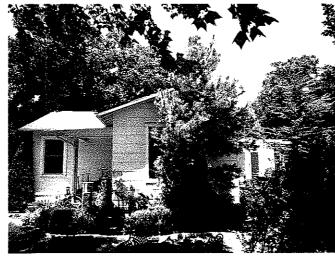
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INFORMATION

mf archiver fund.





LOOKING NORTHWEST FROM CORNER OF FRONT



LOOKING WEST FROM STREET SIDE YARD










LOOKING SOUTHWEST FROM STREET SIDE YARD

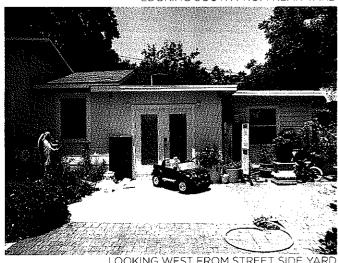

LOOKING WEST FROM STREET SIDE YARD





1900 W. 40TH STREET: EXISTING CONDITIONS


ESIDENCE

PROJECT NUMBER: 1315

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BOA VARIANCE
DRAWING TITLE
SUPPLEMENTAL
INFORMATION

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PROJECT NUMBER: 1315 DAYE: 07.30.2014

PHASE
BOA VARIANCE
DRAWING TITLE
SUPPLEMENTAL
INFORMATION
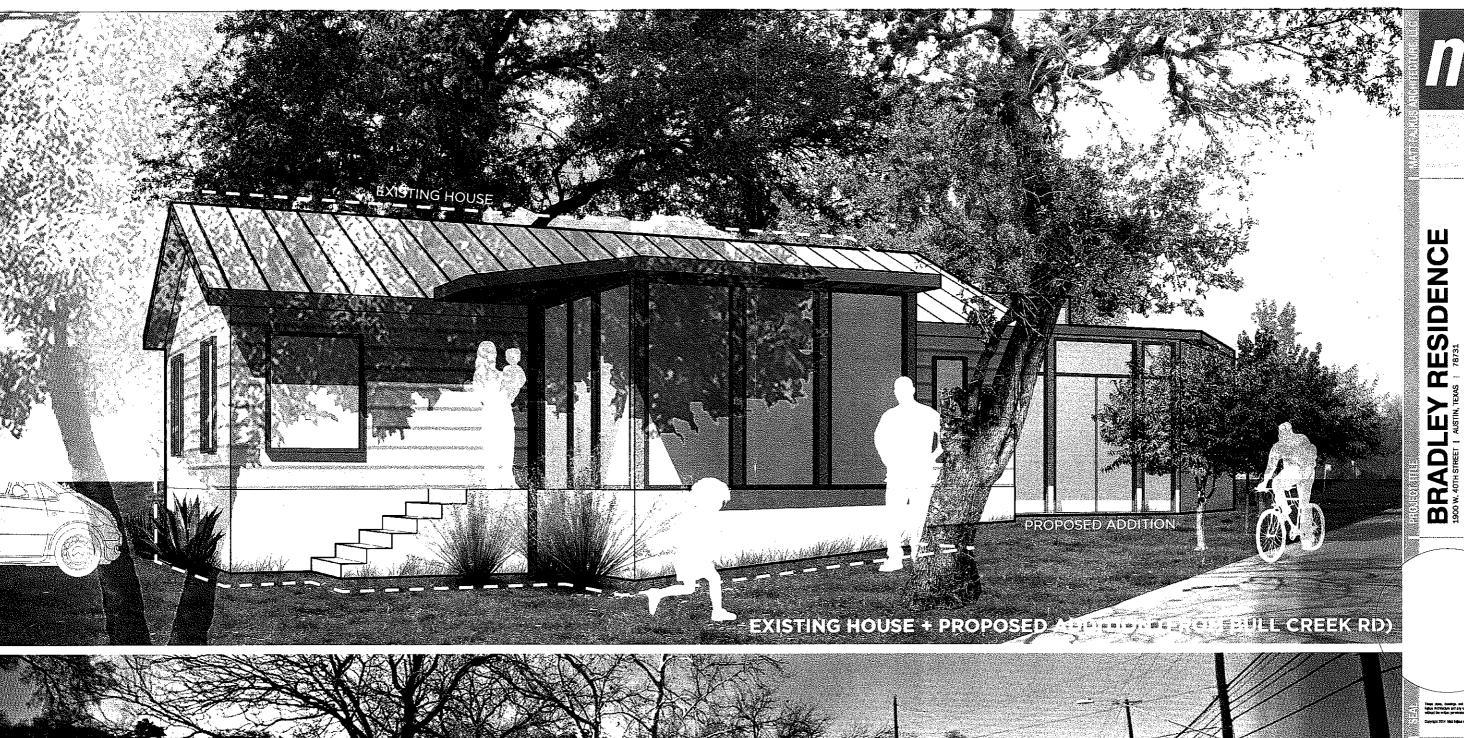
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mf architecture