

NEW/ADDITION 2,096#	MAIN LEVEL CONDITIONED AREA	A.
29#	MAIN LEVEL MASONRY	В.
1,454#	UPPER LEVEL CONDTIONED AREA	С.
Øŧ	UPPER LEVEL MAGONRY	D.
176#	LOWER LEVEL CONDITIONED AREA	E.
24#	LOWER LEVEL MASONRY	F.
	LOWER LEVEL UNCONDITIONED SPACE	G.
1,319#	GARAGE	
33Ø#	EXERCISE	
1Ø2#	STORAGE	
217#	GARAGE ENTRY COVER	
5034	OFFICE / CABANA	H.
281	OFFICE / CABANA MASONRY	I.
500	APARTMENT	J.
Ø	APARTMENT MAGONRY	K.
227#	PATIO UNDER CABANA	L.
624# / 312#	WOOD DECK / (50%)	M.
5714	OUTDOOR LIVING / DINING	N.
1654	COVERED ENTRY	О.
47#	APARTMENT ENTRY	P.
264	CABANA ENTRY	Q.
11	STAIRS TO COVERED PATIO UNDER CABANA	R
100#	SWIMMING POOLS (POOL SURFACE AREA)	S.
Ø		
8,309	TOTAL BUILDING AREA	
3,731*	TOTAL BUILDING COVERAGE ON LOT	
26.43% OF LOT (14,113 SQ FT LOT,	(SUBTRACT CDEG, JKL, & R)	

AREA	NEW/ ADDITION
TOTAL BUILDING COVERAGE	3,731#
DRIVEWAY (UNCOVERED)	73!#
SIDEWALKS/WALKWAYS	364#
UNCOVERED PATIOS	Ø#
AC PADS	33#
RETAINING WALLS	50#
UNCOVERED WOOD DECKS (50%)	692# / 346*
TOTAL IMPERVIOUS COVER	5,255#
TOTAL LOT AREA	14,113#

AREA	TOTAL
PAVER6	111#
DRIVEWAY	398#
TOTAL IMPERVIOUS COVER	509#
TOTAL AREA IN FRONT YARD	1,836#
509#/ 1,836# x 100 = 27.7% PERCENTAGE OF LOT	
ALLOWABLE IMPERVIOUS COVERAGE: 1,836# x 40% = 1341#	

5,068#/14,113# x 100 = 35.9% FLOOR-TO-AREA RATIO (FAR) ALLOWABLE FAR: 14,113# x 40% = 5,645#



VICINITY MAP

A SHEET of 13 PROJECT NO. 14162 CRR DRAWN BY: 02/18/15 -PC, AJS CRR-DATE:

CHECKED BY: PROJECT MGR:

GENERAL PROJECT NOTES


- 10 THESE CONSTRUCTION DOCUMENTS ARE INTENDED TO MEET ALL APPLICABLE CODES AND ORDINANCES. CONTRACTOR TO COMPLY WITH ALL LOCAL CODES, ORDINANCES AND DEED RESTRICTIONS. CONTRACTOR SHALL ALSO REQUIRE ALL SUBCONTRACTORS TO COMPLY WITH THESE REGULATIONS.
- 2.0 ANY DISCREPANCIES IN CONSTRUCTION DOCUMENTS OR NONCOMPLIANCE TO BE BROUGHT TO THE ATTENTION OF THE ARCHITECT PRIOR TO ANY WORK BEING PERFORMED OR MATERIALS BEING ORDERED.
- 3.0 BUILDER ACCEPTS FULL RESPONSIBILITY FOR CHECKING PLANS TO ASSURE CONFORMITY TO CURRENT LOCAL BUILDING CODES. SHOULD ANY CHANGES BE MADE TO THESE PLANS BY BUILDER OR HIS REPRESENTATIVES WITHOUT CONTACTING THE ARCHITECT, THE BUILDER WILL ACCEPT FULL LIABILITY FOR AMENDED PLANS.
- 4.0 ARCHITECTS ARE GOVERNED BY THE TEXAS BOARD OF ARCHITECTURAL EXAMINERS, (512)458-1363.


GENERAL PLAN NOTES:


- 1.0 ALL WINDOWS WILL BE DIMENSIONED TO CENTER LINE UNLESS OTHERWISE NOTED. GLASS SIZE PER MFR. SPECS.
- 20 ALL WINDOWS WITHIN 24" OF AN EXTERIOR OR INTERIOR DOOR TO BE TEMPERED GLASS. WINDOW MANUFACTURER TO VERIFY FOR ALL TEMPERED GLASS LOCATIONS AS PER APPLICABLE CODE.
- 3.0 ALL HINGED SHOWER DOORS SHALL SWING OUTWARD. GLAZING USED IN DOORS AND PANELS OF BATHTUB/SHOWER ENCLOSURES AND BUILDING WALLS ENCLOSING THESE COMPARTMENTS SHALL BE FULLY TEMPERED OR LAMINATED SAFETY GLASS.
- 4.0 WINDOW MANUFACTURER & BUILDER TO VERIFY EGRESSABLE WINDOWS INSTALLED WHERE REQUIRED BY CODE.

- 5.0 WHILE THESE DRAWINGS ARE INTENDED TO SHOW SAME, THE ARCHITECT IS NOT RESPONSIBLE FOR GOVERNING AUTHORITY INTERPRETATIONS WHERE THOSE INTERPRETATIONS CONFLICT WITH THESE DRAWINGS \$/OR SPECS.
- 6.0 PORTIONS OF THIS WORK MAY NOT HAVE BEEN DRAWN BY A REGISTERED ARCHITECT.
- 1.0 THESE DRAWINGS/SPECS ARE INSTRUMENTS OF SERVICE AND SHALL REMAIN THE PROPERTY OF THE ARCHITECT WHETHER THE PROJECT IS EXECUTED OR NOT. THESE DRAWINGS SHALL NOT BE USED BY THE CLIENT FOR OTHER PROJECTS, FOR ADDITIONS TO THIS PROJECT, OR FOR COMPLETION OF THIS PROJECT BY OTHERS WITHOUT PERMISSION OF THIS ARCHITECT.
- 8.0 THESE DOCUMENTS DO NOT SHOW TYPICAL DETAILING 4/OR WATERPROOFING.
- 9.0 THESE DOCUMENTS DO NOT SPECIFY ACTUAL PRODUCTS OR MATERIAL SELECTIONS. CONTRACTOR ACCEPTS FULL RESPONSIBILITY FOR APPROPRIATE AND PROPER DETAILING FOR AND BETWEEN ALL ACTUAL PRODUCTS/MATERIALS SELECTED WHEN INSTALLED.
- 5.0 THESE DOCUMENTS REFLECT NOMINAL WINDOW SIZES. WINDOW MANUFACTURER TO USE STANDARD SIZES UNLESS NOTED OTHERWISE.
- 6.0 PROVIDE BLOCKING FOR CEILING FANS WHERE SPECIFIED. 1.0 PROVIDE ELECTRIC FOR POOL \$/OR SPA EQUIP. \$ LIGHTS. PROVIDE NECESSARY PLUMBING FOR POOL
- 4/OR SPA. VERIFY LOCATION WITH BUILDER OR OWNER. 8.0 BUILDER TO VERIFY SIZING AND LOCATION OF ALL APPLIANCES & RELATED COMPONENTS.
- 9.0 WEATHERSTRIP ATTIC ACCESS DOOR(S).
- 10.0 CONTRACTOR TO PROVIDE A 3/4" PLYWOOD CATWALK FROM ATTIC ACCESS TO HVAC UNITS (IF APPLICABLE), UNITS TO BE LOCATED WITHIN 20'-O" OF ACCESS.

- 10.0 ALL COMPONENTS, MATERIALS, ASSEMBLIES AND FINISHES TO BE CONSTRUCTED AND INSTALLED PER MANUFACTURER'S RECOMMENDATIONS, CODE REQUIREMENTS AND REGULATED BUILDING PRACTICES.
- 11.0 ARCHITECT IS NOT RESPONSIBLE FOR MEANS AND METHODS OF CONSTRUCTION WHICH ARE NOT DETAILED IN THESE CONSTRUCTION DOCUMENTS. CONTRACTOR WILL BE RESPONSIBLE FOR ALL ASPECTS OF CONSTRUCTION INCLUDING BUT NOT LIMITED TO ALL WATER AND DAMP PROOFING, LOAD CONNECTIONS AND MECHANIC, ELECTRICAL AND PLUMBING SYSTEMS.
- 12.0 ALL MATERIALS AND LABOR TO BE GUARANTEED FOR ONE YEAR FROM THE DATE OF FINAL PAYMENT, IN ADDITION TO ALL WARRANTIES THAT ARE STANDARD TO THE INDUSTRY, CONTRACTOR TO PROVIDE (SUPPLY AND INSTALL) ALL EQUIPMENT, LABOR SERVICES, AND MATERIALS REQUIRED FOR THE COMPLETE APPROVED INSTALLATION OF THE SYSTEMS CALLED FOR
- 11.0 IN VENTED ROOF ASSEMBLIES PROVIDE 1 SF. NET FREE AREA OF ATTIC VENTILATION PER 150 SF. OF TOTAL COVERED ROOF AREA AS PER CODE.
- 12.0 IF PLATE HEIGHT IS 3'-O" OR HIGHER, ALL DOORS AND CASED OPENINGS TO BE 8'-0" HT. UNLESS NOTED OTHERWISE. IF PLATE HEIGHT IS 9'-0" OR LESS, ALL DOORS AND CASED OPENINGS TO BE 6'-8" HT. UNLESS NOTED OTHERWISE. EXCEPTION ... IF A 7'-0" HT. DOOR IS USED ADJUST WINDOWS TO 1'-0" HEADER HT.
- 13.0 ALL PLUMBING, APPLIANCE AND GAS VENTS TO VENT TO REAR OF ROOF RIDGE WHEREVER POSSIBLE. ALL VENTS TO BE GANGED TO THE FEWEST NUMBER POSSIBLE PENETRATING THE ROOF.
- 14.0 PROVIDE CONTROL AND EXPANSION JOINTS AS REQUIRED ON CONCRETE DRIVES, WALKS AND PATIOS.

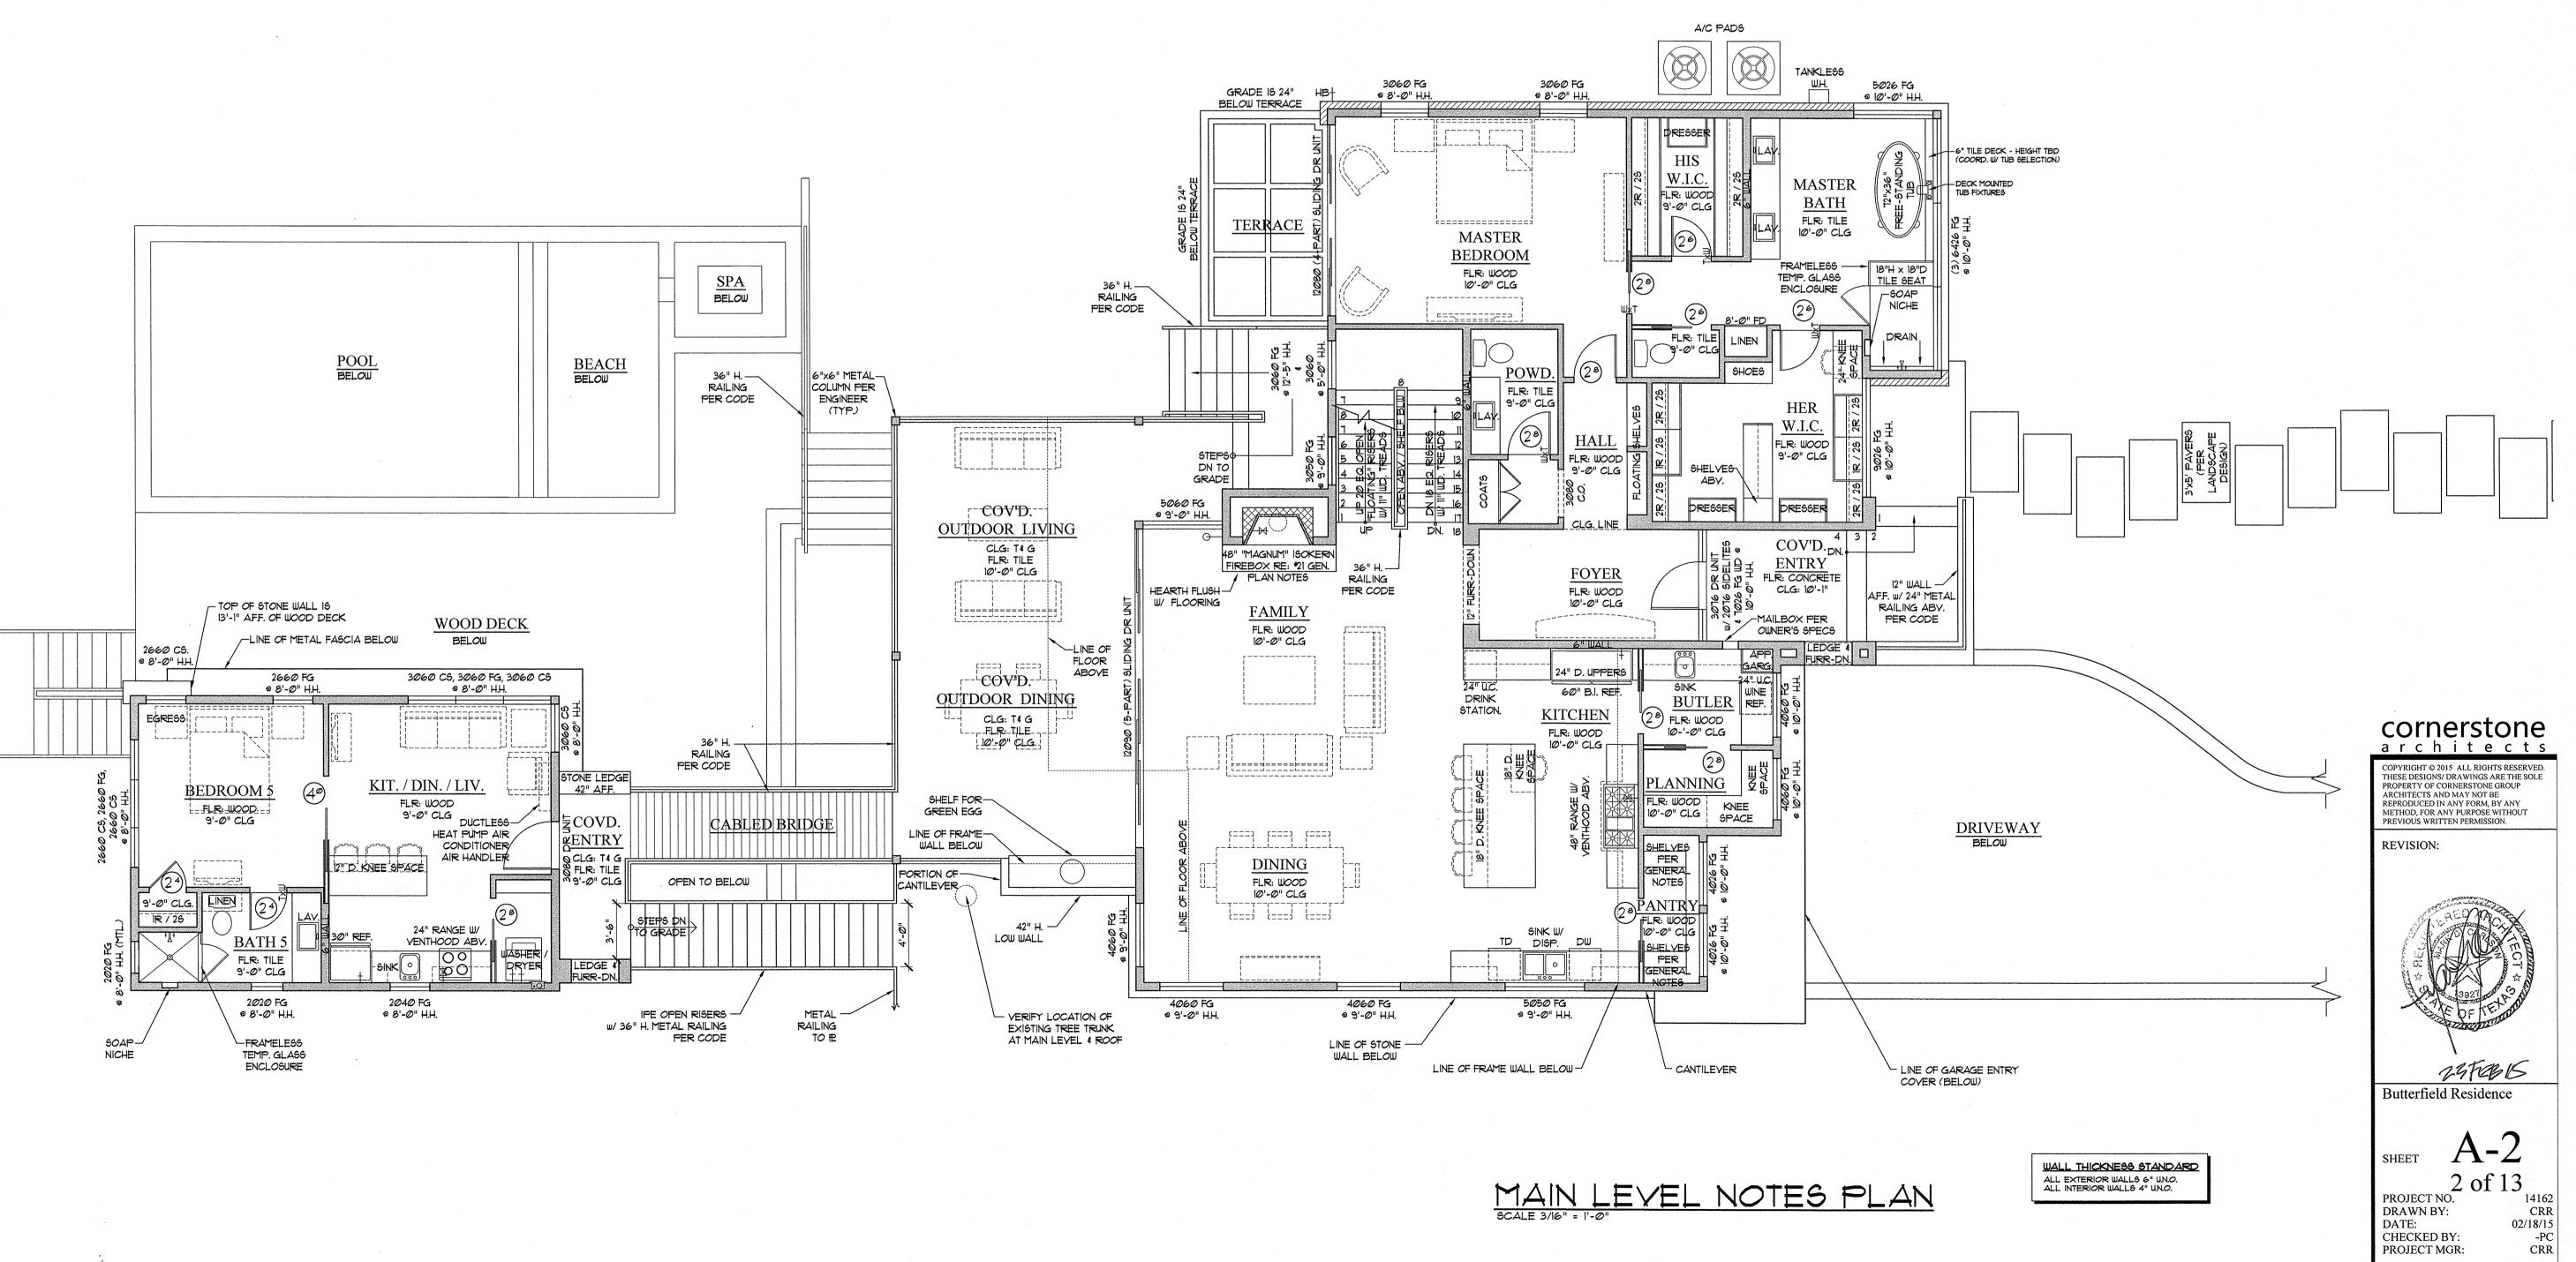

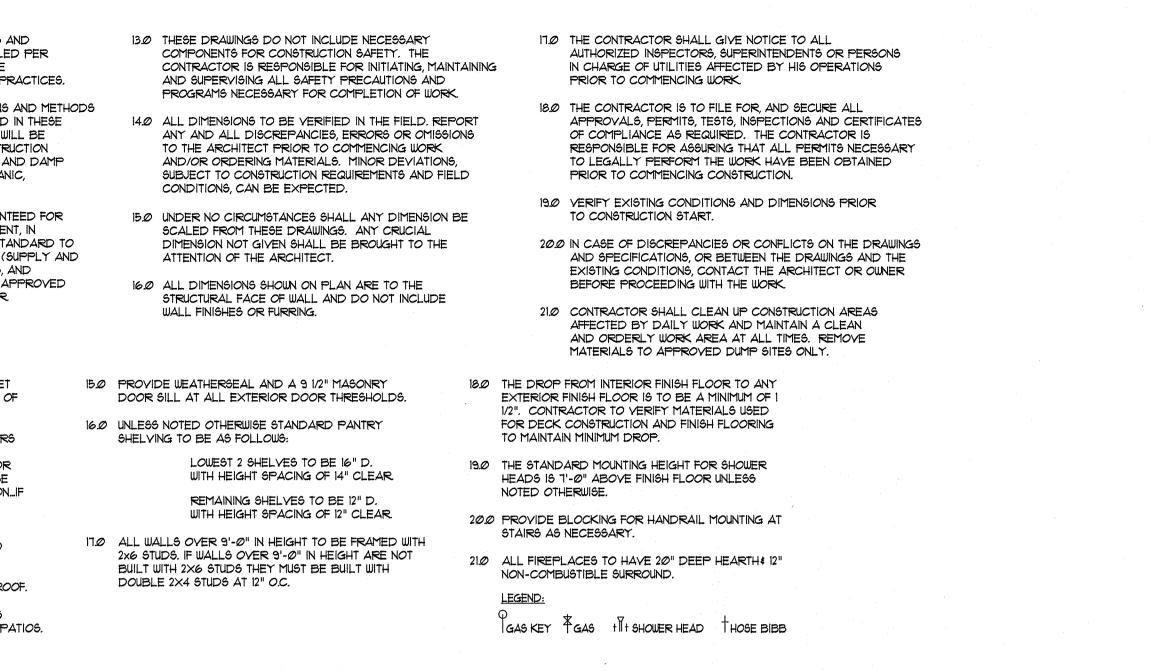

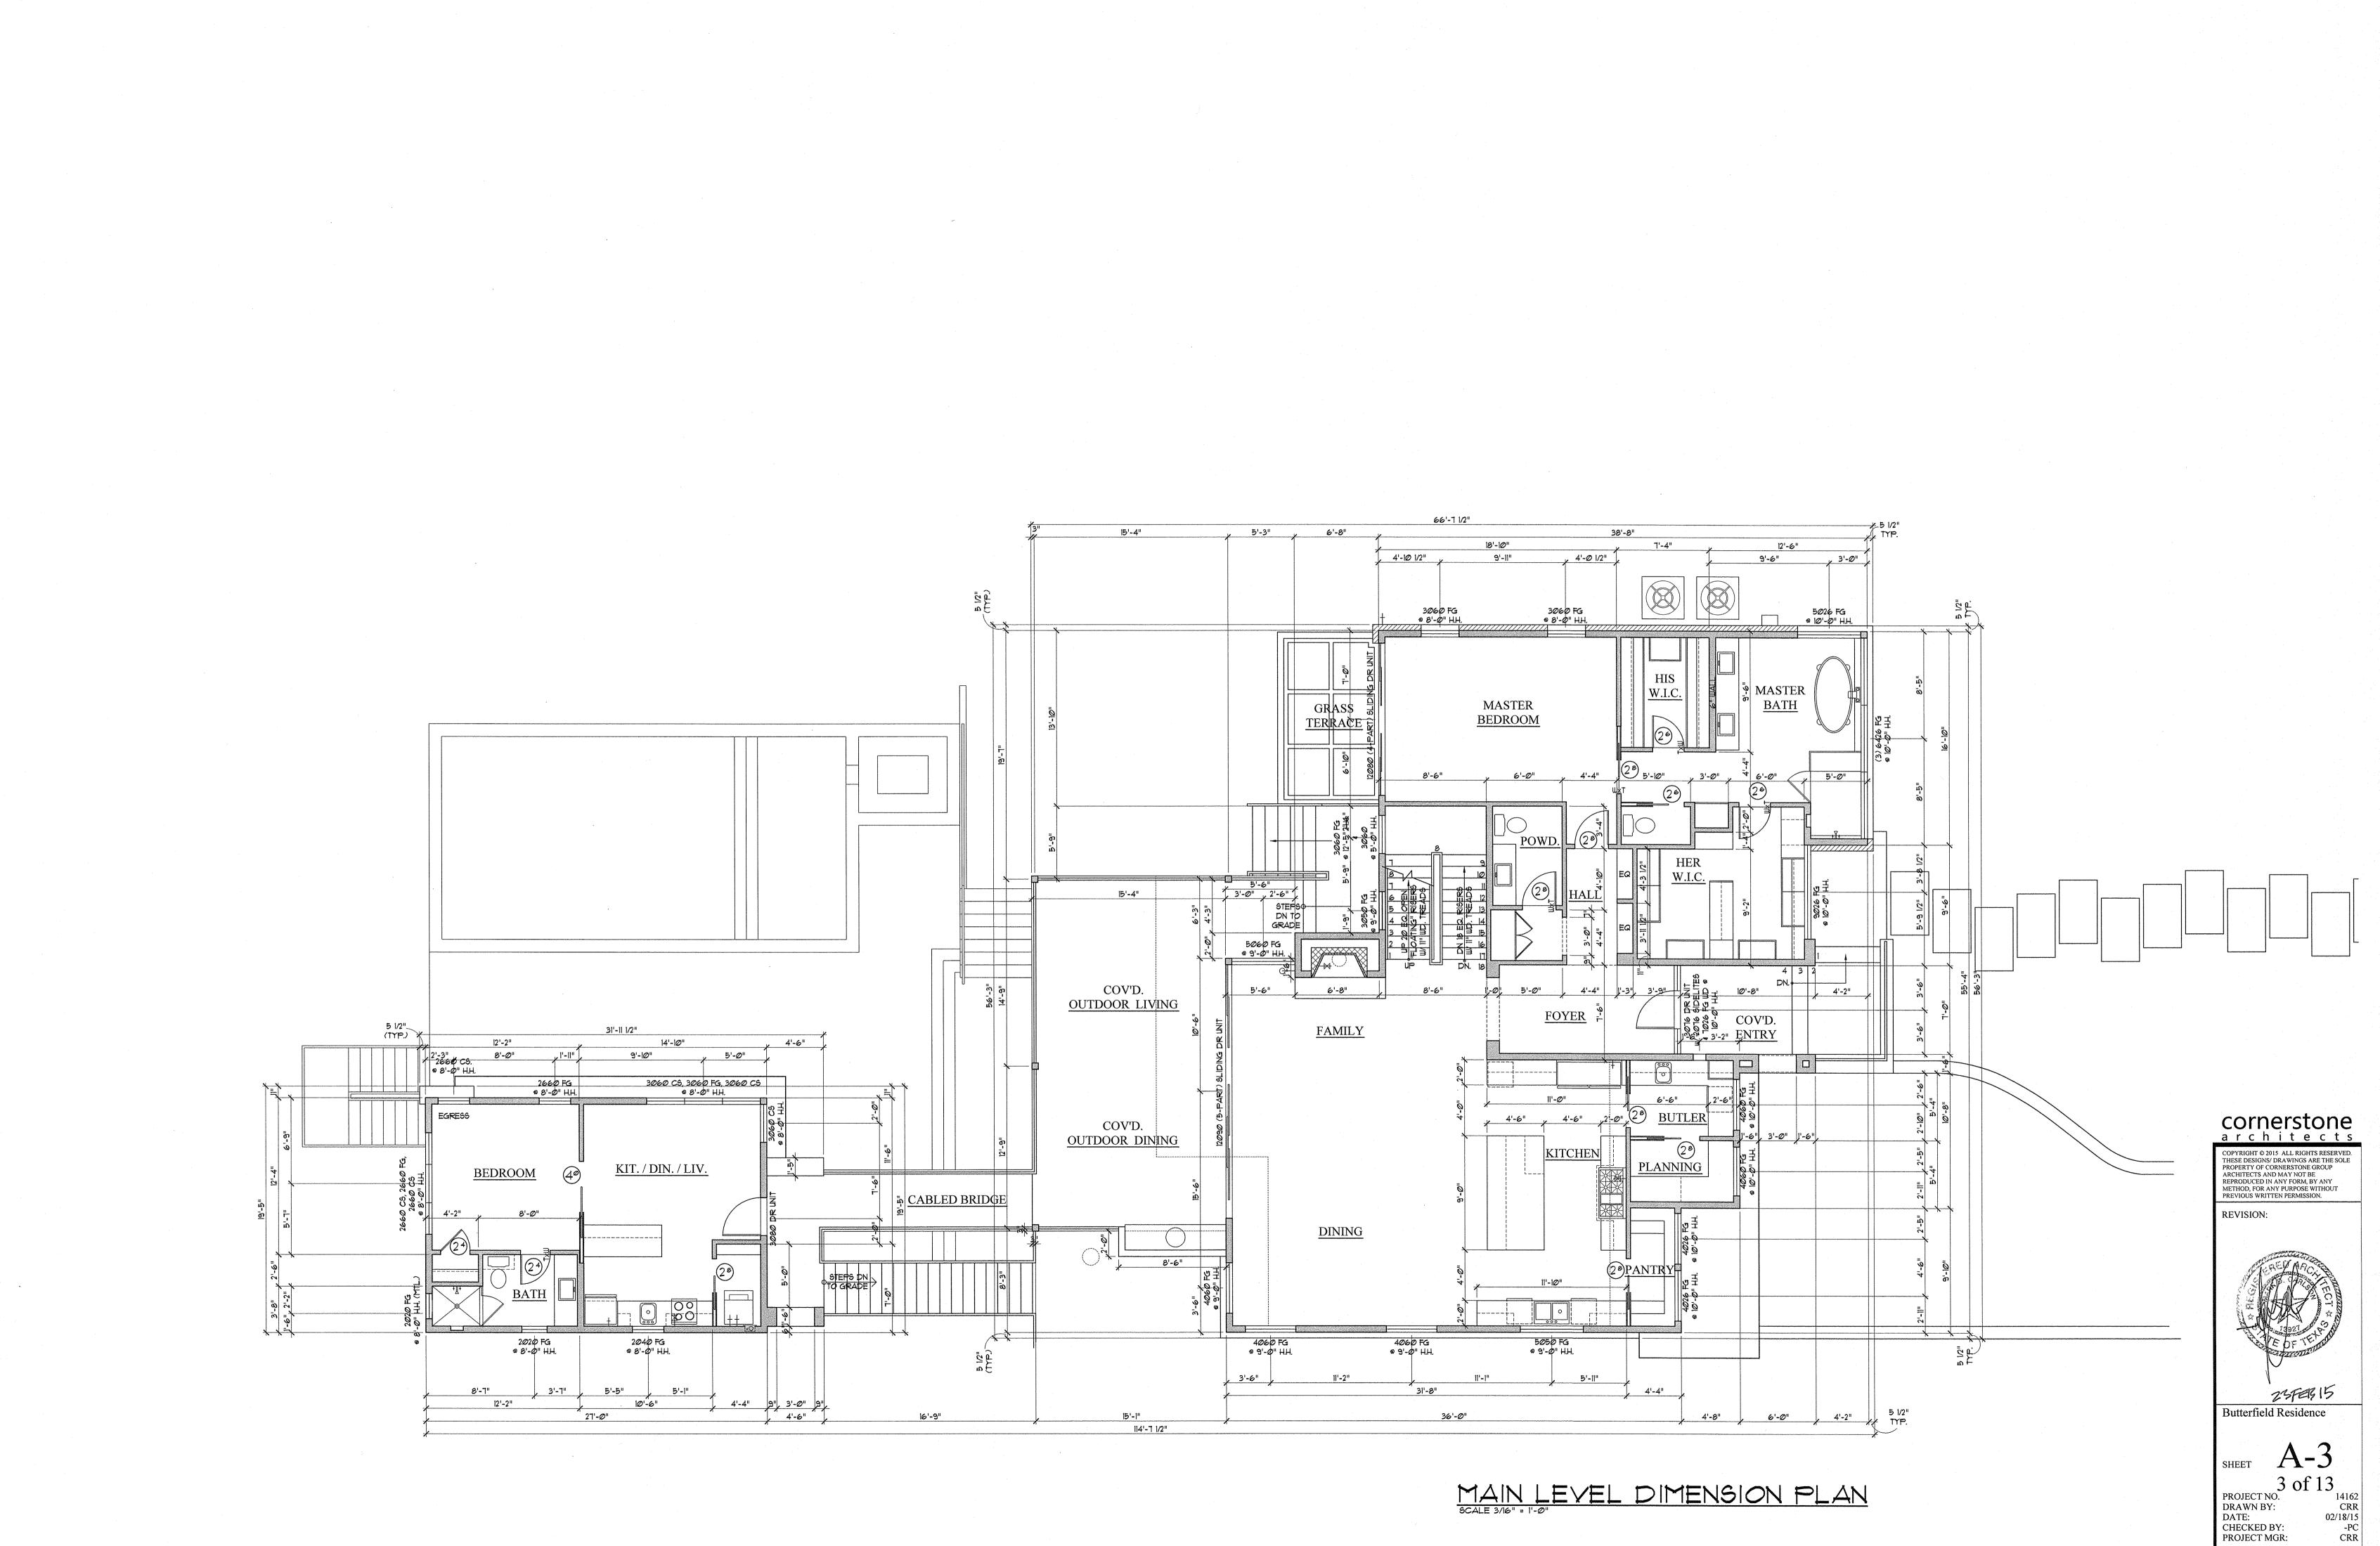


•

•


ROOF OF APARTMENT / CABANA


UPPER LEVEL NOTES PLAN

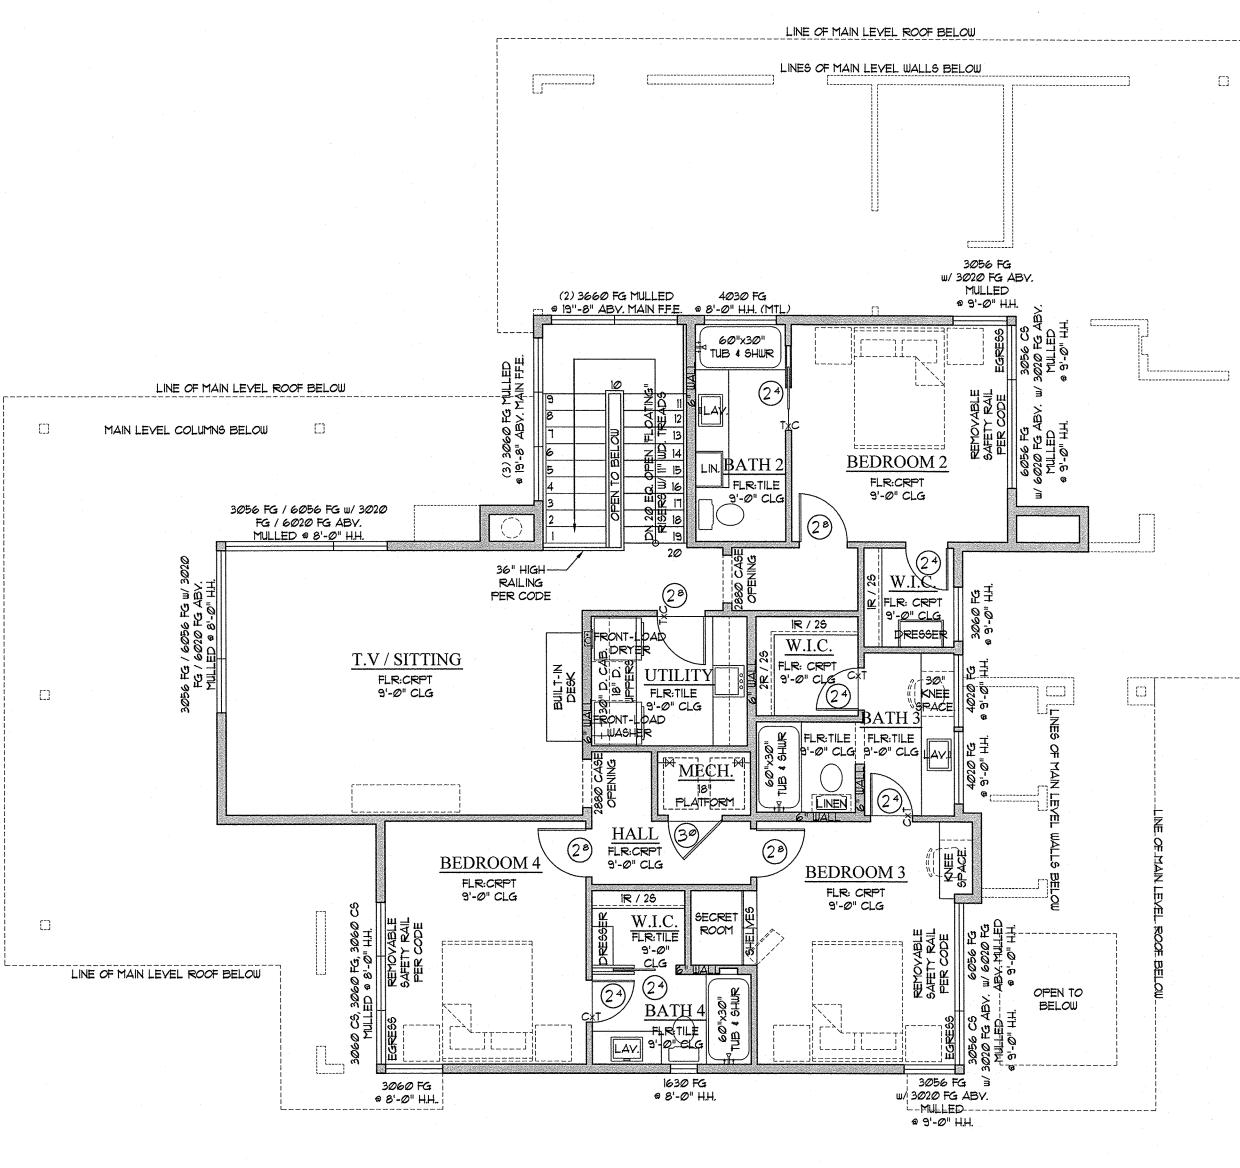


*


WALL THICKNESS STANDARD ALL EXTERIOR WALLS 6" UNO. ALL INTERIOR WALLS 4" UNO.

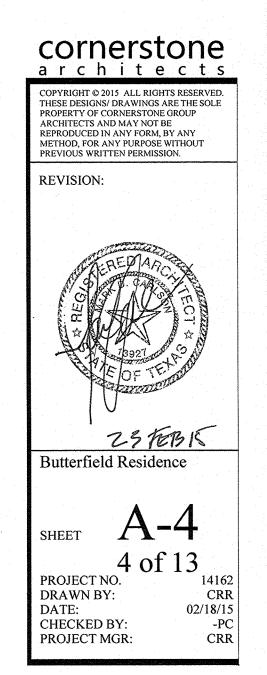

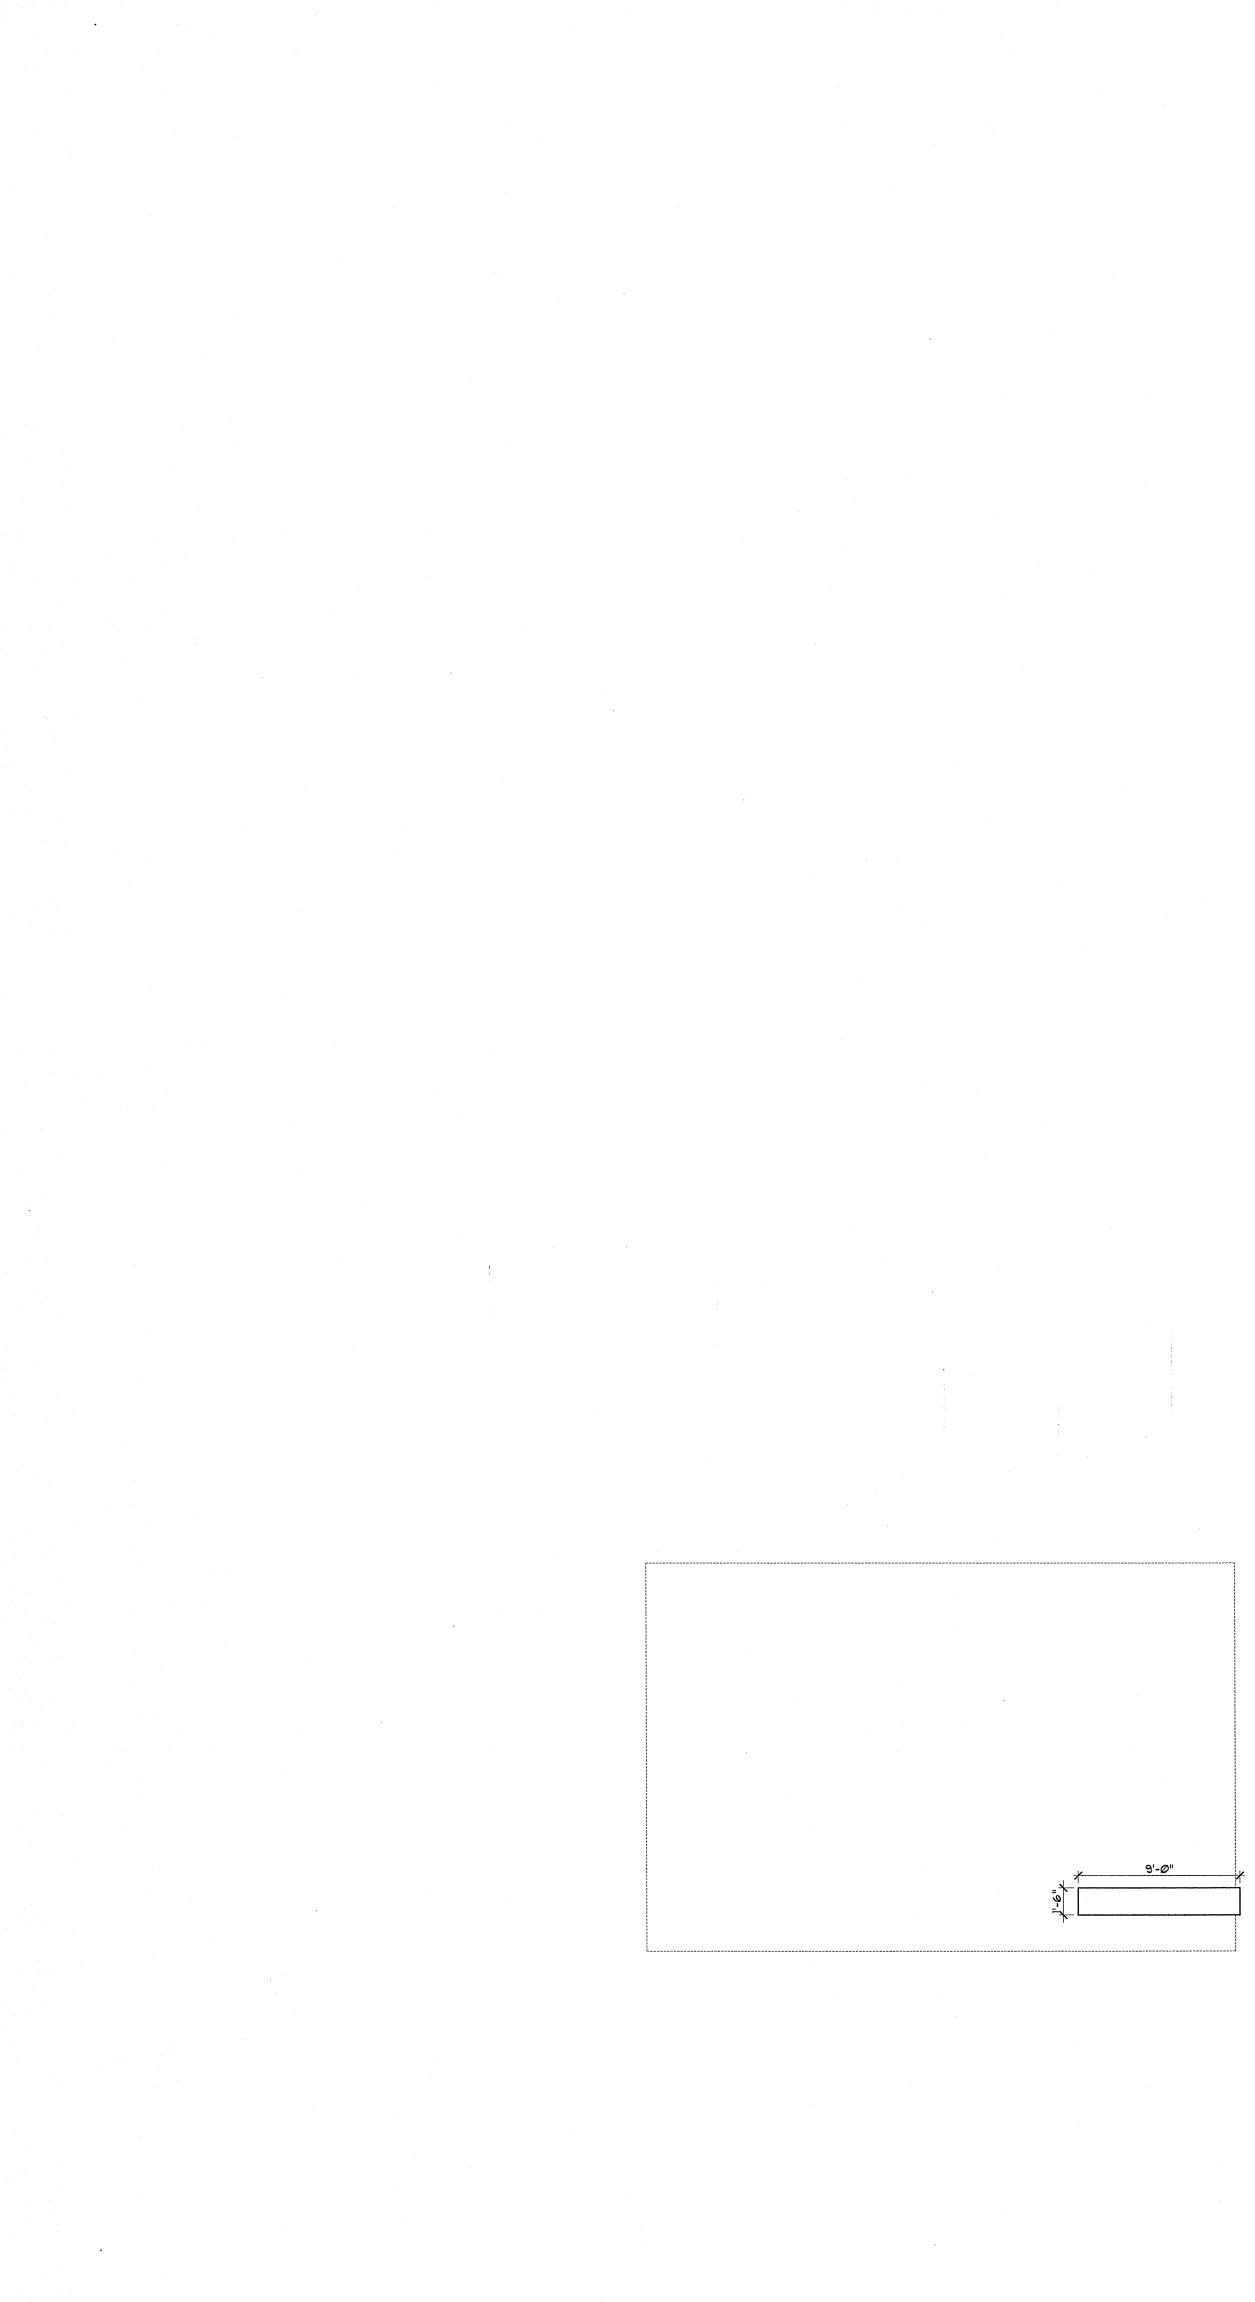





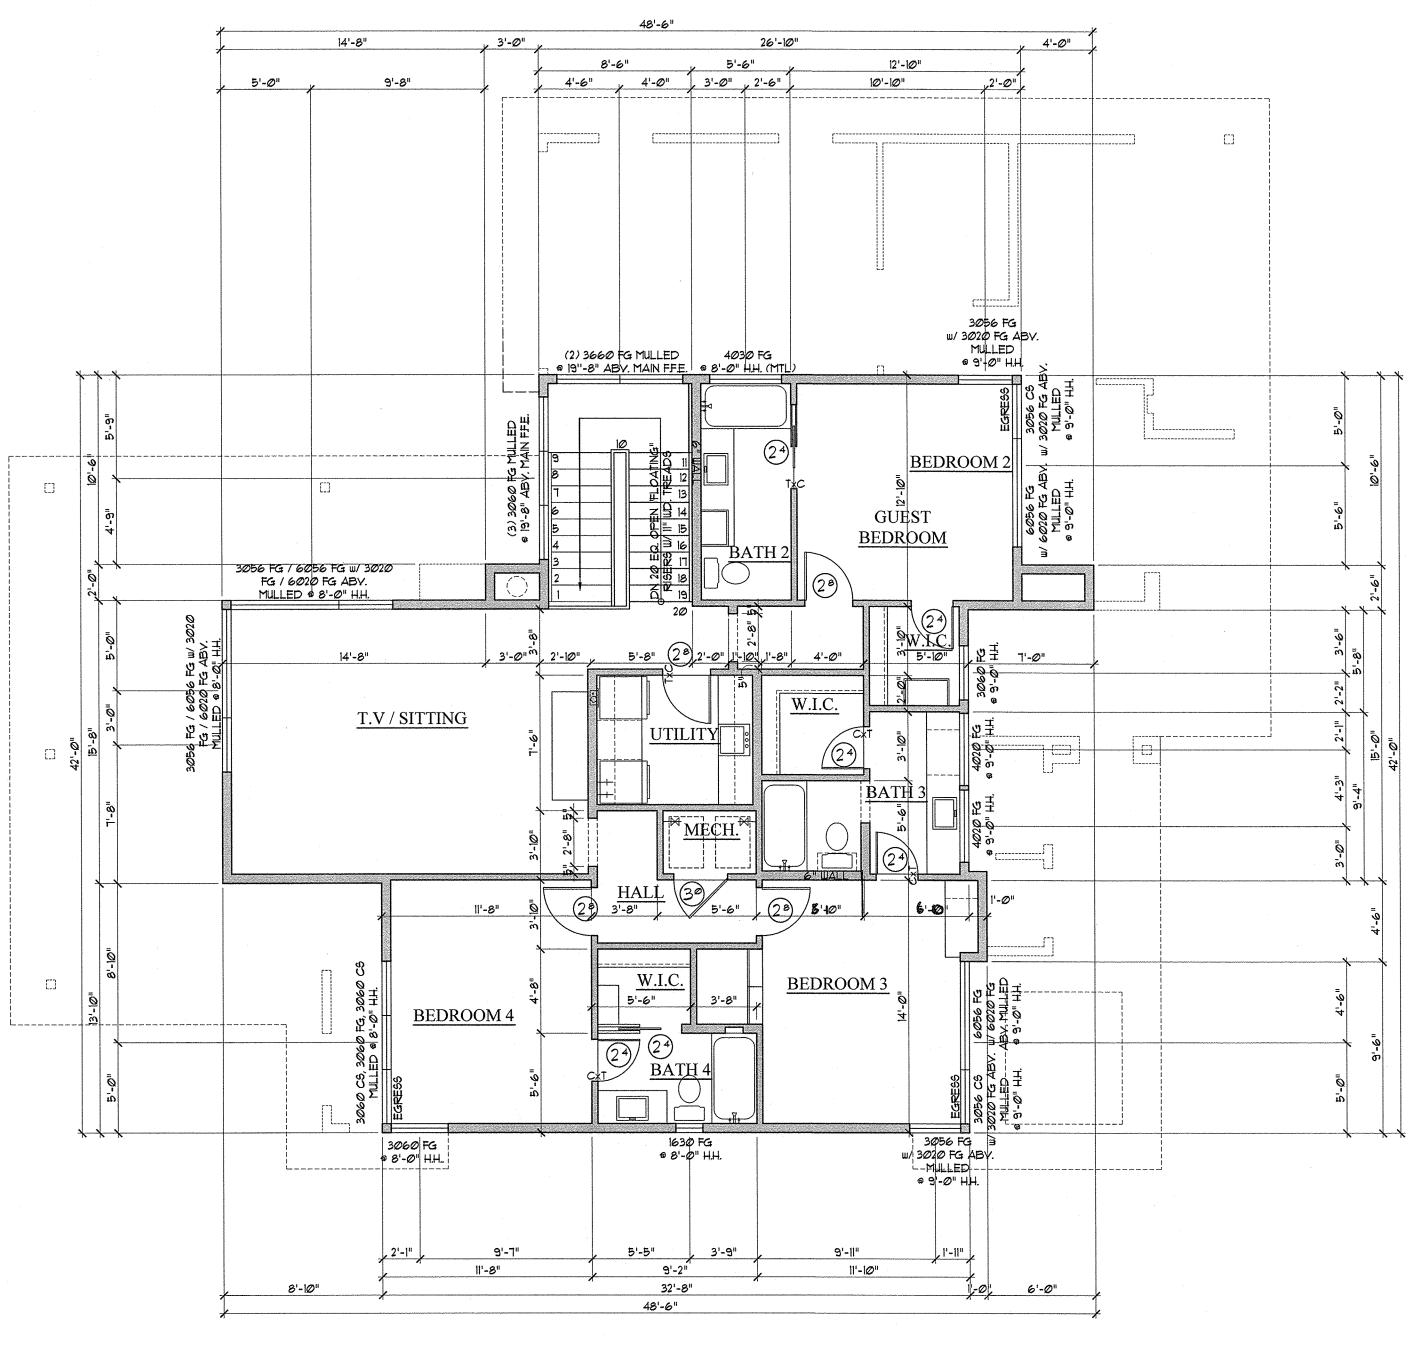

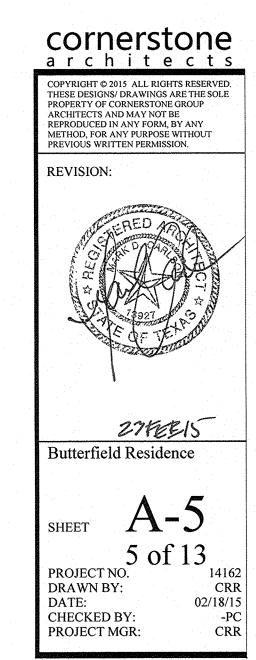

.

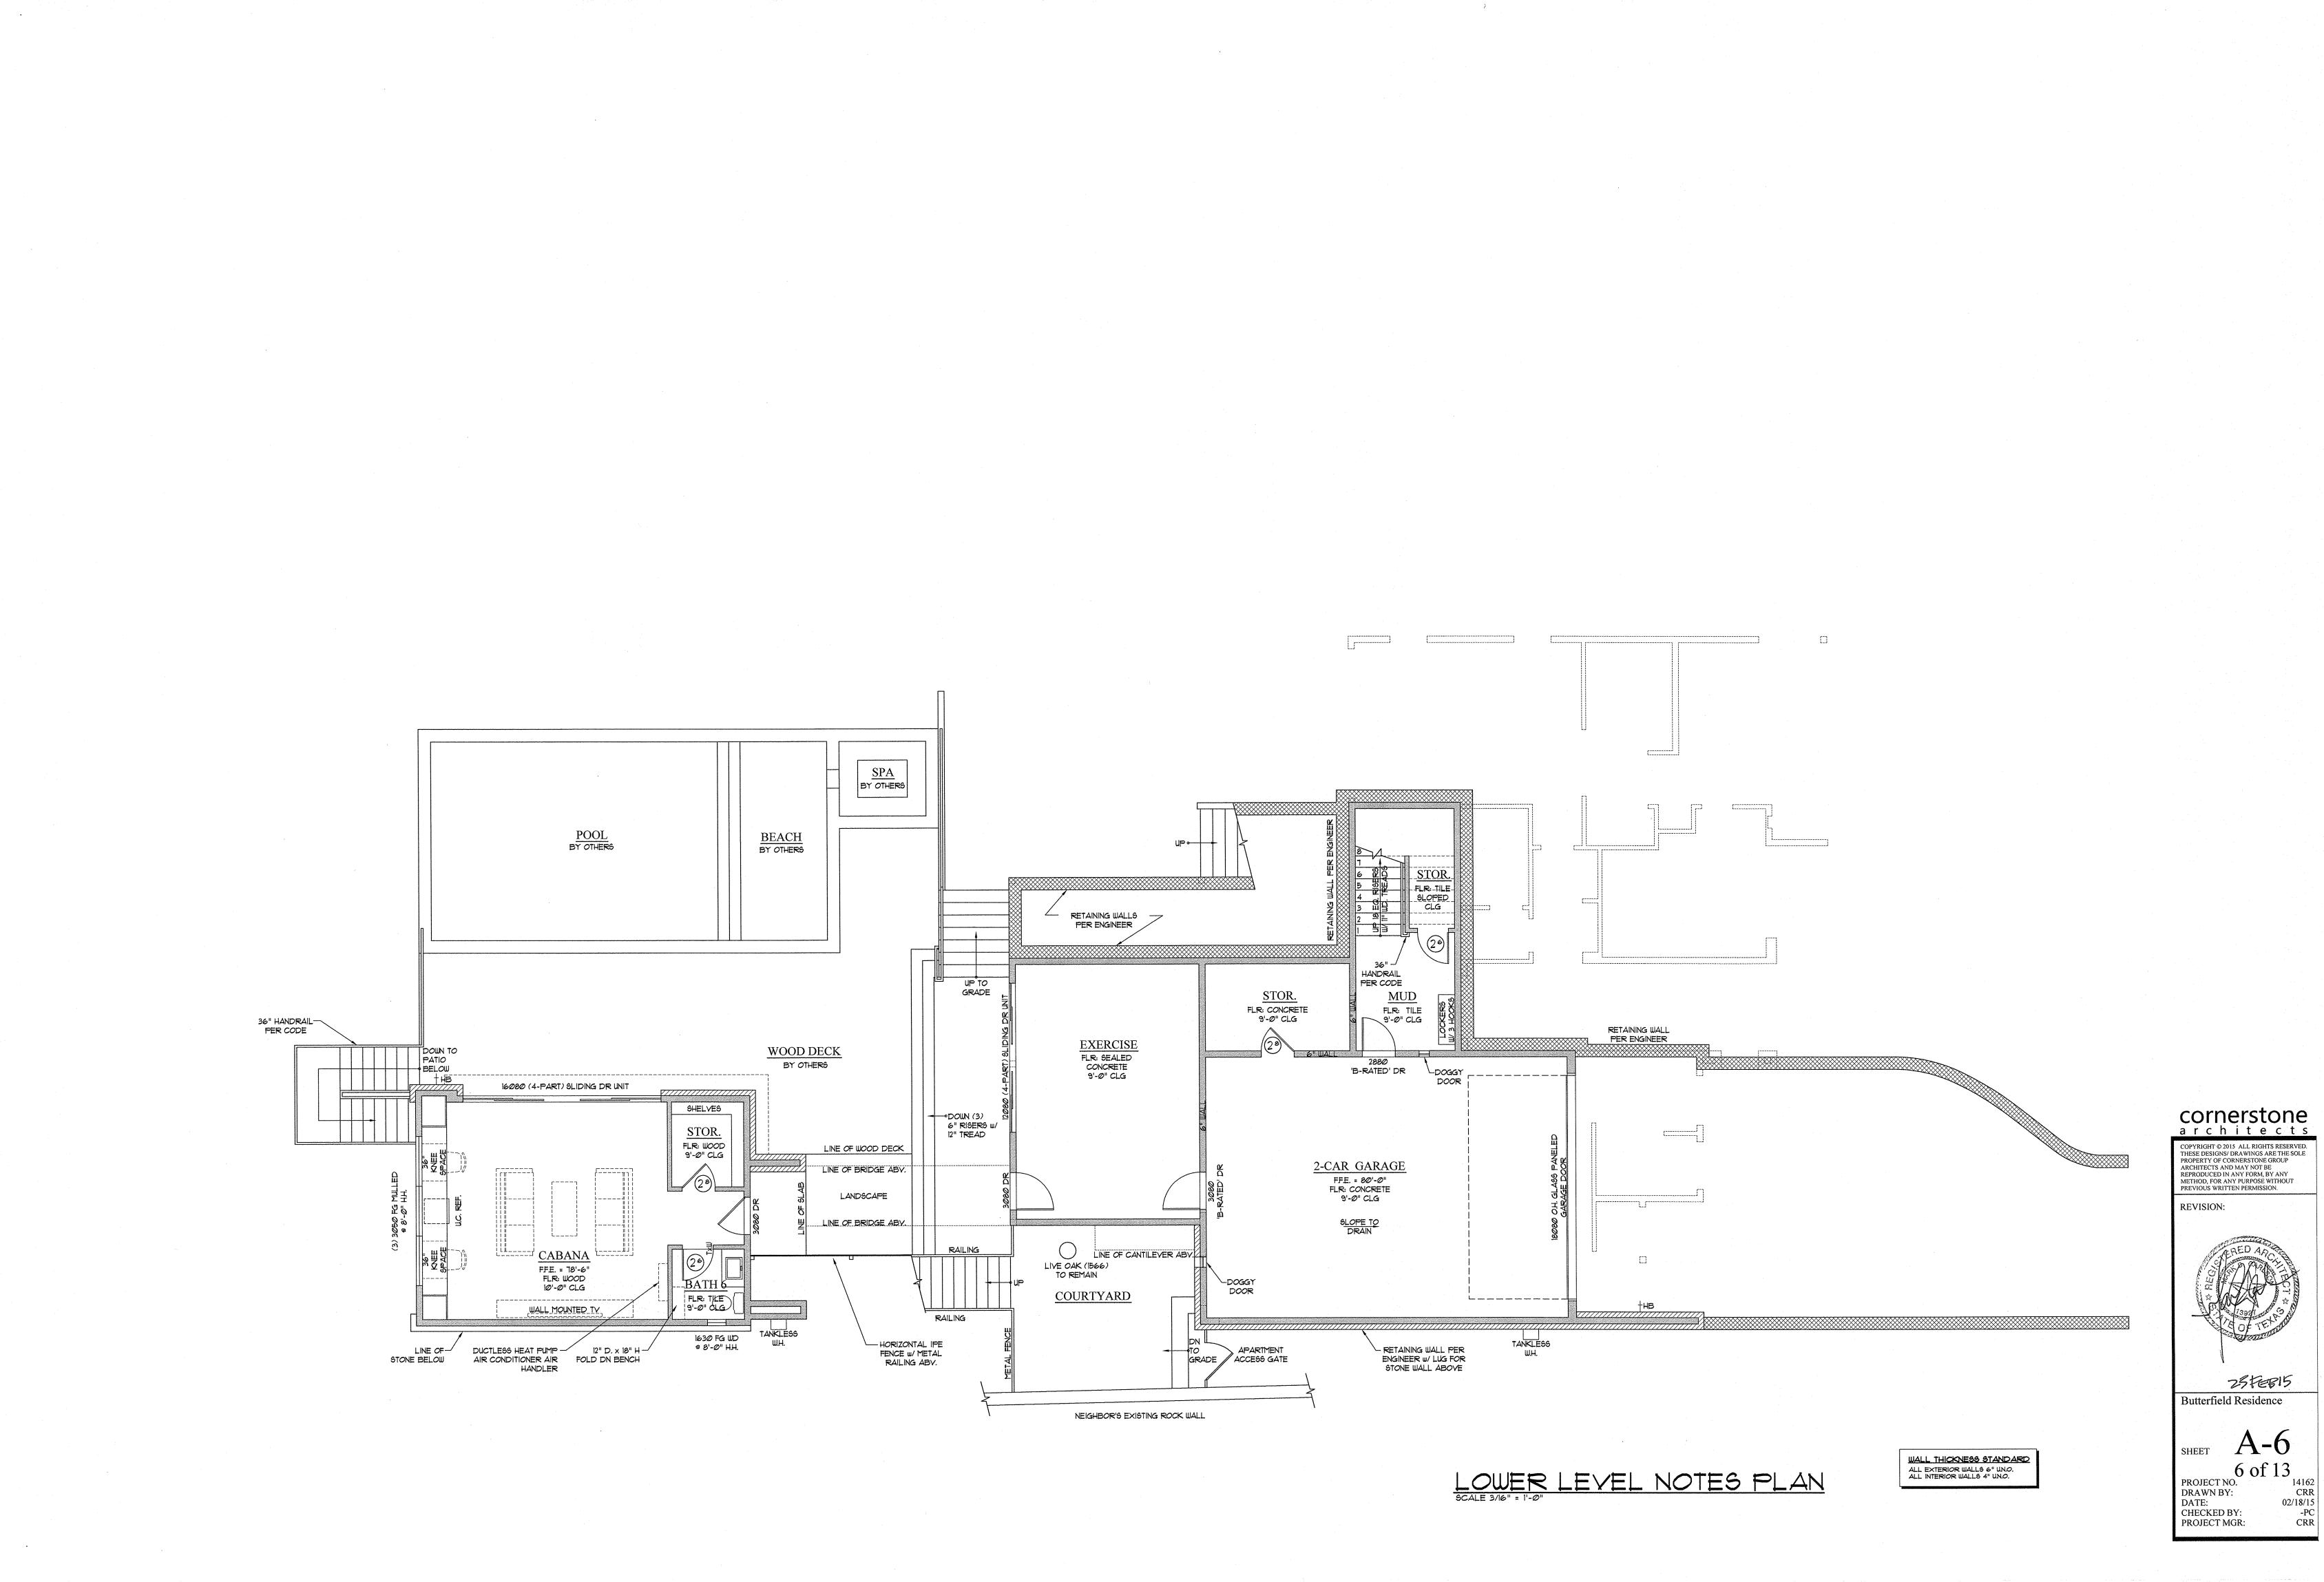


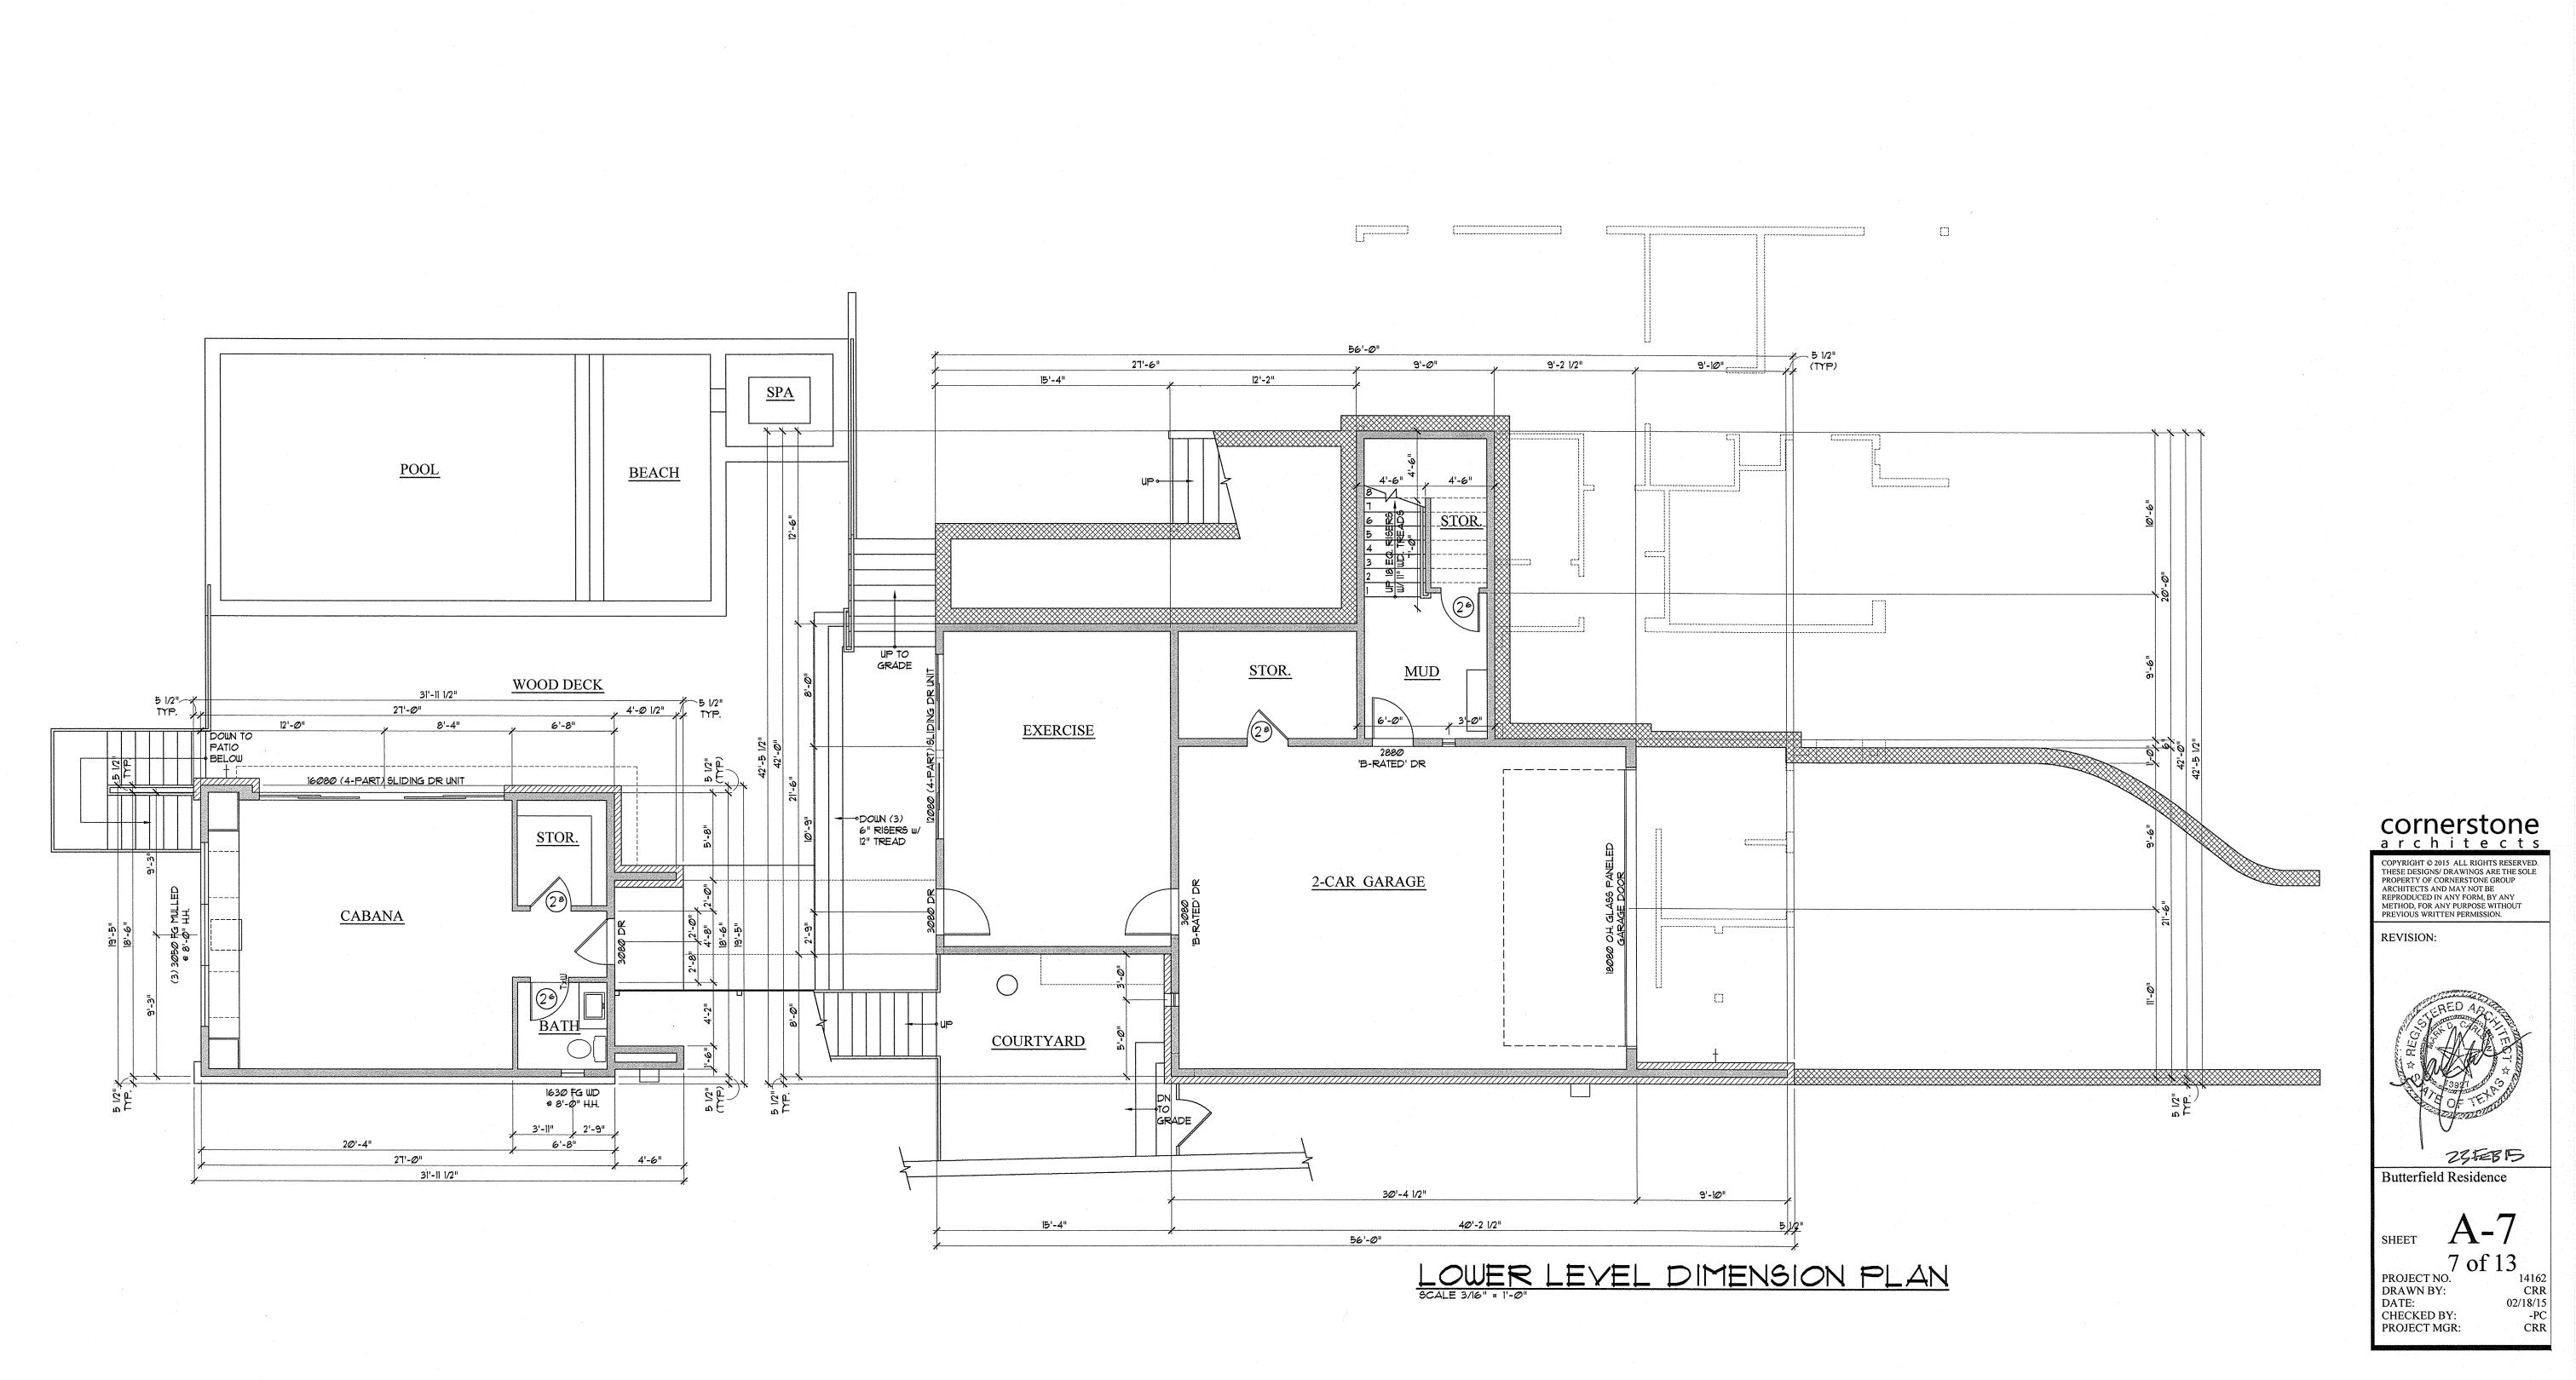



•

GENERAL ELEVATION NOTES


- 10 ALL WINDOW HDR. HTS. ON LOWER LEVEL, MAIN LEVEL, AND UPPER LEVEL TO BE 8'-0" AFF. UNLESS NOTED OTHERWISE ON FLOOR PLANS.
- 20 STUCCO TRIM AT STUCCO WALL VENEER AND 1X4 WD. TRIM AT SIDING/WOOD VENEERS.
- 3.0 EXPOSED FOUNDATION TO BE MINIMUM OF 8" AND A MAXIMUM OF 18" ABOVE FINISHED GRADE OR PER SUBDIVISION REQUIREMENTS. UNDERPIN ALL EXPOSED FOUNDATIONS.
- 4.0 GRADE LINES SHOWN ON ELEVATION DRAWINGS SHALL NOT BE CONSTRUED TO REPRESENT ACTUAL FINISH GRADES. VERIFY FINISH GRADE ON JOB SITE.
- 5.0 ACTUAL ELEVATIONS TO VARY PER GRADE OF EXISTING LOT.
- 6.0 ALL PLUMBING, APPLIANCE AND GAS VENTS TO BE GANGED TO THE FEWEST NUMBER POSSIBLE PENETRATING THE ROOF AND KEPT TO REAR OF ROOF WHEREVER POSSIBLE.
- 1.0 CHIMNEY/FLUE SHOWN AT MINIMUM DIMENSIONAL HEIGHT REQUIREMENTS PER CODE. BUILDER RESPONSIBLE FOR CONSTRUCTING CHIMNEY/FLUE TO ENSURE PROPER DRAW FOR FIREPLACE BASED ON HOUSE & SITE ORIENTATION
- 8.0 CONTRACTOR TO PROVIDE RAINSCREEN AND FLASHING BEHIND ALL STUCCO / SIDING VENEERS TO ASSURE ADEQUATE DRAINAGE.

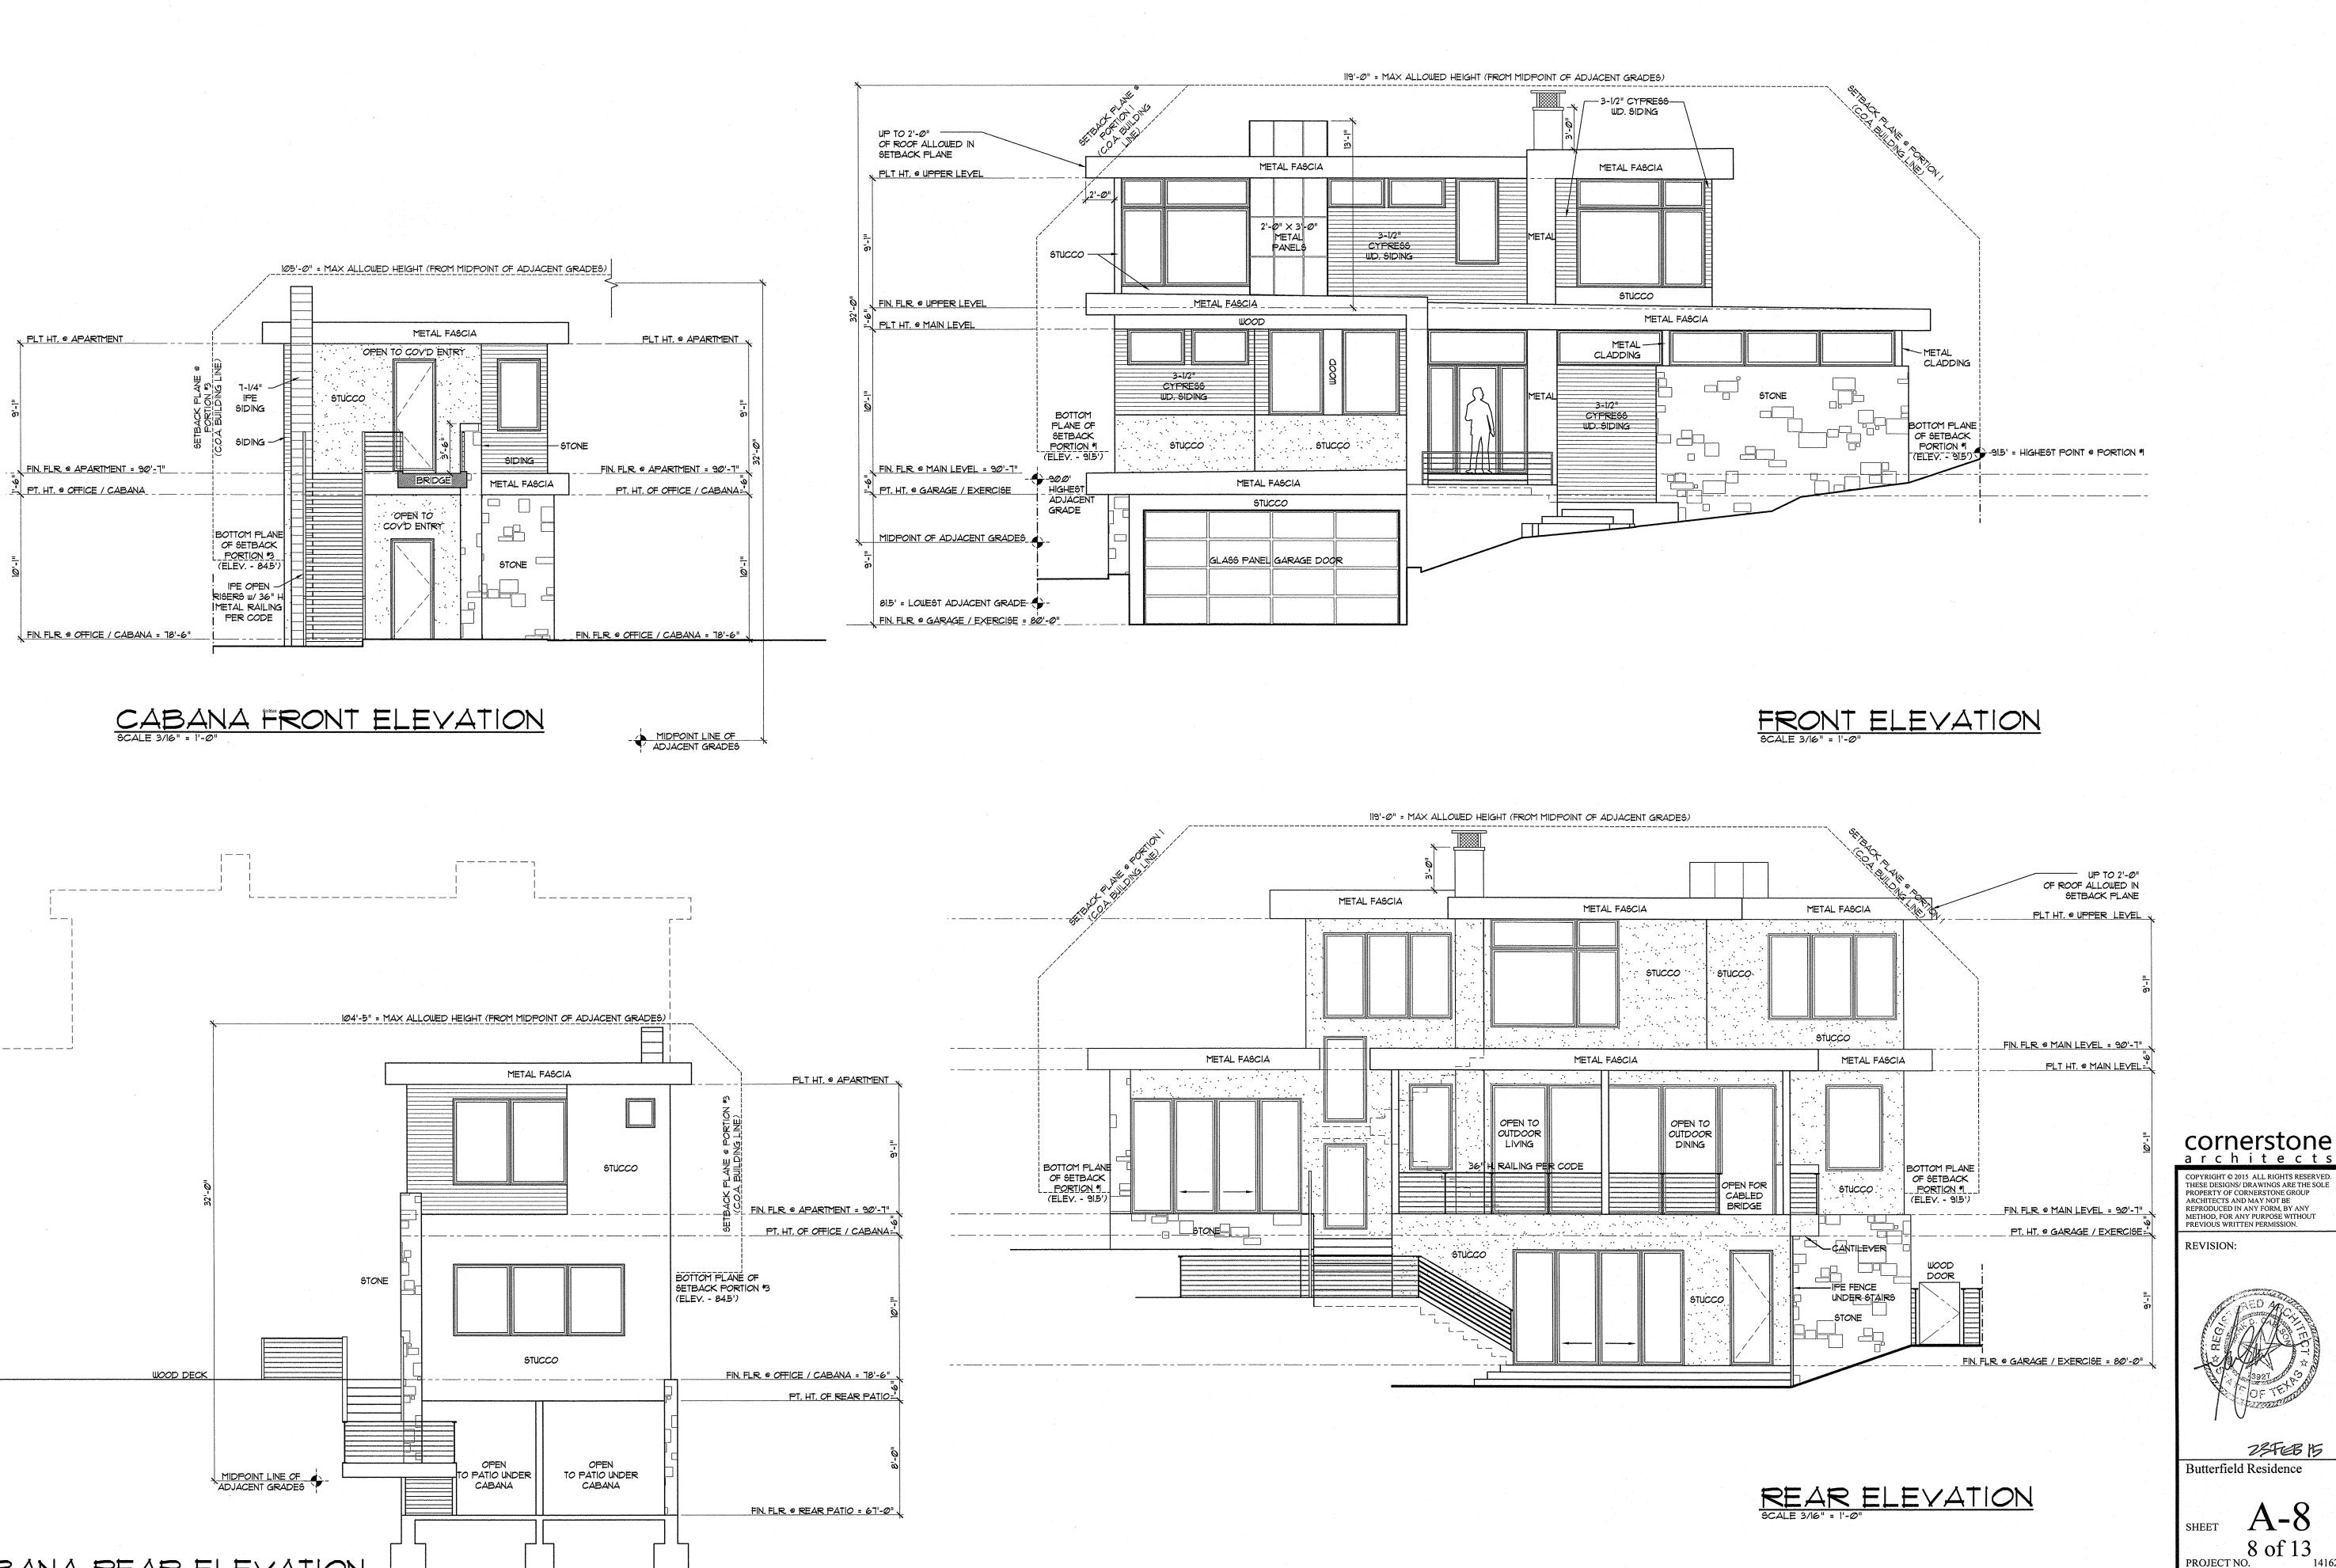


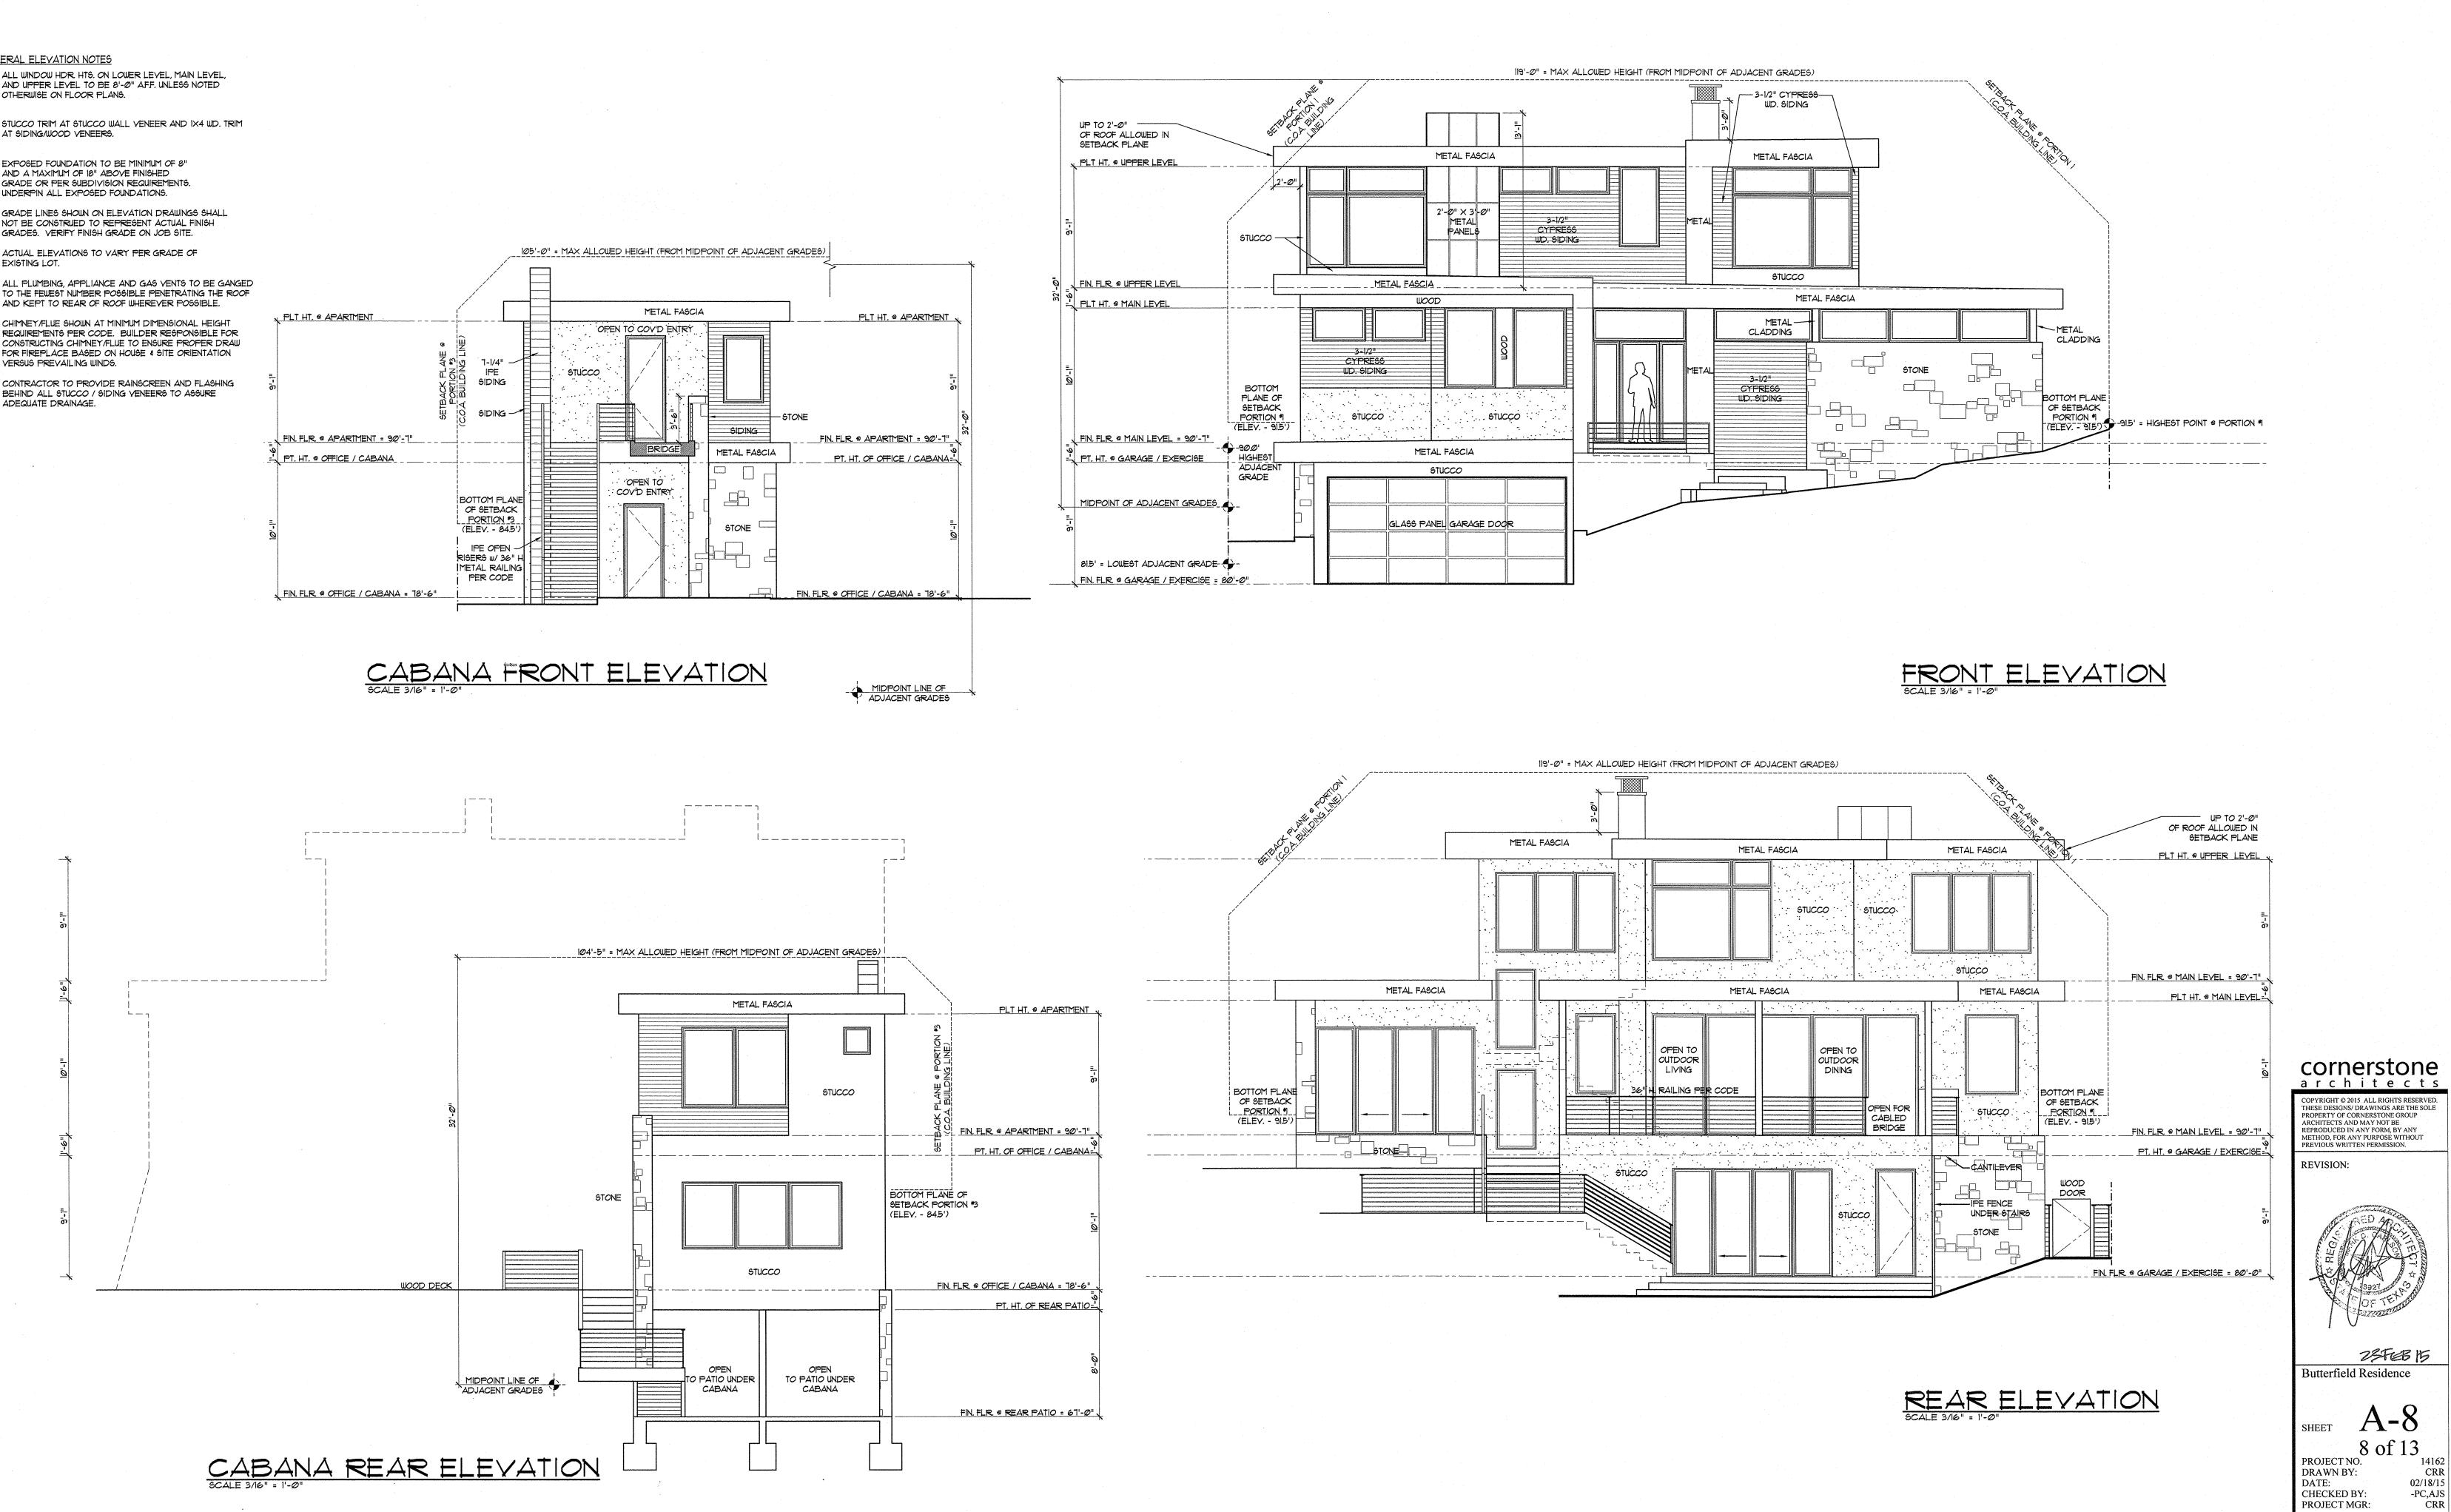


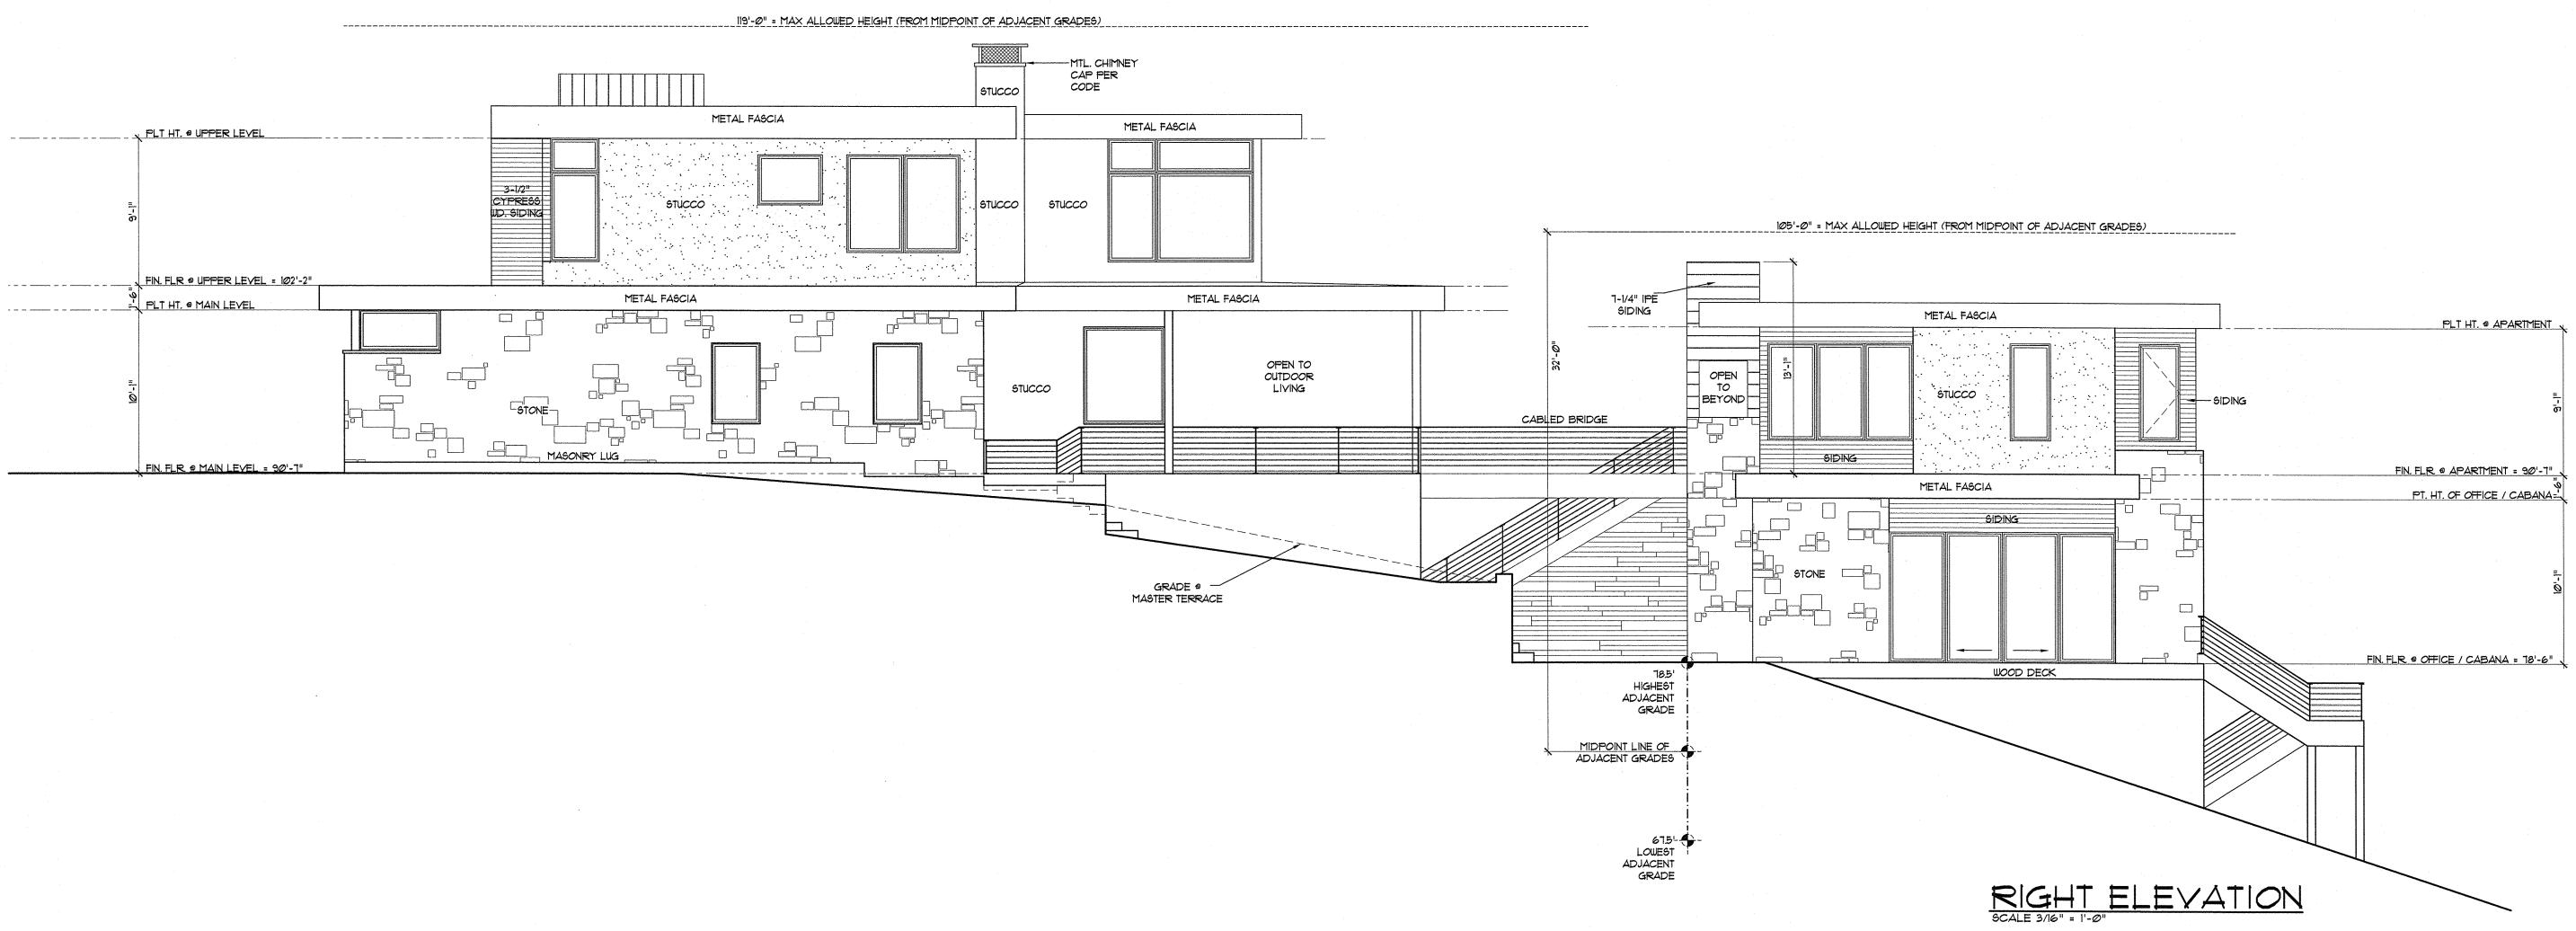



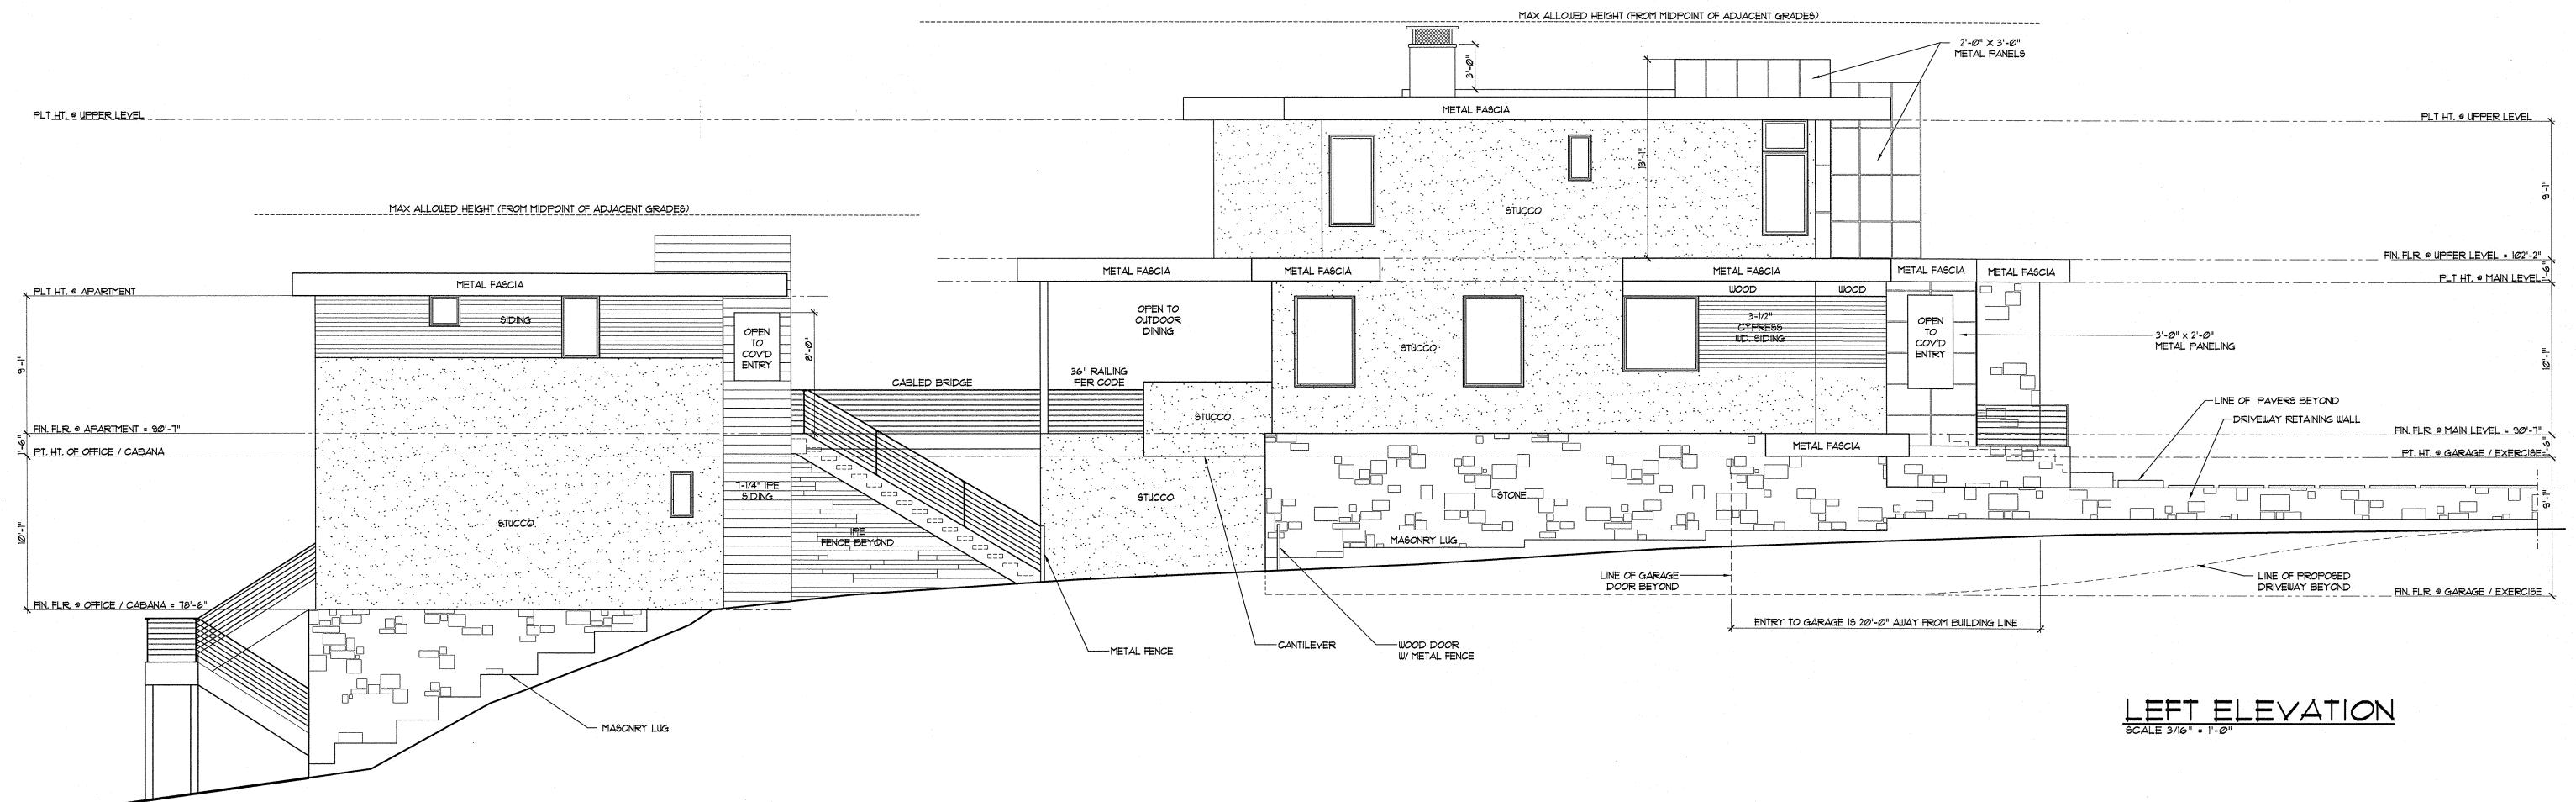

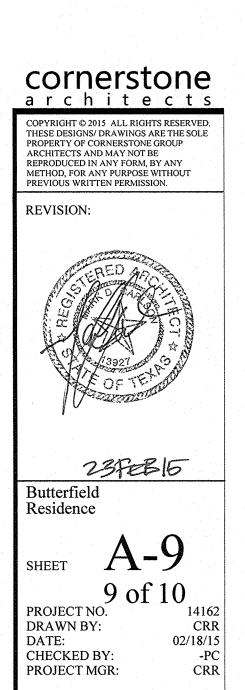


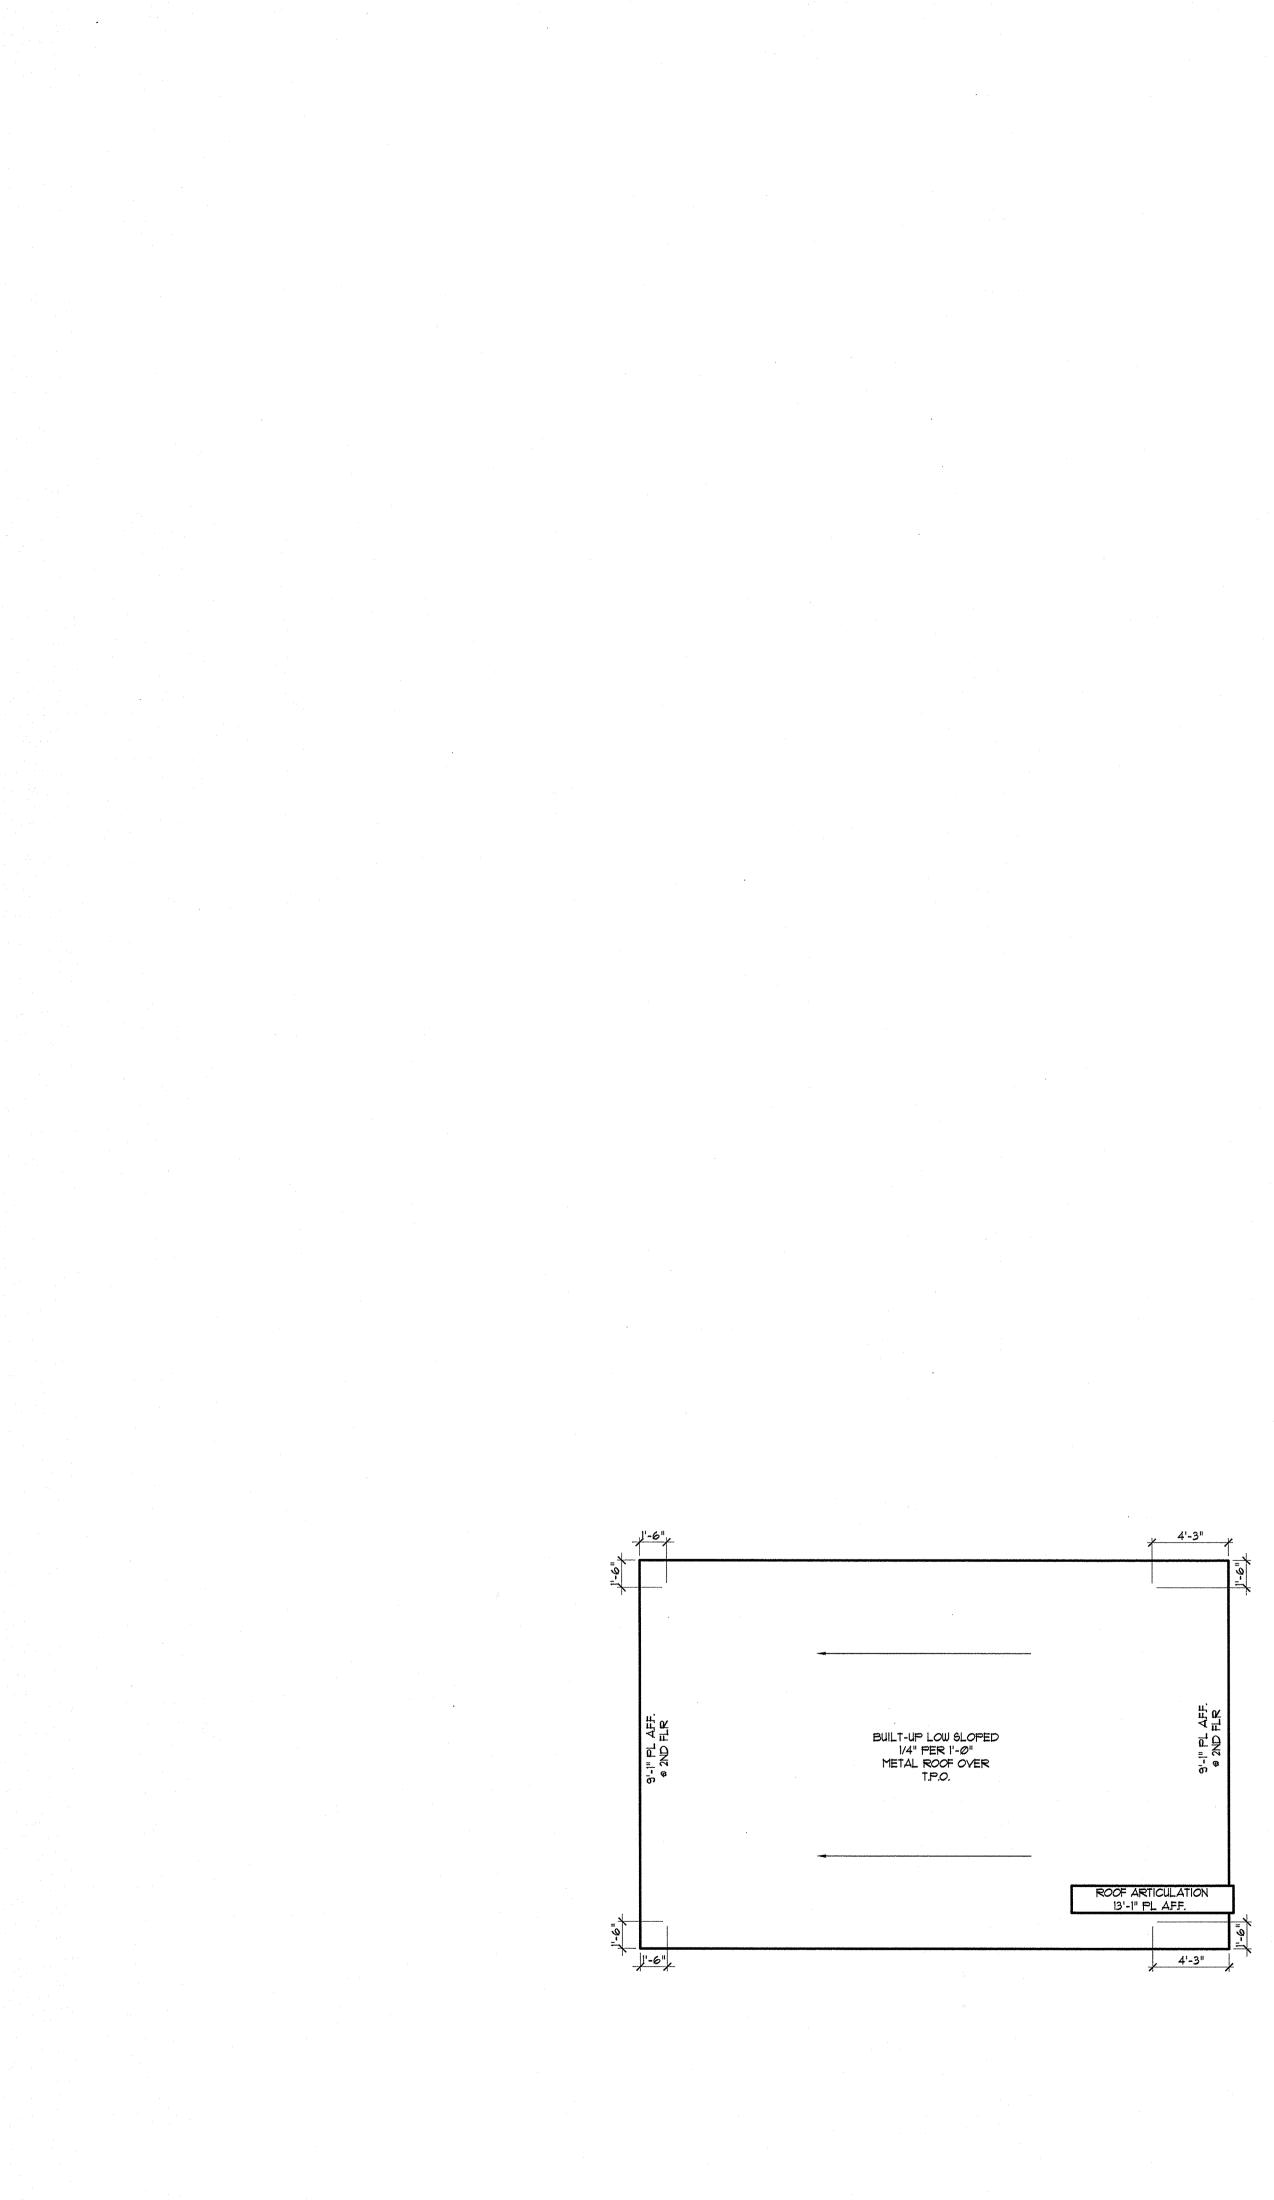


.

.

.

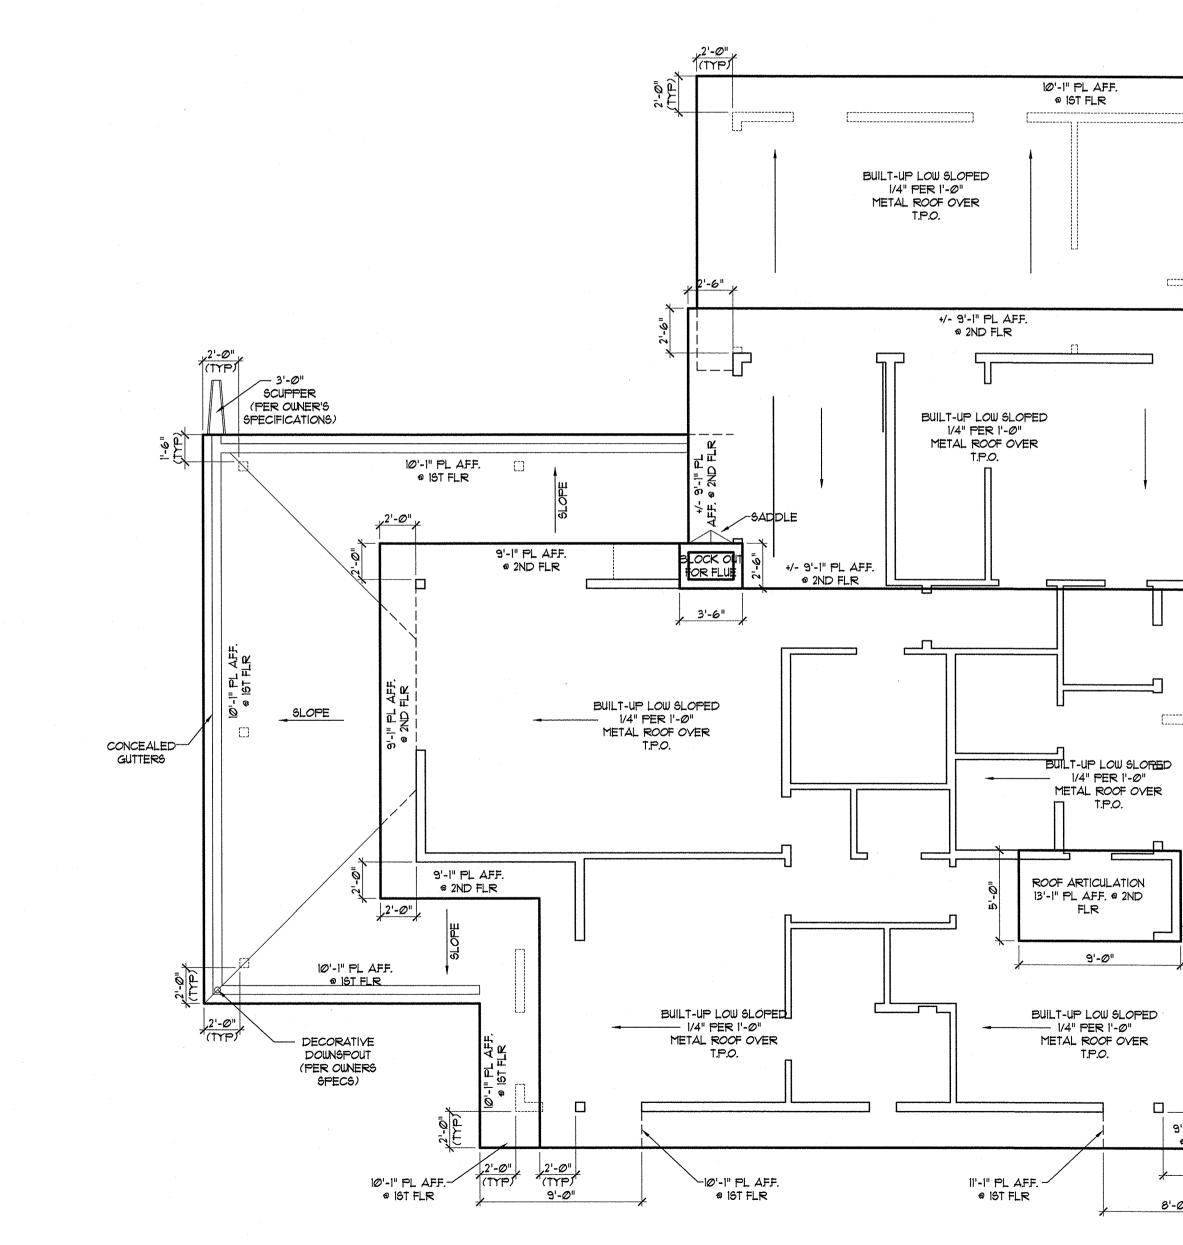

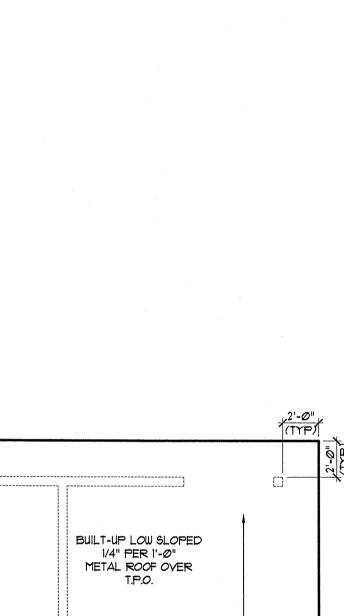

[-----]

₹ų

0 B

-NC

ILT-UP LOW SLOPEDI/4" PER METAL ROOF OVER T.P.O.

9'-1" PL AFF. © 2ND FLR

9'-1" PL AFF. @ 2ND FLR

, 4'-8"

8'-Ø"

OPEN TO BELOW

II'-I" PL AFF. @ IST FLR

LOWER ROOF

SCALE 3/16" = 1'-@"

6'-0"

Ψ. Ψ.

OVERHANG

- 6.0 ALL EXTERIOR OPENINGS TO BE LOAD BEARING.
- POSSIBLE PENETRATING THE ROOF. 4.0 ALL OVERHANGS TO BE 24" FROM THE FRAMEWALL UNLESS NOTED OTHERWISE.
- 50 UN.O. ALL INTERIOR WALLS OF ONE STORY PLANS TO BE LOAD BEARING. 10.0 THE DESIGN & SIZING OF ALL LOAD BEARING HEADERS, STRUCTURAL BEAMS AND TRUSSES IS THE

TO REAR OF ROOF RIDGE WHEREVER POSSIBLE. ALL

14

BUILT-UP LOW SLOPED 1/4" PER 1'-0" METAL ROOF OVER T.P.O.

6'-2"

10'-1" PL AFF. @ 13T FLR

-NO OVERHANG

2.0 HIPS, VALLEYS & RIDGES TO BE FRAMED ONE SIZE


VENTS TO BE GANGED TO THE FEWEST NUMBER

GENERAL ROOF NOTES:

LARGER THAN RAFTERS.

1.0 PITCHES TO BE AS NOTED ON PLANS.

- 7.0 WHEN ENGINEERED TRUSSES TO BE USED TRUSS DESIGN 4 SPACING TO BE PER ENGINEER'S SPECIFICATIONS.
- 8.0 ALL WALLS OVER 10'-0" IN HEIGHT TO BE FRAMED WITH 2×6 STUDS. IF WALLS OVER 10'-0" IN HEIGHT ARE NOT BUILT WITH 2×6 STUDS THEY MUST BE BUILT WITH DOUBLE 2X4 STUDS AT 12" O.C.
- 3.0 ALL PLUMBING, APPLIANCE AND GAS VENTS TO VENT 9.0 BUILDER ACCEPTS FULL RESPONSIBILITY FOR CHECKING PLANS TO ASSURE CONFORMITY TO CURRENT LOCAL BUILDING CODES. SHOULD ANY CHANGES BE MADE TO THESE PLANS BY BUILDER OR HIS REPRESENTATIVES WITHOUT CONTACTING THE ARCHITECT, THE BUILDER WILL ACCEPT FULL LIABILITY FOR AMENDED PLANS.
 - RESPONSIBILITY OF THE AGENT (ENGINEER/TRUSS MANUFACTURER, ETC.) CHOSEN BY THE BUILDER/OWNER TO DO SAID DESIGN.

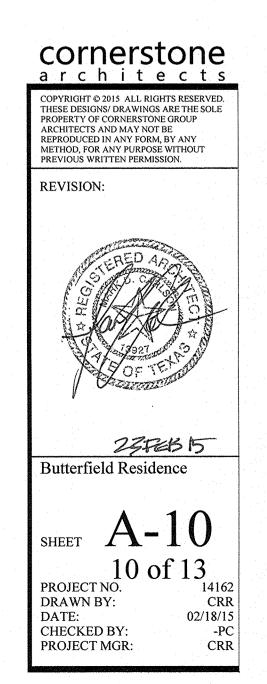


ELECTRICAL LEGEND DOORBELL CHIMES OUTLET - 220V - O→ LIGHT - RECESSED W/ \$ SWITCH WALLWASH TRIM or ADJ. APERTURE JUNCTION BOX \$D SWITCH - DIMMER THERMOSTAT OUTLET - CATS -O- LIGHT - PENDANT \$WP SWITCH - WATERPROOF (SD) SMOKE DETECTOR CONNECTION - LIGHT - RECESSED PIN SPOT OUTLET - PHONE LIGHT - FLOOD SWITCH - PUSH BUTTON (HD) HEAT DETECTOR -CA- LIGHT - WALLWASH CO CARBON MONOXIDE OUTLET - FLOOR PHONE FIXTURE DETECTOR IN RISER -DA- LIGHT - MINI FLOOD OUTLET - TELEVISION EXHAUST / VENT SP INTERCOM / SPEAKER (VERIFY HEIGHT) -- LIGHT - LOW VOLTAGE WPH OUTLET - 110V [NET] OUTLET - COMBINATION MEDIA - CHILING MOUNT WATERPROOF - C- LIGHT - LOW VOLTAGE X GAS BIB U LIGHT - WALL MOUNT SET BELOW COUNTERTOP COMBO -O- LIGHT - LOW VOLTAGE GAS SHUT-OFF KEY - LIGHT - RECESSED CAN DIRECTIONAL SPOT OUTLET - 1107 SPLIT WIRE COMBO SWITCH TOP PLUG ONLY DO MOTION DETECTOR - LIGHT - RECESSED S FLOOR OUTLET - 110V DIRECTIONAL CEILING FAN CEILING FAN C KEYPAD / AUTOMATION

QUADPLEX

.

CEILING OUTLET - 110V

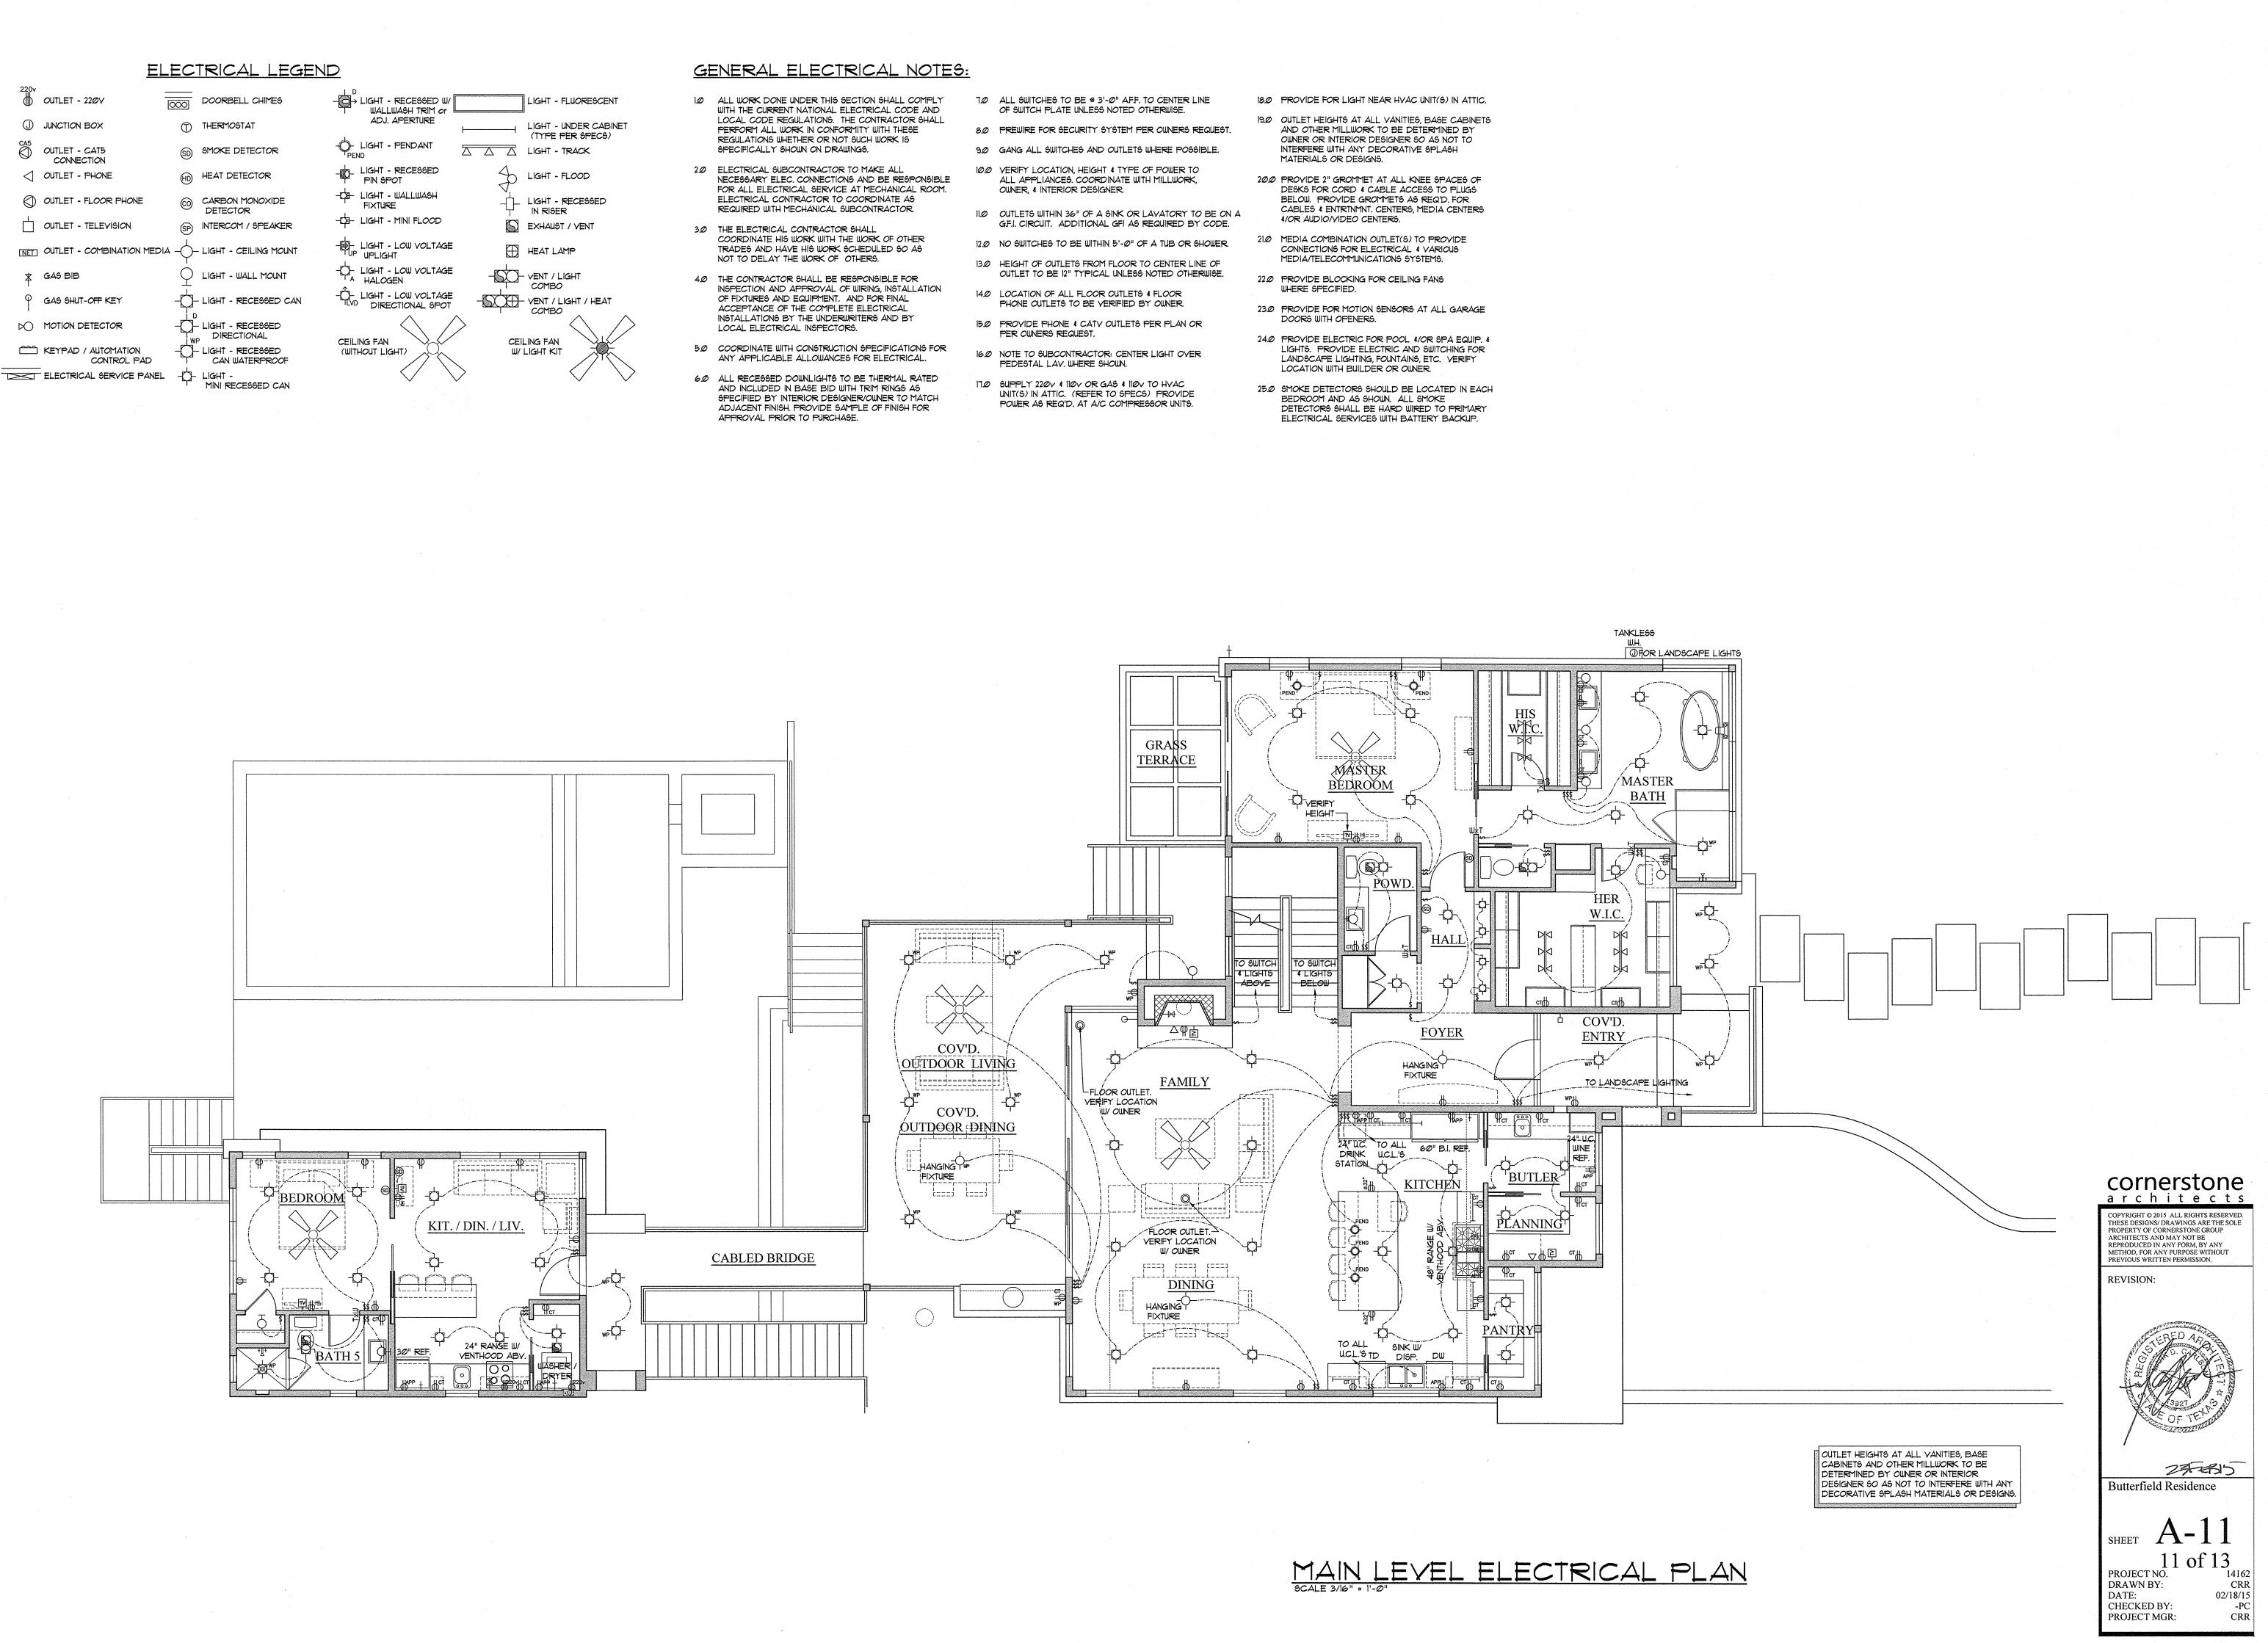

•

•

