


PROJECT NO. DRAWN BY: 03/04/15 KA, BM, JH MC CHECKED BY: PROJECT MGR:

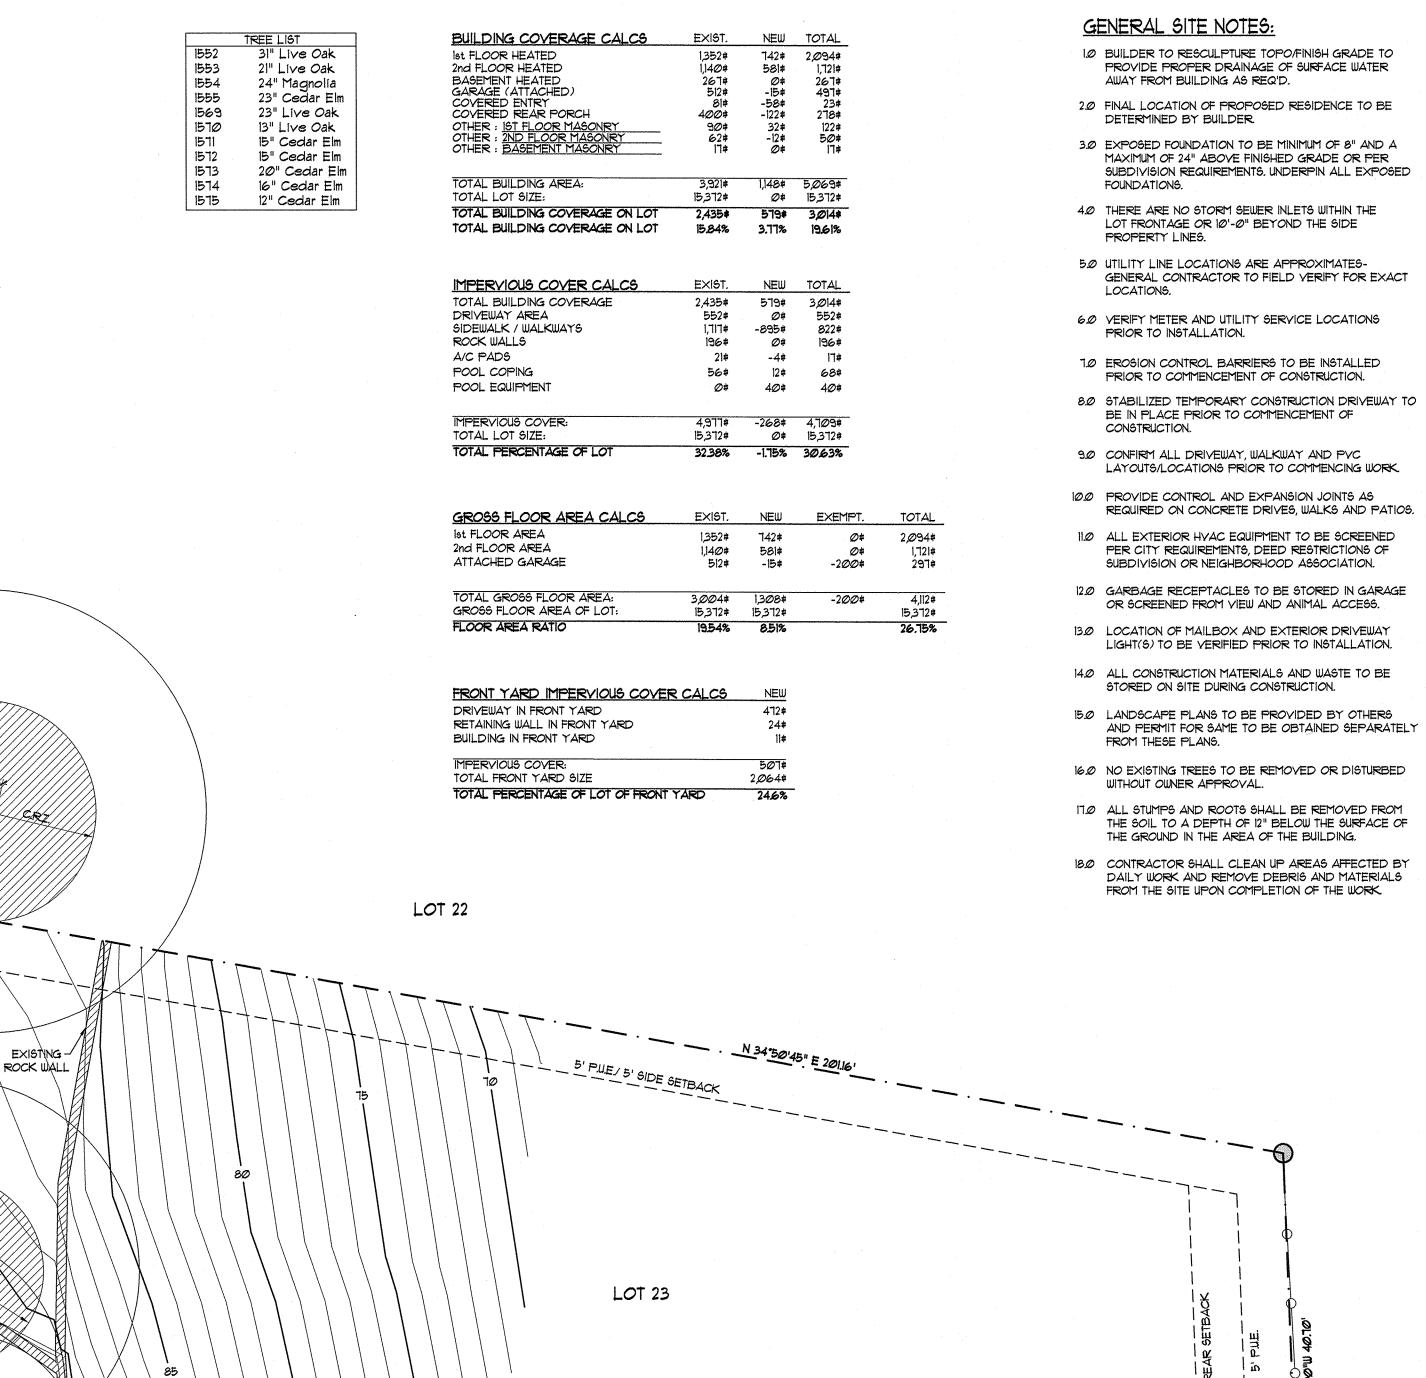

5' PUE/ 5' SIDE SETBACK

-EXISTING FENCE

SHELL TO BE REMOVED & FILLED IN NEW POOL (FINAL DESIGN BY OTHERS) EXISTING PORCH TO BE MEMOVED EXISTING CONCRETE EXISTING ROCK ADDITION PATH TO BE REMOVED

N24*42'40"E 253.22'

NEW CONC. 980' HIGHEST POINT PORTION 2 EXISTING ROCK WALL STEPS TO WOOD FENCE GRADE SIDE SETBACK PLANE PORTION 1

SIDE SETBACK PLANE PORTION 2

EXIST. COV'D. / PORCH /

SIDE SETBACK PLANE PORTION 1

ADJACENT FINISHED

EXISTING A/C

PADS TO BE

TREMOVED ...

EXISTING

SHED TO BE

REMOVED

~30' BL. PER

RESTRICTIONS

EXISTING TWO-STORY

BRICK FRAME

/ EXISTING +OUNDATION

RESIDENCE FIN. FLR. ELEV= 97.5'

WALK TO BE

REMOVED

STONES PER LANDSCAPE DESIGNER

EXIST. ROCK-

WALK TO BE

\ EXISTING

995 HIGHEST POINT

ROCK DRIVE

1010' HIGHEST ADJACENT NATURAL GRADE

EXISTING CONCRETE

TEMPORARY BENCHMARK: TRIANGLE CUT ON QURB AT

10000' ASSUMED ELEVATION-

LOT 24


SIDE SETE ACK PLANE PORTION


1570₀


EXISTING POOL-


LEGAL DESCRIPTION: 1013 GASTON AVENUE SHOAL TERRACE SUBDIVISION AUSTIN, TEXAS 78703

TRAVIS COUNTY

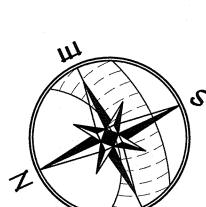

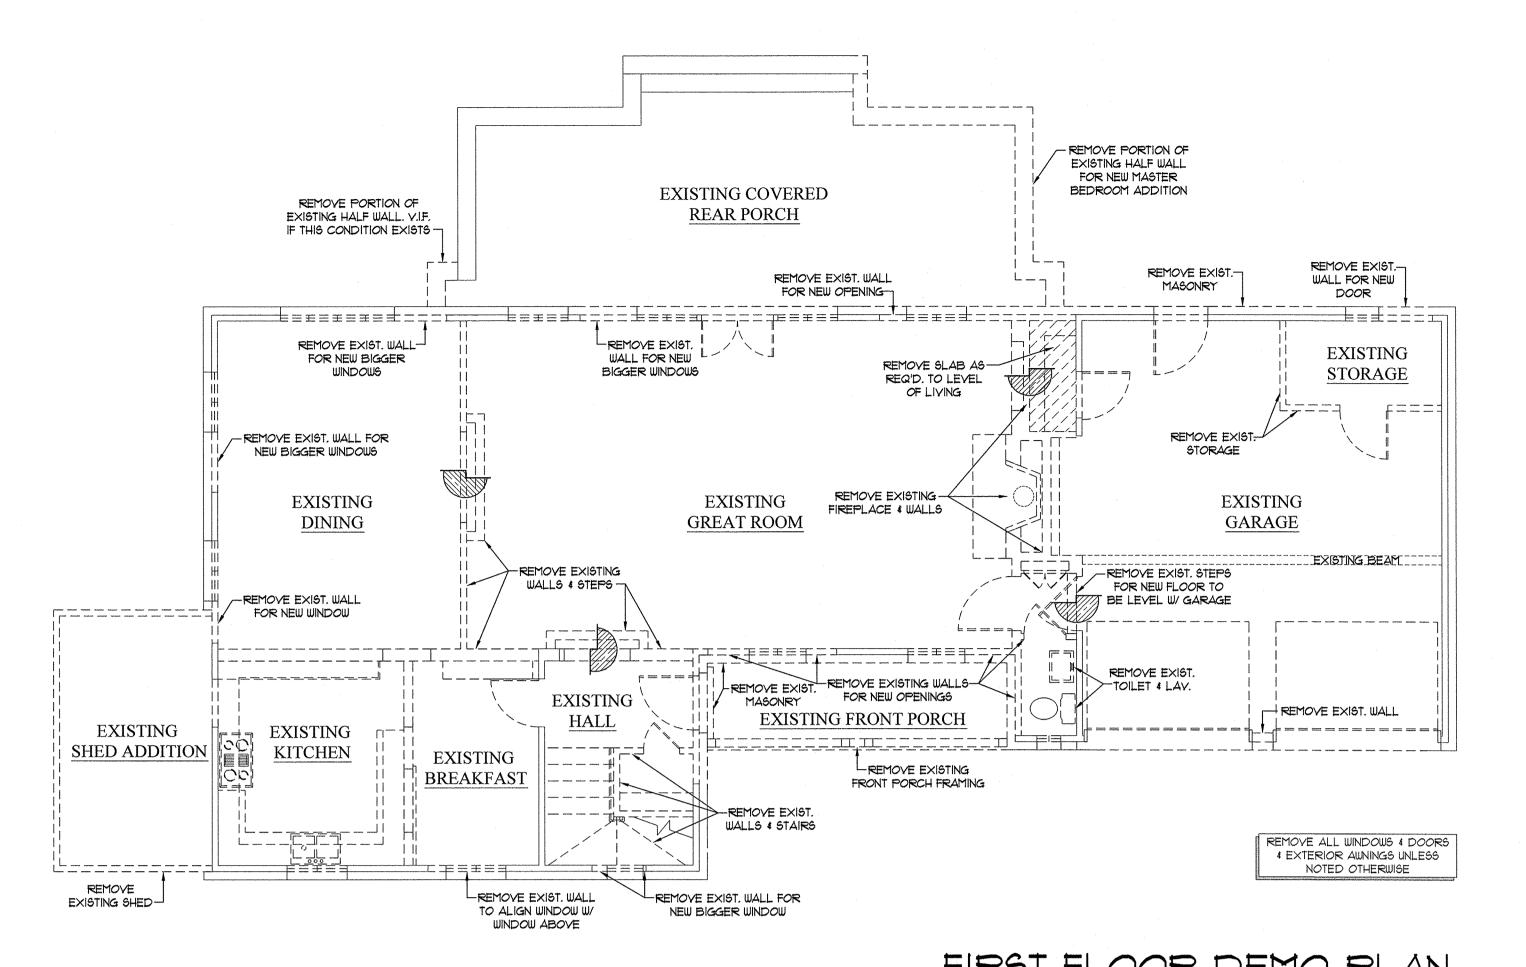

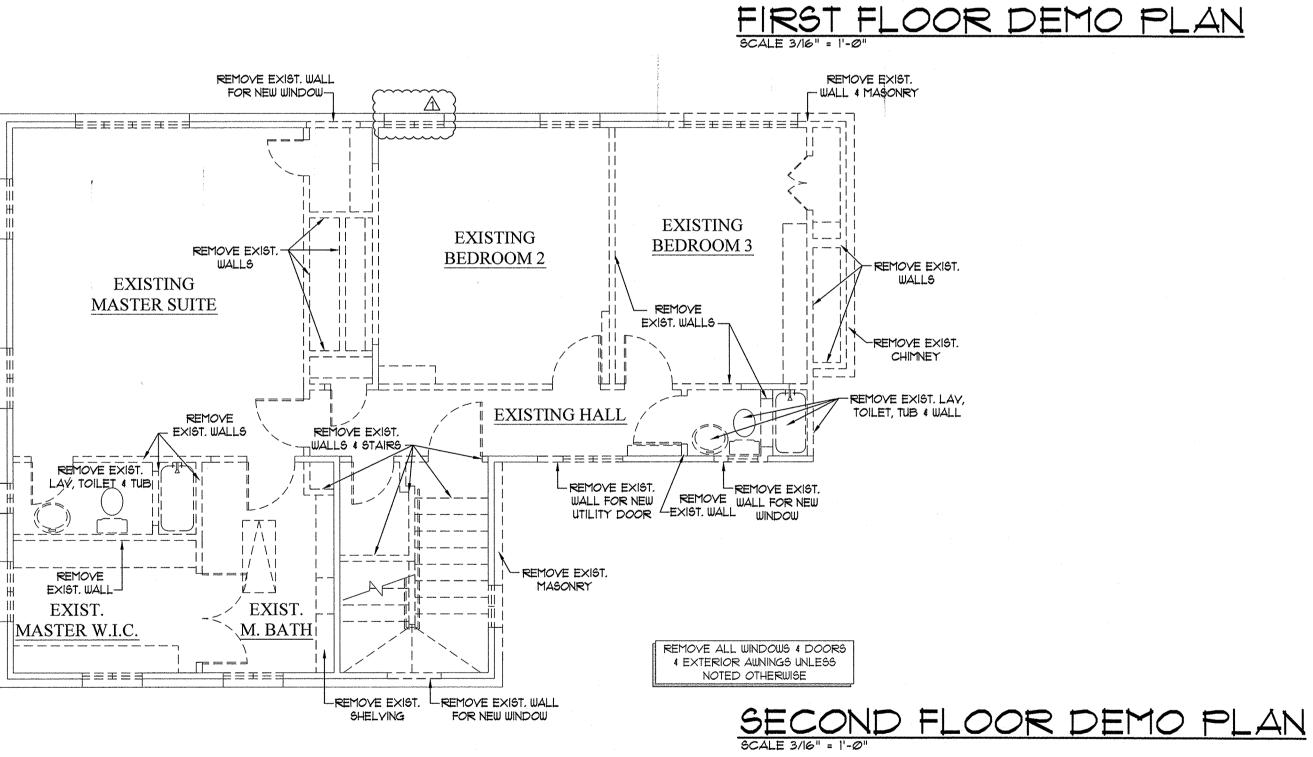

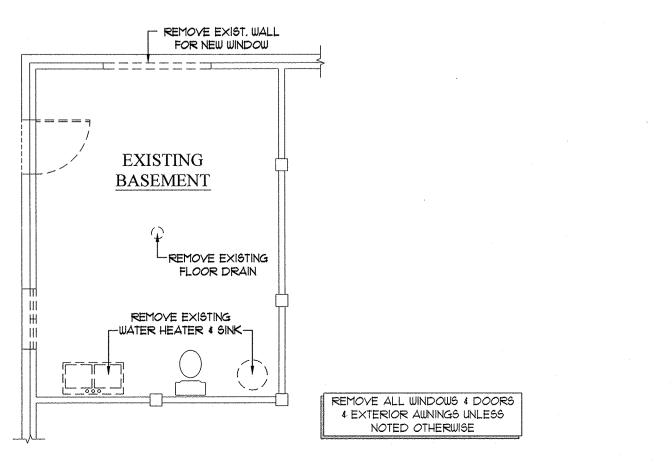

BASEMENT DEMO PLAN
SCALE 3/16" = 1'-0"

DEMO LEGEND

EXISTING WALLS TO REMAIN CPP During System Annual Springer Amount System. Adapt


EXISTING WALLS TO BE DEMOLISHED

GENERAL DEMOLITION NOTES:

- 1.0 REMOVE ALL WALLS, DOORS, AND WINDOWS PER DEMOLITION PLANS (STORE DOORS FOR POSSIBLE RE-USE / SALVAGE)
- 20 REMOVE ALL AFFECTED ELECTRICAL PER DEMOLITION PLANS. REMOVE ALL NON-REMAINING WIRING & CAP OFF ABOVE CEILING. REMOVE ALL NON-REMAINING ELEC. OUTLETS, PHONE JACKS, ETC. (STORE FOR POSSIBLE RE-USE / SALVAGE)
- 3.0 REPLACE ALL DAMAGED SHEETROCK TO REMAIN. TAPE, FLOAT, & TEXTURE TO MATCH EXISTING.
- 4.0 REMOVE ALL CABINETS, COUNTERTOPS & ASSOCIATED FIXTURES UNLESS NOTED OTHERWISE (STORE FOR POSSIBLE RE-USE / SALVAGE)
- 5.0 REMOVE ALL NON-REMAINING LIGHTING & CAP OFF AFFECTED WIRING. (STORE LIGHTING FOR POSSIBLE RE-USE / SALVAGE)
- 6.0 CAP OF ALL NON-REMAINING PLUMBING.
- 7.0 REMOVE ALL NON-REMAINING R/A GRILLS & OTHER HVAC COMPONENTS. REPOSITION AS NEEDED.
- 8.0 REMOVE ALL WINDOWS & DOORS UNLESS NOTED OTHERWISE.



THESE DESIGNS/ DRAWINGS ARE THE SOLE PROPERTY OF CORNERSTONE GROUP ARCHITECTS AND MAY NOT BE REPRODUCED IN ANY FORM, BY ANY METHOD, FOR ANY PURPOSE WITHOUT PREVIOUS WRITTEN PERMISSION.

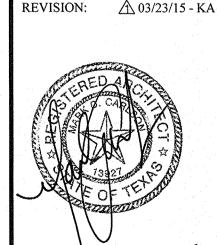


123 MAPKS BUTTERFIELD SPEC

SHEET PROJECT NO.

03/04/15

DRAWN BY: DATE: CHECKED BY: KA, BM, JH PROJECT MGR:

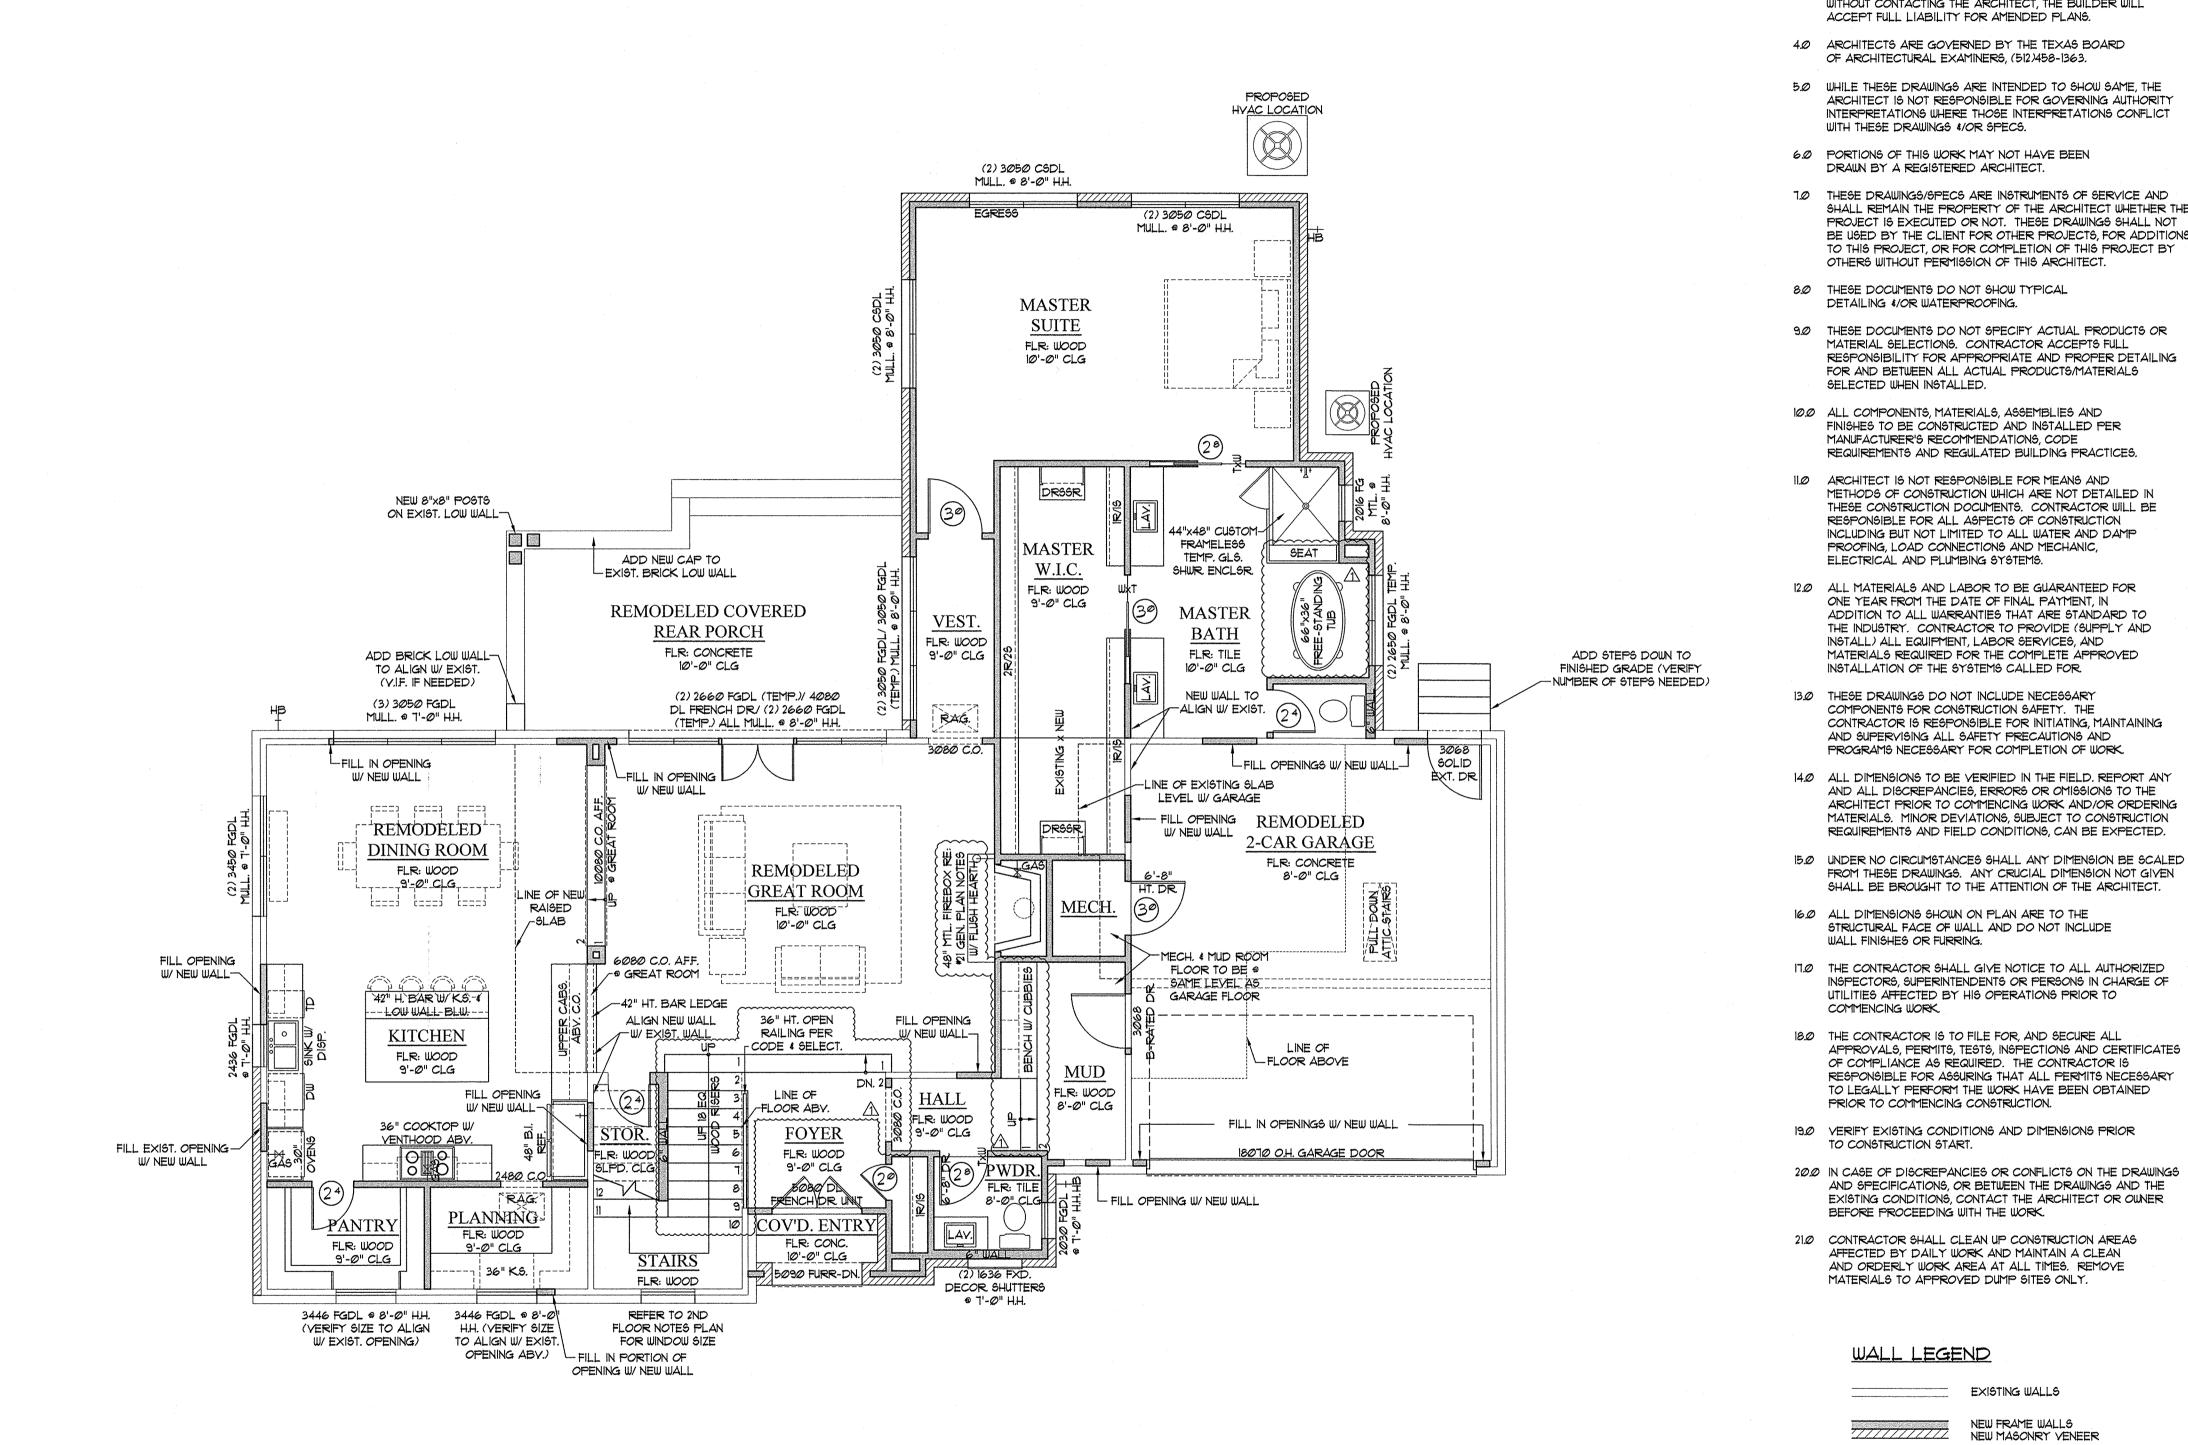

GENERAL PLAN NOTES:

- 10 ALL WINDOWS WILL BE DIMENSIONED TO CENTER LINE UNLESS OTHERWISE NOTED. GLASS SIZE PER MFR. SPECS.
- 20 ALL WINDOWS WITHIN 24" OF AN EXTERIOR OR INTERIOR DOOR TO BE TEMPERED GLASS, WINDOW MANUFACTURER TO VERIFY FOR ALL TEMPERED GLASS LOCATIONS AS PER APPLICABLE CODE.
- 3.0 ALL HINGED SHOWER DOORS SHALL SWING OUTWARD. GLAZING USED IN DOORS AND PANELS OF BATHTUB/SHOWER ENCLOSURES AND BUILDING WALLS ENCLOSING THESE COMPARTMENTS SHALL BE FULLY TEMPERED OR LAMINATED SAFETY GLASS.
- 4.0 WINDOW MANUFACTURER & BUILDER TO VERIFY EGRESSABLE WINDOWS INSTALLED WHERE REQUIRED BY CODE.
- 5.0 THESE DOCUMENTS REFLECT NOMINAL WINDOW SIZES. WINDOW MANUFACTURER TO USE STANDARD SIZES UNLESS NOTED OTHERWISE.
- 6.0 PROVIDE BLOCKING FOR CEILING FANS WHERE SPECIFIED.
- 7.0 BUILDER TO VERIFY SIZING AND LOCATION OF ALL APPLIANCES & RELATED COMPONENTS.
- 8.0 WEATHERSTRIP ATTIC ACCESS DOOR(S).
- 90 CONTRACTOR TO PROVIDE A 3/4" PLYWOOD CATWALK FROM ATTIC ACCESS TO HYAC UNITS (IF APPLICABLE). UNITS TO BE LOCATED WITHIN 20'-0" OF ACCESS.
- 10.0 IN VENTED ROOF ASSEMBLIES PROVIDE I SF. NET FREE AREA OF ATTIC VENTILATION PER 150 SF. OF TOTAL COVERED ROOF AREA AS PER CODE.
- 11.0 AT FIRST FLOOR, ALL DOORS AND CASED OPENINGS TO BE 8'-0" HT. UNLESS NOTED OTHERWISE. AT SECOND FLOOR AND BASEMENT, ALL DOORS AND CASED OPENINGS TO BE 6'-8" HT. UNLESS NOTED OTHERWISE. EXCEPTION...IF A 7'-0" HT. DOOR IS USED ADJUST WINDOWS TO 7'-0" HEADER HT.
- 12.0 ALL PLUMBING, APPLIANCE AND GAS VENTS TO VENT TO REAR OF ROOF RIDGE WHEREVER POSSIBLE. ALL VENTS TO BE GANGED TO THE FEWEST NUMBER POSSIBLE PENETRATING THE ROOF.
- 13.0 PROVIDE CONTROL AND EXPANSION JOINTS AS REQUIRED ON CONCRETE DRIVES, WALKS AND PATIOS.
- 14.0 PROVIDE WEATHERSEAL AND A 9 1/2" MASONRY DOOR SILL AT ALL EXTERIOR DOOR THRESHOLDS.
- 15.0 UNLESS NOTED OTHERWISE STANDARD PANTRY SHELVING TO BE AS FOLLOWS:
 - LOWEST 2 SHELVES TO BE 16" D. WITH HEIGHT SPACING OF 14" CLEAR. REMAINING SHELVES TO BE 12" D. WITH HEIGHT SPACING OF 12" CLEAR
- 16.0 ALL WALLS OVER 9'-0" IN HEIGHT TO BE FRAMED WITH 2x6 STUDS, IF WALLS OVER 9'-0" IN HEIGHT ARE NOT BUILT WITH 2X6 STUDS THEY MUST BE BUILT WITH DOUBLE 2X4 STUDS AT 12" O.C.
- 18.0 THE STANDARD MOUNTING HEIGHT FOR SHOWER HEADS IS 7'-0" ABOVE FINISH FLOOR UNLESS
- 19.0 PROVIDE BLOCKING FOR HANDRAIL MOUNTING AT STAIRS AS NECESSARY.
- NON-COMBUSTIBLE SURROUND.
- NOTED OTHERWISE.
- 200 ALL FIREPLACES TO HAVE 20" DEEP HEARTH \$ 12"
- 17.0 THE DROP FROM INTERIOR FINISH FLOOR TO ANY EXTERIOR FINISH FLOOR IS TO BE A MINIMUM OF I 1/2". CONTRACTOR TO VERIFY MATERIALS USED FOR DECK CONSTRUCTION AND FINISH FLOORING TO MAINTAIN MINIMUM DROP.

IGAS KEY TGAS + IT + SHOWER HEAD THOSE BIBB

FIRST FLOOR NOTES PLAN

NEW SQUARE FOOTAGE CALCS.

HEATED

GARAGE

1ST FLOOR HEATED

TOTAL HEATED

COY'D. ENTRY

TOTAL AREA

2ND FLOOR HEATED

BASEMENT APARTMENT

COV'D. REAR PORCH

IST FLOOR MASONRY

2ND FLOOR MASONRY

BASEMENT MASONRY

TOTAL IMPERVIOUS

GENERAL PROJECT NOTES

1.0 THESE CONSTRUCTION DOCUMENTS ARE INTENDED TO MEET ALL APPLICABLE CODES AND ORDINANCES." CONTRACTOR TO COMPLY WITH ALL LOCAL CODES, ORDINANCES AND DEED RESTRICTIONS. CONTRACTOR SHALL ALSO REQUIRE ALL SUBCONTRACTORS TO

2.0 ANY DISCREPANCIES IN CONSTRUCTION DOCUMENTS OR NONCOMPLIANCE TO BE BROUGHT TO THE ATTENTION OF THE ARCHITECT PRIOR TO ANY WORK BEING PERFORMED OR MATERIALS BEING ORDERED. 3.0 BUILDER ACCEPTS FULL RESPONSIBILITY FOR CHECKING PLANS TO ASSURE CONFORMITY TO CURRENT LOCAL BUILDING CODES. SHOULD ANY CHANGES BE MADE TO THESE PLANS BY BUILDER OR HIS REPRESENTATIVES WITHOUT CONTACTING THE ARCHITECT, THE BUILDER WILL

ACCEPT FULL LIABILITY FOR AMENDED PLANS.

OF ARCHITECTURAL EXAMINERS, (512)458-1363.

WITH THESE DRAWINGS \$/OR SPECS.

DETAILING 4/OR WATERPROOFING.

SELECTED WHEN INSTALLED.

DRAWN BY A REGISTERED ARCHITECT.

ARCHITECT IS NOT RESPONSIBLE FOR GOVERNING AUTHORITY

INTERPRETATIONS WHERE THOSE INTERPRETATIONS CONFLICT

SHALL REMAIN THE PROPERTY OF THE ARCHITECT WHETHER THE PROJECT IS EXECUTED OR NOT. THESE DRAWINGS SHALL NOT

BE USED BY THE CLIENT FOR OTHER PROJECTS, FOR ADDITIONS TO THIS PROJECT, OR FOR COMPLETION OF THIS PROJECT BY

OTHERS WITHOUT PERMISSION OF THIS ARCHITECT.

MATERIAL SELECTIONS. CONTRACTOR ACCEPTS FULL

FINISHES TO BE CONSTRUCTED AND INSTALLED PER MANUFACTURER'S RECOMMENDATIONS, CODE

RESPONSIBLE FOR ALL ASPECTS OF CONSTRUCTION

PROOFING, LOAD CONNECTIONS AND MECHANIC,

ONE YEAR FROM THE DATE OF FINAL PAYMENT, IN

INSTALL) ALL EQUIPMENT, LABOR SERVICES, AND

INSTALLATION OF THE SYSTEMS CALLED FOR

COMPONENTS FOR CONSTRUCTION SAFETY. THE

AND SUPERVISING ALL SAFETY PRECAUTIONS AND

PROGRAMS NECESSARY FOR COMPLETION OF WORK

ADDITION TO ALL WARRANTIES THAT ARE STANDARD TO

MATERIALS REQUIRED FOR THE COMPLETE APPROVED

THE INDUSTRY. CONTRACTOR TO PROVIDE (SUPPLY AND

CONTRACTOR IS RESPONSIBLE FOR INITIATING, MAINTAINING

AND ALL DISCREPANCIES, ERRORS OR OMISSIONS TO THE

ARCHITECT PRIOR TO COMMENCING WORK AND/OR ORDERING

FROM THESE DRAWINGS. ANY CRUCIAL DIMENSION NOT GIVEN

MATERIALS MINOR DEVIATIONS SUBJECT TO CONSTRUCTION

REQUIREMENTS AND FIELD CONDITIONS, CAN BE EXPECTED.

SHALL BE BROUGHT TO THE ATTENTION OF THE ARCHITECT.

INSPECTORS, SUPERINTENDENTS OR PERSONS IN CHARGE OF

APPROVALS, PERMITS, TESTS, INSPECTIONS AND CERTIFICATES

RESPONSIBLE FOR ASSURING THAT ALL PERMITS NECESSARY TO LEGALLY PERFORM THE WORK HAVE BEEN OBTAINED

AND SPECIFICATIONS, OR BETWEEN THE DRAWINGS AND THE

EXISTING CONDITIONS, CONTACT THE ARCHITECT OR OWNER

EXISTING WALLS

NEW MASONRY VENEER

EXIST.

1,352#

1,140#

267#

2,759#

512#

81#

90#

62#

400#

TOTAL

2,094#

1,721#

267#

278#

122#

50#

4,082#

NEW 742#

581#

-15#

-58#

-122#

32#

-12#

3,921# 1,148# 5,069#

2,435# 579# **3,014**#

AFFECTED BY DAILY WORK AND MAINTAIN A CLEAN

AND ORDERLY WORK AREA AT ALL TIMES. REMOVE

MATERIALS TO APPROVED DUMP SITES ONLY.

STRUCTURAL FACE OF WALL AND DO NOT INCLUDE

UTILITIES AFFECTED BY HIS OPERATIONS PRIOR TO

OF COMPLIANCE AS REQUIRED. THE CONTRACTOR IS

PRIOR TO COMMENCING CONSTRUCTION.

BEFORE PROCEEDING WITH THE WORK.

WALL LEGEND

WALL FINISHES OR FURRING.

TO CONSTRUCTION START.

COMMENCING WORK

ELECTRICAL AND PLUMBING SYSTEMS.

INCLUDING BUT NOT LIMITED TO ALL WATER AND DAMP

REQUIREMENTS AND REGULATED BUILDING PRACTICES.

METHODS OF CONSTRUCTION WHICH ARE NOT DETAILED IN

THESE CONSTRUCTION DOCUMENTS. CONTRACTOR WILL BE


RESPONSIBILITY FOR APPROPRIATE AND PROPER DETAILING FOR AND BETWEEN ALL ACTUAL PRODUCTS MATERIALS

COMPLY WITH THESE REGULATIONS.

cornerstone architects

COPYRIGHT © 2015 ALL RIGHTS RESERVED THESE DESIGNS/ DRAWINGS ARE THE SOLE PROPERTY OF CORNERSTONE GROUP ARCHITECTS AND MAY NOT BE REPRODUCED IN ANY FORM, BY ANY METHOD, FOR ANY PURPOSE WITHOUT PREVIOUS WRITTEN PERMISSION.


REVISION: $\triangle 03/23/15 - KA$

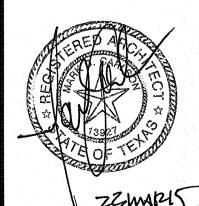


ZZIMPIS **BUTTERFIELD SPEC**

SHEET PROJECT NO. DRAWN BY:

DATE: 03/04/15 CHECKED BY: KA, BM, JH PROJECT MGR:

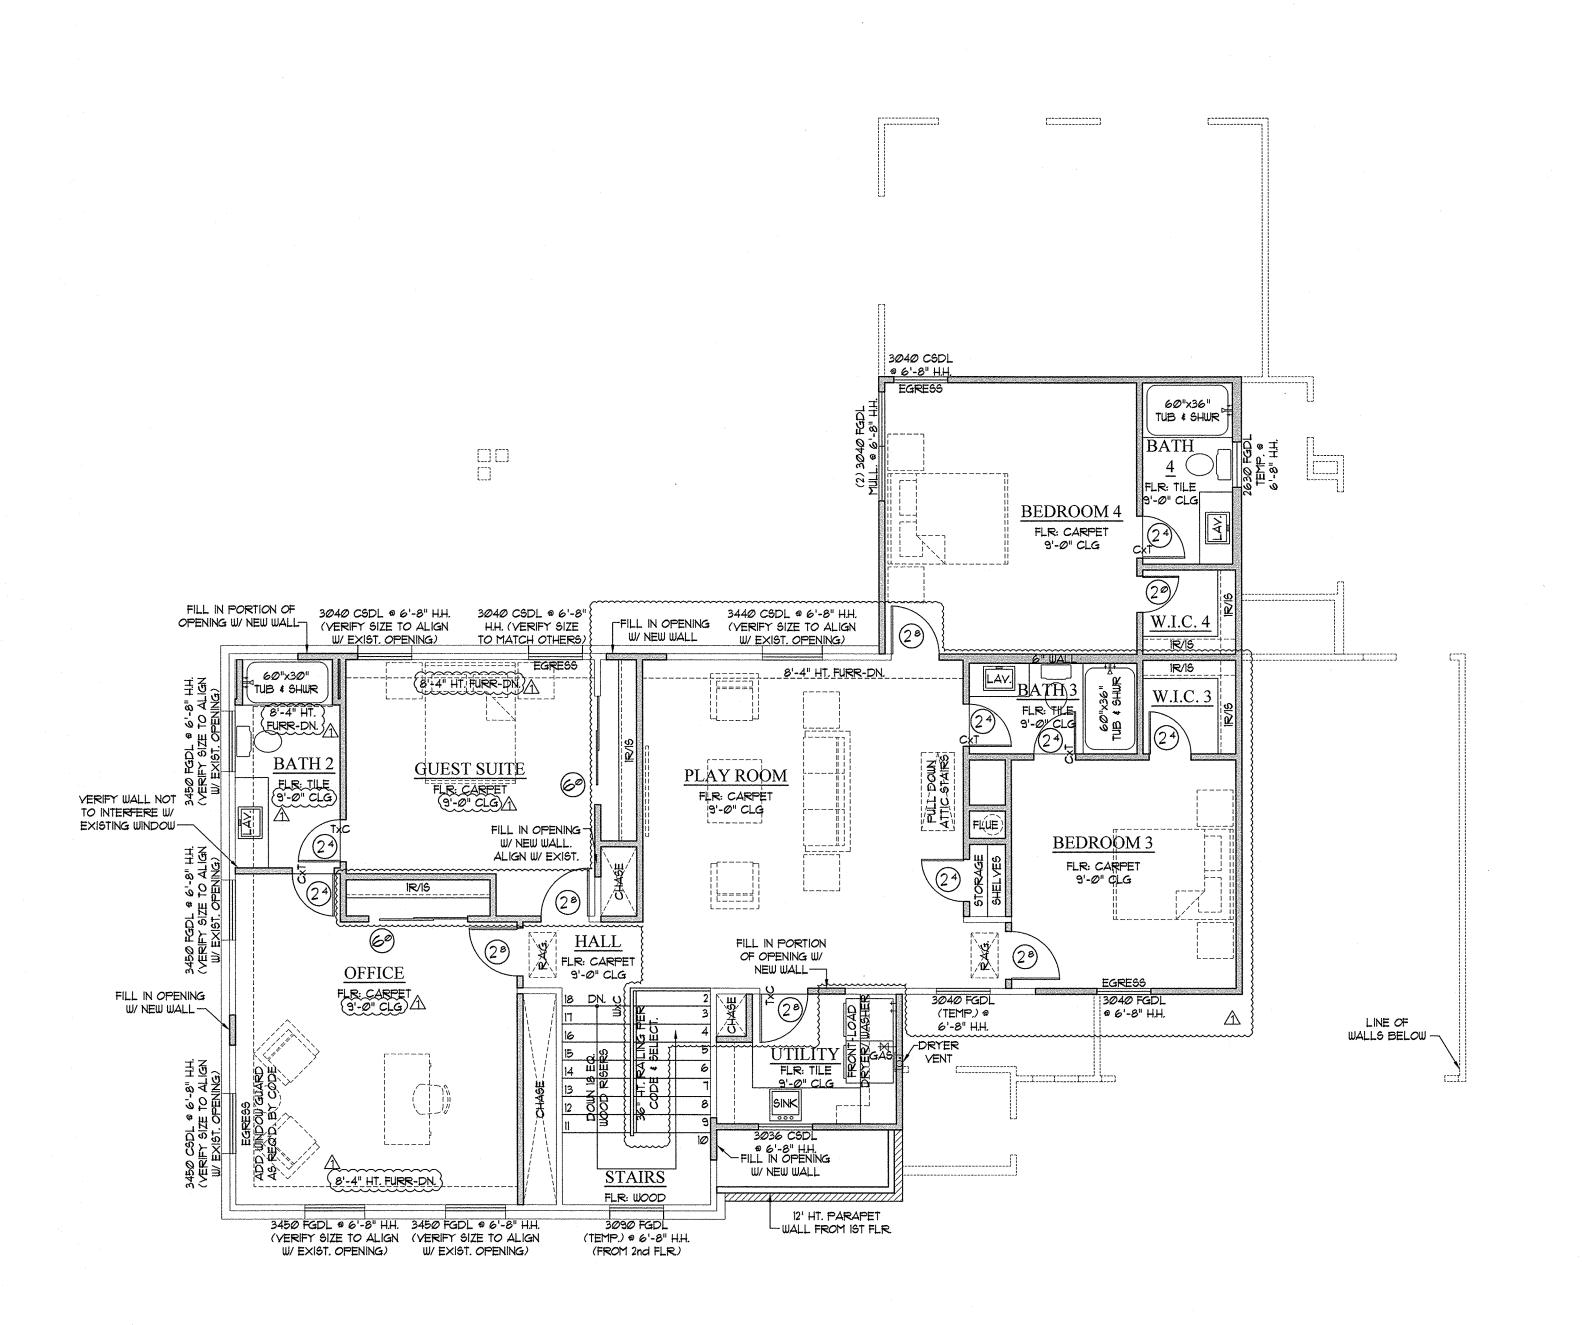

SECOND FLOOR NOTES PLAN

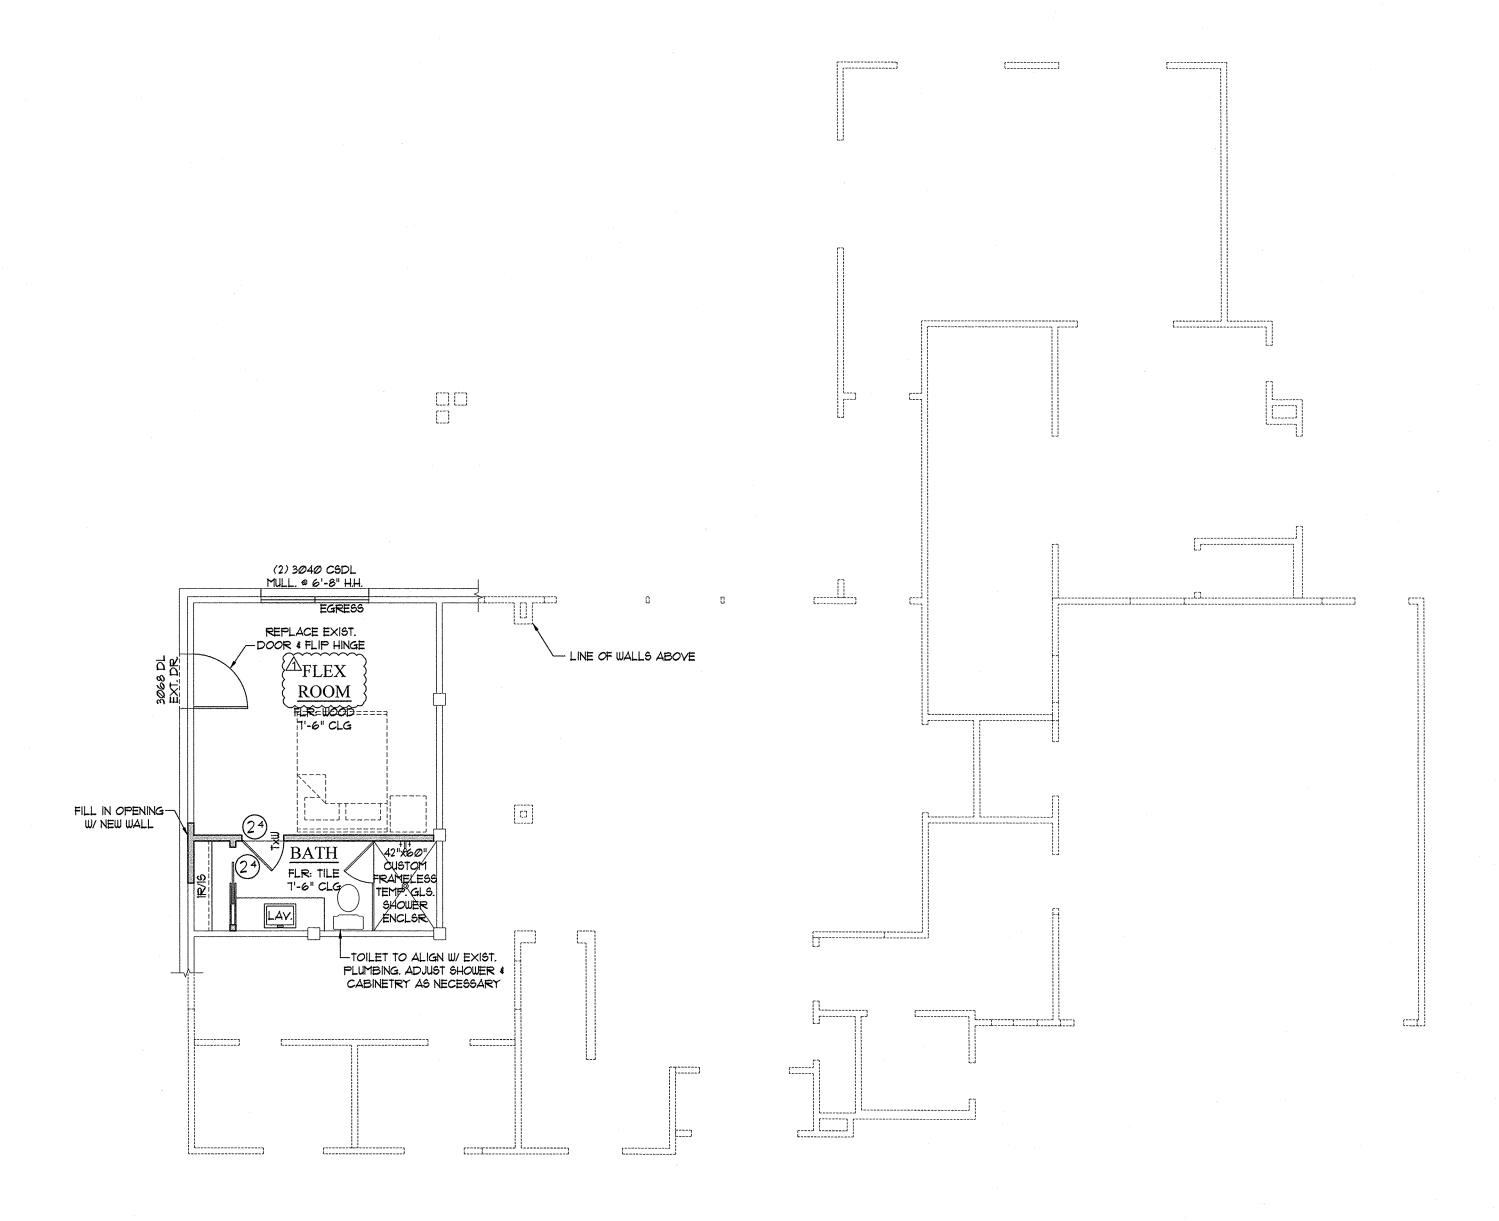



BASEMENT NOTES PLAN SCALE 3/16" = 1'-0"

WALL LEGEND

EXISTING WALLS

NEW FRAME WALLS
NEW MASONRY VENEER

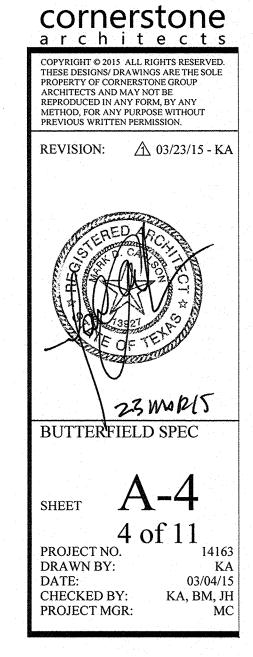

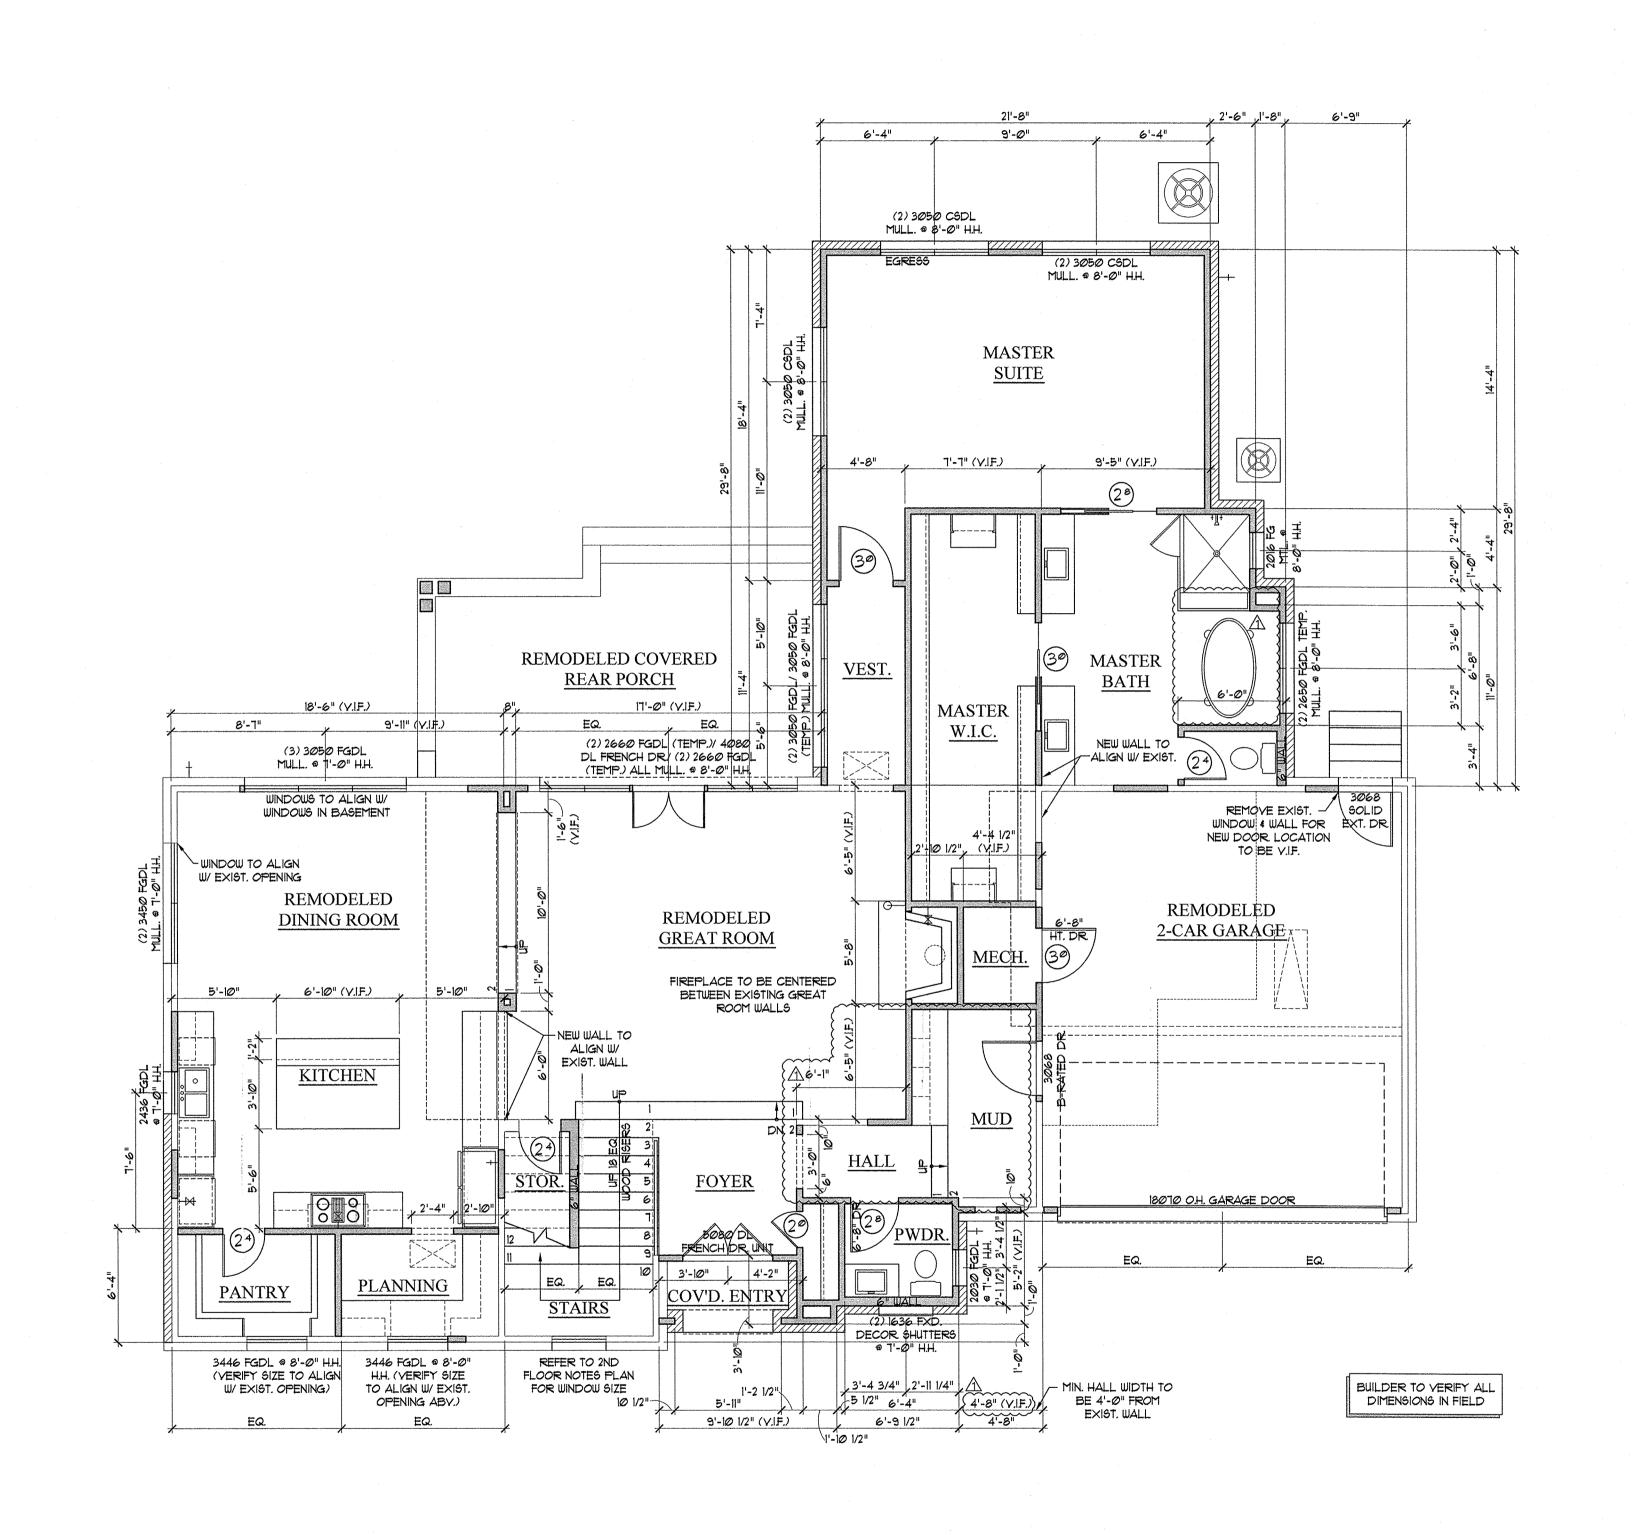

FIRST FLOOR DIMENSION PLAN

cornerstone architects


COPYRIGHT © 2015 ALL RIGHTS RESERVED.
THESE DESIGNS/ DRAWINGS ARE THE SOLE
PROPERTY OF CORNERSTONE GROUP
ARCHITECTS AND MAY NOT BE
REPRODUCED IN ANY FORM, BY ANY
METHOD, FOR ANY PURPOSE WITHOUT
PREVIOUS WRITTEN PERMISSION.




BUTTERFIELD SPEC

SHEET PROJECT NO. DRAWN BY: DATE: CHECKED BY: PROJECT MGR:


03/04/15 KA, BM, JH MC

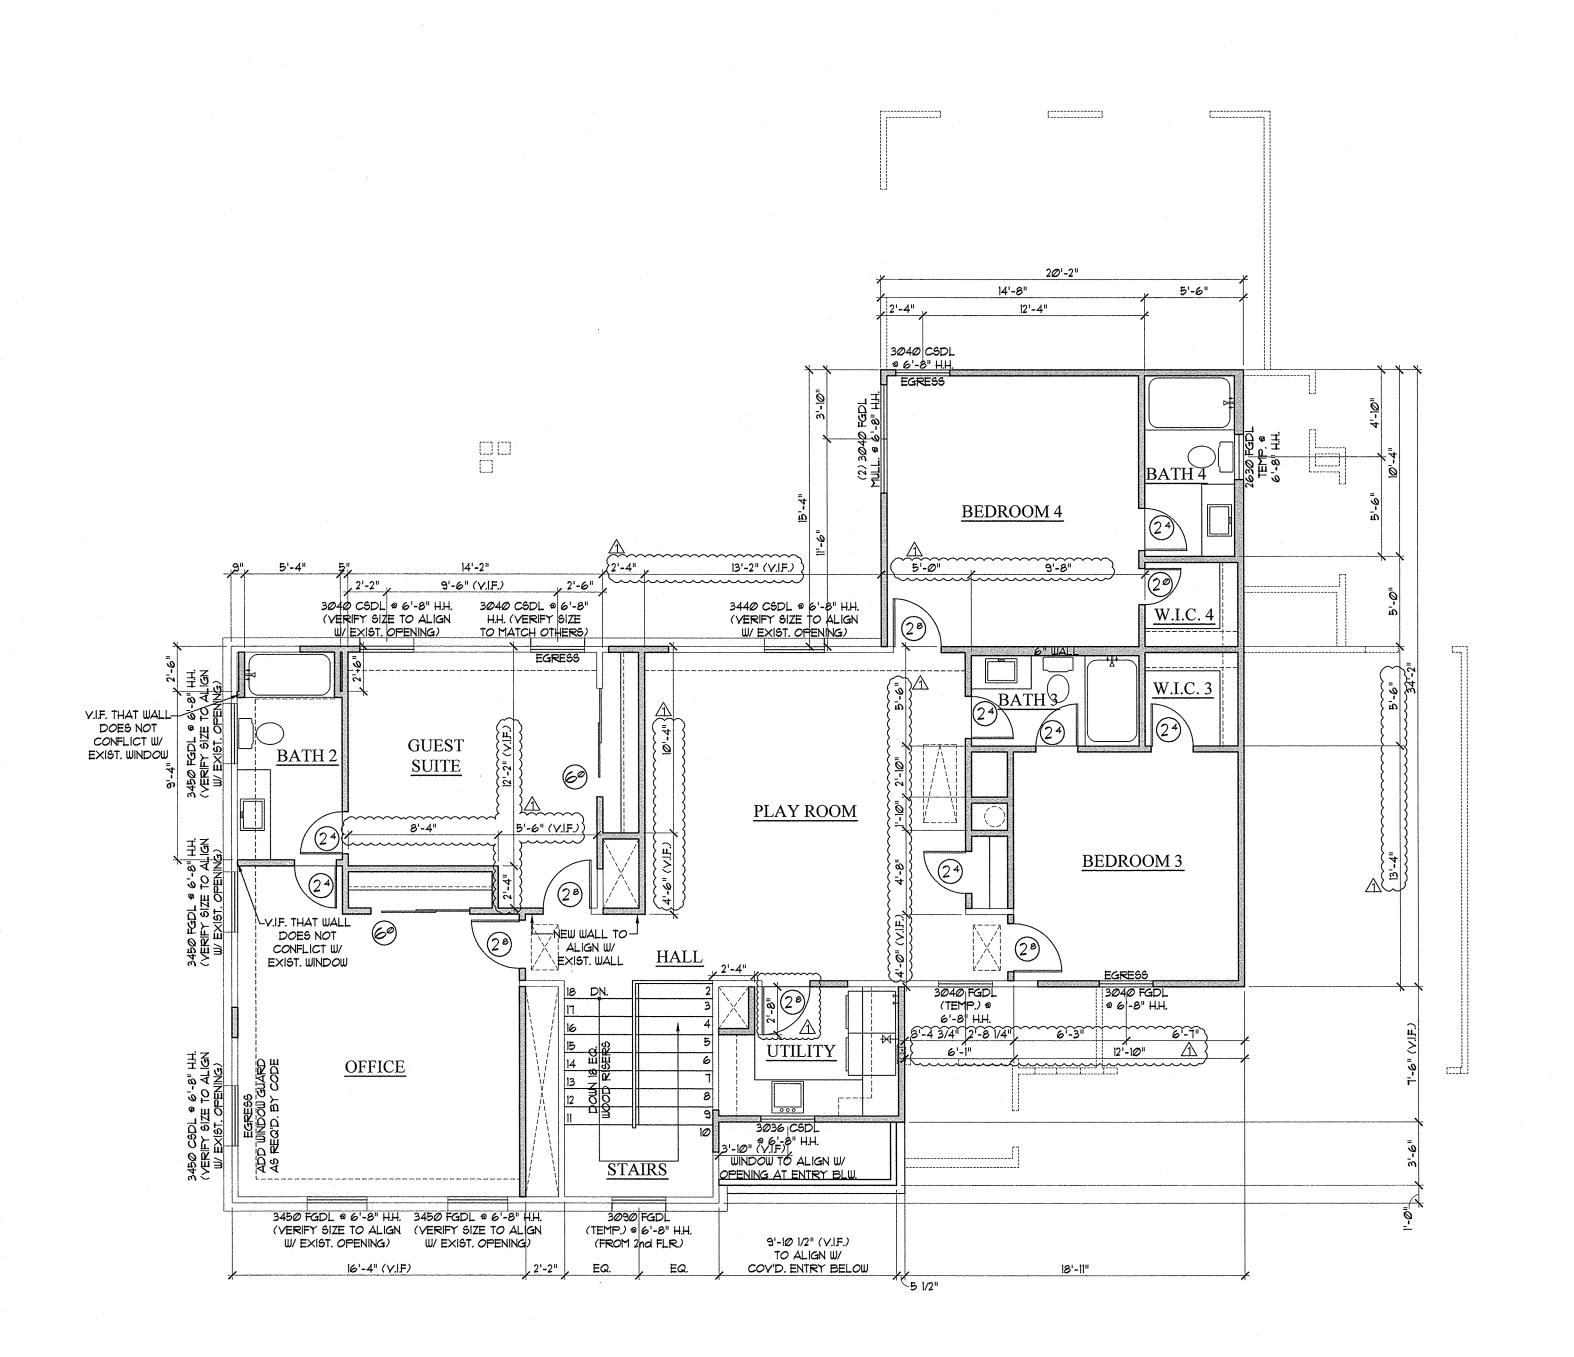


SECOND FLOOR DIMENSION PLAN

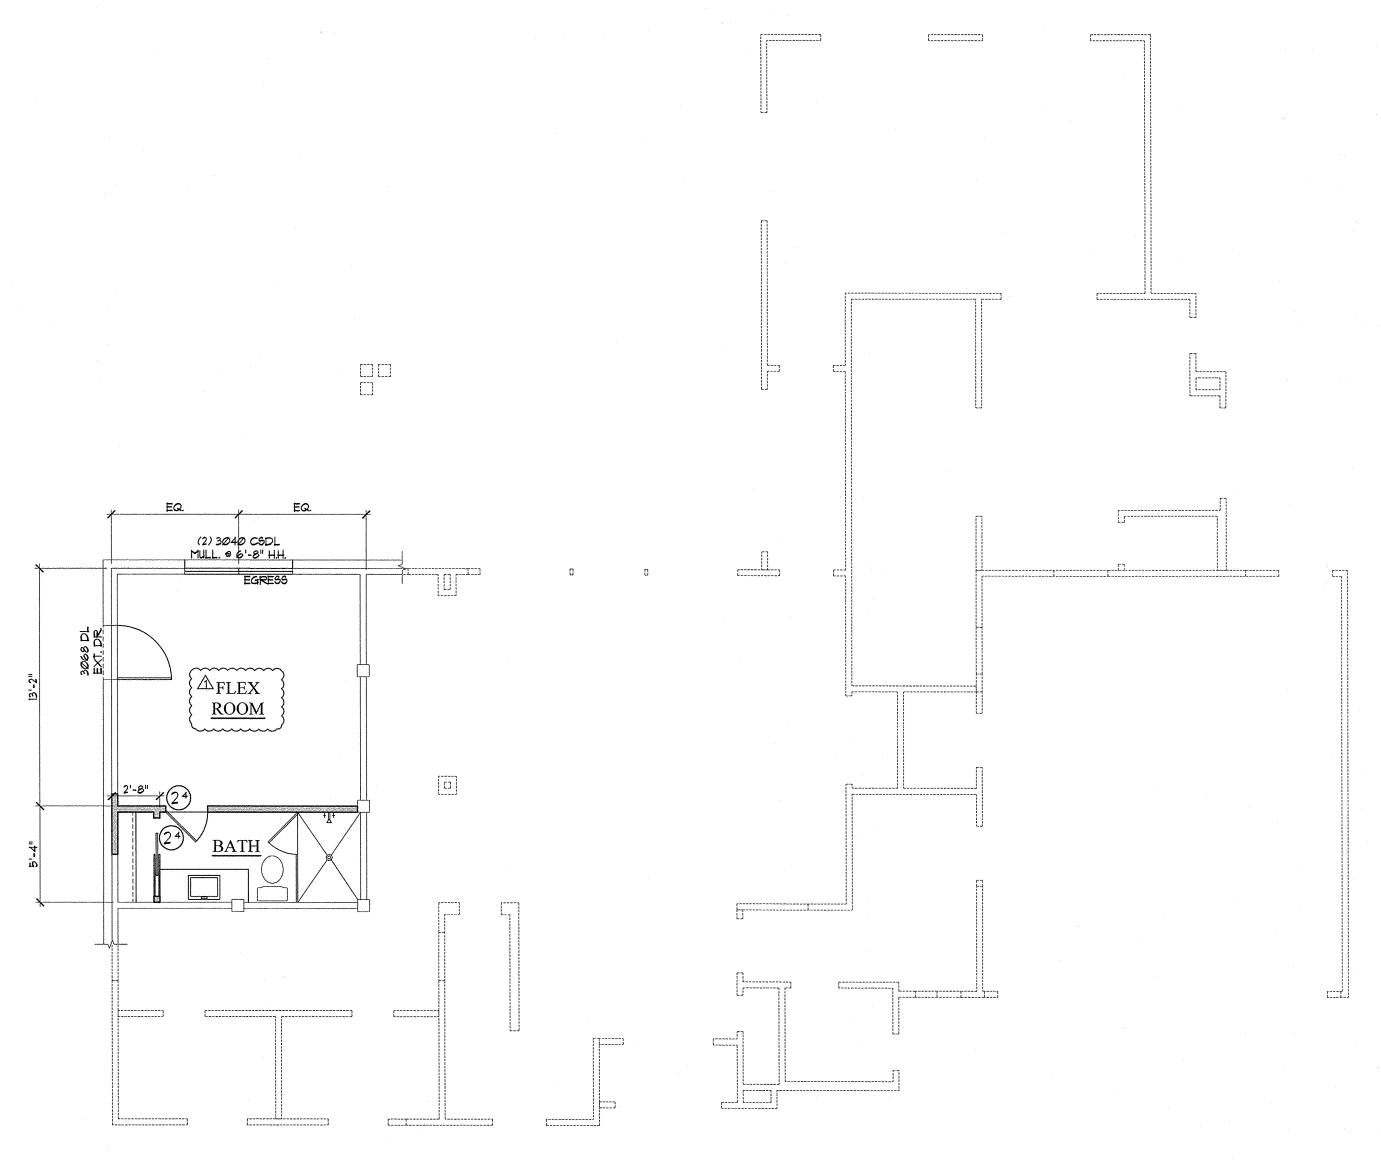


BASEMENT DIMENSION PLAN

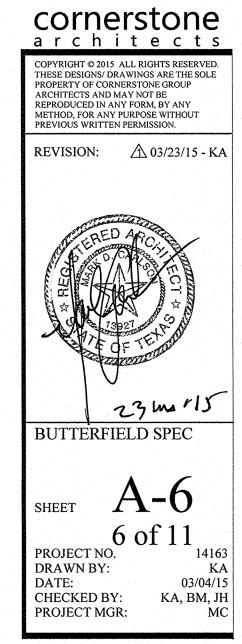

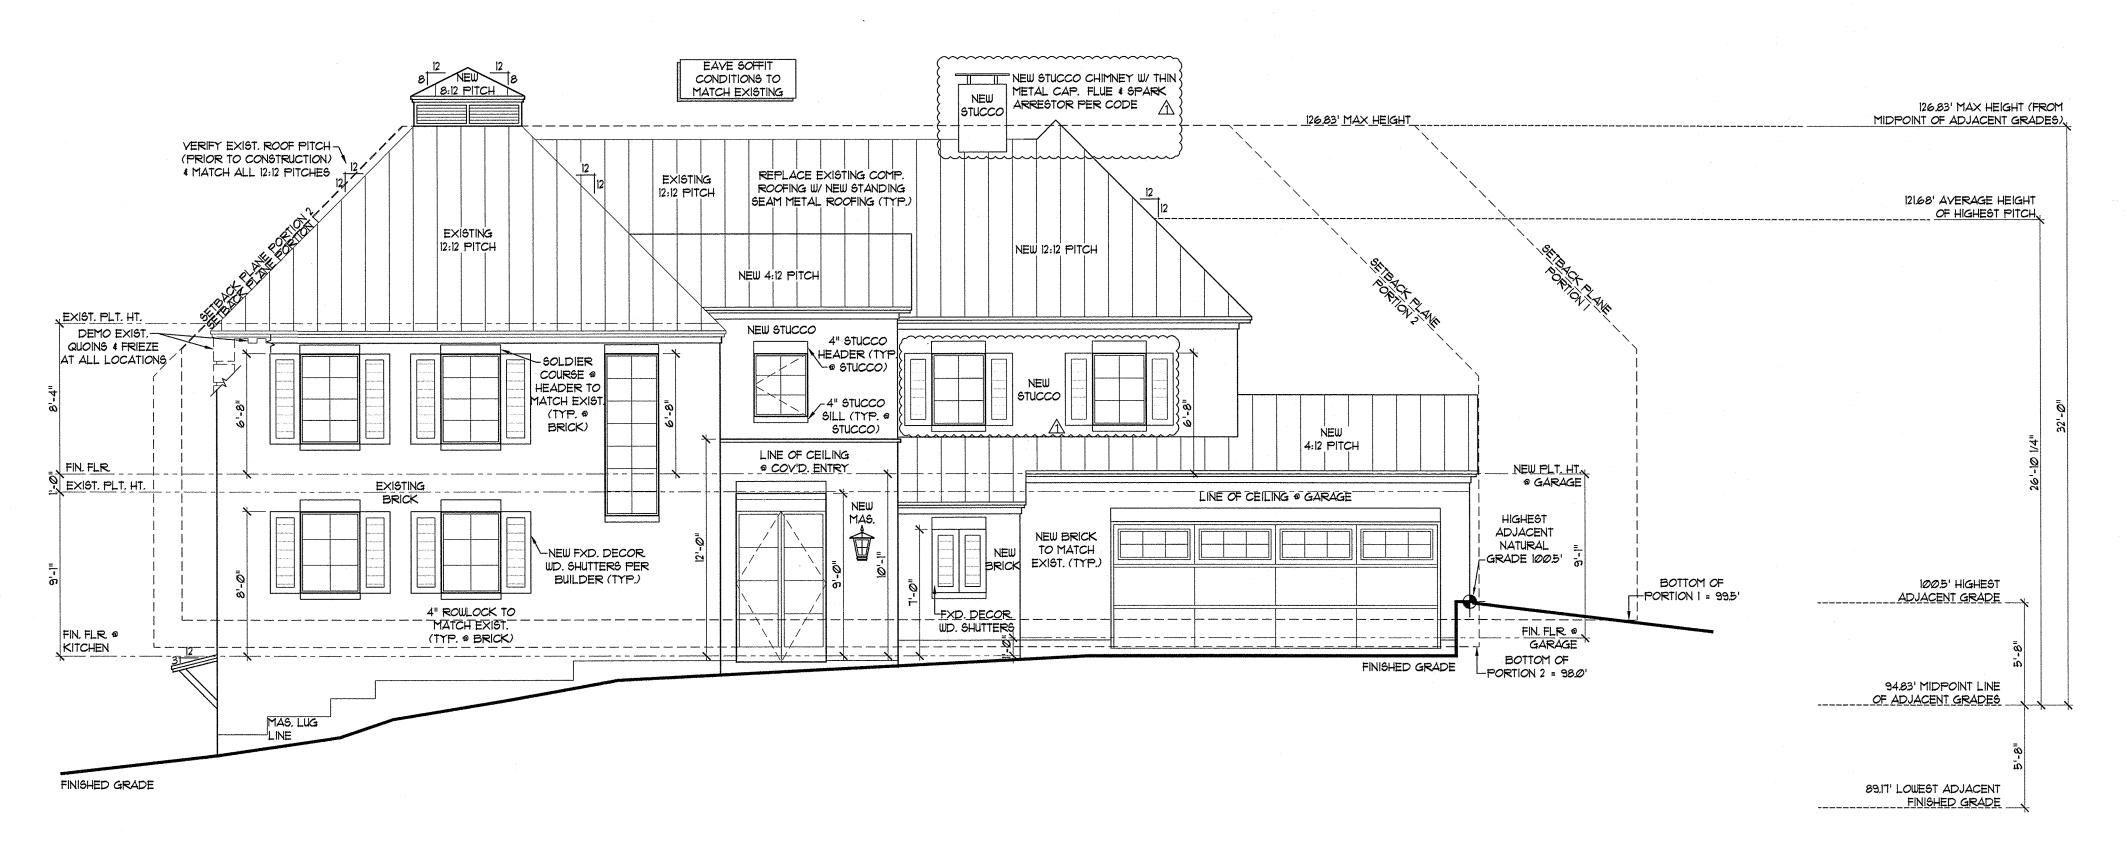


FRONT ELEVATION SCALE 3/16" = 1'-0"

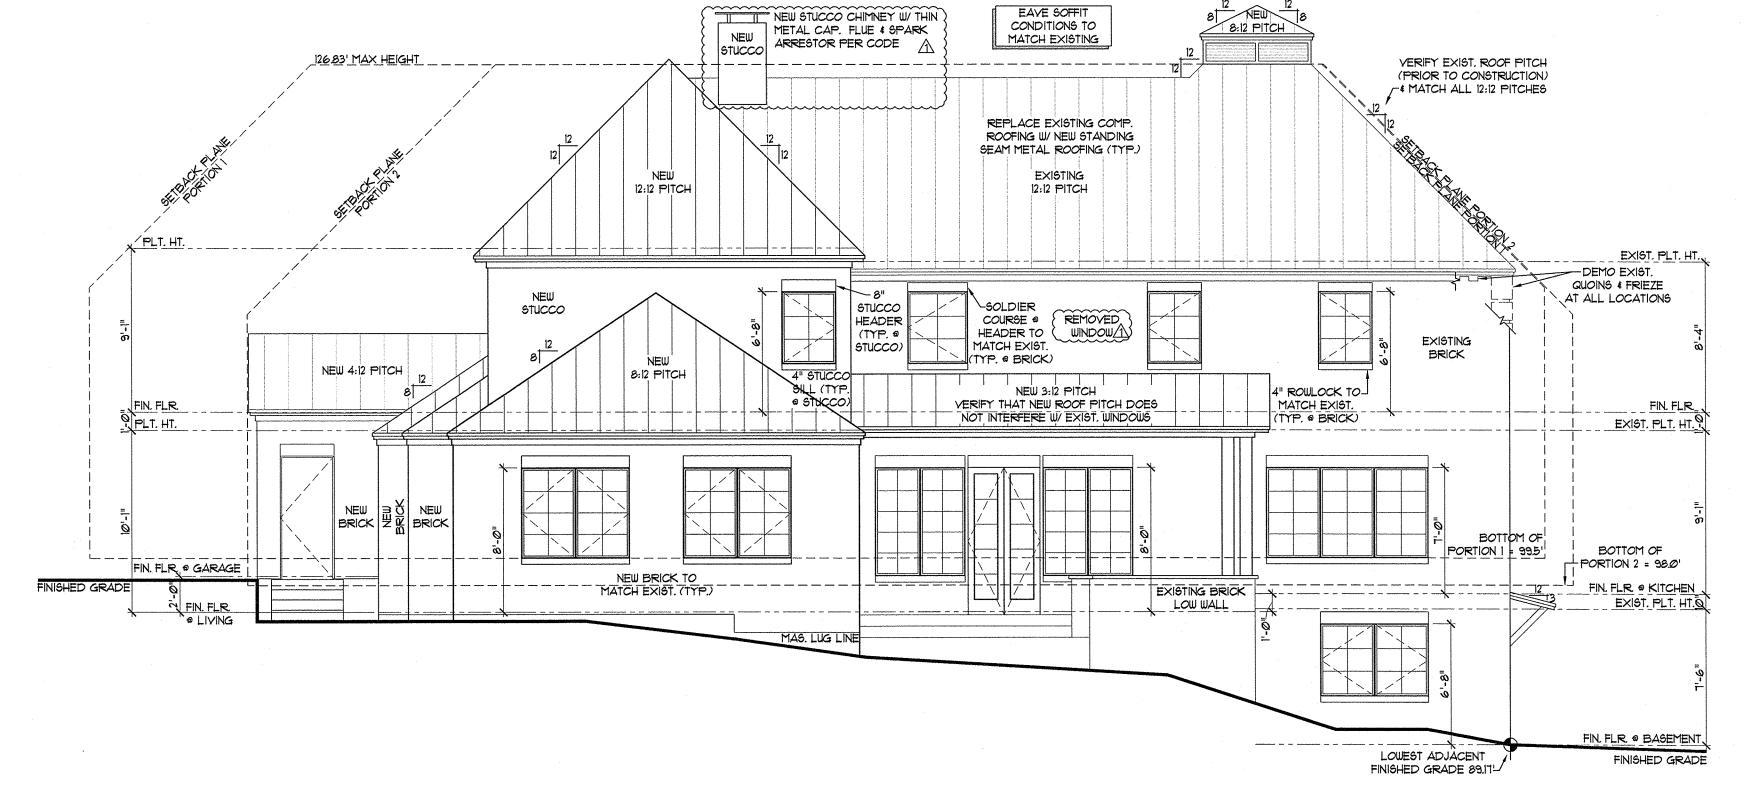

REAR ELEVATION

GENERAL ELEVATION NOTES

- ALL WINDOW HDR HTS. LOWER FLOOR TO BE 8'-0" AFF.
 UNLESS NOTED OTHERWISE ON FLOOR PLANS. ALL
 WINDOW HDR. HTS. UPPER FLOOR & BASEMENT TO BE 6'-8"
 AFF. UNLESS NOTED OTHERWISE ON FLOOR PLANS.
- 2.0 PROVIDE MIN. 4" W. TRIM AT ALL SIDES OF ALUMINUM WINDOWS. STUCCO TRIM AT STUCCO WALL VENEER AND IX4 WD. TRIM AT SIDING/WOOD VENEERS.
- 3.0 EXPOSED FOUNDATION TO BE MINIMUM OF 8"
 AND A MAXIMUM OF 24" ABOVE FINISHED
 GRADE OR PER SUBDIVISION REQUIREMENTS.
 UNDERPIN ALL EXPOSED FOUNDATIONS.
- 4.0 GRADE LINES SHOWN ON ELEVATION DRAWINGS SHALL NOT BE CONSTRUED TO REPRESENT ACTUAL FINISH GRADES. VERIFY FINISH GRADE ON JOB SITE.
- 5.0 ACTUAL ELEVATIONS TO VARY PER GRADE OF EXISTING LOT.
- 60 ALL PLUMBING, APPLIANCE AND GAS VENTS TO BE GANGED TO THE FEWEST NUMBER POSSIBLE PENETRATING THE ROOF AND KEPT TO REAR OF ROOF WHEREVER POSSIBLE.
- CHIMNEY/FLUE SHOWN AT MINIMUM DIMENSIONAL HEIGHT REQUIREMENTS PER CODE. BUILDER RESPONSIBLE FOR CONSTRUCTING CHIMNEY/FLUE TO ENSURE PROPER DRAW FOR FIREPLACE BASED ON HOUSE & SITE ORIENTATION VERSUS PREVAILING WINDS.
- 8.0 CONTRACTOR TO PROVIDE RAINSCREEN AND FLASHING BEHIND ALL STUCCO / SIDING VENEERS TO ASSURE ADEQUATE DRAINAGE.

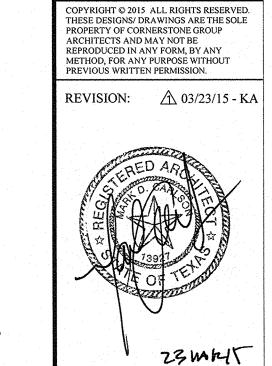

cornerstone architects


SHEET A-7
7 of 11
PROJECT NO. 14

03/04/15 KA, BM, JH MC


DRAWN BY: DATE:

CHECKED BY: PROJECT MGR:


BUTTERFIELD SPEC

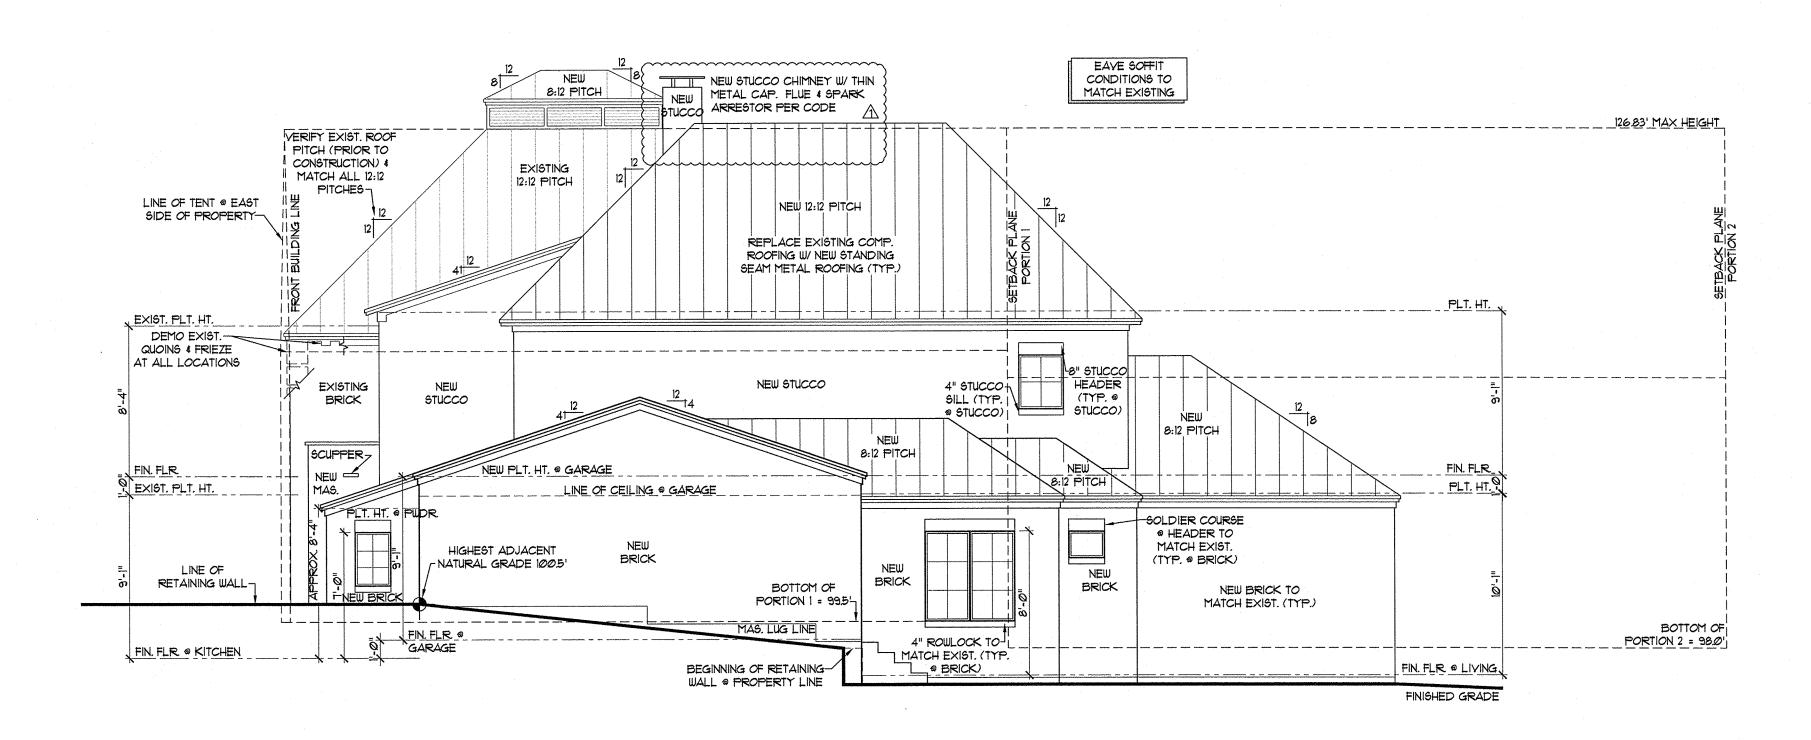


RIGHT ELEVATION

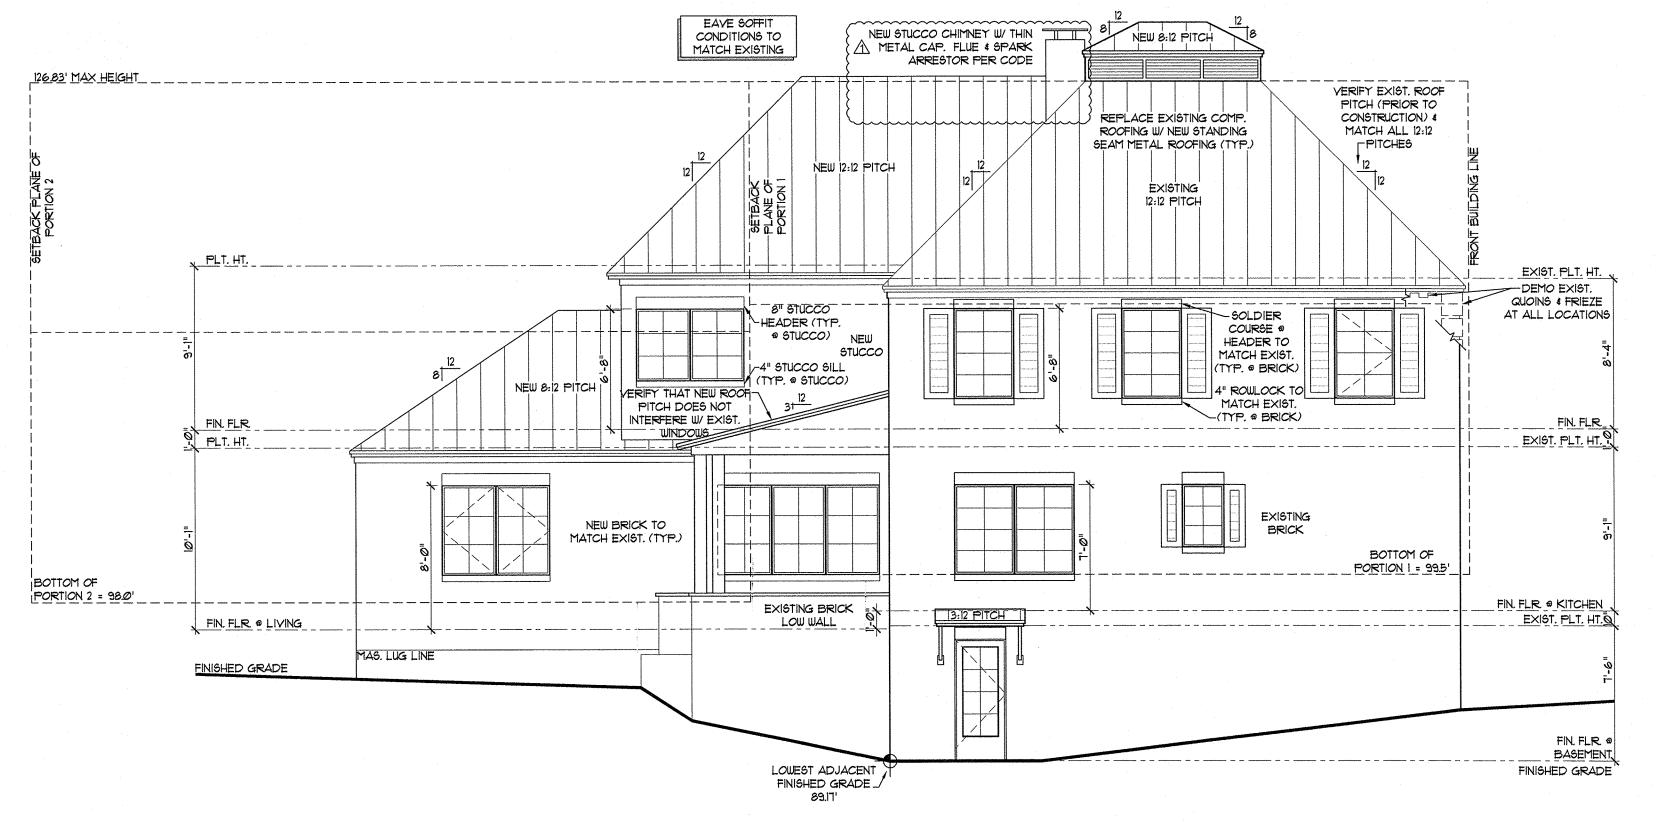

FT ELEVATION

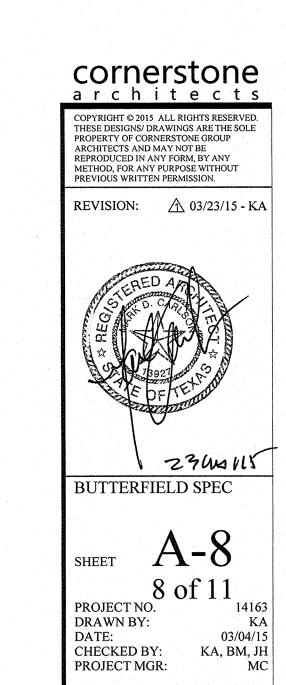

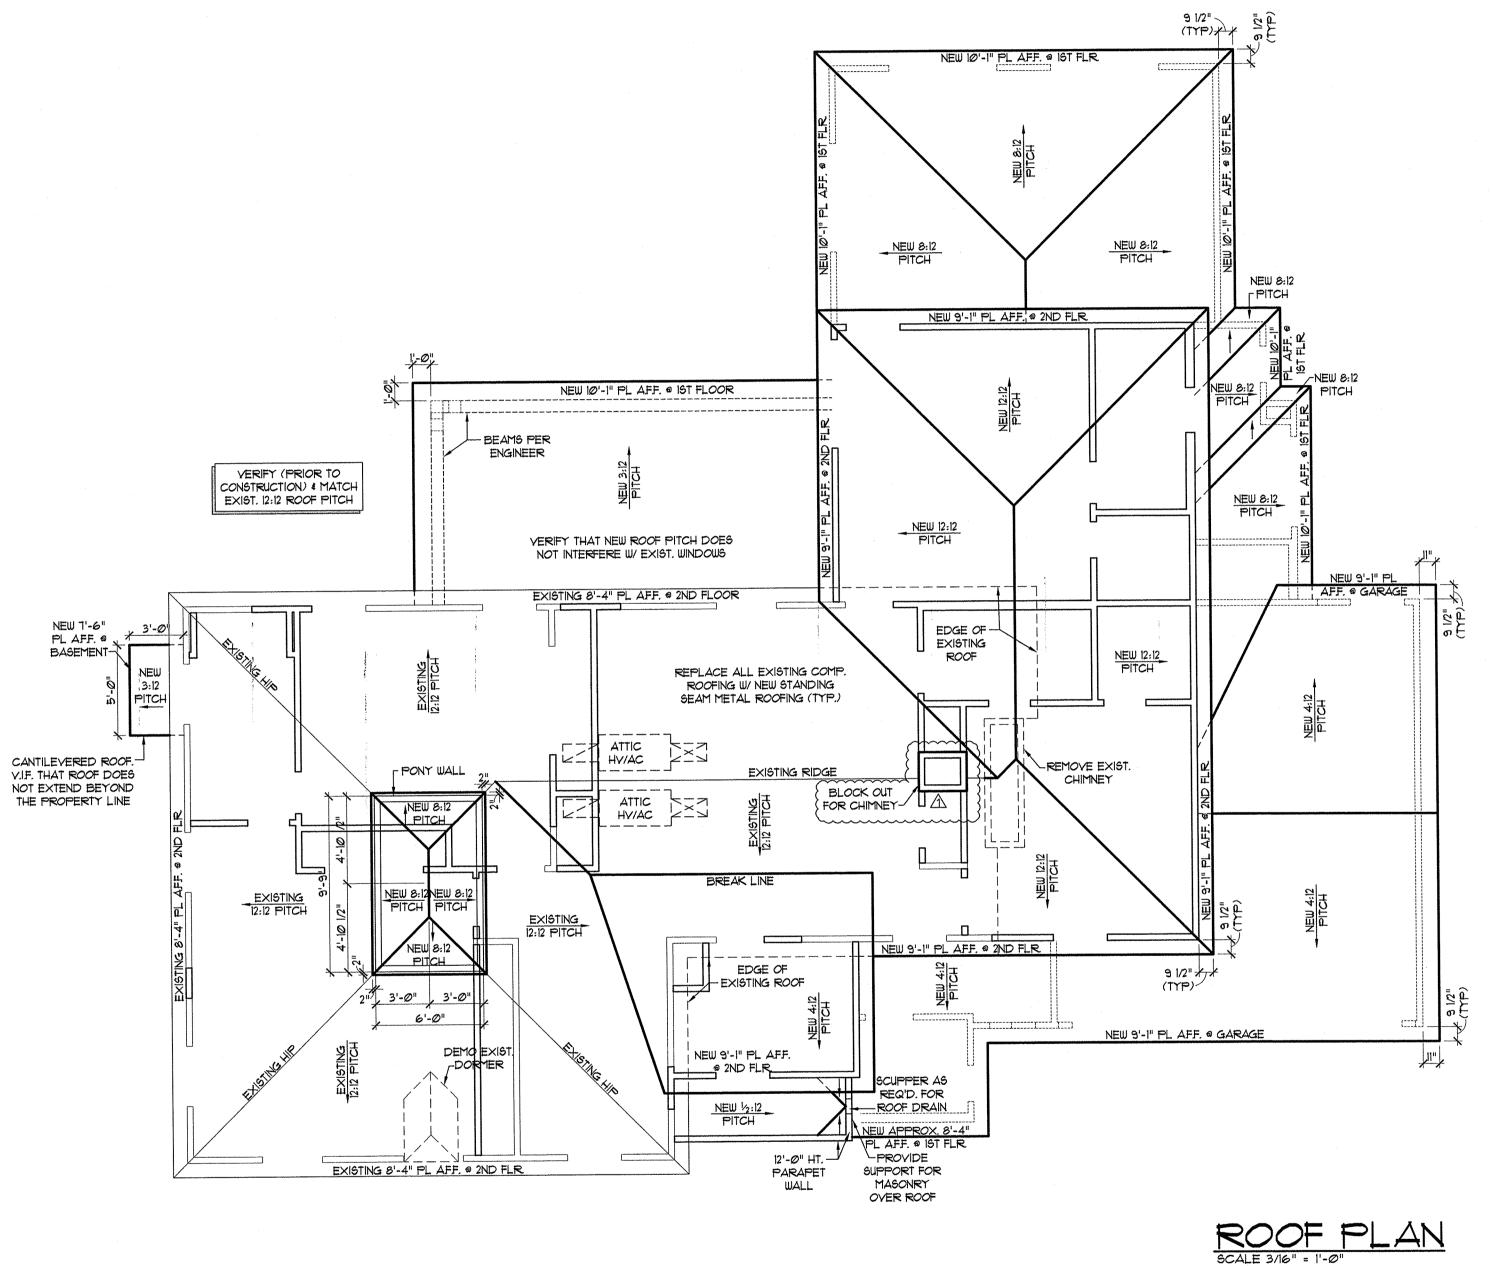

DI AN

WALL/ ROOF LEGEND	
NEW FRAME WALL	
EXISTING FRAME WALL	
NEW ROOF	
EXISTING ROOF	
ROOF DEMO	
ROOF HIDDEN LINES	
Ist FLOOR FRAME WALL	An and the sale \$100,000 to the top one top the top of the first of the top o


GENERAL ROOF NOTES:

- 1.0 PITCHES TO BE AS NOTED ON PLANS.
- 20 HIPS, VALLEYS & RIDGES TO BE FRAMED ONE SIZE LARGER THAN RAFTERS.
- 30 ALL PLUMBING, APPLIANCE AND GAS VENTS TO VENT TO REAR OF ROOF RIDGE WHEREVER POSSIBLE. ALL VENTS TO BE GANGED TO THE FEWEST NUMBER POSSIBLE PENETRATING THE ROOF.
- 4.0 ALL OVERHANGS TO BE 91/2" FROM THE FRAMEWALL UNLESS NOTED OTHERWISE. (V.I.F. TO MATCH EXIST. CONDITION)
- CONDITION)

 5.0 UN.O. ALL INTERIOR WALLS OF ONE STORY PLANS TO BE LOAD BEARING.
- 60 ALL EXTERIOR OPENINGS TO BE LOAD BEARING.
- 1.0 WHEN ENGINEERED TRUSSES TO BE USED TRUSS DESIGN 4 SPACING TO BE PER ENGINEER'S SPECIFICATIONS.
- 8.0 ALL WALLS OVER 10'-0" IN HEIGHT TO BE FRAMED WITH 2x6 STUDS. IF WALLS OVER 10'-0" IN HEIGHT ARE NOT BUILT WITH 2x6 STUDS THEY MUST BE BUILT WITH DOUBLE 2x4 STUDS AT 12" O.C.
- 90 BUILDER ACCEPTS FULL RESPONSIBILITY FOR CHECKING PLANS TO ASSURE CONFORMITY TO CURRENT LOCAL BUILDING CODES. SHOULD ANY CHANGES BE MADE TO THESE PLANS BY BUILDER OR HIS REPRESENTATIVES WITHOUT CONTACTING THE ARCHITECT, THE BUILDER WILL ACCEPT FULL LIABILITY FOR AMENDED PLANS.
- 100 THE DESIGN & SIZING OF ALL LOAD BEARING HEADERS, STRUCTURAL BEAMS AND TRUSSES IS THE RESPONSIBILITY OF THE AGENT (ENGINEER/TRUSS MANUFACTURER, ETC.) CHOSEN BY THE BUILDER/OWNER TO DO SAID DESIGN.

cornerstone architects

COPYRIGHT © 2015 ALL RIGHTS RESERVED.
THESE DESIGNS/ DRAWINGS ARE THE SOLE
PROPERTY OF CORNERSTONE GROUP
ARCHITECTS AND MAY NOT BE
REPRODUCED IN ANY FORM, BY ANY
METHOD, FOR ANY PURPOSE WITHOUT
PREVIOUS WRITTEN PERMISSION.

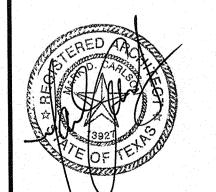

Z3 mr /S BUTTERFIELD SPEC

SHEET A-9

 9 OI 11

 PROJECT NO.
 14163

 DRAWN BY:
 KA

 DATE:
 03/04/15

 CHECKED BY:
 KA, BM, JH

 PROJECT MGR:
 MC