



GENERAL CONDITIONS

01700
ALL WORK SHALL COMPLY WITH APPLICABLE NATIONAL, STATE, AND LOCAL ORDINANCES AND WITH THE APPLICATION EDITION OF THE UBC. DRAWINGS AND SPECIFICATIONS REPRESENT THE FINISHED STRUCTURE. CONTRACTOR SHALL BE RESPONSIBLE FOR MEANS AND METHODS OF CONSTRUCTION, INCLUDING BUT NOT LIMITED TO SHORING AND TEMPORARY BRACING. CONTRACTOR SHALL UNDERTAKE ALL NECESSARY MEASURES TO INSURE SAFETY OF ALL PERSONS AND STRUCTURES AT THE JOB SITE AND ADJACENT TO THE SITE. OBSERVATION VISITS TO THE SITE BY THE DESIGNER OR ENGINEER DOES NOT INCLUDE REVIEW OF THESE MEASURES OR ANY OF THE CONTRACTOR'S WORK. THE CONTRACTOR IS RESPONSIBLE FOR VERIFICATION OF ON-SITE DIMENSIONS AND CONDITIONS AND SHALL REPORT DISCREPANCIES IMMEDIATELY TO THE DESIGNER (ODOM TURNER STUDIO). WHEN APPLICABLE, THE SOIL REPORT, THE STRUCTURAL CALCULATIONS AND THE ENERGY CALCULATIONS, AS WELL AS THE RECOMMENDATIONS CONTAINED THEREIN, ARE AN INTEGRAL PART OF THE CONTRACT DOCUMENTS.

THE INTENTION OF THESE DOCUMENTS IS TO INCLUDE LABOR, MATERIALS, SERVICE, EQUIPMENT, AND TRANSPORTATION NECESSARY FOR COMPLETE AND PROPER EXECUTION OF THE WORK INDICATED ON THE DRAWINGS AND THE WORK THAT CAN BE REASONABLY INFERRED THEREFROM AS BEING NECESSARY TO PRODUCE THE INTENDED RESULTS. THE DRAWINGS SHALL NOT BE SCALED FOR MEASUREMENTS.

THE CONTRACTOR IS RESPONSIBLE FOR OBTAINING ALL NECESSARY PERMITS REQUIRED FOR EXECUTION OF THIS PROJECT. PERMITTING FEES ARE TO BE INCLUDED IN THE CONTRACTOR'S FINAL BID PACKAGE. THE OWNER IS RESPONSIBLE FOR PROVIDING THE CONTRACTOR WITH ALL NECESSARY DRAWINGS AND SPECIFICATIONS IN A TIMELY MANNER, FOR THE PERMITTING PROCESS.

CLEAN-UP: THE CONTRACTOR AT ALL TIMES SHALL KEEP THE PREMISES FREE FROM ACCUMULATION OF WASTE MATERIALS AND RUBBISH. AT THE COMPLETION OF THE WORK THE CONTRACTOR SHALL REMOVE ALL WASTE MATERIALS AND RUBBISH FROM THE SITE AS WELL AS ALL TOOLS, CONSTRUCTION EQUIPMENT, MACHINERY AND SURPLUS MATERIALS. FINAL CLEANING SHALL INCLUDE: BROOM CLEAN ALL PAVED AREAS ON THE SITE AND ADJACENT AREAS. REMOVE ALL TRACES OF SOIL, WASTE MATERIAL, SMUDGES AND OTHER FOREIGN MATTER FROM ALL INTERIOR AND EXTERIOR SURFACES. CLEAN ALL GLASS SURFACES AND MIRRORS, INSIDE AND OUTSIDE.

02000
TAKE ALL NECESSARY MEASURES TO FULLY PROTECT ADJACENT PROPERTIES AND THE UNDERGROUND AND OVERHEAD UTILITY LINES. EXCAVATIONS SHALL BE KEPT FREE OF STANDING WATER. WHERE EXCAVATIONS ARE MADE TO DEPTHS GREATER THAN INDICATED, THEY SHALL BE FILLED WITH CONCRETE AS SPECIFIED FOR FOOTINGS, UNDER FOOTINGS AND FOUNDATIONS, AND WITH PROPERLY COMPACTED SOIL IN ALL OTHER AREAS. BACK FILL SHALL BE COMPACTED TO A MINIMUM 90 PERCENT DENSITY AND SHALL BE DONE IN LAYERS OF 1'-0" MAX.

SANDBLAST CONCRETE RETAINING WALLS FOLLOWING COMPLETE CURING. REMOVE ALL EXPOSED AND LOOSE PAPER BAG RUBBISH FROM SITE AND DISPOSE OF PROPERLY.

03000
MINIMUM COMPRESSION STRENGTH AT 28 DAYS FROM INITIAL DATE OF POUR:
FOOTINGS 2,000 PSI
SLABS ON GRADE 2,000 PSI
ALL OTHER CONCRETE 3,000 PSI

THE CONCRETE SHALL BE SUPPLIED BY AN APPROVED READY MIX PLANT, THE SLUMP SHALL NOT EXCEED 4"

REINFORCING STEEL SHALL BE DEFORMED BAR STEEL, GRADE 40 FOR #3 AND 44, GRADE 60 FOR #5 AND LARGER, CONFORMING TO ASTM A615. LAP BARS 40 DIAM. MIN. WELDED WIRE FABRIC SHALL CONFORM TO ASTM A1 85.

REINFORCING STEEL SHALL HAVE A MINIMUM CONCRETE PROTECTIVE COVERINGS AS FOLLOWS:
POURED AGAINST EARTH 3"
POURED AGAINST FORMS BUT EXPOSED TO EARTH OR WEATHER 2"
WALLS AND SLABS NOT EXPOSED TO EARTH OR WEATHER 1 1/2"

WELDED WIRE FABRIC SHALL BE LAPPED 1 1/2" SPACES. (9" MIN). WELDED REBAR TO BE A706 GRADE 60 USE E90XX WELDING ROD. INTERIOR SLABS SHALL RECEIVE A STEEL TROWEL FINISH, THE EXTERIOR SLABS TO BE BROOM FINISHED, UNLESS NOTED OTHERWISE.

BOLTS, ANCHORS, HOLD-DOWNS AND ALL INSERTS SHALL BE ACCURATELY LOCATED AND SECURELY HELD IN PLACE UNTIL CONCRETE IS HARDENED. ALL HOLD-DOWNS SHALL BE TIED IN PLACE PRIOR TO FOUNDATION INSPECTION.

04000
CONCRETE MASONRY UNITS SHALL BE GRADE N UNITS CONFORMING TO THE ASTM DESIGNATION C90 AND, IN ADDITION, THE REQUIREMENTS OF THE QUALITY CONTROL STANDARDS OF THE CONCRETE MASONRY ASSOCIATION.

PORTLAND CEMENT SHALL CONFORM TO ASTM DESIGNATION C150.
MORTAR SHALL CONFORM TO ASTM C270.

GROUT SHALL BE FLUID CONSISTENCY, GROUT MIX SHALL BE TRANSIT MIX CONFORMING TO ASTM C-94 AND SHALL HAVE A MINIMUM 28 DAY COMPRESSIVE STRENGTH OF 2000 PSI.

REINFORCING STEEL SHALL BE DEFORMED BARS CONFORMING TO ASTM DESIGNATION A 615 EXCEPT THAT 1/4" TIES MAY BE PLAIN BARS. WIRE REINFORCEMENT SHALL CONFORM TO ASTM DESIGNATION A82.

ALL GROUT SHALL BE CONSOLIDATED BY: VIBRATING USING A 3/4" HEAD VIBRATOR FOR ONE OR TWO SECONDS, WITH VIBRATION DONE AFTER THE INITIAL LOSS OF WATER AND BEFORE INITIAL SET, IN LIFTS, NOT EXCEEDING 4'-0".

TOOL ALL JOINTS TO A DENSE, SMOOTH CONCAVE SURFACE.

05000
FURNISH AND INSTALL METAL FLASHING, GUTTERS, COPINGS, ETC.. WHERE REQUIRED.

INSTALL EXPANSION JOINTS WHERE APPLICABLE, TO ADEQUATELY PROVIDE FOR THERMAL MOVEMENT OF THE FINISHED WORK.

06000
FRAMING LUMBER SHALL BE #2 SOUTHERN PINE OR AS NOTED ON THE DRAWINGS. FASCIAS, OUTLOOKERS, EXPOSED BEAMS, ETC. SHALL BE RESAWN UNLESS NOTED OTHERWISE.

PROVIDE 2 X BACKING FOR ALL WALL HUNG CABINETS, SHELVING, HANDRAILS, LIGHT FIXTURES, ACCESSORIES, ETC.. THE FRAMING HARDWARE NOTATIONS ARE BASED ON SIMPSON STRONG TIES, EQUAL PRODUCTS OF OTHER MANUFACTURES ARE ACCEPTABLE. APPLY A CONTINUOUS BEAD OF STRUCTURAL GLUE TO EACH JOIST WHEN THE SPAN OF THE HEADER EXCEEDS 4'-0".

VERIFY ALL NOTES WITH STRUCTURAL PLANS

06200
ALL JOINTS SHALL BE TIGHT AND TRUE AND SECURELY FASTENED. CORNERS SHALL BE NEATLY MITERED, BUTTED, OR COPED, WITH NAILS SET AND SURFACES FREE OF TOOL MARKS. SHELVING SHALL HAVE SOLID EDGING AND WOOD SPECIES AS NOTED, GRADE AA-INT.

WOOD WORK SHALL BE ACCURATELY SCRIBED TO FIT ADJOINING SURFACES.

ALL WORK SHALL BE MACHINED OR HAND-SANDED, SHARP EDGES AND SPLINTERS REMOVED AND COMPLETELY PREPARED FOR FINISH.

FULL LENGTH CONTINUOUS BOARDS SHALL BE USED WHEREVER APPLICABLE OR SPECIFICALLY NOTED.

EACH DOOR SHALL BE ACCURATELY CUT, TRIMMED, AND FITTED TO ITS RESPECTIVE FRAME AND HARDWARE WITH THE ALLOWANCE FOR PAINTER'S FINISHES.

07000
FURNISH AND INSTALL UNFACED BLANKET INSULATION WITH R-VALUES AS REQUIRED. SUPPORT THE INSULATION WHERE REQUIRED TO PREVENT FALLING OUT, WITH WIRE, NETTING, ETC.

ALL OPENINGS IN THE BUILDING ENVELOPE SHALL BE CAULKED OR OTHERWISE SEALED.

INCLUDING BUT NOT LIMITED TO:

1. EXTERIOR JOINTS AROUND DOOR AND WINDOW FRAMES. BETWEEN WALL PLATES AND FLOOR OR CEILING, RIM JOISTS AND MASONRY FIREPLACES, ETC..
2. OPENINGS FOR PLUMBING, ELECTRICAL, COMMUNICATION, AND MECHANICAL WORK IN WALLS, CEILINGS AND FLOORS.
3. OPENINGS IN THE ATTIC CEILING.

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A0.02	EXISTING SURVEY
A0.03	SITE PLAN
A0.04	BUILDING DEMOLITION PLAN
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A1.02	SECOND FLOOR PLAN
A1.03	ROOF PLAN
A2.01	EAST AND NORTH BUILDING ELEVATIONS
A2.02	WEST AND SOUTH BUILDING ELEVATIONS
A3.01	BUILDING SECTION AND DETAILS
A4.01	FIRST FLOOR POWER AND LIGHTING PLAN
A4.02	SECOND FLOOR POWER AND LIGHTING PLAN
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S4	STRUCTURAL GENERAL NOTES

GENERAL NOTE:

ALL OUTSTANDING PERMITS HAVE BEEN RESOLVED PRIOR TO COMMENCEMENT OF WORK OUTLINED HEREIN.

THOROUGHLY CLEAN ALL JOINTS TO BE SEALED AND APPLY PRIMER WHERE RECOMMENDED BY THE SEALANT MANUFACTURER. ALL WATERPROOFING SHALL BE INSTALLED PER MANUFACTURERS SPECIFICATIONS.

07100
ON THE EXTERIOR SURFACE OF WALLS BELOW GRADE, APPLY TEMPROOF 60, VULKAM 201 H OR SIMILAR MATERIAL MEETING ASTM C-836-78 FOLLOWING THE MANUFACTURERS INSTRUCTIONS.

SURFACES TO RECEIVE DAMP PROOFING; SHALL BE SMOOTH AND FREE OF LOOSE DIRT, EXCESS MORTAR, ETC..

INSTALL AMOC06 POLYSTYRENE PROTECTION BOARD BEFORE BACK FILLING DAMP PROOFING WALLS.

08000
SOLID CORE DOORS TO BE PAINTED, SHALL BE PAINT GRADE WOOD VENEER FOR FLUSH DOORS

CLEARANCES AT THE LOCK AND HANGING STILES AT THE TOP SHALL NOT EXCEED 1/8". CLEARANCE AT THE BOTTOM SHALL BE ADJUSTED FOR FINISH FLOOR COVERING SCHEDULE, INCLUDING CARPETING.

LOCK STILE EDGES SHALL BE BEVELED.

DOORS SHALL OPERATE FREELY, BUT NOT LOOSELY, WITHOUT STICKING OR BINDING AND WITHOUT HINGE BOUND CONDITIONS, AND WITH ALL HARDWARE PROPERLY ADJUSTED AND FUNCTIONING.

09200
USE 5/8" THICKNESS DRYWALL PANELS ON WALLS AND CEILINGS U.N.O.. TAPE AND FLOAT ALL DRYWALL EDGES. SMOOTH FINISH ALL WALLS AND CEILINGS. NO TEXTURE IS TO BE APPLIED TO ANY SURFACE. PREPARE ALL SURFACES FOR PAINT FINISH.

15700
MECHANICAL SYSTEMS TO BE INSTALLED BY A LICENSED PROFESSIONAL INSTALLER IN COMPLIANCE WITH LOCAL CODES. SYSTEM MUST BE APPROVED BY DANIEL SCOTT TURNER DESIGN PRIOR TO INSTALLATION.

CONSULTANTS

PROJECT NAME

4214 Avenue G
Residence
Austin, Texas 78751

Sebastien Weyland and
Dana Wassarman

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02 17 April, 2015

SHEET TITLE(S)


PROJECT CONDITIONS
DRAWING INDEX
Subchapter F Compliance


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PROJECT NUMBER: 14003

CONSULTANTS	
PROJECT NAME	
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Sebastien Weyland and Dana Wassarman	
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SURVEY OF EXISTING CONDITIONS	
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PROJECT NUMBER: 14003	



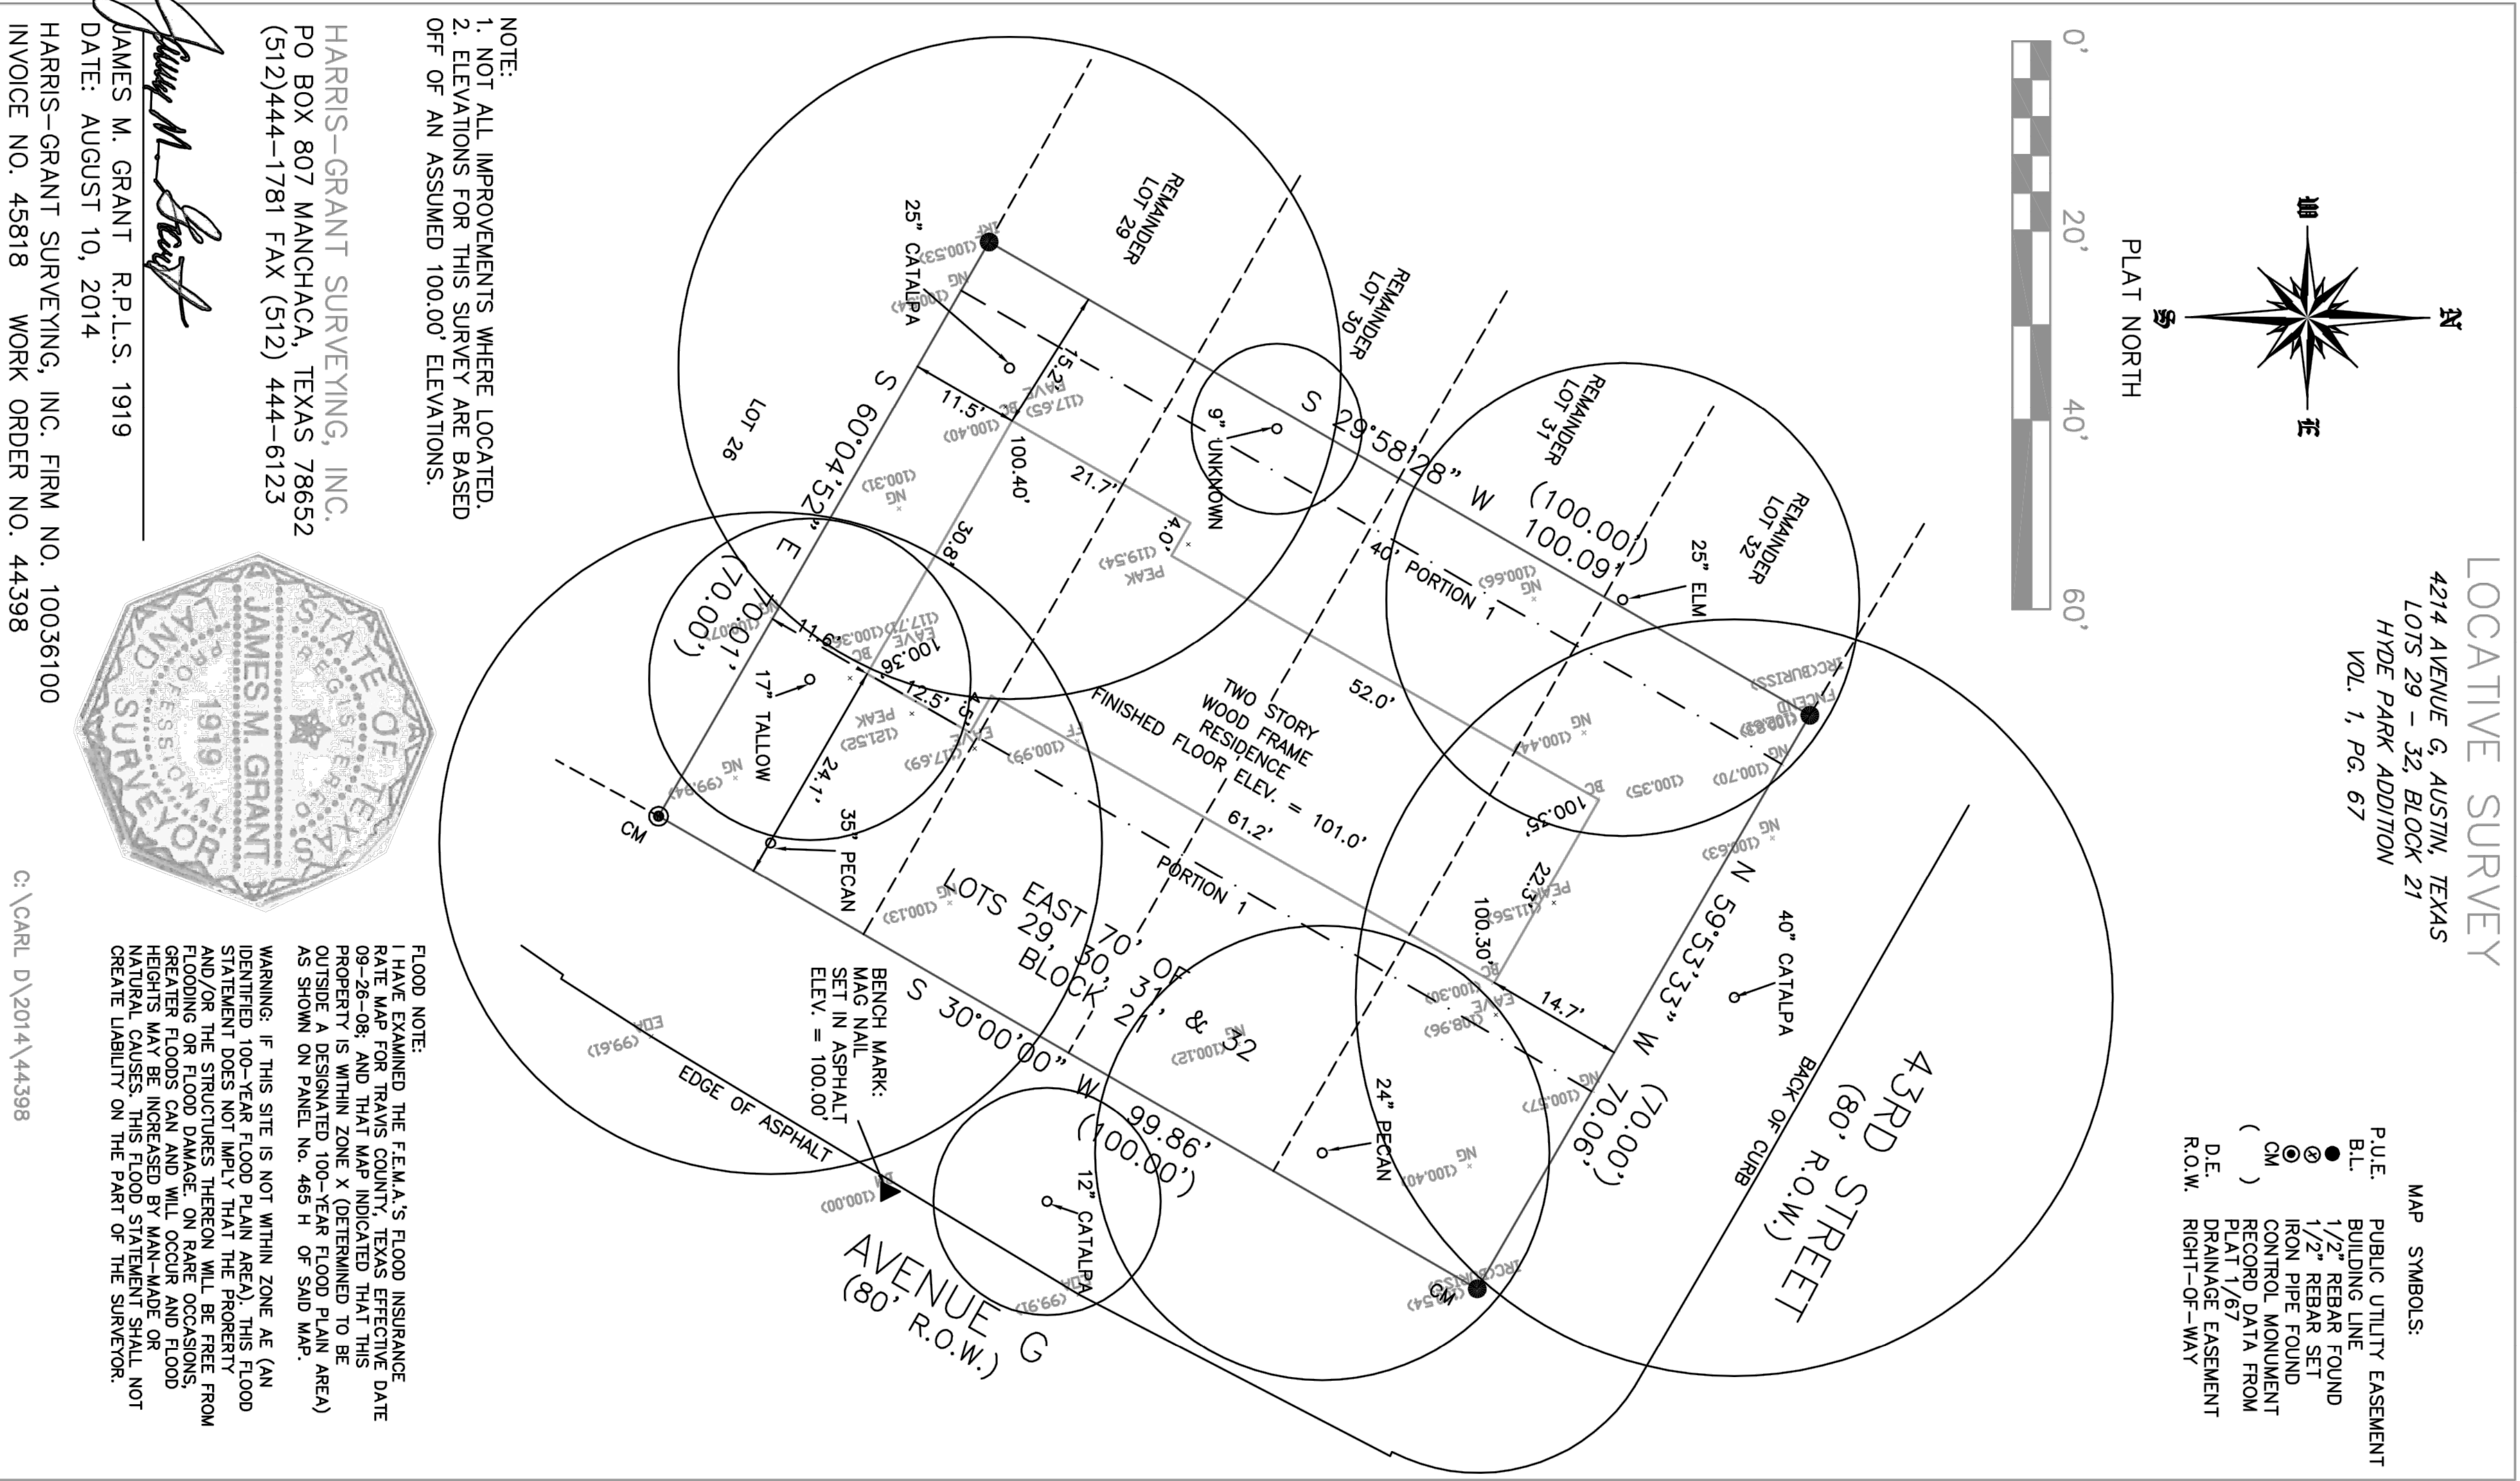

FOR REGULATORY REVIEW

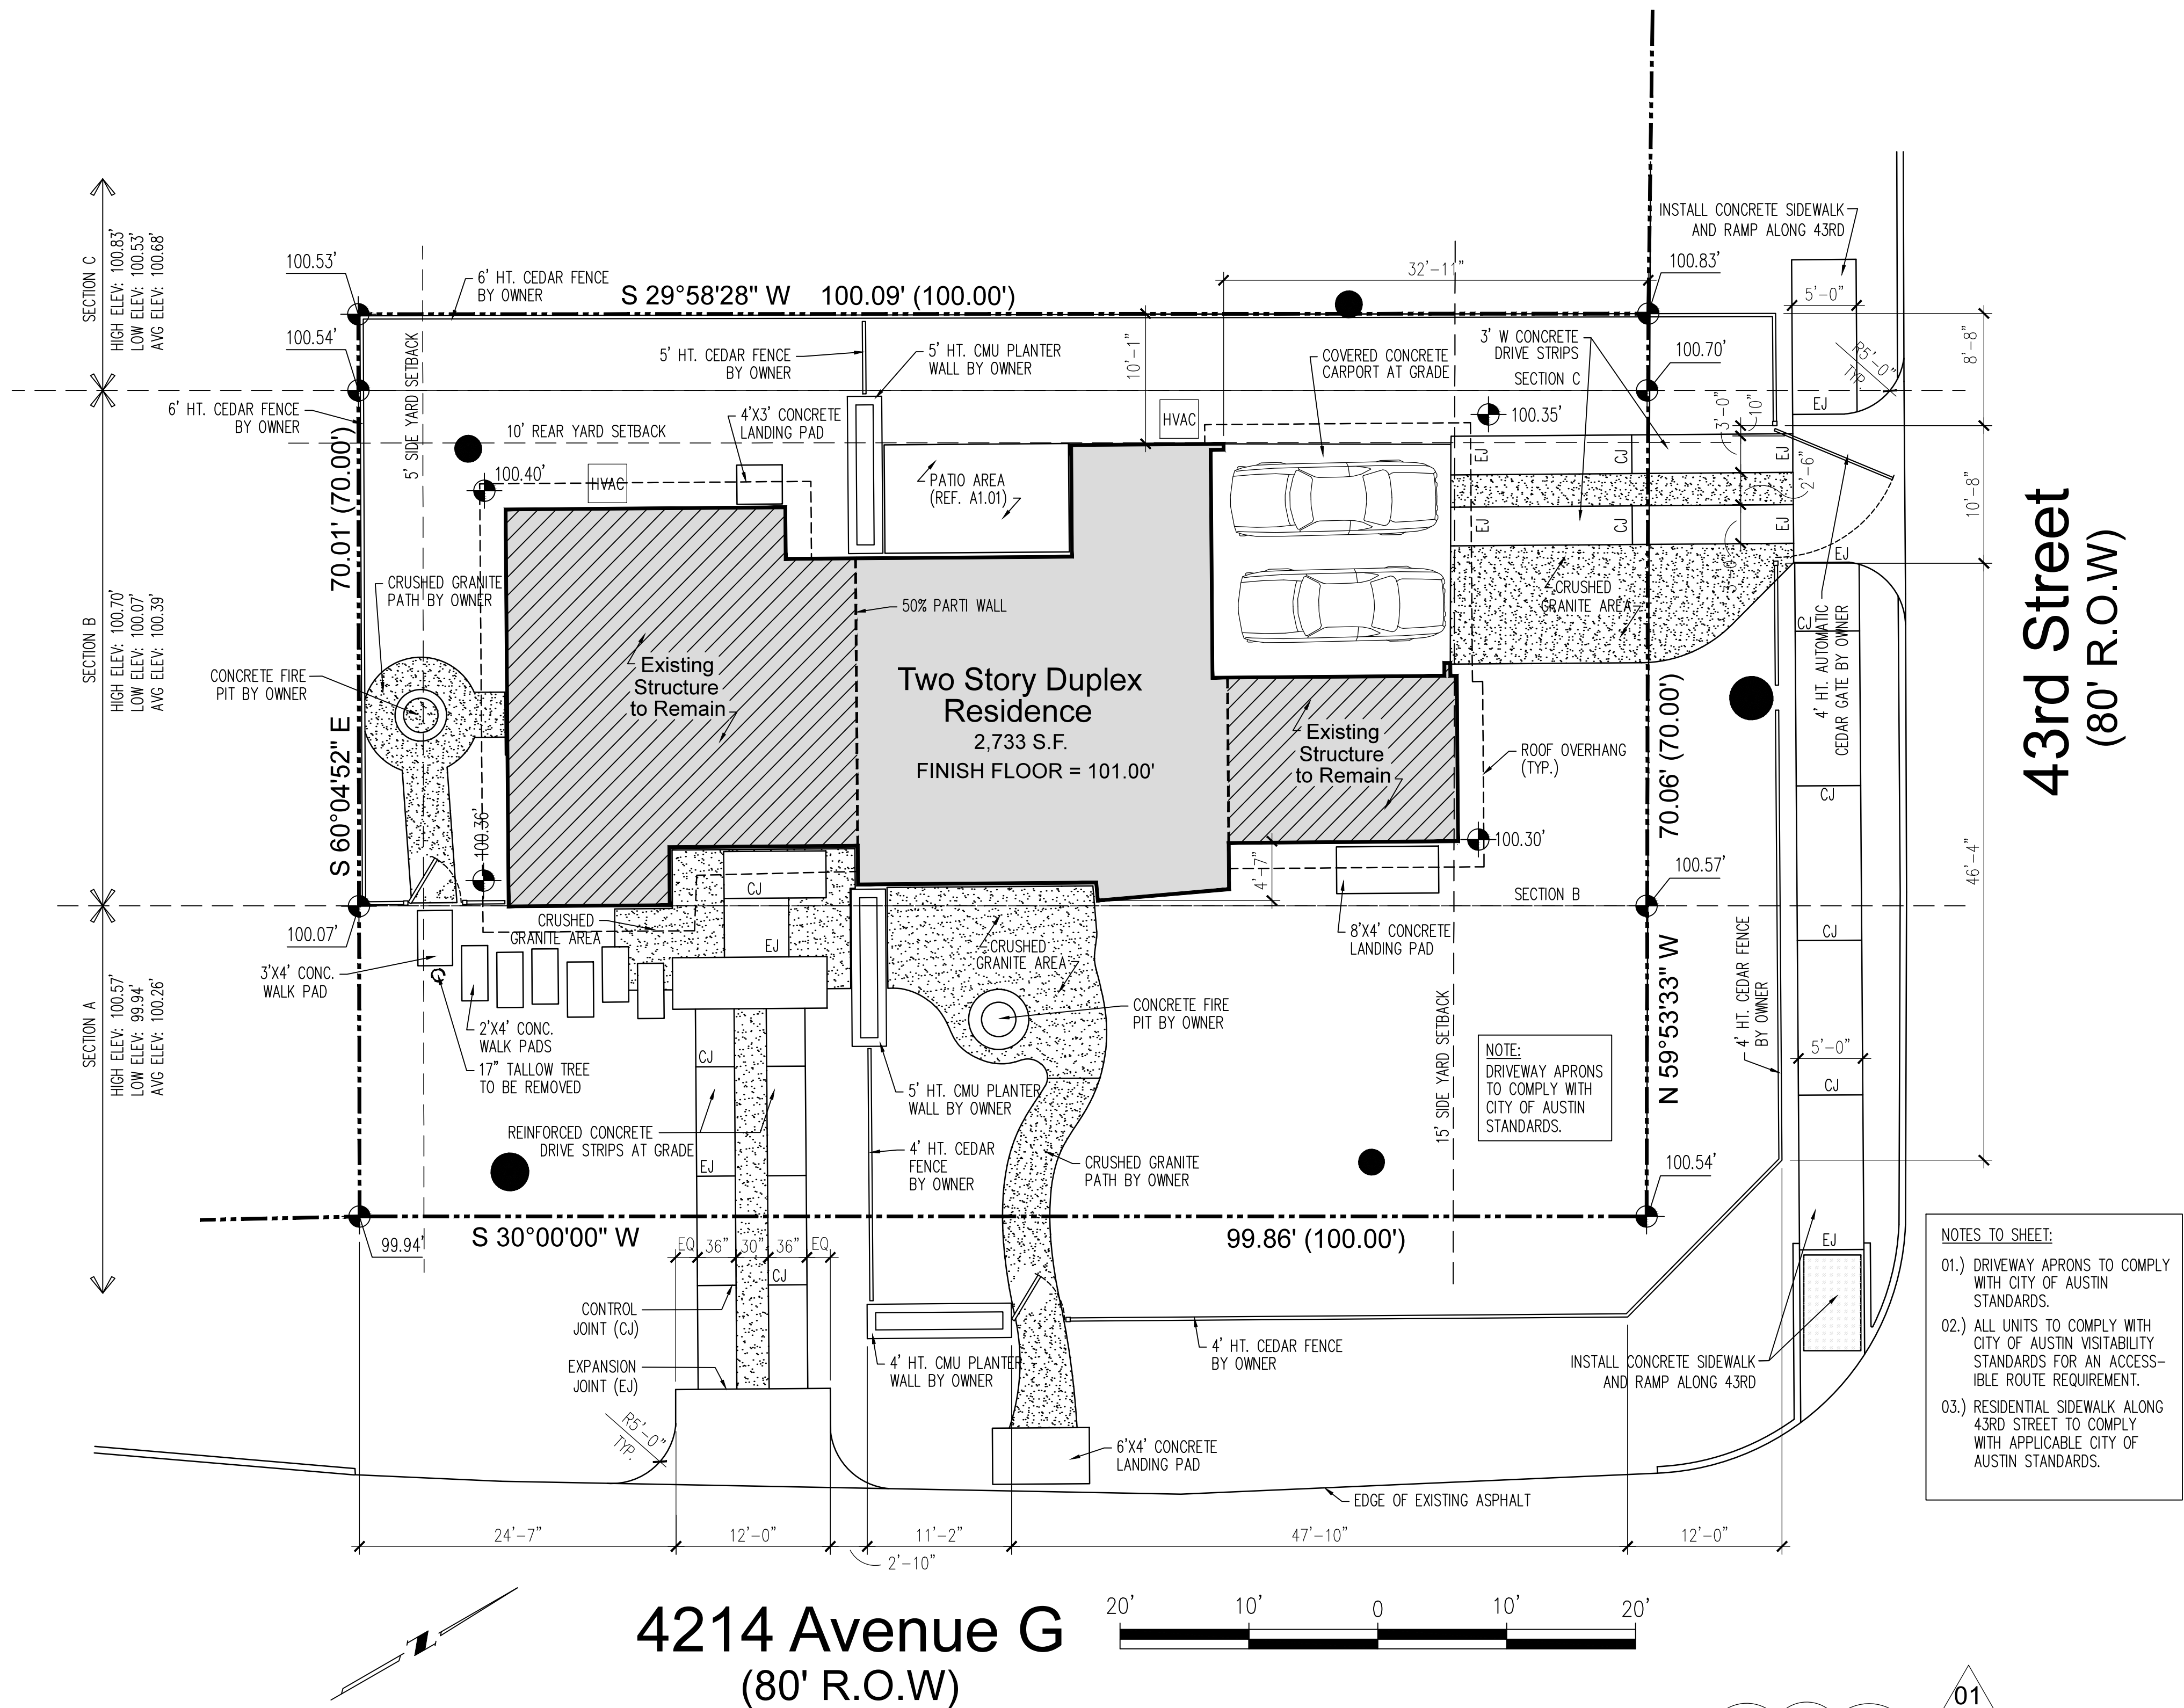01

SITE PLAN

SCALE 1/16" = 1'-0"

CONSULTANTS	
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Sebastien Weyland and Dana Wassarman	
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01	09 March, 2015
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SHEET TITLE(S)	
NEW CONSTRUCTION SITE PLAN Subchapter F Compliance	
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A0.03


DEMOLITION WALL LEGEND

- INDICATES WALLS TO REMAIN
- INDICATES WALLS TO REMAIN

EXTERIOR WALL COMPLIANCE

- TOTAL LENGTH OF EXTERIOR WALLS:
316.7 FEET
- TOTAL LENGTH OF WALLS TO REMAIN:
205.6 FEET
- PERCENTAGE OF EXTERIOR WALLS TO BE DEMOLISHED:
35.08 %


01

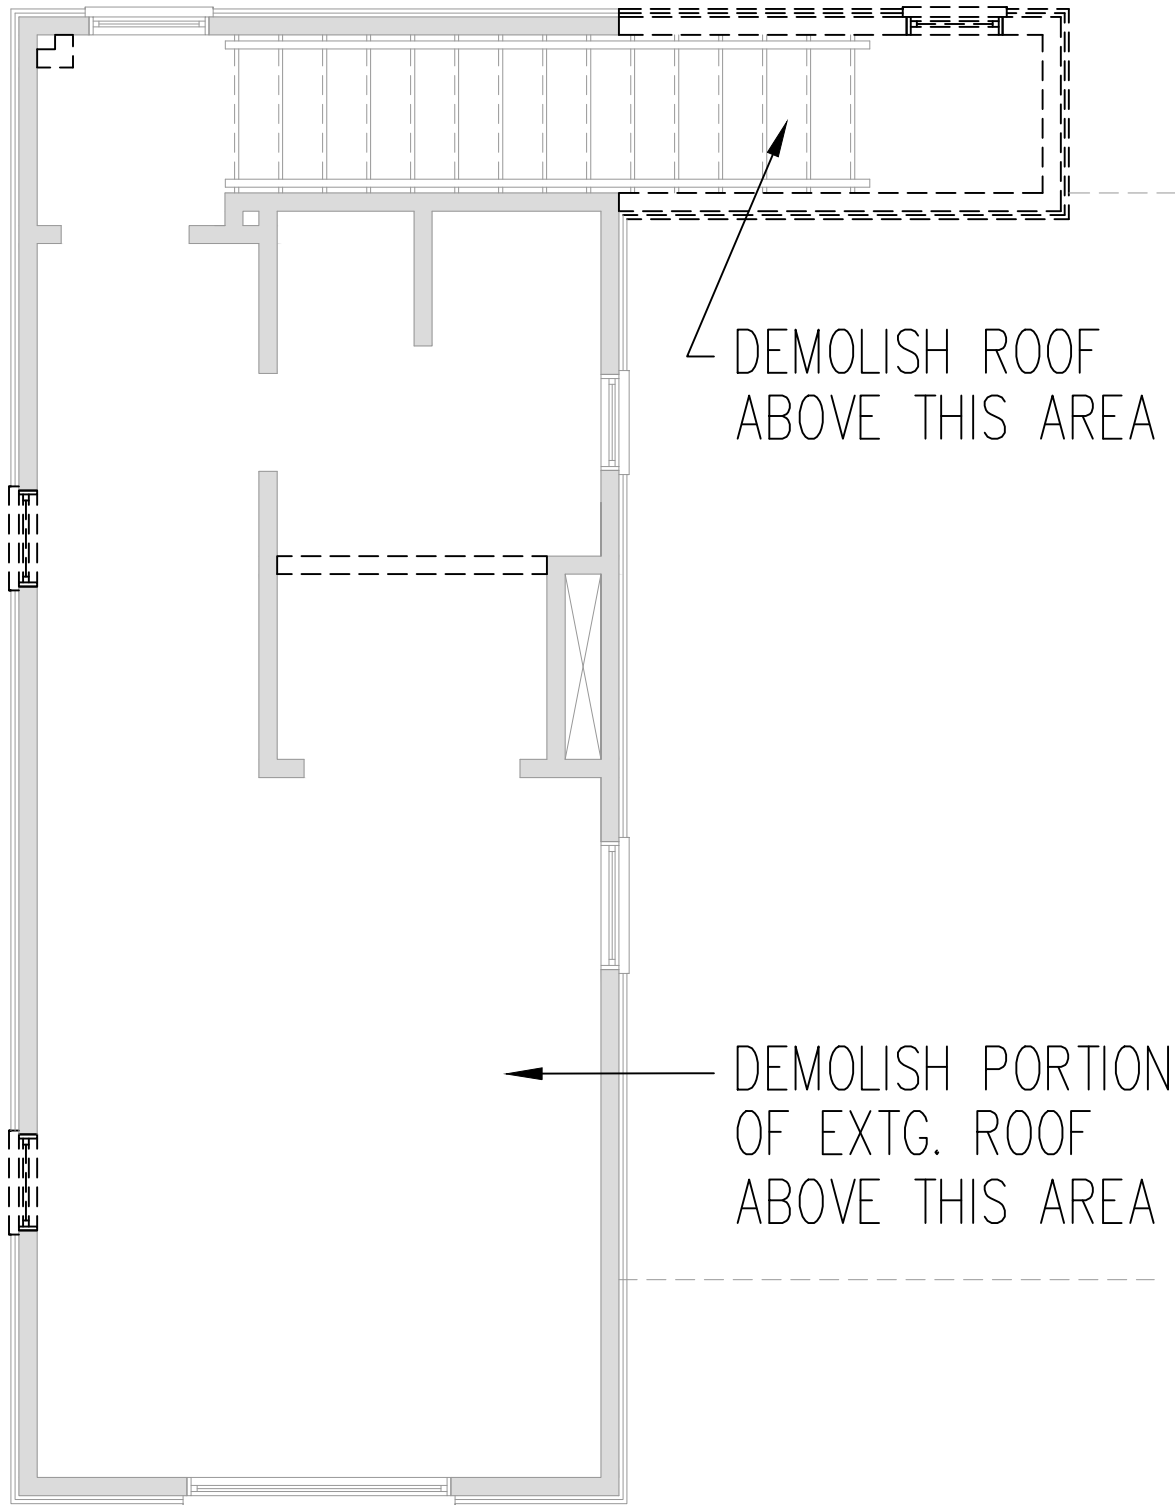

01

SECOND FLOOR DEMOLITION

SCALE 1/8" = 1'-0"

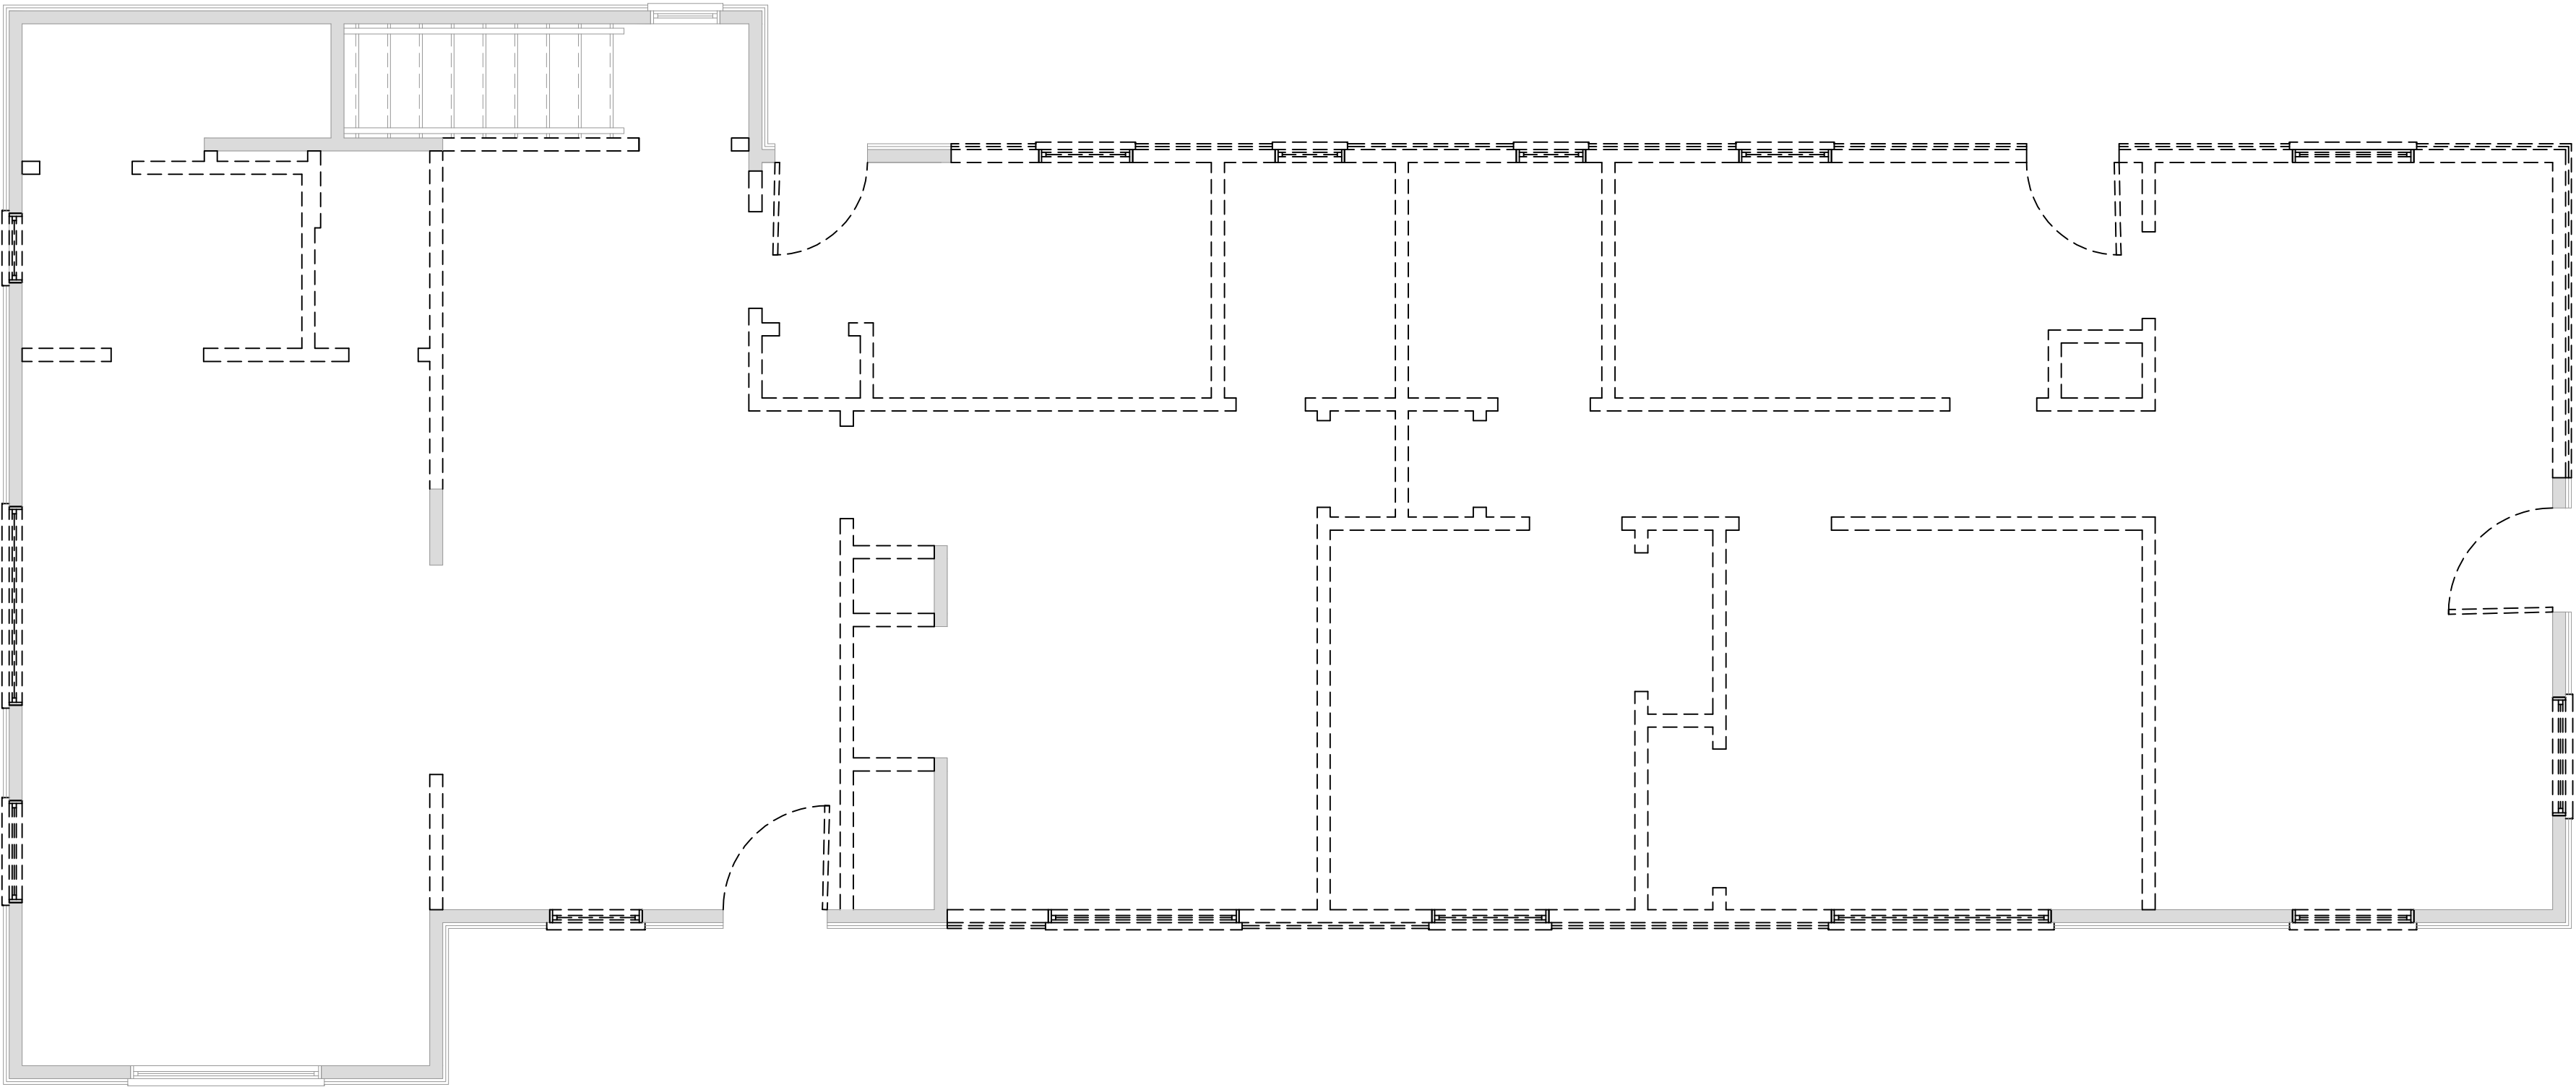

01

FIRST FLOOR DEMOLITION

SCALE 1/8" = 1'-0"

CONSULTANTS

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SHEET TITLE(S)
EXISTING RESIDENCE
DEMOLITION PLANS

Subchapter F Compliance

REVISION DATE:

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<u>DOOR SCHEDULE</u>				
TAG	SIZE	TYPE	NOTE	QUANTITY
01	3'-0" X 7'-0"	EXT - SCWD	STOREFRONT	1
02	3'-0" X 7'-0"	EXT - GLASS	STOREFRONT	1
03	6'-0" X 7'-0"	EXT - GLASS	PATIO SLIDER	3
04	2'-8" X 7'-0"	EXT - SCWD	FULL LITE GLASS	3
05	5'-0" X 7'-0"	EXT - SCWD	PAIR 1	1
06	2'-8" X 7'-0"	INT - SCWD	POCKET DOOR	3
07	2'-8" X 7'-0"	INT - SCWD	PRIVACY HWDR	1
08	5'-0" X 7'-0"	INT - SCWD	PAIR - POCKET	1
09	2'-8" X 7'-0"	INT - SCWD	PAIR 1	1

GENERAL PLAN NOTES

- 1.) REFERENCE ELEVATION SHEETS A2.01 TO A2.04 FOR WINDOW SCHEDULE AND HEIGHT INFORMATION.
- 2.) ALL DIMENSIONS ARE ROUGH FRAMING DIMENSIONS TO THE FACE OF STUD UNLESS NOTED OTHERWISE.
- 3.) ALL WINDOW DIMENSIONS ARE TO THE CENTER OF THE FRAME. VERIFY ROUGH OPENING DIMENSIONS WITH WINDOW UNIT DIMENSIONS.

GENERAL PLAN LEGEND

01/A3.02 BUILDING SECTION / ELEVATION

⊕	HOSE BIB
⊕	NATURAL GAS


 NEW CONSTRUCTION EXTERIOR WALL

NEW CONSTRUCTION INTERIOR WALL

 EXISTING WALL TO REMAIN

VISITABILITY COMPLIANCE NOTES

- 1.) VISIBILITY COMPLIANT ENTRANCE TO HAVE MAXIMUM 1/2" BEVELED THRESHOLD.
- 2.) ALL LIGHT SWITCHES AND ENVIRONMENTAL CONTROLS TO BE MOUNTED MAX. 48" A.F.F.
- 3.) WALL MOUNT ELECTRICAL RECEPTACLES TO BE MOUNTED AT 15" A.F.F.
- 4.) COMPLIANT BATHROOM, LIVING ROOM, DINING ROOM, AND KITCHEN ON VISABILITY ROUTE.
- 5.) PROVIDE 2X6 BLOCKING IN WALLS AND AS REQUIRED IN ACCORDANCE WITH CITY OF AUSTIN ORDINANCE 20140130-021

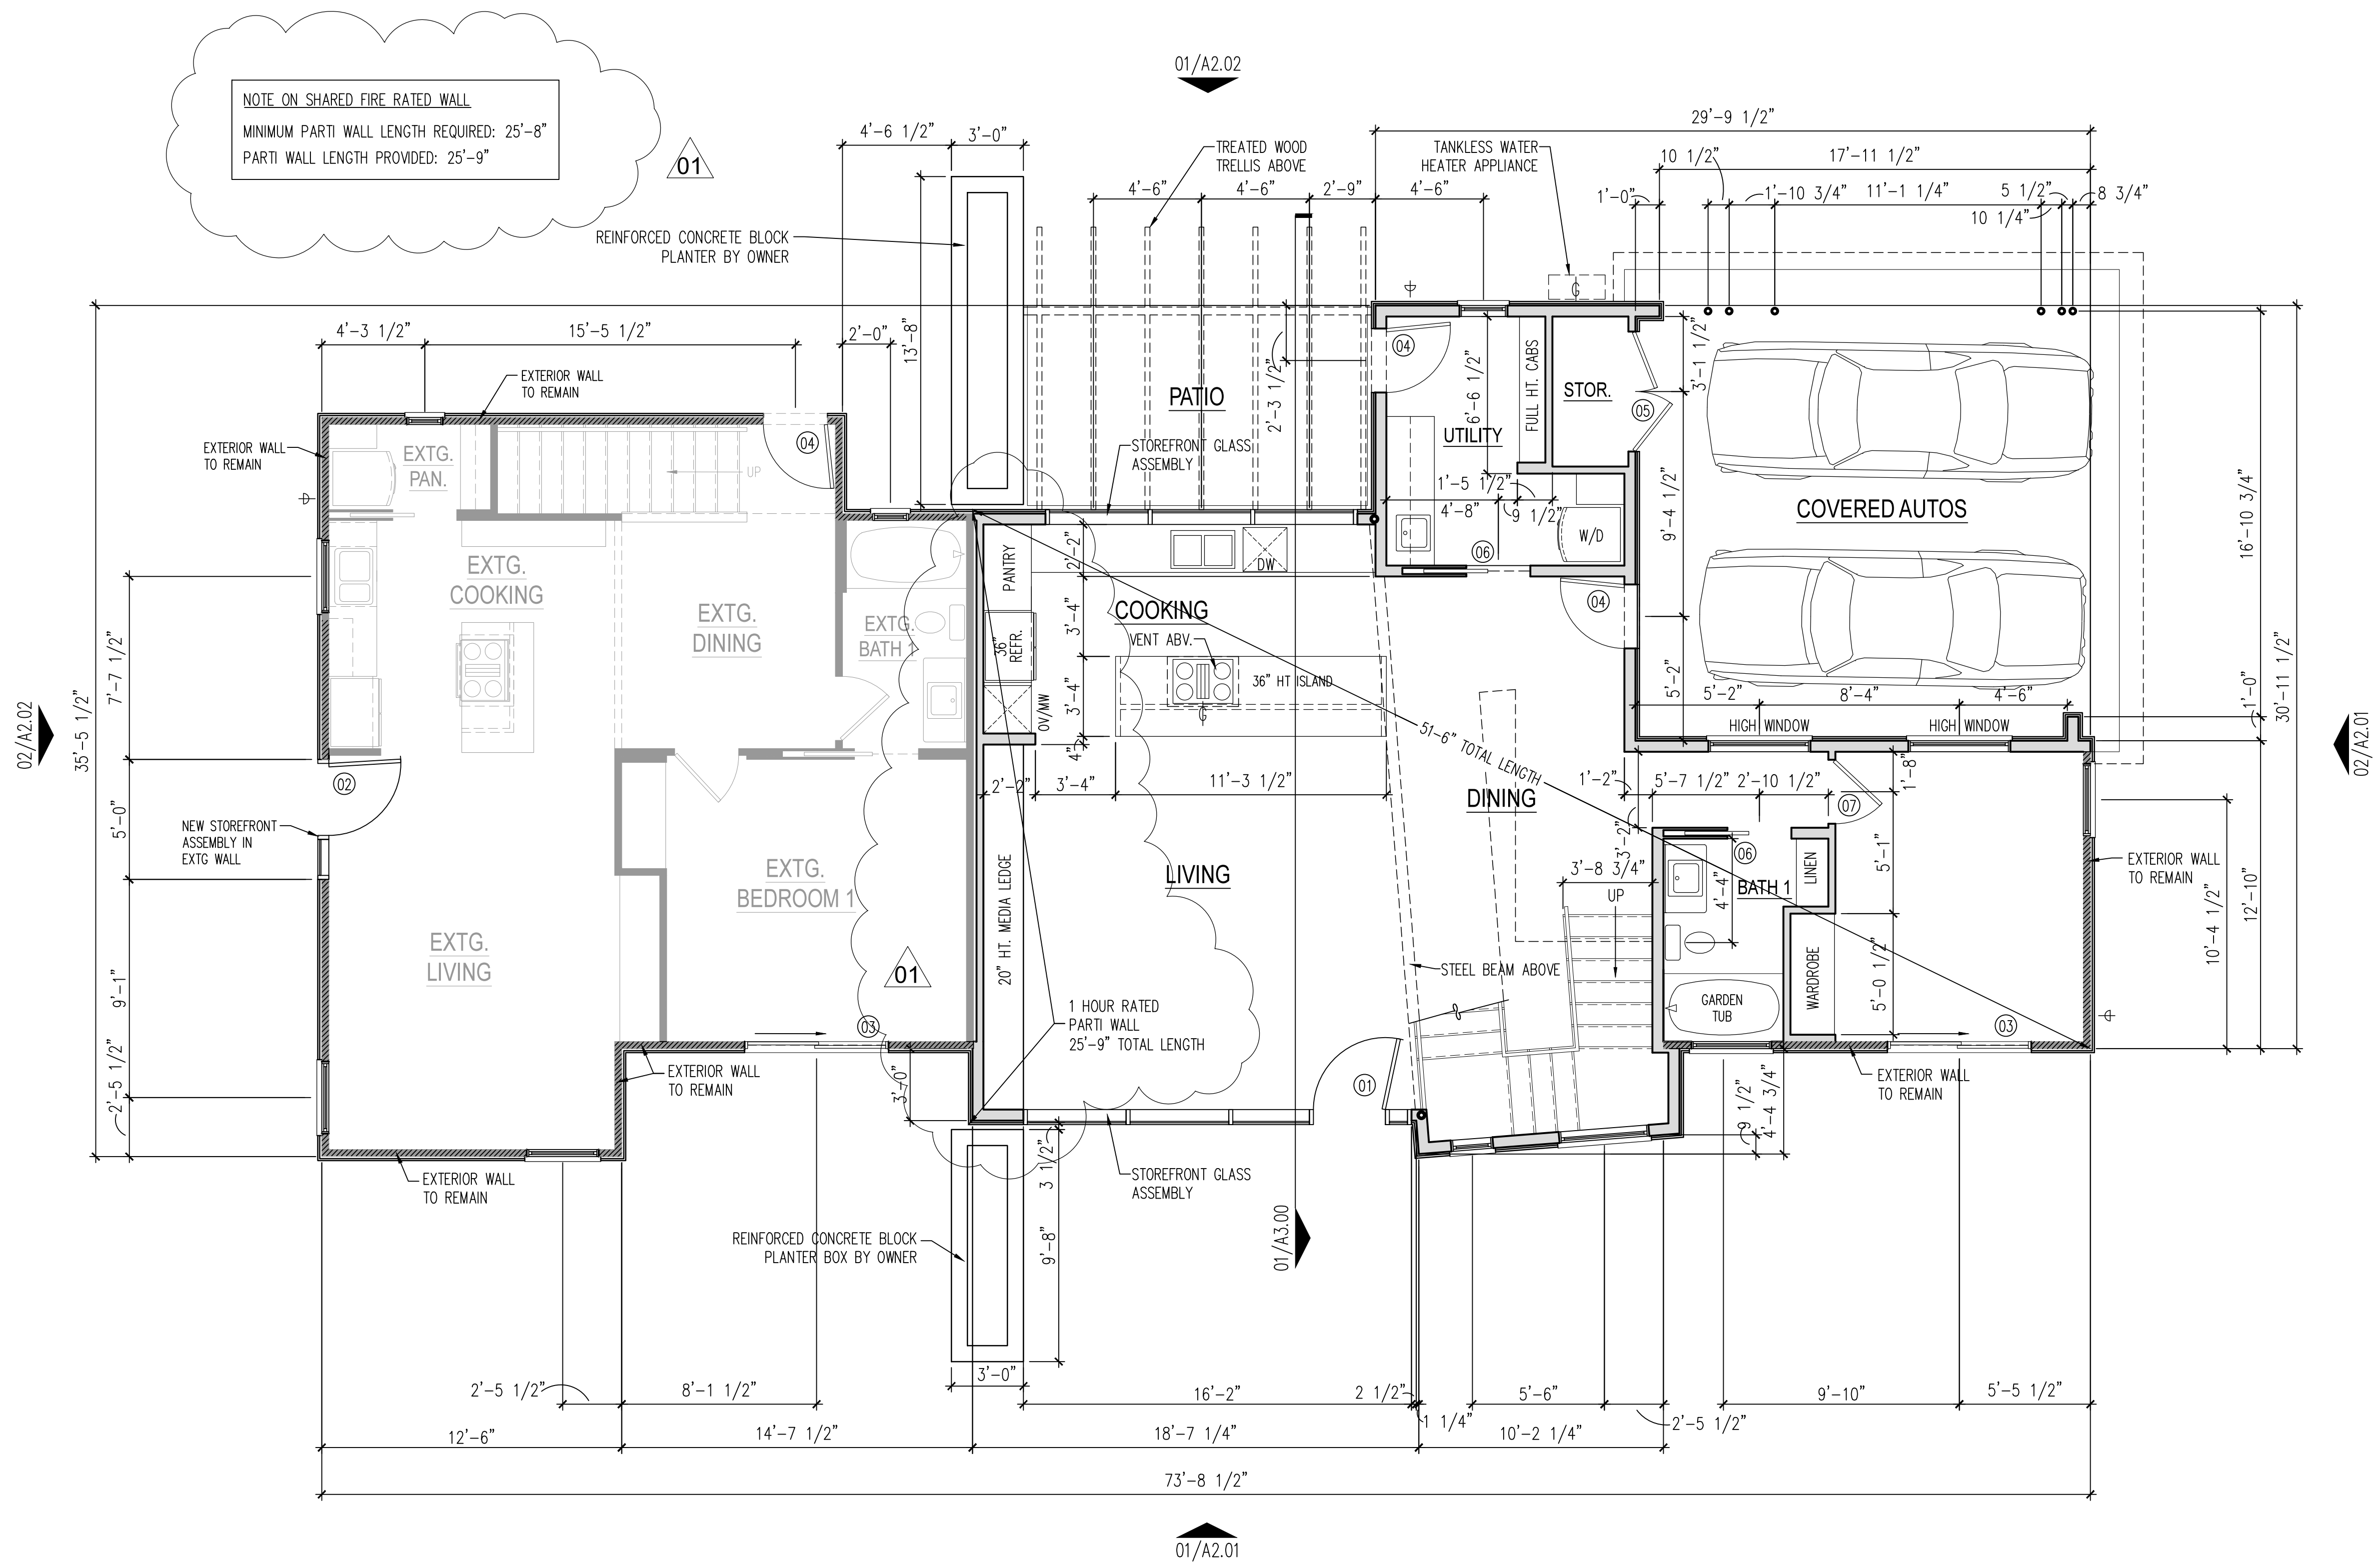

FOR REGULATORY REVIEW

01 GROUND FLOOR PLAN

SCALE 1/8" = 1'-0"

Daniel
Scott
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Design

2430 Albans Road
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CONSULTANTS

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SHEET TITLE(S)

GROUND FLOOR NEW CONSTRUCTION PLAN

REVISION DATE:

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A1.01


DOOR SCHEDULE				
TAG	SIZE	TYPE	NOTE	QUANTITY
01	3'-0" X 7'-0"	EXT - SCWD	STOREFRONT	1
02	3'-0" X 7'-0"	EXT - GLASS	STOREFRONT	1
03	6'-0" X 7'-0"	EXT - GLASS	PATIO SLIDER	3
04	2'-8" X 7'-0"	EXT - SCWD	FULL LITE GLASS	3
05	5'-0" X 7'-0"	EXT - SCWD	PAIR	1
06	2'-8" X 7'-0"	INT - SCWD	POCKET DOOR	3
07	2'-8" X 7'-0"	INT - SCWD	PRIVACY HDWR	1
08	5'-0" X 7'-0"	INT - SCWD	PAIR - POCKET	1
09	2'-8" X 7'-0"	INT - SCWD	PAIR	1

GENERAL PLAN NOTES

- 1.) REFERENCE ELEVATION SHEETS A2.01 TO A2.04 FOR WINDOW SCHEDULE AND HEIGHT INFORMATION.
- 2.) ALL DIMENSIONS ARE ROUGH FRAMING DIMENSIONS TO THE FACE OF STUD UNLESS NOTED OTHERWISE.
- 3.) ALL WINDOW DIMENSIONS ARE TO THE CENTER OF THE FRAME. VERIFY ROUGH OPENING DIMENSIONS WITH WINDOW UNIT DIMENSIONS.

GENERAL PLAN LEGEND

- 01/A3.02 — BUILDING SECTION / ELEVATION
- ⌀ HOSE BIB
- Ⓔ NATURAL GAS
- ===== NEW CONSTRUCTION EXTERIOR WALL
- ===== NEW CONSTRUCTION INTERIOR WALL
- ===== EXISTING WALL TO REMAIN

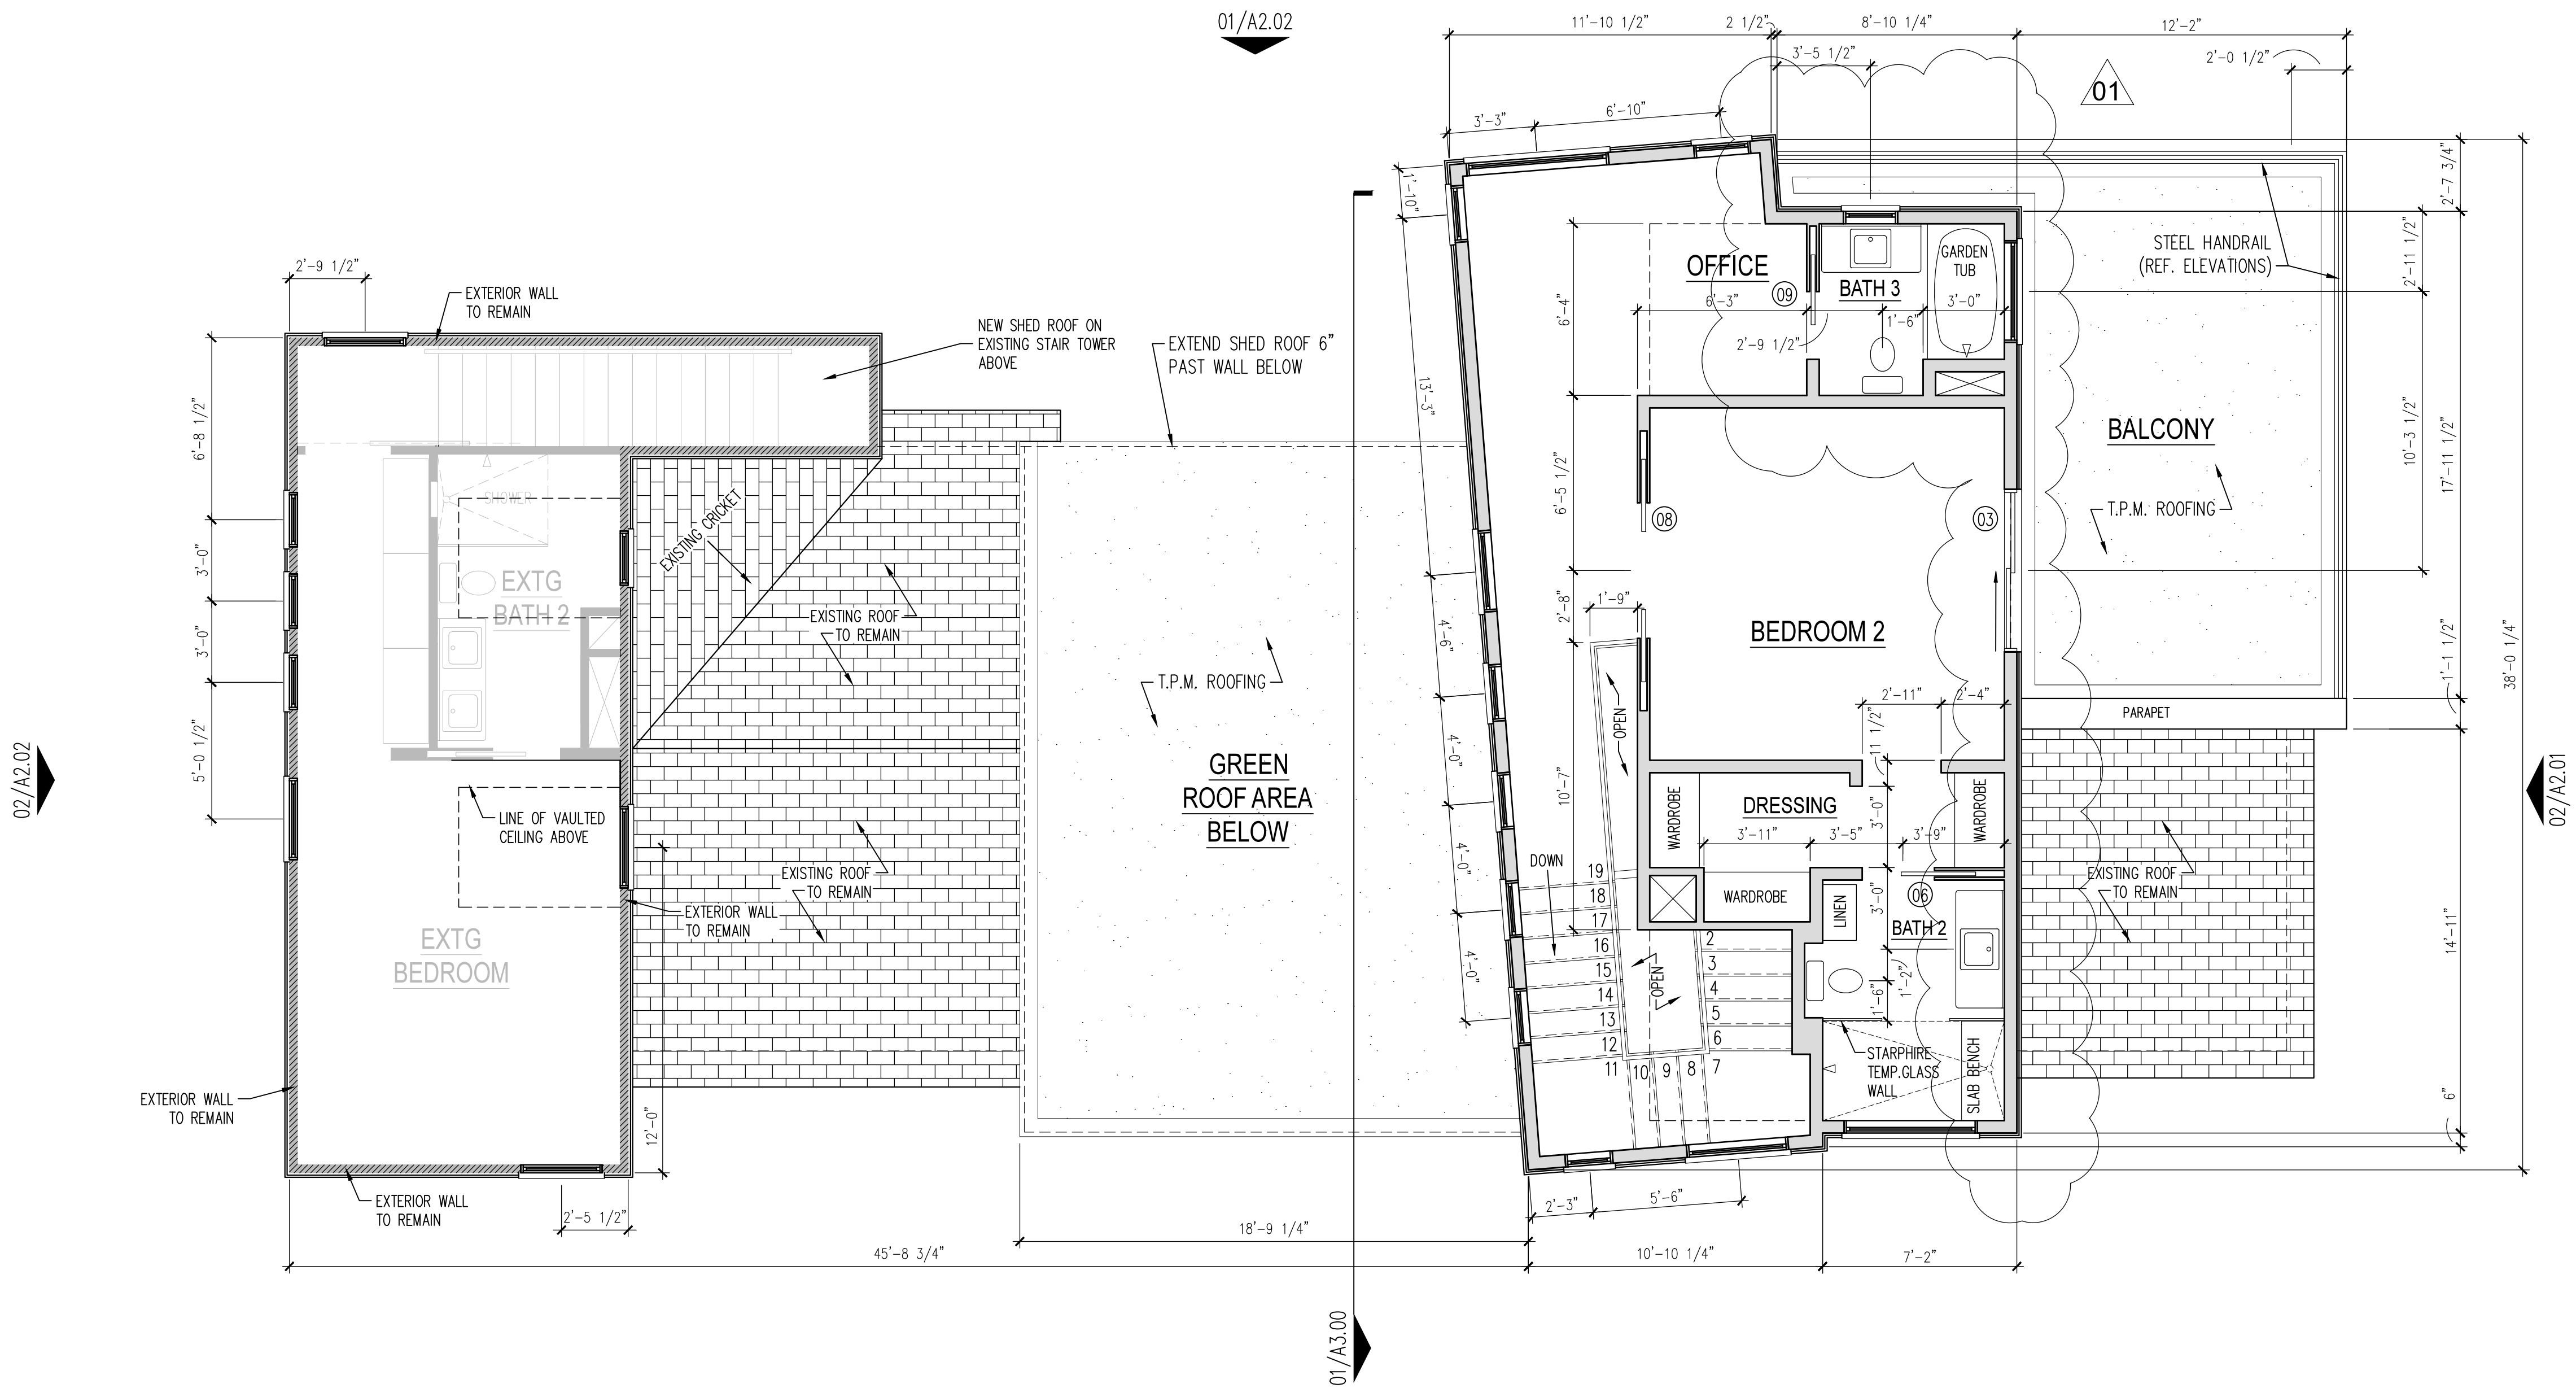

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SHEET TITLE(S)

**SECOND FLOOR
NEW CONSTRUCTION
PLAN**

REVISION DATE:

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PROJECT NUMBER: 14003

01

SECOND FLOOR PLAN

SCALE 1/8" = 1'-0"

FOR REGULATORY REVIEW

A1.02

CONSULTANTS

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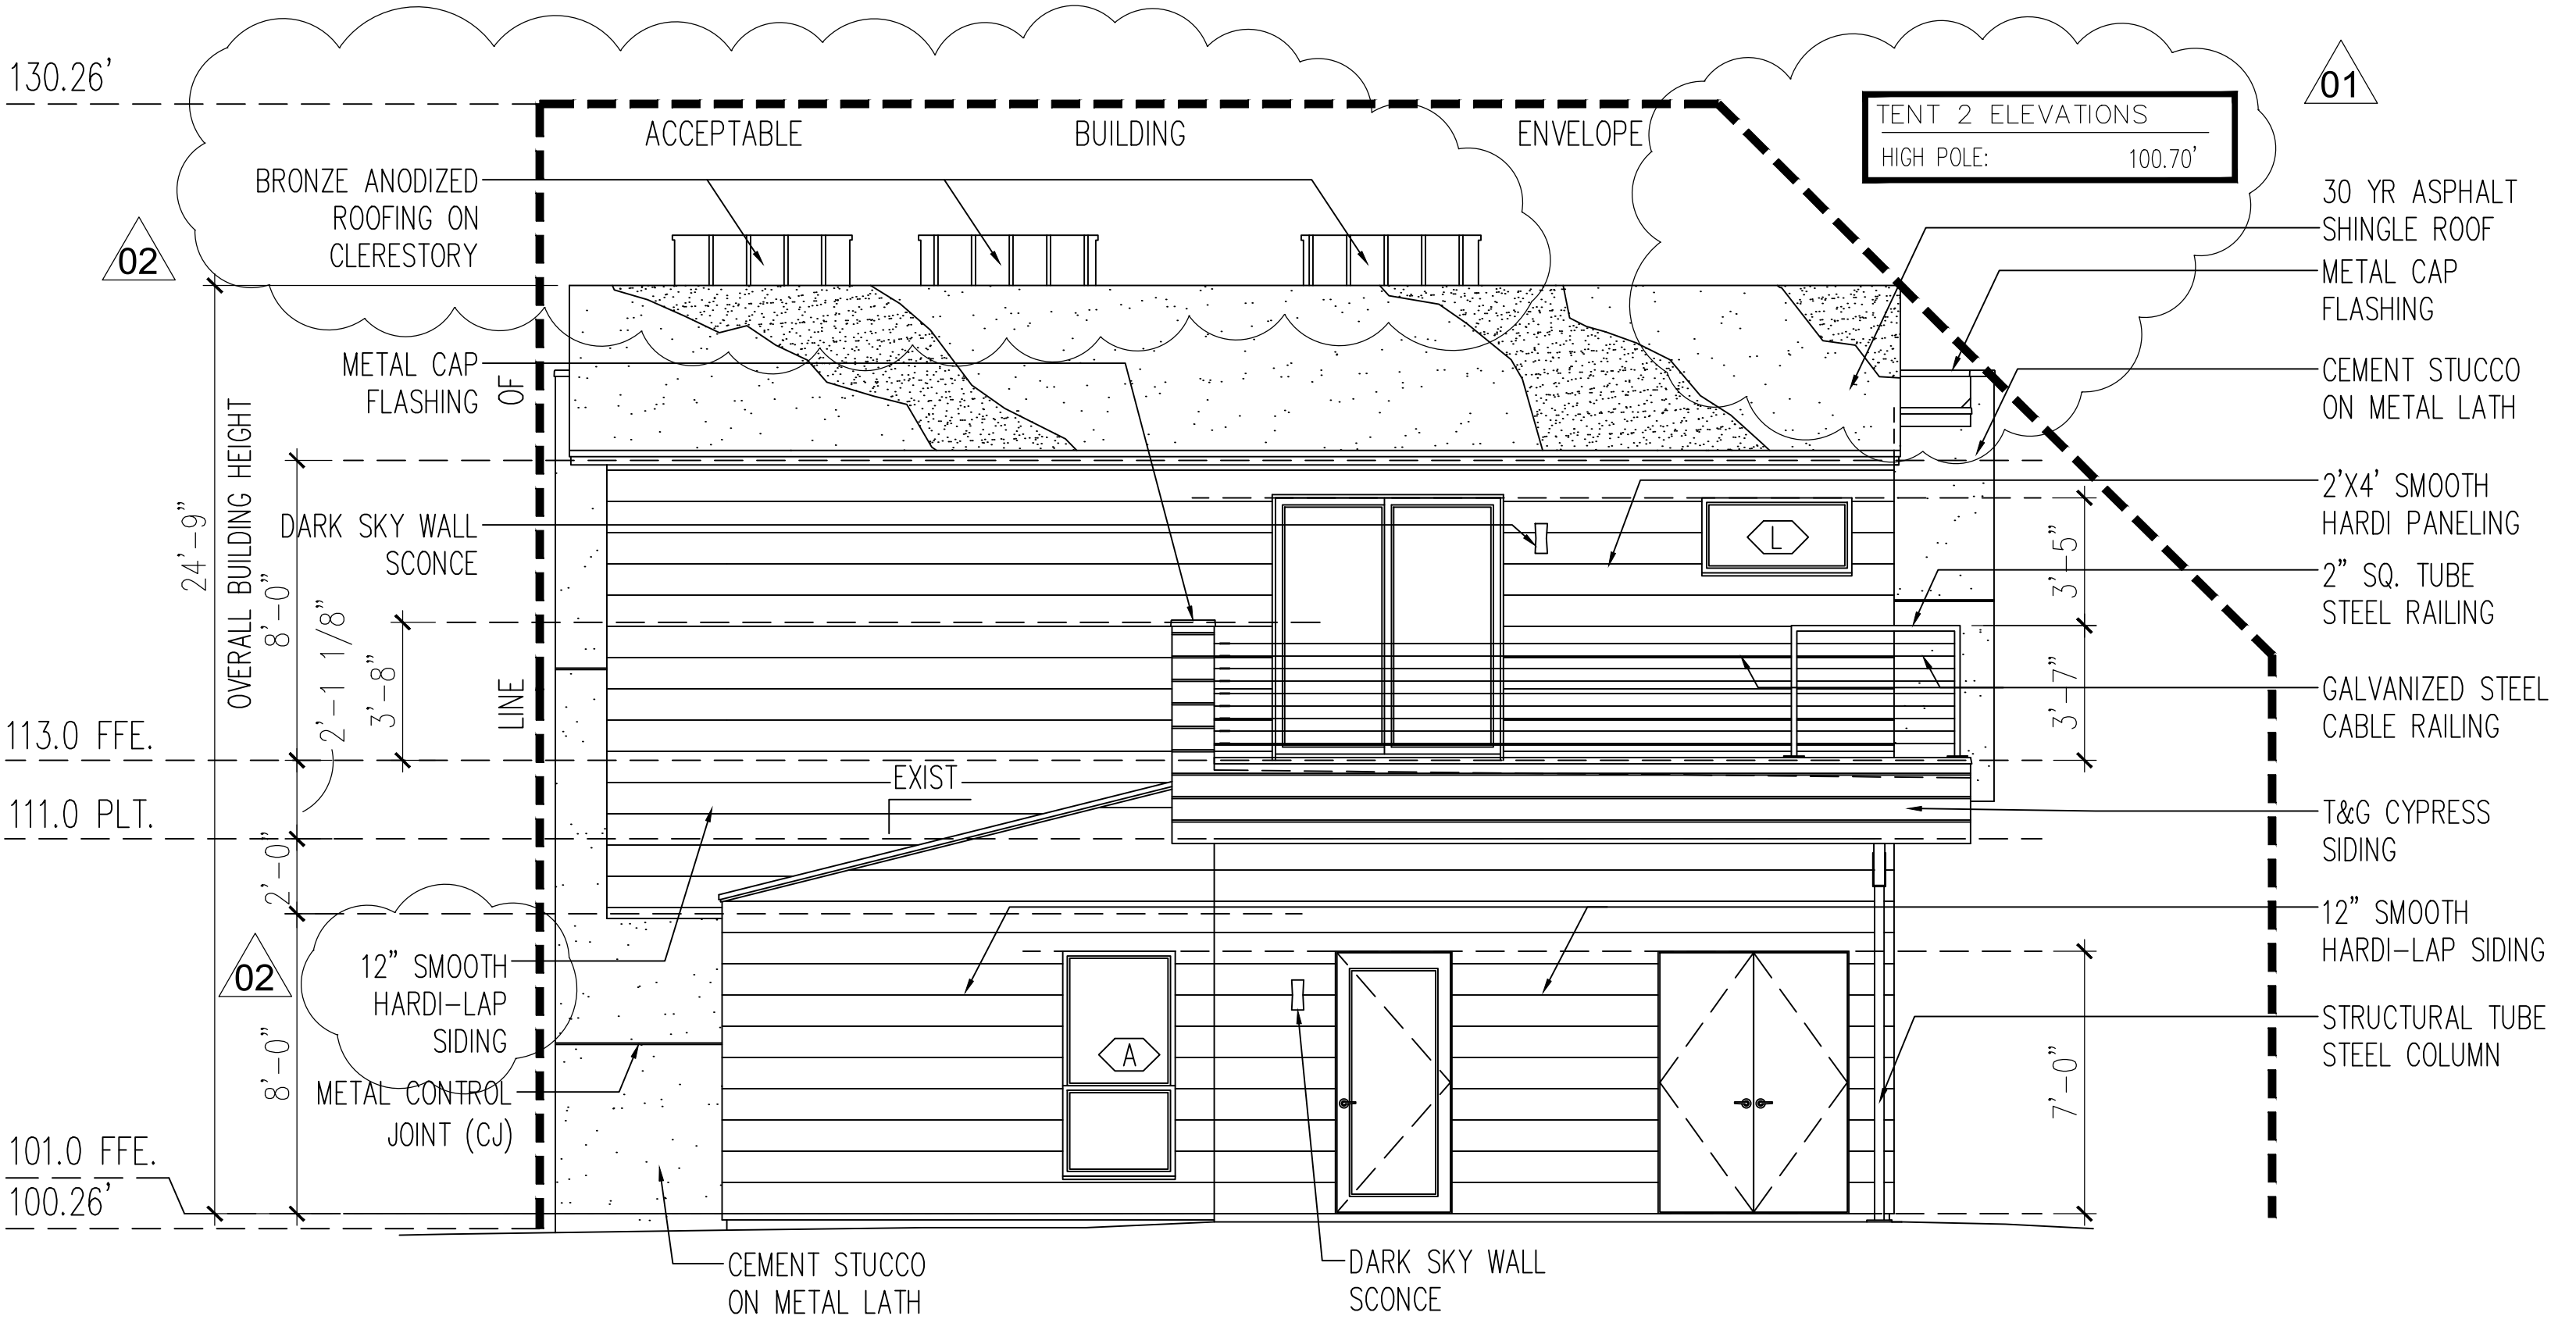
SHEET TITLE(S)
EXTERIOR ELEVATIONS

REVISION DATE:


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WINDOW SCHEDULE					
TAG	SIZE	OPERATION	WALL TYPE	QUANTITY	SAFETY GL.
<A>	6'-0" X 3'-0"	DBL HUNG	2X4	6	T
	NOT USED				
<C>	2'-8" X 7'-0"	PICTURE	2X6	2	T
<D>	3'-4" X 5'-0"	PICTURE	2X6	1	T
<E>	4'-0" X 2'-0"	PICTURE	2X4	1	T
<F>	3'-6" X 3'-6"	PICTURE	2X6	1	
<G>	2'-0" X 4'-6"	CSMNT	2X6	1	T
<H>	2'-8" X 4'-6"	CSMNT	2X6	1	T
<J>	4'-6" X 2'-6"	PICTURE	2X6	4	
<K>	2'-6" X 2'-6"	REM. OPER.	2X4	5	T
<L>	4'-0" X 2'-0"	PICTURE	2X6	2	
<M>	4'-0" X 2'-0"	CSMNT	2X6	1	T
<N>	1'-6" X 6'-0"	PICTURE	2X6	1	T
<P>	2'-0" X 2'-0"	PICTURE	2X6	1	
<Q>	2'-0" X 6'-0"	PICTURE	2X6	1	T
<R>	6'-0" X 1'-6"	PICTURE	2X6	1	
<S>	1'-8" X 1'-8"	PICTURE	2X6	1	
<T>	1'-6" X 4'-6"	PICTURE	2X4	1	T
<U>	3'-0" X 3'-6"	CSMNT	2X4	1	T
<V>	1'-6" X 6'-0"	PICTURE	2X4	1	T



02 NORTH (STREET) ELEVATION
SCALE 1/4" = 1'-0"



01 EAST (STREET) ELEVATION
SCALE 1/4" = 1'-0"

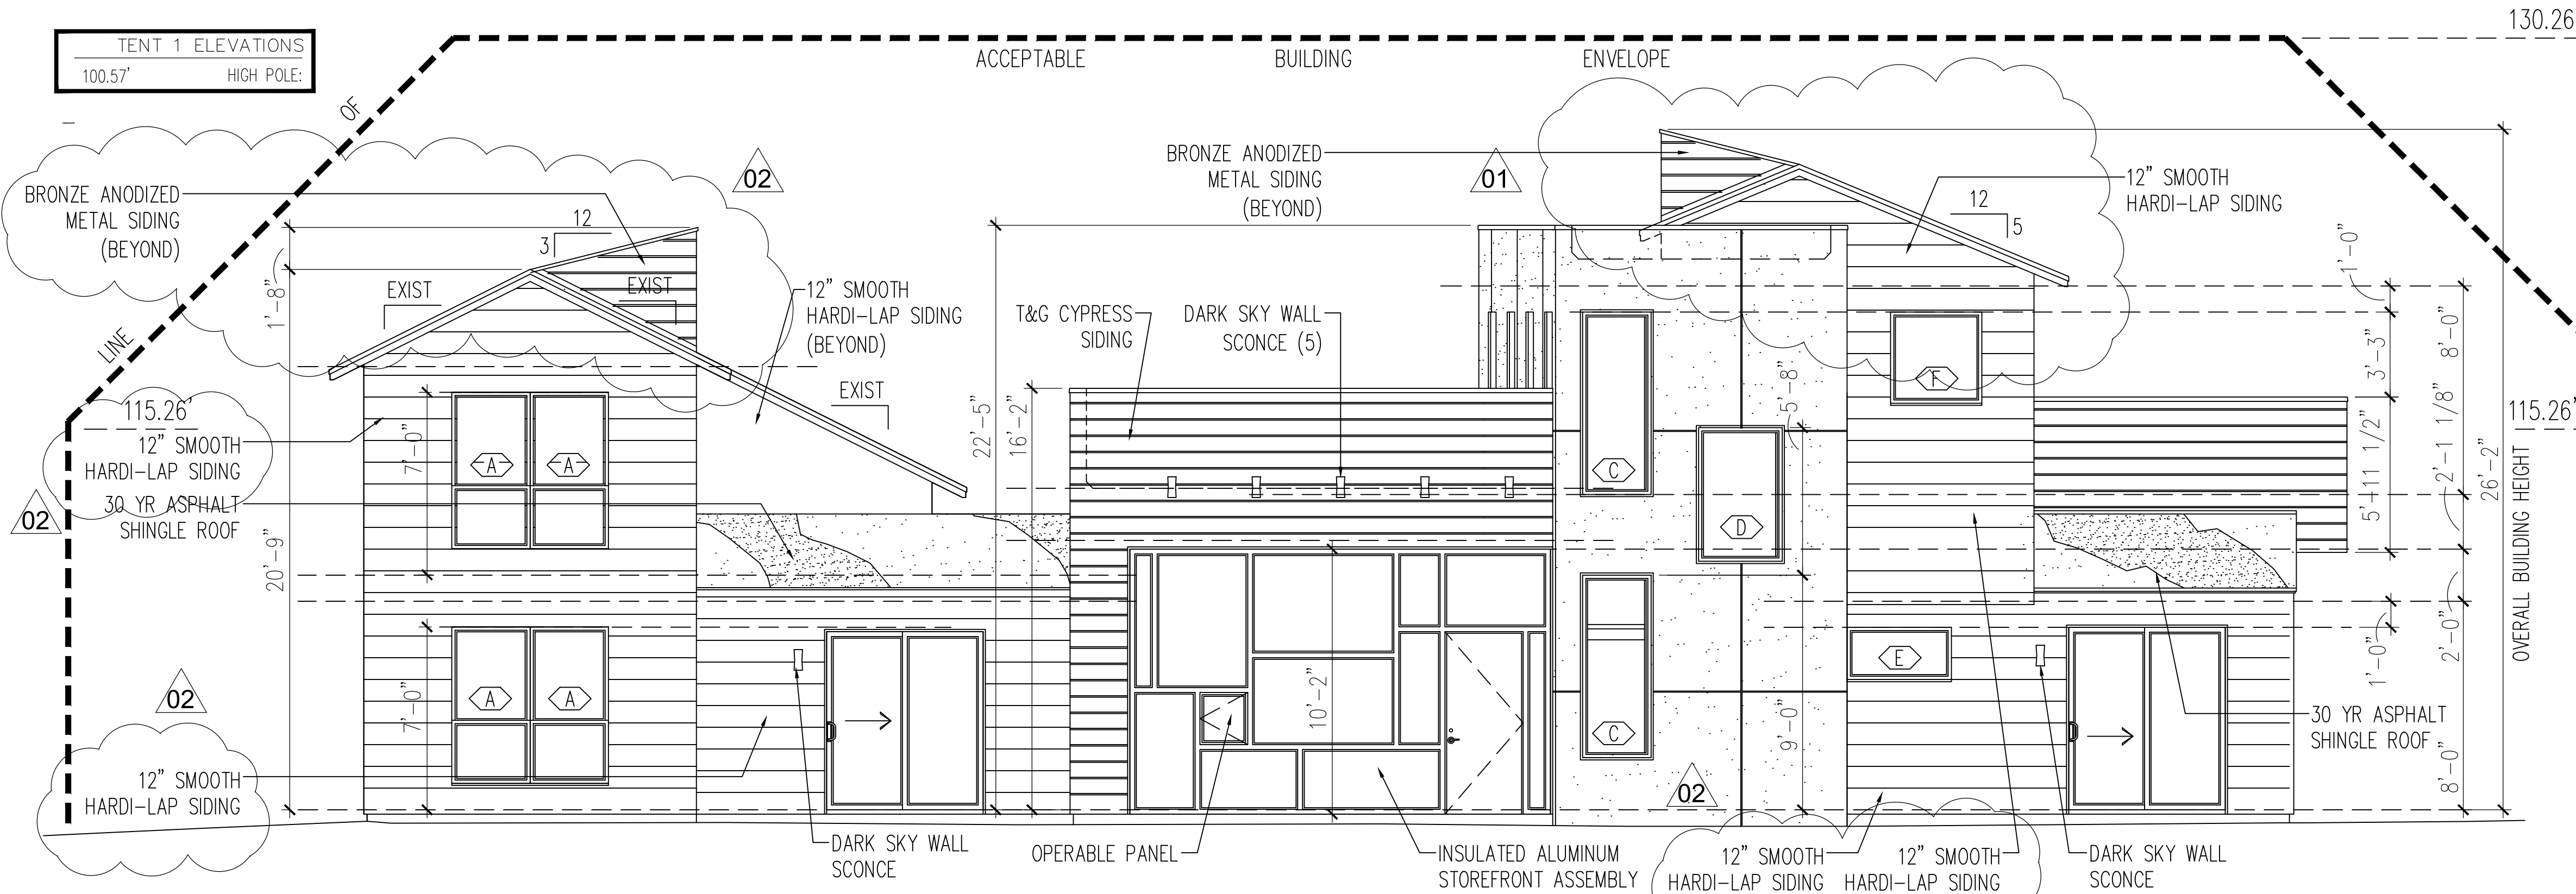CONSULTANTS

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Sebastien Weyland and
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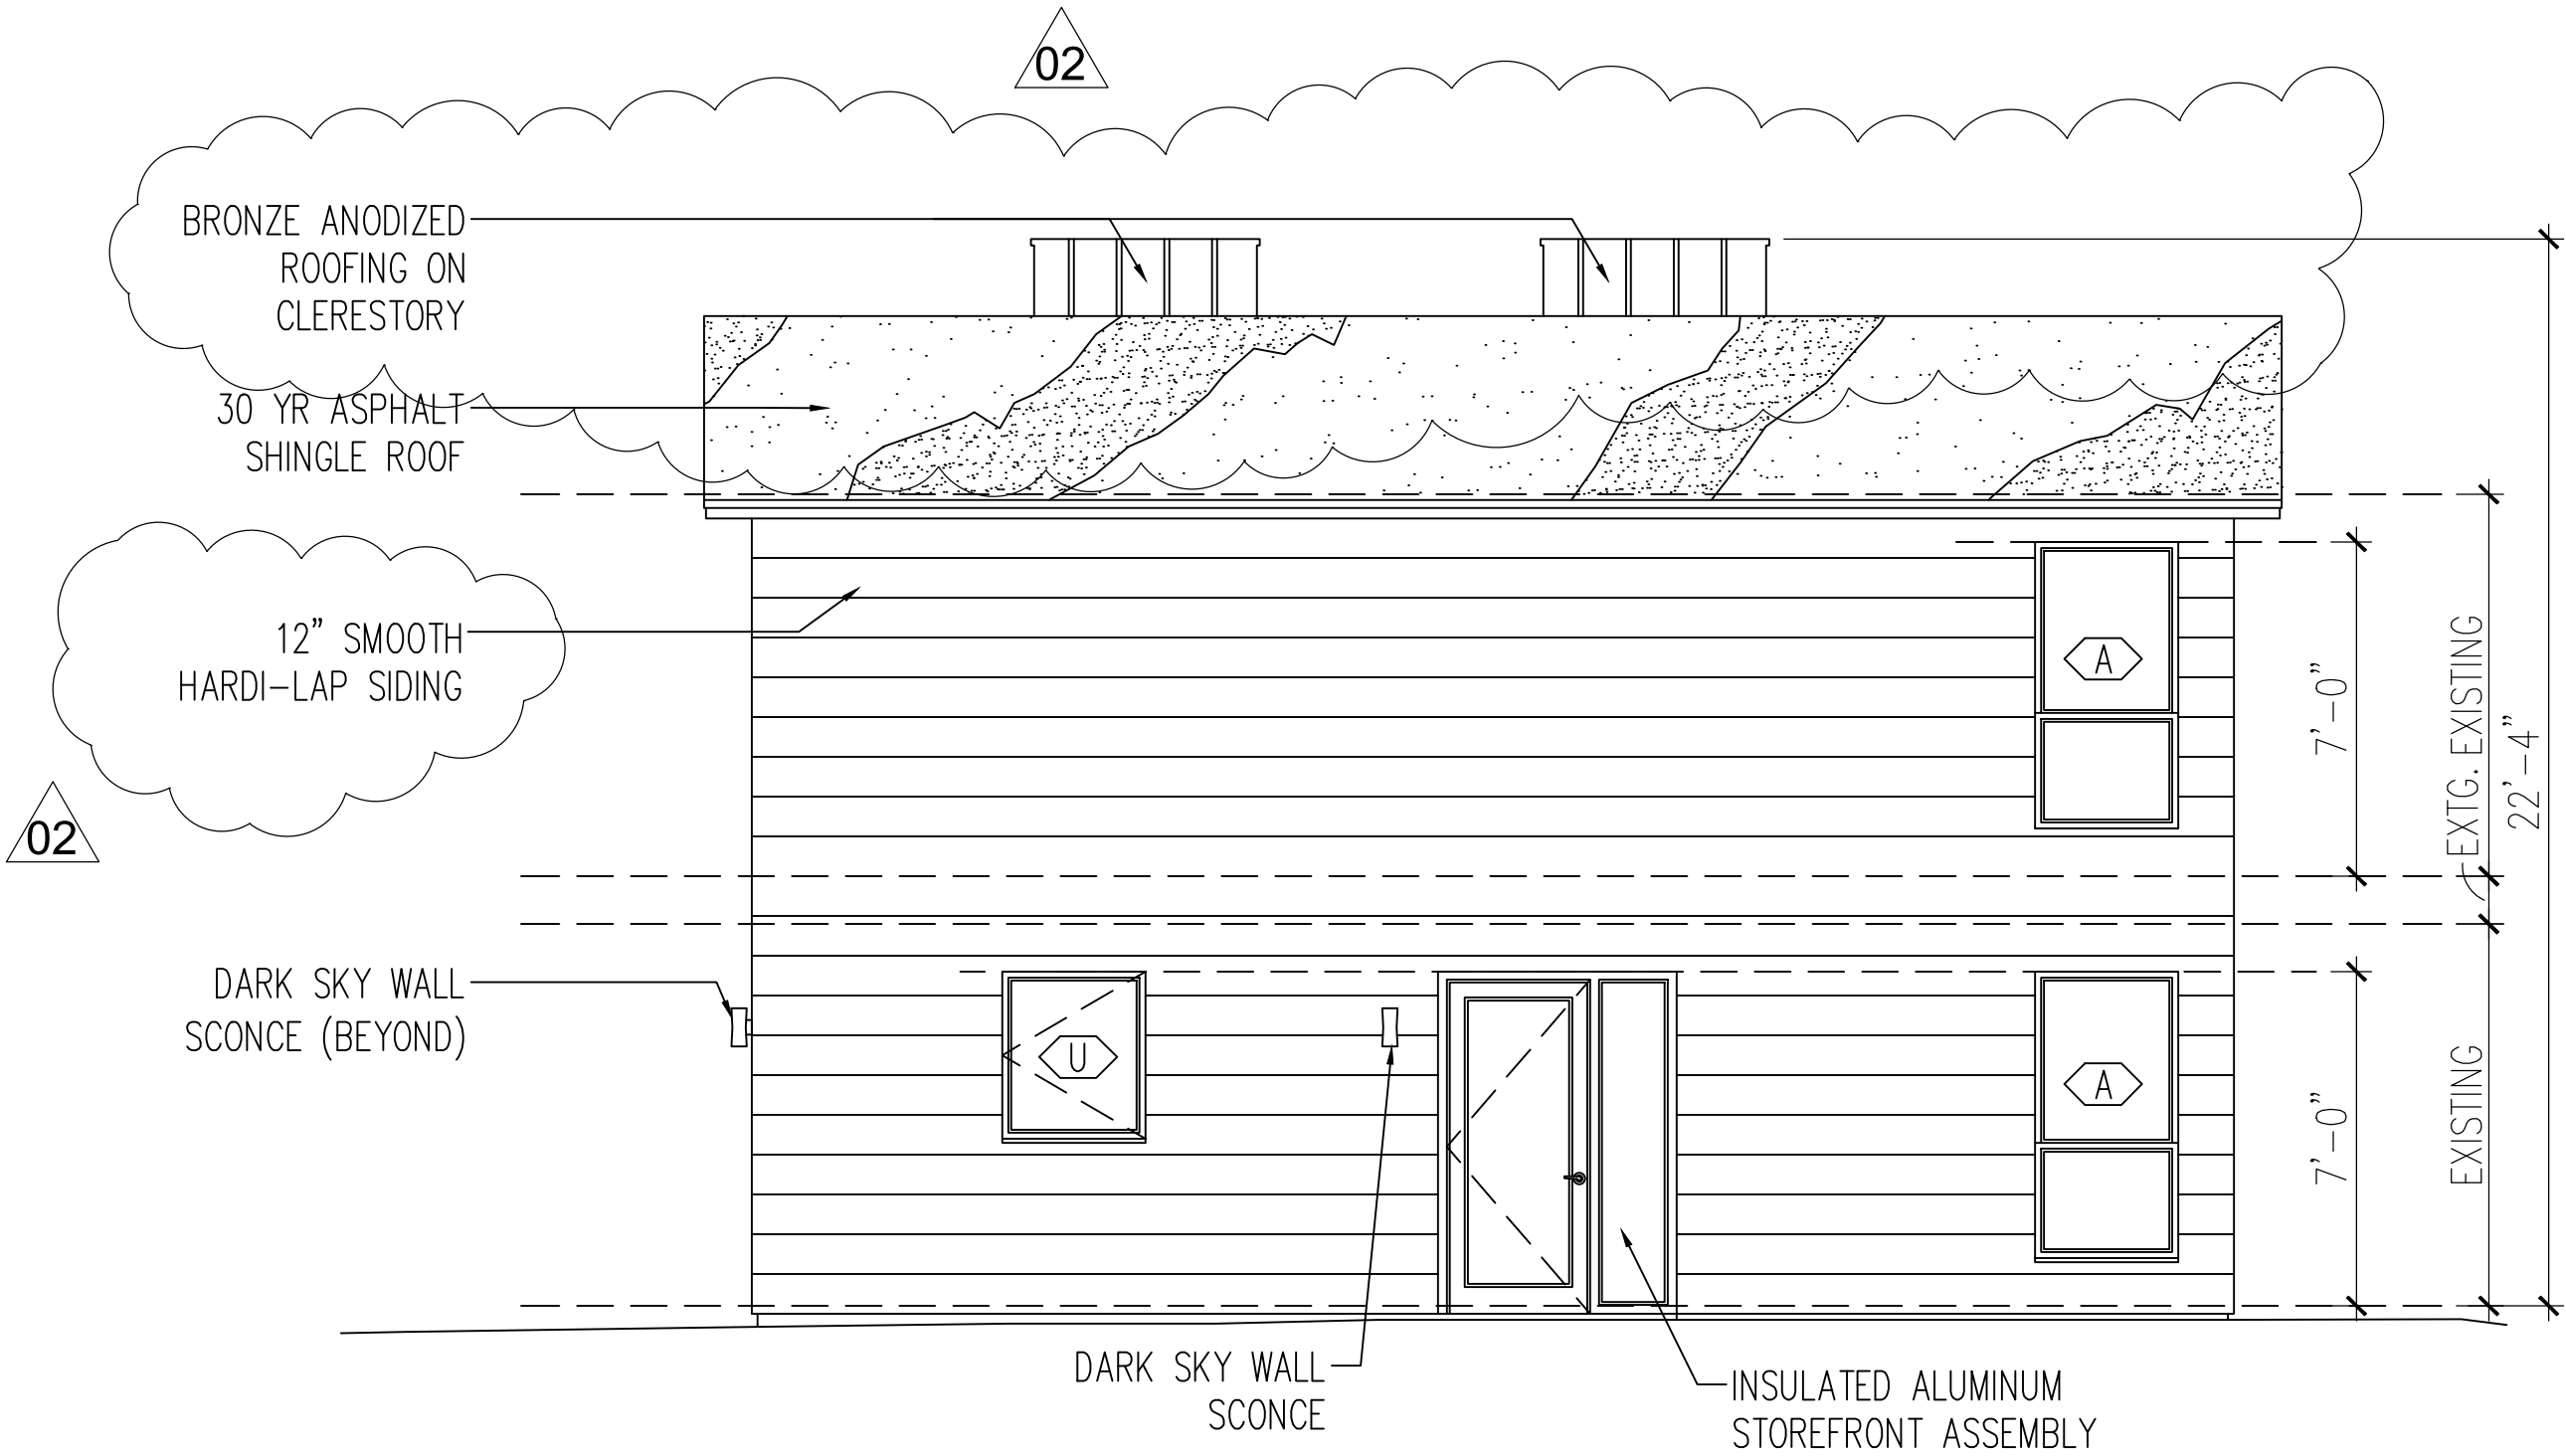
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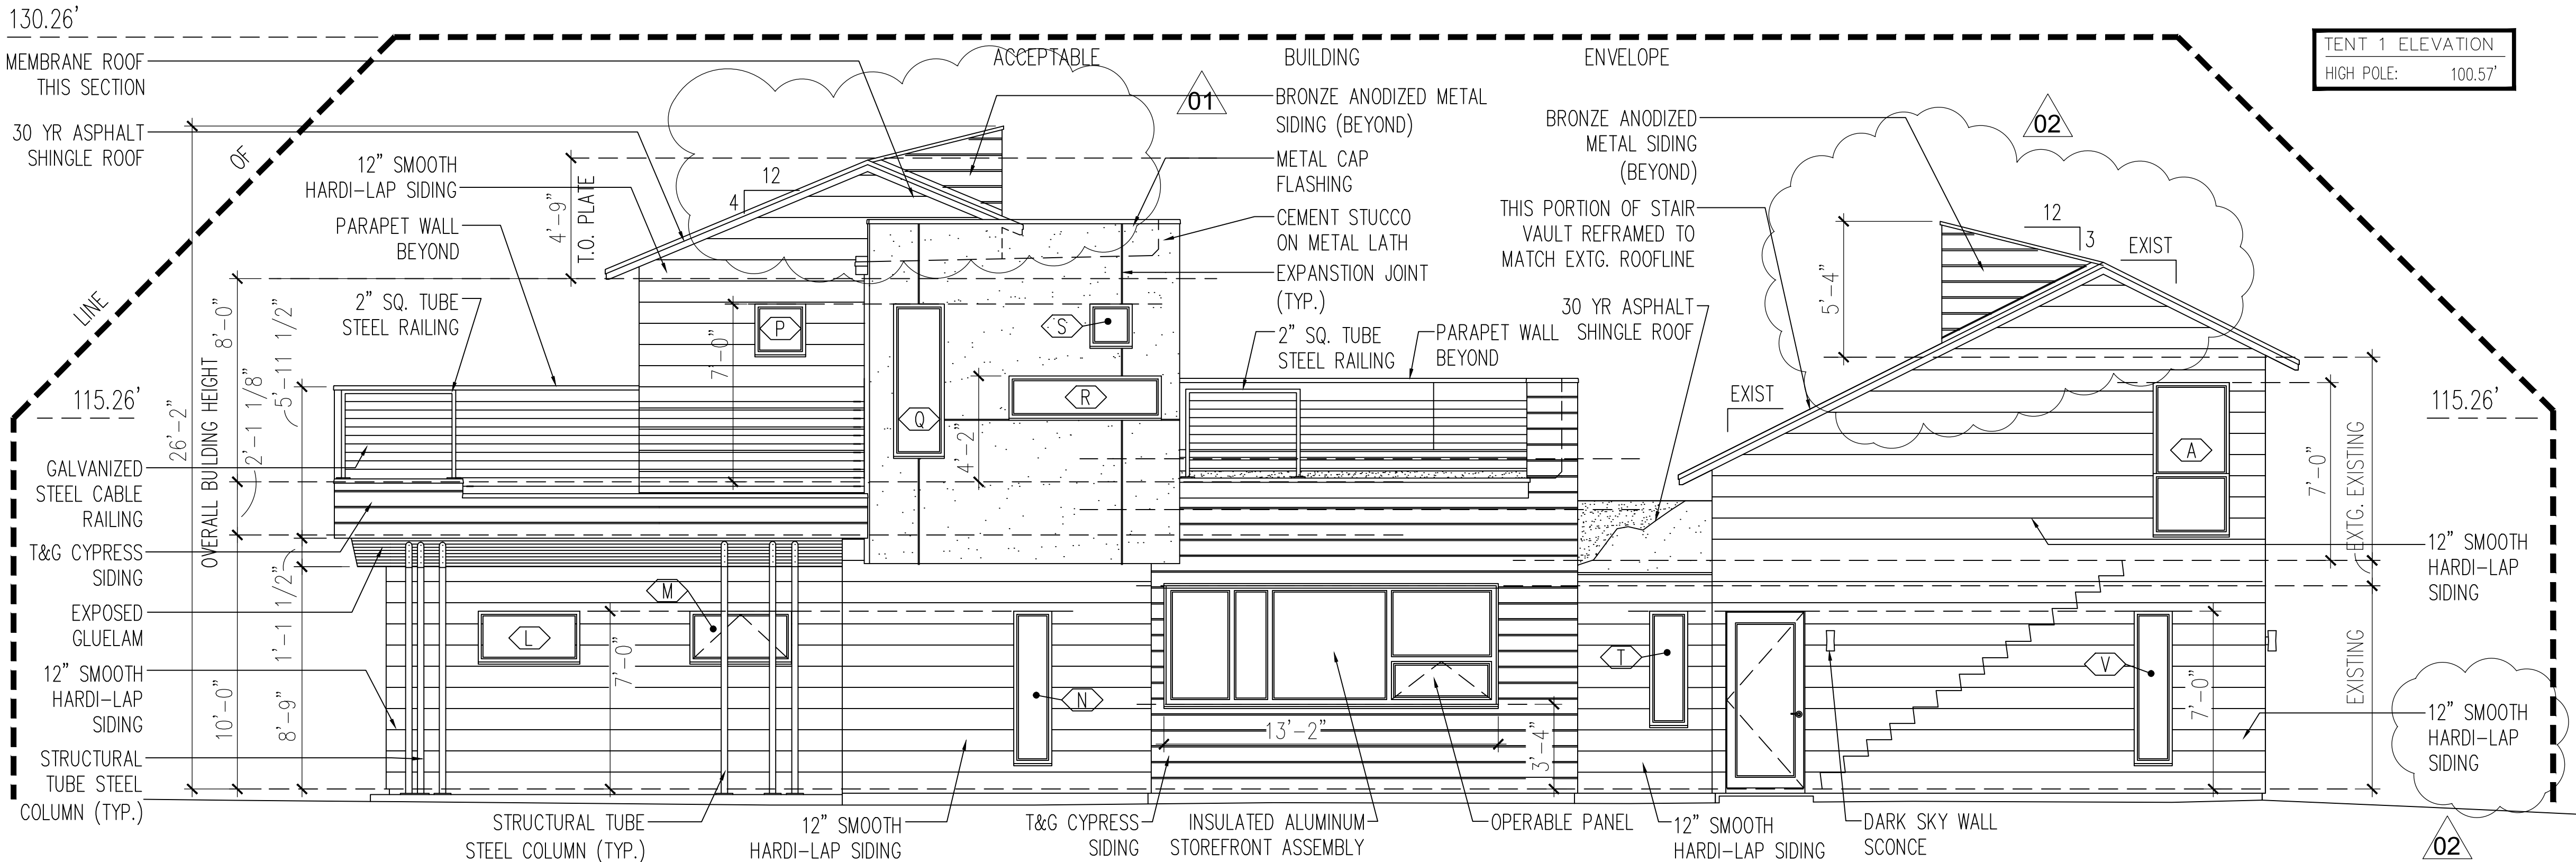
SHEET TITLE(S)
EXTERIOR
ELEVATIONS

REVISION DATE:
ISSUE DATE: 21 DEC, 2014
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WINDOW SCHEDULE					
TAG	SIZE	OPERATION	WALL TYPE	QUANTITY	SAFETY GL.
A	6'-0" X 3'-0"	DBL HUNG	2X4	6	T
B	NOT USED				
C	2'-8" X 7'-0"	PICTURE	2X6	2	T
D	3'-4" X 5'-0"	PICTURE	2X6	1	T
E	4'-0" X 2'-0"	PICTURE	2X4	1	T
F	3'-6" X 3'-6"	PICTURE	2X6	1	
G	2'-0" X 4'-6"	CSMNT	2X6	1	T
H	2'-8" X 4'-6"	CSMNT	2X6	1	T
J	4'-6" X 2'-6"	PICTURE	2X6	4	
K	2'-6" X 2'-6"	REM. OPER.	2X4	5	T
L	4'-0" X 2'-0"	PICTURE	2X6	2	
M	4'-0" X 2'-0"	CSMNT	2X6	1	T
N	1'-6" X 6'-0"	PICTURE	2X6	1	T
P	2'-0" X 2'-0"	PICTURE	2X6	1	
Q	2'-0" X 6'-0"	PICTURE	2X6	1	T
R	6'-0" X 1'-6"	PICTURE	2X6	1	
S	1'-8" X 1'-8"	PICTURE	2X6	1	
T	1'-6" X 4'-6"	PICTURE	2X4	1	T
U	3'-0" X 3'-6"	CSMNT	2X4	1	T
V	1'-6" X 6'-0"	PICTURE	2X4	1	T



02 SOUTH ELEVATION
SCALE 1/4" = 1'-0"



01 WEST (REAR) ELEVATION
SCALE 1/4" = 1'-0"

CONSULTANTS

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01	09 March, 2015
02	17 April, 2015

SHEET TITLE(S)
BUILDING SECTION AND DETAILS

REVISION DATE:
ISSUE DATE: 21 DEC, 2014
PROJECT NUMBER: 14003

WINDOW SCHEDULE						
TAG	SIZE	OPERATION	WALL TYPE	QUANTITY	SAFETY GL.	
A	6'-0" X 3'-0"	DBL HUNG	2X4	6	T	
B	NOT USED					
C	2'-8" X 7'-0"	PICTURE	2X6	2	T	
D	3'-4" X 5'-0"	PICTURE	2X6	1	T	
E	4'-0" X 2'-0"	PICTURE	2X4	1	T	
F	3'-6" X 3'-6"	PICTURE	2X6	1		
G	2'-0" X 4'-6"	CSMNT	2X6	1	T	
H	2'-8" X 4'-6"	CSMNT	2X6	1	T	
J	4'-6" X 2'-6"	PICTURE	2X6	4		
K	2'-6" X 2'-6"	REM. OPER.	2X4	5	T	
L	4'-0" X 2'-0"	PICTURE	2X6	2		
M	4'-0" X 2'-0"	CSMNT	2X6	1	T	
N	1'-6" X 6'-0"	PICTURE	2X6	1	T	
P	2'-0" X 2'-0"	PICTURE	2X6	1		
Q	2'-0" X 6'-0"	PICTURE	2X6	1	T	
R	6'-0" X 1'-6"	PICTURE	2X6	1		
S	1'-8" X 1'-8"	PICTURE	2X6	1		
T	1'-6" X 4'-6"	PICTURE	2X4	1	T	
U	3'-0" X 3'-6"	CSMNT	2X4	1	T	
V	1'-6" X 6'-0"	PICTURE	2X4	1	T	

