1 of 9

ZONING AND PLATTING COMMISSION HILL COUNTRY ROADWAY SITE PLAN REVIEW SHEET

CASE NUMBER: SPC-2014-0467C ZAP COMMISSION DATE: January 19, 2016 **PROJECT NAME:** Volente Village **ADDRESS:** 11907 Anderson Mill Road WATERSHED: Lake Travis (Water Supply Rural) **AREA:** 5.38 Acres Johnson Four Corners (Eric Johnson) **APPLICANT:** Austin, Texas 512-423-9703 AGENT: Michael Chapa Christine Barton-Holmes, LEED AP CASE MANAGER: (512) 974-2788 christine.barton-holmes@austintexas.gov

EXISTING ZONING: GR- CO and CS-1-CO

PROPOSED USE: The applicant is proposing to construct 5 retail and restaurant buildings on 5.38 acres with associated improvements in the FM 620 High Intensity Hill Country Roadway. No waivers or variances have been requested.

REQUEST: The site is located within the RM 620 high intensity zone, and must be presented to the Zoning and Platting Commission for approval, a Hill Country Roadway Ordinance requirement.

SUMMARY STAFF RECOMMENDATION FOR HCRC SITE PLAN: Staff recommends approval of this Hill Country Roadway site plan. The site plan will comply with applicable requirements of the Land Development Code including all Hill Country Roadway Corridor development regulations.

ZONING AND PLATTING COMMISSION ACTION:

LEGAL DESCRIPTION: Lot 4, Block A, Volente SubdivisionEXIST. ZONING: GR-CO and CS-1-COPROPOSED USE: Retail/restaurant/officeALLOWED F.A.R.: 0.30:1PROPOSED F.A.R.: 0.12:1ALLOWED HEIGHT: 60'PROPOSED HEIGHT: 29'MAX. BLDG. COVERAGE: 95%PROPOSED BLDG. CVRG: 11.73%MAX. IMPERV. CVRG.: 60%PROPOSED IMP. CVRG.: 49.34%MIN. REQ. HC NATURAL AREA: 40%PROVIDED: 41%REQUIRED PARKING: 141PROPOSED PARKING: 149

SUMMARY COMMENTS ON SITE PLAN:

Land Use: This site is currently undeveloped, and is proposed to be developed in two phases for restaurant, retail, and professional office uses. One of the restaurants will be located in the portion of the site that is zoned CS-1. There are no Critical Environmental Features on the site. The applicant will use building materials that are compatible with the Hill Country environment, and the site plan will comply with all requirements of the Land Development Code prior to its release.

Environmental: This site is located in the Lake Travis watershed, and is subject to Water Supply Rural Watershed regulations.

Transportation: Access to the proposed site will be taken from FM 620 and Anderson Mill Road. The site plan will comply with all transportation requirements prior to release.


SURROUNDING CONDITIONS:

North: Anderson Mill Rd, then multifamily residential (City of Cedar Park) East: Commercial retail, then FM 620 (I-RR) West: Single-family residential and undeveloped (2-mile ETJ) South: Commercial (GR-CO and 2-mile ETJ)

Street	<u>R.O.W.</u>	Surfacing	Classification
FM 620	140'	75'	Major Arterial
Anderson Mill Road	95'	62'	Major Arterial

NEIGHBORHOOD ORGANIZATION:

Anderson Mill Neighborhood Association Austin Heritage Tree Foundation Bike Austin Bull Creek Foundation Friends of Austin Neighborhoods Leander ISD Long Canyon Homeowners Association Long Canyon Phase II & III Homeowners Association SEL Texas Sierra Club The Parke HOA Volente Neighborhood Association

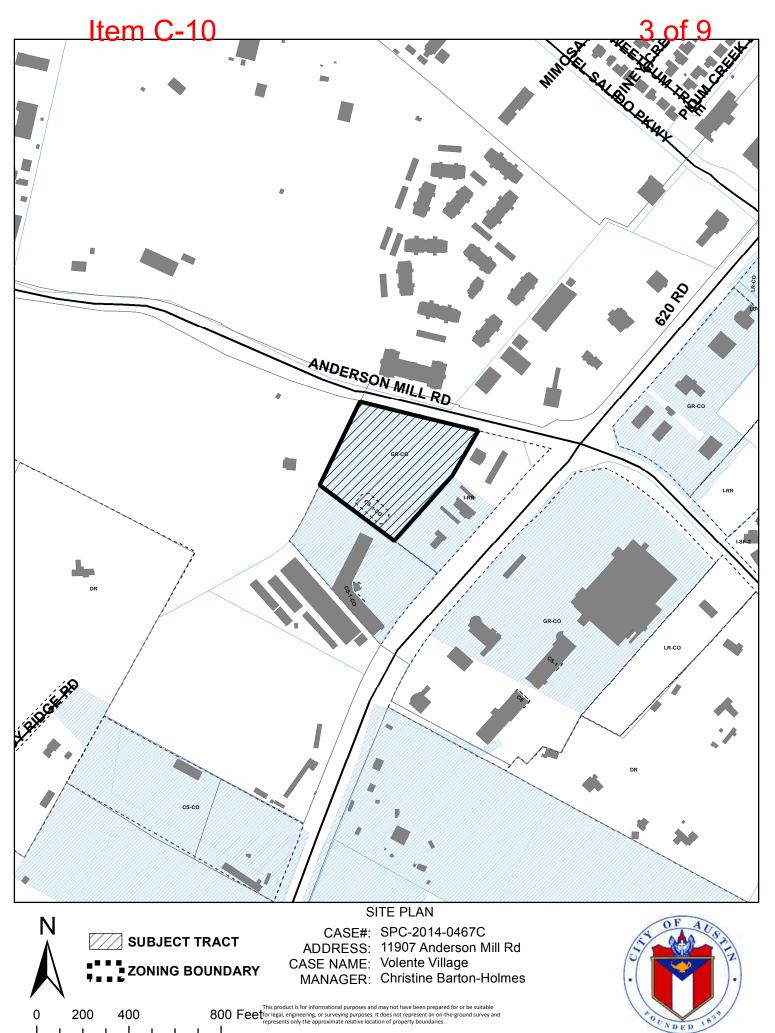

This product has been produced by the Planning and Development Review Department for the sole purpose of geographic reference. No warranty is made by the City of Austin regarding specific accuracy or completeness.

OPERATOR: Christine Barton-Holmes

OWNER:	JOHNSON FOUR CORNERS 11100 LAUREL CREEK AUSTIN, TX 78726	
ENGNEER:	CRD GROUP, LLC 9111 JOLLYVILLE RD, SUITE 106 AUSTIN, TX 78759 512-775-5166	
ARCHITECT:	ALLAN NUTT ARCHITECTS 5121 BEE CAVES ROAD, SUITE AUSTIN, TEXAS 78746	202
SURVEYOR:	CRICHTON AND ASSOCIATES 6448 HIGHWAY 290 EAST AUSTIN, TX 78723 512–244–9508	

ZONING:

CITY OF AUSTIN - FULL PURPOSE (GR & CS-1) LAND USE SUMMARY:

GROSS ACREAGE TOTAL IMPERVIOUS COVER ALLOWABLE IMPERVIOUS COVER PRINCIPAL STREET FLOODPLAIN INFORMATION:

5.05 ACRES 53.07% (2.68 AC.) 60% (3.02 AC.) MAJOR ARTERIAL (FM 2769)

FEDERAL EMERGENCY MANAGEMENT AGENCY FLOOD INSURANCE RATE MAP NO. 48453CO230H DATED SEPTEMBER 26, 2008 INDICATES THAT THE SUBJECT TRACT LIES WITHIN ZONE "X" (UNSHADED), AREAS DETERMINED TO BE OUTSIDE THE FLOOD PLAIN.

WATERSHED:

THIS PROJECT IS LOCATED IN THE LAKE TRAVIS WATERSHED A WATER SUPPLY RURAL WATERSHED AND IN THE NORTH EDWARD AQUIFER RECHARGE ZONE.

BEARING BASIS NOTE:

BENCHMARK:

T.B.M. NOTE: SQUARE CUT IN TOP OF CURB ELEVATION = 1026.92

Plan Not

This note is being placed on the plan set in place of a temporary traffic control strategy with the full understanding that, at a minimum of 6 weeks prior to the start of construction, a temporary traffic control plan must be reviewed and approved by the Right of Way Management Division. The owner/ representative further recognizes that a review fee, as prescribed by the most current version of the City's fee ordinance, shall be paid <u>each time</u> a plan or plan revision is submitted to Right of Way Management Division for review.

The following must be taken into consideration when developing future traffic control strategies:

- Pedestrian and bicycle traffic access must be maintained at all times. unless otherwise authorized by Right of Way Management.
- No long-term lane closures will be authorized, unless Right of Way Management determines that adequate accommodations have been made to minimize traffic impact.
- Project should be phased so that utility installation minimally impacts existing or temporary pedestrian facilities.

Case Report Note

The Owner/Representative has elected to defer the temporary traffic control plan review until after the completion of the developmental review process and fully understands that, at a minimum of 6 weeks prior to the start of construction, a temporary traffic control plan must be reviewed and approved by Right of Way Management Division. The owner/ representative further recognizes that a review fee, as prescribed by the most current version of the City's fee ordinance, shall be paid each time a plan or plan revision is submitted to Right of Way Management Division for review.

The following must be taken into consideration when developing future traffic control strategies:

- Pedestrian and bicycle traffic access must be maintained at all times, unless otherwise authorized by Right of Way Management.
- No long-term lane closures will be authorized, unless Right of Way Management determines that adequate accommodations have been made to minimize traffic impact.
- Project should be phased so that utility installation minimally impacts existing or temporary pedestrian facilities.

NOTES

- RELEASE OF THIS APPLICATION DOES NOT CONSTITUTE A VERIFICATION OF ALL DATA, INFORMATION AND CALCULATIONS SUPPLIED BY THE APPLICANT. THE ENGINEER OF RECORD IS SOLELY RESPONSIBLE FOR THE COMPLETENESS, ACCURACY AND ADEQUACY OF HIS/HER SUBMITTAL, WHETHER OR NOT THE APPLICATION IS REVIEWED FOR CODE COMPLIANCE BY CITY ENGINEERS.
- 2. RETAINING WALLS OVER FOUR FEET IN HEIGHT, MEASURE FROM THE BOTTOM OF THE FOOTING TO THE TOP OF THE WALL, SHALL BE ENGINEERED AND WILL REQUIRE A SEPARATE PERMIT (UNIFORM BUILDING CODE 106.2.5)
- 3. THIS SITE PLAN IS WITHIN COMPLIANCE WITH SUBCHAPTER E: DESIGN STANDARDS. 4. THIS SITE WILL COMPLY WITH \$3.3 OPTIONS TO
- IMPROVE BUILDING DESIGN. 5. THIS PROJECT IS SUBJECT TO THE VOID AND WATER FLOW MITIGATION RULE (COA ECM 1.12.0 AND COA ITEM NO. 658S OF THE SSM) PROVISION THAT ALL TRENCHING GREATER THAN 5 FEET DEEP MUST BE INSPECTED BY A GEOLOGIST (TEXAS P.G.) OR A GEOLGOIST'S REPRESENTATIVE.
- 6. APPROVAL OF THESE PLANS BY THE CITY OF AUSTIN INDICATES COMPLIANCE WITH APPLICABLE CITY REGULATIONS ONLY. APPROVAL BY OTHER GOVERNMENT ENTITIES MAY BE REQUIRED PRIOR TO START OF CONSTRUCTION. THE APPLICANT IS RESPONSIBLE FOR DETERMINING WHAT ADDITIONAL APPROVALS MAY BE REQUIRED.
- 7. RETAINING WALLS MUST BE ENGINEERED AND WILL BE A SEPERATE PERMIT

CITY OF AUSTIN WATER AND WASTEWATER UTILITY <u>SPECIAL SERVICES DIVISION</u> (512) 972-1060

THIS PROJECT HAS PRIVATE HYDRANTS WITHIN THE PROPERTY. THE PROPERTY OWNER IS REQUIRED TO COMPLY WITH AUSTIN FIRE CODE. FAILURE TO COMPLY MAY RESULT IN CIVIL AND/OR CRIMINAL REMEDIES AVAILABLE TO THE CITY. THE PERFORMANCE OF THIS OBLIGATION SHALL ALWAYS REST WITH THE OWNER OR RECORD. FIRE HYDRANTS ON PRIVATE PROPERTY ARE REQUIRED TO BE SERVICES, MAINTAINED AND FLOWED ANNUALLY. USING A CONTRACTOR REGISTERED WITH THE CITY TO PROVIDE THE SERVICE. THE PROJECT INCLUDES 3 PRIVATE HYDRANTS.

AWN BY:	
IGNED BY:	
MC	1
T REVISION:	
ROJECT NO .:	
	PROJECT NAME:

				CRDGROUP, LLC COMMERCIAL.RESIDENTIAL.DESIGN TAPLE FIRM FORM		DESIGNED BY: MC LATEST REVISION:
REVISION	BY	CK'D	DATE	9111 Joliyville Road, Suite 106 Austin, Texas 78759 T—512.775.5166 F—512.346.0520	Iŀ	CRD PROJECT NO.:


NO SPRINKLERS

FIRE DEPARTMENT

CONSOLIDATED ADMINISTRATIVE SITE PLAN FOR

VOLENTE VILLAGE

11907 ANDERSON MILL AUSTIN, TEXAS 78726

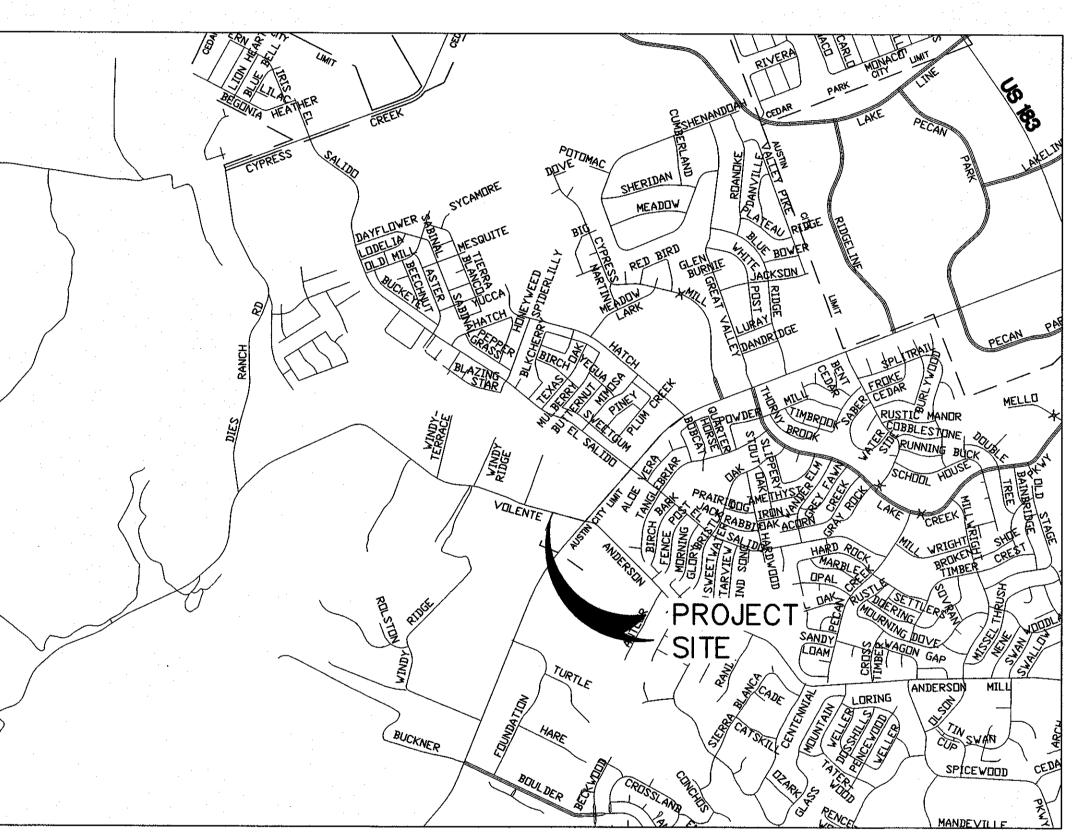

VICINITY MAP COA GRID E38

MAPSCO #433J & 433 N

SUBMITTAL DATE: NOVEMBER 19, 2014

LEGAL DESCRIPTION

LOT 4 IN BLOCK A OF THE VOLENTE SUBDIVISION, AS RECORDED UNDER DOCUMENT NO. 200000061 OF THE OFFICIAL PUBLIC RECORDS OF TRAVIS COUNTY, TEXAS,

RELATED CASES

VARIANCES

PROJECT DESCRIPTION

THIS PROJECT CONSISTS OF THE CONSTRUCTION OF FIVE (5) ONE-STORY RETAIL BUILDINGS TOTALING 34,014 SQ. FT. (GSF), ON A 5.05 ACRE SITE WITH ASSOCIATED PARKING, DETENTION, WATER QUALITY, AND UTILITY IMPROVEMENTS. THE TOTAL IMPERVIOUS COVER IS 53.07%

Number Description

NORTHWEST B1 PRESSURE ZONE TYPE 1-B CONSTRUCTION FIRE AREA: 8,207 SF REQUIRED FIRE FLOW: 1,500 GPM (PER THE INTERNATIONAL FIRE CODE) STATIC PRESSURE: 80 PSI

I_____ TEXAS LICENSE NUMBER _____ CERTIFY THAT THE DESIGN OF THE DAM IN THIS SET OF PLANS CAN SAFELY PASS 75% OF THE PROBABLE MAXIMUM

FLOOD BASED ON THE HYDROLOGIC, HYDRAULIC, STRUCTURAL AND GEOTECHNICAL ANALYSIS USING

STANDARD ACCEPTED ENGINEERING PRACTICES.

AUSTIN WATER UTILITY 222 FIXTURE UNITS

> VOLENTE VILLAGE 11907 ANDERSON MILL ROAD AUSTIN, TX 78726


SHEET NAME:




		an an 20 an	4 of 9
	· .		
	· · · · · · · · · · · · · · · · · · ·		
DESCRIPT			

Ź4 |8

	SHEET NO.	SHEET DESCRIPTION
	1	COVER SHEET
	2	FINAL PLAT
	3	EROSION CONTROL & DEMOLITION PLAN
	. 4	SITE PLAN
	5	SLOPE MAP
NOTE TO CONTRACTOR	6	GRADING & DRAINAGE PLAN
1. ALL BIDDERS SHALL IMMEDIATELY NOTIFY THE ENGINEER OF AN AMBIGUITIES, ERRORS, OR	7	OFFSITE DRAINAGE PLAN
INCONSISTENCIES THEY DISCOVER OF THE BIDDING DOCUMENTS OR OF THE SITE CONDITIONS. ANY	8	DETENTION POND - PLAN AND PROFILE
OF THESE ITEMS NOT BROUGHT TO THE ATTENTION	9	WATER QUALITY POND PLAN AND PROFILE
OF THE ENGINEER DURING THE BIDDING PROCESS SHALL BE PROVIDED AT NO ADDITIONAL COST	10	WATER QUALITY POND NOTES AND DETAILS
2. ALL BIDDERS SHALL PERFORM AN INDEPENDENT	11	UTILITY PLAN
QUANTITY TAKE-OFF TO VERIFY QUANTITIES ARE WITHIN FIVE PERCENT OF THE ACTUAL QUANTITIES	12 13	WATERLINE PLAN AND PROFILE 1+00 - 4+52
REQUIRED TO COMPLETE THE CONSTRUCTION BY THE PLANS PRIOR TO SUBMITTING A BID TO THE	13	GENERAL NOTES
ENGINEER. IF ANY QUANTITY IS FOUND TO BE IN ERROR BY MORE THAN FIVE PERCENT, THE	15	GENERAL NOTES CONSTRUCTION DETAILS
CONTRACTOR SHALL NOTIFY THE ENGINEER AT LEASE FORTY-EIGHT HOURS PRIOR TO SUBMITTING		CONSTRUCTION DETAILS
BID	16	
3. THE LOCATION OF ALL EXISTING UTILITIES SHOWN ON THESE PLANS HAS BEEN BASED UPON	17 18	UTILITY DETAILS LANDSCAPE PLAN
RECORD INFORMATION ONLY AND MAY NOT MATCH LOCATIONS AND/OR DEPTHS AS CONSTRUCTED.	18	LANDSCAPE PLAN LANDSCAPE DETAILS
THE CONTRACTOR SHALL CONTACT EACH OF THE INDIVIDUAL UTILITY, FOR ASSISTANCE IN	20	SPECIFICATIONS
DETERMINING EXISTING UTILITY LOCATIONS AND DEPTHS PRIOR TO BEGINNING ANY CONSTRUCTION	20	TREE MITIGATION PLAN
CONTRACTOR SHALL FIELD VERIFY LOCATIONS OF ALL UTILITY CROSSINGS PRIOR TO BEGINNING ANY	22	BUILDING 1 ELEVATIONS
CONSTRUCTION.	23	BUILDING 2 ELEVATIONS
4. LOTS WITH 65 PSI OR GREATER, REQUIRE PRV	24	BUILDING 3 ELEVATIONS
SET AT 65 PSI, TO BE INSTALLED ON THE PROPERTY OWNERS SIDE OF THE PROPERTY.		
ACCEPTED BY:		
		DATE
FOR DIRECTOR, PLANNING AND DEVELOPMENT		
FOR DIRECTOR, PLANNING AND DEVELOPMENT	REVIEW DEPARTMENT	
SITE PLAN/DEVELOPMENT PERMIT NUMBER		
SHE FLANY DEVELOPMENT FERMIT NOMBER	n an	DATE
	· · · · · · · · · · · · · · · · · · ·	
AUSTIN WATER UTILITY		DATE
AUSTIN FIRE DEPARTMENT	· · · · · · · · · · · · · · · · · · ·	
		DATE
INDUSTRIAL WASTE DEPARTMENT		
		DATE
FOR TEXAS DEPARTMENT OF TRANSPORTATION		
SUBMITTED BY :		
Alman VIIIan		DATE //- 25-15
MICHAEL R. CHAPA, P.E.		
LICENSED PROFESSIONAL ENGINEER NO. 9172	4	
REVISIONS / CORRECTIONS	Date	
Add (A)Sheets in Plan SetChangeImp.Approval –Void (V)Plan SetImp.CoverDate	Imaged	
Sheet No.'s Cover (sq. ft.)/%		SITE PLAN RELEASE Sheet 1 of 24
	CASE I	UMBER: <u>SPC-2014-0467C</u> EXPIRATION DATE: MANAGER: <u>CHRISTINE BARTON-HOLMES</u> APPLICATION DATE: <u>NOV. 19. 2014</u> VED ADMINISTRATIVELY ON:
	APPROV APPROV	VED BY PLANNING COMMISSION ON:
		Section <u>142</u> on Chapter <u>25–5</u> of the Austin City Code.
	DATE O	ning for Director, Planning and Development Review Department DF RELEASE:ofZoning:GR, CS-1
	Rev. 1	1 Correction 1 2 Correction 2
	Rev. 3	3 Correction 3
	DATA	SE OF THIS APPLICATION DOES NOT CONSTITUTE A VERIFICATION OF ALL INFORMATION AND CALCULATIONS SUPPLIED BY THE APPLICANT. THE INEER OF RECORD IS SOLELY RESPONSIBLE FOR THE COMPLETENESS,
	ACCU	IRACY AND ADEQUACY OF HIS/HER SUBMITTAL, WHETHER OR NOT THE PLICATION IS REVIEWED FOR CODE COMPLIANCE BY CITY ENGINEERS.
- to the state of		FULL SIZE DRAWING SCALE: SHEET NO.
The second		VERTICAL HORIZONTAL
MICHAEL R. CHAPA		<u>11"x17" DRAWING SCALE:</u> VERTICAL
91724 SEE	1	HORIZONTAL
	11	PLOT DATE: 11/12/2015 24
SEAL:	1	FILE NAME:

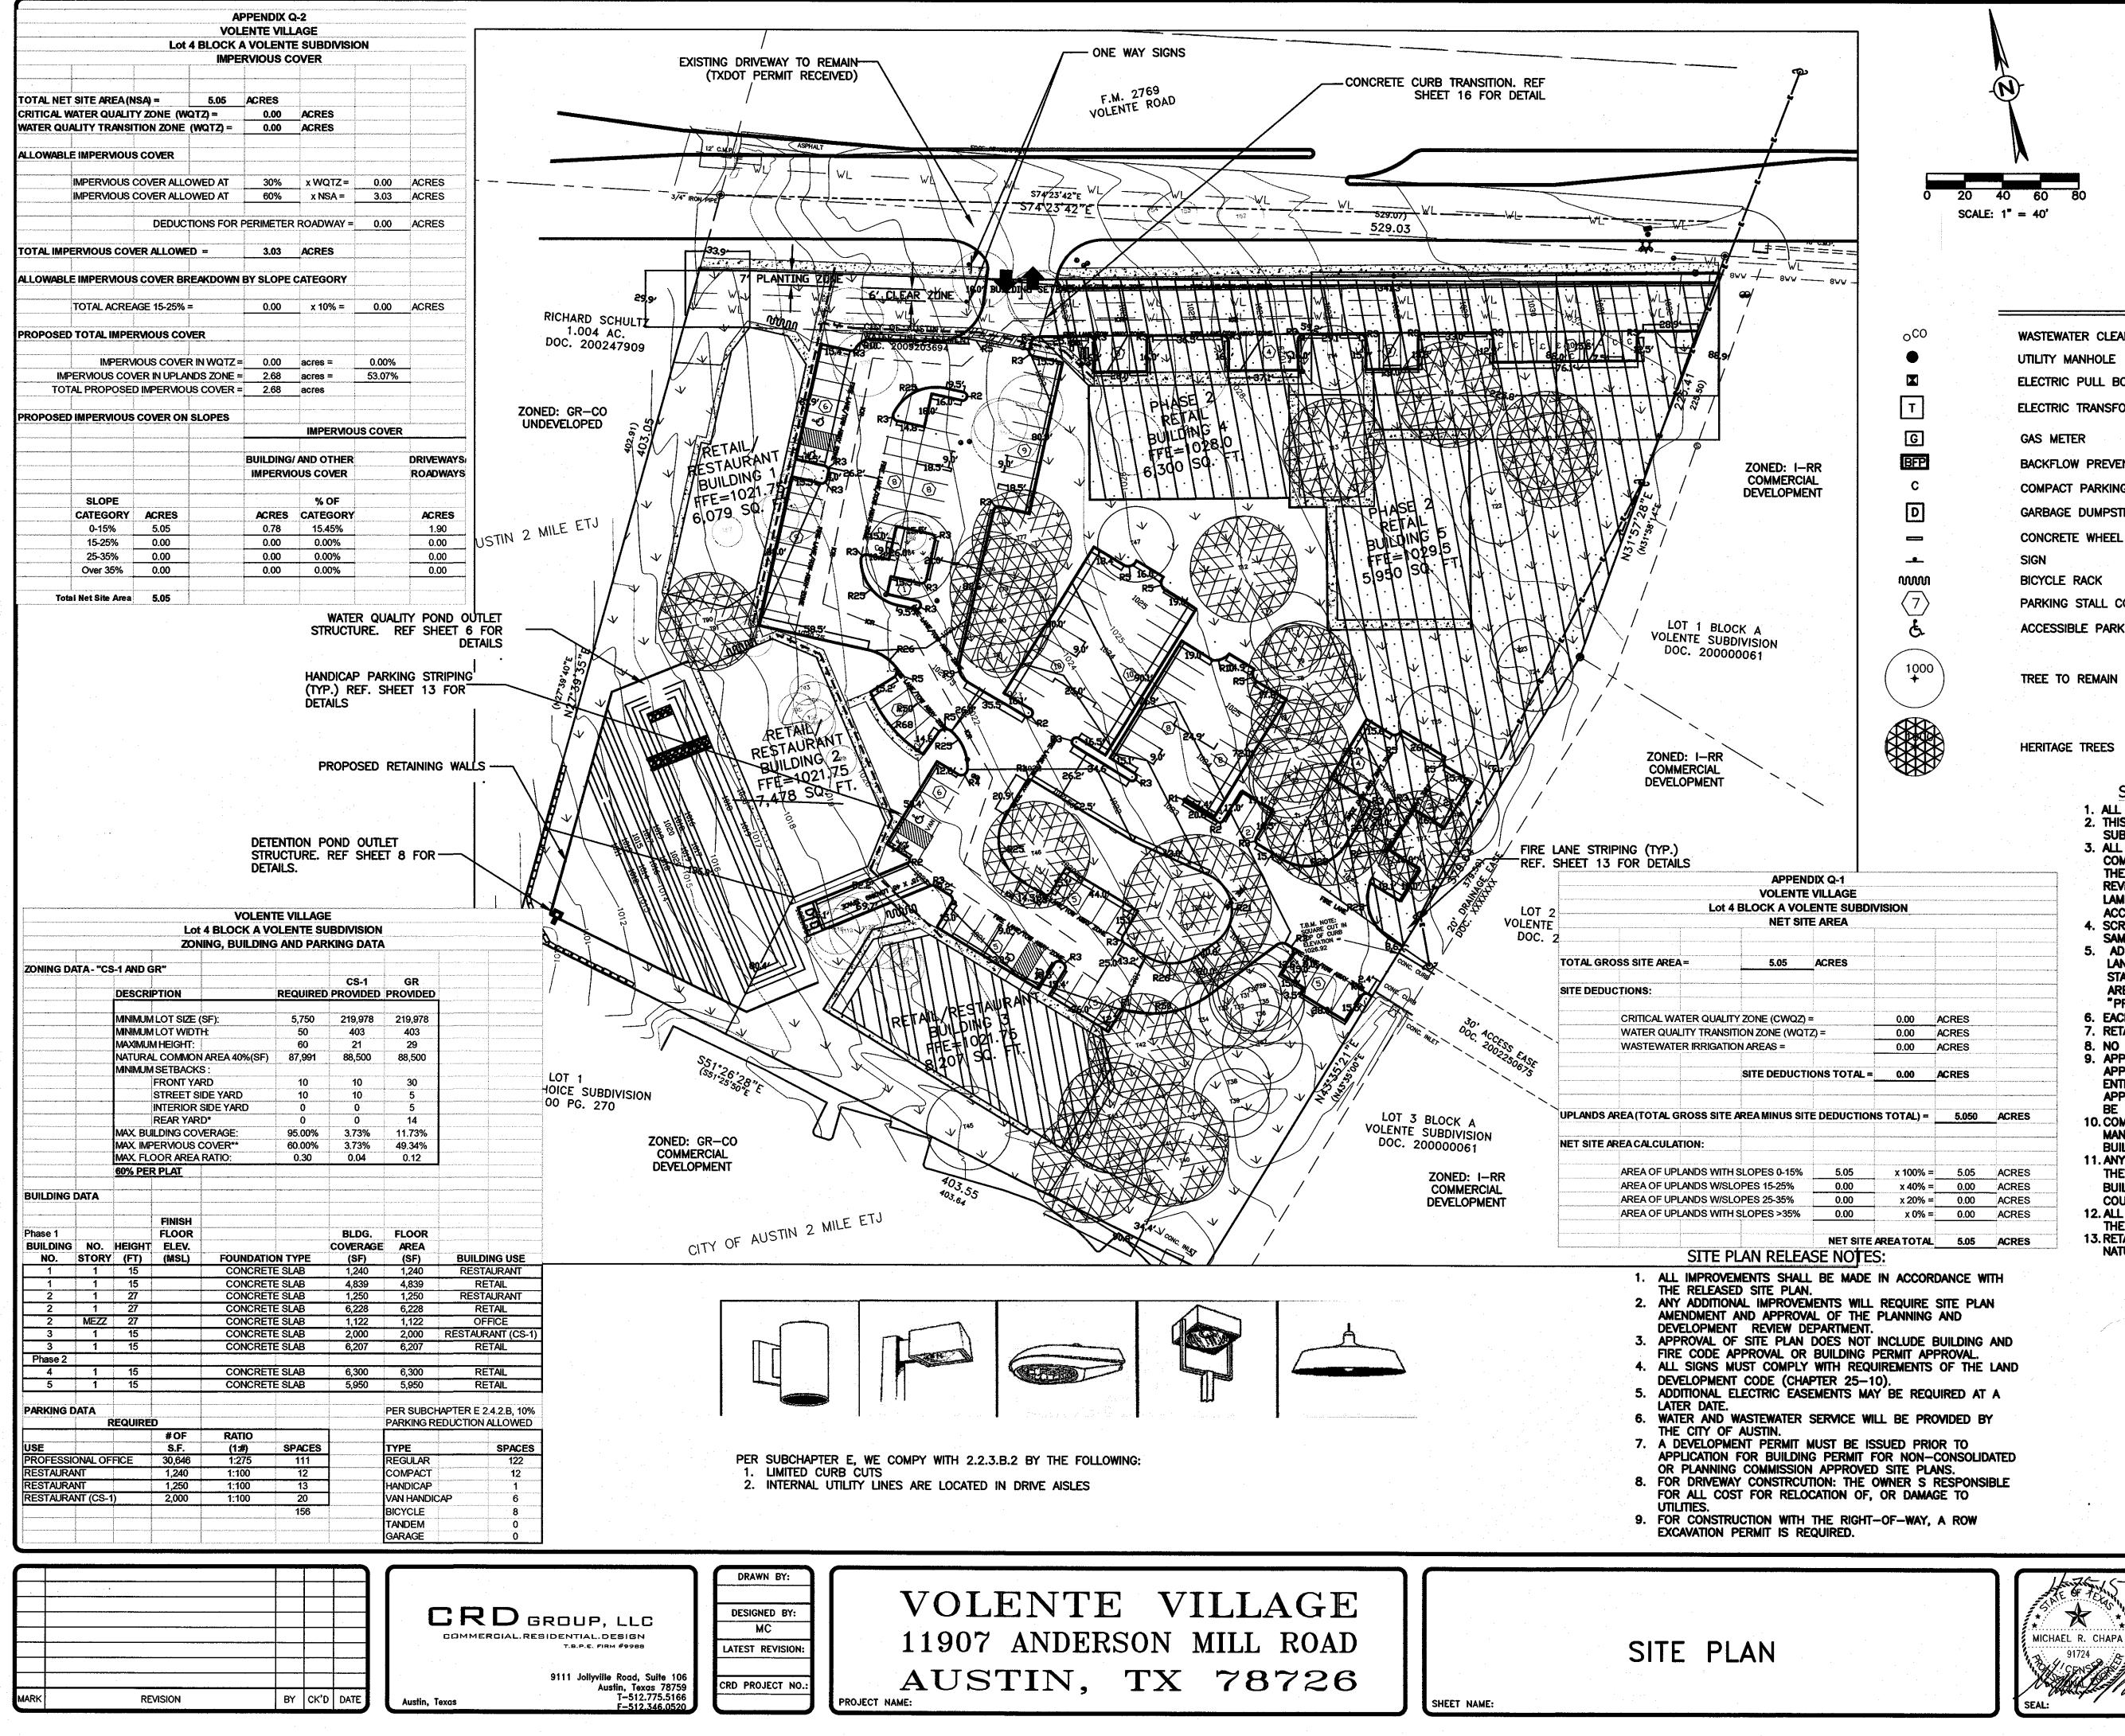

LEGEND

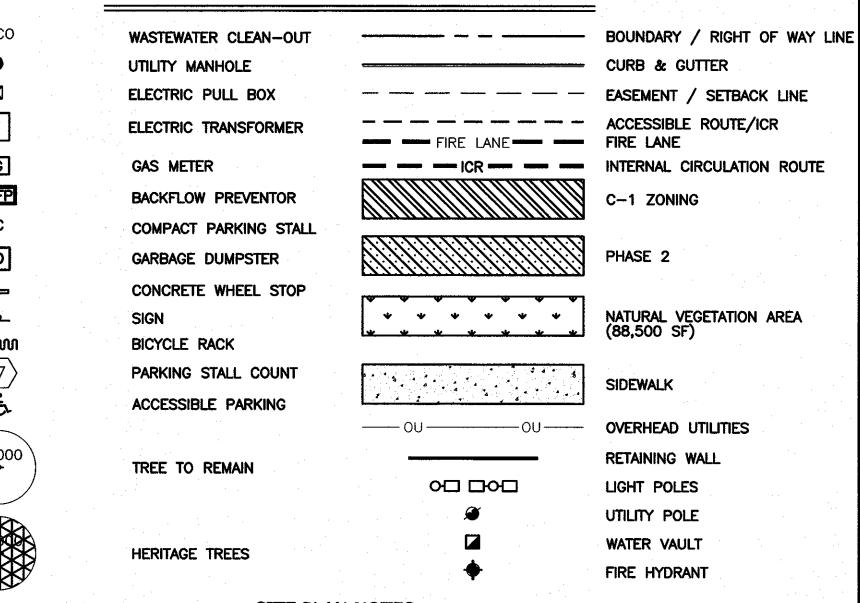

- SITE PLAN NOTES:
- 1. ALL SITE DIMENSIONS ARE TO FACE OF CURB UNLESS OTHERWISE NOTED. 2. THIS SITE PLAN IS IN COMPLIANCE WITH COMMERCIAL DESIGN STANDARDS
- SUBCHAPTER E 3. ALL EXTERIOR LIGHTING WILL BE FULL CUT-OFF AND FULLY SHIELDED IN COMPLIANCE WITH SUBCHAPTER E 2.5. ALL SITE LIGHTING TO BE LOCATED ON THE BUILDING WILL BE IN COMPLIANCE WITH SUBCHAPTER E 2.5, AND WILL BE REVIEWED DURING BUILDING PLAN REVIEW. ANY CHANGE OR SUBSTITUTION OF 2/LIGHT FIXTURES SHALL BE SUBMITTED TO THE DIRECTOR FOR APPROVAL IN ACCORDANCE WITH SECTION 2.5.2.E
- 4. SCREENING FOR SOLID WASTE COLLECTION AND LOADING AREAS SHALL BE THE SAME AS, OR OF EQUAL QUALITY TO, PRINCIPAL BUILDING MATERIALS.
- 5. ADEQUATE BARRIERS BETWEEN ALL VEHICULAR USE AREAS AND ADJACENT LANDSCAPE AREAS, SUCH AS A 6" CONCRETE CURB ARE REQUIRED. IF A STANDARD 6" CURB AND GUTTER ARE NOT PROVIDED FOR ALL VEHICULAR USE AREAS AND ADJACENT LANDSCAPE AREAS, COMPLY WITH ECM, SECTION 2.4.7, "PROTECTION OF LANDSCAPE AREAS".
- 6. EACH COMPACT PARKING SPACE/AISLE WILL BE SIGNED "SMALL CAR ONLY" 7. RETAINING WALLS MUST BE ENGINEERED AND WILL REQUIRE SEPARATE PERMIT.
- 8. NO CUT OR FILL >4" PERMITTED WITHIN THE $\frac{1}{2}$ CRZ OF TREES IN RIGHT OF WAY. 9. APPROVAL OF THESE PLANS BY THE CITY OF AUSTIN INDICATES COMPLIANCE WITH
- APPLICABLE CITY REGULATIONS ONLY. APPROVAL BY OTHER GOVERNMENTAL ENTITIES MAY BE REQUIRED PRIOR TO THE START OF CONSTRUCTION. THE APPLICANT IS RESPONSIBLE FOR DETERMINING WHAT ADDITIONAL APPROVALS MAY BE NECESSARY.
- 10. COMPLIANCE WITH THE COMMERCIAL AND MULTI-FAMILY RECYCLING ORDINANCE IS MANDATORY FOR MULTI-FAMILY COMPLEXES AND BUSINESSES AND OFFICE BUILDINGS.
- 11. ANY PROPOSED MODIFICATIONS WHICH INCLUDE MOVING A STRUCTURE MORE THAN THENTY-FIVE (25') FEET OR INCREASING THE HEIGHT OR SQUARE FOOTAGE OF A BUILDING WILL REQUIRE REVIEW BY THE PLANNING COMMISSION AND/OR CITY COUNCIL.
- 12. ALL ON-SITE UTILITIES SHALL BE LOCATED UNDERGROUND UNLESS REQUIRED BY THE UTILITY TO BE OTHERWISE LOCATED.
- 13. RETAINING WALLS TO BE LOCATED ALONG THE PERIMETER OF THE DESIGNATED NATURAL VEGETATIVE AREA AS NEEDED.

SITE PLAN RELEASE Sheet _4_ of 24 FILE NUMBER: <u>SPC-2014-0467C</u> EXPIRATION DATE: CASE MANAGER: <u>CHRISTINE BARTON-HOLMES</u> APPLICATION DATE: <u>NOV. 19, 2014</u> APPROVED ADMINISTRATIVELY ON: APPROVED BY PLANNING COMMISSION ON:. Signing for Director, Planning and Development Review Departme DATE OF RELEASE: _____ .of_____ Zoning:__ Correction 1 Correction 2 Rev. Correction 3 Rev. 3. RELEASE OF THIS APPLICATION DOES NOT CONSTITUTE A VERIFICATION OF ALL DATA. INFORMATION AND CALCULATIONS SUPPLIED BY THE APPLICANT. THE ENGINEER OF RECORD IS SOLELY RESPONSIBLE FOR THE COMPLETENESS,

ACCURACY AND ADEQUACY OF HIS/HER SUBMITTAL, WHETHER OR NOT THE APPLICATION IS REVIEWED FOR CODE COMPLIANCE BY CITY ENGINEERS.

FULL SIZE DRAWING SCALE: VERTICAL HORIZONTAL 11"x17" DRAWING SCALE: VERTICAL HORIZONTAL PLOT DATE: 11/23/2015 FILE NAME:

SHEET NO.	
4	
	\mathcal{T}
	Ζ4


Q


NOS

5 of 9

 \mathbf{X}

9172

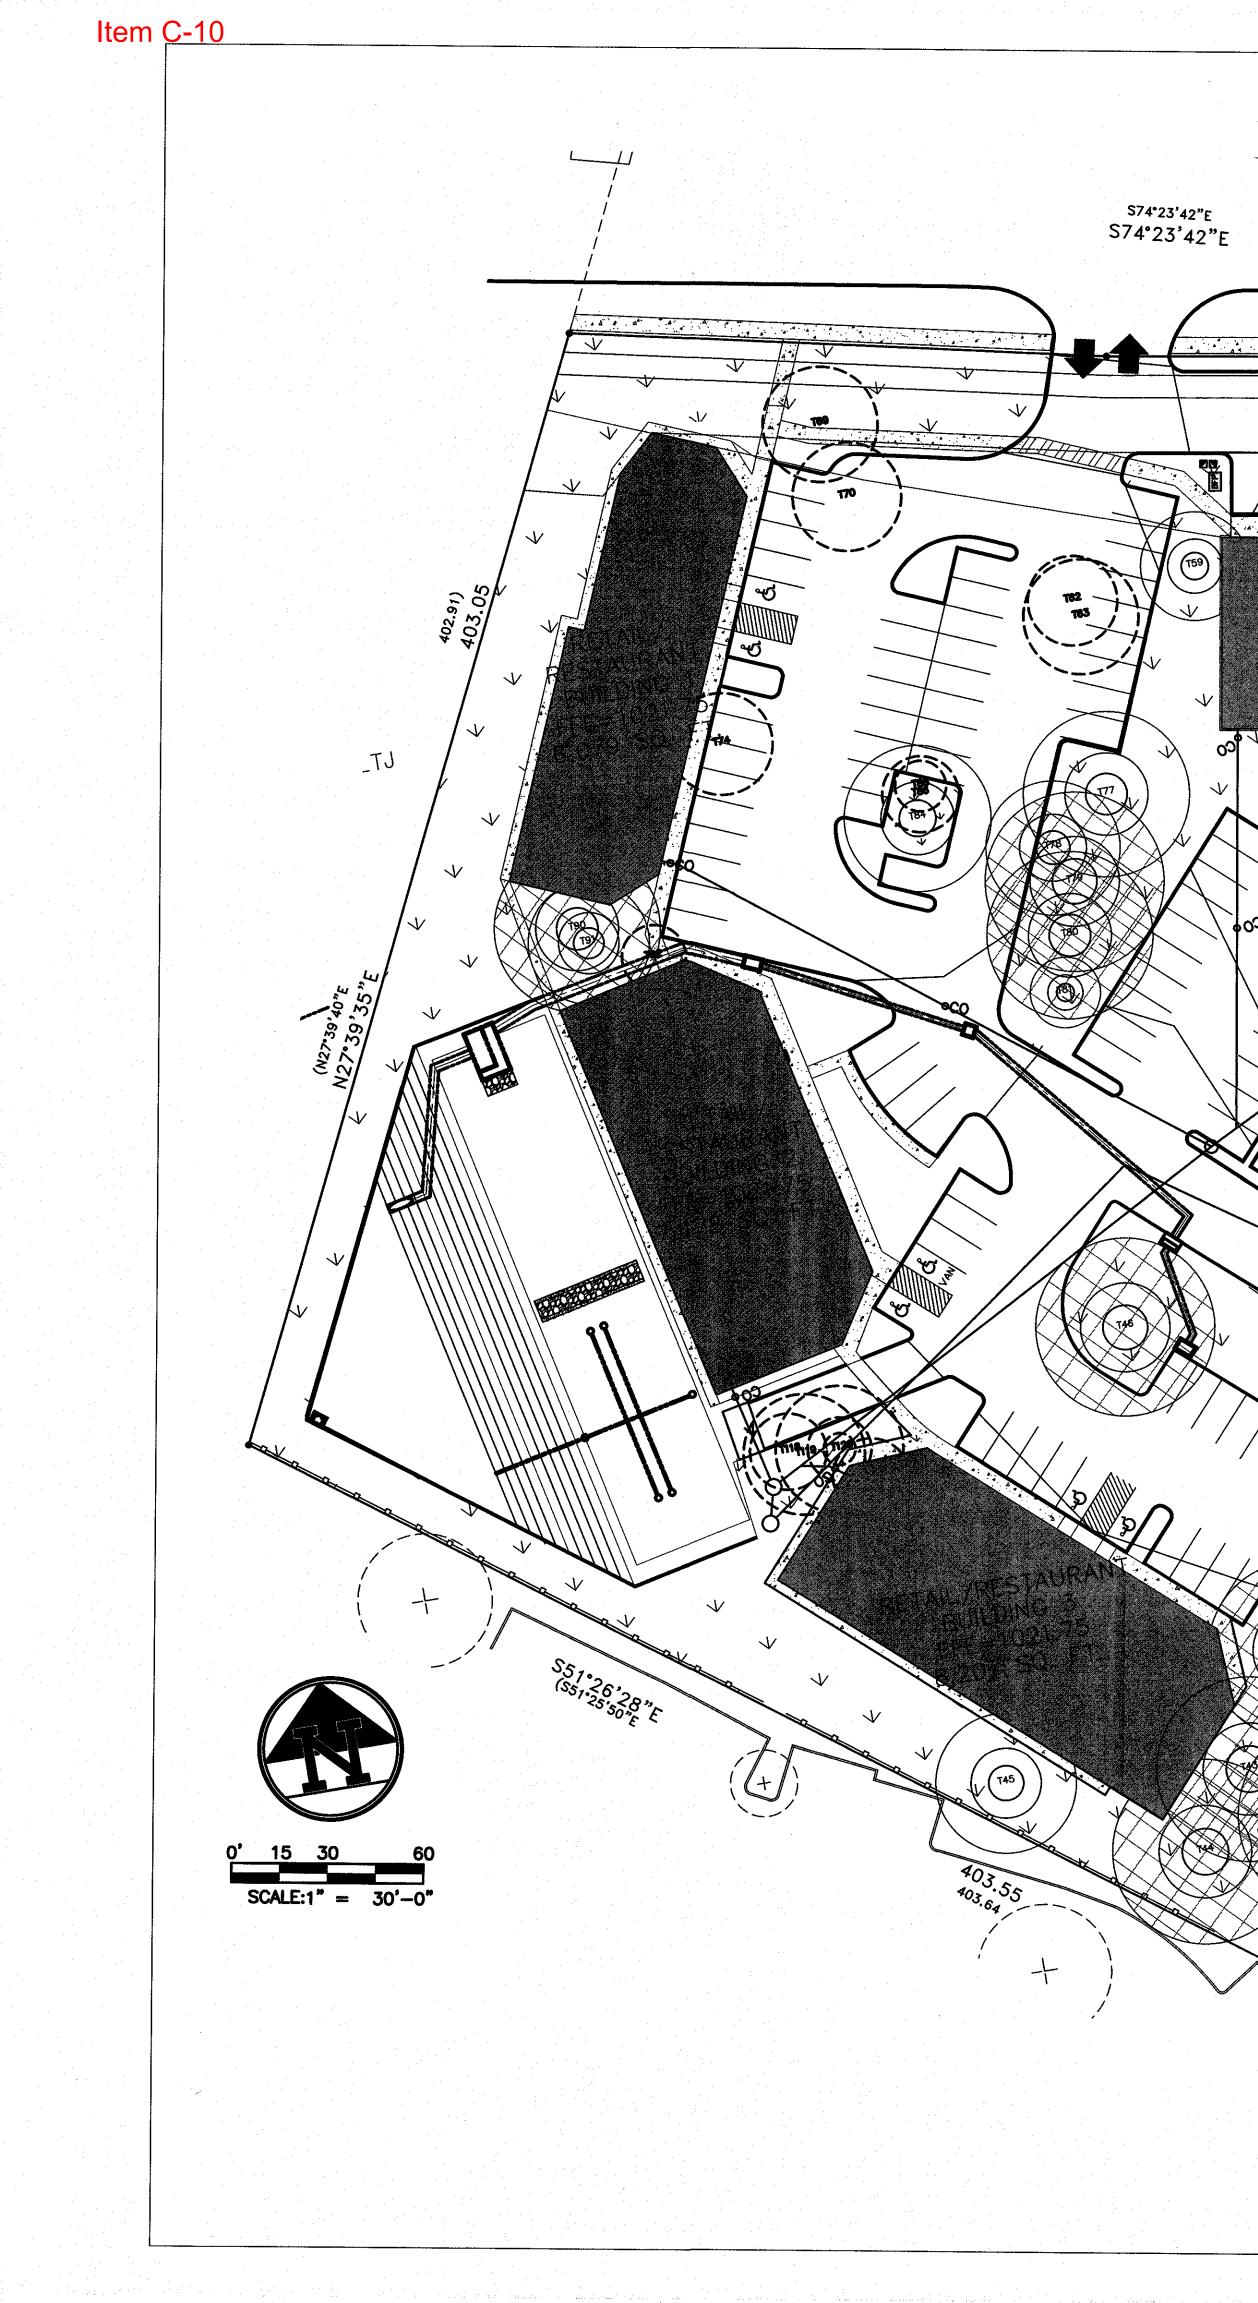

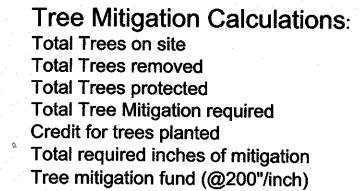

To be paid into Tree Mitigation Bank

Tree Mitigation:

N. 35. 4

 \checkmark

^{529.07)} 529.03

*

V 125

à 1/ 4.

- 1. Trees will be fertilized prior to any construction activity. materials and methods are to be approved by the City Arborist (974-1876) prior to application. the general contractor shall select a fertilization contractor and insure coordination with the city arborist. Within 7 days after fertilization is performed, the contractor shall provide documentation of the work performed to the City Arborist, Watershed Protection, p.o. box 1088, Austin, Texas, 78767. All class 1 trees within (or adjacent to) the limits of construction which are indicated to be preserved (on the plans) will be fertilized prior to the beginning of construction activities and again after the completion of all construction. Areas to be fertilized include the entire critical root zone of a tree as depicted on the city approved plans. Trees are to be fertilized via soil injection method (minimum 100 psi), using doggett x-l injecto 32-7-7 or equivalent at recommended rates. construction that will be completed in less than 90 days should use material at 1/2 recommended rates. Alternative organic fertilizer materials are acceptable when approved by the city arborist.
- 2. All Trees are to be protected per the notes and details found on the approved Erosion and Sedimentation Control Plan
- 3. All Landscape trees shall also be used for mitigation credit (125") .
- 4. All trees to be professionally pruned to lift canopies 12 to 15' above existing grade to protect trees from accidental damage to canopies and to allow construction as needed.

.1	6	of	1.	Q
	U		÷	J

	ree Inven					
EE ST .G#		size	save	remove	mitigation req	
G# SCRI ION						
1 2	LIVE OAK	20 32.5	20 32.5		0	
- 3	LIVE OAK	23	23		0	
- 4 - 6	LIVE OAK	21	21		0	
- 0 - 6	LIVE OAK	27 18	27 18		0	
7	LIVE OAK	18	18		0	
) 9	LIVE OAK -m	29	29 22		0	
9 10	LIVE OAK	22 15	22 15		0 0	<u> </u>
11	LIVE OAK	21	21		0	
12 13	LIVE OAK	28	28 27		0	
13 14	LIVE OAK	27 17	27 17		0	
19	LIVE OAK	28	28		0	
20 21	LIVE OAK	26	28 25		0	
21 23	LIVE OAK	25 17	25 17		0	
24	LIVE OAK	20	20		0	
5	Live Oak	20	20		0	
27 28	LIVE OAK	26 39	26 39	0	0	
29	LIVE OAK	23	23		0	
30 24		21	21		0	
31 32	LIVE OAK	19 21	19 21	<u> </u>	0 0	
72 33	LIVE OAK	20	20		0	
34	LIVE OAK	20	20		0	
35 36	LIVE OAK LIVE OAK	21 16	21 16		0	
37 37	LIVE OAK	16 21	16 20	[0	
8	ELM	20	20		0	
39 14		18 00	20		0	
41 42	LIVE OAK -m	33 28	33 28		0	
3	LIVE OAK	29	29			A set of the set of
4	ELM	29	29			B
5 6	LIVE OAK	22 28.5	22 28.5		0	
1	LIVE OAK	20.5 21	20.5 0	21	0 21	
59	LIVE OAK	17	17		0	
62 63	LIVE OAK	14 18	0 0	14 18	7	
9	LIVE OAK	18 18	0	18 18	9 18	
	LIVE OAK	17	0	17	8.5	
		12	0	12	6	
	LIVE OAK	26 21	26 21		0	Н
79	LIVE OAK	28	28		0	
		26	26		0	
	LIVE OAK	11 23	11 0	0	0 23	
	LIVE OAK	8	0	8	4	
_		12	0	12	6	
	LIVE OAK LIVE OAK	8 216	0 26	8 0	4 0	
	LIVE OAK		20 19	0	0	
	CEDAR ELM		10		5	
_	LIVE OAK	8 11	8 11		4 5.5	
	LIVE OAK		11 10		5.5 5	
	LIVE OAK	11	11		5.5	
			9		4.5	
	LIVE OAK LIVE OAK		8 0	12	4 6	
	LIVE OAK -m				1 9.5	
	LIVE OAK -m				9.25	
_	LIVE OAK -m			8 12	4 6	
	LIVE OAK		_		6	

1365" 210" 1151" 190.75" 143" 47.75" \$9500

\$9500

construction.

	SITE PLAN RELEASE Sheet <u>21 of 24</u>
FILE NUMBER: SPC-2014	-0467C EXPIRATION DATE:
CASE MANAGER: CHRISTINE	BARTON-HOLMES APPLICATION DATE: NOV. 19, 2014
	ELY ON:
	COMMISSION ON:
APPROVED BY CITY COUN	ICIL ON:
onder Section	on Chapter of the Austin City Code.
·····	
••• · · · · · · · · · · · · · · · · · ·	
Signing for Director, Pla	anning and Development Review Department
DATE OF RELEASE:	of Zoning: <u>GR & CS-1</u>
DATE OF RELEASE:	anning and Development Review Department of Zoning: <u>GR & CS-1</u> Correction 1
DATE OF RELEASE: Rev. 1	of Zoning: <u>GR & CS-1</u> Correction 1
DATE OF RELEASE; Rev. 1 Rev. 2	of Zoning: <u>GR & CS-1</u> Correction 1 Correction 2
DATE OF RELEASE; Rev. 1 Rev. 2 Rev. 3	of Zoning: <u>GR & CS-1</u> Correction 1 Correction 2 Correction 3
DATE OF RELEASE: Rev. 1 Rev. 2 Rev. 3 RELEASE OF THIS APPLIC	of Zoning: <u>GR & CS-1</u> Correction 1 Correction 2 Correction 3 CATION DOES NOT CONSTITUTE A VERIFICATION OF A
DATE OF RELEASE: Rev. 1 Rev. 2 Rev. 3 RELEASE OF THIS APPLIC DATA. INFORMATION AN	of Zoning: <u>GR & CS-1</u> Correction 1 Correction 2 Correction 3 CATION DOES NOT CONSTITUTE A VERIFICATION OF A ID CALCULATIONS SUPPLIED BY THE APPLICANT. THE
DATE OF RELEASE: Rev. 1 Rev. 2 Rev. 3 RELEASE OF THIS APPLIC DATA. INFORMATION AN ENGINEER OF RECORD	of Zoning: <u>GR & CS-1</u> Correction 1 Correction 2 Correction 3 CATION DOES NOT CONSTITUTE A VERIFICATION OF A

AT CAPE ECTS LLC nosha Pass exas 573. 2051 2014 ယ 28 Texas Austin,

REASON

CITY

CITY COMMENTS

07.26 CITY COMMENTS 08.17.2015 **CITY COMMENTS** 10/02/2015 CITY COMMENTS

PROJECT PHASE revie\ PROJECT TEAM ds SHEET CONTENTS

Tree Mitigation Plan

21 of 24


SPC-2014-0467C


SHEET NO.


⊕ ^{2@'} -8" AFF				(-4)
Ф <u>13'-@" дрг</u> 				
⊕@'- <i>©</i> " AFF				
Ψ	WINDOW AS PER SCHEDU	ILE TYP	IT STONE VENEER T	

⊕ ^{20'-8" AFF.}		Ţ	-) ATA
⊕ ^{13'-} @" <u>A</u> FF	STUCCO TYP.	EXPANSION JOINT BEHIND DOWNSPOUT TYP.	
Ψ			

1997 - 1997 - 1997 - 1997 - 1997 - 1997 - 1997 - 1997 - 1997 - 1997 - 1997 - 1997 - 1997 - 1997 - 1997 - 1997 -

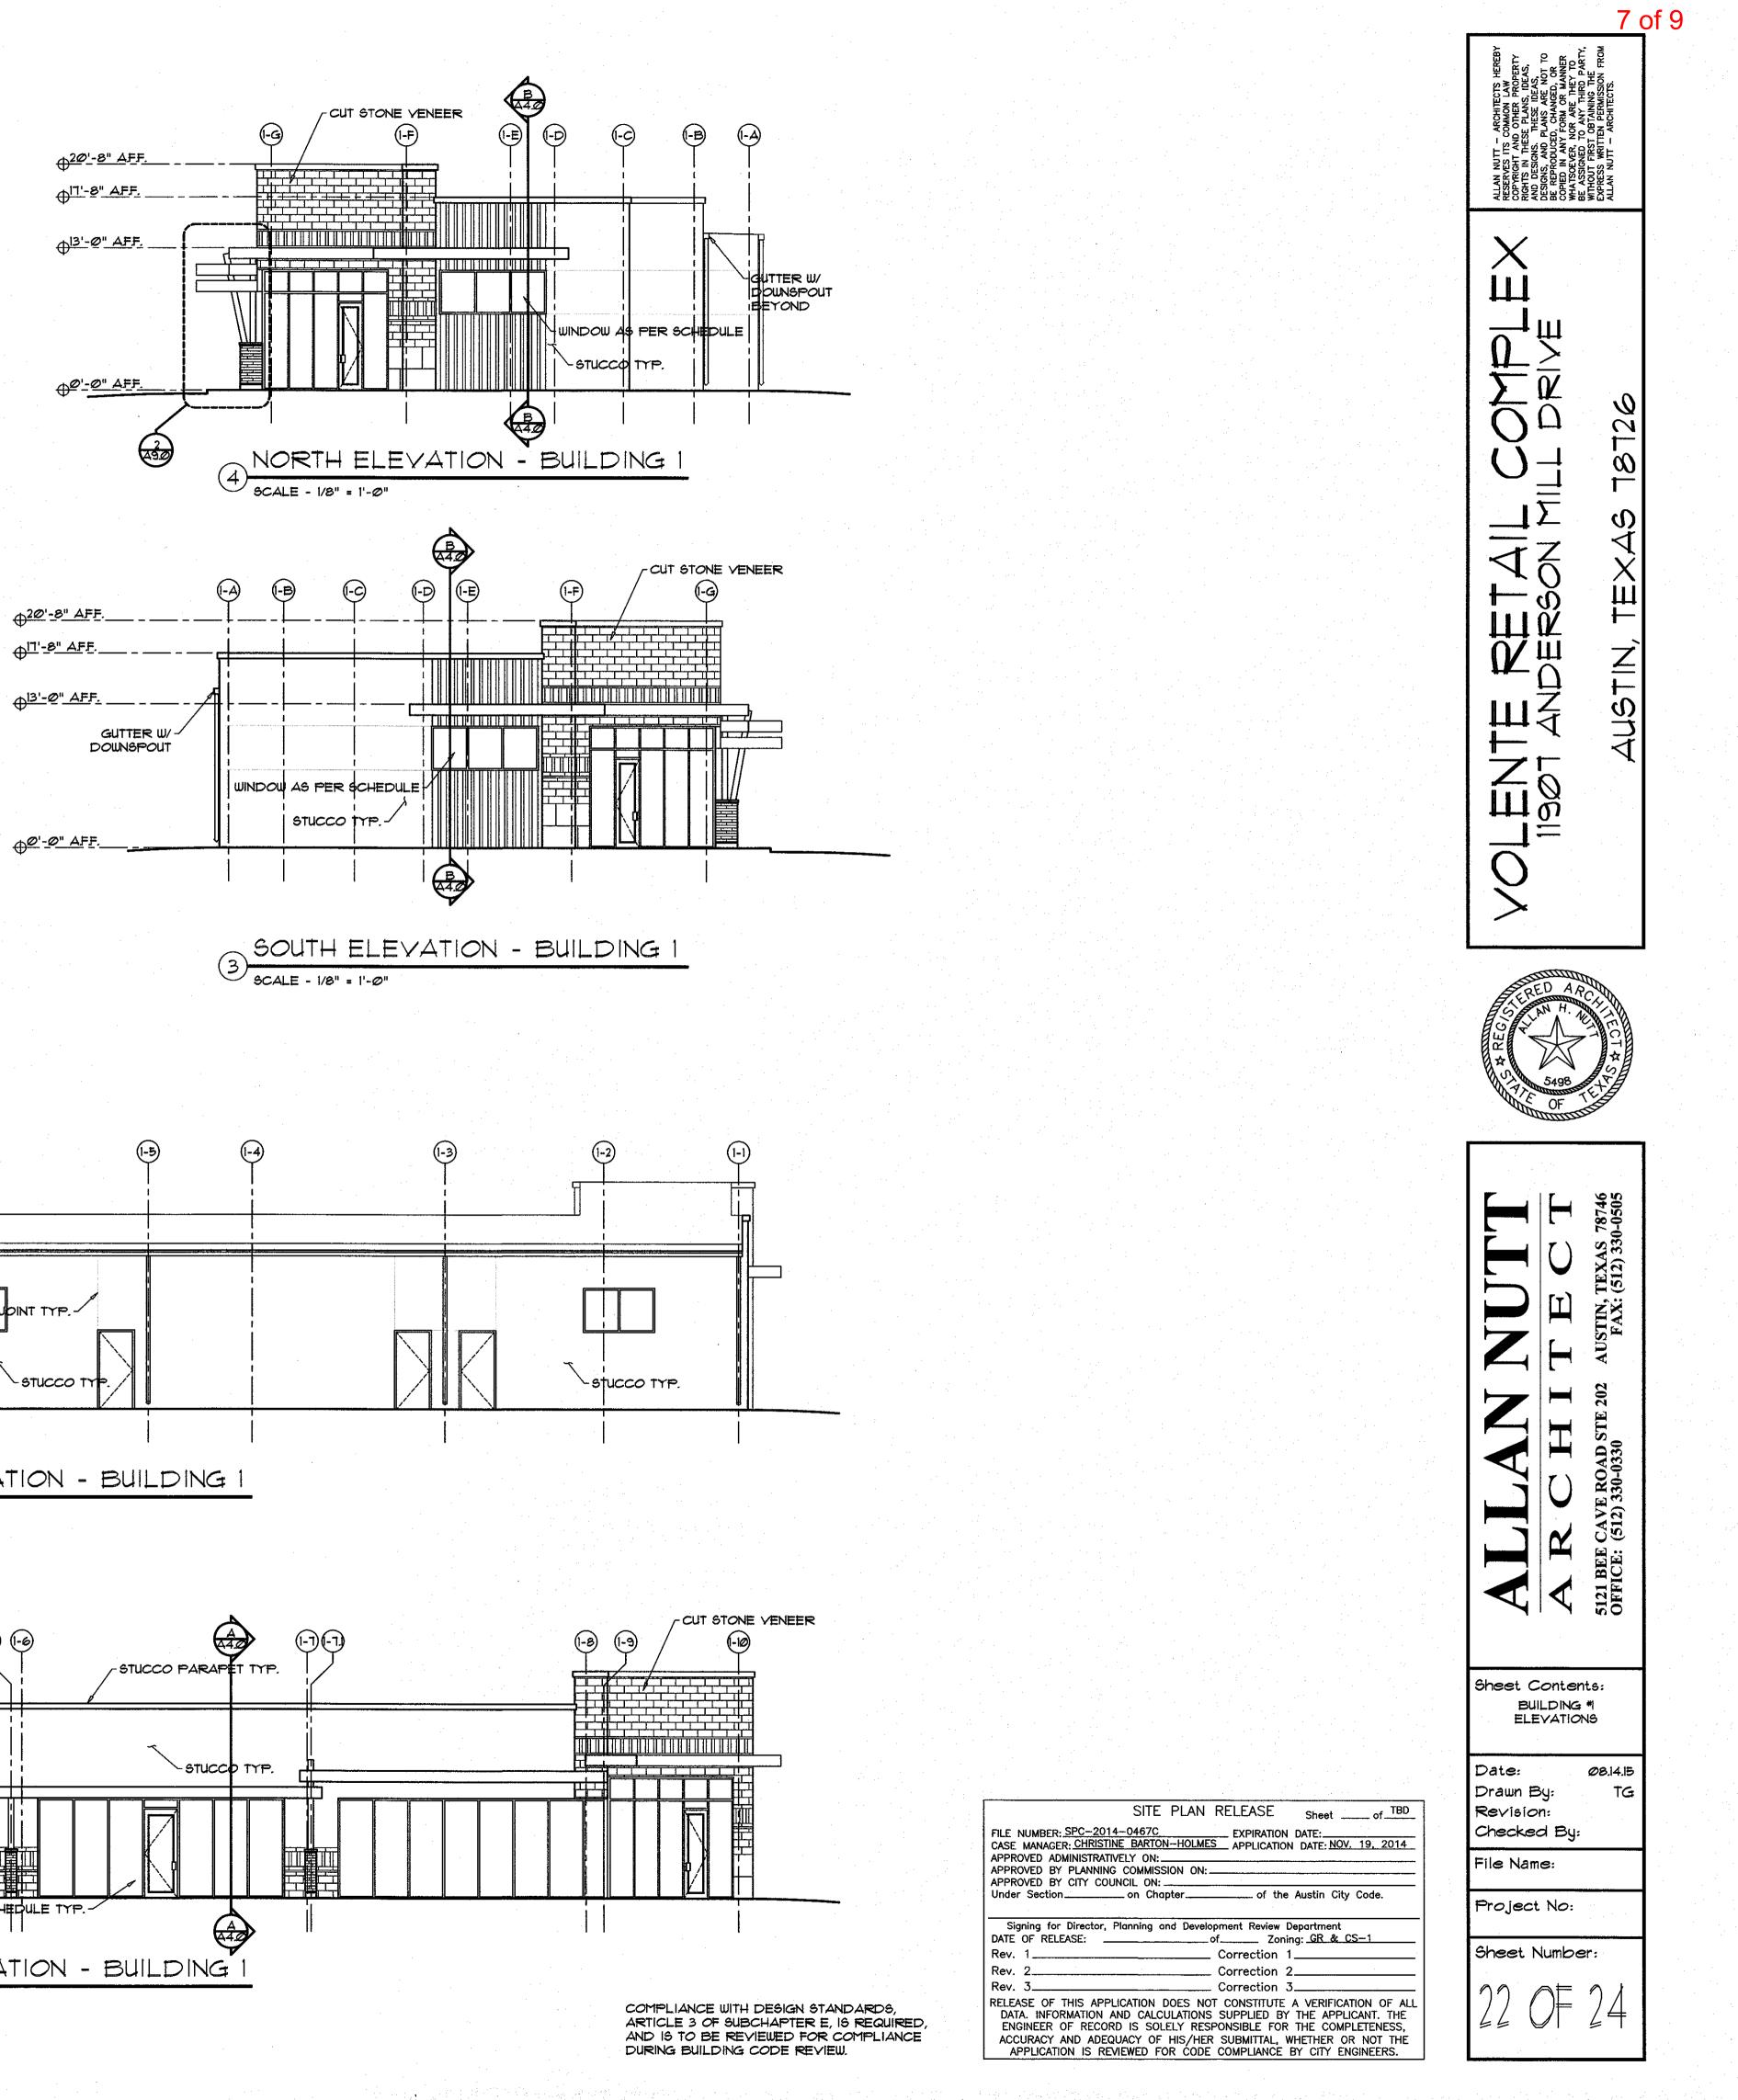

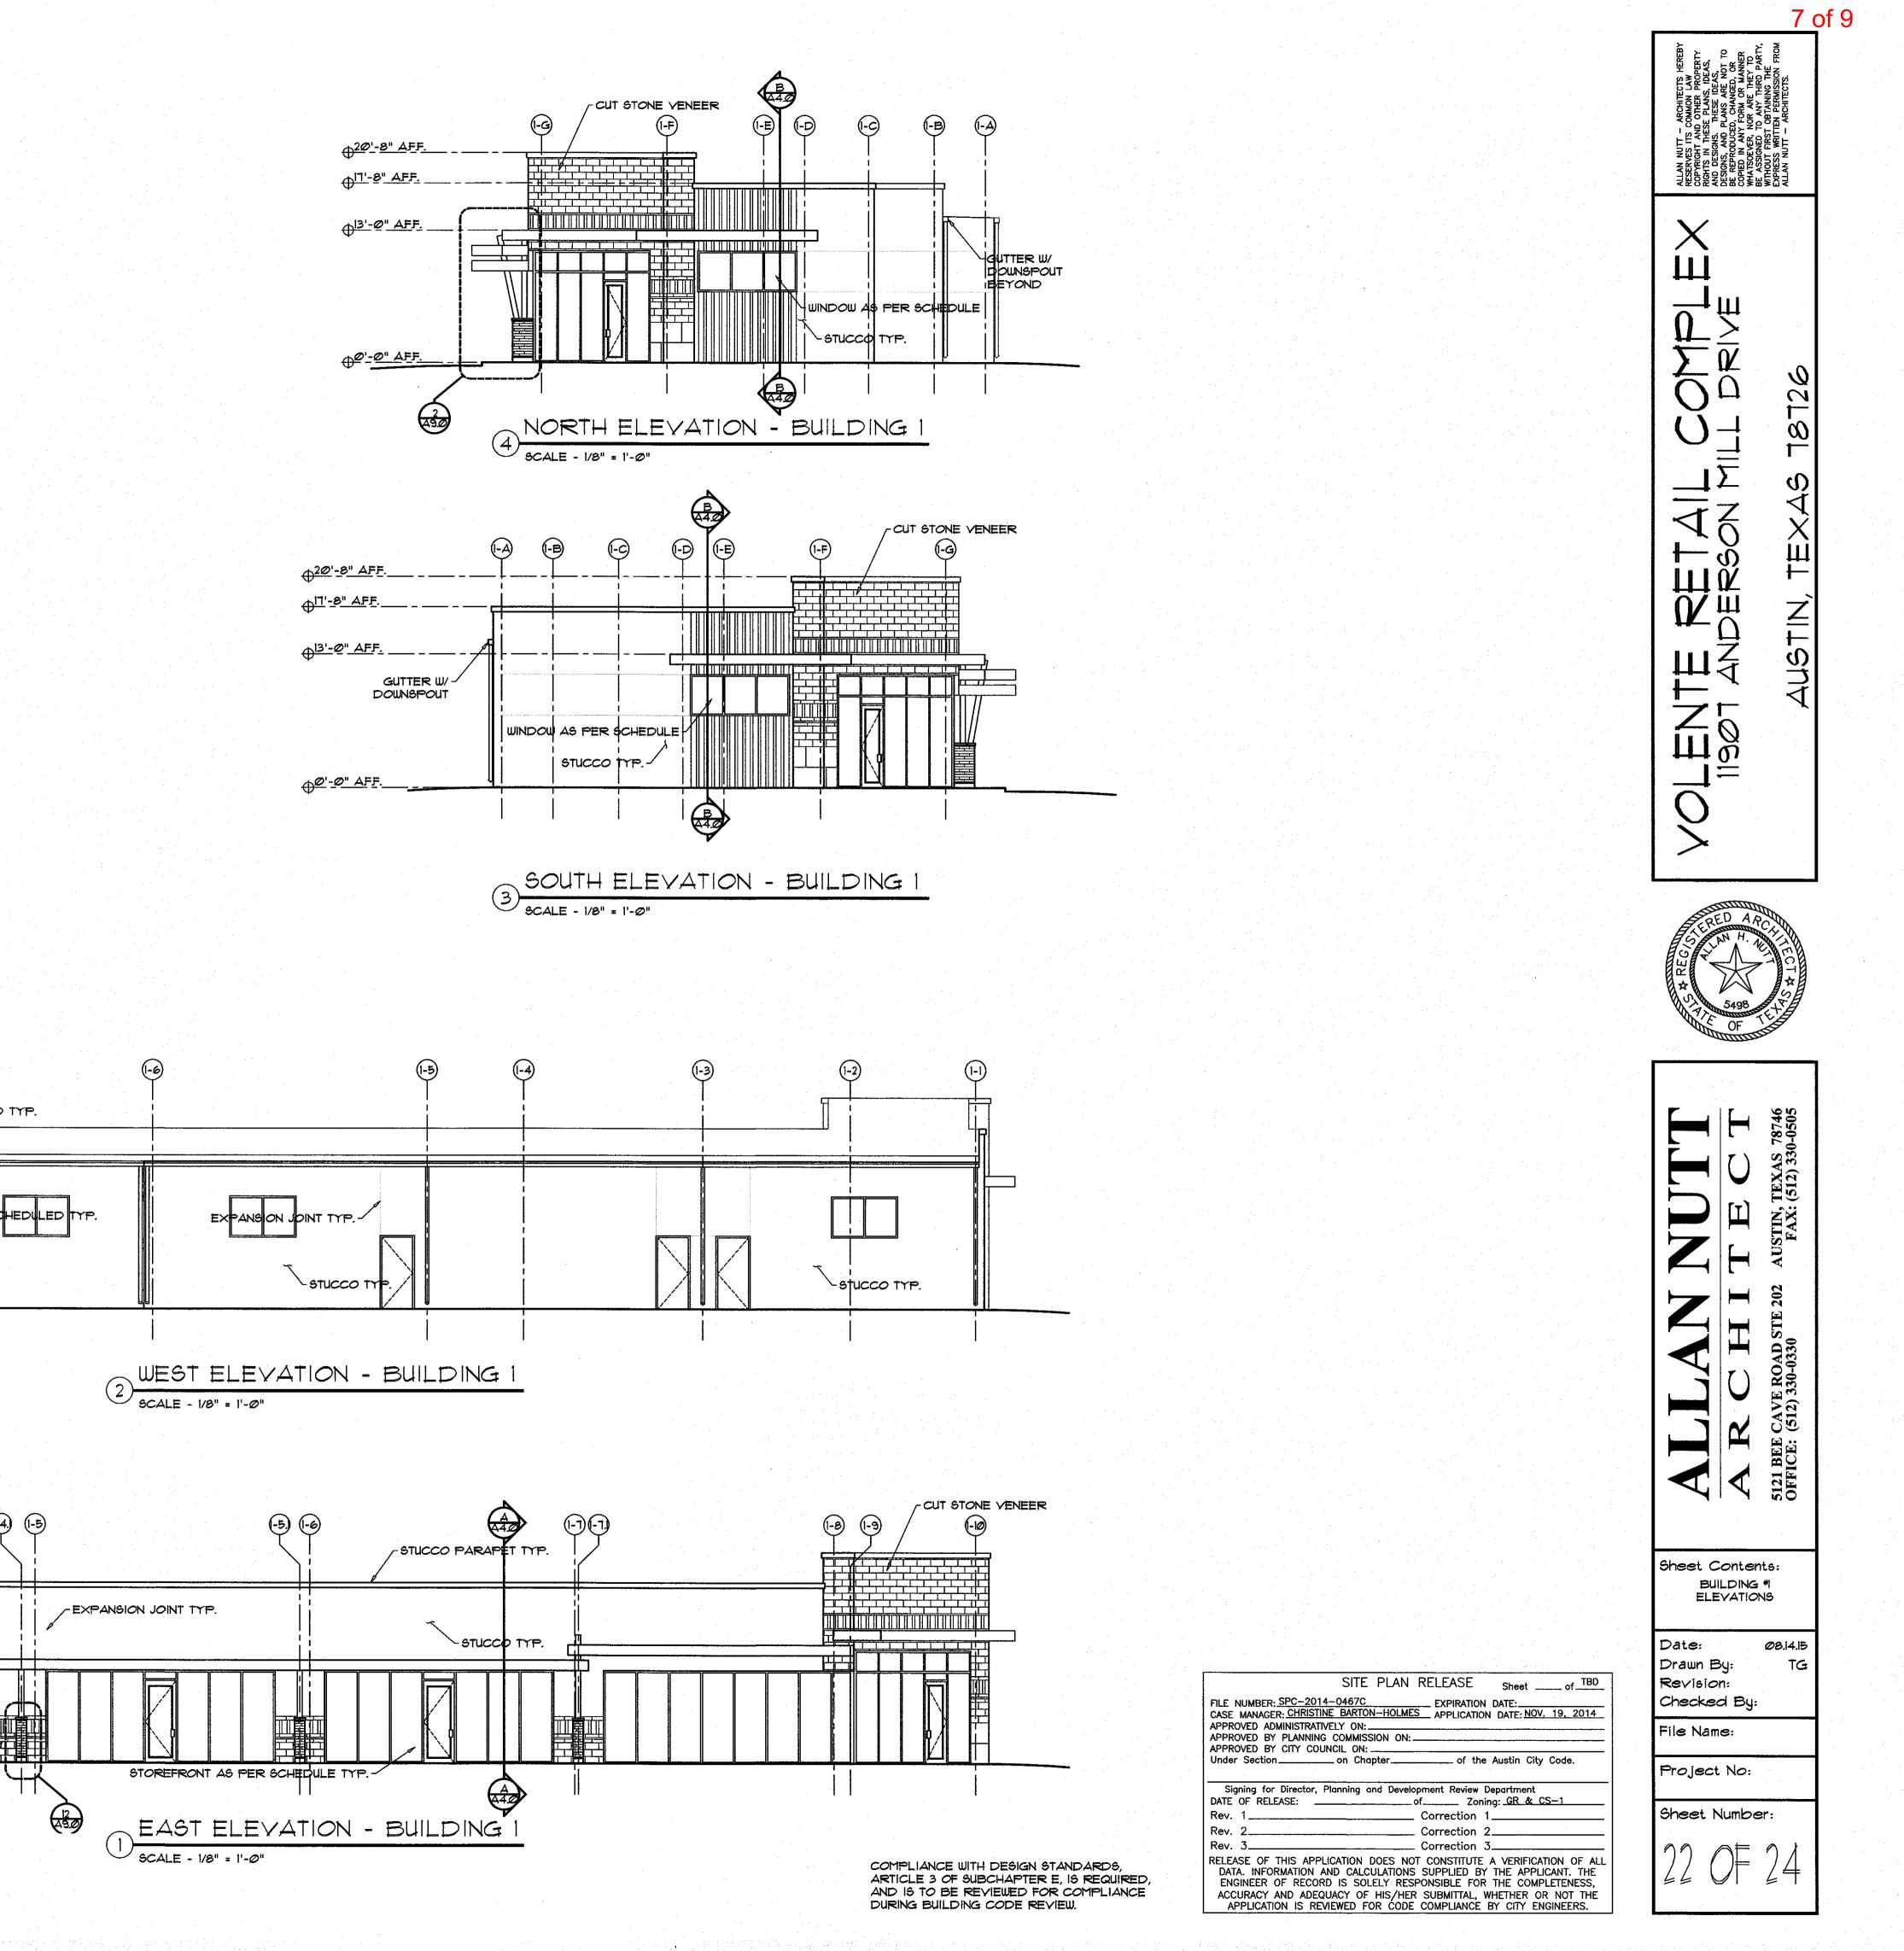

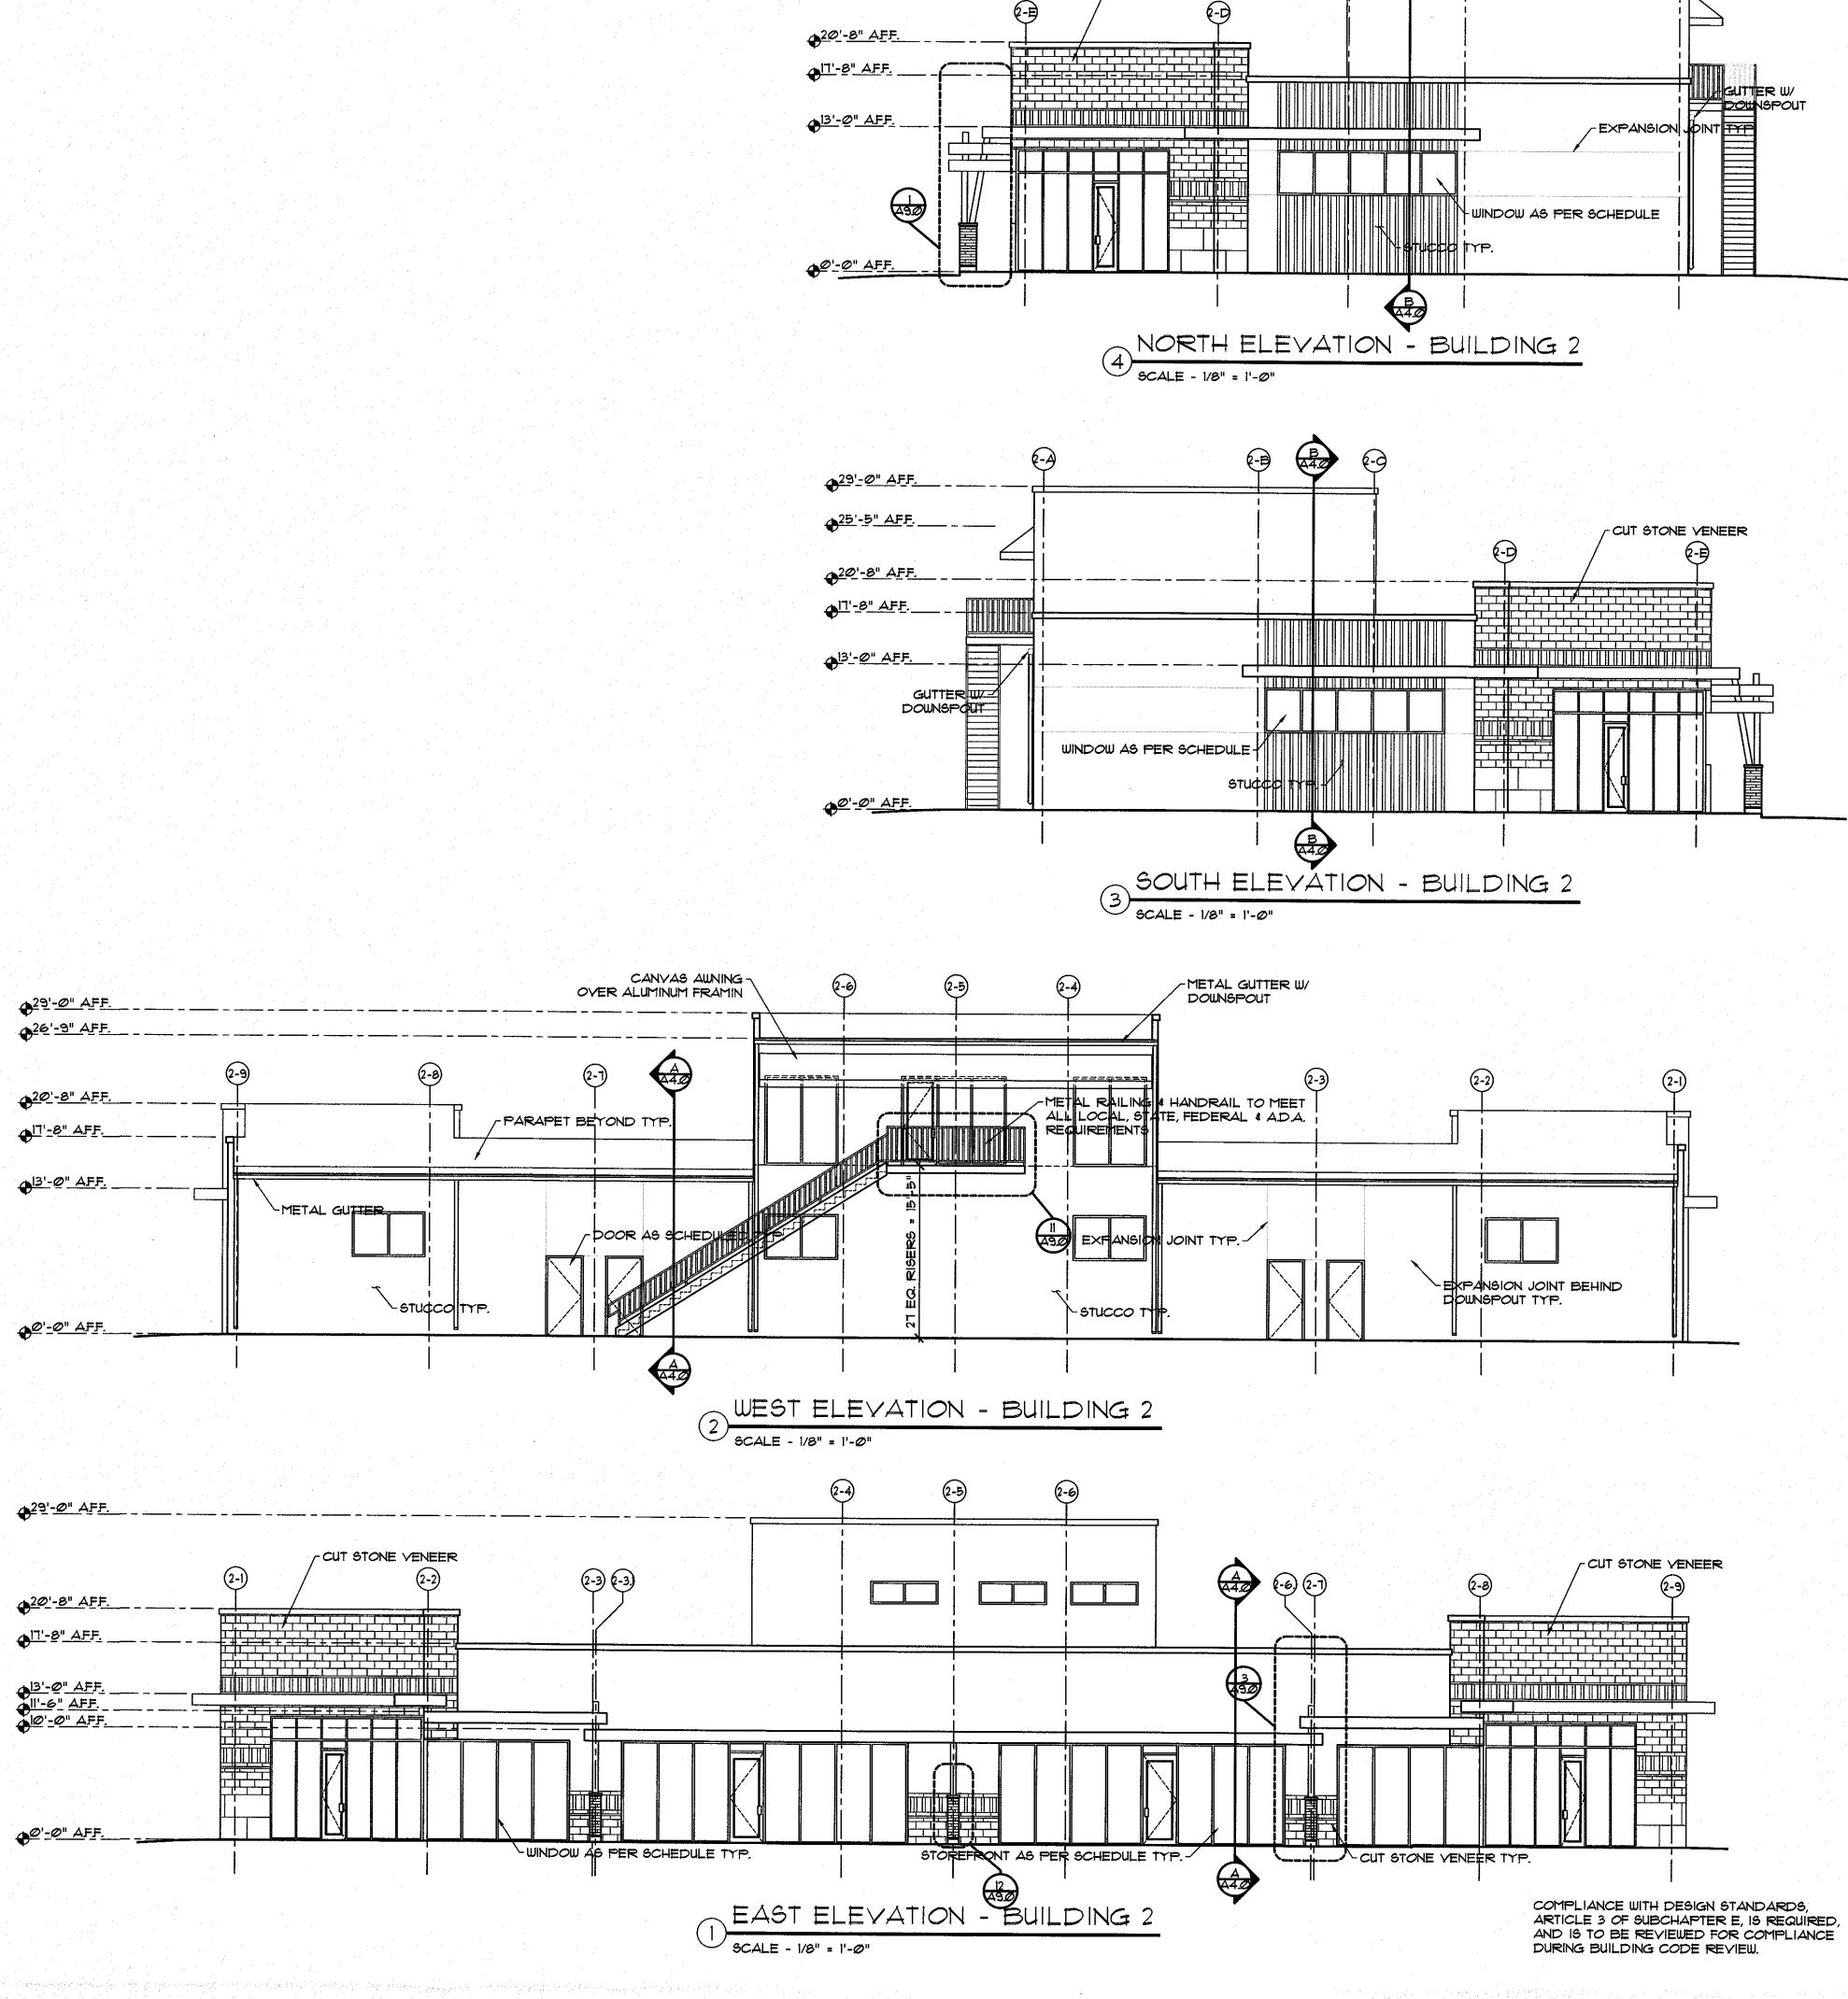

(-B)

(-)

e-9

CUT STONE VENEER

	· · · ·		
	- CUT S	TONE VENEER	
	(2-1)	(2-2)	(2-
•20'-8" AFF.		Ť	T T
€ ^{II'-8"} AFF			
0 ^{13'-0" AFF} 11'-6" AFF 10'-0" AFF			
00'-0" AFF		<mark>╴╷╶╷╴╷</mark> ╶┠──╂╶╴╫┲╕┫── ╶┠──╂╺╴╢┲╕┛	
<u> </u>			
V			-WINDOW A

8 of 9 ALLAN NUTT – A RESERVES ITS CC COPYRIGHT AND O RIGHTS IN THESE AND DESIGNS. AND PL DESIGNS, AND PL DESIGNS, AND PL DESIGNS, AND FL DESIGNS, AN Х \mathbf{n} Ø ₩ ~ ~ <mark>ЮХ</mark>Ш ШЙ P/E OF TE 8746 0505 **TEXAS** (512) 33 AX: Z E RO 330-CAVI (512) K 5121 BEE OFFICE: Sheet Contents: BUILDING 2 ELEVATIONS Date: Ø8.14,15 Drawn By: TG SITE PLAN RELEASE Sheet _____ of _____ Revision: Checked By: FILE NUMBER: SPC-2014-0467C EXPIRATION DATE: CASE MANAGER: CHRISTINE BARTON-HOLMES APPLICATION DATE: NOV. 19, 2014 APPROVED ADMINISTRATIVELY ON: File Name: APPROVED BY PLANNING COMMISSION ON: . APPROVED BY CITY COUNCIL ON: Under Section _____ on Chapter _____ _____ of the Austin City Code. Project No: Signing for Director, Planning and Development Review Department DATE OF RELEASE: of_____ Zoning: <u>GR & CS-1</u> Sheet Number: Correction Rev. 2. Correction 2 Rev. 3... Correction RELEASE OF THIS APPLICATION DOES NOT CONSTITUTE A VERIFICATION OF ALL DATA. INFORMATION AND CALCULATIONS SUPPLIED BY THE APPLICANT. THE ENGINEER OF RECORD IS SOLELY RESPONSIBLE FOR THE COMPLETENESS, 49 ACCURACY AND ADEQUACY OF HIS/HER SUBMITTAL, WHETHER OR NOT THE APPLICATION IS REVIEWED FOR CODE COMPLIANCE BY CITY ENGINEERS.

⊕^{19'}-4" AFF._____ 0^{16'-4"} AFF.____ ⊕^{13'}-Ø"_<u>AFF.</u>____

⊕^{@'}-<u>@" A</u>FF.____

<u>_20'-8" AFF.____</u> ⊕^[]-8"_<u>AFF.</u>_____ 013'-@"_AFF.____ 011'-6"_AFF._____ 010'-0"_AFF.____

3-1)

3-1

CUT STONE VENEER 3-3 ┑╫╷╴┎┶┯┷╸┶┰┶┯┶┑╴╫╴┑┍┯╗╸┾╶╫╖ ╕╫╷╧╤╦╴╴┹╷╧╦╧╕┸╶┺╬╬╴┹╷╧╦╄╴┺╷╫╢╴

WINDOW AS PER OCHEDULE TYP.

-STUCCO TYP.


6-9

6-19


6-3

DOOR AS SCHEDULED TY

8-4 6-4 5 A30

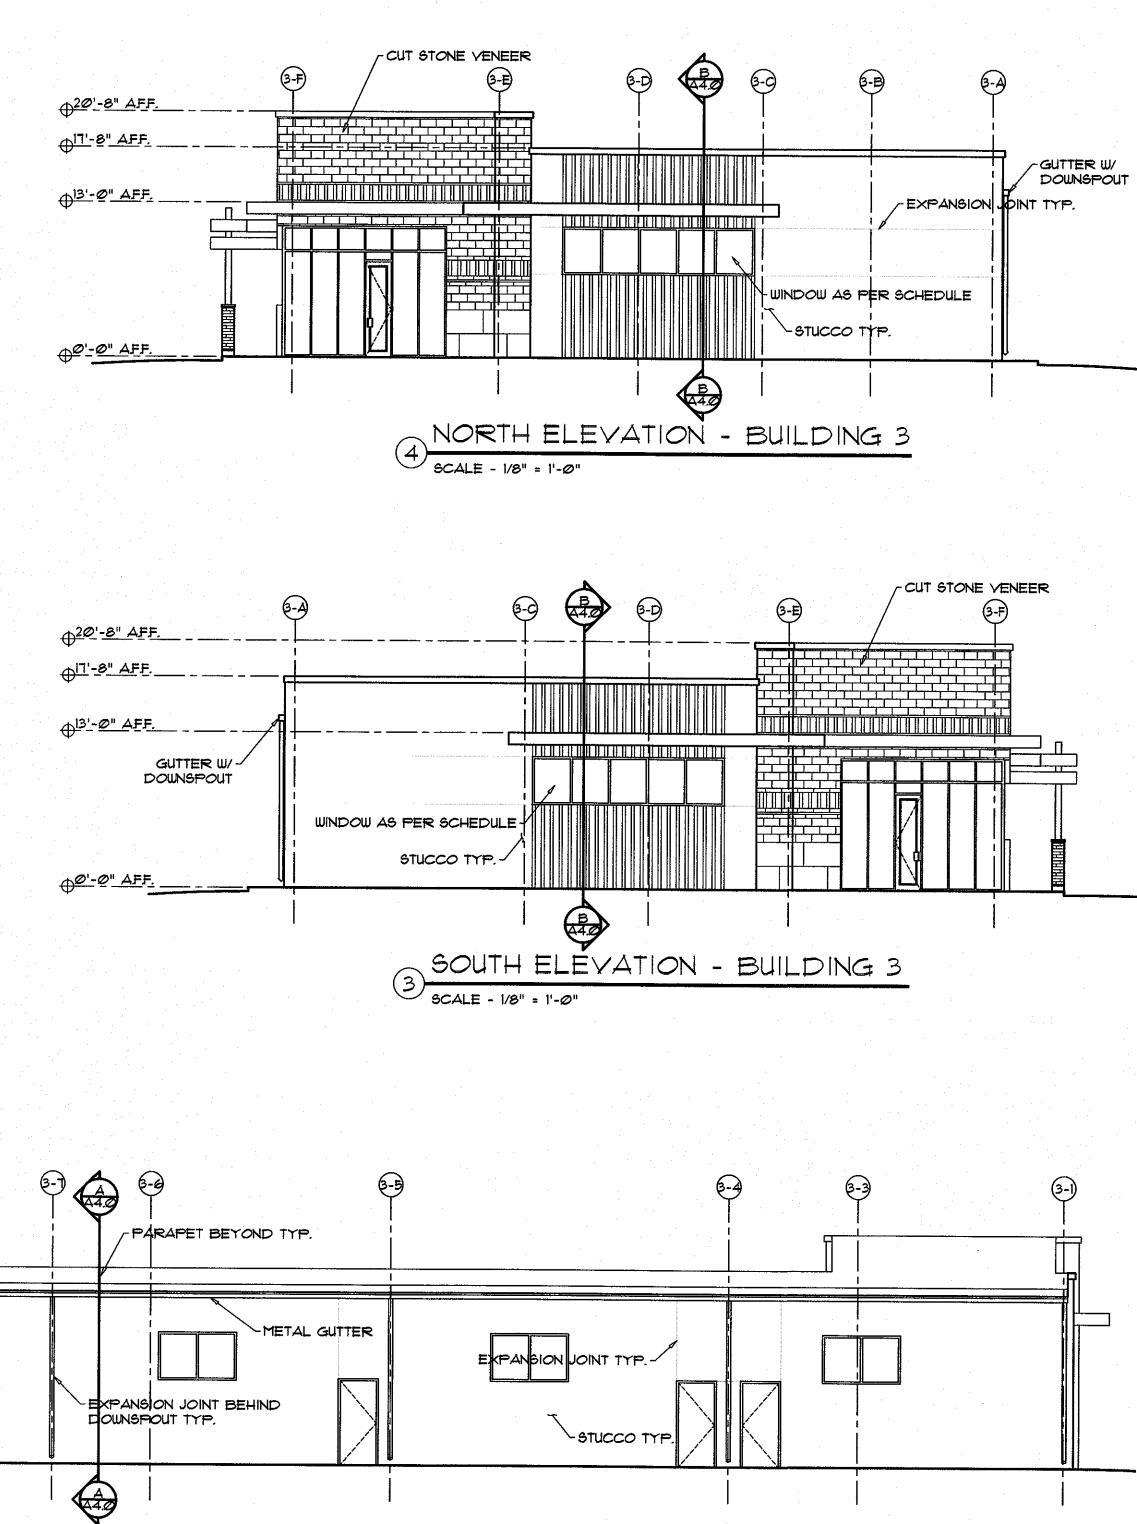

WEST ELEVATION - BUILDING 3 ' SCALE - 1/8" = 1'-@"

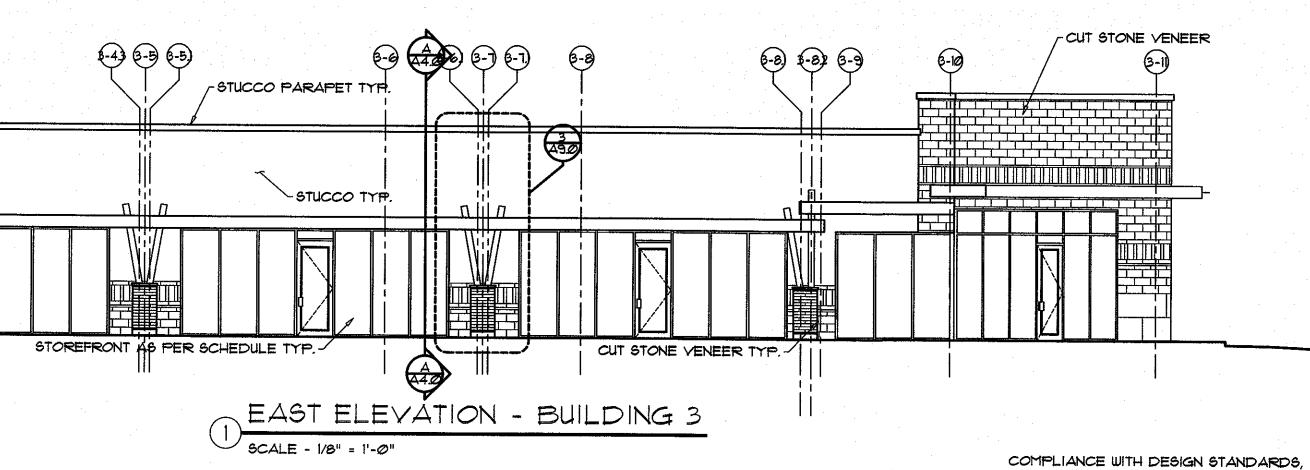

ARTICLE 3 OF SUBCHAPTER E, IS REQUIRED, AND IS TO BE REVIEWED FOR COMPLIANCE DURING BUILDING CODE REVIEW.

9 of 9 ALLAN NU RESERVES COPYRIGHI RIGHTS IN AND DESIG BE REPRIS, I WHATSOEVS, I WHATSOEV WITHOUT F ALLAN NU X $\overline{\mathbf{U}}$ $\overline{\mathbf{V}}$ $\overline{\mathbf{U}}$ $\overline{\mathbf{$ N Ŭ Ø S \leq ₩-ŏ Ш NDER ANDER Z ⊢ 4US OF THE - 45 AX: 7 RO-RO- \smile CAV (512) K 5121 BEE OFFICE: Sheet Contents: BUILDING *3 ELEVATIONS Date: Ø8.14.15 Drawn By: TG SITE PLAN RELEASE Sheet _____ of TBD Revision: FILE NUMBER: SPC-2014-0467C EXPIRATION DATE: CASE MANAGER: CHRISTINE BARTON-HOLMES APPLICATION DATE: NOV. 19, 2014 Checked By: APPROVED ADMINISTRATIVELY ON:_____ APPROVED BY PLANNING COMMISSION ON:____ File Name: APPROVED BY CITY COUNCIL ON: Under Section_____ on Chapter_____ of the Austin City Code. Project No: Signing for Director, Planning and Development Review Department DATE OF RELEASE: _of____ Zoning: <u>GR & CS-1</u> Sheet Number: Rev. Correction 1 Rev. Correction 2 Rev. Correction 3 RELEASE OF THIS APPLICATION DOES NOT CONSTITUTE A VERIFICATION OF ALL DATA. INFORMATION AND CALCULATIONS SUPPLIED BY THE APPLICANT. THE • 4 ENGINEER OF RECORD IS SOLELY RESPONSIBLE FOR THE COMPLETENESS, ACCURACY AND ADEQUACY OF HIS/HER SUBMITTAL, WHETHER OR NOT THE APPLICATION IS REVIEWED FOR CODE COMPLIANCE BY CITY ENGINEERS.