







SPEC SS STD STL STOR STR STRUCT SUSP SYM structural suspended symmetrical tongue & groove top of concrete top of steel temporary tempered to match existing top of unless noted otherwise vapor barrier vinyl compostion tile vertical verify in field without watercloset watercloset wood window waterproof weight waste water spring hinge

standard steel

structural or stair





SYMBOLS LEGEND

VISITABILITY REQUIREMENTS

DRAWING INDEX

GENERAL INFORMATION SITE PLAN DEMOLITION PLAN A0-01 A0-02 A1-00 A1-01 A1-02 A1-03 A1-04 A1-05 A2-01 A2-02 A6-01 FLOOR PLAN FLOOR PLAN ROOF PLAN REFLECTED CEILING PLAN REFLECTED CEILING PLAN ELEVATIONS DETAILS DOOR & WINDOW INFORMATION



DECEMBER 11, 2015

FEATHERSTON | STUDIO IIc

p.o. box 170024 austin, texas 78717

ph: 512 740 4234

NICOLE KESSLER **GASTON REMODEL**

1605 GASTON AVE. AUSTIN, TEXAS 78703

DESCRIPTION

PERMIT DRAWINGS

PROJECT NUMBER

20150720

DATE

GENERAL INFORMATION

SHEET NUMBER

NOTE; STANDARD SHEET SIZE IS 22x34; SETS REPRODUCED ON 11x17 WIL BE AT HALF SCALE. (EX. DRAWINGS SHOWN AT 1/8" = 1²-0" WILL SCALE AT 1/16" = 1²-0"

IMPERVIOUS COVER

EXISTING 1st FLOOR: EXISTING FRONT PORCH: EXISTING FRONT SIDEWALK(s): 1,945 SQFT 252 SQFT 2,882 SQFT 398 SQFT 36 SQFT 150 SQFT EXISTING DRIVEWAY(s): EXISTING REAR SIDEWALK(s): 5,785 **S**QFT 51.65% EXISTING IMPERVIOUS COVER NEW 1st FLOOR: FRONT PORCH: FRONT SIDEWALK(s): 251 SQFT 1,245 SQFT 262 SQFT 191 SQFT REAR PATH(s)

4,505 SQFT

GENERAL NOTES

distribution power lines. Enforced by AE and NESC codes-this review DOES NOT include transmission power lines.

TO EXISTING FACE OF WA

All structures must maintain

7'6" clearance from AE energized

NEW SIDEWALK

NEW LANDSCAPED PATH

B' - B 1/2" TO FACE OF WALL

5' - 0"

THE DRAWINGS GENERALLY DESCRIBE THOSE PORTIONS OF THE EVISTING THE DRAWINGS GENERALLY DESCRIBETHOSE PORTIONS OF THE EXISTING CONDITIONS WHICH ARE TO BE REMOVED; THESE DRAWINGS DO NOT NECESSARILY DESCRIBE ALL DEMOLITION THAT WILL BE REQUIRED IN ORDER TO CONSTRUCT THE NEW WORK THE CONTRACTOR SHALL BE RESPONSIBLE FOR THE DEMOLITION OF ALL PORTIONS OF THE EXISTING CONDITIONS IN RECESSARY TO CONSTRUCT AND COORDINATE WITH THE NEW WORK SHOWN ON THE DRAWINGS, IF UNCERTAIN WHETHER AN EXISTING ELEMENT IS TO BE REMOVED, CONTACT ARCHITECT OR OWNER BEFORE PROCEEDING.

UNLESS NOTED OTHERWISE, NUMERICAL DESIGNATIONS IN THE DRAWINGS ARE NOT INTENDED TO IMPLY SEQUENCE OF CONSTRUCTION OR DEMOLITION.

BASED ON THE CONTRACTOR'S "MEANS AND METHODS" FOR CONSTRUCTION, CONTRACTOR SHALL DETERMINE INTERMEDIATE STACING AND SEQUENCING OF THE DEMOLITION, TEMPORARY WORK AND NEW WORK TO ENSURE CONTINUOUS AND SAFE OCCUPATION OF EXISTING FACILITIES.

THE CONTRACTOR SHALL MAKE PROVISIONS FOR ALL DEMOLITION AND

THE CONTRACTOR SHALL MAKE PROVISIONS FOR ALL DEMOLITION AND CONSTRUCTION PROCESSES TO TAKE PLACE IN A MANNER SO AS NOTTO AFFECT THE NORMAL OPERATION OF THE BUILDING.
ALL LIFE SAFETY SYSTEMS, EXTIN AND SERVICES ARE TO BE MAINTAINED THROUGHOUT DEMOLITION AND CONSTRUCTION WORK, IF THE CONTRACTOR PROPOSES TO INTERRUPT THE LIFE SAFETY SYSTEMS, EXITING, THE CONTRACTOR IS REQUIRED TO PROVIDE TEMPORARY SECURITY AND/OR FIRE PROTECTION SERVICES DURING THE

SECURITY AND/OFF HE PROTECTION SERVICES DURING THE INTERRUPTION IN ACCORDANCE WITH THE REQUIREMENTS OF THE OWNER AND LOCAL JURISDICTION OF CODE ENFORCEMENT. MAINTAIN AND PROTECT THE GENERAL PUBLICS CIRCULATION PATHS AND EXITING FROM BUILDING DURING DEMOLITION AND CONSTRUCTION. OBTAIN APPROVAL FOR ALL TEMPORARY WALKWAY/EXITS FROM LOCAL INVESTIGATION. JURISDICTION OF CODE ENFORCEMENT.

NOTIFY OWNER PRIOR TO COMMENCEMENT OF ALL FLECTRICAL MECHANICAL, PLUMBING AND FIRE PROTECTION WORK, OBTAIN OWNER'S AUTHORIZATION 72 HOURS IN ADVANCE FOR ANY DISRUPTION OF SERVICES, IN NO CASE SHALL DISRUPTION OF SERVICES OCCUR IN

OWNER OCCUPIED AREAS.
CONTRACTOR TO INFORM ARCHITECT IF THERE ARE ANY UNFORESEEN STRUCTURAL MEMBERS, MISCELLANEOUS OBJECTS OR UNIDENTIFIED

STRUCTURAL MEMBERS, MISCELLANEOUS OBJECTS OR UNIDENTIFIED UTILITY DIMES FOUND DUBLING DEMOLITION WORK. ALL DEMOLITION WORK AFFECTING ADJACENT SPACES/BUILDINGS, OR OTHER OCCUPIED PORTIONS OF THE BUILDING MUST BE COORDINATED WITH THE OWNER. NO WORK MAY BE DONE WITHOUT PRIOR AUTHORIZATION FROM THE OWNER.

AUTHORIZATION FROM THE OWNER.
CONTRACTOR SHALL MEET WITH OWNER FOR PRE-DEMOLITION
CONSTRUCTION MEETING TO COORDINATE EXTENT OF DEMOLITION
CONSTRUCTION DETAILS, AND TIMING WITH BUILDING OPERATIONS,
PRIOR TO START OF WORK.
ALL SALVAGE MATERIALS SELECTED BY THE OWNER SHALL BE PROTECTED
AND STORED IN OWNER SELECTED LOCATION.
TEMPORARY ENCLOSURES WILL BE SECURE AND STRUCTURALLY SOUND.

ALL ITEMS WHICH ARE DESIGNATED FOR RE-USE/RE-INSTALLATION WILL BE CAREFULLY REMOVED AND LABELED, CLEANED, PACKAGED/MAPPED FOR PROTECTION, AND STORED IN OWNER'S DESIGNATED STORAGE AREA UNTIL NEEDED FOR PRINTALLATION.
"PROPER DISPOSAL" INCLUDES RECYCLING/RECLAIMATION AS DIRECTED

BY OWNERSHIP AND/OR AS AVAILABLE LOCALLY AND/OR VIA ASSOCIATED VENDORS AND MANUFACTURERS PROGRAMS.
CONTRACTOR IS RESPONSIBLE FOR FIRE ALARM, PULLS, STROBES, AND

AE APPROVED DEC 2 1 2015 355-204

JGM

DECEMBER 11, 2015

FEATHERSTON | STUDIO IIC

p.o. box 170024 austin, texas 78717

ph: 512 740 4234

NICOLE KESSLER **GASTON REMODEL**

1605 GASTON AVE. AUSTIN, TEXAS 78703

DESCRIPTION

PERMIT DRAWINGS

PROJECT NUMBER

SITE PLAN

DATE

20150720

SHEET NUMBER

SITE PLAN - EXISTING

DEMOLITION NOTES

- THIS DEMOLITION PLAN REFLECTS GRAPHIC AND WRITTEN INFORMATION CONCERNING THE EXISTING SPACE, THIS IS INCLUDED AS "INFORMATION ONLY" REPRESENTING AVAILABLE RECORD INFORMATION OF THE ORIGINAL DRAWINGS PLUS FIEL NOTATIONS. THIS INFORMATION IS FOR THE CONTRACTOR'S USE AS HE SEES FIT. CONTRACTOR SHALL FIELD VERIFY ALL EXISTING CONDITIONS AND DETERMINE THE SCOPE OF WORK REQUIRED, THE CONTRACTOR SHALL ALSO EXAMINE THE EXISTING BUILDING AND WORK SHOWN BY ALL CONTRACT DOCUMENTS TO DETERMINE THE SCOPE OF DEMOLITION REQUIRED, WHETHER SPECIFICALLY SHOWN OR NOT.
 THE CONTRACTOR SHALL NOTIFY THE ARCHITECT IMMEDIATELY IF
- ANY WORK INDICATED IN THE CONTRACT DOCUMENTS CANNOT BE PERFORMED DUE TO THE EXISTING CONDITIONS.
- DEMOLITION WORK SHALL BE EXECUTED IN CONFORMANCE WITH ALL CODES AND ORDINANCES AS SET FORTH BY ALL GOVERNING AUTHORITIES. DEMOLITION IS TO BE DONE IN A CAREFUL AND ORDERLY MANNERS O. AS NOT TO DAMAGE FINISHES OR EQUIPMENT TO REMAIN.
- IF ANY FIREPROOFING OR FIRE ASSEMBLIES WHICH ARE INDICATED TO REMAIN ARE DAMAGED DURING DEMOLITION, THEY SHALL BE REPAIRED TO CONFORM TO ORIGINAL FIRE PROTECTION REQUIREMENTS. THE CONTRACTOR SHALL VERIFY THAT EXIT EGRESS IS MAINTAINED
- PER CODE FOR ALL OCCUPIED AREAS OF THE BUILDING THROUGHOUT CONSTRUCTION AND DEMOLITION.
- ALL WORK SHALL BE FERFORMED IN THE BEST WORKMANSHIP POSSIBLE IN ACCORDANCE WITH HIGHEST TRADE STANDARDS. CONTRACTOR IS RESPONSIBLE FOR DEMOLISHING AND REMOVING FROM THE PREMISES ALL WORK NECESSARY TO ACCOMPLISH SCOPE OF WORK.
- CONTRACTOR SHALL ARRANGE FOR SHUT OFF OF EXISTING
- CONTRACTION SHALL ARRANGE FOR SHUT OFF OF EXISTING UTILITIES AND ARRANGE FOR ALL TEMPORARY POWER NECESSARY. THE EXISTING BUILDING ENVELOPE SHALL BE MAINTAINED IN A WATER TIGHT CONDITION AT ALL TIMES DURING DEMOLITION. PROTECT ALL EXISTING STRUCTURE, SYSTEMS, FINISHES AND
- GENERAL CONDITIONS THAT ARE TO REMAIN THROUGHOUT THE COURSE OF THE WORK TO PREVENT DAMAGE OR LOSS, ANY SUCH DAMAGE CAUSED DURING THE COURSE OF THIS WORK WILL BE REPAIRED AT THE CONTRACTOR'S EXPENSE BEFORE THIS WORK IS
- PRIOR TO INTERRUPTING OR OTHERWISE AFFECTING ANY SUCH PRIGHT TO INTERROPITING OR OTHERWISE AFFECTING ANY SUCH OPERATING SYSTEM, UTILITY OR SERVICE, CONTRACTOR SHALL CONSULT WITH OWNER'S REPRESENTATIVE TO ESTABLISH A MUTUALLY SATISFACTORY SCHEDULE FOR CUT OVER, CUT OFF DISRUPTION OR OTHER CHANGE IN OPERATING OF THE AFFECTED SYSTEM, UTILITY OR SERVICE, CONTRACTOR SHALL ARRANGE TEMPOŘARY POWER.
- OPERATING SYSTEMS, UTILITIES AND SERVICES SERVING THE OF EXAMING 3 FISHALL BE MAINTAINED IN OPERATION TO SERVE THE EXISTING SITE SHALL BE MAINTAINED IN OPERATION TO SERVE THE NEEDS OF PORTIONS OF THE BUILDING AND SITE NOT INVOLVED IN THE WORK UNDER THIS CONTRACT AT ALL TIMES DURING THE PROGRESS OF THE WORK IN THIS CONTRACT, EXCEPT FOR SUCH SHORT PERIODS AS ARE ABSOLUTELY NECESSARY TO PERFORM THE WORK. SUCH OPERATING SYSTEMS, UTILITIES, AND SERVICES INCLUDE BUT ARE NOT LIMITED TO WATER, ELECTRICITY, HVAC, SANITARY SEWER, FIRE ALARM, TELEPHONE AND SECURITY. REFER TO MECHANICAL AND ELECTRICAL AND PLUMBING
- DEMOLITION NOTES FOR EXTENT OF DEMOLITION OF THOSE SYSTEMS.
- THE CONTRACTOR SHALL BRACE ALL EXISTING WALLS, STRUCTURES OR STRUCTURAL ELEMENTS AS NECESSARY DURING DEMOLITION. CONTRACTOR IS RESPONSIBLE FOR ALL PATCHING NECESSARY TO EXECUTE THE NEW WORK.
- THE CONTRACTOR SHALL NOT CUT STRUCTURAL WORK IN A MANNER RESULTING IN A REDUCTION OF LOAD CARRYING MANNER RESULTING IN A REDUCTION OF LOAD CARRYING CAPACITY OR LOAD/DEFLECTION RATIO. THE CONTRACTOR SHALL NOTIFY THE ARCHITECT OF ALL STRUCTURAL CUTS PRIOR TO EXECUTION SO THAT APPROVAL CAN BE OBTAINED FROM THE ARCHITECT/PICKINEER. REMOVE ALL EXISTING FLOOR FINISH MATERIALS, U.N.O. REMOVE
- ALL MATERIALS AND ACCESSORIES FLUSH AND SMOOTH WITH EXISTING CONCRETE FLOOR TOPPING, U.N.O. SCRAPE OR GRIND MASTIC OR OTHER FOREIGN MATERIALS FROM SLAB SURFACE AS REQUIRED AS NOT TO INHIBIT APPLICATION OF ANY FUTURE FLOOR FINISH OR FLOOR FILL MATERIALS.
- FOR ITEMS THAT ARE NOT PLANNED FOR REUSE IN THE NEW CONSTRUCTION, THE CONTRACTOR IS TO COORDINATE WITH ARCHITECT OR OWNER'S REPRESENTATIVE ON THE STORAGE OF
- ARCHITECT UN COMEN'S MEPRESENTATIVE ON THE STORAGE OR DISPOSAL OF ALL SALVAGED ITEMS AS FOLLOWS: COORDINATE DEMOLITION WITH NEW CONSTRUCTION SO RECONSTRUCTION WILL BE COMPATIBLE WITH REMOVAL TECHNIQUES. CAREFULLY REMOVE ALL APPLIED FINISHES ON GYP. BD, WALLS AND COLUMNS TO REMAIN, U.N.O. THE GYP, BD. SUBSTRATE SHOULD BE LEFT REASONABLY SMOOTH AND UNDAMAGED. WHERE REMOVAL IS NOT FEASIBLE WITHOUT DAMAGING THE SUBSTRATE, REMOVE ONE LAYER OF GYP, BD, AND REPLACE WITH EQUIVALENT THICKNESS AFTER DEMOLITION IS
- REMOVE CASEWORK, WINDOWS, FRAMES, FURR-DOWNS. RESTROOM FIXTURES, ETC. AS REQUIRED AFTER REMOVAL OF PIPE CHASES. PATCH HOLES IN EXISTING FLOORS OR WALLS TO REMAIN TO MEET ORIGINAL FIRE PROTECTION AND STRUCTURAL REQUIREMENTS. PATCH ADJOINING WALLS, FLOOR DECK AND PREPARE SURFACES TO RECEIVE NEW FINISHES AS PER INTERIOR FINISH SCHEDULE.
- NOISE AND DUST ARE NOT TO BE DISRUPTIVE TO THE OCCUPIED AREAS OF THE BUILDING. PROVIDE TEMPORARY PARTITIONS AS
- EITHER SIDE OF THE WALL ARE TO HAVE INSULATION IN SAME LOCATION WHEN CEILINGS ARE CLOSED UP. REJUSE EXISTING WHERE POSSIBLE AND PROVIDE NEW TO MATCH EXISTING AS



DECEMBER 11, 2015

FEATHERSTON | STUDIO IIc

p.o. box 170024

austin, texas 78717 ph: 512 740 4234

NICOLE KESSLER **GASTON REMODEL**

1605 GASTON AVE. AUSTIN, TEXAS 78703

DESCRIPTION

PERMIT DRAWINGS

DATE

20150720

PROJECT NUMBER

DEMOLITION PLAN SHEET NUMBER

NOTE; STANDARD SHEET SIZE IS 22x34; SETS REPRODUCED ON 11x17 WIL BE AT HALF SCALE. (EX. DRAWINGS SHOWN AT 1/8" = 11.0" WILL SCALE AT 1/16" = 11.0"

FLOOR PLAN - LVL 1 DEMOLITION

NOTE; STANDARD SHEET SIZE IS 22x34; SETS REPRODUCED ON 11x17 WIL BE AT HALF SCALE. (EX. DRAWINGS SHOWN AT 1/8" = 1'-0" WILL SCALE AT 1/16" = 1'-0"

GROSS FLOOR AREA

AREA	EXISTING SQ FT	NEW / ADDED 5Q FT	PROPOSED EXEMPTION	APPLIED EXEMPTION SQ FT	TOTAL SQ FT
1ST FLOOR	1,560 SQFT	89 SQFT			1,643 SQFT
2ND FLOOR	1,106 5QFT	1,371 SQFT	T	-	2,431 SQFT
AREA W/ CEILINGS >15"	o SQFT	o SQFT	*	-	o SQFT
GROUND FLOOR PORCH	o SQFT	285 SQFT	200 SQFT	200 SQFT	85 SQFT
BASEMENT			*		***********
ATTIC		+			
GARAGE (ATTACHED)	371 SQFT	137 SQFT	200 SQFT	200 SQFT	308 SQFT
CARPORT					
ACCESSORY BUILDINGS	150 SQFT				
TOTALS	3,350 SQFT	2,079 SQFT			4,467 SQFT

GROSS FLOOR AREA
TITLE 25-2 SUBCHAPTER F OF THE LAND DEVELOPMENT CODE.

(TOTAL GROSS FLOOR AREA / LOT AREA) x 100 = (4,467 5QFT/11,200 SQFT) x 100 = 39.88 FAR

FLOOR PLAN NOTES

- UNLESS NOTED OTHERWISE, DIMENSIONS ARE TO FACE OF GYPSUM BOARD, FACE OF EXISTING SURFACES, CENTERLINE OF COLUMN OR OTHER STRUCTURAL MEMBER, OR TO EXPOSED SURFACES OF CONCRETE OR MASONRY.
- ROOM NAMES AND NUMBERS SHOWN ARE FOR PURPOSES OF COORDINATION DURING CONSTRUCTION AND DO NOT NECESSARILY REPRESENT FINAL ROOM
- DURING CONSTRUCTION AND DO NOT NECESSARILY REPRESENT FINAL RUOM NAMES OR NUMBERS.

 DOOR FRAMES SHALL BE HELD 6 INCHES FROM FRAME FACE TO ADJACENT WALLS AT HINGE JAMB UNLESS NOTED WERE THERWISE.

 DIMENSIONS NOTED "VERIFY" SHALL BE CONFIRMED IN THE FIELD. REPORT VARIATIONS TO ARCHITECT FOR RESOLUTION BEFORE PROCEEDING WITH WORK
- AFFECTED.

 REFER TO ACCESSIBILITY INFORMATION SHEETS FOR INFORMATION RELATING TO ACCESSIBILITY, INCLUDING CLEARANCES, MOUNTING HEIGHTS, AND OTHER REQUIREMENTS.

 PREPARE EXISTING SURFACES TO REMAIN TO RECEIVE NEW FINISHES.

 NOTIFY ARCHITECT WHEN PARTITION LAYOUT IS COMPLETE AND READY FOR ADDROXING.

- AFFROVAL.
 ALL NEW ARE TO BE 2X4 WOOD STUD WALLS UNLESS NOTED OTHERWISE.
 ALL TOILET ACCESSORIES, HARDWARE, AND FIXTURES TO BE OWNER PROVIDED,
 CONTRACTOR INSTALLED.
 G.C. TO PROVIDED BLOCKING FOR TOILET ACCESSORIES AS REQUIRED.



FLOOR PLAN LEGEND

Room name	ROOM IDENTIFICATION
	NEW PARTITION.
	INDICATES EXISTING PARTITION TO REMAIN.
COMPANY AND ADDRESSED ON COMPANY	INDICATES 1-HOUR RATED WALL
	EXISTING DOOR TO REMAIN
	NEW INTERIOR DOOR
///////	AREA NOT IN CONTRACT
-	KEYED NOTE
	PARTITION TYPE
-	WINDOWTAG
X	DOORTAG

KEYED FLOOR PLAN NOTES

- (1) NEW EXTERIOR SIDING, CONTRACTOR TO DETERMINE DEPTH OF ADDITIONAL SHEATHING & STUDS SO THAT FACE OF SIDING ABOVE ALIGNS WITH NEW SIDING BELOW.
- (2) MILLWORK; SUB-CONTRACTOR TO SUBMIT ALL MILLWORK SHOP DRAWINGS TO INTERIOR DECORATOR ROBIN FOSTER, FOR APPROVAL.
- LINE REPRESENTS A 11/2" CURB IN GARAGE. SLOPE GARAGE FLOOR TOWARD STREET. SEE STRUCTURAL DRAWINGS FOR ADDITIONAL INFORMATION
- (4) EXISTING WINDOWS TO REMAIN
- (5) REMOVE PORTION OF EXISTING WALL FOR INSTALLATION OF NEW POCKET DOOR.



DECEMBER 11, 2015

FEATHERSTON | STUDIO IIc

p.o. box 170024 austin, texas 78717

ph: 512 740 4234

NICOLE KESSLER

GASTON REMODEL

1605 GASTON AVE. AUSTIN, TEXAS 78703

NO. DESCRIPTION DATE **PERMIT**


DRAWINGS

PROJECT NUMBER

FLOOR PLAN

SHEET NUMBER



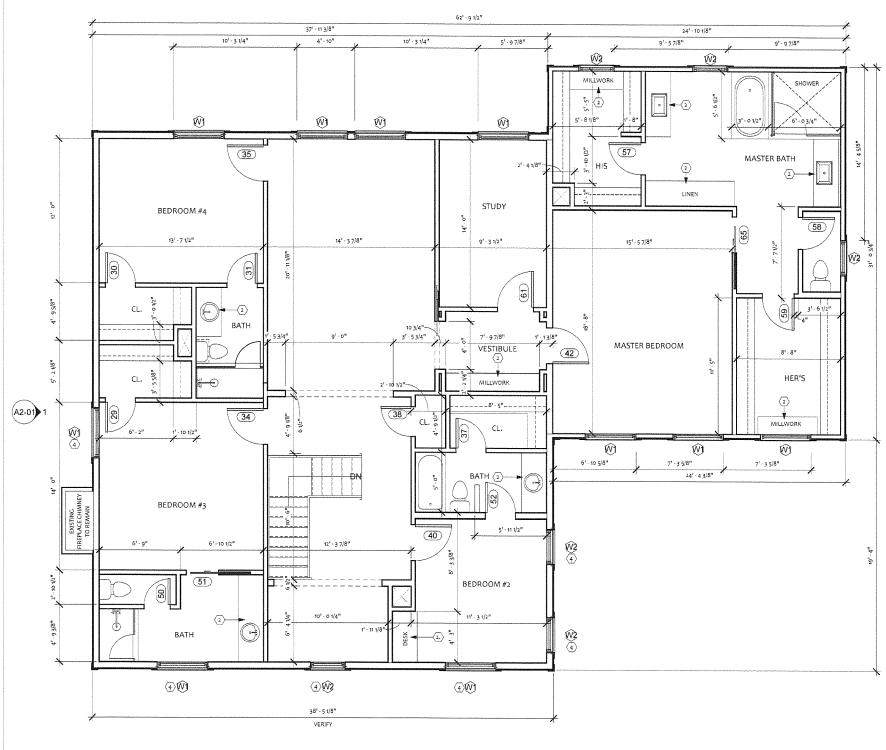



FLOOR PLAN - SECOND FLOOR
1/4" = 1'-0"



NOTE; STANDARD SHEET SIZE IS 22x34; SETS REPRODUCED ON 11x17 WIL BE AT HALF SCALE. (EX. DRAWINGS SHOWN AT 1/8" = 1'-0" WILL SCALE AT 1/16" = 1'-0"

GROSS FLOOR AREA

AREA	EXISTING SQ FT	NEW / ADDED SQ FT	PROPOSED EXEMPTION	APPLIED EXEMPTION SQ FT	TOTAL SQ FT
IST FLOOR	1,560 SQFT	89 SQFT		-	1,643 SQFT
2ND FLOOR	1,106 SQFT	1,371 SQFT	*		2,431 SQFT
AREA W/ CEILINGS >15'	o SQFT	o SQFT	*		o SQFT
GROUND FLOOR PORCH	o SQFT	185 SQFT	200 SQFT	200 SQFT	85 SQFT
BASEMENT			*		
ATTIC			*		
GARAGE (ATTACHED)	371 SQFT	137 SQFT	200 SQFT	200 SQFT	308 SQFT
CARPORT			*	-	
ACCESSORY BUILDINGS	150 SQFT	*			
TOTALS	3,350 SQFT	2,079 SQFT			4,467 SOFT

GROSS FLOOR AREA
TITLE 25-2 SUBCHAPTER F OF THE LAND DEVELOPMENT CODE.

(TOTAL GROSS FLOOR AREA / LOT AREA) x 100 = (4,467 SQFT/11,200 SQFT) x 100 = 39.88 FAR

FLOOR PLAN NOTES

- UNLESS NOTED OTHERWISE, DIMENSIONS ARE TO FACE OF GYPSUM BOARD, FACE ONLESS NOTED UTHERWISE, DIMENSIONS ARE TO FACE OF CYPSOM BOARD, FAC OF EXISTING SURFACES, CENTRELINE OF COLUMN OR OTHER STRUCTURAL MEMBER, OR TO EXPOSED SURFACES OF CONCAFTE OR MASONRY, ROOM NAMES AND NUMBERS SHOWN, ARE FOR PURPOSES OF COORDINATION DURING CONSTRUCTION AND DO NOT NECESSARILY REPRESENT FINAL ROOM
- NAMES OR NUMBERS.
- DOOR FRAMES SHALL BE HELD 6 INCHES FROM FRAME FACE TO ADJACENT WALLS
- DOOR TRANSES THAT LE RELUE IN CHIEF FROM PHANNETAKE TO AUTACEN I WALL AT HINGE JAMB UNLESS NOTED OTHERWISE. DIMENSIONS NOTED VERIFY SHALL BE CONFIRMED IN THE FIELD. REPORT VARIATIONS TO ARCHITECT FOR RESOLUTION BEFORE PROCEEDING WITH WORK AFFECTED.
- REFER TO ACCESSIBILITY INFORMATION SHEETS FOR INFORMATION RELATING TO ACCESSIBILITY, INCLUDING CLEARANCES, MOUNTING HEIGHTS, AND OTHER
- PREPARE EXISTING SURFACES TO REMAIN TO RECEIVE NEW FINISHES.
 NOTIFY ARCHITECT WHEN PARTITION LAYOUT IS COMPLETE AND READY FOR
- APPROVAL.
 ALL NEW ARE TO BE 2X4 WOOD STUD WALLS UNLESS NOTED OTHERWISE.
- ALL TOILET ACCESSORIES, HARDWARE, AND FIXTURES TO BE OWNER PROVIDED,
- CONTRACTOR INSTALLED.

 G.C. TO PROVIDED BLOCKING FOR TOILET ACCESSORIES AS REQUIRED.

FLOOR PLAN LEGEND

1 A2-02

Room name	
101	ROOM IDENTIFICATION
	NEW PARTITION.
	INDICATES EXISTING PARTITION TO REMAIN.
	INDICATES 1-HOUR RATED WALL
	EXISTING DOOR TO REMAIN
	NEW INTERIOR DOOR
//////	AREA NOT IN CONTRACT
	KEYED NOTE
	PARTITION TYPE
(<u>Ŵ</u> 1)	WINDOWTAG
X	DOORTAG

KEYED FLOOR PLAN NOTES

- (1) NEW EXTERIOR SIDING. CONTRACTOR TO DETERMINE DEPTH OF ADDITIONAL SHEATHING & STUDS SO THAT FACE OF SIDING ABOVE ALICNS WITH NEW SIDING BELOW.
- (2) MILLWORK; SUB-CONTRACTOR TO SUBMIT ALL MILLWORK SHOP DRAWINGS TO INTERIOR DECORATOR ROBIN FOSTER, FOR APPROVAL.
- (3) LINE REPRESENTS A 11/2" CURB IN GARAGE. SLOPE GARAGE FLOOR TOWARD STREET. SEE STRUCTURAL DRAWINGS FOR ADDITIONAL INFORMATION
- (5) REMOVE PORTION OF EXISTING WALL FOR INSTALLATION OF NEW POCKET DOOR
- 6 EXISTING PORCH TO REMAIN

(4) EXISTING WINDOWS TO REMAIN



DECEMBER 11, 2015

FEATHERSTON | STUDIO IIc

p.o. box 170024 austin, texas 78717

ph: 512 740 4234

NICOLE KESSLER **GASTON REMODEL**

1605 GASTON AVE. AUSTIN, TEXAS 78703

DESCRIPTION DATE

PERMIT DRAWINGS

PROJECT NUMBER

FLOOR PLAN

SHEET NUMBER

ROOF PLAN NOTES

- ALL LUMBER USED FOR ADDITION, RENOVATION AND/OR ADDITION ROOF IS TO BE GRADE No. 1, DOUGLAS FURR. UNLESS NOTED OTHERWISE. ALL OTHER FRAMING TO BE GRADE No. 3, DOUGLAS FURR.
 ALL EXPOSED WOOD SHALL BE STAINLESS STEEL UNLESS NOTED OTHERWISE ALL LUMBER NOT EXPOSED IS TO BE PRE-TREATED ACQ. 40; ALL OTHER LUMBER IS TO BE PRE-TREATED TO MEET ACQ. 25
 CONTRACTOR TO MATCH EXISTING SHINGLES, UNLESS DIRECTED OTHERWISE BY OWNER, INSTALL AS DIRECTED BY MANUFACTURER.
 ALL NEW VENEER TO MATCH EXISTING UNLESS NOTED OTHERWISE USES SILCOTED SHASED STAIN TUNLESS NOTED OTHERWISE WERE SEALANTS ARE CALLED OUT BETWEEN NEW MASONRY AND FLASHING USES BUTCH URBBER BASED SEALANT
 ALL NEW INTERIOR STUD WALLS TO BE 2X4 @ 16" O.C. U.N.O.
 ALL NEW EXTERIOR STUD WALLS TO BE 2X6 @ 16" O.C. U.N.O.

KEYED ROOF PLAN NOTES

(1) FLASH AROUND CHIMNEY, STEP OVERLAPPING MTL FLASHING DOWN SIDE OF CHIMNEY TO ROOF.



DECEMBER 11, 2015

FEATHERSTON | STUDIO IIc

p.o. box 170024 austin, texas 78717

ph: 512 740 4234

NICOLE KESSLER **GASTON REMODEL**

1605 GASTON AVE. AUSTIN, TEXAS 78703

DESCRIPTION

PERMIT DRAWINGS


PROJECT NUMBER

ROOF PLAN

SHEET NUMBER

FLOOR PLAN - ROOF 1/4" = 1'-0"



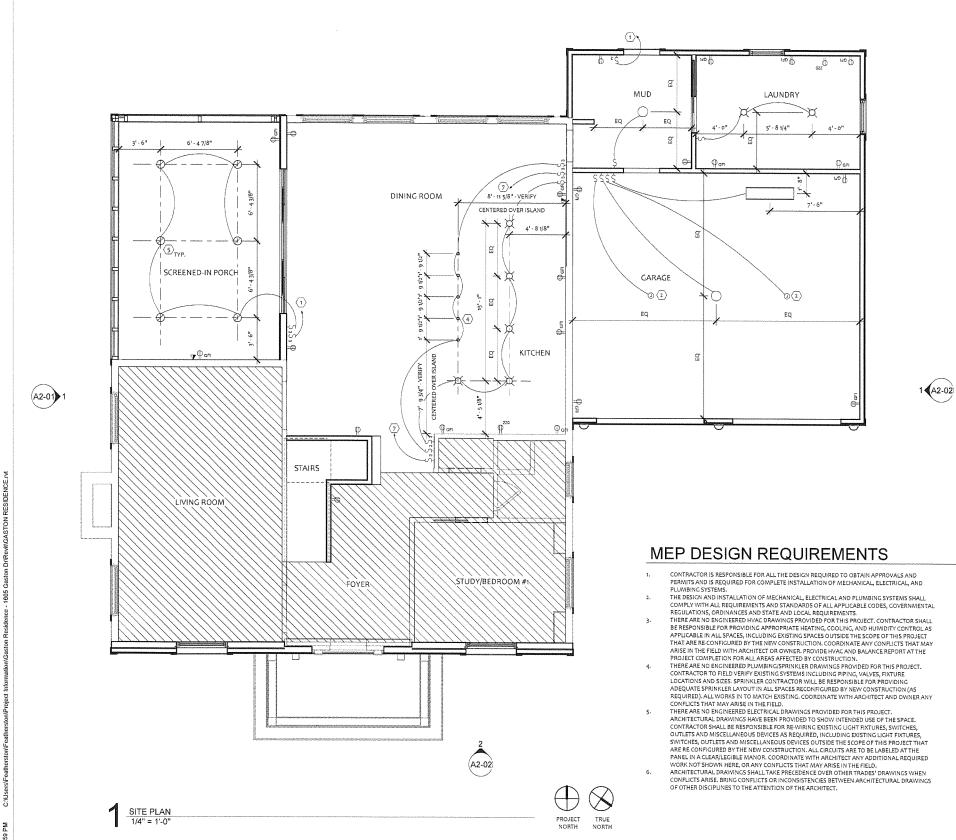

REFLECTED CEILING PLAN NOTES

CENTER LIGHT FIXTURES IN CEILING TILE, UNLESS NOTED OTHERWISE.

NOTIFY ARCHITECT IMMEDIATELY OF CONFLICTS DISCOVERED ON SITE BETWEEN DRAWINGS AND ACTUAL FIELD CONDITIONS. OBTAIN CLARIFICATIONS OR RESOLUTION OF CONFLICTS PRIOR TO PROCEEDING WITH WORK IN QUESTION.

UNLESS NOTED OTHERWISE, CELIUM CHEIGHT IS 81-01. REFER TO REFLECTED CEILING PLAN AND INTERIOR ELEVATIONS FOR ADDITIONAL INFORMATION. G.C. TO VERIFY EXISTING CEILING HEIGHTS. REFER TO MECHANICAL NOTES FOR INFORMATION PERTAINING TO HYAC DEVICES IN THE CEILING AND PLENUM SPACE,

AND PLENUM SPACE.

CEILING AND SOFFIT HEIGHTS ARE NOTED ON THE REFLECTED CEILING PLANS.

UNLESS NOTED OTHERWISE, INSTALL ALL SWITCHES AT 48" A.F.F. TO CENTERLINE OF COVER PLATE.

ALL PIXTURES TO BE AS SCHEDULED. LOCATIONS OF LIGHT FIXTURES SHALL BE AS SHOWN ON

ARCHITECTURAL DRAWINGS, REPORT CONFLICTS BETWEEN ARCHITECTURAL AND ELECTRICAL

DRAWINGS TO THE ARCHITECT FOR RESOLUTION PRIOR TO INSTALLATION.

PAINT ALL GYPSUM BOARD CEILINGS AND SOFFITS BT-3, UNLESS NOTED OTHERWISE, REFER TO

EVICURE IN ALM FOR ADMITIOAL INFORMATION.

FINISH PLANS FOR ADDITIONAL INFORMATION.

REFLECTED CEILING PLAN LEGEND

	GYP BD, PTD	X	COMBINATION LIGHT AND EXHAUST FAN	
No.	DIFFUSER - SUPPLY (MECHANCIAL SUBCONTRACTOR TO COORDINATE WITH ARCHITECT) DIFFUSER - RETURN (MECHANCIAL	ş	WALL MOUNTED LIGHT SWITCH @ 42" A.F.F.; WHITE COVER PLATE.	
Z	SUBCONTRACTOR TO COORDINATE WITH ARCHITECT)	Ş.	3-WAY SWITCH	
1///.	NOT IN CONTRACT	Şı	DIMMER SWITCH	
0	RECESSED CAN FIXTURE.	¤	NEW INTERIOR LED 6° DOWNLIGHT	
	PENDANT LIGHT FIXTURE (KITCHEN & DINING)	¤	NEW INTERIOR/EXTERIOR LED 6" DOWNLIGHT	
0	CEILING MOUNTED FIXTURE.	_	WALL MOUNTED LIGHT FIXTURE	
		0	SPEAKER	
H	CEILING FAN	⊗ .	SMOKE DETECTOR	

KEYED RCP NOTES

EXHAUST FAN

- 1 SWITCH GOES TO EXTERIOR GFI OUTLET(S) IN SOFFIT FOR CHRISTMAS LIGHT(S)
- SWITCH & J-BOX FOR GARAGE DOOR OPENER & HARDWARE; OWNER SELECTED, CONTRACTOR INSTALLED. 2
- WALL SCONCES TO BE FRAMED UP ON EITHER SIDE OF OWNER SELECTED 3
- 4 OWNER SELECTED PENDANT LIGHT OVER ISLAND.
- (5) EXTERIOR | INTERIOR RECESSED FIXTURE; SAFE FOR USE IN WET CONDITIONS
- 6 SWITCH GOES TO EXTERIOR BACK PORCH LIGHT(S)
- OWNER SELECTED FIXTURE OVER DINING ROOM TABLE. REFER TO INTERIOR DECORATOR ROBIN FOSTER FOR ADDITIONAL INFORMATION

8	CENTER FAN WITH TOILET BELOW		
EL	ECTRICAL LEGE	END	
8	Floor mounted duplex electrical outlet	N	Indicates new item location as shown. See note below.
O	Floor mounted data and/or telephone line outlet	Фол	Indicates ground fault interrupt outlet
0	Building standard electrical J-box outlet		Wall mounted direct connection location for power and telephone/data
φ	Wall mounted duplex outlet at standard height.		for systems furniture panels. Coordinate exact location(s) and requirements with furniture dealer and installer.
₽ ²²⁰	Wall mounted 220 outlet at standard height.	®	Indicates power pole location.
#	Wall mounted quadruplex electrical outlet at standard height.	Φ	Thermostat
Q	Building standard wall mounted dedicated duplex outlet,	+42"	Special mounting height indication for wail outlets. Taken to bottom of plate.
∇	Building standard wall mounted data outlet		place.
4	Wall mounted telephone and data shared outlet.		e: Unless noted with an "N", al) items will
•	Wall mounted telephone outlet.	be e	xisting to remain.
	"Plug Mold" Power strip (Re: Keyed notes)		



DECEMBER 11, 2015

FEATHERSTON | STUDIO IIc

p.o. box 170024 austin, texas 78717

ph: 512 740 4234

NICOLE KESSLER **GASTON REMODEL**

1605 GASTON AVE. AUSTIN, TEXAS 78703

DESCRIPTION

PERMIT DRAWINGS

PROJECT NUMBER

REFLECTED CEILING

DATE

PLAN SHEET NUMBER

NOTE; STANDARD SHEET SIZE IS 22x34; SETS REPRODUCED ON 11x17 WIL BE AT HALF SCALE. (EX. DRAWINGS SHOWN AT 1/8" = 1'-0" WILL SCALE AT 1/16" = 1'-0"



- CONTRACTOR IS RESPONSIBLE FOR ALL THE DESIGN REQUIRED TO OBTAIN APPROVALS AND PERMITS AND IS REQUIRED FOR COMPLETE INSTALLATION OF MECHANICAL, ELECTRICAL, AND PLUMBING SYSTEMS.
- ARISE IN THE FIELD WITH ARCHITECT OR OWNER, PROVIDE HVAC AND BALANCE REPORT AT THE
 - ARISE IN THE FIELD WITH ARCHITECT OR OWNER, PROVIDE HVAC AND BALANCE REPORT AT THE
 PROJECT COMPLETION FOR ALL AREA SFETCED BY CONSTRUCTION.

 THERE ARE NO ENGINEERED PLUMBING; SPRINKLER DRAWINGS PROVIDED FOR THIS PROJECT.

 CONTRACTOR TO FIELD VERIFY EXISTING SYSTEMS INCLUDING PIPING, VALVES, FIXTURE

 LOCATIONS AND SIZES. SPRINKLER CONTRACTOR WILL BE RESPONSIBLE FOR PROVIDING

 ADEQUATE SPRINKLER LAYOUT IN ALL SPACES RECONFIGURED BY NEW CONSTRUCTION (AS

 REQUIRED). ALL WORKS IN TO MACTHE KISTING. COORDINATE WITH ARCHITECT AND OWNER ANY

 CONFLICTS THAT MAY ARISE IN THE FIELD.
- CONTRACTOR SHALL BE RESPONSIBLE FOR RE-WIRING SPROVIDED FOR THIS PROJECT. ARCHITECTURAL DRAWINGS HAVE BEEN PROVIDED TO SHOW INTENDED USE OF THE SPACE. CONTRACTOR SHALL BE RESPONSIBLE FOR RE-WIRING EXISTING LIGHT FIXTURES, SWITCHES, OUTLETS AND MISCELLANEOUS DEVICES AS REQUIRED, INCLUDING EXISTING LIGHT FIXTURES, SWITCHES, OUTLETS AND MISCELLANEOUS DEVICES OUTSIDE THE SCOPE OF THIS PROJECT THAT ARE RECONFICURED BY THE NEW CONSTRUCTION. ALL CIRCUITS ARE TO BE LABELED AT THE PAVEL IN A CLEAR/LEGIBLE MANDR. COORDINATE WITH ARCHITECT ANY ADDITIONAL REQUIRED WORK NOT SHOWN HERE, OR ANY CORPLICTS THAT MAY ARISE IN THE RELD.

 ARCHITECTURAL DRAWINGS SHALL TAKE PRECEDENCE OVER OTHER TRADES' DRAWINGS WHEN CONFLICTS ARISE. BRING CONFLICTS AN RECONSISTENCY.

REFLECTED CEILING PLAN NOTES

CENTER LIGHT FIXTURES IN CEILING TILE, UNLESS NOTED OTHERWISE

DIFFUSER - SUPPLY (MECHANCIAL SUBCONTRACTOR TO

COORDINATE WITH ARCHITECT)
DIFFUSER - RETURN (MECHANCIAL
SUBCONTRACTOR TO COORDINATE

WITH ARCHITECT) NOT IN CONTRACT

RECESSED CAN FIXTURE

PENDANT LIGHT

FIXTURE (KITCHEN & DINING)

CEILING MOUNTED FIXTURE.

KEYED RCP NOTES

OWNER SELECTED PENDANT LIGHT OVER ISLAND.

SWITCH GOES TO EXTERIOR BACK PORCH LIGHT(S).

ELECTRICAL LEGEND

CENTER FAN WITH TOILET BELOW

Floor mounted duplex electrical outlet

Building standard electrical J-box outlet

Wall mounted duplex outlet at standard height,

Building standard wall mounted dedicated

Bullding standard wall mounted data

Wall mounted telephone and data

"Plug Mold" Power strip (Re: Keyed

shared outlet.

Wall mounted 220 outlet at standard height.

SWITCH GOES TO EXTERIOR GFI OUTLET(S) IN SOFFIT FOR CHRISTMAS LIGHT(S).

SWITCH & J-BOX FOR GARAGE DOOR OPENER & HARDWARE; OWNER SELECTED, WALL SCONCES TO BE FRAMED UP ON EITHER SIDE OF OWNER SELECTED FRAMED MIRROR.

EXTERIOR | INTERIOR RECESSED FIXTURE; SAFE FOR USE IN WET CONDITIONS

OWNER SELECTED FIXTURE OVER DINING ROOM TABLE, REFER TO INTERIOR DECORATOR - ROBIN FOSTER FOR ADDITIONAL INFORMATION

 \boxtimes

2

3 4

(6)

CRIVER LIGHT FATURES IN CELLION THE, DIFLESS NOTED OTHERWISE SET UP OF THE SET UP OF T

INTERIOR ELEVATIONS FOR ADDITIONAL INFORMATION, G.C. TO VERIFY EXISTING CEILING HEIGHTS. REFER TO MECHANICAL NOTES FOR INFORMATION PERTAINING TO HVAC DEVICES IN THE CEILING

REFER TO MECHANICAL NOTES FOR INFORMATION PERTAINING TO HVAC DEVICES IN THE CEILING AND PLENUM SPACE.
CEILING AND SOFFIT HEIGHTS ARE NOTED ON THE REFLECTED CEILING PLANS.
UNLESS NOTED OTHERWISE, INSTALL ALL SWITCHES AT 48" A.FF. TO CENTERLINE OF COVER PLATE.
ALL FIXTURES TO BE AS SCHOULED. LOCATIONS OF LIGHT RIXTURES SHALLE AS SHOWN ON ARCHITECTURAL DRAWINGS. REPORT CONFLICTS BETWEEN ARCHITECTURAL AND ELECTRICAL DRAWINGS TO THE ARCHITECT FOR RESOLUTION PRIOR TO INSTALLATION.
PAINT ALL CYPSUM BOARD CEILINGS AND SOFFITS TT-3, UNLESS NOTED OTHERWISE. REFER TO FINISH PLANS FOR ADDITIONAL INFORMATION.

REFLECTED CEILING PLAN LEGEND

X

COMBINATION LIGHT AND

WALL MOUNTED LIGHT

SWITCH @ 42" A.F.F.;

NEW INTERIOR LED 6"

NEW INTERIOR/EXTERIOR

WALL MOUNTED LIGHT FIXTURE

SPEAKER SMOKE DETECTOR

Indicates new item location as

Indicates ground fault interrupt outlet

Coordinate exact location(s) and requirements with furniture dealer and installer.

shown. See note below

Wall mounted direct connection

indicates power pole location.

+42" Special mounting height indication

for wall outlets. Taken to bottom of

Note: Unless noted with an "N", all items will

Thermostat

WHITE COVER PLATE 3-WAY SWITCH

EXHAUST FAN

DECEMBER 11, 2015

FEATHERSTON | STUDIO IIc

p.o. box 170024 austin, texas 78717

ph: 512 740 4234

NICOLE KESSLER **GASTON REMODEL**

1605 GASTON AVE. AUSTIN, TEXAS 78703

NO.	DESCRIPTION	

		·


DATE

PERMIT location for power and telephone/data for systems furniture panels. **DRAWINGS**

PROJECT NUMBER

REFLECTED CEILING **PLAN**

SHEET NUMBER

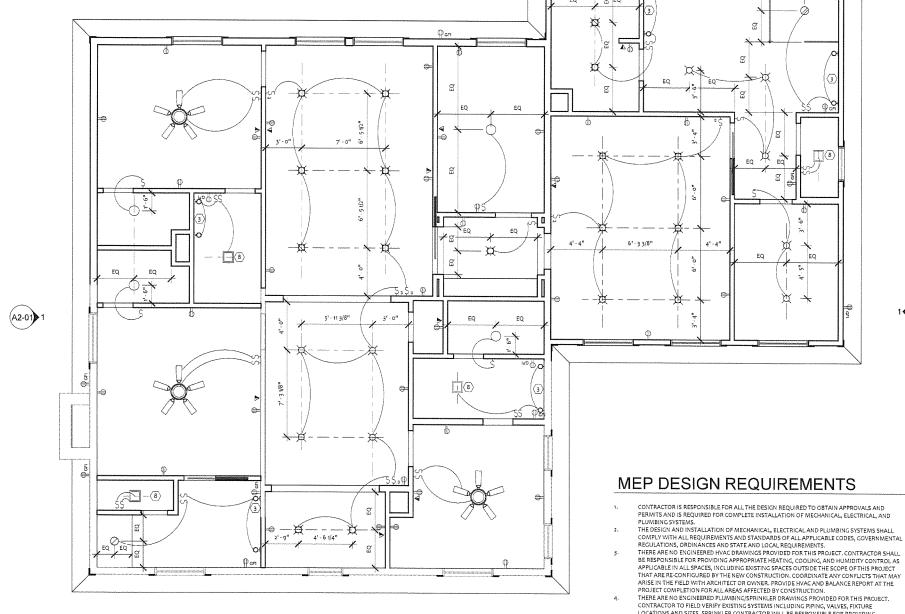

A2-02

FLOOR PLAN - SECOND FLOOR

EQ

MEP DESIGN REQUIREMENTS

- CONTRACTOR IS RESPONSIBLE FOR ALL THE DESIGN REQUIRED TO OBTAIN APPROVALS AND PERMITS AND IS REQUIRED FOR COMPLETE INSTALLATION OF MECHANICAL, ELECTRICAL, AND
- PLUMBING SYSTEMS.

 THE DESIGN AND INSTALLATION OF MECHANICAL, ELECTRICAL AND PLUMBING SYSTEMS SHALL COMPLY WITH ALL REQUIREMENTS AND STANDARDS OF ALL APPLICABLE CODES, GOVERNMENTAL REGULATIONS, ORDINANCES AND STATE AND LOCAL REQUIREMENTS.

 THERE ARE NO ENCINEERED HAZ DRAWINGS PROVIDED FOR THIS PROJECT. CONTRACTOR SHALL BE RESPONSIBLE FOR PROVIDING APPROPRIATE HEATING, COOLING, AND HUMIDITY CONTROL AS
- BE RESPONSIBLE ON PROVIDING APPROPRIATE HEALING, COOLING, AND HOMIDITY CONTROL APPLICABLE IN ALL SPACES, INCLUDING RESTITUDE SPACES OUTSIDE THE SCOPE OF THIS PROJECT THAT ARE RE-CONFICURED BY THE NEW CONSTRUCTION. COORDINATE ANY CONFLICTS THAT MAY ARISE IN THE FIELD WITH ARCHITECT OR OWNER, PROVIDE HVAC AND BALANCE REPORT AT THE PROJECT COMPLETION FOR ALL AREAS AFFECTED BY CONSTRUCTION.

 THERE ARE NO ENGINEERED PLUMBING/SPRINKLER DRAWINGS PROVIDED FOR THIS PROJECT. CONTRACTOR TO FIELD VERTIFY EXISTING SYSTEMS INCLUDING PPING, VALVES, FIXTURE LOCATIONS AND SIZES. SPRINKLER CONTRACTOR WILL BE RESPONSIBLE FOR PROVIDING
- LOCATIONS AND SIZES. SPRINKLER CONTRACTOR WILL BE RESPONSIBLE FOR PROVIDING ADEQUATE SPRINKLER LAVOUT IN ALL SPACES RECONFIGURED BY NEW CONSTRUCTION (AS REQUIRED). ALL WORKS IN TO MATCH EXISTING, COORDINATE WITH ARCHITECT AND OWNER ANY CONFLICTS THAT MAY ARISE IN THE FIELD. THERE ARE NO ENGINEERED ELECTRICAL DRAWINGS PROVIDED FOR THIS PROJECT. ARCHITECTURAL DRAWINGS HAVE BEEN PROVIDED TO SHOW INTENDED USE OF THE SPACE. CONTRACTOR SHALL BE RESPONSIBLE FOR RE-WIRING EXISTING LIGHT FIXTURES, SWITCHES, CONTRACTOR SHALL BE RESPONSIBLE FOR RE-WIRING EXISTING LIGHT FIXTURES, SWITCHES, OUTLETS AND MISCELLANEOUS DEVICES AS REQUIRED, INCLUDING EXISTING LIGHT FIXTURES, SWITCHES, OUTLETS AND MISCELLANEOUS DEVICES OUTSIDE THE SCOPE OF THIS PROJECT THAT ARE RECONFIGURED BY THE NEW CONSTRUCTION. ALL CIRCUITS ARE TO BE LABELED AT THE PANEL IN A CLEARLEGIBLE MANOR. CORDINATE WITH ARCHITECT ANY ADDITIONAL REQUIRED WORK NOT SHOWN HERE, OR ANY CONFLICTS THAT MAY ARISE IN THE FIELD.
- ARCHITECTURAL DRAWINGS SHALL TAKE PRECEDENCE OVER OTHER TRADES' DRAWINGS WHEN CONFLICTS ARISE, BRING CONFLICTS OR INCONSISTENCIES BETWEEN ARCHITECTURAL DRAWINGS OF OTHER DISCIPLINES TO THE ATTENTION OF THE ARCHITECT.

REFLECTED CEILING PLAN NOTES

- CENTER LIGHT FIXTURES IN CEILING TILE, UNLESS NOTED OTHERWISE.
 NOTIFY ARCHITECT IMMEDIATELY OF CONFLICTS DISCOVERED ON SITE BETWEEN DRAWINGS AND
 ACTUAL, FIELD COMDITIONS, OBTAIN CLARIFICATIONS OR RESOLUTION OF CONFLICTS PRIOR TO
 PROCEEDING WITH WORK IN QUESTION.
- PROCEEDING WITH WORK IN QUESTION.

 UNLESS NOTED OTHERWISE, CEILING HEIGHT IS 81-91. REFER TO REFLECTED CEILING PLAN AND
 INTERIOR ELEVATIONS FOR ADDITIONAL INFORMATION. O.C. TO VERIFY EXISTING CEILING HEIGHTS.
 REFER TO MECHANICAL NOTES FOR INFORMATION PERTAINING TO HVAC DEVICES IN THE CEILING
 AND PLENUM SPACE.
 CEILING AND SOFFIT HEIGHTS ARE NOTED ON THE REFLECTED CEILING PLANS.
 UNLESS NOTED OTHERWISE, INSTALL ALL SWITCHES AT 48" A.F.F. TO CENTERLINE OF COVER PLATE.
 ALL FIXTURES TO BE AS SCHEDULED. LOCATIONS OF LIGHT FIXTURES SHALL BE AS SHOWN ON
 ARCHITECTURAL DRAWINGS. REPORT CONFLICTS BETWEEN ARCHITECTURAL AND ELECTRICAL
 DRAWINGS TO THE ARCHITECT FOR RESOLUTION PRIOR TO INSTALLATION.
 PAINT ALL GYPSUM BOARD CEILINGS AND SOFFITS PT.3, UNLESS NOTED OTHERWISE, REFER TO
 FINISH PLANS FOR ADDITIONAL INFORMATION.

REFLECTED CEILING PLAN LEGEND

GYP BD, PTD DIFFUSER - SUPPLY (MECHANCIAL SUBCONTRACTOR TO COORDINATE WITH ARCHITECT) DIFFUSER - RETURN (MECHANCIAL SUBCONTRACTOR TO COORDINATE WITH ARCHITECT)

NOT IN CONTRACT

PENDANT LIGHT FIXTURE (KITCHEN & DINING)

CEILING MOUNTED FIXTURE.

CEILING FAN

COMBINATION LIGHT AND

X WALL MOUNTED LIGHT SWITCH @ 42" A.F.F.; WHITE COVER PLATE.

3-WAY SWITCH

DIMMER SWITCH

NEW INTERIOR LED 6" NEW INTERIOR/EXTERIOR

LED 6" DOWNLIGHT

(9) SPEAKER

SMOKE DETECTOR

Indicates new Item location as

Indicates ground fault interrupt

location for power and telephone/data for systems furniture panels.

Coordinate exact location(s) and requirements with furniture dealer and installer.

shown. See note below

⟨ ∀y Wall mounted direct connection

indicates power pole location.

+42" Special mounting height indication for wail outlets. Taken to bottom of

Note: Unless noted with an "N", all items will

KEYED RCP NOTES

- (1) SWITCH GOES TO EXTERIOR GFI OUTLET(S) IN SOFFIT FOR CHRISTMAS LIGHT(S)
- SWITCH & J-BOX FOR GARAGE DOOR OPENER & HARDWARE; OWNER SELECTED, CONTRACTOR INSTALLED. 2
- 3 WALL SCONCES TO BE FRAMED UP ON EITHER SIDE OF OWNER SELECTED FRAMED MIRROR.
- 4 OWNER SELECTED PENDANT LIGHT OVER ISLAND.
- EXTERIOR | INTERIOR RECESSED FIXTURE; SAFE FOR USE IN WET CONDITIONS
- 6 SWITCH GOES TO EXTERIOR BACK PORCH LIGHT(S)
- OWNER SELECTED FIXTURE OVER DINING ROOM TABLE, REFER TO INTERIOR
- CENTER FAN WITH TOILET BELOW

ELECTRICAL LEGEND

- Floor mounted duplex electrical outle
- Building standard electrical J-box outlet Wall mounted duplex outlet at standard
- Wall mounted 220 outlet at standard height.
- Building standard wall mounted dedicated duplex outlet.
- Building standard wall mounted data
- Wall mounted telephone and data
 - be existing to remain
- "Plug Mold" Power strip (Re: Keyed

AUSTIN, TEXAS 78703

1605 GASTON AVE.

NICOLE KESSLER

GASTON REMODEL

DECEMBER 11, 2015

p.o. box 170024 austin, texas 78717

ph: 512 740 4234

FEATHERSTON | STUDIO IIc

PERMIT DRAWINGS

DESCRIPTION

DATE

20150720

REFLECTED CEILING **PLAN**

SHEET NUMBER

8






41 - 411

61-33/81

A2-01 1

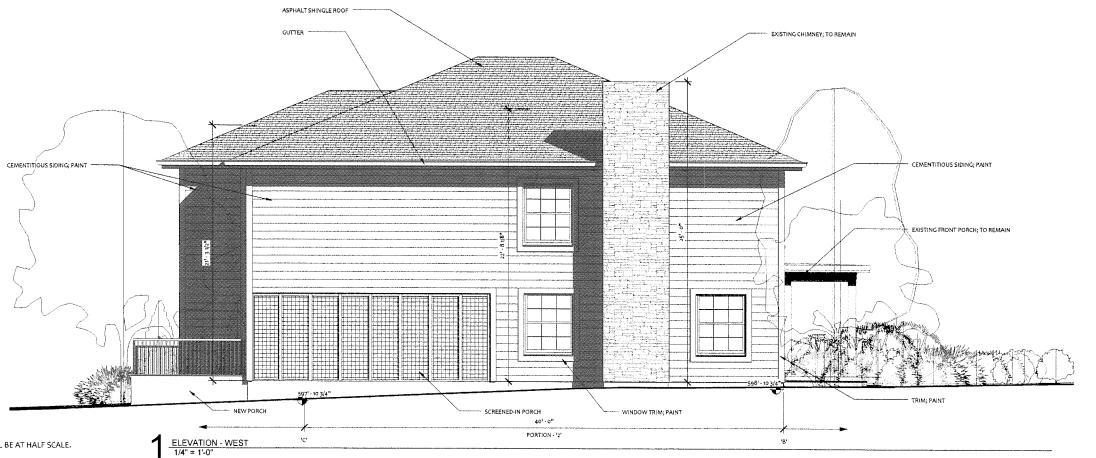



DECEMBER 11, 2015

FEATHERSTON | STUDIO IIC

p.o. box 170024 austin, texas 78717

ph: 512 740 4234

NICOLE KESSLER **GASTON REMODEL**

1605 GASTON AVE. AUSTIN, TEXAS 78703

DESCRIPTION **PERMIT DRAWINGS**


DATE

PROJECT NUMBER


ELEVATIONS

SHEET NUMBER

NOTE; STANDARD SHEET SIZE IS 22×34; SETS REPRODUCED ON 11×17 WIL BE AT HALF SCALE. (EX. DRAWINGS SHOWN AT 1/8" = 1'.0" WILL SCALE AT 1/16" = 1'.0"

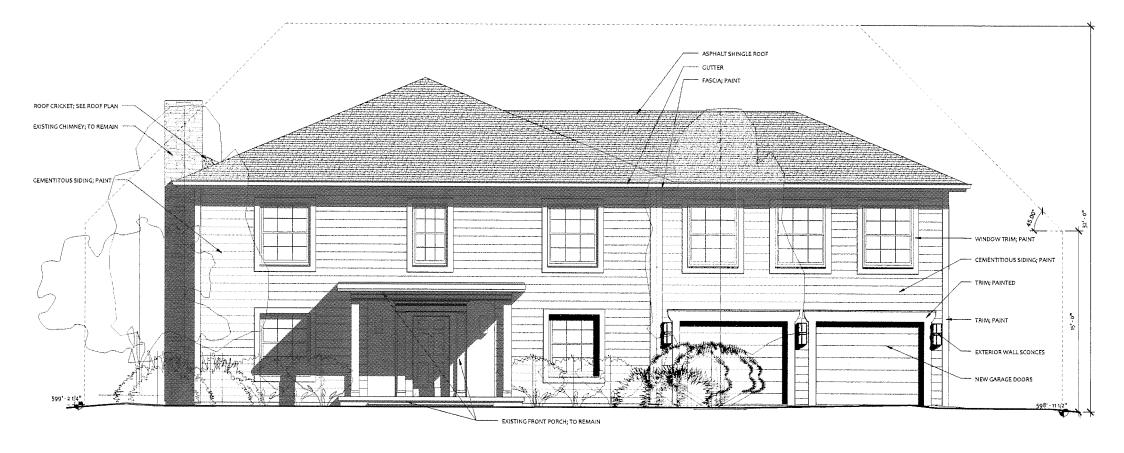

2 ELEVATION - SOUTH

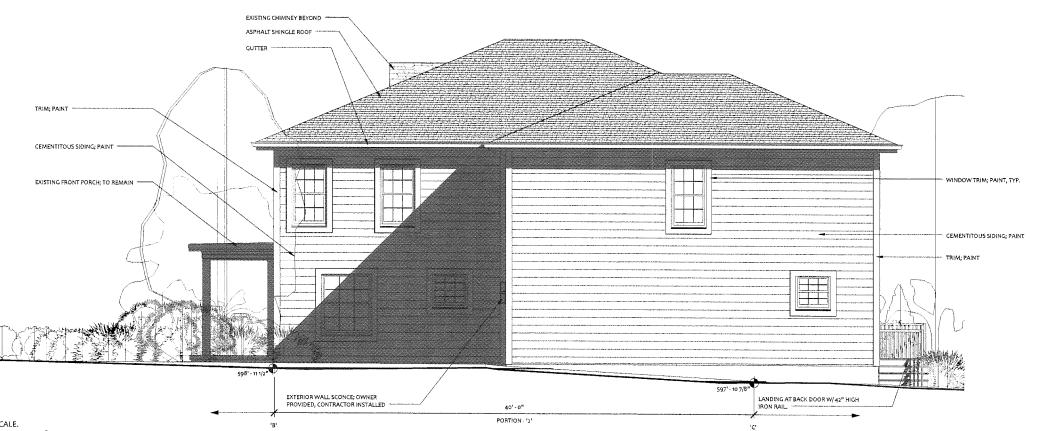

SERED AND SERVICE OF TELES

DECEMBER 11, 2015

FEATHERSTON | STUDIO IIC

p.o. box 170024 austin, texas 78717

ph: 512 740 4234

NICOLE KESSLER GASTON REMODEL

1605 GASTON AVE. AUSTIN, TEXAS 78703

NO. DESCRIPTION

PERMIT DRAWINGS

DATE

20150720

PROJECT NUMBER

ELEVATIONS


SHEET NUMBER

A2-02

NOTE; STANDARD SHEET SIZE IS 22×34; SETS REPRODUCED ON 11×17 WIL BE AT HALF SCALE. (EX. DRAWINGS SHOWN AT 1/8" = 1'-0" WILL SCALE AT 1/16" = 1'-0"

ELEVATION - EAST

4/2015 1:42:26 PM C:\Users\Feathersk

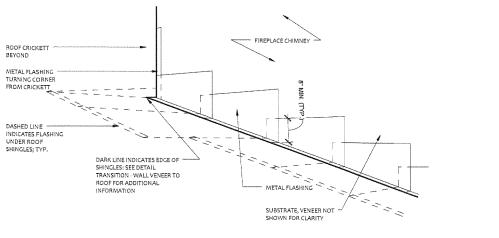

WOOD CANT STRIP FLASHING, TYP.

2X RIDGE BOARD

ASPHALT SHINGLES TO MATCH EXISTING, #30 FELT EACH COURSE, 3/4" CDX PLYWOOD SHEETING ROOF DECK, STRUCTURE - SEE STRUCTURAL DRAWINGS, MIN. 6" INSULATION, 1/2" GYPSUM BOARD CEILINGS; PAINTED 2x SOLID BLOCKING DOUBLE TOP PLATE 3" HALF ROUND GUTTERS (SEE ROOF PLAN), FASTENED TO 2X FASCIA BOARD: PAINTED SOFFIT; PAINTED

CEMENTITIOUS SIDING; PAINT FILL FLOOR CAVITY WITH INSULATION FRAMING; SEE STRUCTURAL DRAWINGS FOR ADDITIONAL INFORMATION 1x HORIZONTAL TRIM CAI CEDAR SOFFIT BLACK ALUMINUM SCREENING (5' ROLL) 4X4 POST 2X6 CAP RAIL 1X HORIZONTAL TRIM CAP 2X4 SUBRAIL DASHED LINE REPRESENTS BLACK ALUMINUM SCREENING (5' ROLL) 2x8 PLANKS SPACED 1/4" APART 2x BOTTOM PLATE 1x HORIZONTALTRIM CAP FRAMING; SEE STRUCTURAL DRAWINGS FOR ADDITIONAL INFORMATION 1x HORIZONTAL TRIM CAP FOUNDATION; SEE

STRUCTURAL DRAWINGS FOR
ADDITIONAL INFORMATION DOUBLE TOP PLATE ON EXTERIOR WALLS AND BEARING PARTITIONS. STAGGER JOINTS 4". (SINGLE TOP PLATE PERMITTED AT INTERIOR NON-BEARING WALLS). MANUFACTURED TRUSS BY OTHERS HEADER SPANS: 4"x4" - UP TO 4' SPAN 4"x6" - 4' TO 6' SPAN 4"x8" - 6' TO 8' SPAN (ONE EDGE IN TWO PIECES) BLOCKING (TYP) FLOOR TRUSSES BY TRUSS MANUFACTURE; REFER TO STRUCTURAL WD STUD'S 16" O.C. HEADER HEADER HEADER SPANS: 4"x4" - UP TO 4' SPAN 4"x6" - 4' TO 6' SPAN 4"x8" - 6' TO 8' SPAN (ONE EDGE IN TWO PIECES) SI "MAJ" LET IN BRACE REQUIRED AT EACH END OF WALL AND EVERY 25 LF. OF WALL EXTEND FROM SOLE PLATE TO DOUBLE TOP PLATE @ 60 DEGREE ANGLE FROM TOP PLATE. PURLINS SHALL NOT BE SMALLER THAN RAFTER SIZES.

1" RIDGE BOARD SHALL NOT BE LESS THAN DEPTH OF RAFTERS. SEE TYPICAL WALL SECTION FOR ADDITIONAL INFORMATION

3/4" FLOOR FINISH, 3/4" PLYWOOD SUB-FLOOR, ON 16" FLOOR TRUSSES BY TRUSS MANUFACTURER 4" NOMINAL STONE VENEER (SEE ELEVATIONS), 15# BLDG PAPER OR TYVEK, 1/2" CDX SHEETHING, 2x4 STUDS ON 16" CENTERS, INSULATION, 1/2" GYPSUM BOARD 3/4" FINISHED WOOD FLOOR, ON CONCRETE SLAB 2x4 P.T. MUDSILL WITH 5/8" A.B. @ 48" O.C. (MIN, AND WITHIN 12" OF ANY CORNER) BOTTOM PLATE SLOPE GRADE AWAY FROM RESIDENCE FOUNDATION; REFER STRUCTURAL

2 TYPICAL FRAMING 1/2" = 1'-0"

WALL SECTION - NEW AT GRADE

CEILING STRUCTURE @

16" O.C., 1/2" GYPSUM BD CEILING; PAINTED



DECEMBER 11, 2015

FEATHERSTON | STUDIO IIc

p.o. box 170024 austin, texas 78717

ph: 512 740 4234

NICOLE KESSLER

GASTON REMODEL

1605 GASTON AVE. AUSTIN, TEXAS 78703

NO. DESCRIPTION DATE


PERMIT **DRAWINGS**


PROJECT NUMBER

DETAILS

20150720


SHEET NUMBER

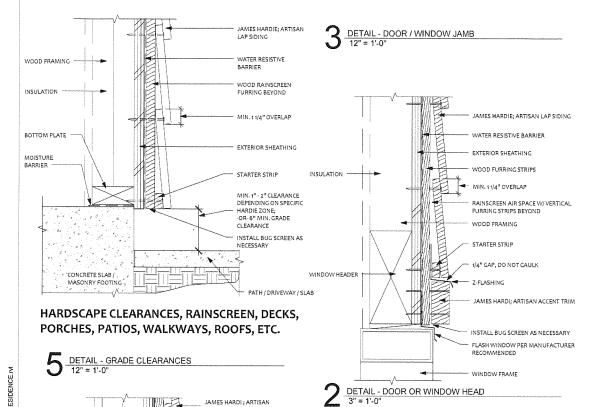

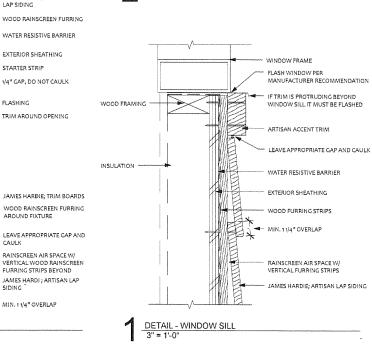

					DOOR	SCHEDUL	E			
DOOR				DOOR			FRAME [DOOR	
NUMBER	w	н	TYPE	MATERIAL	FINISH	TYPE	FINISH	RATING	HARDWARE	COMMENTS
23	3' - 0"	6' - 8"	D3	WD	PT	F1	PT	-	PRIVACY LOCKSET	
24	31 - 0"	6' - 8"	D2	G1	PT	F1	PT		KEYED LOCKSET	
25	31 - 0"	6' - 8"	D4	WD	PT	,	PT	-		
27	21 - 8"	61 - 8"	D4	WD	PT	-	PT	-	PRIVACY LOCKSET	
28	3' - 0"	6' - 8"	D6	WD	PT	F1	PT		*	
29	21-6"	61 - B ^{rt}	D3	WD	PT	F1	PT	-	-	
30	21 - 6"	61 - 811	D3	WD	PT	Ft	PT	-	~	
31	z' - 6"	6'-8"	D3	WD	PT	F1	PT	-	PRIVACY LOCKSET	
34	3'-0"	6'-8"	D3	WD	PT	Ft Ft	PT		PRIVACY LOCKSET	
35	31 - 0 ¹¹	61 - 811	D3	WD	PT	Ft Ft	PT	-	PRIVACY LOCKSET	
37	2' - 6"	6'-8"	D3	WD	PT	F1	PT		-	
38	2'-6"	6'-8"	D3	WD	PT	F1	PT			
40	31-0"	61 - 84	D3	WD	PT	F1	PT		PRIVACY LOCKSET	
42	31 - Off	6' - 8"	D3	WD	PT	Ft	PT		PRIVACY LOCKSET	
50	2' - 2"	6'-8"	D3	WD	PT	F1	PT	-	PRIVACY LOCKSET	
51	21 - 8"	6'-8"	D4	WD	PT	-	PT		PRIVACY LOCKSET	
52	21-61	6' - 8"	D3	WD	PT	F1	PT		PRIVACY LOCKSET	
54	9'-0"	7'-0"	-	PER OWNER	PER OWNER		-	-		GARAGE DOORS - OWNER SELECTED
56	9'-0"	7'-0"		PER OWNER	PER OWNER	-		-		GARAGE DOORS - OWNER SELECTED
57	21 - 8 ^{rt}	6'-8"	D3	WD	PT	F1	PT			
58	21 - 8"	6' - 8"	D3	WD	PT	F1	PT	-	PRIVACY LOCKSET	
59	21 - 811	6'-8"	D3	WD	PT	F1	PT	-	-	
61	3'-0"	6'-8"	D3	WD	PT	F1	PT	-	PRIVACY LOCKSET	
64	12* - 0**	6'-8"	D5	ALUM	G1		PRE-FINISHED	-	LOCKSET	
65	3'-0"	6' - 8"	D4	WD	PT	-	PT		PRIVACY LOCKSET	
66	3'-0"	61-8"	D4	WD	PT		PT			DOOR LOCATED BETWEEN MASTER SUITE 8

FRAME TYPE

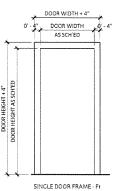

FEATHERSTON | STUDIO IIc

p.o. box 170024 austin, texas 78717

DECEMBER 11, 2015


ph: 512 740 4234

DOOR & HARDWARE NOTES

- ALL EXISTING DOORS TO BE SALVAGED OR REINSTALLED TO BE REPAIRED FROM ANY DAMAGE, WORN AREAS OR SCRATCHES.
 DOOR STOPS ARE TO BE WALL MOUNTED UNLESS OTHERWISE NOTED IN DOOR SCHEDULE REMARKS, PROVIDE BLOCKING INSIDE WALL FOR STOPS.
 EGRESS DOORS SHALL BE READILY OPENABLE FROM THE EGRESS SIDE WITHOUT THE USE OF A KEY, KEYCARD, OR COMBINATION. THE MAIN EXTERIOR DOOR IS
- PERMITTED TO BE EQUIPPED WITH KEY OPERATED LOCKING DEVICES OR DEADBOLTS FROM THE EGRESS SIDE PROVIDED THAT THE LOCKING DEVICE IS READILY DISTINGUISHABLE AS LOCKED AND A READILY VISIBLE DURABLE SIDE ON THE EGRESS SIDE OF THE LATCH OR ADJACENT TO THE DOOR STATING "THIS DOOR TO REMAIN UNLOCKED WHEN BUILDING IS OCCUPIED." THE SION SHALL BE 1" HIGH LETTERS ON A CONTRASTING BACKGROUND.


 ALL EXISTING DOORS TO RECEIVE BUILDING STANDARD LEVER HANDLES.

DOOR TYPES

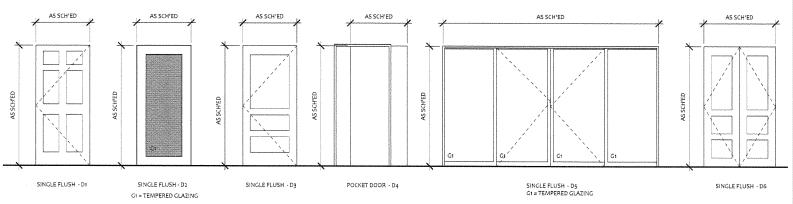

					WIND	OOW SCHEDUL	E
	WIN	DOW	HEAD	GLAZING	R	.O.	
TYPE	WDTH	HEIGHT	HEIGHT	THICKNESS	HEIGHT	WIDTH	Comments
W1	4' - 2 1/2"	5' - 1"	6' - 9"	LOW E SUN GLASS	5' - 1 1/2"	4' - 3"	BASES OF DESIGN, ANDERSEN VINYL-CLAD HUNG WINDOW; CONTRACTOR TO MATCH EXISTING
W2	2' - 11"	5' - 1*	6' - 9"	LOW E SUN GLASS	5' - 1 1/2"	2' - 11 1/2"	BASES OF DESIGN, ANDERSEN VINYL-CLAD HUNG WINDOW; CONTRACTOR TO MATCH EXISTING
W3	2' - 11"	2' - 9*	6' - 9"	LOW E SUN GLASS	2' - 9 1/2"	2' - 11 1/2"	BASES OF DESIGN; ANDERSEN VINYL-CLAD HUNG WINDOW

WINDOW FRAME TYPES

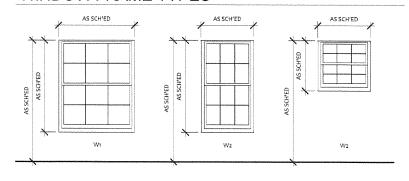

NICOLE KESSLER **GASTON REMODEL**

1605 GASTON AVE. AUSTIN, TEXAS 78703

DATE

DESCRIPTION **PERMIT**

DRAWINGS


PROJECT NUMBER


DOOR & WINDOW INFORMATION

SHEET NUMBER

DETAIL - WALL PENETRATION
3" = 1'-0"

VENT OPENING

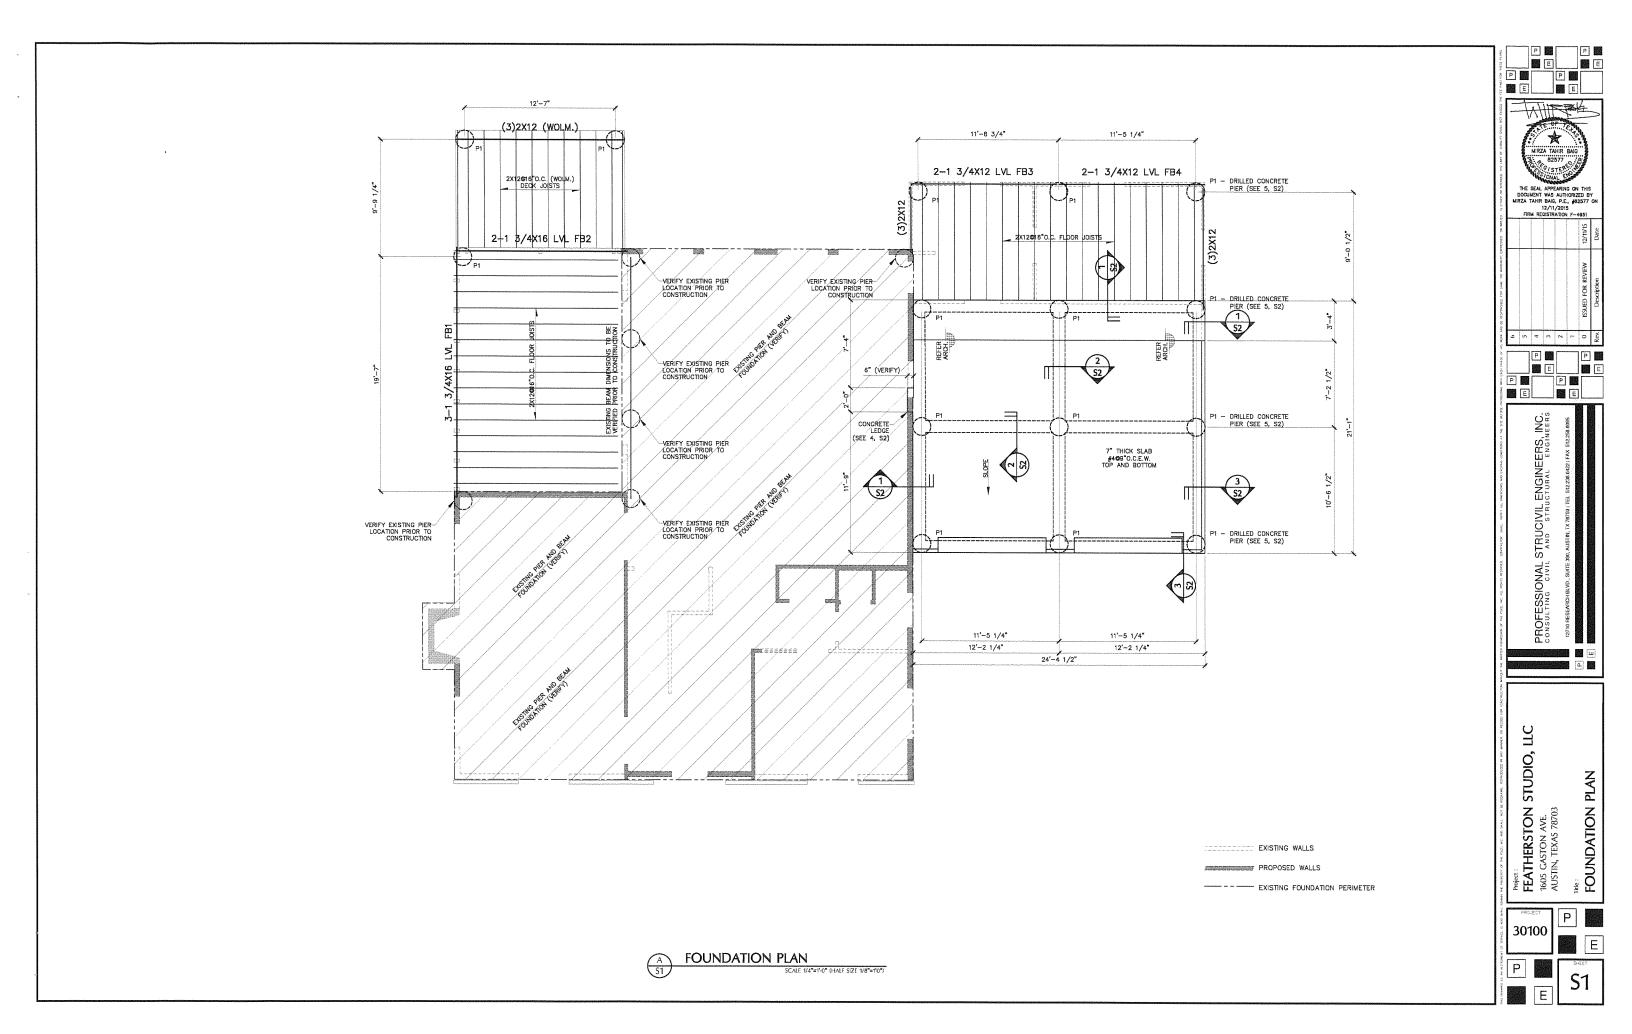

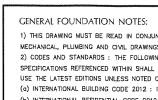

- 1) THIS DRAWING MUST BE READ IN CONJUNCTION WITH ALL ARCHITECTURAL, ELECTRICAL, MECHANICAL, PLUMBING AND CIVIL DRAWINGS.
- 2) CODES AND STANDARDS: THE FOLLOWING CODES AND STANDARDS, INCLUDING ALL SPECIFICATIONS REFERENCED WITHIN SHALL APPLY TO ALL WORK PERFORMED ON THIS PROJECT. USE THE LATEST EDITIONS UNLESS NOTED OTHERWISE.
- (a) INTERNATIONAL BUILDING CODE 2012 : INTERNATIONAL CODE COUNCIL
- (b) INTERNATIONAL RESIDENTIAL CODE 2012: INTERNATIONAL CODE COUNCIL
- (c) MINIMUM DESIGN LOADS FOR BUILDINGS AND OTHER STRUCTURES (ASCE-7). AMERICAN SOCIETY OF CIVIL ENGINEERS.
- (d) BUILDING CODE REQUIREMENTS FOR STRUCTURAL CONCRETE (ACI 318-14): AMERICAN CONCRETE INSTITUTE. (e) RESIDENTIAL CODE REQUIREMENTS FOR CONCRETE (ACI 332-14) AND COMMENTARY
- AMERICAN CONCRETE INSTITUTE.
- (f) STEEL CONSTRUCTION MANUAL (14th. EDITION) : AMERICAN INSTITUTE OF STEEL CONSTRUCTION.
- 3) DESIGN DATA
- (a) GRAVITY SUPERIMPOSED DEAD LOADS ROOF TILES 25 PSF ROOF COMPOSITION 15 PSF ROOF METAL 15 PSF FLOOR LOAD 25 PSF 24 PSF (2" CONCRETE) CONCRETE TILES (b) GRAVITY - LIVE LOADS FLOOR 40 PSF BALCONY 100 PSF (MORE THAN 100 SQ.FT.) ROOF 20 PSF ATTICS 10 PSF (WITHOUT STORAGE) ATTICS 20 PSF (WTH STORAGE)

4) MATERIALS

(a) CONCRETE STRENGTH 3,000 PSI, CONCRETE SHALL CONFORM TO ACI 301 & ASTM C39/C39M. ALSO ASTM C150/C150M, C595/C595M, OR C1157/C1157M.

- (b) DEFORMED STEEL REINFORCEMENT BARS SHALL CONFORM TO ASTM A615/A615M.
- A706/A706M, OR A996/A996M. THE YIELD STRENGTH OF REINFORCEMENT SHALL BE 60,000 PSI. (c) FORMWORK SHALL CONFORM ACI-347 AND ACI SP-4 FOR GUIDANCE ON DESIGN AND CONSTRUCTION OF FORMWORK.
- 5) CONCRETE COVER SHALL HAVE A TOLERANCE OF (+/-)3/8".

(a) CONCRETE CAST AGAINST EARTH (b) NOT EXPOSED TO EARTH OR WEATHER 3/4" (c) BARS NOT LARGER THAN NO.5 & EXPOSED TO EARTH OR WEATHER 1 1/2" (d) NOT SMALLER THAN NO.6 & EXPOSED TO EARTH OR WEATHER

6) DEFORMED REINFORCEMENT BARS DEVELOPMENT LENGTH SHALL BE:

BAR DIA LENGTH 24" 30" 38" 53" 60"

7) ALL EXTERIOR WALLS AND LOAD BEARING WALLS SHALL HAVE 1/2" DIA X8" LONG ANCHOR BOLTS AT 36" O.C. OR EQUAL.

8) PROVIDE #5 CORNER BARS AT EACH HORIZONTAL REINFORCEMENT ON WALL AND GRADE BEAMS.

9) BUILDING SUBGRADE PREPARATION AND FARTHWORK OPERATIONS:

(a) SELECTION OF FILL MATERIAL SHALL BE GUIDED BY THE FOLLOWING CRITERIA: MAXIMUM PLASTICITY INDEX: 15 MINIMUM PLASTICITY INDEX: 3 MINIMUM AND MAXIMUM PASSING #200 SIEVE : 10% TO 70% NO STONES LARGER THAN 2"


(b) ANY EXISTING VEGETATION, TOPSOIL, TREES, AND DEBRIS SHALL BE STRIPPED AND REMOVED FROM THE PROPOSED BUILDING FOOTPRINT(S). EXISTING TREE ROOTS AND STUMPS SHALL BE GRUBBED AND REMOVED FROM THE SITE.

(c) THE SELECT FILL MATERIAL SHALL BE PLACED UP TO THE REQUIRED FINAL BUILDING PAD ELEVATIONS, ALL FILL SHALL BE PLACED IN EIGHT (8) INCH MAXIMUM THICK LOOSE LIFTS. SELECT FILL SHALL BE COMPACTED TO AT LEAST 95 PERCENT OF THE MAXIMUM DRY DENSITY AS DETERMINED IN ACCORDANCE WITH ASTM D698. COMPACTION TESTS SHALL BE PERFORMED BY A PROFESSIONAL GEOTECHNICAL ENGINEER.

(d) IMPORTED SELECT FILL SHALL BE AN APPROVED INORGANIC MATERIAL, FREE OF DEBRIS. 10) SITE SLOPE SHALL CAUSE WATER TO FLOW AWAY FROM THE STRUCTURE FOUNDATION FOR A MINIMUM DISTANCE OF TEN (10) FEET. CONTRACTOR SHALL BE RESPONSIBLE FOR SITE DRAINAGE SYSTEM, AND DIVERT RUN-OFF AWAY FROM THE FOUNDATION STRUCTURE.


SITE SPECIFIC FOUNDATION NOTES:


- 1) REFER TO GEOTECHNICAL REPORT (ENGINEER'S JOB #) 15104100.388 PREPARED FOR THE SITE NOVEMBER OF 2015 BY MILA GEOTECHNICAL FOR SPECIFICATIONS REGARDING UNDERSLAB FILL PROPERTIES AND PLACEMENT PROCEDURES.
- 2) THE GEOTECHNICAL ENGINEER SHALL BE RETAINED TO REVIEW THE FOUNDATION DESIGN FOR THE STRUCTURE AND TO EVALUATE THE CONSTRUCTION PROCEDURES UTILIZED ON SITE TO ENSURE THAT THEY ARE IN ACCORDANCE WITH THE RECOMMENDATIONS PROVIDED IN THE AFOREMENTIONED GEOTECHNICAL REPORT.
- 3) VOID CARTONS SHALL BE UTILIZED TO PROVIDE A 12" VOID SPACE BETWEEN SOIL AND THE BOTTOM OF SUSPENDED FOUNDATION ELEMENTS. SOIL RETAINERS SHALL ALSO BE UTILIZED TO MAINTAIN THE VOID SPACE WHERE SUSPENDED FOUNDATION ELEMENTS ARE NOT FORMED AT LEAST 12" ABOVE THE FINISH GRADE SOIL LEVEL.

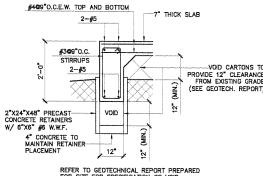

SECTION


#469"O.C.E.W. TOP AND BOTTOM 2-#5 PROVIDE 12" CLEARANCE FROM EXISTING GRADE 2"X24"X48" PRECAST CONCRETE RETAINERS W/ 6"X6" #6 W.W.F. VOID 12" FOR SITE FOR SPECIFICATION OF VOID CARTONS AND RETAINER INSTALLATION

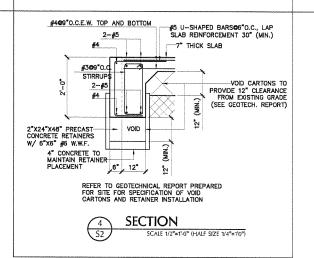

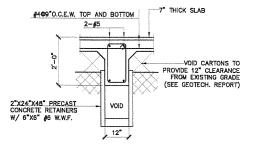


REFER TO GEOTECHNICAL REPORT PREPARED FOR SITE FOR SPECIFICATION OF VOID CARTONS AND RETAINER INSTALLATION



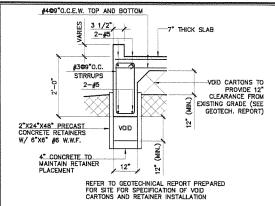



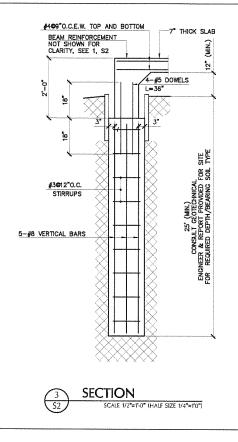



DETAILS

FOUNDATION

THE SEAL APPEARING ON THE INCLUMENT WAS AUTHORIZED B' IRZA TAHIR BAIG, P.E., #82577 12/11/2015 FIRM REGISTRATION F-4851

0 2 4 6

P

EL

ENGINEERS,

STRUCIVIL AND STRE

PROFESSIONAL



GENERAL FRAMING NOTES

GENERAL FRAMING NOTES

1) THIS DRAWING MUST BE READ IN CONJUNCTION WITH ARCHITECTURAL ELECTRICAL, PLUMBING, MECHANICAL, AND AIR—CONDITIONING DRAWINGS.
2) 2) QUALITY AND DESIGN: THE QUALITY AND DESIGN OF WOOD MEMBERS AND THEIR FASTEMINGS SHALL CONFORM TO THE PROVISIONS OF IRC CODE AND APPLICABLE STANDARDS USED IN IRC.
3) 3) WORKMANSHIP: ALL MEMBERS SHALL BE FRAMED, AANCHORED, TIED AND BRACED WHICH THEY ARE USED.
4) 4) FABRICATION: PREPARATION, FABRICATION AND INSTALLATION OF WOOD MEMBERS AND THEIR FASTEWINGS SHALL CONFORM TO ACCEPTED ENGINEERING PRACTICES AND TO THE REQUIREMENTS OF 2012 IRC CODE.
5) 5) MINIMUM QUALITY: MINIMUM CAPACITY OF STRUCTURAL FRAMING MEMBERS MAY BE ESTABLISHED BY PERFORMANCE TESTS, WHEN TESTS ARE NOT MADE, CAPACITY SHALL BE BASED UPON ALLOWABLE STRESSES AND DESIGN CRITERIA SPECIFIED IN IRC CODE. STUDS, JOISTS, RAFTERS, FOUNDATION PLATES OR SILLS, PLANKING 2 INCHES OR MORE IN DEPTH, BEAMS, STRINGERS, POSTS, STRUCTURAL SHEATHING AND SIMILAR LOAD BEARING MEMBERS SHALL BE OF AT LEAST THE MINIMUM GRADES SET FORTH IN 2012 IRC TABLE, PLYWOOD SHALL BE SPECIES GROUP 1, 2, 3 OR 4 AND SHALL BE ONE OF THE GRADES SPECIFIED IN IRC. PARTICLEBOAND SHALL CONFORM TO 2012 IRC. APPROVED FIRE—RETARDANT TREATED WOOD SHALL BE ORDED, FOLLOWING TREATMENT, TO A MAXIMUM MOISTURE CONTENT AS FOLLOWS:
5) SHRINKAGE: CONSIDERATION TO THE POSSIBLE EFFECT OF CROSS—GRAN DIMENSIONAL CHANGES CONSIDERED VERTICALLY WHICH MAY OCCUR IN LUMBER FABRICATED IN A GREEN CONDITION.
7) HANGERS ALL METAL ANCHORS, FASTENS AND CONNECTORS—CRAIN DIMENSIONAL CHANGES CONSIDERED VERTICALLY WHICH MAY OCCUR IN LUMBER FABRICATED IN A GREEN CONDITION.
7) HANGERS ALL METAL ANCHORS, FASTENS AND CONNECTORS—CRAIN DIMENSIONAL CHANGES CONSIDERED VERTICALLY WHICH MAY OCCUR IN LUMBER FABRICATED IN A GREEN CONDITION.
7) HANGERS ELL METAL ANCHORS, FASTENS AND CONNECTORS—CRAIN DIMENSIONAL CHANGES CONSIDERED VERTICALLY WHICH MAY OCCUR IN LUMBER FABRICATED IN A GREEN CONDITION.
7) STRISSESS EXCEPT AS HEREINAFTER PROVIDED, STRESSES SHALL BOT EXCEPT THE ALLOWABLE

BESIGN AND LOAD VALUES.

8) STRESSES: EXCEPT AS HEREINAFTER PROVIDED,
STRESSES SHALL NOT EXCEED THE ALLOWABLE UNIT
STRESSES FOR THE RESPECTIVE SPECIES AND GRADES OR
FABRICATED AS SET FORTH IN IRC CODE FOR LUMBER, AND
STRUCTURAL GLUED—LAMINATED TIMBER.

A) HEADERS, RAFTERS & JOISTS
Fb = 1200 PSI SINGLE MEMBER
Fb = 1400 PSI REPETITIVE MEMBER
FV = 90 PSI

B) STUD & WALL MEMBERS
Fb = 900 PSI FOR 2X4
Fc = 575 PSI FOR 2X4
Fb = 850 PSI FOR 2X6, 2X8
Fc = 625 PSI FOR 2X6, 2X8

C) GLUE LAMINATED BEAMS (GL)

Fb = 2400 PSI

Fv = 200 PSI

Fc = 385 PSI PERPENDICULAR

Fc = 1500 PSI PARALLEL

D) MICRO-LAM (LVL) Fb = 2900 PSI Fv = 290 PSI

9) CONTRACTOR IS RESPONSIBLE TO VERIFY ALL EXISTING CONDITIONS AND NOTIFY THE ENGINEER IMMEDIATELY IN CASE OF DISCREPANCY.

HIP & VALLEY TABLE

SPAN	SIZE
10-0"	2X8
12'-0"	2X10
14'-0"	2X12
16'-0"	(2)2X12
18'-0"	(3)2X12
20'-0"	(3)2X12
22'-0"	3 1/8X13 1/2GL

CEILING JOIST TABLE

SPAN	CLG. JOIST
13'-0"	2X8@16"O.C.
16'-0"	2X8@16"O.C.
18'-0"	2X10@16"0.C.
20'-0"	2X12 © 16"0.C.


FLOOR LOADS LIVE LOAD=40 PSF MISC. LOAD=25 PSF TOTAL LOAD=65 PSF

TOTAL ULTIMATE LOAD=94 PSF

ROOF LOADS MISC. LOAD=15 PSF (COMPOSITION)

TOTAL LOAD=35 PSF TOTAL ULTIMATE LOAD=50 PSF

ALL INTERIOR STUD WALLS TO BE 2X4 © 16° O.C. U.N.O. ALL EXTERIOR STUD WALLS TO BE 2X4 © 16° O.C. U.N.O. ALL STUD WALLS BELOW ARE SHOWN IN FULL. ALL STUD WALLS ABOVE ARE SHOWN IN DOTTED. ALL STUD WALLS ADOVE APE SHOWN IN DOTTED. ALL STUD WALLS TO BE 9'-1" U.N.O.

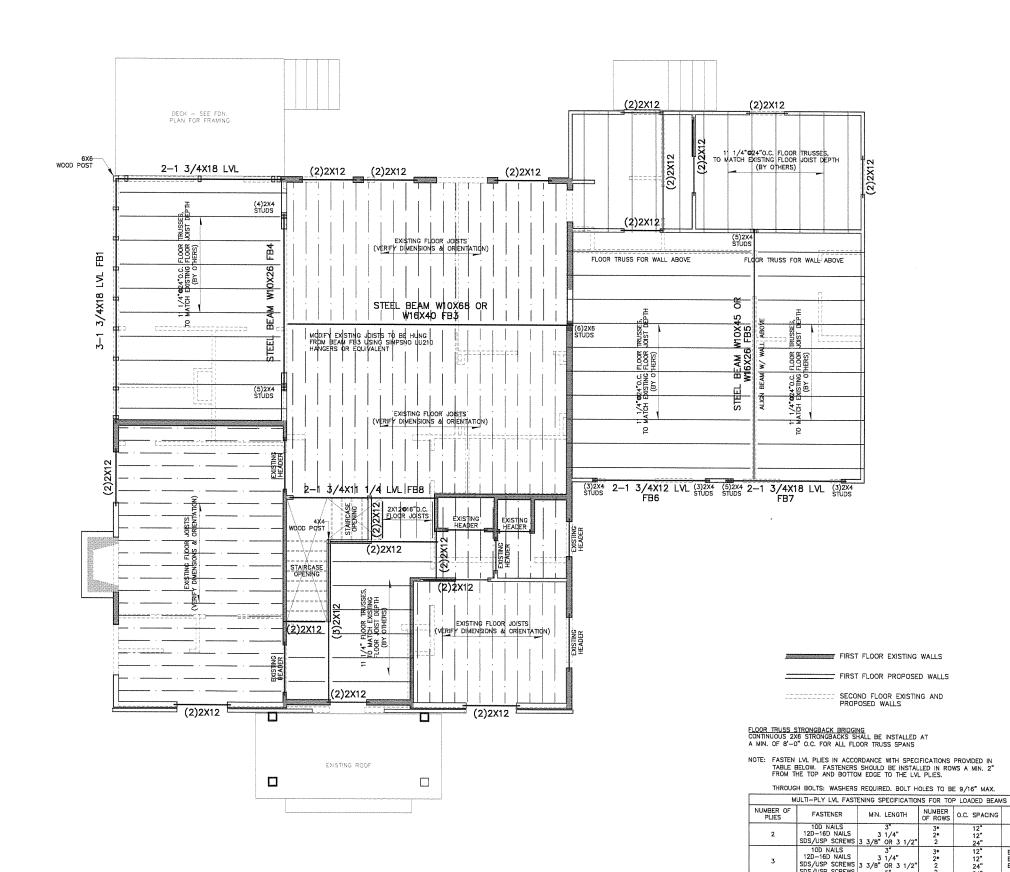

TATHE * MIRZA TAHIR BAN THE SEAL APPEARING ON THI DOCUMENT WAS AUTHORIZED E IRZA TAHIR BAIG, P.E., \$82577 12/11/2015 FIRM REGISTRATION F-4951 P E STRUCIVIL AND STRU PROFESSIONAL PLAN STUDIO, FLOOR Fejet: FEATHERSTON S 1605 GASTON AVE AUSTIN, TEXAS 78703 30100

NUMBER OF ROWS O.C. SPACING

12" 12" 24" 24"

3

SDS/USP SCREWS

10D NAILS 12D-16D NAILS SDS/USP SCREWS

SDS/USP SCREWS

6 3/4" *BEAM DEPTHS EXCEEDING 14" REQUIRE AN ADDITIONAL ROW OF FASTENERS

FASTENER LOCATION

ONE SIDE

BOTH SIDES BOTH SIDES BOTH SIDES ONE SIDE

ONE SIDE (PER PLY) BOTH SIDES ONE SIDE

SECOND FLOOR FRAMING PLAN

GENERAL FRAMING NOTES

THIS DRAWING MUST BE READ IN CONJUNCTION WITH ARCHITECTURAL, ELECTRICAL, PLUMBING, MECHANICAL, AND AIR—CONDITIONING DRAWINGS.

AIR-CONDITIONING DRAWINGS.
2) 20 JUALITY AND DESIGN: THE QUALITY AND DESIGN OF WOOD MEMBERS AND THEIR FASTENINGS SHALL CONFORM TO THE PROVISIONS OF IRC CODE AND APPLICABLE STANDARDS USTED IN IRC.
3) 3) WORKMANSHIP: ALL MEMBERS SHALL BE FRAMED, ANCHORED, TIED AND BRACED WHICH THEY ARE USED.
4) 4) FABRICATION: PREPARATION, FABRICATION AND INSTALLATION OF WOOD MEMBERS AND THEIR FASTENINGS SHALL CONFORM TO ACCEPTED ENGINEERING PRACTICES AND THE REQUIREMENTS OF 2012 IRC CODE.

SHALL CONFORM TO ACCEPTED ENGINEERING PRACTICES
AND TO THE REQUIREMENTS OF 2012 IRC CODE.
5) S) MINIMUM QUALITY: MINIMUM CAPACITY OF
STRUCTURAL FRAMING MEMERS MAY BE ESTABLISHED BY
PERFORMANCE TESTS. WHEN TESTS ARE NOT MADE.
CAPACITY SHALL BE BASED UPON ALLOWABLE STRESSES
AND DESIGN CRITERIA SPECIPED IN IRC CODE. STUDS,
JOISTS, RAFTERS, FOUNDATION PLATES OR SILLS, PLANKING
2 INCHES OR MORE IN DEPTH, BEAMS, STRINGERS, POSTS,
STRUCTURAL SHEATHING AND SIMILAR LOAD BEARING
MEMBERS SHALL BE OF AT LEAST THE MINIMUM GRADES
SET FORTH IN 2012 IRC TABLE. PLYWOOD SHALL BE
SPECIES GROUP 1, 2, 3 OR 4 AND SHALL BE ONE OF THE
GRADES SPECIFIED IN IR.C. PARTICLEDBARD SHALL
CONFORM TO 2012 IRC. APPROVED FIRE-RETARDANT
TREATED WOOD SHALL BE DRIED, FOLLOWING TREATMENT, TO
A MAXIMUM MOISTURE CONTENT AS FOLLOWS:
SOLID-SAWN LUMBER 2 INCHES IN THICKNESS OR LESS TO
19 PERCENT, AND PLYWOOD TO 15 PERCENT.
6) SWRINKAGE: CONSIDERATION SHALL BE GIVEN IN
CONSTRUCTION AND FABRICATION TO THE POSSIBLE EFFECT
OF CROSS-GRAIN DIMENSIONAL CHANGES CONSIDERED
VERTICALLY WHICH MAY OCCUR IN LUMBER FABRICATED IN
A GREEN CONDITION.
7) HANGERS: ALL METAL ANCHORS, FASTENS AND
CONNECTORS ETC. SPECIFIED ON PLANS SHALL BE FROM
SIMPSON CO. OR AM APPROVED EQUAL IN STRUCTURAL
DESIGN AND LOAD VALUES.
8) STRESSES: EXCEPT AS HEREINAFTER PROVIDED.
STRESSES: EXCEPT AS HEREINAFTER PROVIDED.

DESIGN AND LOAD VALUES.

8) STRESSES: EXCEPT AS HEREINAFTER PROVIDED,
STRESSES SHALL NOT EXCEED THE ALLOWABLE UNIT
STRESSES FOR THE RESPECTIVE SPECIES AND GRADES OR
FABRICATED AS SET FORTH IN IRC CODE FOR LUMBER, AND
STRUCTURAL GLUED—LAMNATED TIMBER.

A) HEADERS, RAFTERS & JOISTS
Fb = 1200 PSI SINGLE MEMBER
Fb = 1400 PSI REPETITIVE MEMBER
FV = 90 PSI

B) STUD & WALL MEMBERS Fb = 900 PSI FOR 2X4 Fc = 575 PSI FOR 2X4 Fb = 850 PSI FOR 2X6, 2X8 Fc = 625 PSI FOR 2X6, 2X8

C) GLUE LAMINATED BEAMS (GL)

Fb = 2400 PSI

Fv = 200 PSI

Fc = 385 PSI PERPENDICULAR

Fc = 1500 PSI PARALLEL

D) MICRO-LAM (LVL) Fb = 2900 PSI Fv = 290 PSI

9) CONTRACTOR IS RESPONSIBLE TO VERIFY ALL EXISTING CONDITIONS AND NOTIFY THE ENGINEER IMMEDIATELY IN CASE OF DISCREPANCY.

HIP & VALLEY TABLE

SPAN	SIZE
10-0"	2X8
12'-0"	2X10
14'-0"	2X12
16'-0"	(2)2X12
18'-0"	(3)2X12
20'-0"	(3)2X12
22'-0"	3 1/8X13 1/2GL

CEILING JOIST TABLE

SPAN	CLG. JOIST
13'-0"	2X8@15"O.C.
16'-0"	2X8@16"O.C.
18'-0"	2X10@16"O.C.
20'-0"	2X12@16"0.C.

FLOOR LOADS LIVE LOAD=40 PSF MISC. LOAD=25 PSF TOTAL LOAD=65 PSF

TOTAL ULTIMATE LOAD=94 PSF


ROOF LOADS LIVE LOAD=20 PSF MISC. LOAD=15 PSF (COMPOSITION)

TOTAL LOAD=35 PSF TOTAL ULTIMATE LOAD=50 PSF

NOTES:

ALL PROPOSED INTERIOR STUD WALLS TO BE 2X4 © 16" O.C. U.N.O. ALL PROPOSED EXTERIOR STUD WALLS TO BE 2X4 © 16" O.C. U.N.O. ALL STUD WALLS BELOW ARE SHOWN IN FULL.

ALL STUD WALLS ABOVE ARE SHOWN IN DOTTED.
ALL STUD WALLS TO BE 9'-1" U.N.O.

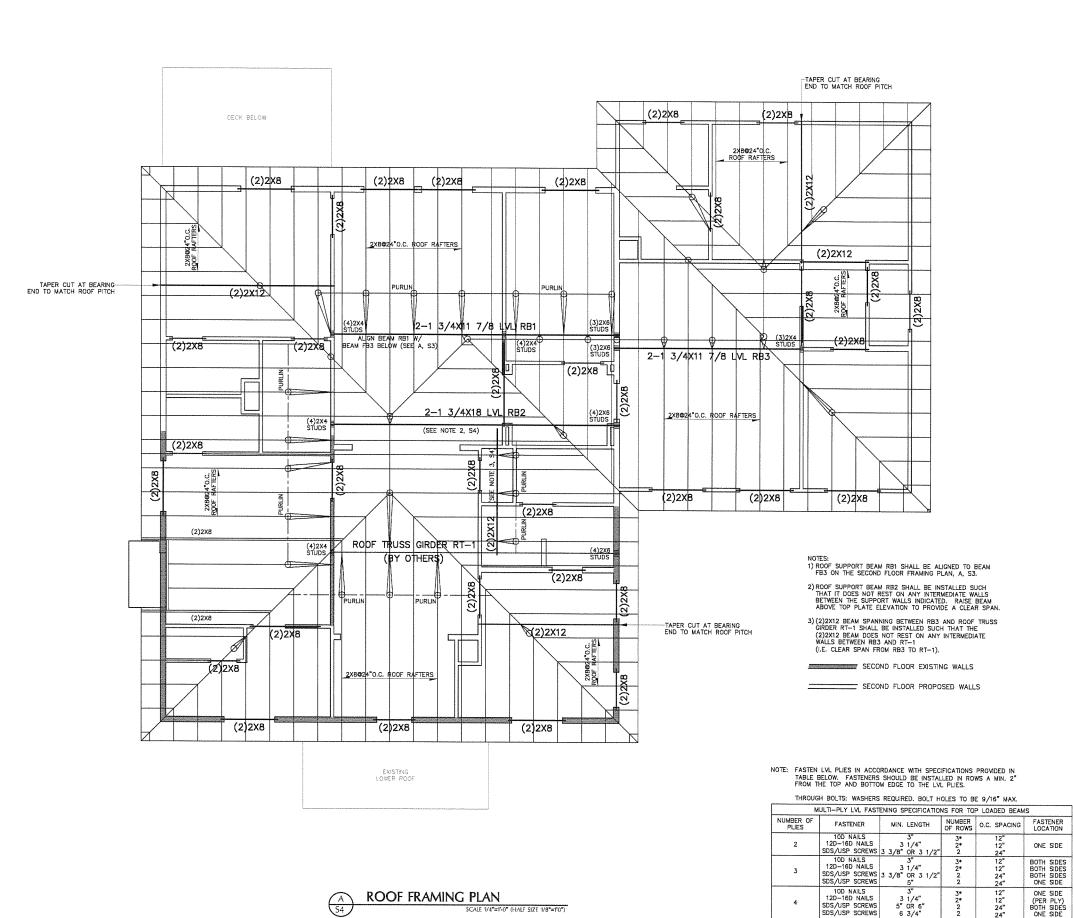


SCALE 1/4"=1"-0" (HALF SIZE 1/8"=1"0")

SDS/USP SCREWS

6 3/4" *BEAM DEPTHS EXCEEDING 14" REQUIRE AN ADDITIONAL ROW OF FASTENERS

E MITTER * MIRZA TAHIR BA THE SEAL APPEARING ON THE FIRM REGISTRATION F-4951 Р P EL ENGINEERS, STRUCIVIL AND STRU PROFESSIONAL CONSULTING CIVIL STUDIO, FEATHERSTON S 1605 GASTON AVE AUSTIN, TEXAS 78703 Title: ROOF 30100 Р

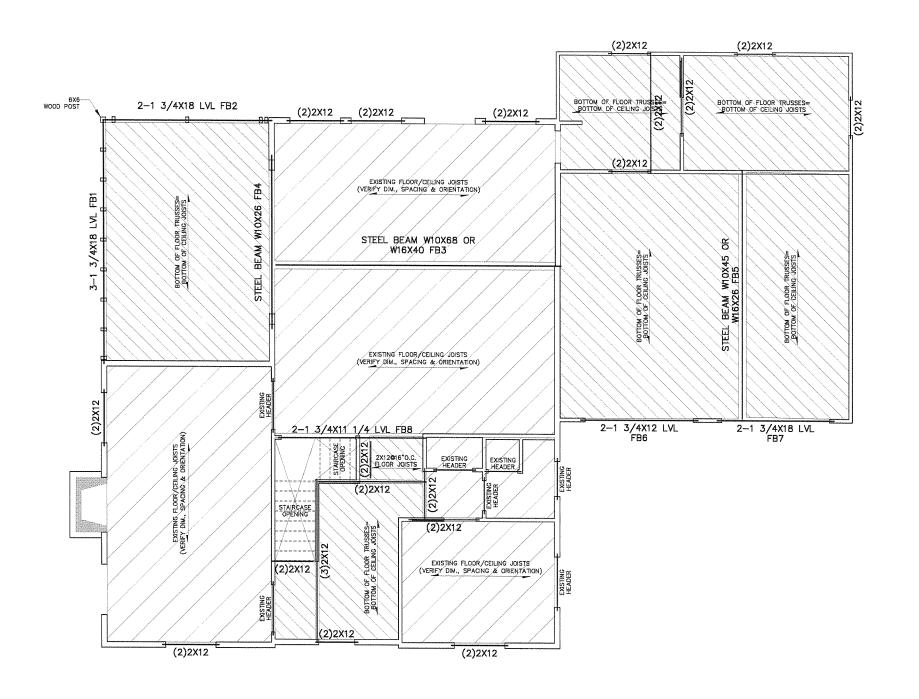

E P E

PROFESSIONAL STRUCIVIL ENGINEERS, INC.

18t. FLR. CEILING FRAMING PLAN


E

Project:
FEATHERSTON STUDIO, LLC
1605 GASTON AVE.
AUSTIN, TEXAS 78703

30100

CEILING	JOIST	TABLE

CEILING JOIST TABLE		
SPAN	CLG. JOIST	
13'-0"	2X8@16"O.C.	
16'-0"	2XB@16*0.C.	
18'0"	2X10 © 16"0.C.	
20'~0"	2X12 6 16"0.C.	

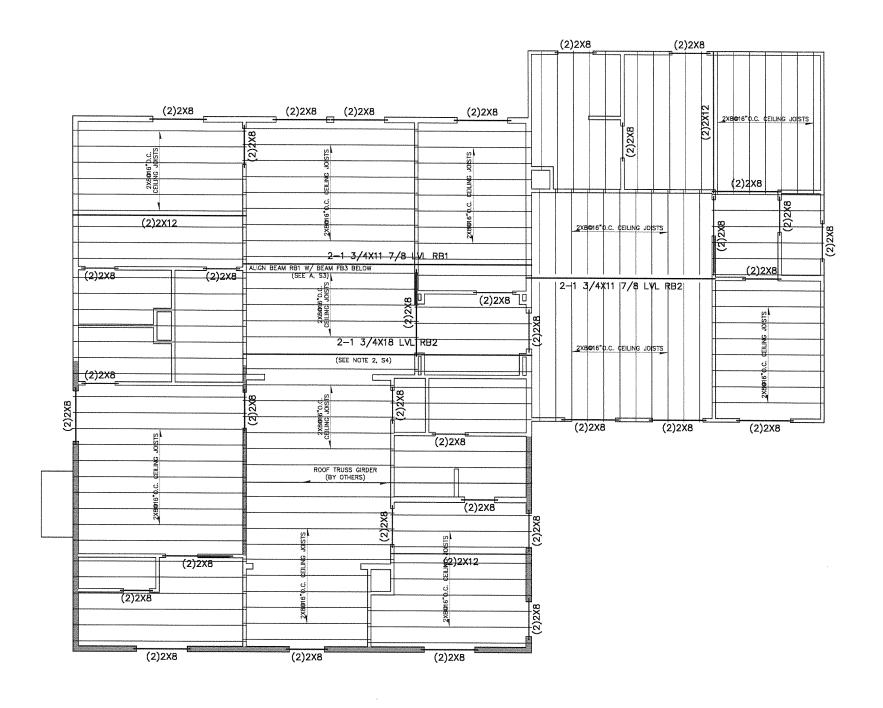

PE

PROFESSIONAL STRUCIVIL ENGINEERS, INC. CONSULTING CIVIL AND STRUCTURAL ENGINEERS

FEATHERSTON STUDIO, LLC
1605 GASTON AVE.
AUSTIN, TEXAS 78703
THE:
2nd. FLR. CEILING FRAMING PLAN

E

S6

30100

Ε

PE

CEILING	IOIST	TABLE

CEREIT TO JOID! TABLE		
	SPAN	CLG. JOIST
	13'-0"	2X8@16"O.C.
	16'-0"	2X8@16*O.C.
	18'-0"	2X10@16"O.C.
	20'-0"	2X12@16"0.C,



