

City of Austin Residential New Construction and Addition Permit Application Residential Review, 2nd floor, One Texas Center 505 Barton Springs, Austin, TX 78704 (512) 978-4000

Property Information	
Project Address: 2301 Rundell Place Austin TX 78704	Tax Parcel ID: 0102090201
Legal Description: LOT 4 *& N 5.5 FT OF LOT 3 STENGER A D A	DDN
Zoning District: SF-3	Lot Area (sq ft): 9,225.00
Neighborhood Plan Area (if applicable): Zilver	Historic District (if applicable):
Required Reviews	
	Does project have a Green Building requirement? Y N (If yes, attach signed conditional approval letter from Austin Energy Green Building)
Is this site within an Airport Overlay Zone? Y N (If yes, approval through Aviation is required)	Does this site have a septic system? Y N (If yes, submit a copy of approved septic permit)
Does the structure exceed 3,600 square feet total under roof? Is this property within 200 feet of a hazardous pipeline? Y	N (If yes, Fire review is required) N (If yes, Fire review is required)
Is this site located within an Erosion Hazard Zone? Y N Is t (If yes, EHZ review is required)	his property within 150 feet of the 100 year floodplain? Y N (Proximity to floodplain may require additional review time.)
Note: Include tree location(s) on plot plan.	N (If yes, application for a tree permit with the <u>City Arborist</u> is required)
Is this site within the Residential Design and Compatibility Standards C	Ordinance Boundary Area? (LDC 25-2 Subchapter F) W N
Does this site currently have: water availability? Wastewater availability? Y N	(If no, contact Austin Water Utility to apply for water/wastewater taps and/or service extension request.)
Are there existing water/wastewater infrastructure, appurtenances or ex (If yes, contact Austin Water Utility Pipeline Engineering for review and approval)	isting water/wastewater easements located on site? Y N
Does this site have or will it have an auxiliary water source? Y (Auxiliary water supplies are wells, rainwater harvesting, river water, lake water, reclaim	N (If yes, submit approved auxiliary and potable plumbing plans.) ed water, etc.)
Does this site require a cut or fill in excess of four (4) feet? Y N	(If yes, contact the Development Assistance Center for a Site Plan Exemption)
	e within the Lake Austin Overlay? Y N
	e adjacent to a paved alley? Y N rks approval required to take access from a public alley.)
Does this site have a Board of Adjustment (BOA) variance? Y Does this site have a Residential Design and Compatibility Commission (If yes, provide a copy of decision sheet. Note: A permit cannot be approved within 10 of Description of Work	
Existing Use: vacant single-family residential duplex	residential two-family residential other:
Proposed Use: vacant single-family residential duplex	residential two-family residential other:
Project Type: new construction addition	addition/remodel other:
Will all or part of an existing exterior wall, structure, or roof be remove (Note: Removal of all or part of a structure requires a demolition permit application.)	• • • • • • • • • • • • • • • • • • • •
# of existing bedrooms: 2 # of bedrooms upon completion: 3	# of baths existing: 2.0 # of baths upon completion:
Project Description: (Note: Please provide thorough description of project. Attach a See Attached Sheet.	dditional pages as necessary.)
Trades Permits Required (Circle as applicable): electric plum	nbing mechanical (HVAC) concrete (R.O.W.)

Job Valuation								
Job valuation				111.1		CT-4-1 I-1 37-		
Total Job Valuation: \$ 100,000 -0	Amount of Total Job Va and/or New Construction		- APP	Addition	dedicated	f Total Job Va to all Remode	l/Repair:	
Note: The total job valuation should be	Amount for Primary Str		\$ 60,0					
the sum total of all valuations noted to the right. Labor and materials only,	Elec: Y N Plmbg: Y N Mech: Y		ZY DN	Plmbg: \$ (0,000—		0-		
rounded to nearest dollar. Permit fees				\$ 5,000-				
are based on adopted fee schedule.	Elec: Y N Plmt	og: LJY L	JN Mech: L	□Y □N	TOTAL: \$	40,00	0,000	
Please utilize the Calculation following calculation	n Aid on the last page culations and to provi						plete the	
Site Development Information	on	W. T. S	****					
Area Description Note: Provide a separate calculation for ea	ach distinct area. Attach	Existing Sq Ft New/Added Sq Ft		Total S	Total Sq Ft			
additional sheets as necessary. Measurement of the exterior wall.		Bldg 1	Bldg 2	Bldg 1	Bldg 2	Bldg 1	Bldg 2	
a) 1 st Floor conditioned area		1,431.00		607.00		2,038.00	0.00	
b) 2 nd Floor conditioned area				295.00		295.00	0.00	
c) 3 rd Floor conditioned area						0.00	0.00	
d) Basement						0.00	0.00	
e) Covered parking (garage or ca	rport)			272.00		272.00	0.00	
f) Covered patio, deck, porch,	and/or balcony area(s)			29.00		29.00	0.00	
g) Other covered or roofed are	a			129.00		129.00	0.00	
h) Uncovered wood decks				202.00		202.00	0.00	
Total Building Area (total a	through h)	1,431.00	0.00	1,534.00	0.00	2,965.00	0.00	
i) Pool						0.00	0.00	
j) Spa Building Coverage Information						0.00	0.00	
Note: Building Coverage means the area of incidental projecting eaves, balconies, and Total Building Coverage (sq ft):	of a lot covered by buildings or d similar features. Pools, ponds,		are not included				cilities,	
Impervious Cover Information								
Note: Impervious cover is the total horizo gravel placed over pervious surfaces that boards and that is located over a pervious	are used only for landscaping of	r by pedestriar	s. For an uncover	red wood deck the	at has drainage	spaces between th	ne deck	
Total Impervious Cover (sq ft): 3	3,138.00 % of	f lot size: 3	4				1	
Setbacks								
Are any existing structures on thi (LDC 25-2-492)	s site a non-compliant str	ucture base	d on a yard se	tback requirer	ment?	Y N		
Does any structure (or an element Is front yard setback averaging be						Y N Y N		
Height Information (LDC 25-1-21	or 25-2 Subchapter F, Section	3.4) P	arking (LDC 2	25-6 Appendix A	& 25-6-478)			
Building Height: 22 ft 7 i	in Number of Floors: 2	#	of spaces requ	uired: 2	# of spa	ces provided:	2	
Right-of-Way Information								
Is a sidewalk required for the pro *Sidewalks are to be installed on any new increases the building's gross floor area b	construction of a single family			N ial structure and a	ny addition to a	an existing buildir	ng that	
Will a Type I driveway approach	be installed, relocated, re	moved or r	epaired as par	t of this proje	ct? 🔳 Y	N		
Width of approach (measured at	property line): 18.0	ft	Distance from	n intersection	(for corner le	ots only): 32.	0ft	
Are storm sewer inlets located ald (If yes, drainage review is required)	ong the property or within	n ten (10) fe	et of the bour	ndaries of the	property?	Y N		

Subchapter F

Gross Floor Area

This section is only required for projects located within the Residential Design and Compatibility Standards Ordinance Boundaries as defined and illustrated in Title 25-2 Subchapter F of the Land Development Code. The Gross Floor Area of each floor is measured as the area contained within the outside edge of the exterior walls.

		Existing Sq Ft	New/Added Sq Ft	Proposed Exemption (check article utilized)	Applied Exemption Sq Ft	Total Sq Ft
1 st Floor		1,431.00	607.00			2,038.00
2 nd Floor			295.00			295.00
3 rd Floor						0.00
Area w/ ceil	ings > 15'			Must follow article 3.3.5		0.00
Ground Floo (check article			158.00	☐ Full Porch sq ft (3.3.3 A) ☐ 200 sq ft (3.3.3 A 2)		158.00
Basement				Must follow article 3.3.3B, see note below		0.00
Attic				Must follow article 3.3.3C, see note below		0.00
Garage**: (check	Attached		272.00	☐ 200 sq ft (3.3.2 B 2b)		272.00
article utilized)	Detached			☐ 450 sq ft (3.3.2 A 1 / 2a) ☐ 200 sq ft (3.3.2 B 2a)		0.00
Carport**: (check article	Attached			☐ 450 sq ft (3.3.2 A 3) ☐ 200 sq ft (3.3.2 B 1)***		0.00
utilized)	Detached			☐ 450 sq ft (3.3.2 A 1)		0.00
Accessory B (detached)	Building(s)		•			0.00
Totals		1,431.00	1,332.00			2,763.00

· · · · · · · · · · · · · · · · · · ·			
	TOTAL	L GROSS FLOOR AREA (add Total Sq Ft column) 2.763	3.00
(Total Gross Floor Area ÷ Lot Area) x 100 = 30		Floor-To-Area Ratio (FAR)	
	Y	N	
(Yes, if: a wall, 15' tall or higher, within 9 feet of a side property			
Does any portion of the structure extend beyond a se (If Yes, indicate applicable section of Subchapter F and length of	-		

Basement exemption: A habitable portion of a building that is below grade may be exempted if the habitable portion does not extend beyond the first-story footprint and is below natural or finished grade, whichever is lower; and it is surrounded by natural grade for at least 50% of its perimeter wall area and the finished floor of the first story is not more than three feet above the average elevation at the intersections of the minimum front yard setback line and the side property lines.

Habitable Attic exemption: A habitable portion of an attic may be exempted if: 1) The roof above it is not a flat or mansard roof and has a slope of 3 to 12 or greater; 2) It is fully contained within the roof structure; 3) It has only one floor; 4) It does not extend beyond the footprint of the floors below; 5) It is the highest habitable portion of the building, or a section of the building, and adds no additional mass to the structure; and 6) Fifty percent or more of the area has a ceiling height of seven feet or less.

^{*}Ground Floor Porch exemption: A ground floor porch, including a screened porch, may be exempted, provided that the porch is not accessible by automobile and is not connected to a driveway; and the exemption may not exceed 200 square feet if a porch has habitable space or a balcony above it.

^{**}Garage and carport exemptions (in relation to primary structure): Exemptions must follow the code as outlined in Title 25-2 Subchapter F 3.3.2. Each amount listed (450 or 200) is the maximum exclusion allowed per the article designated. Note: Article 3.3.2 C, "An applicant may receive only one 450-square foot exemption per site under paragraph A. An applicant who receives a 450-square foot exemption may receive an additional 200-foot exemption for the same site under paragraph B, but only for an attached parking area used to meet minimum parking requirements."

^{***}Ordinance article 3.3.2 B 1 is the only 200 sq ft exemption that may be combined with a 450 sq ft exemption. Otherwise only one 450 exemption or one 200 sq ft exemption may be taken.

Additional Information, Continued

Area Description Note: Provide a separate calculation for each distinct area. Attach additional sheets as necessary. Measurements are to the outside surface of the exterior wall.	Existing Sq Ft	New/Added Sq Ft	Total Sq Ft
a) 1 st floor conditioned area	1,431.00	607.00	2,038.00
b) 2 nd floor conditioned area	1 1 1 1 1 1	295.00	295.00
c) 3 rd floor conditioned area			0.00
d) Basement			0.00
e) Attached Covered Parking (garage or carport)		272.00	272.00
f) Detached Covered Parking (garage or carport)			0.00
g) Covered Wood Decks (counted at 100%)			0.00
h) Covered Patio			0.00
i) Covered Porch		29.00	29.00
j) Balcony			0.00
k) Other - Specify: SCREENED IN PORCH		129.00	129.00
Total Building Area (TBA) (add: a through k)	1,431.00	1,332.00	2,763.00
Total Building Coverage (TBC) (from TBA subtract, if applicable: b, c, d, and j)	(A) 1,431.00	1,037.00	(B) 2,468.00
l) Driveway		401.00	401.00
m) Sidewalks	96.00		96.00
n) Uncovered Patio			0.00
o) Uncovered Wood Decks (counted at 50%)		101.00	101.00
p) AC pads and other concrete flatwork		6.00	6.00
q) Other (Pool Coping, Retaining Walls)		66.00	66.00
Total Site Impervious Coverage (add: TBC and I through q)	(C) 1,527.00	1,611.00	(D) 3,138.00
r) Pool			0.00
s) Spa			0.00

Building Coverage Information Note: Building Coverage means the area of a lot covered by buildings or roofed are incidental projecting eaves, balconies, and similar features. Pools, ponds, and found		
Lot Area (sq ft): 9,225.00		
Existing Building Coverage (see above A, sq ft): 1,431.00	1	
Exist	ing Coverage % of lot (A ÷ Lot Area) x 100 : 16	%
Final Building Coverage (see above <u>B</u> , sq ft): <u>2.468.00</u>		
Fin	al Coverage % of lot (B ÷ Lot Area) x 100: 27	%
Impervious Cover Information Note: Impervious cover is the total horizontal area of covered spaces, paved areas, gravel placed over pervious surfaces that are used only for landscaping or by pedes		s with
Existing Impervious Coverage (see above <u>C</u> , sq ft): <u>1.527</u>	2.00	
Existi	ng coverage % of lot (<u>C</u> ÷ Lot Area) x 100 : <u>17</u>	%
Final Impervious Coverage (see above <u>D</u> , sq ft): <u>3,138.00</u>	<u>, </u>	
Fir	nal coverage % of lot (<u>D</u> ÷ Lot Area) x 100: <u>34</u>	%

2301 Rundell Place


Project Description:

A 902 square foot addition to a one story single family residence with a new attached single stall carport and a 129 S.F. screened in porch.

Residence features a covered front porch and an uncovered wood deck. Existing 2 bedroom 2 bathroom home will be expanded to 3 bedrooms and 4 bathrooms. A new second floor will be added at the south west corner of the home. The new second floor will consist of a bedroom and a bathroom. The existing south west exterior wall is 4.8' from the property line. It is 2" over the 5'-0" setback. The south wall will be demolished and a new wall will be built on the existing slab 1" inside the 5'-0" side yard setback.

Exterior materials will be fiber cement lap siding, and limestone veneer. Roof will be a standing seam metal roof.


Front

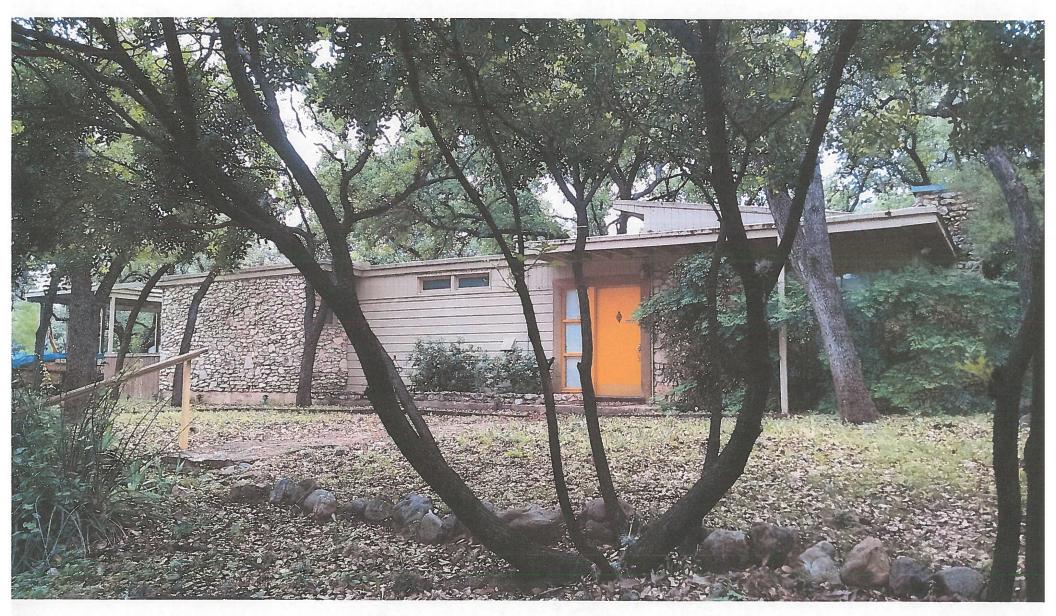

Front of house from Streets.

Front-left.

Deno Roof

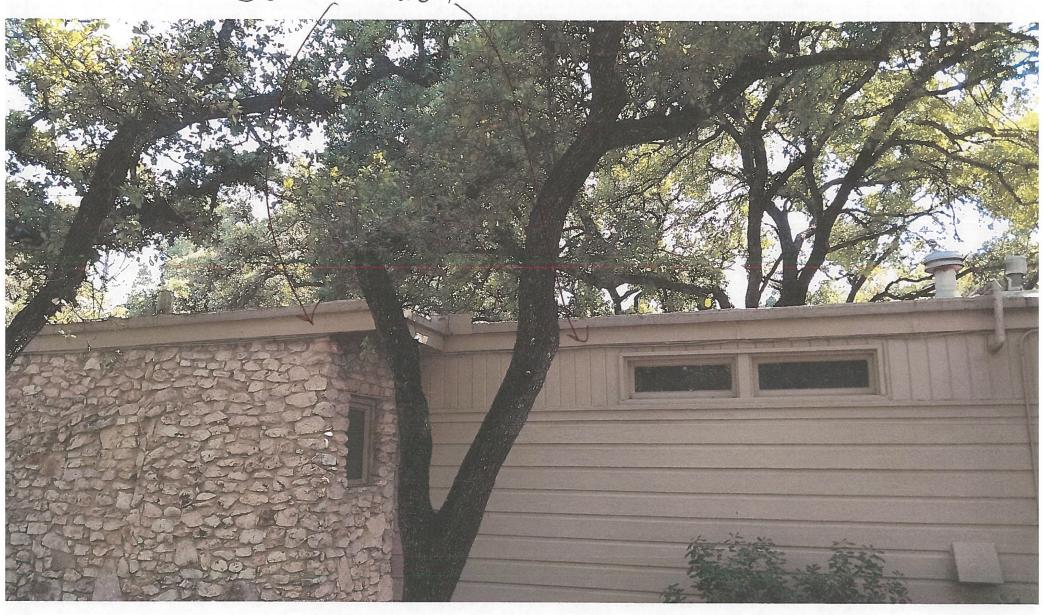

Front-Right/


Demo Roof



West-hear

Deno Roof




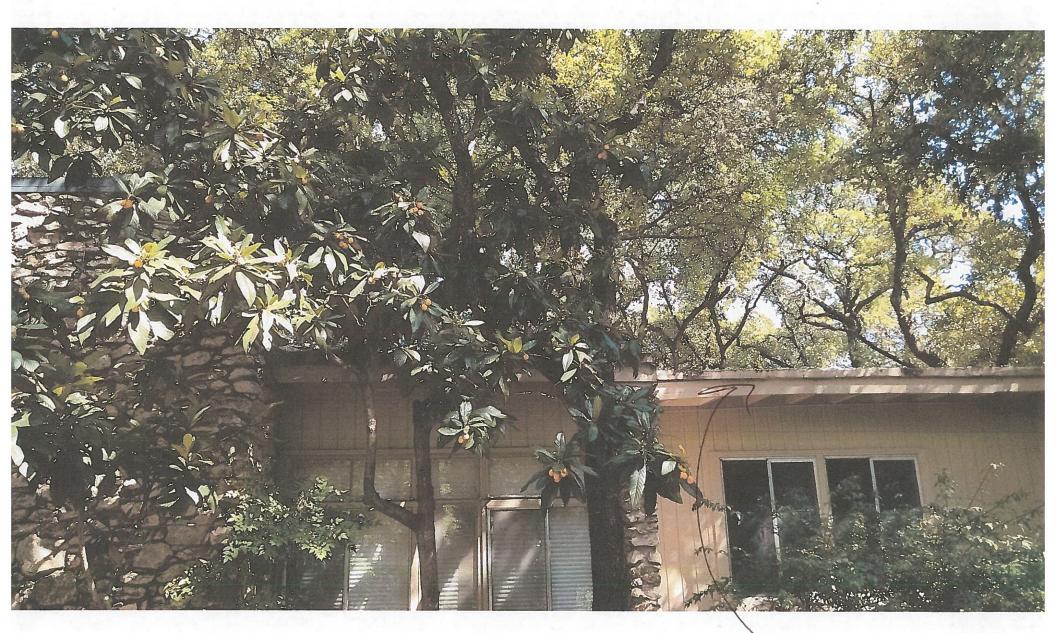

Deno Roof

Rear

Demo Roof

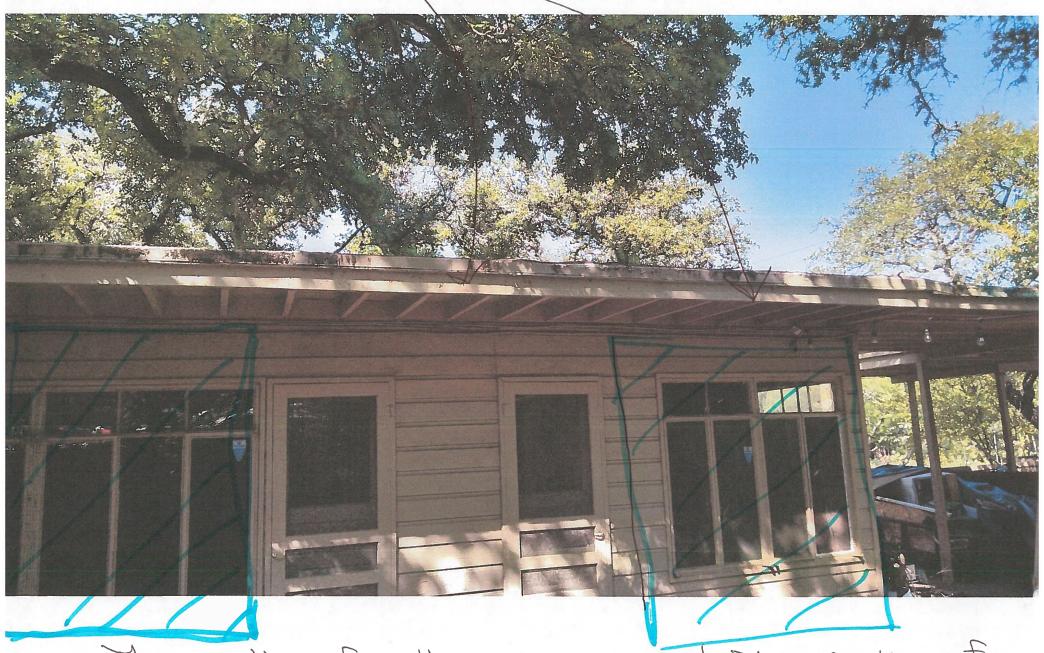

This portion of wall for new windows This portion of wall.


Front

Carport & Storage being demoid





Rear-

Deno Carport & Storage

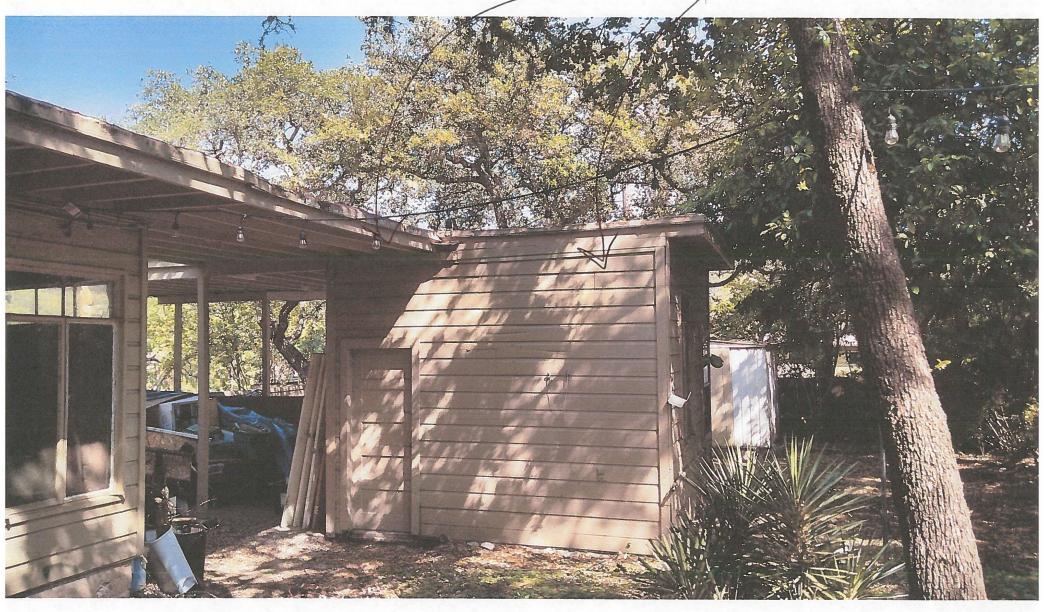

Deno App.

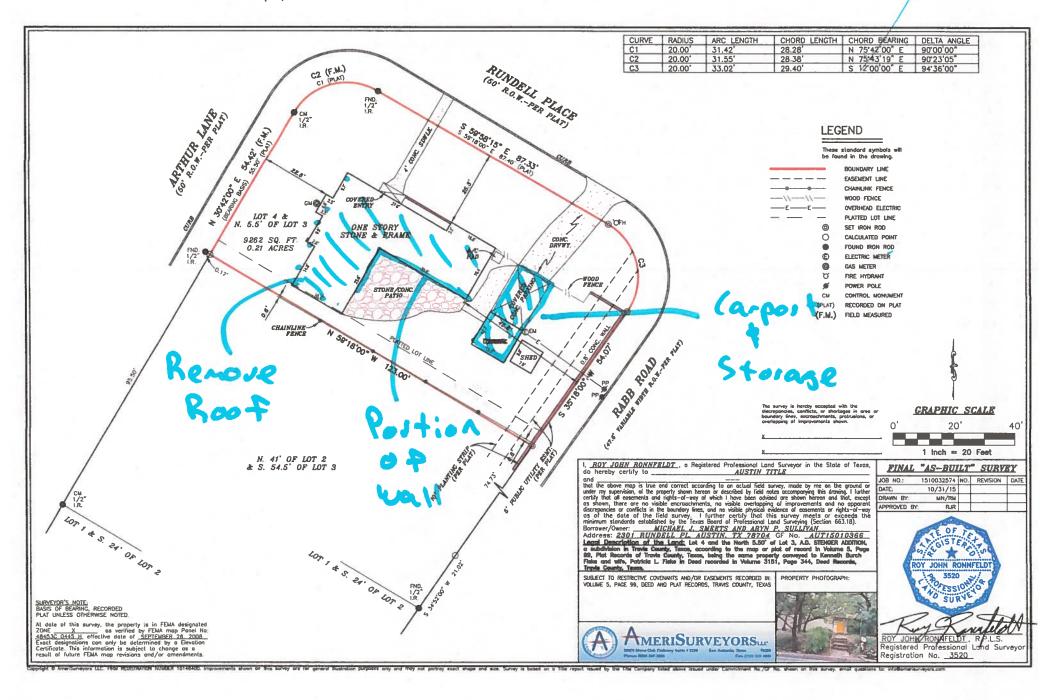

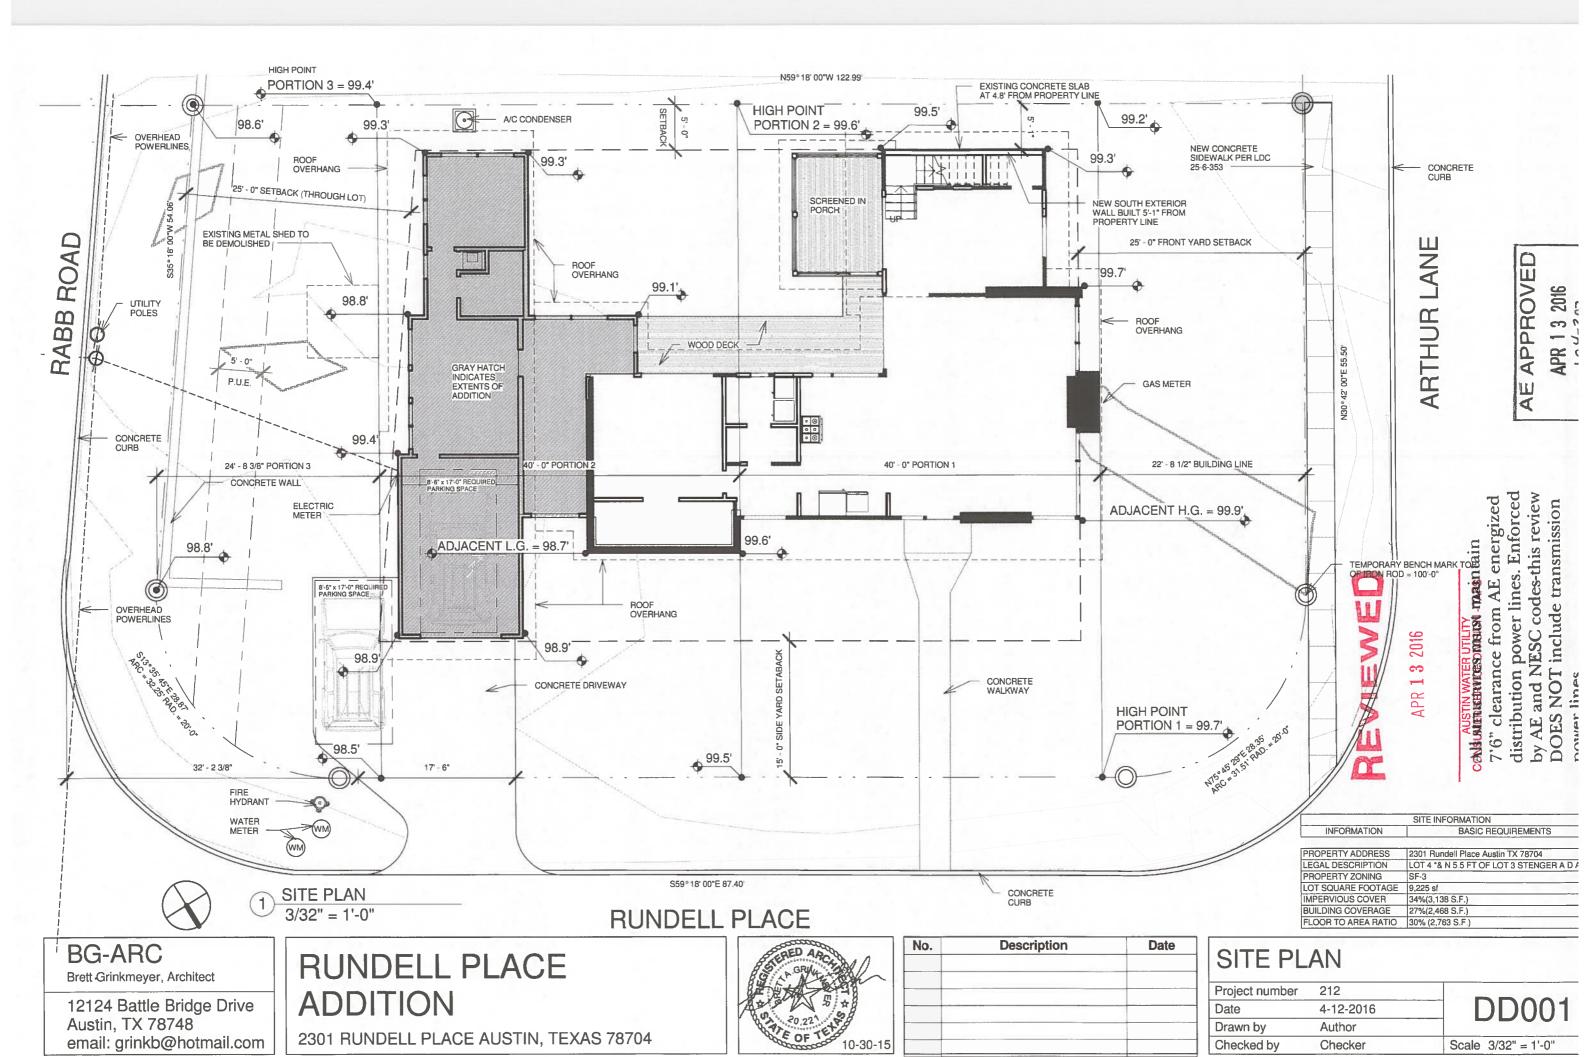



Brett Grinkmeyer, Architect

12124 Battle Bridge Drive Austin, TX 78748 email: grinkb@hotmail.com


RUNDELL PLACE ADDITION



No.	Description	Date
	····	

Δ	R	FA	P	LA	N	2
$\overline{}$	\Box	\perp	\		ıΝ۰	

Project number	212	
Date	4-12-2016	DD003
Drawn by	Author	
Checked by	Checker	Scale 3/32" = 1'-0"

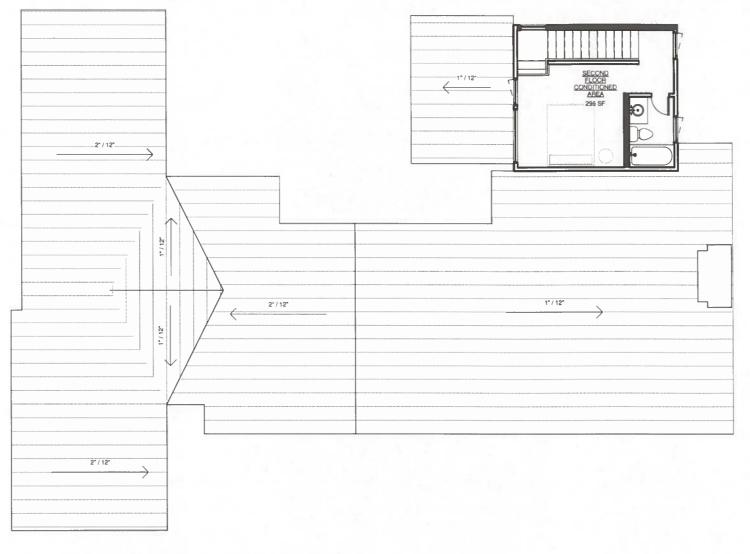

1 AREA PLAN - 02 SECOND FLOOR 3/32" = 1'-0"

BG-ARC

Brett Grinkmeyer, Architect


12124 Battle Bridge Drive Austin, TX 78748 email: grinkb@hotmail.com

RUNDELL PLACE ADDITION



No.	Description	Date
_		_
		_

AREA P	LANS	
Project number	212	
Date	4-12-2016	DD004
Drawn by	Author	
Checked by	Checker	Scale 3/32" = 1'-0"

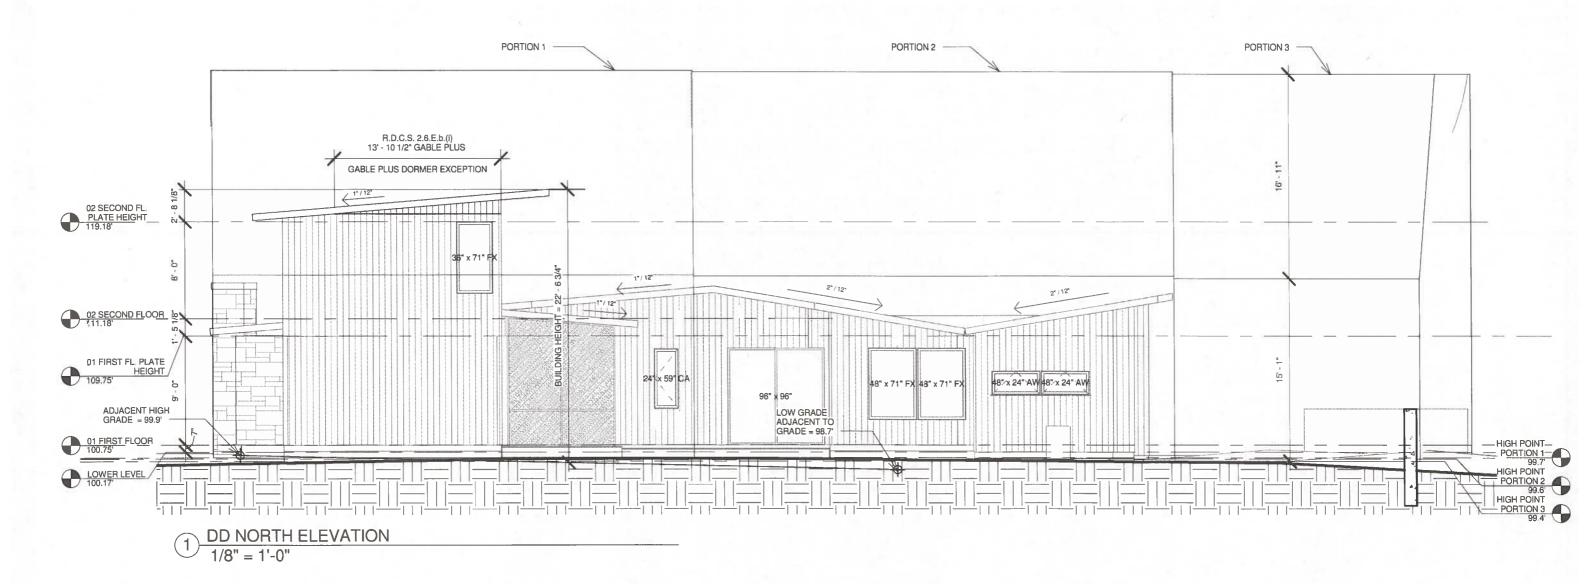

Brett Grinkmeyer, Architect


12124 Battle Bridge Drive Austin, TX 78748 email: grinkb@hotmail.com RUNDELL PLACE ADDITION



No.	Description	Date	
	100		
44			

EXTERIOR ELEVATIO	\mathbb{N}	1	
-------------------	--------------	---	--

Project number	212	
Date	4-12-2016	DD200
Drawn by	Author	00200
Checked by	Checker	Scale 1/8" = 1'-0"

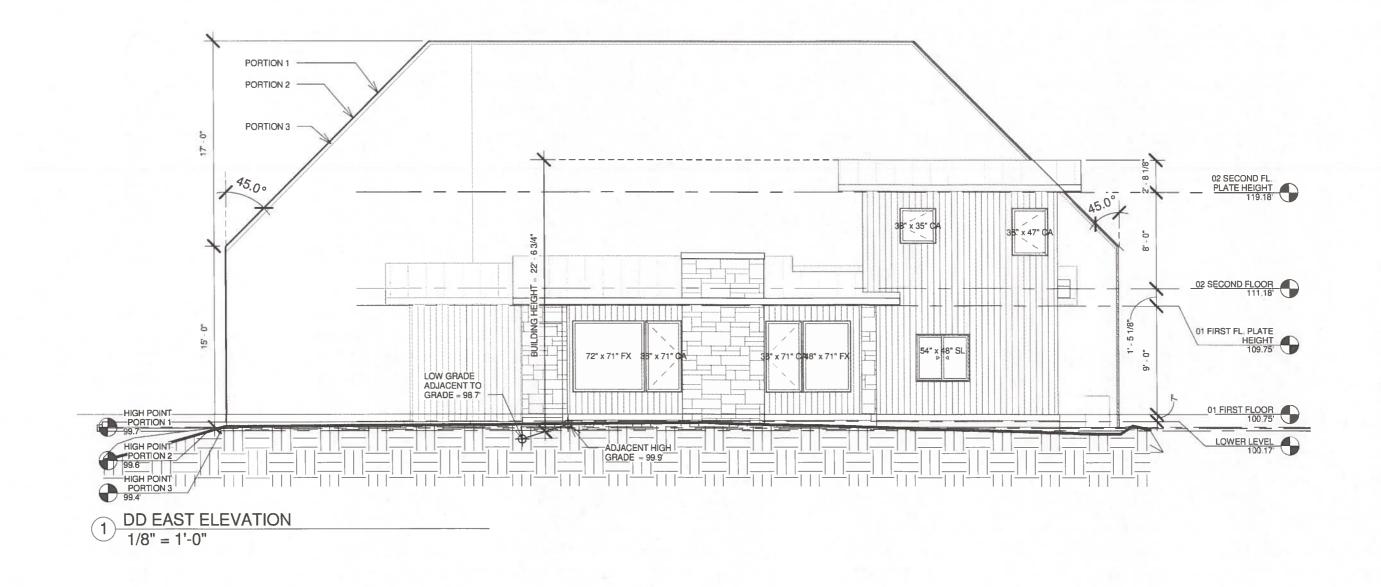

Brett Grinkmeyer, Architect

12124 Battle Bridge Drive Austin, TX 78748 email: grinkb@hotmail.com

RUNDELL PLACE ADDITION


2301 RUNDELL PLACE AUSTIN, TEXAS 78704



No.	Description	Date

EXTERIOR ELEVATION

Project number	212	
Date	4-12-2016	DD201
Drawn by	Author	
Checked by	Checker	Scale 1/8" = 1'-0"

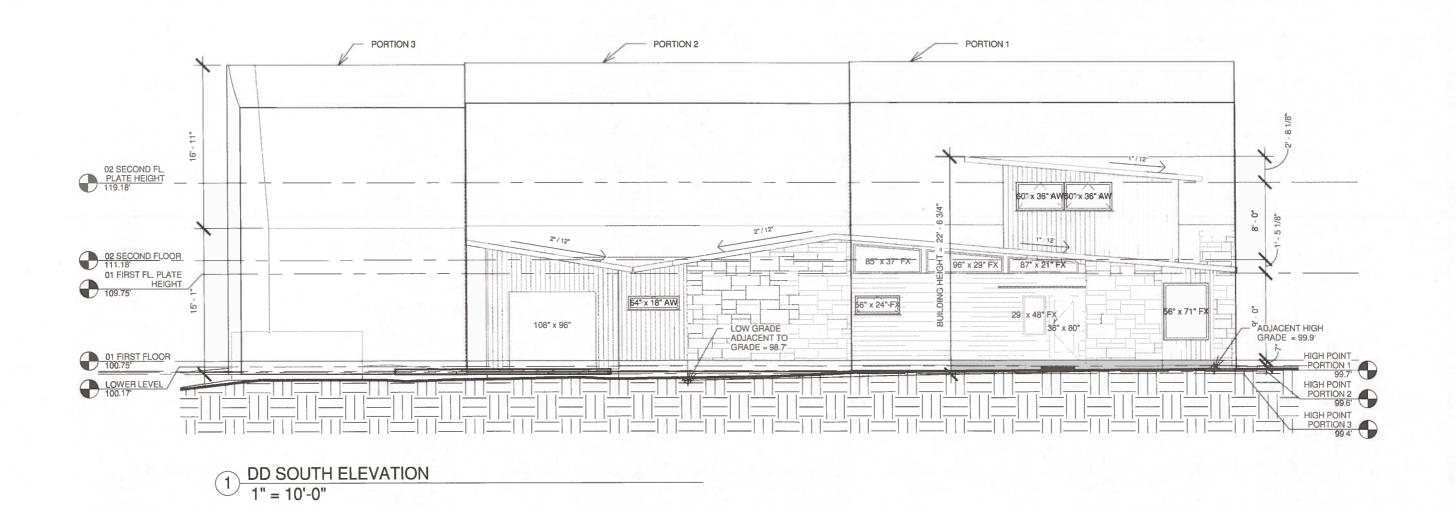

Brett Grinkmeyer, Architect

12124 Battle Bridge Drive Austin, TX 78748 email: grinkb@hotmail.com


RUNDELL PLACE ADDITION



No.	Description	Date

EXTERIOR ELEVATION

Project number	212		
Date	4-12-2016	DD202	
Drawn by	Author		
Checked by	Checker	Scale 1" = 10'-0"	

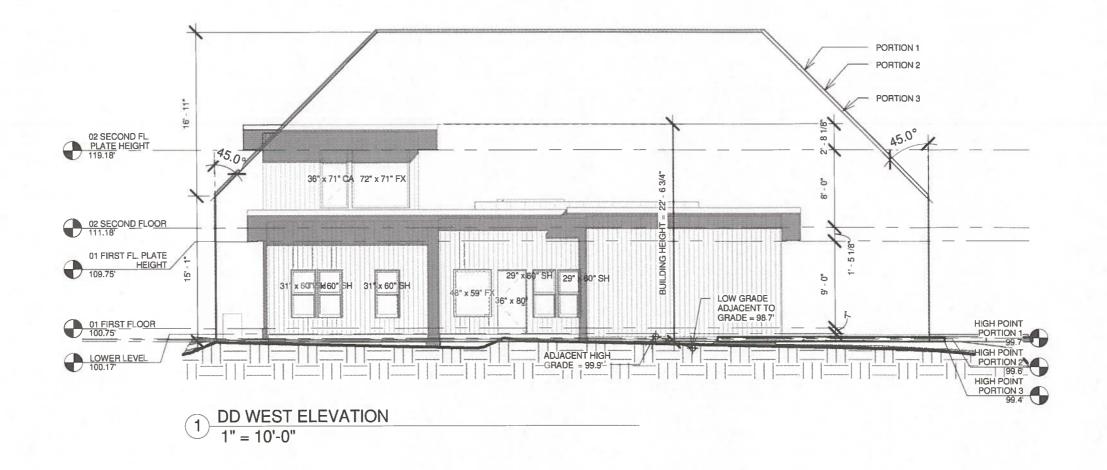

Brett Grinkmeyer, Architect

12124 Battle Bridge Drive Austin, TX 78748 email: grinkb@hotmail.com RUNDELL PLACE ADDITION


2301 RUNDELL PLACE AUSTIN, TEXAS 78704



Date

EXTERIOR ELEVATION

Project number	212		
Date	4-12-2016	DD203	
Drawn by	Author		
Checked by	Checker	Scale 1" = 10'-0"	

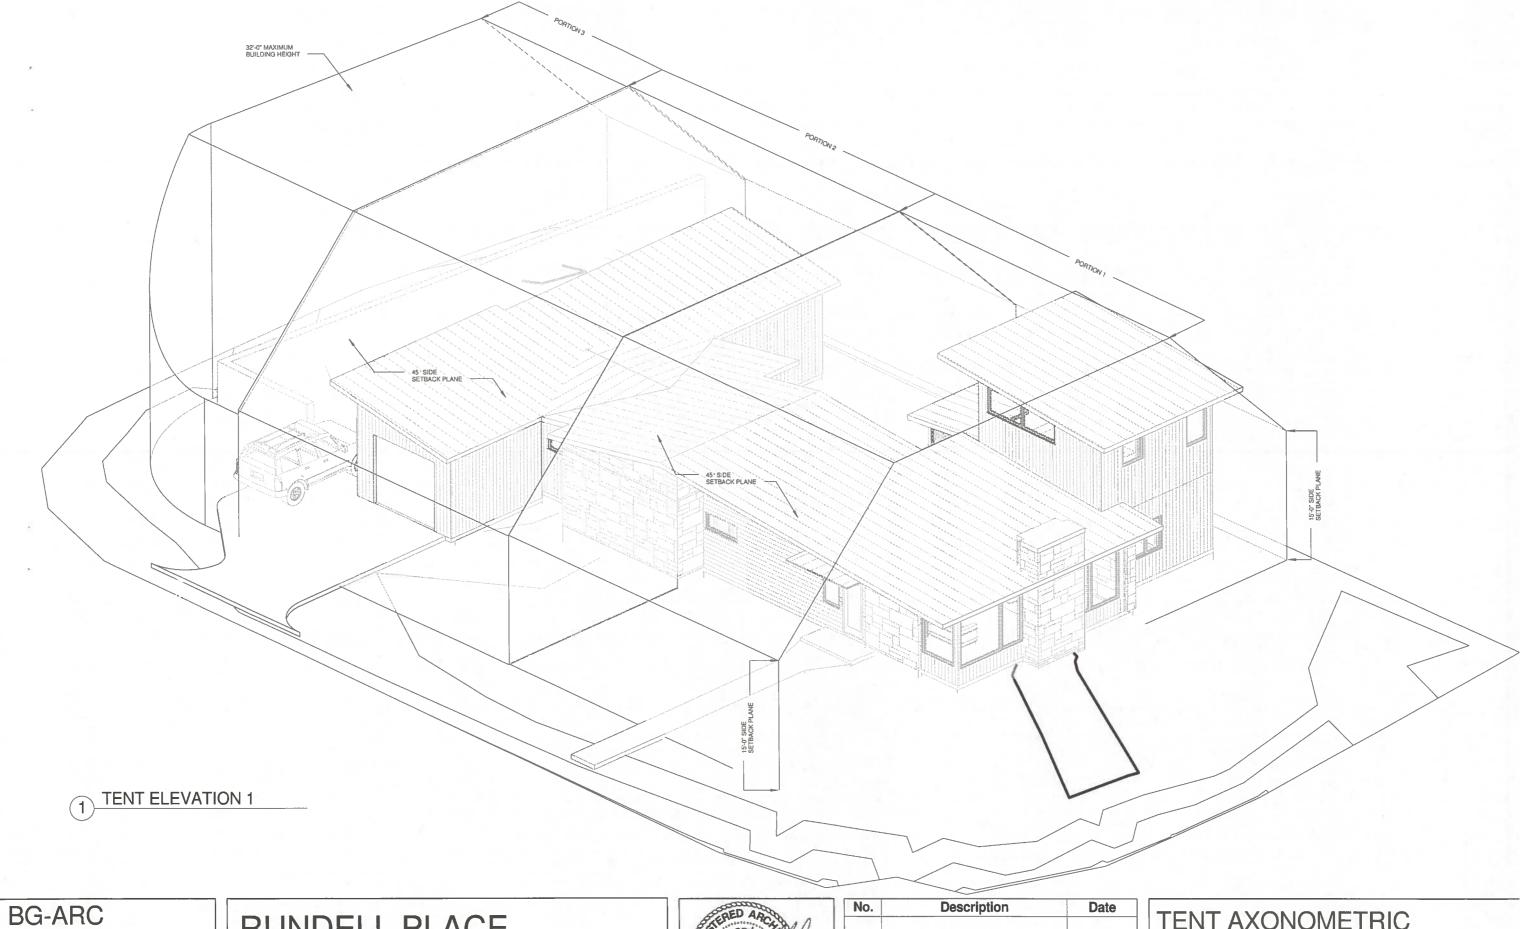

Brett Grinkmeyer, Architect

12124 Battle Bridge Drive Austin, TX 78748 email: grinkb@hotmail.com

RUNDELL PLACE **ADDITION**

2301 RUNDELL PLACE AUSTIN, TEXAS 78704



No.	Description	Date

TENT AXONOMETRIC

Project number	212		
Date	4-12-2016	DD206	
Drawn by	Author	DDLOG	
Checked by	Checker	Scale	