

Residential Review – One Texas Center 505 Barton Springs Road, Austin, TX 78704; (512) 978-4000

Residential New Construction and Addition Permit Application

To complete this form electronically: Open with Internet Explorer, then <u>Click Here to Save</u> and continue.

Property Information					
Project Address: 906 Robertson Street	Tax Parcel ID:				
Legal Description: Lot 12, Blk 2, Westridge Subdivision					
Zoning District: SF-3-NP	Lot Area (sq ft): 8,933.00				
Neighborhood Plan Area (if applicable): Old West Austin	Historic District (if applicable):				
Required Reviews					
Is project participating in S.M.A.R.T. Housing? Y N	Does project have a Green Building requirement? Y ■ N				
(If yes, attach signed certification letter from NHCD, and signed conditional approval letter from Austin Energy Green Building)	(If yes, attach signed conditional approval letter from Austin Energy Green Building)				
Is this site within an Airport Overlay Zone? Y N N (If yes, approval through Aviation is required)	Does this site have a septic system? Y N (If yes, submit a copy of approved septic permit)				
Does the structure exceed 3,600 square feet total under roof?	■ N (If yes, Fire review is required)				
Is this property within 200 feet of a hazardous pipeline?	N (If yes, Fire review is required)				
Is this site located within an Erosion Hazard Zone? Y N Is to (If yes, EHZ review is required)	this property within 150 feet of the 100 year floodplain? Y N (Proximity to floodplain may require additional review time.)				
Is there a protected sized tree on this lot or adjacent lot(s)? Y Note: Include tree location(s) on plot plan.	N (If yes, application for a tree permit with the <u>City Arborist</u> is required)				
Is this site within the Residential Design and Compatibility Standards (Ordinance Boundary Area? (LDC 25-2 Subchapter F) Y N				
Does this site currently have: water availability? Wastewater availability? WY N N	* * * * * * * * * * * * * * * * * * * *				
Are there existing water/wastewater infrastructure, appurtenances or ex (If yes, contact Austin Water Utility Pipeline Engineering for review and approval)	cisting water/wastewater easements located on site? Y IN N				
Does this site have or will it have an auxiliary water source? Y (Auxiliary water supplies are wells, rainwater harvesting, river water, lake water, reclain	N (If yes, submit approved auxiliary and potable plumbing plans.) ned water, etc.)				
Does this site require a cut or fill in excess of four (4) feet? Y N	(If yes, contact the Development Assistance Center for a Site Plan Exemption)				
	te within the Lake Austin Overlay? Y N N:-180, 25-2-647)				
Does this site front a paved street? Y N Is this sit	te adjacent to a paved alley? Y Norks approval required to take access from a public alley.)				
Does this site have a Board of Adjustment (BOA) variance? Y	N Case #(if applicable)				
Does this site have a Residential Design and Compatibility Commissio (If yes, provide a copy of decision sheet. Note: A permit cannot be approved within 10	on (RDCC) waiver? Y N N N N N N N N N N N N N N N N N N				
Description of Work					
Is Total New/Added Building Area > 5,000 Sq Ft? Y N	(If yes, construction material recycling is required per LDC 25-11-39)				
Existing Use: vacant single-family residential duples	residential two-family residential other:				
Proposed Use: vacant single-family residential duplex	residential two-family residential other:				
Project Type: new construction addition	addition/remodel other:				
Will all or part of an existing exterior wall, structure, or roof be remove (Note: Removal of all or part of a structure requires a demolition permit application.)	ed as part of the project? I Y N				
# existing bedrooms: 1 # bedrooms upon completion: 2	# baths existing: 1.0 # baths upon completion: 1.0				
Project Description: (Note: Please provide thorough description of project. Attach a bathroom addition, remodel: new wall to enclose new bedroom	additional pages as necessary.)				
Trades Permits Required (Circle as applicable): electric plus	mbing ■ mechanical (HVAC) concrete (R.O.W.)				

Job Valuation								
Total Job Valuation: \$ 0	Amount of Total Job V and/or New Construction	Addition 0	Amount of Total Job Valuation dedicated to all Remodel/Repair:					
Note: The total job valuation should be the sum total of all valuations noted to	Amount for Primary Structure: \$					Bldg: \$ Elec: \$ Plmbg: \$ Mech: \$		
the right. Labor and materials only.			Structure: \$					
rounded to nearest dollar. Permit fees are based on adopted fee schedule.	Elec: Y N Plm				Mech: \$			
Please utilize the Calculation				·				
	ulations and to provi						ipiete the	
Site Development Information	n terretain							
Area Description Note: Provide a separate calculation for each distinct area. Attach		Existing Sq Ft		New/Added Sq Ft		Total Sq Ft		
additional sheets as necessary. Measurement of the exterior wall.		Bldg 1	Bldg 2	Bldg 1	Bldg 2	Bldg 1	Bldg 2	
a) 1 st Floor conditioned area		1,196.0)	106.00		1,302.00	0.00	
b) 2 nd Floor conditioned area					Ì	0.00	0.00	
c) 3 rd Floor conditioned area						0.00	0.00	
d) Basement						0.00	0.00	
e) Covered parking (garage or ca	port)					0.00	0.00	
f) Covered patio, deck, porch,	and/or balcony area(s)	9.0)			9.00	0.00	
g) Other covered or roofed are		245.0)			245.00	0.00	
h) Uncovered wood decks	in the state of th					0.00	0.00	
Total Building Area (total a	through h)	1,450.00	0.00	106.00	0.00	1,556.00	0.00	
i) Pool						0.00	0.00	
j) Spa						0.00	0.00	
 k) Remodeled Floor Area, excl New Construction 	uding Addition /	4000000444	was a company	dammani	********			
Building Coverage Information						***************************************		
Note: Building Coverage means the area of incidental projecting eaves, balconies, and	similar features. Pools, ponds,	and fountain:	are not included	ind-level paving, in this measurem	landscaping, op ent. (LDC 25-1-	en recreational fa- -21)	cilities,	
Total Building Coverage (sq ft):	1,556.00 % of	flot size: 1	7.4					
Impervious Cover Information								
Note: Impervious cover is the total horizon gravel placed over pervious surfaces that a boards and that is located over a pervious: Total Impervious Cover (sq ft): 1	re used only for landscaping or surface, 50 percent of the horiz	r by pedestria	is. For an uncove he deck is include	red wood deck th	at has drainage:	spaces between th	e deck	
		100 5120. 2	THE CONTRACT OF THE CONTRACT O					
Setbacks								
Are any existing structures on this Does any structure (or an element Is front yard setback averaging be	of a structure) extend ov	er or beyor	nd a required y	yard? (LDC 25-2	2-513)		Y N	
Height Information (LDC 25-1-21 of	or 25-2 Subchapter F, Section 3	(.4) Pa	rking (LDC 25-	6 Appendix A &	25-6-478)			
Building Height: ft i	n Number of Floors:	# o	f spaces requi	red: <u>2</u>	# of space	es provided: 2		
Right-of-Way Information	NAME OF THE OWNER OW							
Is a sidewalk required for the prop *Sidewalks are to be installed on any new increases the building's gross floor area b	construction of a single family.	25-6-353) , two-family c	Y]		ny addition to a	n existing buildin	g that	
Will a Type I driveway approach I	e installed, relocated, re	moved or 1	epaired as par	t of this projec	et? Y	■ N		
Width of approach (measured at p	roperty line): 10.0	ft	Distance fron	n intersection (for corner lo	ots only):	ft	
Are storm sewer inlets located alo (If yes, drainage review is required)	ng the property or within	ten (10) fe	et of the boun	idaries of the p	property?	Y IN		

Subchapter F

Gross Floor Area

This section is only required for projects located within the Residential Design and Compatibility Standards Ordinance Boundaries as defined and illustrated in Title 25-2 Subchapter F of the Land Development Code. The Gross Floor Area of each floor is measured as the area contained within the outside edge of the exterior walls.

mro nist (i 		Existing Sq Ft	New/Added Sq Ft	Proposed Exemption (check article utilized)	Applied Exemption Sq Ft	Total Sq Ft
I st Floor		1,196.00	106.00			1,302.00
2 nd Floor						0.00
3 rd Floor						0.00
Area w/ ceil	ings > 15'		, , , , , , , , , , , , , , , , , , ,	Must follow article 3.3.5		0.00
Ground Floor Porch* (check article utilized)		9.00	THE STATE OF THE S	Full Porch sq ft (3.3.3 A) 200 sq ft (3.3.3 A 2)	9.00	0.00
Basement				Must follow article 3.3.3B, see note below		0.00
Attic				Must follow article 3.3.3C, see note below		0.00
Garage**: (check	Attached			☐ 200 sq ft (3.3.2 B 1)		0.00
article utilized)	Detached	245.00		450 sq ft (3.3.2 A 1 / 2a)	245.00	0.00
C			DATE OF THE PROPERTY OF THE PR	200 sq ft (3.3.2 B 2a / 2b)		
Carport**: (check	Attached			☐ 450 sq ft (3.3.2 A 3)		0.00
article utilized)	***************************************			200 sq ft (3.3.2 B 1)***		
	Detached			☐ 450 sq ft (3.3.2 A 1)		0.00
Accessory B (detached)	uilding(s)					0.00
Totals		1,450.00	106.00			1,302.00
			TOTA	L GROSS FLOOR AREA (add	Total Sq Ft column)	1,302.00
(Total Gross	Floor Area ÷	Lot Area) $x 100 =$	15	Floor-To-Area Ratio (FAR)	
		equired for this pro		N ds further than 36 feet in length per arti	cle 2.7.1)	
				ane/exemption exhibit (aka "ten		

*Ground Floor Porch exemption: A ground floor porch, including a screened porch, may be exempted, provided that the porch is not accessible by automobile and is not connected to a driveway; and the exemption may not exceed 200 square feet if a porch has habitable space or a balcony above it.

Basement exemption: A habitable portion of a building that is below grade may be exempted if the habitable portion does not extend beyond the first-story footprint and is below natural or finished grade, whichever is lower; and it is surrounded by natural grade for at least 50% of its perimeter wall area and the finished floor of the first story is not more than three feet above the average elevation at the intersections of the minimum front yard setback line and the side property lines.


Habitable Attic exemption: A habitable portion of an attic may be exempted if: 1) The roof above it is not a flat or mansard roof and has a slope of 3 to 12 or greater; 2) It is fully contained within the roof structure; 3) It has only one floor; 4) It does not extend beyond the footprint of the floors below; 5) It is the highest habitable portion of the building, or a section of the building, and adds no additional mass to the structure; and 6) Fifty percent or more of the area has a ceiling height of seven feet or less.

(If Yes, indicate applicable section of Subchapter F and length of protrusion on the drawings.)


^{**}Garage and carport exemptions (in relation to primary structure): Exemptions must follow the code as outlined in Title 25-2 Subchapter F 3.3.2. Each amount listed (450 or 200) is the maximum exclusion allowed per the article designated. Note: Article 3.3.2 C, "An applicant may receive only one 450-square foot exemption per site under paragraph A. An applicant who receives a 450-square foot exemption may receive an additional 200-foot exemption for the same site under paragraph B, but only for an attached parking area used to meet minimum parking requirements."

^{***}Ordinance article 3.3.2 B 1 is the only 200 sq ft exemption that may be combined with a 450 sq ft exemption. Otherwise only one 450 exemption or one 200 sq ft exemption may be taken.

906 ROBERTSON ST

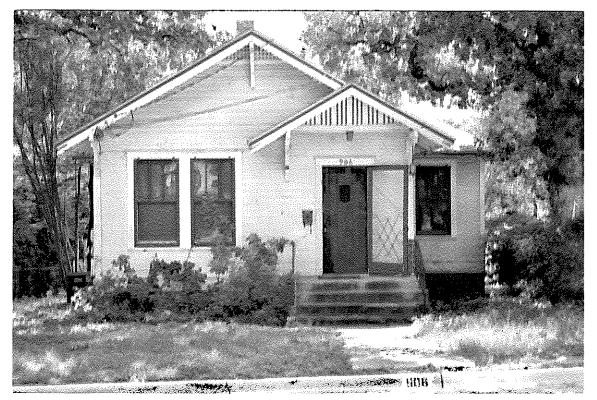


FRONT

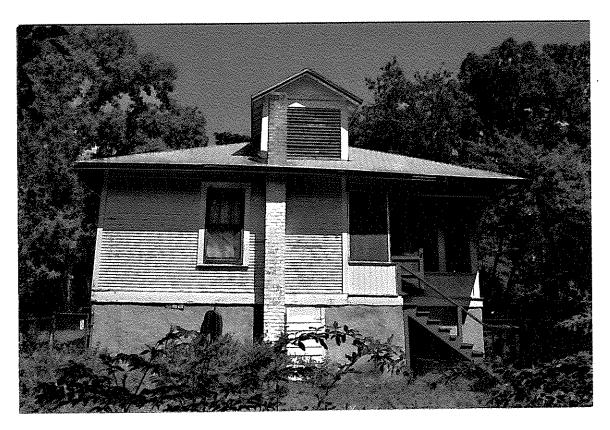

REAR

906 ROBERTSON ST

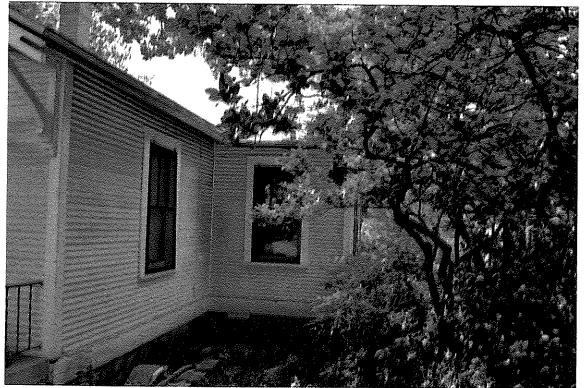


NORTH SIDE



SOUTH SIDE

				Ψ		4	

		,					
	ŧ				•		
							•
					e ⁱ		
•							

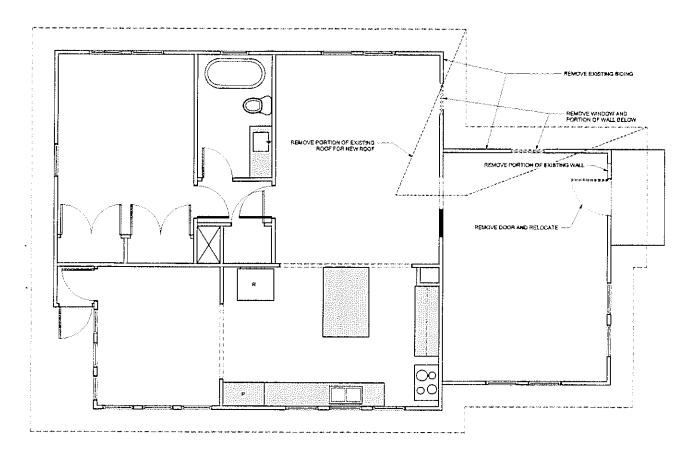

CABINET AT REMOVED WINDOW

CABINET AT REMOVED WI

13'-8 3-8"

2 FLOOR PLAN Scale: 1/4" = 1'-0"

1 DEMO PLAN
Scale: 1/4" = 1'-0"

CORMIER ARCHITECTURE 906 ROBERTSON STREET ADDITION ADGRESS 906 ROBERTSON ST AUSTIN, TX 78703 DRAWING TITLE: 1ST FL PLAN 11X17 SETS SCALE, 1/6"+1"0" DATE NOTES

DATE NOTES

SUSTEMBLE


2011-17 PARROCES

MS/Spick.



A-2

_ ___

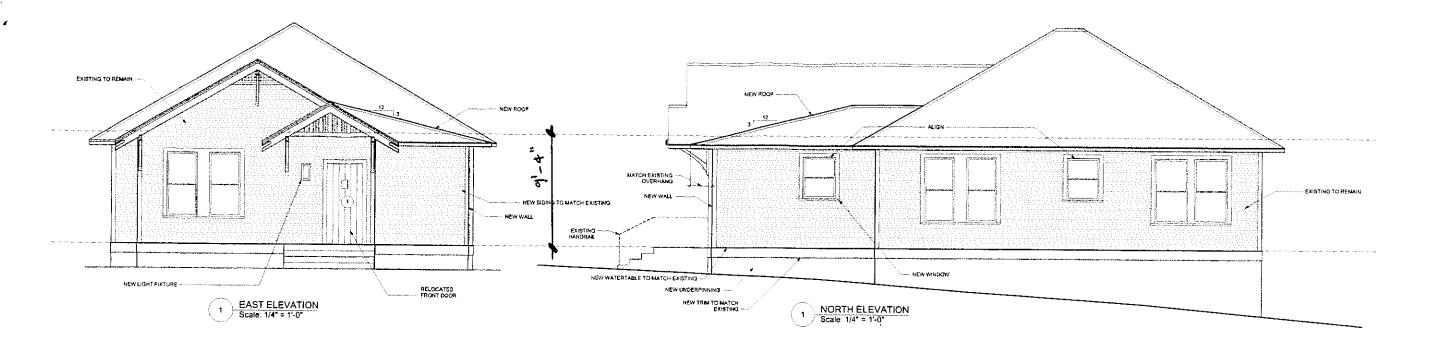

CORMIER ARCHITECTURE





906 ROBERTSON STREET ADDITION

ADORESS 996 ROBERTSON ST AUSTIN, TX 78703

DRAWING TITLE:

11X17 BETS SCALE 18"HTD" DATE NOTES

2171-7 PLAN REVIEW

HE WHICH:



A-3.1

003