

Residential Review – One Texas Center 505 Barton Springs Road, Austin, TX 78704; (512) 978-4000

Residential New Construction and Addition Permit Application

To complete this form electronically: Open with Internet Explorer, then <u>Click Here to Save</u> and continue

300 Daniel Opiniga (10dd, 11dani, 111 10104, (312) 310-4000	memer Explorer, their Chek Here to Save and continue.
Property Information	
Project Address: 1105 West 9th Street	Tax Parcel ID: 106930
Legal Description: Lot 9 Blk A Olt 2 Div Z Rayond Subd	
Zoning District: MF-4	Lot Area (sq fi): 9,168.00
Neighborhood Plan Area (if applicable): Old West Austin	Historic District (if applicable): Castle Hill LHD
Required Reviews	
Is project participating in S.M.A.R.T. Housing? Y N (If yes, attach signed certification letter from NHCD, and signed conditional approveletter from Austin Energy Green Building)	Does project have a Green Building requirement? Y N (If yes, attach signed conditional approval letter from Austin Energy Green Building)
Is this site within an Airport Overlay Zone? Y N (If yes, approval through Aviation is required)	Does this site have a septic system? Y N (If yes, submit a copy of approved septic permit)
Does the structure exceed 3,600 square feet total under roof? Is this property within 200 feet of a hazardous pipeline?	Y N (If yes, Fire review is required) Y N (If yes, Fire review is required)
Is this site located within an Erosion Hazard Zone? Y N N (If yes, EHZ review is required)	Is this property within 150 feet of the 100 year floodplain? Y N (Proximity to floodplain may require additional review time.)
Is there a protected sized tree on this lot or adjacent lot(s)?	N (If yes, <u>click here</u> for more information on the tree permit process.)
Is this site within the Residential Design and Compatibility Standar	rds Ordinance Boundary Area? (LDC 25-2 Subchapter F) Y N
Does this site currently have: water availability?	N (If no, contact Austin Water Utility to apply for N water/wastewater taps and/or service extension request.)
Are there existing water/wastewater infrastructure, appurtenances o (If yes, contact Austin Water Utility Pipeline Engineering for review and approval)	
(Auxiliary water supplies are wells, rainwater harvesting, river water, lake water, rec	Y N (If yes, submit approved auxiliary and potable plumbing plans.)
Does this site require a cut or fill in excess of four (4) feet? Y	N (If yes, contact the Development Assistance Center for more information)
	s site within the Lake Austin Overlay? Y N 25-2-180, 25-2-647)
	s site adjacent to a paved alley? Vorks approval required to take access from a public alley.)
Does this site have a Residential Design and Compatibility Commis (If yes, provide a copy of decision sheet. Note: A permit cannot be approved within	Y N Case # (if applicable) ssion (RDCC) waiver? Y N 10 days of approval of a variance from BOA.)
Description of Work	
Is Total New/Added Building Area > 5,000 Sq Ft? Y ■ N	(If yes, construction material recycling is required per LDC 25-11-39)
Existing Use: vacant single-family residential dup	olex residential two-family residential other: 3-family
Proposed Use: vacant single-family residential dup	lex residential two-family residential other:
Project Type: new construction addition	addition/remodel other:
Will all or part of an existing exterior wall, structure, or roof be rem (Note: Removal of all or part of a structure requires a demolition permit application.)	oved as part of the project? Y N
# existing bedrooms: 3 # bedrooms upon completion: 3	# baths existing: 3.0 # baths upon completion: 3.5
Project Description: (Note: Please provide thorough description of project. Attach	ch additional pages as necessary.)
Complete exterior and interior rahabilitation, new addition; cer	ntral HVAC, new electrical, site improvements
Trades Permits Required (Circle as applicable): electric p	dumbing mechanical (HVAC) concrete (P.O.W.)

Total Job Valuation: \$400,000	Amount of Total Job V and/or New Constructi	/aluation ded on:	icated to all		dedicated	Amount of Total Job Valuation dedicated to all Remodel/Repair:		
Note: The total job valuation should be	Amount for Primary S	Bldg: \$ 230,000 Elec: \$ 70,000						
the sum total of all valuations noted to the right. Labor and materials only,	Elec: Y N Plm	Plmbg:						
rounded to nearest dollar. Permit fees	Amount for Accessory	Mech:						
are based on adopted fee schedule.	Elec: Y N Plm	ıbg: 🗌 Y 📋	N Mech:	\square Y \square N	TOTAL: \$ 400,000			
Please utilize the Calculation following calculations	n Aid on the last page culations and to prov	of the Addide supplen	litional Inf nental info	ormation, p	age 7, as a thorough	guide to con	nplete the	
Site Development Information								
Area Description	***************************************	Existin	a Sa Ft	New/Add	d Sa Et	Tatal	0 174	
Note: Provide a separate calculation for ea additional sheets as necessary. Measurement	ach distinct area. Attach	LAISTIN	5 oq 11	2 New//Xuus	cu oq rı	Total	Sq Ft	
of the exterior wall.	ents are to the outside surface	Bldg 1	Bldg 2	Bldg 1	Bldg 2	Bldg 1	Bldg 2	
 a) Ist Floor conditioned area 		1,070.00		13.00		1,083.00	0.00	
 b) 2nd Floor conditioned area 		1,180.00	MOONING CONTRACTOR OF THE STREET, STRE	-221.00	rick returns and a few annual measurements and a second section of the second second section of the secti	959.00	0.00	
 c) 3rd Floor conditioned area 						0.00	0.00	
d) Basement					AMERICAN PROPERTY AND STREET AND	0.00	0.00	
e) Covered parking (garage or ca	rport)			***************************************	0000+00000 artetii esta ila ammesa amma angagang,	0.00	0.00	
f) Covered patio, deck, porch,	and/or balcony area(s)	127.00		731.00	***************************************	858.00	0.00	
g) Other covered or roofed are	a department in the contract of the contract o	149.00	***************************************	-149.00	***************************************	0.00	0.00	
h) Uncovered wood decks		51.00		-51.00	77	0.00	0.00	
Total Building Area (total a	through h)	2,577.00	0.00	323.00	0.00	2,900.00	0.00	
i) Pool						0.00	0.00	
j) Spa				***************************************	N/ 000733665aanan (marin marin m	0.00	0.00	
 k) Remodeled Floor Area, excl New Construction 	uding Addition /	****		- pr- print			***************************************	
Building Coverage Information						PER NA PERIODE DE LA PERIODE D	00004448004444000maatan birinin oo kaanii maaa	
Note: Building Coverage means the area of incidental projecting eaves, balconies, and	similar features. Pools, ponds,	and fountains at	t excludes grou e not included	nd-level paving, 1 in this measureme	andscaping, op ent. (LDC 25-1	en recreational fac -21)	cilities,	
Total Building Coverage (sq ft): 1	1 <u>,580.00</u> % of	lot size: 17	shammer ar a c cc ar.					
Impervious Cover Information	######################################		**************************************	**************************************				
Note: Impervious cover is the total horizon gravel placed over pervious surfaces that a boards and that is located over a pervious s Total Impervious Cover (sq ft): 3	re used only for landscaping or surface, 50 percent of the horiz-	r by pedestrians.	For an uncover deck is include	ed wood deck the	t has drainage.	enneae hativaan th	م باعماد	
Setbacks			**************************************			Meditert Links (ministrale el Lenne e e essena en el Lenne e en el Company de la Company de la Company de la Co		
Are any existing structures on this Does any structure (or an element Is front yard setback averaging bei	of a structure) extend ov	er or beyond	a required v	ard? (LDC 25-2-	-513)	5-2-492) Y ■ N Y ■ N	Y N	
Height Information (LDC 25-1-21 o	r 25-2 Subchapter F, Section 3	.4) Parki	ing (LDC 25-6	Appendix A & 2	5-6-478)		***************************************	
Building Height: 31 ft 5 in	n Number of Floors: 2	# of s	paces requir	ed: 2	# of space	s provided: 2		
Right-of-Way Information		**************************************	,	All Angelon (See): (S	***************************************	Sinterioristic distribution of a second assessment as a second assessment as a second as a		
s a sidewalk required for the propersidewalks are to be installed on any new concreases the building's gross floor area by	construction of a single family,	25-6-353) two-family or d	Y Naplex residentia	l al structure and an	y addition to a	n existing building	g that	
Will a Type I driveway approach b	e installed, relocated, re	moved or rep	aired as part	of this project	ı? ■ Y	N		
Width of approach (measured at pr	operty line):	ft Di	stance from	intersection (f	or corner lo	ts only):	ſt	
Are storm sewer inlets located alor						Y ■ N		

Subchapter F

Gross Floor Area

This section is only required for projects located within the Residential Design and Compatibility Standards Ordinance Boundaries as defined and illustrated in Title 25-2 Subchapter F of the Land Development Code. The Gross Floor Area of each floor is measured as the area contained within the outside edge of the exterior walls.

		Existing Sq Ft	New/Added Sq Ft	Proposed Exemption (check article utilized)	Applied Exemption Sq Ft	Total Sq Ft	
1 st Floor		1,064.00	19.00	The state of the s		1,083.00	
2 nd Floor		1,188.00	-229.00			959.00	
3 rd Floor		0.00	0.00			0.00	
Area w/ cei	lings > 15'	0.00	0.00	Must follow article 3.3.5	00000000000000000000000000000000000000	0.00	
Ground Floo (check article		178.00	319.00	Full Porch sq ft (3.3.3 A) 200 sq ft (3.3.3 A 2)	200.00	297.00	
Basement		0.00	0.00	Must follow article 3.3.3B, see note below		0.00	
Attic		0.00	0.00	Must follow article 3.3.3C, see note below		0.00	
Garage**: (check article	Attached	0.00	0.00	200 sq ft (3.3.2 B 1)		0.00	
utilized)	Detached	0.00	0.00	☐ 450 sq ft (3.3.2 A 1 / 2a) ☐ 200 sq ft (3.3.2 B 2a / 2b)		0.00	
Carport**: (check article	Attached	0.00	0.00	450 sq ft (3.3.2 A 3) 200 sq ft (3.3.2 B 1)***		0.00	
utilized)	Detached	0.00	0.00	☐ 450 sq ft (3.3.2 A 1)		0.00	
Accessory B (detached)	uilding(s)	0.00	0.00			0.00	
Totals		2,430.00	109.00			2,339.00	

TOTAL GROSS FLOOR AREA (add Total	Sq Ft	column)	2,339.00
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Total Gross Floor Area ÷ Lot Area) x 100 = 25 Floor-To-Area Ratio	(FAR)
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Is a sidewall articulation required for this project?

Y III N

(Yes, if: a wall, 15' tall or higher, within 9 feet of a side property line extends further than 36 feet in length per article 2.7.1)

Does any portion of the structure extend beyond a setback plane/exemption exhibit (aka "tent")?

Y

N

(If Yes, indicate applicable section of Subchapter F and length of protrusion on the drawings.)

Basement exemption: A habitable portion of a building that is below grade may be exempted if the habitable portion does not extend beyond the first-story footprint and is below natural or finished grade, whichever is lower; and it is surrounded by natural grade for at least 50% of its perimeter wall area and the finished floor of the first story is not more than three feet above the average elevation at the intersections of the minimum front yard setback line and the side property lines.


Habitable Attic exemption: A habitable portion of an attic may be exempted if: 1) The roof above it is not a flat or mansard roof and has a slope of 3 to 12 or greater; 2) It is fully contained within the roof structure; 3) It has only one floor; 4) It does not extend beyond the footprint of the floors below; 5) It is the highest habitable portion of the building, or a section of the building, and adds no additional mass to the structure; and 6) Fifty percent or more of the area has a ceiling height of seven feet or less.


^{*}Ground Floor Porch exemption: A ground floor porch, including a screened porch, may be exempted, provided that the porch is not accessible by automobile and is not connected to a driveway; and the exemption may not exceed 200 square feet if a porch has habitable space or a balcony above it.


^{**}Garage and carport exemptions (in relation to primary structure): Exemptions must follow the code as outlined in Title 25-2 Subchapter F 3.3.2. Each amount listed (450 or 200) is the maximum exclusion allowed per the article designated. Note: Article 3.3.2 C, "An applicant may receive only one 450-square foot exemption per site under paragraph A. An applicant who receives a 450-square foot exemption may receive an additional 200-foot exemption for the same site under paragraph B, but only for an attached parking area used to meet minimum parking requirements."

^{***}Ordinance article 3.3.2 B 1 is the only 200 sq ft exemption that may be combined with a 450 sq ft exemption. Otherwise only one 450 exemption or one 200 sq ft exemption may be taken,



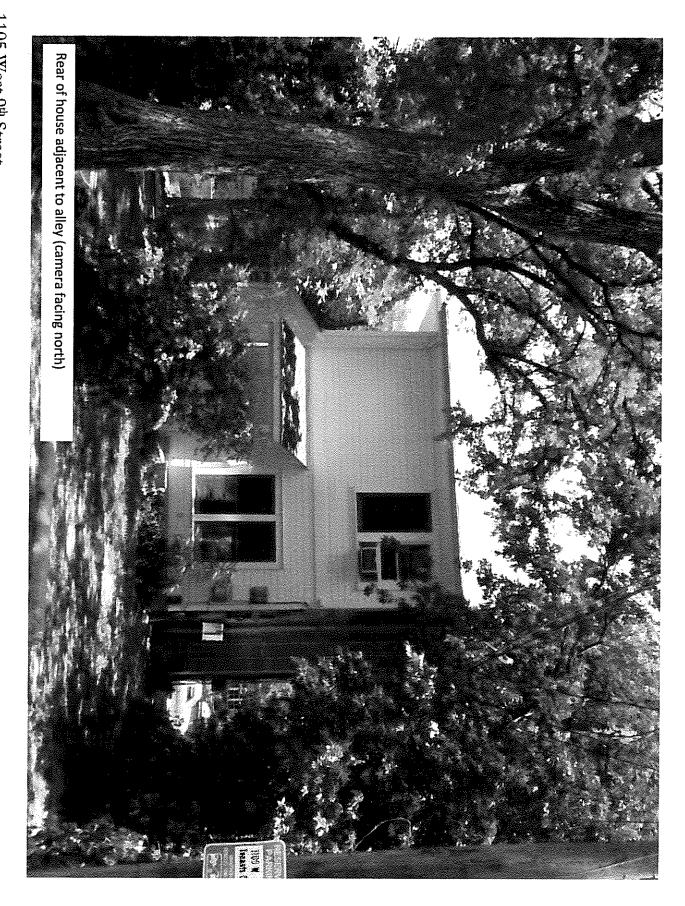


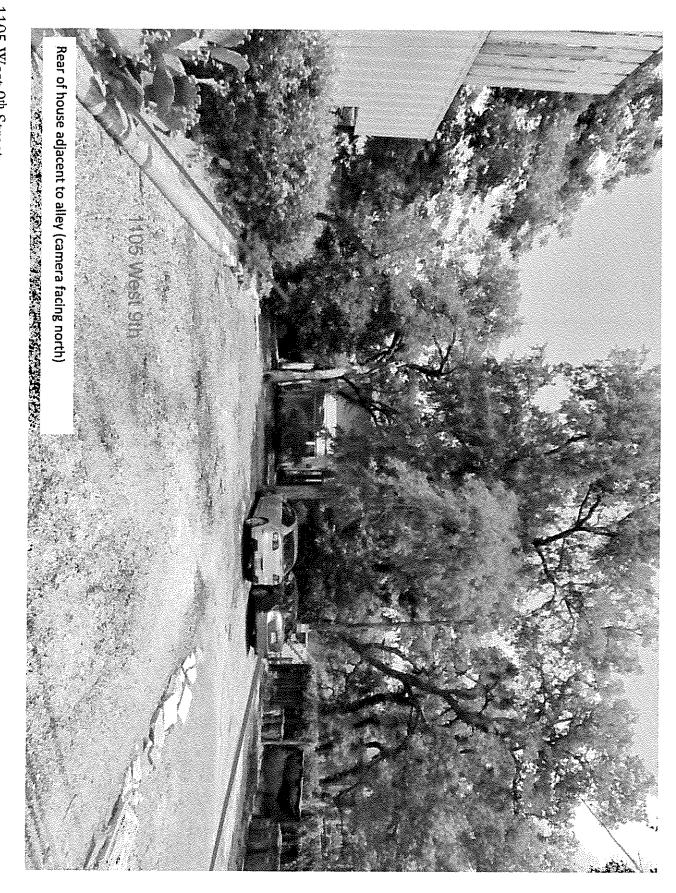

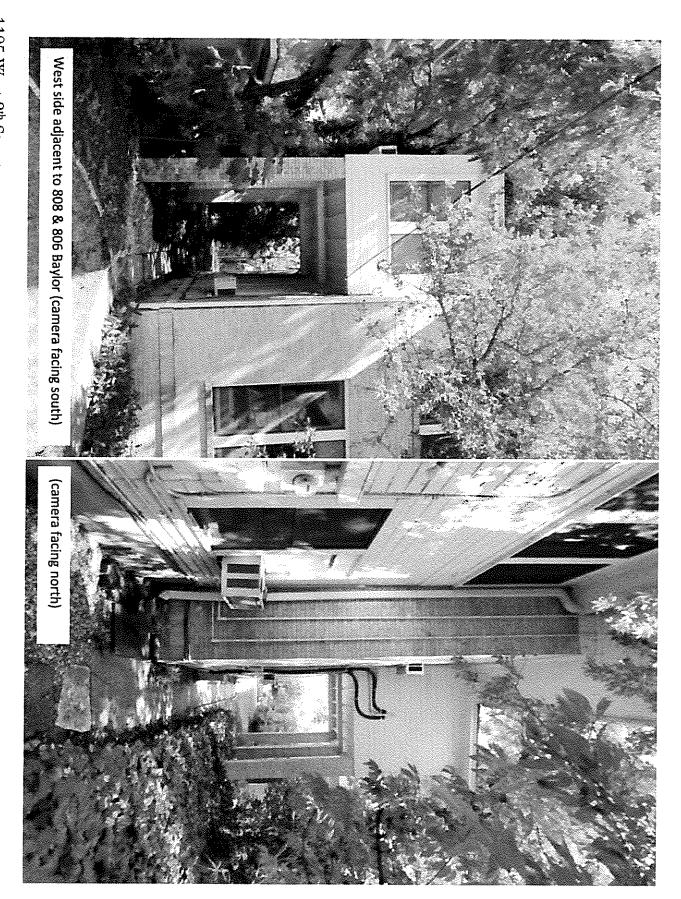



1105 9TH. W. STREET AUSTIN, TEXAS

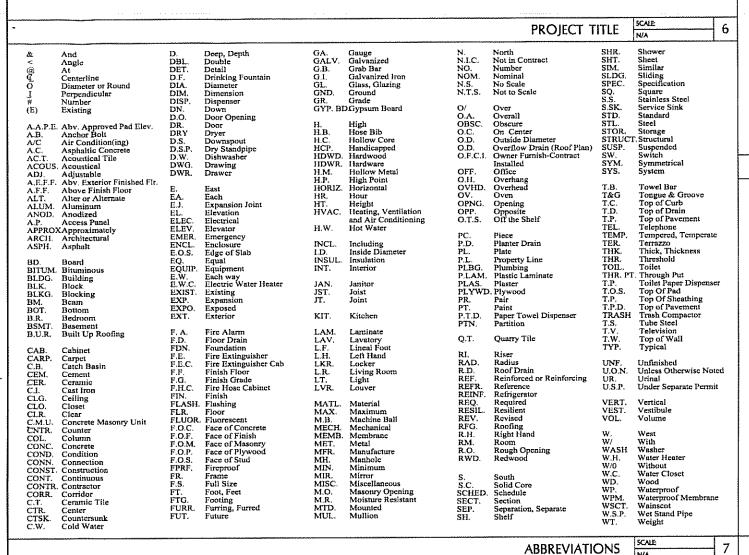

BUILDING GRID

LINES

WINDOW SYMBOL

DOOR SYMBOL


DETAIL NO.

CONSTRUCTION

TYPE SYMBOL

SHEET NO.


OPENING SYMBOL

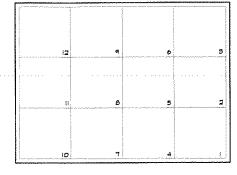

ALL DRAWINGS AND DETAILS ARE IDENTIFIED BY THE GRID NUMBER IN THE LOWER RIGHT HAND CORNER. ALL NUMBER LOCATIONS CONFORM TO THIS GRID SYSTEM.

SHEET GRID SYSTEM

AUSTIN, TEXAS

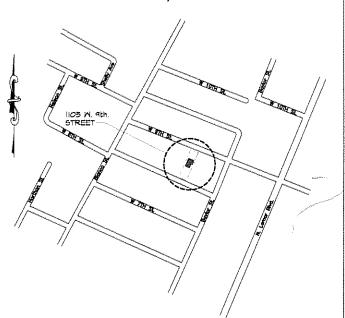

VICINITY MAP

ARCHITECTURAL DRAWINGS

A 1.0 COVER SHEET

A 20 ARCHITECTURAL SITE PLAN - EXISTING

FIRST & SECOND FLOOR DEMOLITION PLAN FIRST & SECOND FLOOR ANNOTATION PLAN

FIRST & SECOND FLOOR DIMENSION PLANS

ROOF PLAN

A 4.0 BUILDING SECTIONS

NORTH & FAST EXTERIOR FLEVATIONS

SOUTH & WEST EXTERIOR ELEVATIONS EXTERIOR ELEVATION MAXIMUM HEIGHT ENVELOPES

DOOR SCHEDULE

WINDOW SCHEDULE A 6.1

A 7.0 STAIR DETAILS

FYTERIOR DETAILS EXTERIOR DETAILS

AE 3.0 EXTERIOR DETAILS

AE 31 EXTERIOR DETAILS

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THEE DRAWINGS, DESIGN CONCEPTS, AND IDAS ARE THE PROPERTY OF WELLAM HUMBERS ARCHITECTURE AND SHALL NOT BE USED FOR ANY PROPERTY OF THE STANDARD HIS BY AND HE CONSTRUCTION OF THE STREET, PROJECT PROJECTED HEIDER, AND SHALL NOT BE USED UNLESS TRESONAULY ENDORSED ON EACH DRAWINGS TRESONAULY ENDORSED ON EACH DRAWINGS.

ARCHITECT: WILLIAM HABLINSKI ARCHITECTURE, INC.

AUSTIN OFFICE 2905 WESTLAKE COVE AUSTIN, TX 78746 TEL: (310) 600-6940



PROJECT TITLE AND ADDRESS:

1105 M. 9th ST.

NOTES:
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REVISION DATE

SHIFT NAME AND SCALE. AS NOTE COVER SHEET

Joe Kaplan 203 Lakeridge Dr. San Antonio, TX 78229 210-822-7124 Land 310-701-9090 Cell

APRIL 4th. 2017

DRAWING DATA: PROJECT NO: CHECKED:

ISSUE DATE DRAWN BY:

SHEET NUMBER:

PROJECT LEAGL DESCRIPTION:

PROJECT ADDRESS

REVISION CLOUD

Historic District: Castle Hill LHD

Lot #9, Block - A. Olt 2 Div. Z (Old West Austin)

Zoning District: MF-4

Lot Size: 9,168 Sq. Ft.

HISTORICAL CONSULTANT: O'Connell Architecture 1405 West 10th Street

Contact: Charlotte Grant (512) 419-8888

STRUCTURAL ENGINEER:

Smith Structural Engineers 9701 Brodie Lane, Suite A-204 Austin, TX 78748 (512) 478-5281

CIVIL ENGINEER: Urban Design Group Don Sansome (512)347-0040 ext 111

(512)633-6552

Austin, Texas 78703 Contact: Tere O'Connell 512 751-1374

ARCHITECT: William Hablinski 2905 Westlake Cove Austin, TX 78746

(310) 600-6940

HVAC & AIR QUALITY:

Positive Energy 1206 B 5 3rd St Austin, TX, 78704 512 462 3221 office

DIRECTORY

DRAWING INDEX

J Pinnelli Company 1507 West 6th Street Austin, TX 78703 (512) 478-5958

Contact: Mike Austin (512) 844-5600 mike@pinnelli.com

LIGHTING DESIGN:


LANDSCAPE DESIGN:

Christy Ten Byck 512 813-9999 office

512 492-5805 cell

CONTRACTORS AND CONSULTANTS

2

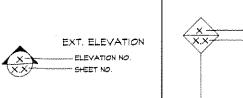

DETAIL

DETAIL NO

AREA DETAIL

DETAIL NO.

-SHEET NO.

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(wxxx)

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PROJECT SYMBOLS

INTERIOR ELEVATION

SECTION

MALL SECTION NORTH

SECTION NO

SHEET NO

GRID SPACE NO.

8

REVISION NO

MORK POINT

TRUE NORTH

NORTH ARROW


CONTROL POINT

OR DATUM POINT

PROJECT DATA

4

5

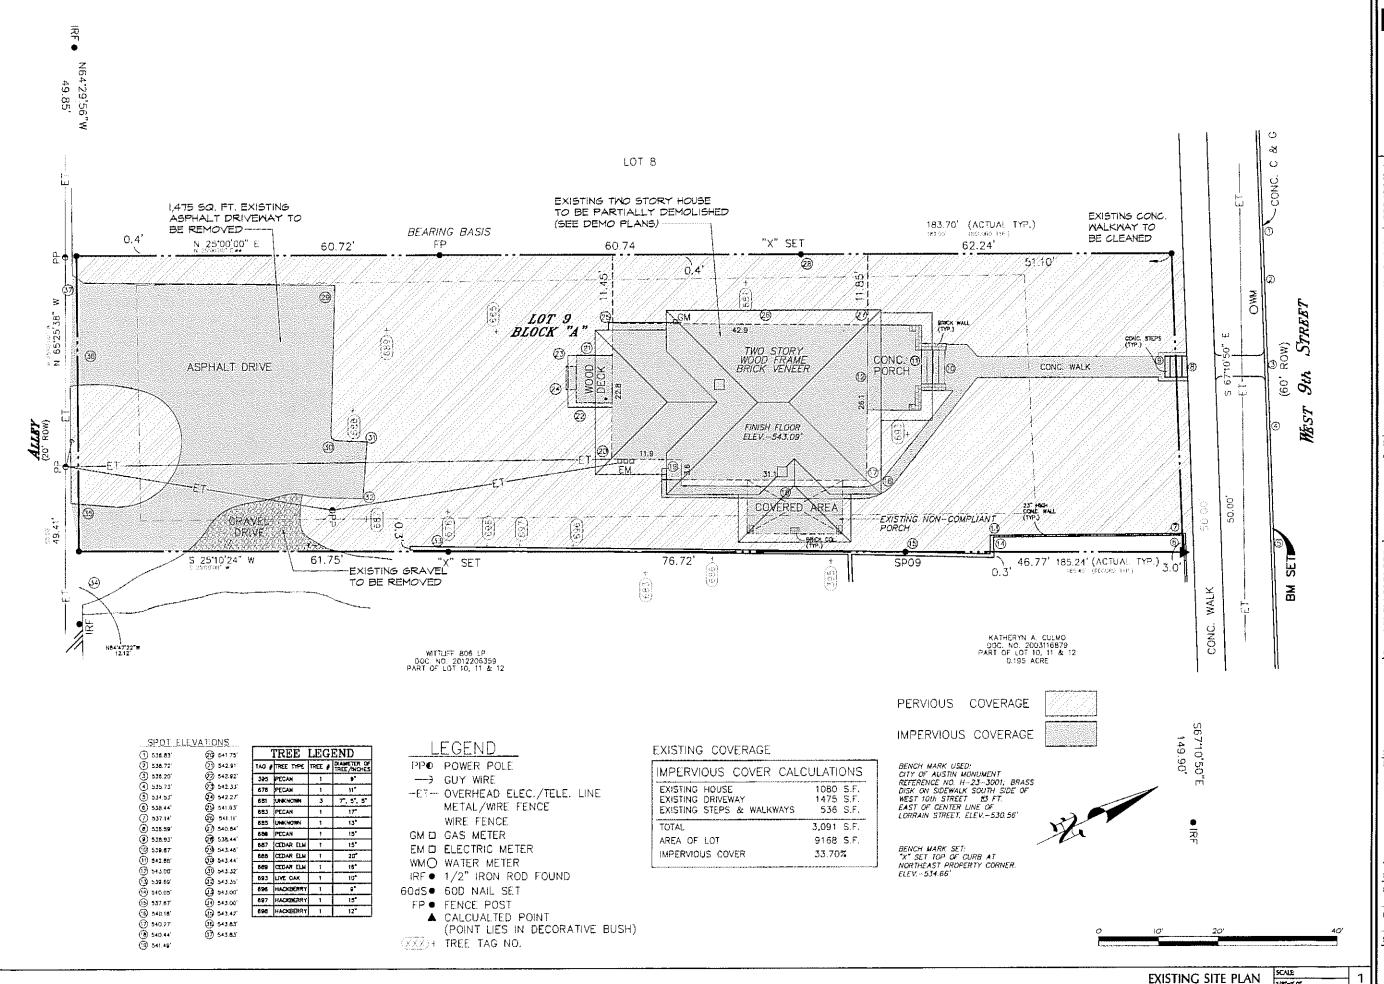

HABLINSKI Architecture MARCARI

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ARCHITECTE WELLIAM HABLENSKI ARCHITECTURE, INC. AUSTIN OFFICE

2905 WESTLAKE COVE AUSTIN, TX 78746 TE: 0103 600-6940



PROJECT TITLE AND ADDRESS: 1105 M. 9th ST.

AUSTIN, TEXAS

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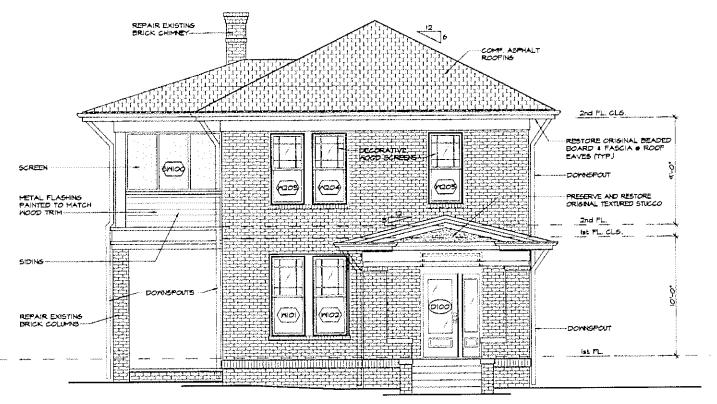
SHEET NAME AND SCALE AS NOTE EXISTING SITE PLAN

APRIL 4th. 2017

PROJECT NO: CHECKED:

ISSUE DATE

SHEET NUMBER



EXTERIOR ELEVATION GENERAL NOTES.

- DOCUMENT BRICK ASSEMBLY AND COURSING RELATIVE TO EXISTING TRIM AND FASCIA TO REMAIN TO ALLOW FOR ACCURATE RECONSTRUCTION FOLLOWING INSTALLATION
- 2. REMOVE AND SALVAGE BRICK VENEER.
- 3. INSTALL NEW VAPOR BARRIER AND INSULATION IN MALLS PER DETAILS
- 4. REINSTALL BRICK VENEER WITH I INCH AIR BARRIER -COORDINATE AIR BARRIER PRIOR TO DISASSEMBLY.
- 5. REFER TO ELEVATIONS AND SCHEDULES FOR SPECIFIC

HABLINSKI MODOW

THESE DIAMENTS, DESCH CONCEPTS, AND DESS ASE THE PROPERTY OF WILLIAM HARMERS ARCHITECTURE AND SHALL NOT SE USED DIX ANY REPORT PROCESSOR OF THE CONCEPTURE OF THE SPECIFIC PROJECT MODICATED HARDIN, AND SHALL NOT SELECT MODICATED UNIQUE PRESCHALLY DESCRIPTION OF THE SPECIFIC PROJECT MODICATED ON EACH COMMITTED SHALL NOT MODIFIED ON EACH COMMITTED THE SECONDARY PRODUCED ON EACH COMMITTED.

ARCHITECT: WILLIAM HABLINSKI ARCHITECTURE, INC.

AUSTIN OFFICE 2905 WESTLAKE COVE AUSTIN, TX 78746 TE; (210) 600-6940



W. M. HABLINSKI, MA

PROJECT TITLE AND ADDRESS:

1105 M. 9th ST. AUSTIN, TEXAS

NOTES

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REVISION DATE

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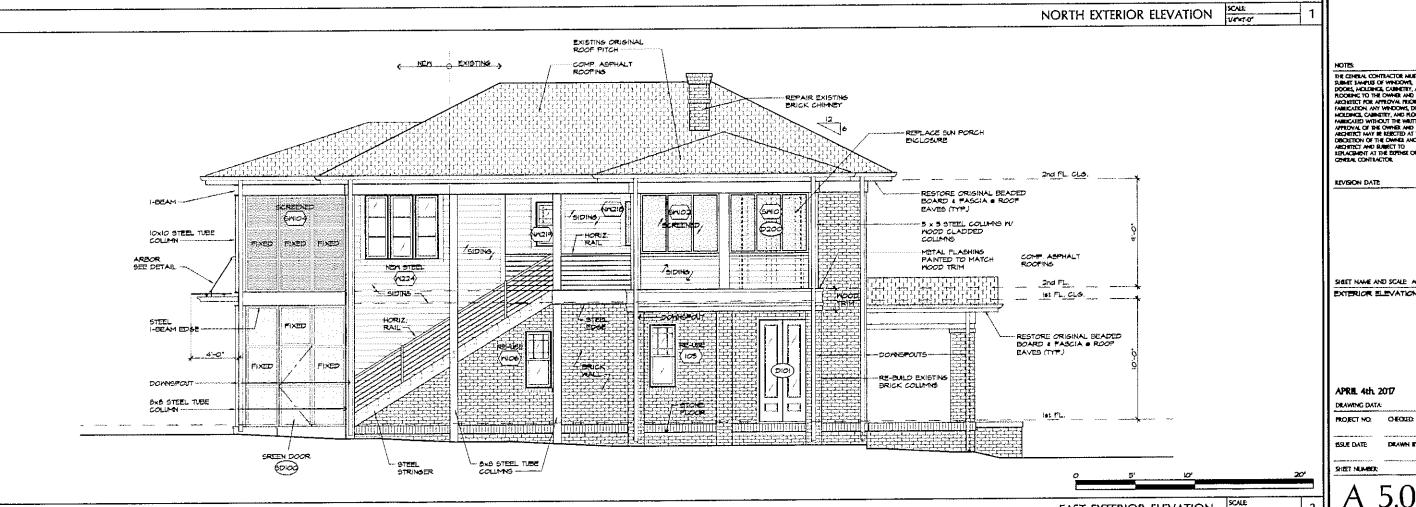
APRIL 4th. 2017


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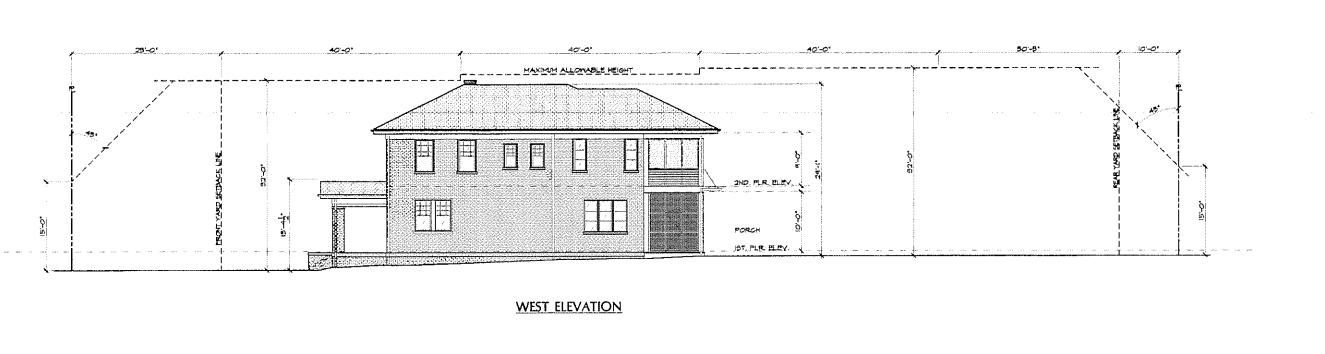
EAST EXTERIOR ELEVATION


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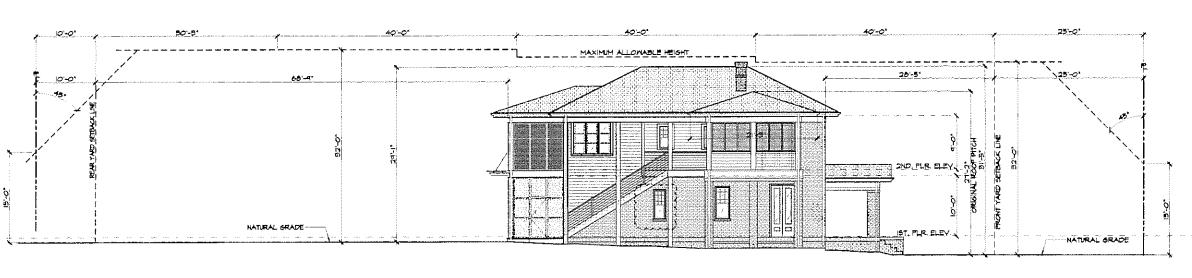
SHIET NUMBER:








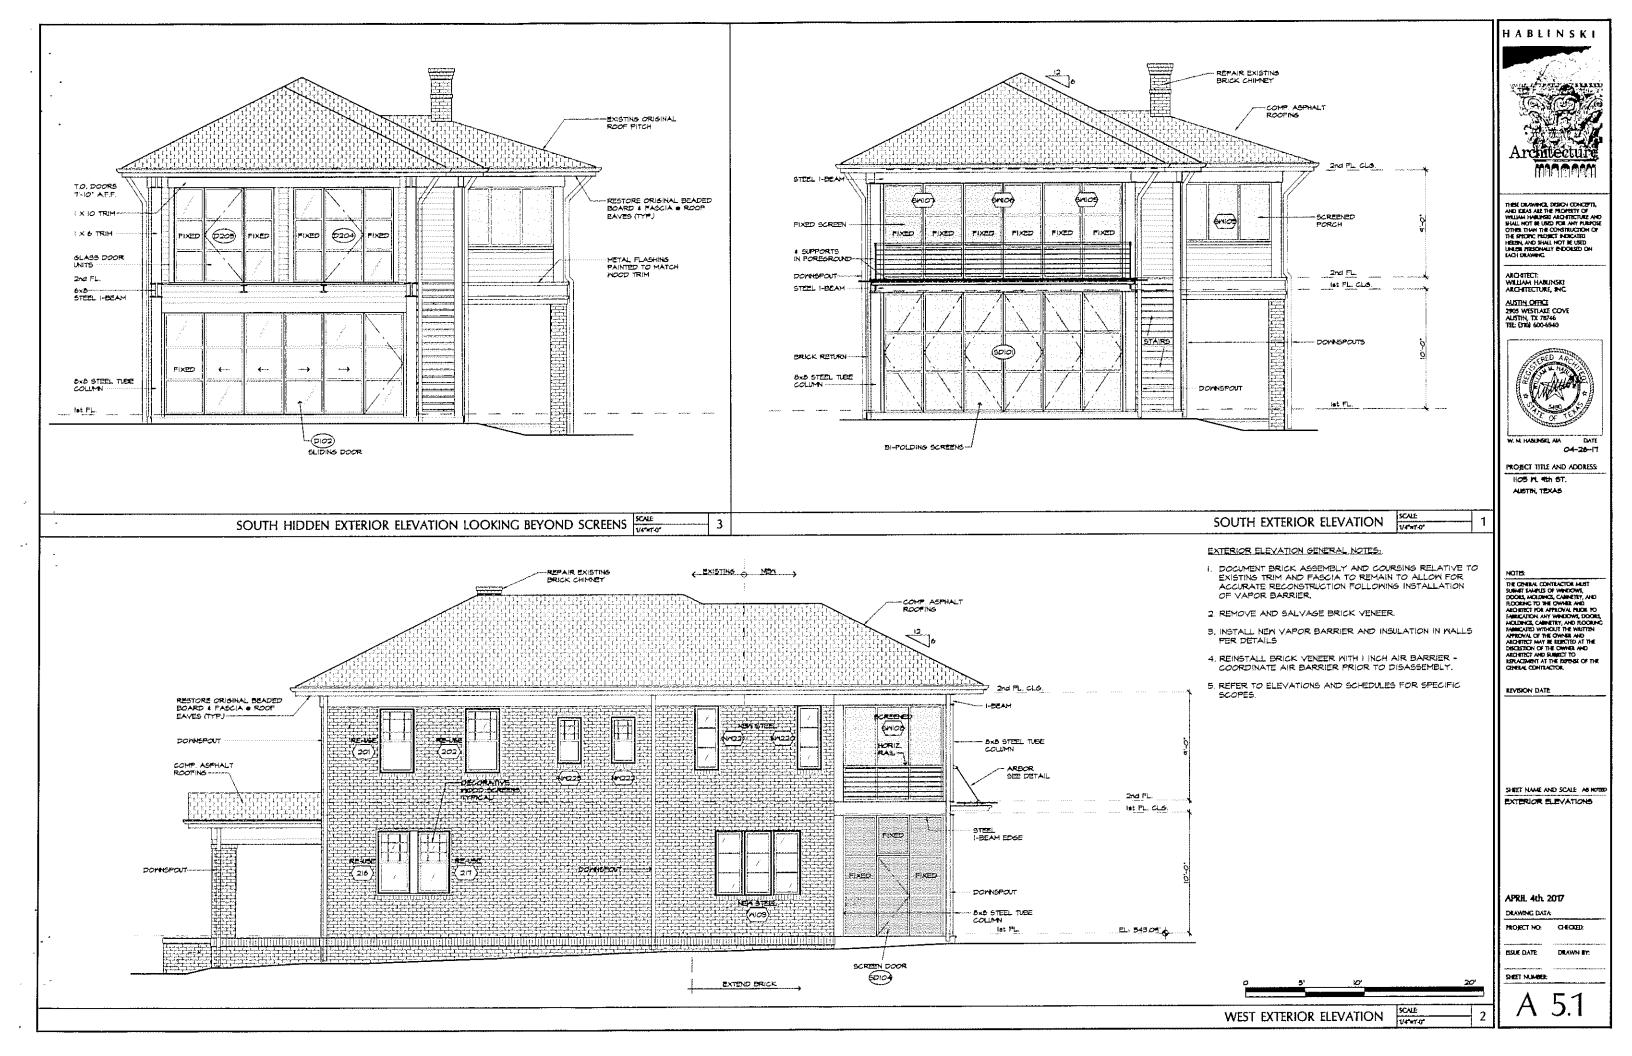

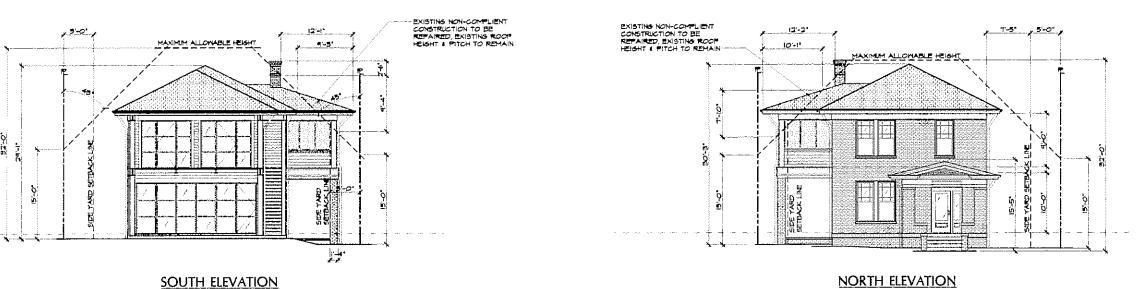

EAST ELEVATION

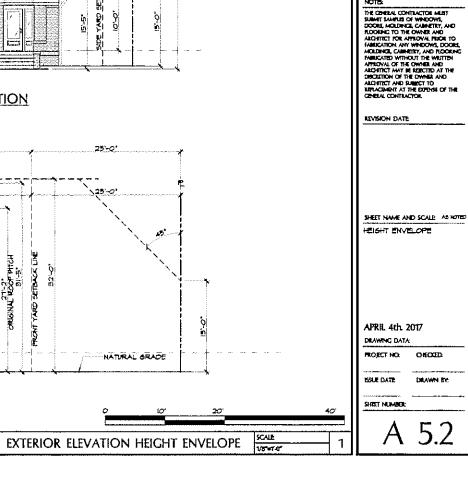

HABEINSKI

Architectur

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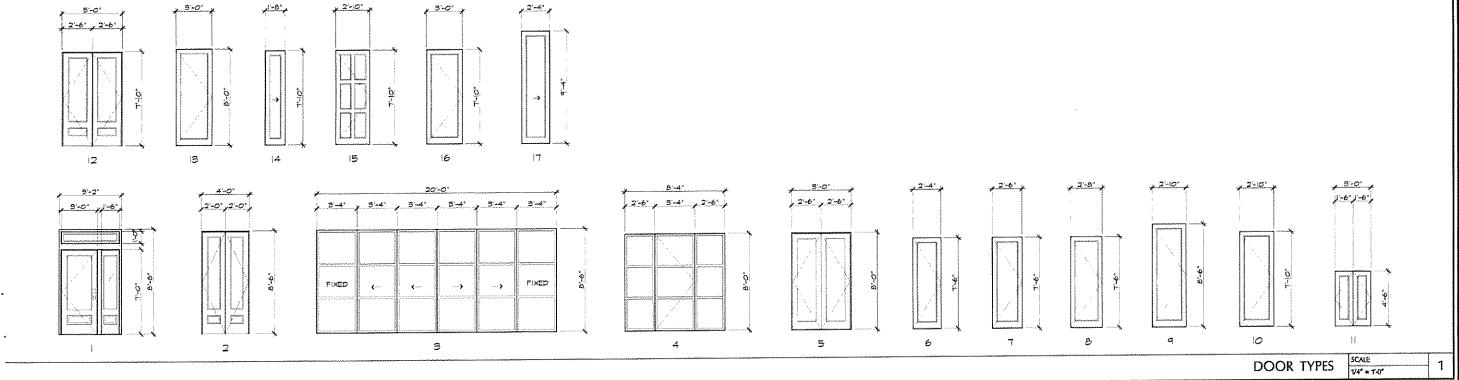
ARCHITECT: WELLAM HABLINSKI ARCHITECTURE, INC.

AUSTIN OFFICE 2905 WESTLAKE COVE AUSTIN, TX 78746 TB: (290) 600-6940

PROJECT TITLE AND ADDRESS: ILOS M. 9th 5T. Austin, Texas

						1	i siemia/		
MARK	ROOM	MIDTH	AL SIZE HEISHT	TYPE	DESCRIPTION	TO BE CLEANED	DOOR	REMARKS	NOTE: INTERIOR DOOR STYLES PENDING
FIR	ST FLOOR						~		
DIOO	OFFICE / LIVING ROOM	5'-0'	88.	}	ENTRY DOOR UNIT	*	;	3'-0" 1'-0" DOOR WITH SIDE LIGHTS & TRANSOM	
DIO	BEDROOM	4'-0"	8'-6"	2	FRENCH DOOR UNIT	a constant	*	MOOD	
DIO2	LOUNGE	20'-0"	8-6"	3	SLIDING UNIT		*		
. פסום	BEDROOM	2'-8"	7-6"	8	HINGED RAISED PANEL DOOR		*		
DIO4	CLOSET	2'-4"	T'-6*	6	POCKET DOOR		*		
Di05	BATH	2'-6"	7'-6"	7	HINGED RAISED PANEL DOOR		*		111
DI06	POWDER ROOM	2'-8"	7'-6"	В	HINGED RAISED PANEL DOOR		*		
דסום	A / V CLOSET	3°-0°	4'-6"	11	VERIFY FRENCH DOORS		*		
DIOB	KITCHEN	2'-10"	8-6"	9	HINGED RAISED PANEL DOOR		*		
POIQ	PANTRY	2'-6"	7'-6"	7	HINGED RAISED PANEL DOOR		*		
SDIOO	REAR PORCH	B'-4"	10'-0"	- La vocamenta	SCREEN DOOR STEEL FRAME		*	OPERABLE CENTER UNIT (6'-8" HIGH W/ TRANSOM) WITH 2 FULL HEIGHT FIXED SIDE UNITS	
50101	REAR PORCH	20'-0"	10'-0'		BI-FOLD SCREENS STEEL FRAME		*		
5D103	- NOT USED -								
50103	- NOT USED -						<u>.</u>		
50104	REAR PORCH	8'-4"	10'-0'		SCREEN DOOR STEEL FRAME		*	OPERABLE CENTER UNIT (6'-8" HIGH W/ TRANSOM) WITH 2 FULL HEIGHT FIXED SIDE UNITS	4
SEC	COND FLOOR		***************************************						
	SITTING ROOM	5'-0"	7'-10"	1 2	FRENCH DOOR UNIT	96946999999999999999999999999999999999	*	WOOD	
D201	SITTING ROOM	2'-10"	7-10'	15			*		
D202		2'-10"	7'-10"	15	and the second s		*		
D203		8'-4"	7'-10"	4	STEEL UNIT		*	OPERABLE CENTER UNIT (3'-4") WITH 2 FIXED SIDE UNITS (2'-6")	
D204	BEDROOM	B'-4"	7'-10"	4	STEEL UNIT		*	OPERABLE CENTER UNIT (3'-4") WITH 2 FIXED SIDE UNITS (2'-6")	
D205	BEDROOM	8'-0"	T'-10°	14	4 SLIDING UNITS WITH POCKET IN WALL		*		, ma
D206		2'-10"	7'-10"	10			*		
5207	CLOSET	3'-0"	7'-10"	16		a a a garaga	*		
D208		2'-10"	7'-10'	10			*		A company
D204	- NOT USED -			×			*		
D210	UTILITY	2'-10"	7'-10"	10			*		
D2:1	CLOSET	B'-0"	7'-10"	16			*		
D212	BATH	2'+ 0"	7'-10'		and the state of t		*		
0215		9'-4"	7'-10'		4 SLIDING UNITS WITH POCKET IN WALL		*		
			<u> </u>				<u> </u>		

SCALE NONE DOOR SCHEDULE



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Architecture ,

THESE DIAMNINGS, DESIGN CONCEPTS, AND IDEAS ARE THE PROPERTY OF WELLIAM HABILISES AND HITCTUSE AND SHALL NOT SE USED TOK ANY PURPOSE OTHER THAN THE CONSTRUCTION OF THE SPECIFIC PROPECT INDICATE HEREN, AND SHALL NOT SE USED UNIESS PRESONALLY ENDORSED ON EACH DRAWFING.

ARCHITECT: WILLIAM HABLINSKI ARCHITECTURE, INC. AUSTIN OFFICE

2905 WESTLAKE COVE AUSTIN, TX 78746 TEL: (310) 600-6940



PROJECT TITLE AND ADDRESS: ILOS M. 9th ST.

AUSTIN, TEXAS

NOTES

NOTES:
THE CHIEFAL CONTRACTOR MAST
STRAIT SAMPLES OF WINDOWS;
DOORS, MODIBONS, CARRIETY, AND
ROORING TO THE OWNER AND
AGGITTET OF APPOARS HOOR TO
FARRICATION ANY WINDOWS, DOORS,
MODINING, CRIENTEY, AND FLOORING
FARRICATED WITHOUT THE WRITTEN
APPOARS OF THE OWNER AND
ARGUITTET MAY BE ESECTED AT THE
DECLETION OF THE OWNER AND
ARGUITTET AND STABLICT TO
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CENERAL CONTRACTOR.

REVISION DATE

SHEET NAME AND SCALE AS NOTED DOOR SCHEDULE

APRIL 4th 2017

DRAWING DATA:

PROJECT NO: CHECKED: ISSUE DATE: DRAWN BY:

SHEET NUMBER:

A 6.0

MARK	ROOM	NOM:N/ WIDTH	AL SIZE HEISHT	HEAD ME	G. TYPE	DESCRIPTION	TO BE CLEANED & RE-USED	TO BE MOVED	NEW MINDOM	REMARKS
FIRS	T FLOOR		1							
MIO!	BEDROOM	: 2'-8"	5'-10"	: 8'-6* :	i 6		*	- CALCARO PROPERTO		DECORATIVE WOOD SCREEN
MI02	BEDROOM	2'-8*	5'-10"	8'-6" i	; C		*			DECORATIVE WOOD SCREEN
MIOS	LOUNGE	7'-0"	5'-2"	8'-6"	6	STEEL UNIT			*	
MIO4	- NOT USED -		ļ				* * *			
MI05	BATH	2'-0"	4-6°	8'-6"	#		*	*	and a first for a few sections of the section of t	DECORATIVE WOOD SCREEN
MIC6	PONDER ROOM	I'-8"	4-6"	7'-6"	F2		*	*		DECORATIVE WOOD SCREEN
M2l6	OFFICEALIVINS	2'-0"	4-6*	B'-6*	F		*	*		DECORATIVE MOOD SCREEN
M217	OFFICE/LIVING	2'-0"	4-6*	8'-6*	F			*		DECORATIVE WOOD SCREEN
	o o o o o o o o o o o o o o o o o o o									
									, e. , , , , , , , , , , , , , , , , , ,	
	OND FLOOR									100ml do C6656 (1000000000000000000000000000000000000
	·			mi i and			*	*		DECORATIVE WOOD SCREEN
M20I	SITTING ROOM	2'-8"	5'-2'	7-10"	D D		*	*		DECORATIVE MOOD SCREEN
M202	SITTING ROOM	2'-8"	§ 5'-2'	7-0"			***************************************	····.	,,.,,,,,,,	DECORATIVE MOOD SCREEN
M203	SITTING ROOM	2'-8"	5-10"	7'-10"			*			DECORATIVE WOOD SCREEN
M204	SITTING ROOM		5'-10"	7'-10"	٠		*		,,,,,,	DECORATIVE WOOD SCREEN
M205	BEDROOM	2'-8"	5-10"	7-10"						Manual Contraction of the Contra
NW216	annount for most frame for the second contraction of the second contraction for the second contraction of the second contr	2'-8"	5'-2"	8'-6"	, K		* *			
NM2 7		2'-8"	5'-2"	8'-6"	K		**************************************	.,	*	DECORATIVE WOOD SCREEN
NM215	KITCHENETTE	1'-10	3'-6"	7'-10"	<u></u>	WOOD, DOUBLE HUNG				DECORATIVE MOOD SCREEN
NM2!9	KITCHENETTE	!'-i <i>o</i> "	5'-6"	יד		MOOD, DOUBLE HUNG			*	DECORATIVE POOD SOCIETY
NW220	BEDROOM	1'-10"	5'-2'	7'-10"	A	STEEL UNIT			*	
NM22:	BEDROOM		5'-2'	T'- O"	A	STEEL UNIT		e para para para para para para para par	*	
NM222	BATH	i'-l0"	3'-8"	1'-IO"	E	MOOD, DOUBLE HUNS			*	DECORATIVE WOOD SCREEN
NW229	BATH	1'-10"	3'-8"	T-10"	E	MOOD, DOUBLE HUNG			*	DECORATIVE WOOD SCREEN
NM224	SITTING ROOM	6'-0"	5'-2'	T'-IO"	H	STEEL UNIT		وددده بردو التقديم والمراوا والمحسسات المراسسات	*	
			ļ,						*	
	,								*	
5M100	SCREENED FORCH	8'-0"	5'-0"	8'-0"		STEEL UNIT			*	
וסואפ	SCREENED PORCH	6'-8"	5'-0'	8'-0"		STEEL UNIT			*	
5MIO2	SCREENED PORCH	6'-6"	5'-0"	8'-0"		STEEL UNIT			*	
SMICS	SCREENED PORCH	7'-6"	5'-0"	8'-0"		STEEL UNIT			*	
5MI04	SCREENED PORCH	8'-4"	8'-0"	B'-C"		STEEL UNIT	5		*	
5MI05	SCREENED PORCH	6'-8"	a'-o"	8'-0'		STEEL UNIT		o, en per popo e per personal de la compansa de la	*	
SMIC6	SCREENED PORCH	6'-8"	8'-0"	8'-0"		STEEL UNIT			*	
SWIOT	SCREENED PORCH	6'-8'	8'-0"	. 8'-O" ;		STEEL UNIT			*	
SMICS	SCREENED PORCH	8'-4"	8'-0"	8'-0"		STEEL UNIT			*	

7'-0"

S

× 2-8° ×

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× 2-8" ×

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Architecture

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THISE DEAMINGS, DESIGN CONCEPTS, AND IDEAS ARE THE PROPERTY OF WILLIAM HARRISKES ARCHITICITISE AND SHALL NOT BE USED FOR ANY PURPOSE OTHER THAN THE CONSTRUCTION OF THE SHORE PROJECT NONCOUNT HE SHORE SHORE PROJECT NONCOUNT HE SHORE SHORE SHORE THE SHORE SHORE THE SHORE SHORE THE SHORE SHORE

ARCHITECT: WILLIAM HABLINSKI ARCHITECTURE, INC.

AUSTIN OFFICE 2905 WESTLAKE COVE AUSTIN, TX 78746 TEL: (310) 600-6940



PROJECT TITLE AND ADDRESS

1105 M. 9th ST. AUSTIN, TEXAS

NOTES

NOTE
THE CONTRACTOR MUST SUBMIT SAMPLES OF WINDOWS, SOUTHWARDOWS, DOORS, MODIFIED ON STREET OF WINDOWS, DOORS, MODIFIED ON APPLOVAL PREDR TO FAMILIATION AND WINDOWS, DOORS, MODIFIED, COMPRETE, MODIFIED COMPRISE AND MODIFIED AND WINDOWS, DOORS, MODIFIED COMPRETED AND WINDOWS, DOORS, MODIFIED COMPRETED THE WINDOWS, DOORS, MODIFIED AND WINDOWS, DOORS, MODIFIED AND WINDOWS, DOORS, MODIFIED AND WINDOWS, DOORS, DOORS,

REVISION DATE

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SHEET NAME AND SCALE AS NOTED NINDOM SCHEDULE

APRIL 4th 2017

DRAWING DATA:

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ESSUE DATE

SHEET NUMBER:

A 6.1

NOTES ON MINDONS

2'-6"

K

<u>بر"10-الر</u>

6'-0"

MINDOM RESTORATION TO INCLUDE:

WINDOW SCHEDULE

7. SEAL UPPER SASH SHUT 8. PREP, PRIME AND PAINT

WINDOW TYPES