



2017 July 10

Architect

M G — C

MAGIC Architecture 7712 Lazy Lane Austin, Texas 78757

(512) 994-5782

Project Title

Koppel Building Lobby Renovation

320 Congress Avenue Austin, TX 78701

Issue

June 20, 2017 Schematic Design

July 11, 2017 Historic Commission Drawings

Sheet Title

First Floor Plans

Sheet

A1.1



Arch



MAGIC Architecture 7712 Lazy Lane Austin, Texas 78757 (512) 994-5782

Project Title

Koppel Building Lobby Renovation

320 Congress Avenue Austin, TX 78701


June 20, 2017 Schematic Design

Sheet Title

Building Elevations North [4th Street]

Sha

A3.0

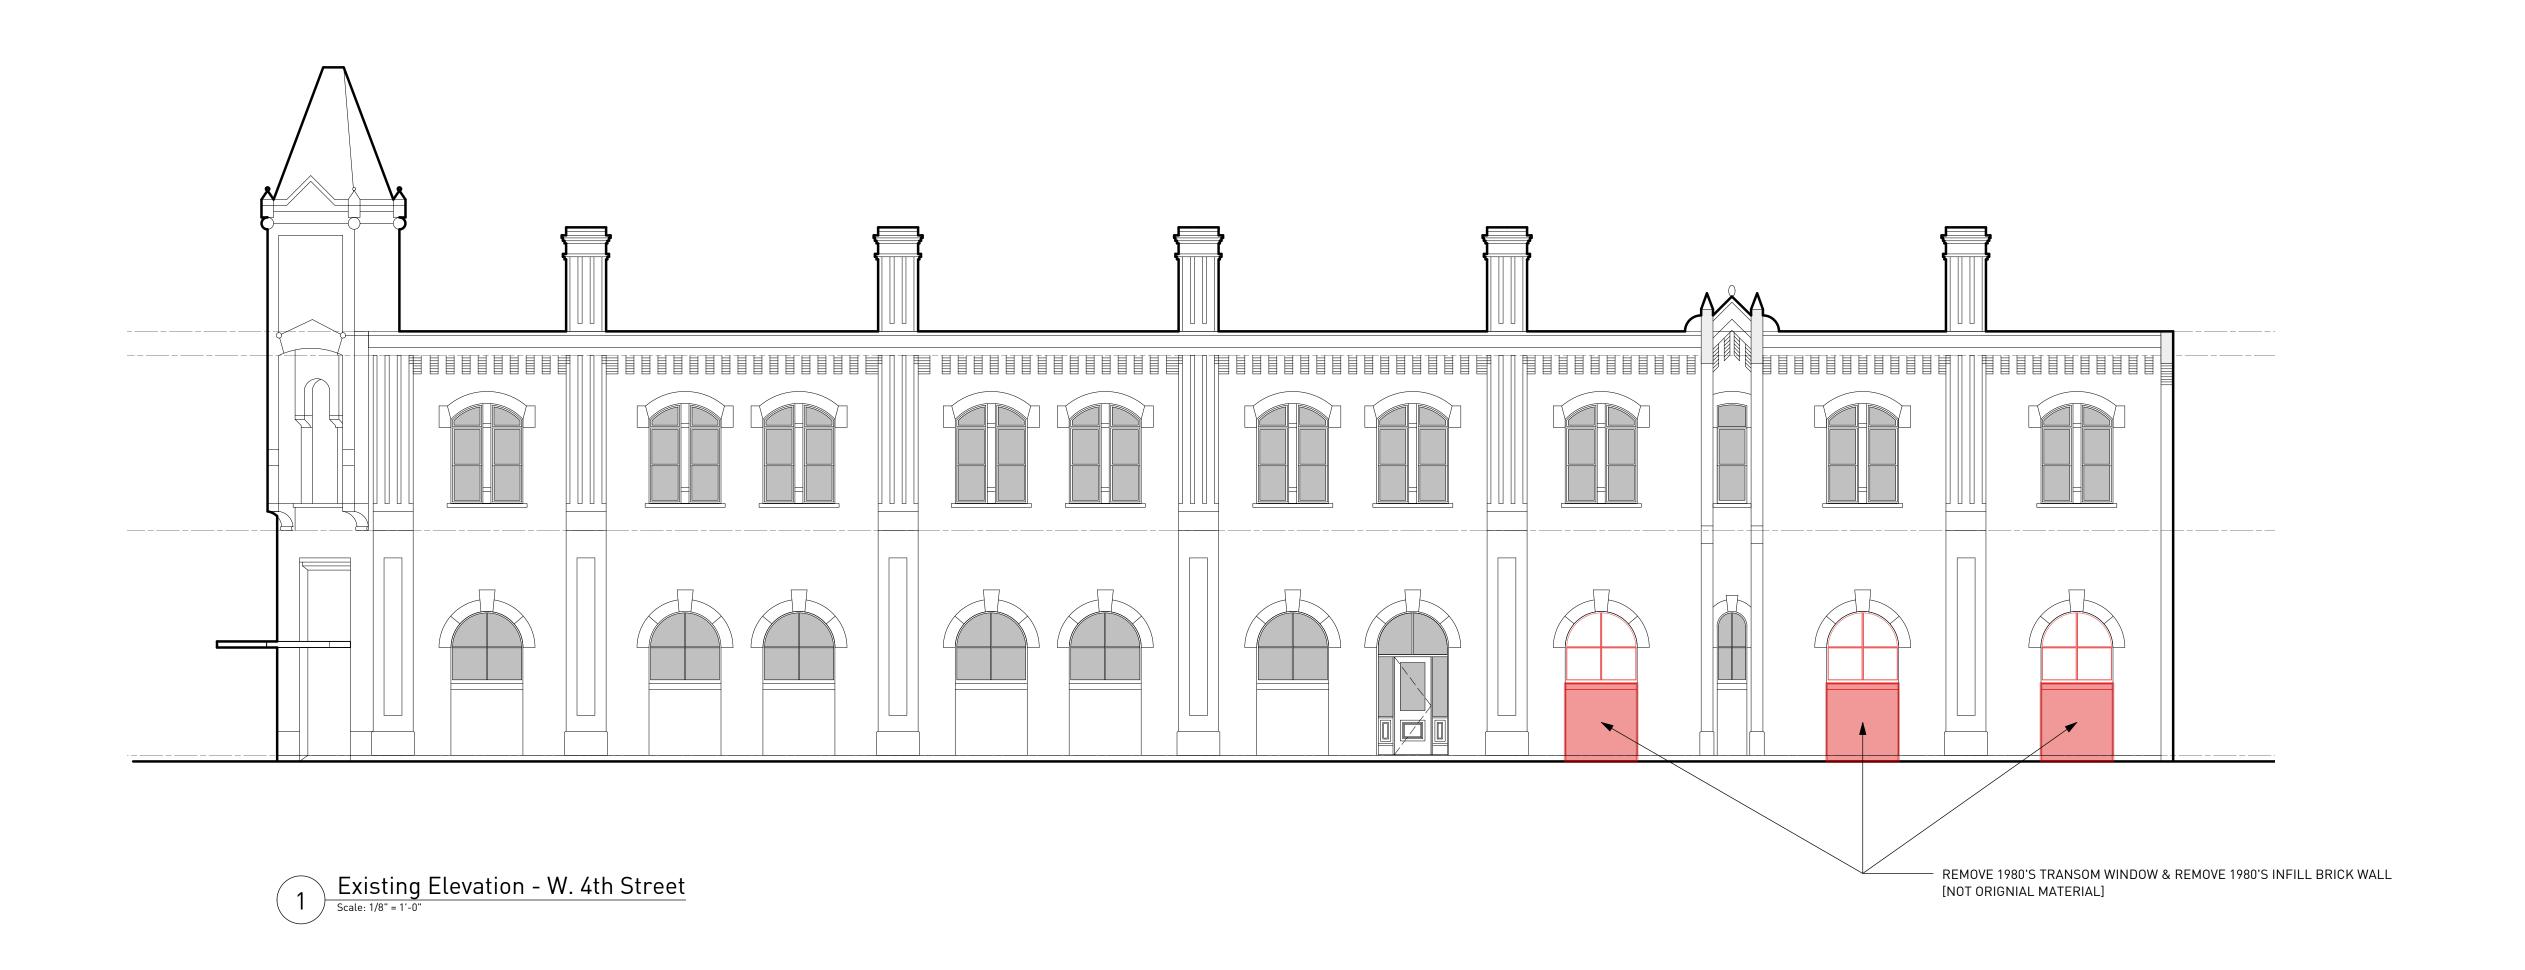





MAGIC Architecture 7712 Lazy Lane Austin, Texas 78757 (512) 994-5782

Project Title


Koppel Building Lobby Renovation

320 Congress Avenue Austin, TX 78701

June 20, 2017 Schematic Design


Sheet Title

Building Elevations West [Alley]

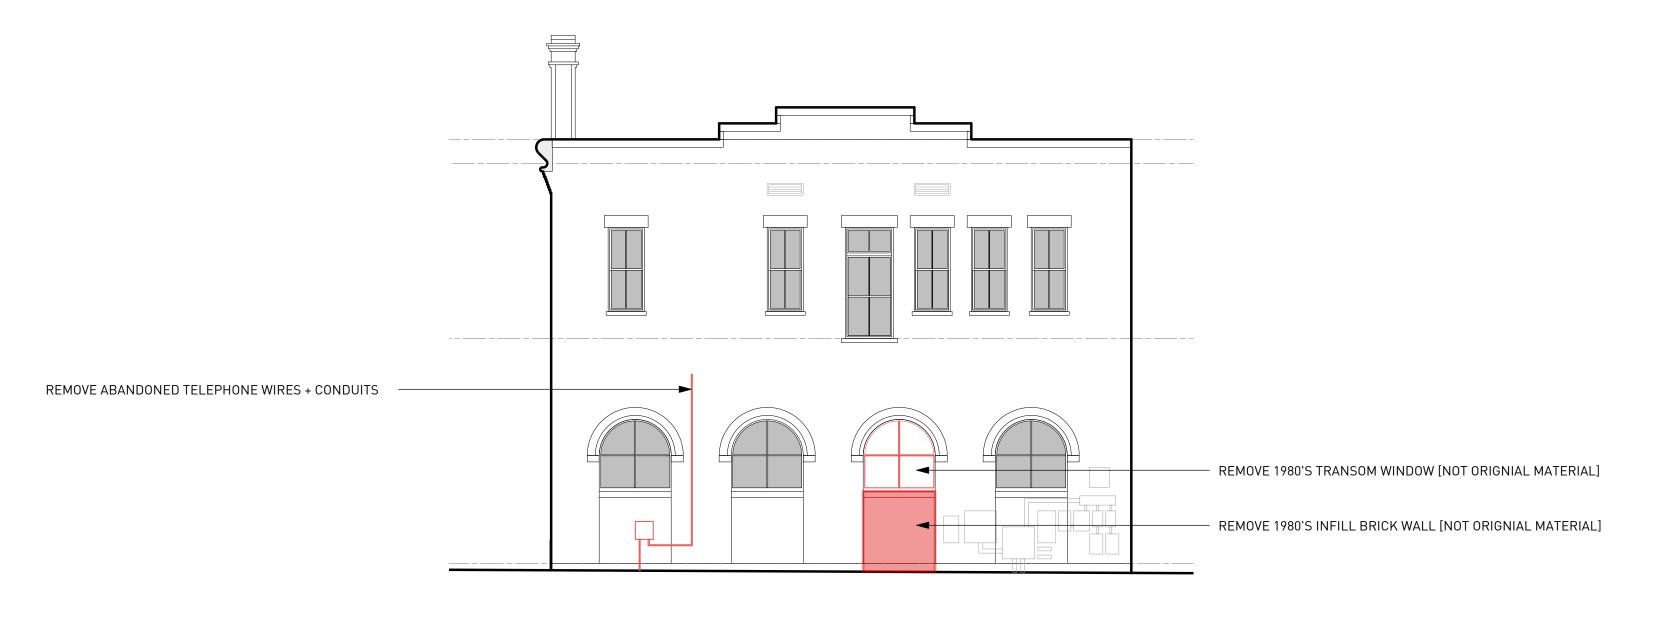

Existing Elevation - Alley


Scale: 1/8" = 1'-0"

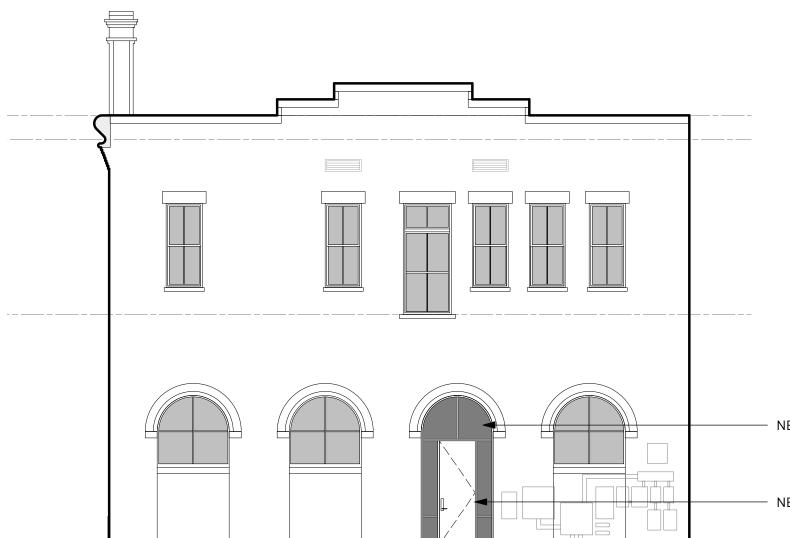

NEW WOOD TRANSOM WINDOW, PAINTED, MULLION PROFILES TO MATCH HISTORIC PROFILES ON-SITE

- NEW SOLID DOOR AND SIDELITES, PAINTED, MULLION PROFILES TO MATCH HISTORIC PROFILES ON-SITE

2 Proposed Elevation - Alley
Scale: 1/8" = 1'-0"

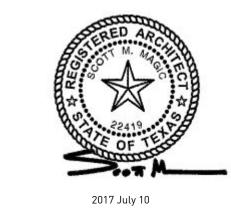

Architect



MAGIC Architecture 7712 Lazy Lane Austin, Texas 78757 (512) 994-5782

Project Title

Koppel Building Lobby Renovation

320 Congress Avenue Austin, TX 78701

Issue

June 20, 2017 Schematic Design


July 11, 2017 Historic Commission Drawings

Sheet Title

Doors + Windows

Sheet

0.8A

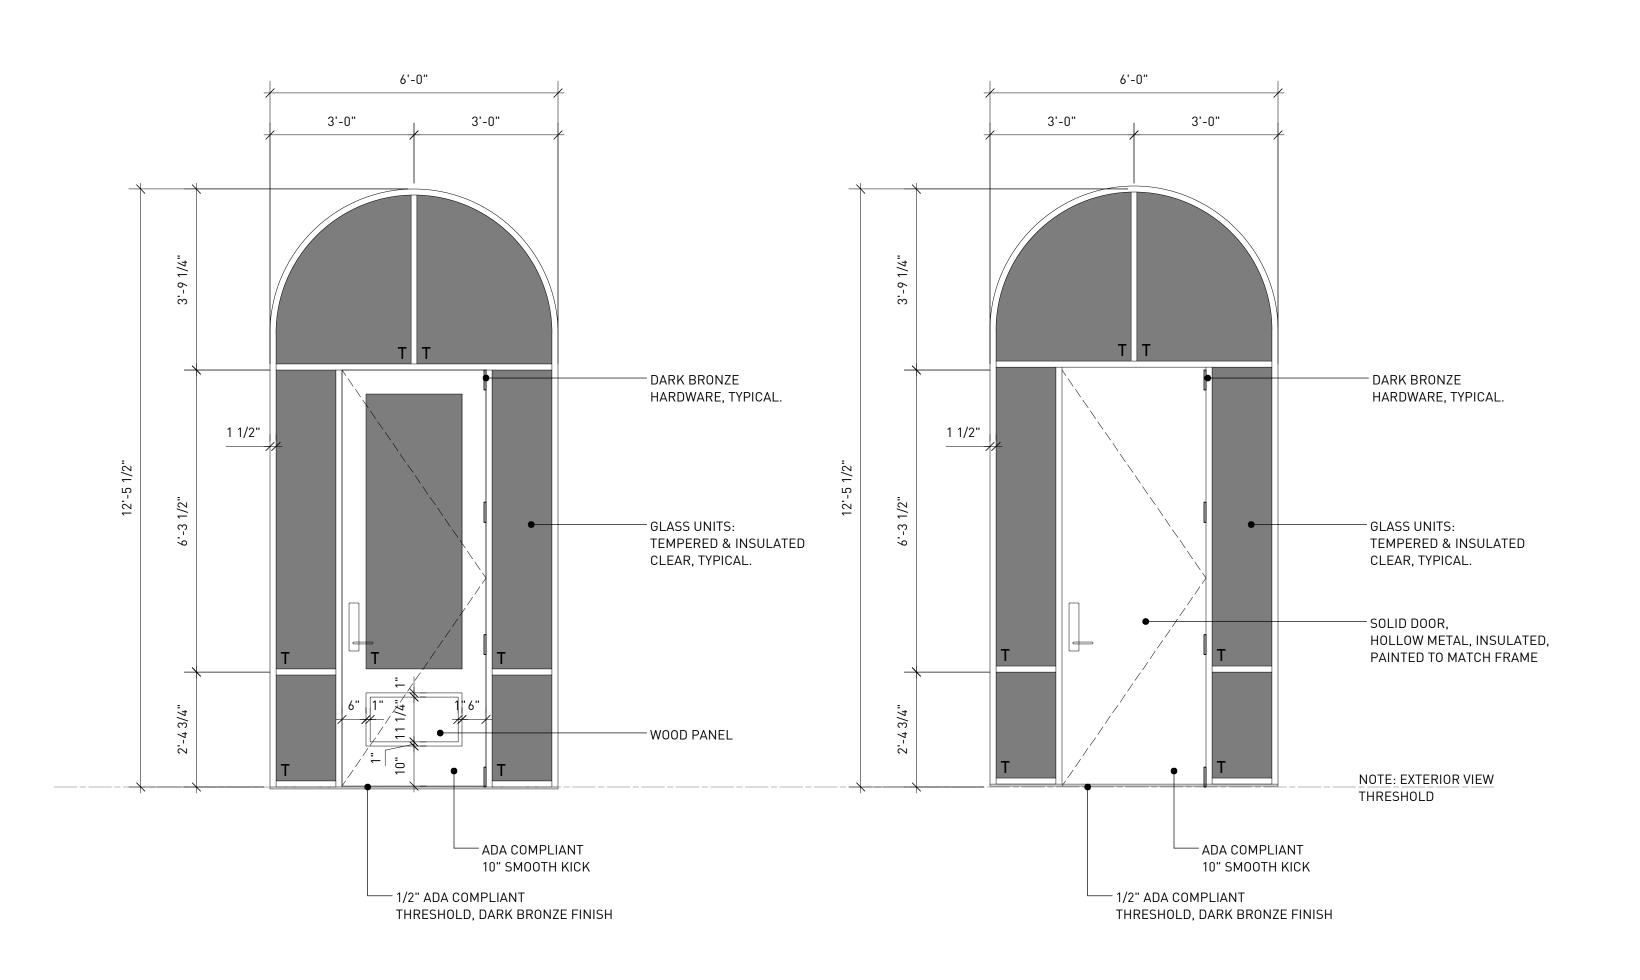

Exterior Doors + Window Elevations

Scale: 1/2" = 1'-0"

EXTERIOR WINDOW & DOOR SPECIFICATIONS

SUBCONTRACTOR TO PROVIDE SHOP DRAWINGS AND FIELD VERIFY ALL DIMENSION PRIOR TO FABRICATION OF UNIT.
 EXTERIOR FACE OF WINDOW UNIT TO BE FACTORY FINISHED.
 ALL GLASS UNITS TO BE TEMPERED PER 2015 IBC STANDARDS.

GLASS UNIT SHGC (SOLAR HEAT GAIN COEFFICIENT) = 0.37

PROJECTION FACTOR = 0.20

VISIBLE LIGHT TRANSMITTANCE = 0.60 = 60%

<u>U-FACTOR GLASS UNIT</u>:

<u>U-FACTOR DOOR</u> = 0.83

WOOD SPECIES: DOUGLAS FIR, GRADE: CLEAR VERTICAL GRAIN

EXTERIOR FINISH: VARINSH, TO MATCH EXISTING BUILDING COLOR

INTERIOR FINISH: NONE, RAW

EXTERIOR WINDOW & DOOR MANUFACTURERS

- DURATHERM WINDOW SERIES: WOOD WINDOWS + DOORS

- PELLA WINDOW CORPORATION SERIES: COMMERCIAL WOOD STOREFRONT

SERIES: MARVIN, CUSTOM HISTORIC PROFILE WOOD WINDOWS

EXTERIOR DOOR HARDWARE SET

HINGES: (4) HAGER OR EQUAL

BALL BEARING, HEAVY-DUTY USE

FINISH: BLACK OR DARK BRONZE

CLOSER: DORMA 8900 SERIES CLOSER
SURFACE APPLIED, INTERIOR FACE

FINISH: BLACK OR DARK BRONZE

THRESHOLD: NGP

GASKET: BY MANUFACTURER, BLACK, 3-SIDES OF DOOR

LEVER SET: MORTISED

FINISH: BLACK OR DARK BRONZE

DEADBOLT: LEVER INSIDE (ADA COMPLIANT) FINISH: BLACK OR DARK BRONZE

MOUNTING HEIGHT: CENTER OF LEVER = 36" ABOVE FLOOR