




Residential Review – One Texas Center 505 Barton Springs Road, Austin, TX 78704; (512) 978-4000

Residential New Construction and Addition Permit Application

To complete this form electronically: Open with Internet Explorer, then <u>Click Here to Save</u> and continue.

9/22/2016 | Page 1 of 7

3-11-11-11-11-11-11-11-11-11-11-11-11-11	and contained.
Property Information	
Project Address: 4307 Avenue C	Tax Parcel ID:
Legal Description: Lots 7 & 8, Blk 13, Hyde Park Ac	dition Plat record Vol. 1. Page 67
Zoning District: SF-3-NP	Lot Area (sq ft): 6020
Neighborhood Plan Area (if applicable): Hyde Park	Historic District (if applicable):
Required Reviews	
Is project participating in S.M.A.R.T. Housing? Y (If yes, attach signed certification letter from NHCD, and signed conditional approval letter from Austin Energy Green Building)	Does project have a Green Building requirement? Y N (If yes, attach signed conditional approval letter from Austin Energy Green Building)
Is this site within an Airport Overlay Zone? (If yes, approval through Aviation is required)	Does this site have a septic system? (If yes, submit a copy of approved septic permit)
Does the structure exceed 3,600 square feet total under roof? Y Is this property within 200 feet of a hazardous pipeline? Y	N (If yes, Fire review is required) N (If yes, Fire review is required)
Is this site located within an Erosion Hazard Zone? Y N Is (If yes, EHZ review is required)	this property within 150 feet of the 100 year floodplain? Y (Proximity to floodplain may require additional review time.)
Is there a protected sized tree on this lot or adjacent lot(s)?	N (If yes, chick here for more information on the tree permit process.)
Is this site within the Residential Design and Compatibility Standards (Ordinance Boundary Area? (LDC 25-2 Subchapter F)
Does this site currently have: water availability? Wastewater availability? N N	· · · · · · · · · · · · · · · · · · ·
Are there existing water/wastewater infrastructure, appurtenances or ex (If yes, contact Austin Water Utility Pipeline Engineering for review and approval)	
Does this site have or will it have an auxiliary water source? Y (Auxiliary water supplies are wells, rainwater harvesting, river water, lake water, reclaim	(If yes, submit approved auxiliary and potable plumbing plans.)
	(If yes, contact the Development Assistance Center for more information)
	te within the Lake Austin Overlay? Y N
	te adjacent to a paved alley? Y N orks approval required to take access from a public alley.)
Does this site have a Board of Adjustment (BOA) variance? Y Does this site have a Residential Design and Compatibility Commissio (If yes, provide a copy of decision sheet. Note: A permit cannot be approved within 10 c	N Case # (if applicable) on (RDCC) waiver? Y N days of approval of a variance from BOA.)
Description of Work	
Is Total New/Added Building Area > 5,000 Sq Ft? Y N	(If yes, construction material recycling is required per LDC 25-11-39)
Existing Use: vacant single-family residential duplex	residential two-family residential other:
Proposed Use: vacant (single-family residential) duplex	residential two-family residential other:
Project Type: new construction addition	addition/remodel other:
Will all or part of an existing exterior wall, structure, or roof be remove (Note: Removal of all or part of a structure requires a demolition permit application.)	ed as part of the project? Y N
# existing bedrooms: 2 # bedrooms upon completion: 3	0 1/2
Project Description: (Note: Please provide thorough description of project. Attach a Addition & Alterations to existing Ones	additional pages as necessary.) Story tesidence
Trades Permits Required (Circle as applicable): electric plun	mbing mechanical (HVAQ) concrete (R.O.W.)

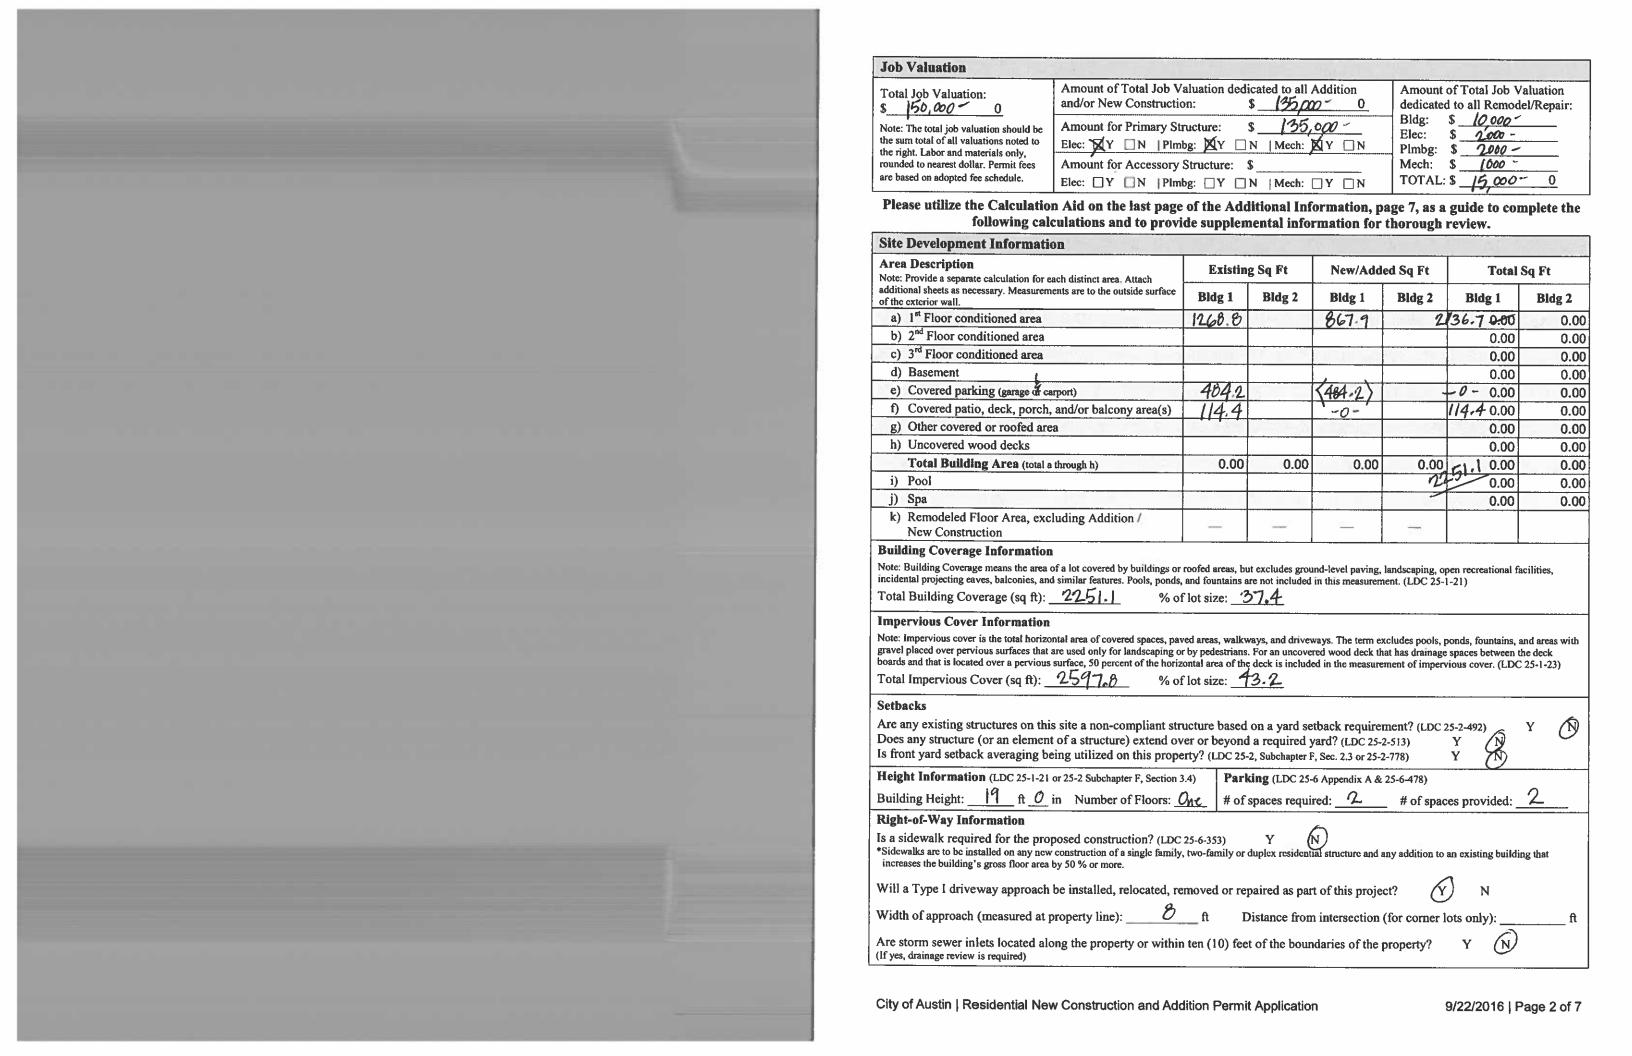



Su	be	hai	pter	F

Gross Floor Area

This section is only required for projects located within the Residential Design and Compatibility Standards Ordinance Boundaries as defined and illustrated in Title 25-2 Subchapter F of the Land Development Code. The Gross Floor Area of each floor is measured as the area contained within the outside edge of the exterior walls.

		Existing Sq Ft	New/Added Sq Ft	Proposed Exemption (check article utilized)	Applied Exemption Sq Ft	Total Sq Ft	
1 st Floor		1268.8	867.9			2136.70	0.00
2 nd Floor							0.00
3 rd Floor						C	0.00
Area w/ ceil	ings > 15'			Must follow article 3.3.5		C	0.00
Ground Floo (check article		114.4		Full Porch sq ft (3.3.3 A) 200 sq ft (3.3.3 A 2)	(114.4)	(114.4)	0.00
Basement				Must follow article 3.3.3B, see note below		0	0.00
Attic			10 110	Must follow article 3.3.3C, see note below		C	0.00
Garage**: (check article utilized)	Attached			□ 200 sq ft (3.3.2 B 1)		C	0.00
	Detached	320.0	(320.0)	☐ 450 sq ft (3.3.2 A 1 / 2a) ☐ 200 sq ft (3.3.2 B 2a / 2b)		-0-0	0.00
Carport**: (check article utilized)	Attached			☐ 450 sq ft (3.3.2 A 3) ☐ 200 sq ft (3.3.2 B 1)***		o	0.00
	Detached	162.6	(162.6)	☐ 450 sq ft (3.3.2 A 1)		-0- c	0.00
Accessory B (detached)	uilding(s)					C	0.00
Totals		0.00	0.00			2022.30	0.00

TOTAL GROSS FLOOR AREA (add Total Sq Ft column) 0.00

(Total Gross Floor Area ÷ Lot Area) x 100 = 35.5 Floor-To-Area Ratio (FAR)

Is a sidewall articulation required for this project?

Y (N)

(Yes, if: a wall, 15' tall or higher, within 9 feet of a side property line extends further than 36 feet in length per article 2.7.1)

Does any portion of the structure extend beyond a setback plane/exemption exhibit (aka "tent")? (If Yes, indicate applicable section of Subchapter F and length of protrusion on the drawings.)



*Ground Floor Porch exemption: A ground floor porch, including a screened porch, may be exempted, provided that the porch is not accessible by automobile and is not connected to a driveway; and the exemption may not exceed 200 square feet if a porch has habitable space or a balcony above it.


**Garage and carport exemptions (in relation to primary structure): Exemptions must follow the code as outlined in Title 25-2 Subchapter F 3.3.2. Each amount listed (450 or 200) is the maximum exclusion allowed per the article designated. Note: Article 3.3.2 C, "An applicant may receive only one 450-square foot exemption per site under paragraph A. An applicant who receives a 450-square foot exemption may receive an additional 200-foot exemption for the same site under paragraph B, but only for an attached parking area used to meet minimum parking requirements."

***Ordinance article 3.3.2 B 1 is the only 200 sq ft exemption that may be combined with a 450 sq ft exemption. Otherwise only one 450 exemption or one 200 sq ft exemption may be taken.

Basement exemption: A habitable portion of a building that is below grade may be exempted if the habitable portion does not extend beyond the first-story footprint and is below natural or finished grade, whichever is lower; and it is surrounded by natural grade for at least 50% of its perimeter wall area and the finished floor of the first story is not more than three feet above the average elevation at the intersections of the minimum front yard setback line and the side property lines.

Habitable Attic exemption: A habitable portion of an attic may be exempted if: 1) The roof above it is not a flat or mansard roof and has a slope of 3 to 12 or greater;

2) It is fully contained within the roof structure; 3) It has only one floor; 4) It does not extend beyond the footprint of the floors below; 5) It is the highest habitable portion of the building, or a section of the building, and adds no additional mass to the structure; and 6) Fifty percent or more of the area has a ceiling height of seven feet or less.

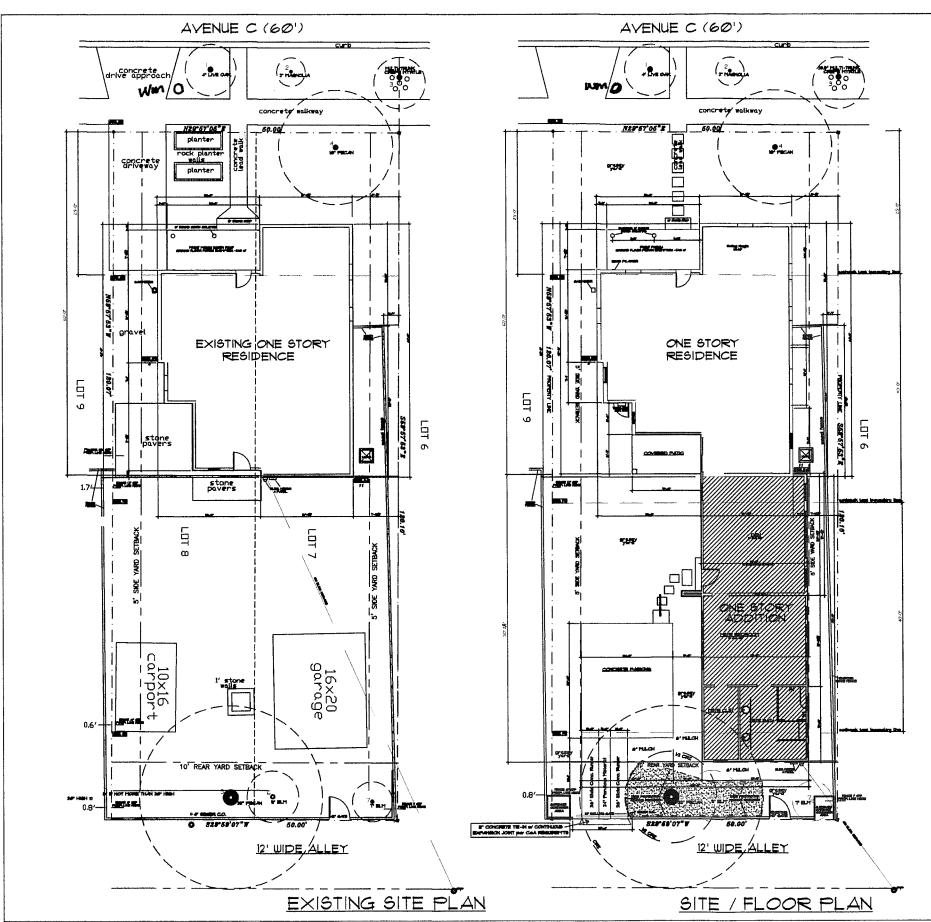

SHEET LEGEND

A-I - SITE PLANS & PROJECT DATA

A-2 - SITE PLAN - 1/8" SCALE

A-3 - EXISTING FLOOR PLAN

A-4 - NEW FLOOR PLAN

A-5 - EXISTING EXTERIOR ELEVATIONS

A-6 - NEW EXTERIOR ELEVATIONS - SECTION

A-7 - NEW EXTERIOR ELEVATIONS

A-8 - ROOF PLANS

A-9 - WINDOW & DOOR SCHEDULE

A-10 - CABINET # WALL ELEVATIONS

A-11 - ELECTRICAL LAYOUT

ZONING DATA

ZONING SF-3 - NP LOT AREA 40% MAX. BLDG AREA 6020.0 sf 2408.0 sf 45% MAX. IMPER.COVER 2709.0 sf 40% FAR - MAX. 2408.0 sf

AREA DESCRIPTION	EXISTING 5q.Ft.	NEW Sq.Ft.	TOTAL 5q.Ft
1st FLOOR CONDITIONED AREA	1268.8	867.9	2136.7
OUTDOOR KITCHEN AREA	(82.0)	82.0	0.0
COVERED PARKING (Detached Carport)	162.6	(162.6)	0
EXISTING GARAGE	322.1	(322.1)	0
COVERED PORCH (Front) Exemption	114.4	(114.4)	0
			

TOTAL BUILDING COVERAGE

TOTAL BUILDING COV	ÉRAGE		2136.7 sf	•
DRIVEWAY & CONCRETE RUNNERS CONCRETE PARRING SLAB BIDEWALKS (Front Stepping Blocks) INCOVERED PATIO (Stone Pavers) CONCRETE STEPPING BLOCKS AIR CONDITIONER PADS BTONE RETAINING WALLS	(223.2) - 64.7 (235.8) - 6.3 (24.4)	71.5 320.0 (27.0) - 17.7 9.0	(151.7) 320.0 37.7 (235.8) 17.7 15.3 (24.4)	_
TOTAL NON-BUILDING COVERAGE TOTAL SITE IMPERVIOUS COV	(4 2.4) VERAGE	391.2	(21.2) 2115.5 sf	-

LEGAL DESCRIPTION LOTS 7 AND 8, BLOCK I 3, HYDE PARK ADDITION,
A SUBDIVISION IN TRAVIS COUNTY, TEXAS, ACCORDING
TO THE MAP OR PLAT THEREOF RECORDED IN VOLUME I
PAGE 67 OF THE PLAT RECORDS OF TRAVIS COUNTY, TEXAS.
LOCATED AT 4307 AVENUE C.

TREE PROTECTION REQUIREMENTS

MIN. 5' HIGH CHAIN-LINK FENCING IN SHADED AREA. 6" LAYER OF MULCH TO BE MAINTAINED DURING CONSTRUCTION IN CRZ AREA AS POSSIBLE.
A MINUMUM 50% OF CRZ TO REMAIN AT NATURAL GRADE.

STRAP 8' 2x4's AROUND FACE OF ENTIRE TRUNK

	TREE LEGI	ÊND -	
	LOCATION	TYPE	DIAMETER
	0	LIVE OAK	4"
i	(<u>2</u>)	MAGNOLIA	2*
	3	CREPE MYRTLE	MULTIPLE
	. ⊕	PECAN	IC*
	(3)	PECAN	32*
	(G)	ELM	9*
	7	ELM	7*





2-21-18


Architect
((512) 406 - 6806
settin, Texas 78705


Shrum, David

2 οţ ere Residence erb 0 the σ 20 σ Additions \equiv \Box ₩ atrıck Alterations Ω_


> Sheet No. A-1

Of 11 Drawn by: DVS Date: 2-21-18 3-15-18

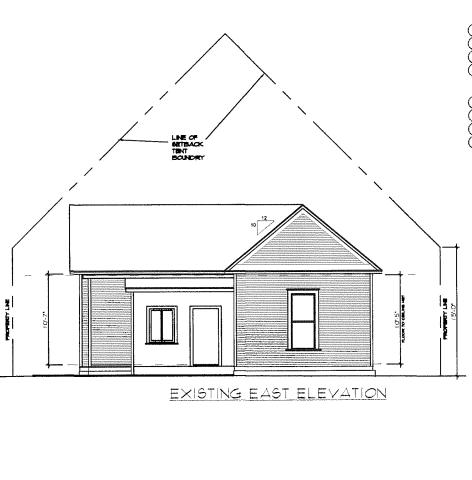

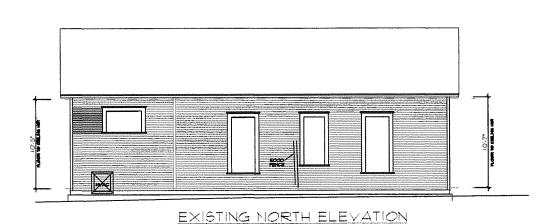

- 1 EXISTING COMPOSITION SHINGLE ROOF 2 SINGLE PLY EPDM MEMBRANE ROOF PER PLAN
- (3) COPPER 22x34 STAGGERED SIDING PANELS 4 - 3/4" THICK 3-part STUCCO METAL LATH \$
 VAPOR BARRIER DESIGNED FOR STUCCO
- w/ ELASTOMERIC COATING
- (5) 24 gauge COPING FLASHING
 (6) GALV. GUTTER & DOWNSPOUT PAINTED
 (7) 12" ROUND TAPERED COMPOSITION COLUMNS
- 8 6x6 TREATED WOOD COLUMNS W/ "SIMPSON" COMPOSITE STAND OFF BASES or Approved Equal
- 9 ROUND GALVANIZED METAL FLUE CHIMNEY
- (10)- 1x6 T#G CYPRESS SOFFIT
- (1) WOOD TRIM & CASING PAINTED
- (2)- NATURAL GAS TANKLESS WATER HEATER
- (3)- UNDER-PINNING TO MATCH EXISTING
- (14) EXISTING SIDING & CORNICE TO REMAIN
- (15)- 1/2" OSB SHEATHING
- (16)- FOUNDATION PER ENGINEER
- (7)- 1/2" INTERIOR GYPSUM BOARD
- (18) SPRAY APPLIED HI-DENSITY POLYURETHANE FOAM INSULATION TYPICAL

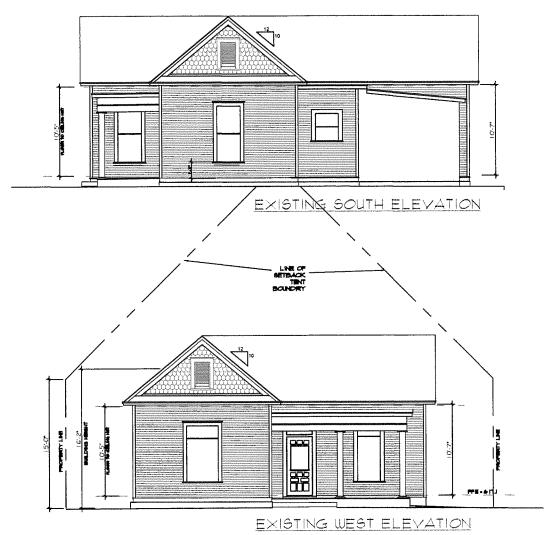

EXISTING EXTERIOR ELEVATIONS
3/32' • I' - Ø'




2-21-18

Architect
nont (512) 406 - 6808
Austin, Texas 78705 Shrum, David

5 oţ Ø Residence -agerbe 78751 the 5 σ \overline{e} Additions മ് ₩- \circ atrick Alterations

Sheet No. A-5 Of 11

Drawn by: DVS Date: 2-21-18

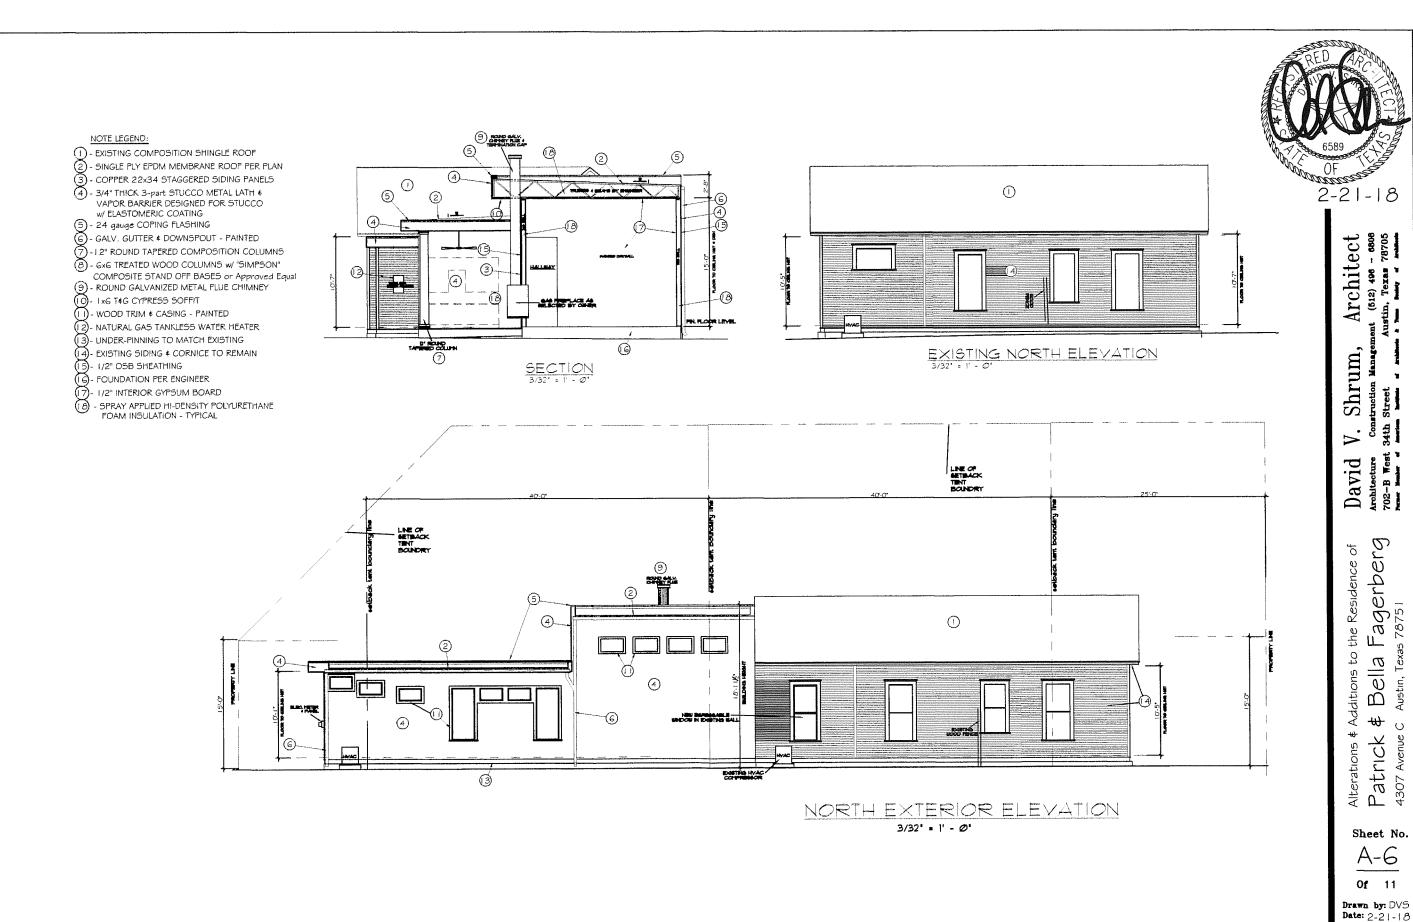

- EXISTING COMPOSITION SHINGLE ROOF
 - SINGLE PLY EPDM MEMBRANE ROOF PER PLAN
 - COPPER 22x34 STAGGERED SIDING PANELS
 - 3/4" THICK 3-part STUCCO METAL LATH & VAPOR BARRIER DESIGNED FOR STUCCO W/ ELASTOMERIC COATING

(5) - 24 gauge COPING FLASHING


6 - GALV. GUTTER & DOWNSPOUT - PAINTED
7 - I 2" ROUND TAPERED COMPOSITION COLUMNS
8 - 6x6 TREATED WOOD COLUMNS w/ "SIMPSON" COMPOSITE STAND OFF BASES or Approved Equal (9) - ROUND GALVANIZED METAL FLUE CHIMNEY


(1) - VOOD TRIM & CASING - PAINTED

(2)- NATURAL GAS TANKLESS WATER HEATER

(13) - UNDER-PINNING TO MATCH EXISTING

(14) - EXISTING SIDING & CORNICE TO REMAIN
(15) - 1/2" OSB SHEATHING
(16) - FOUNDATION PER ENGINEER
(17) - 1/2" INTERIOR GYPSUM BOARD
(18) - SPRAY APPLIED HI-DENSITY POLYURETHANE
FOAM INSULATION - TYPICAL

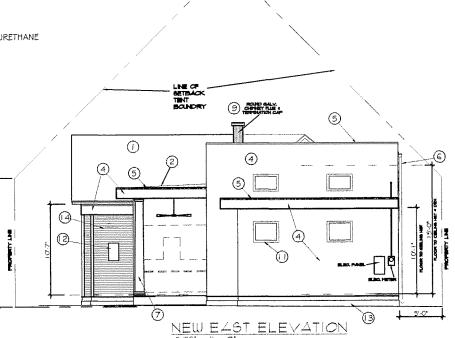

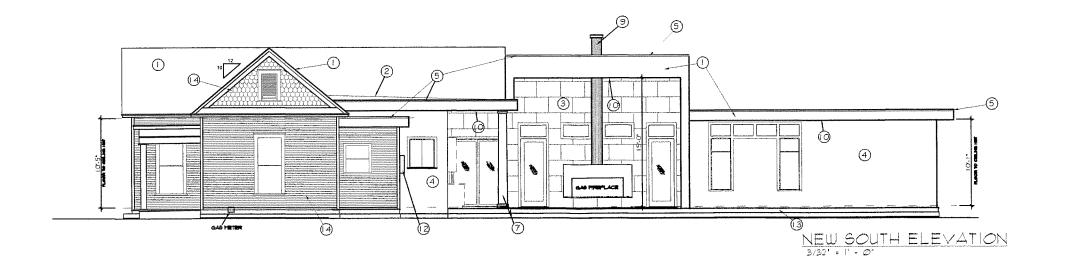




Architect
14 (512) 496 - 6806
11stin, Texas 78705 Shrum, David

erg of the Residence -agerbe ţ0 σ Additions \overline{e} $\tilde{\Omega}$ ₩ \circ Alterations # /
Patrick 8

> Sheet No. A-7 Of 11

Drawn by: DVS Date: 2-21-18

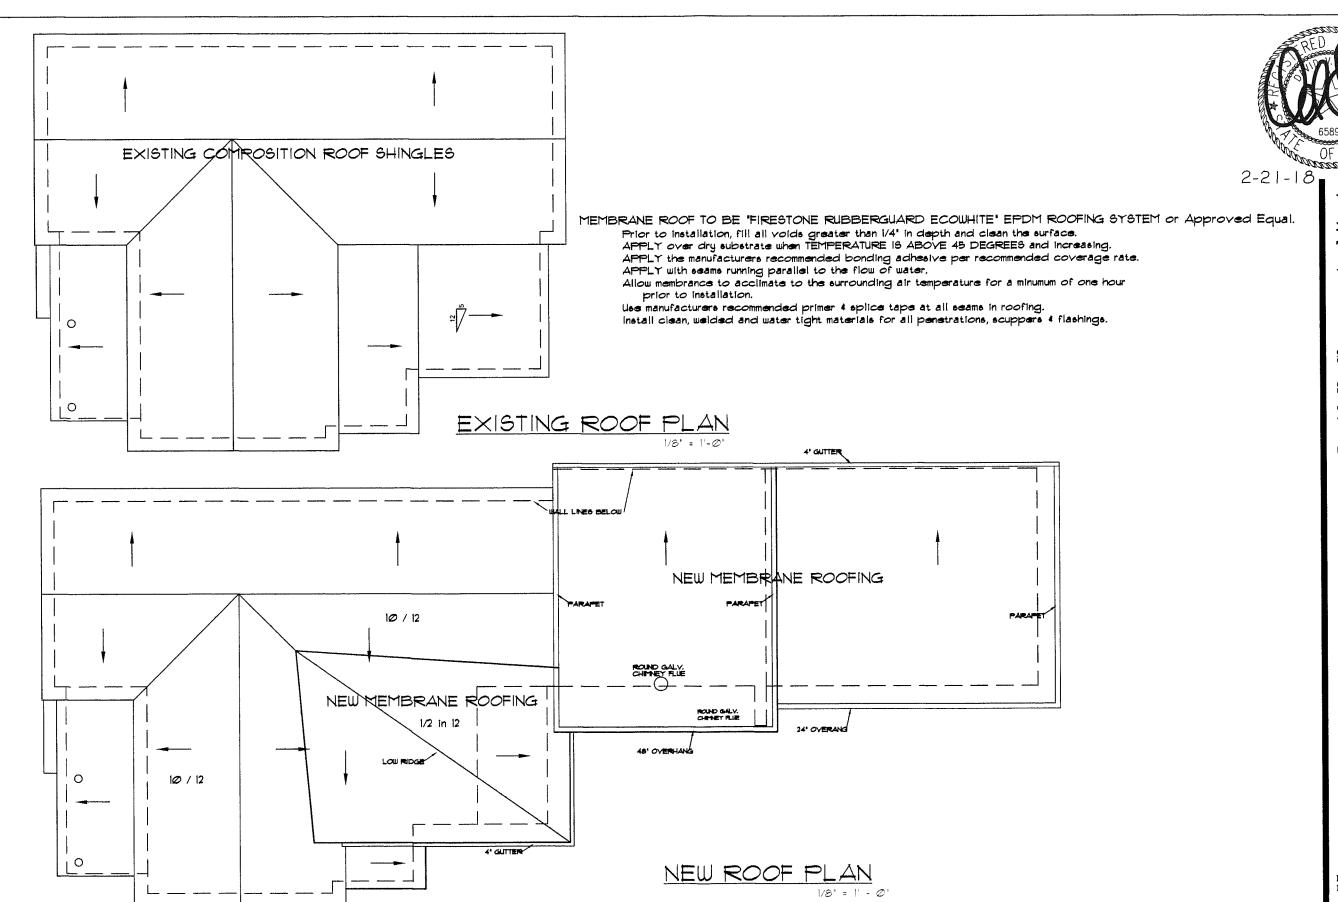


David V. Shrum, Architect
Architecture Construction Management (512) 496 - 6608
702-B West 34th Street Austin, Texas 78705

Alterations & Additions to the Residence of Patrick & Bella Fagerberg 4307 Avenue C Austin, Texas 78751

Sheet No. $\frac{A-8}{0f}$

Drawn by: DV5
Date: 2-21-18

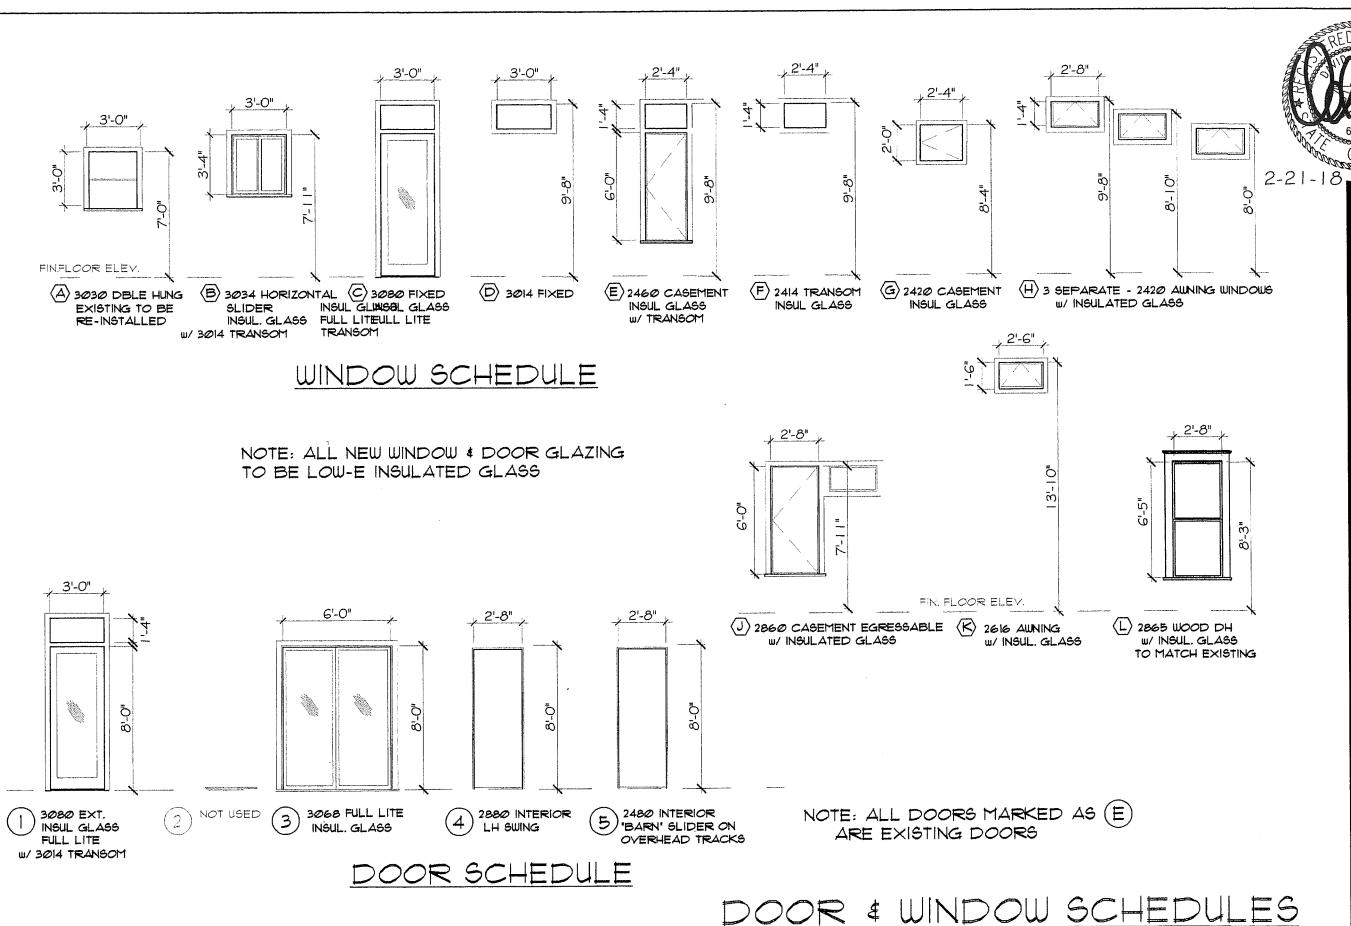

Architect
nent (512) 406 - 6806
Austin, Texas 78705 Shrum, David

34th

la Fagerberg Texas 78751 Additions to the Residence of Bella ₩ Patrick 4307 Avenue (Alterations \$

Sheet No. A-9

Drawn by: DVS Date: 2-21-18

3/16" = 1'-0"

Of 11