hugh jefferson randolph
architects

03.07.18 Issue:

Revision:

**A2.1** 

**PLANS** 

1 OF 2

**CANOPY FLOOR** 

## **ENTRY LEVEL PLAN LEGEND:** HARDWIRED SMOKE DETECTOR & CARBON MONOXIDE DETECTOR

W/ BATTERY BACKUP EXISTING WALL TO REMAIN **NEW WALL** 

NEW GLASS WALL OVERHEAD FEATURE / ROOF


## **PLAN NOTES:**

- PERFORM ALL WORK IN ACCORDANCE WITH CITY OF AUSTIN CODES AND ORDINANCES
- DO NOT SCALE DRAWING, CONTACT ARCHITECT UPON DISCOVERY OF MISSING INFORMATION OR CONFLICTS IN DRAWING
- ALL DIMENSIONS ARE TAKEN FROM FRAMING FOR NEW WALLS AND FROM FINISHED FACE OF EXISTING WALLS UNLESS NOTED
- CONTACT ARCHITECT/ OWNER WITH ANY FRAMING QUESTIONS/ DISCREPANCIES
- MINIMUM R-15 INSULATION IN WALLS
- 6. FIELD VERIFY ALL DIMENSIONS PRIOR TO CONSTRUCTION
- . USE 1/2" GYP. BOARD FOR ALL WALLS AND CEILINGS EXCEPT IN THE FOLLOWING LOCATIONS:USE 1/2" WATER RESISTANT GYP. BD. IN BATHROOM AND KITCHEN ON ALL WALLS EXCEPT BEHIND CERAMIC TILE AND BATHTUB WHERE TILE BACKER BOARD IS USED
- DISTANCE BETWEEN HINGE SIDE OF DOOR AND ADJACENT WALL IS 6" UNLESS NOTED OTHERWISE
- 9. CONTRACTOR TO INSTALL BLOCKING IN WALLS AND CEILINGS AS REQUIRED FOR ALL ACCESSORIES, WALL MOUNTED ITEMS, CEILING FAN, ETC. INCLUDING 2X6 BLOCKING INSIDE ALL BATHROOM WALLS AT 36" ABOVE FINISHED FLOOR


PLAN NORTH



(4) CANOPY VIEW - FOR REFERENCE ONLY

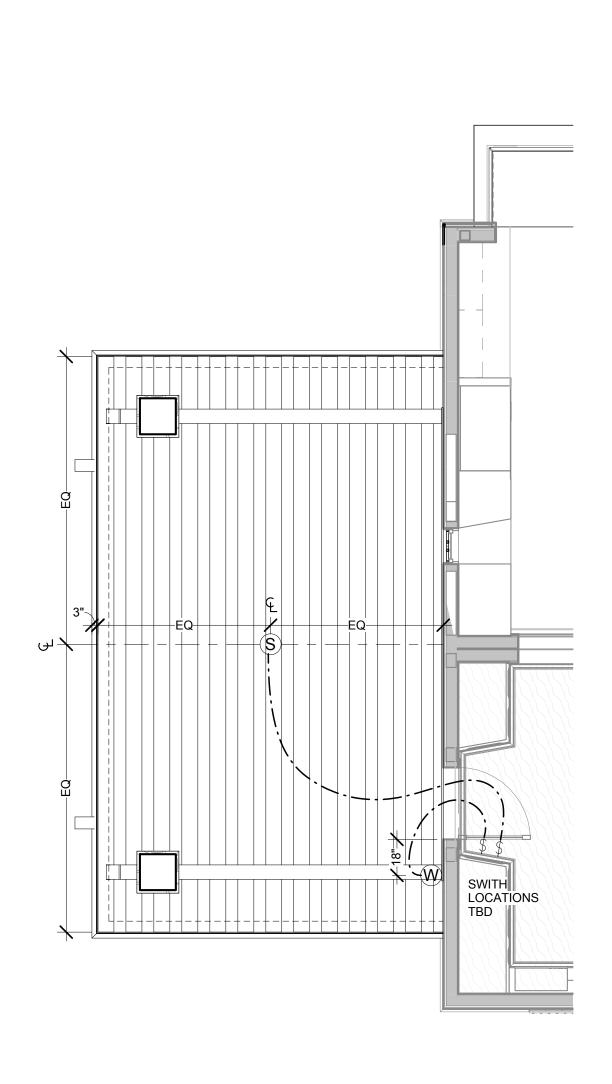

+/- 3/8":12" SLOPE L\_\_\_\_\_ 2 CANOPY ROOF PLAN 1/4" = 1'-0"

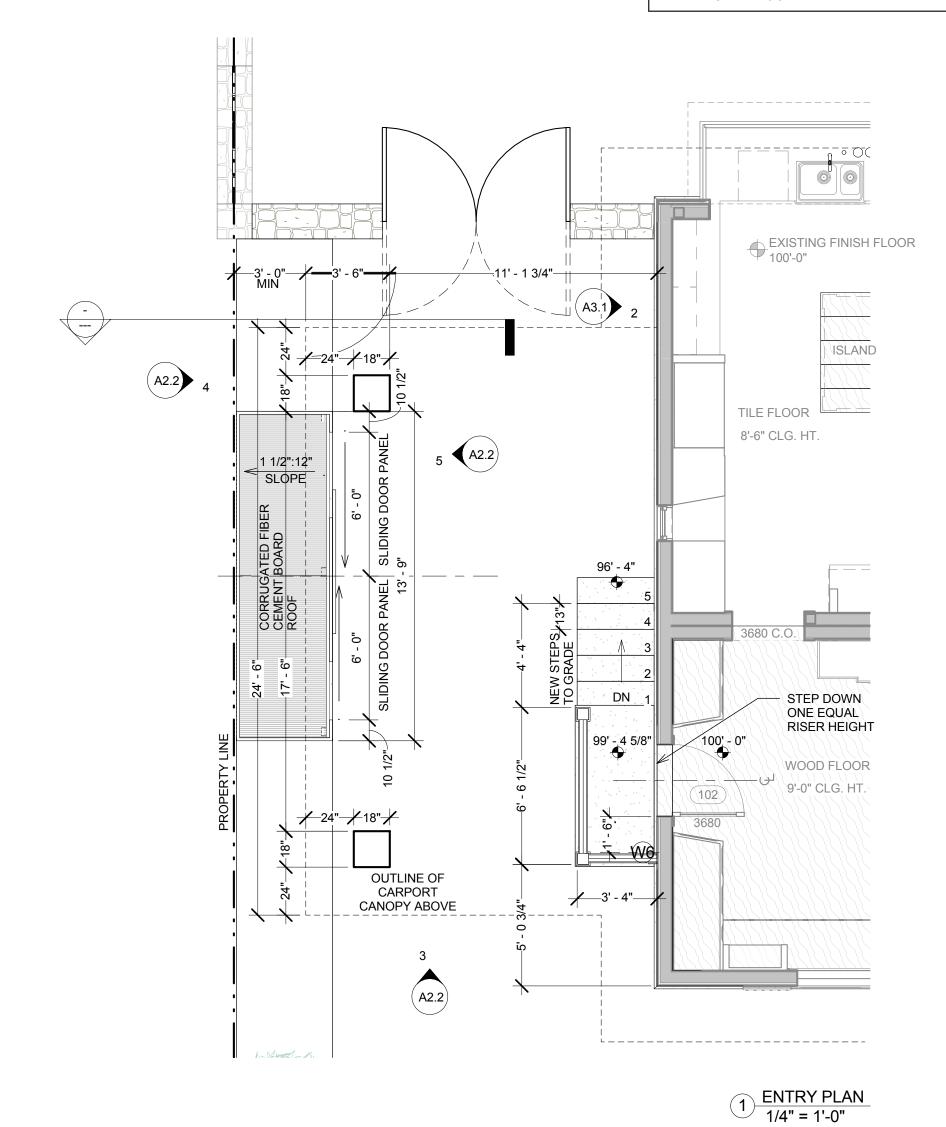



3 CANOPY LIGHTING PLAN 1/4" = 1'-0"

ROOF ISOMETRIC VIEWS FOR

REFERENCE ONLY

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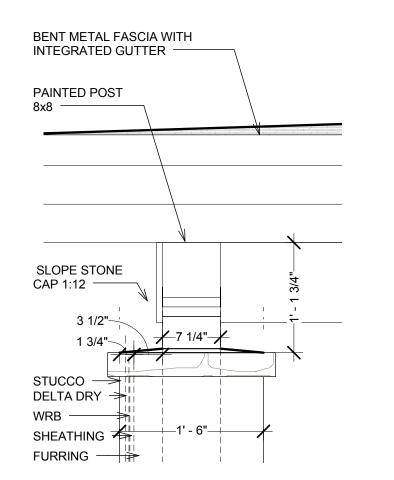


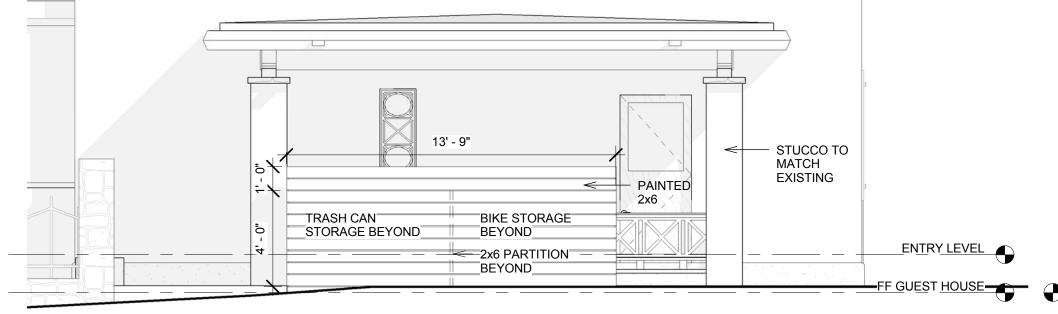

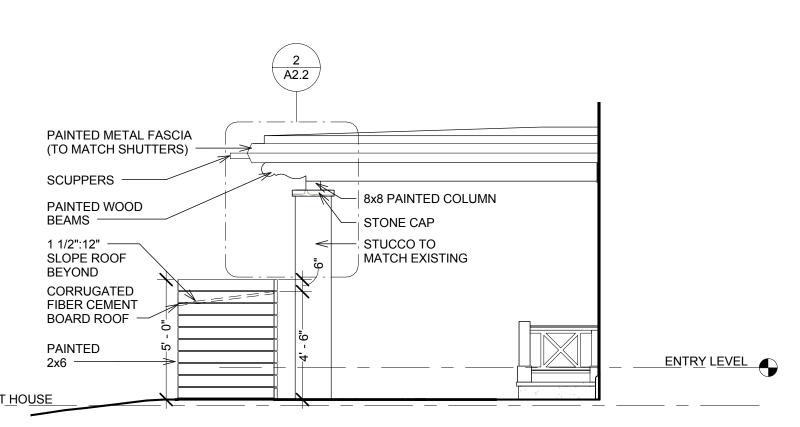



Drawn by BL, TJR
Checked by BL


4 BIKE SHED - WEST 1/4" = 1'-0"



9 COLUMN TOP DETAIL 1" = 1'-0"

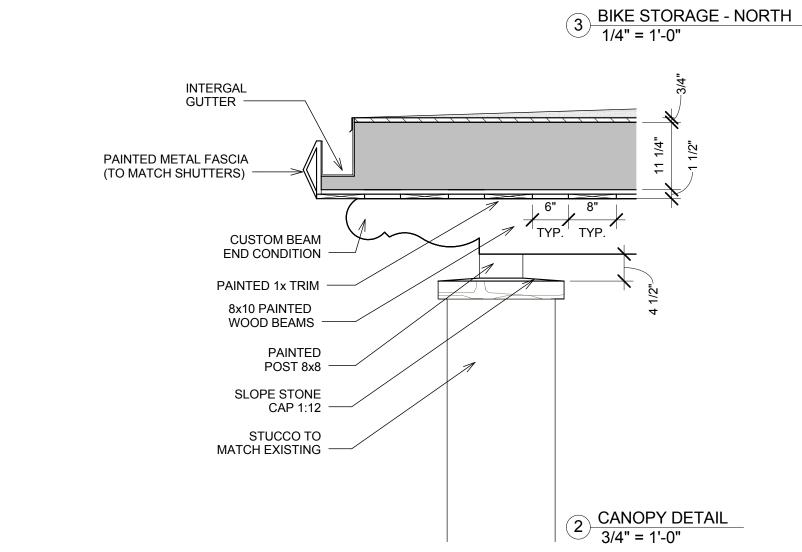

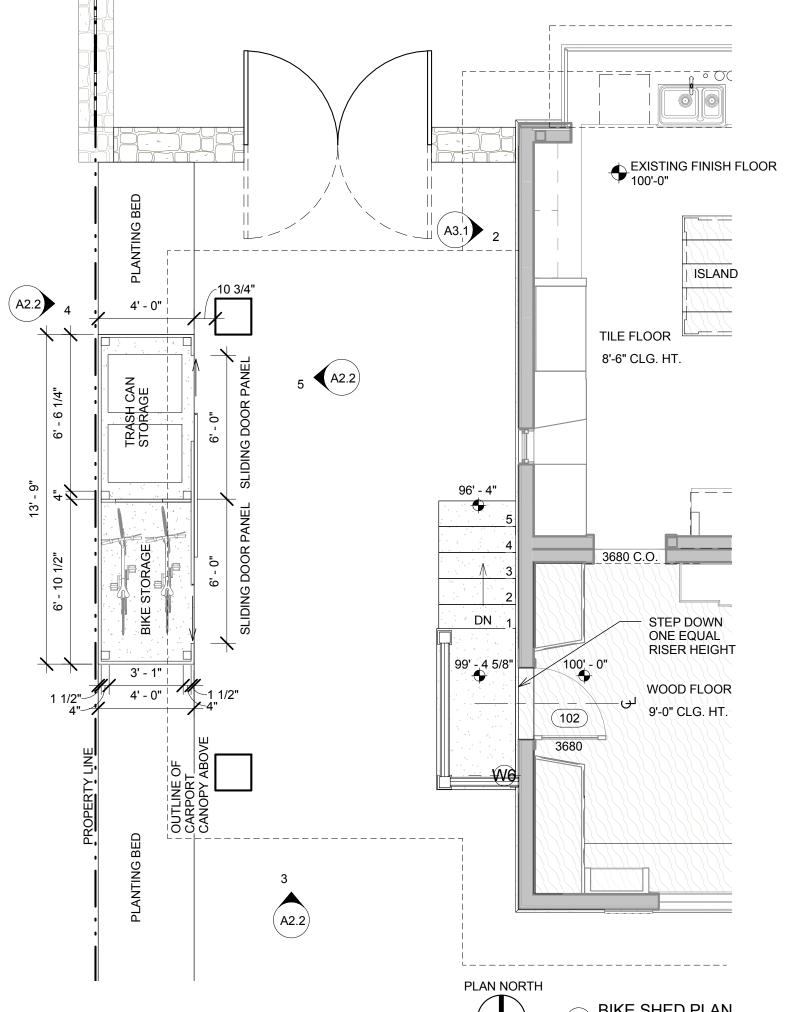

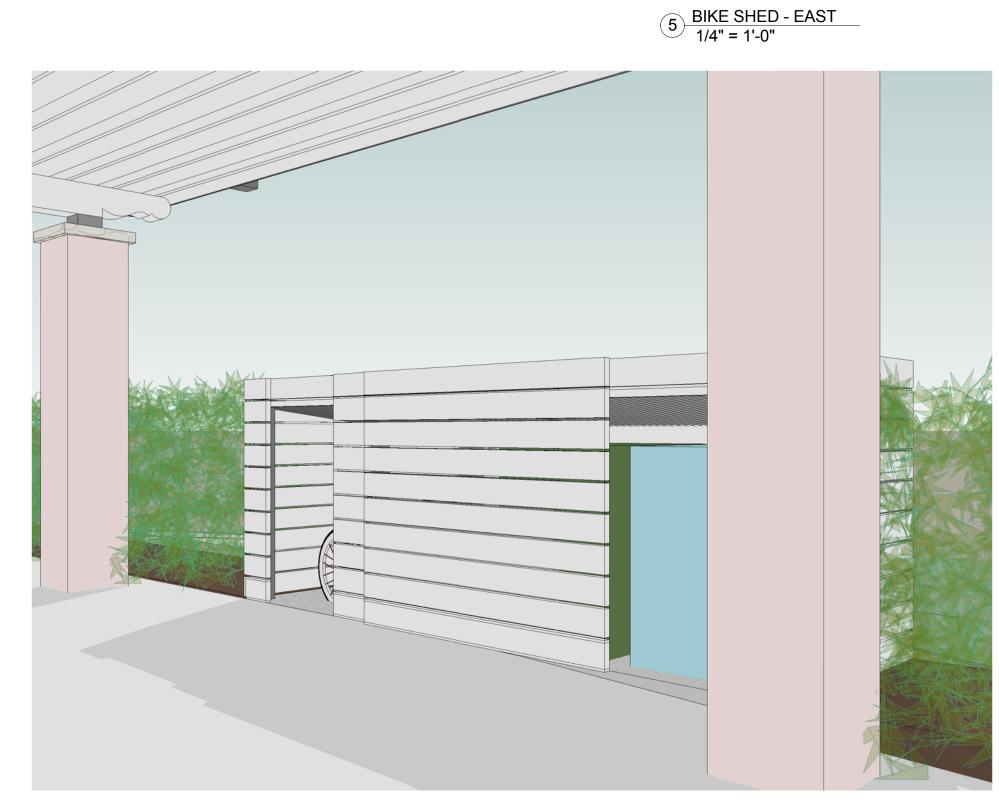


8 3D VIEW FOR REFERENCE ONLY



7 3D VIEW FOR REFERENCE ONLY



6 3D VIEW FOR REFERENCE ONLY

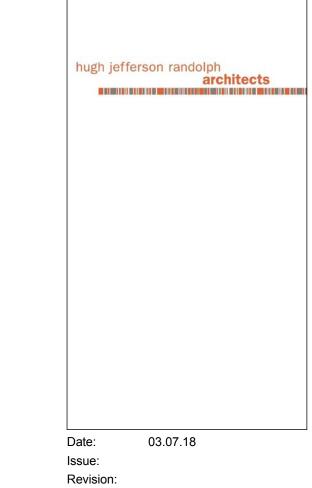

A2.2

CANOPY
ELEVATIONS AND
SECTIONS

2 OF 2