CAUTION: DO NOT SCALE DRAWINGS THESE DRAWINGS ARE THE PROPERTY OF IN CONJUNCTION WITH THIS PROJECT

AUSTIN, TX 78702

HISTORIC LANDMARK COMMISSION | NOVEMBER 21, 2018

PROJECT LOCATION | PROXIMITY MAP



PROJECT DATA


LOT SIZE: 9051.75 S.F.

TOTAL AIR CONDITIONED AREA:

HOUSE SQUARE FOOTAGE: SECOND FLOOR 1802 S.F THIRD FLOOR 257 S.F.

COVERED PATIO

ARCHITECTURAL SYMBOLS

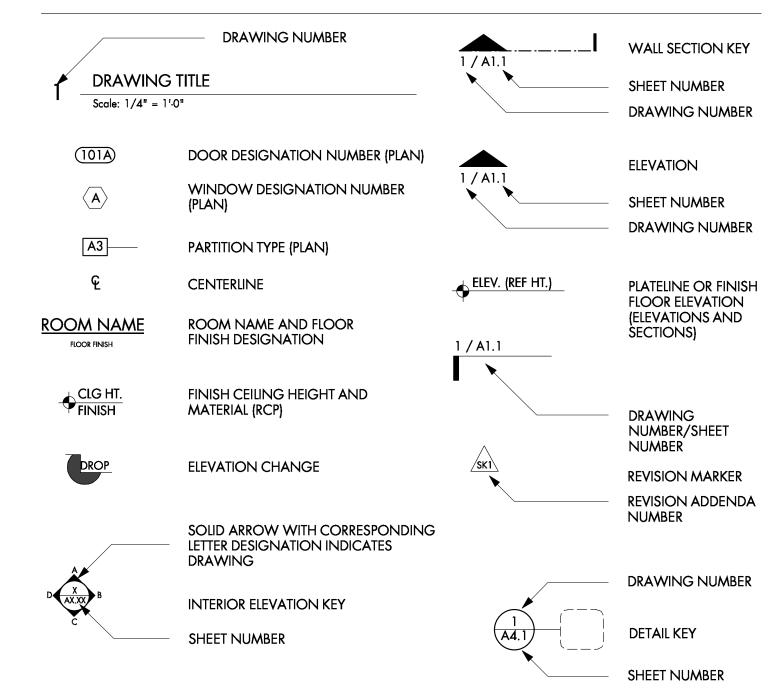

PRELIMINARY PROJECT PRICING SPEC

EXTERIOR MATERIALS **COORDINATE ALL ALTERNATES WITH ARCHITECT** WOOD SIDING: 6" PTD. HARDIE BOARD LAP SIDING,

MAIN ENTRY DOOR: EXISTING

EXT. DOORS: PAINTED WOOD W/ MULTIPLE LIGHTS. VERIFY W/ OWNER

DECKS: EXTERIOR GRADE WOOD DECKING, IPE OR SIMILAR. AWNING FASCIA: PTD. WOOD

AWNING SOFFIT: PTD. WOOD, EXPOSED PTD. RAFTER TAILS

ROOF: SHINGLE

GUTTERS: 4" - 1/2 ROUND PRE-FINISHED MTL. GUTTERS (as req'd)

COLUMNS: TREATED WOOD, PTD.

INTERIOR FINISHES

FLOOR: WOOD MATCH EXISTING FLOOR; EXTERIOR GRADE DECKING @ OUTDOOR DECKS

MASTER BATH FLOOR: \TLE, VERIFY W/ OWNER

MASTER BATH WALL THE! TILE, VERIFY W/ OWNER

GYP BOARD WALLS & CEILING: LEVEL 5 FINISH

BASE BOARD: 1" x 4" TYP. PTD. WOOD.

CASING: 1" x 4" TYP. PTD. WOOD & 1" x 2" PTD. WOOD. TYPICAL INTERIOR DOORS: PAINT GRADE STYLE AND RAIL W/FLUSH PANEL

TYPICAL CABINETS: CUSTOM PAINT GRADE. DOOR FRONTS TO BE SHAKER STYLE W/EUROPEAN HINGES, OWNER TO MAKE FINAL

TYPICAL KITCHEN COUNTERS: SILESTONE OR SIMILAR

TYPICAL BATH COUNTERS: STONE SLAB

KITCHEN WALL TILE: \$30/SF ALLOWANCE

BATH WALL TILE: TBD

DECORATIVE LIGHTS: TBD

PLUMBING FIXTURES: TBD

KITCHEN APPLIANCES: VERIFY WITH CLIENT

AIR REGISTERS: MATCH EXISTING

ALL SHOWERS SHOULD HAVE A LINEAR DRAIN & NO CURB

GENERAL NOTES

- 1. CONTRACTOR TO COORDINATE STAGING AREAS
- 2. ALL PROPOSALS SHALL TAKE INTO CONSIDERATION ALL SITE CONDITIONS AFFECTING WORK UNDER THIS CONTRACT
- RE-USED, REPRODUCED, OR ALTERED WITHOUT THE EXPRESS WRITTEN PERMISSION OF THE ARCHITECT. FAILURE TO OBTAIN PERMISSION VIOLATES UNITED STATES
- 5. THE CONTRACTOR SHALL BE RESPONSIBLE FOR CONSTRUCTING THE PROJECT IN ACCORDANCE WITH ALL PROVISIONS OF APPLICABLE CODES AND
- THE PLANS AND SPECIFICATIONS HAVE BEEN DEVELOPED WITH THE INTENT OF MEETING OF EXCEEDING THE MINIMUM REQUIRED STANDARDS. SHOULD THE plans and specifications disagree with themselves , the greater quality or greater quantity shall be performed or furnished
- THE FACT THAT SOMETHING WAS NOT INDICATED ON YOUR PORTION OF THE DRAWINGS WILL NOT BE ACCEPTABLE AS A REASON FOR AN EXTRA, IF IT CAN BE FOUND ELSEWHERE IN THE DRAWINGS OR SPECIFICATIONS.
- THE CONTRACTOR MUST VERIFY ALL EXISTING CONDITIONS, ITEMS AND NOTIFY THE ARCHITECT OF ANY DISCREPANCIES

HAVING JURISDICTION THEREOF. PAY ALL COSTS FOR TEMPORARY ELECTRICAL POWER, WATER AND HEATING

9. EACH PRIME CONTRACTOR SHALL REPLACE AND/OR RESTORE ALL MATERIALS STORED OR INSTALLED ON THE SITE SHALL BE SUBJECT TO DAMAGE OR THEFT.

10. PROVIDE AND PAY FOR ALL COST FOR TEMPORARY FACILITIES AND SERVICES REQUIRED FOR THE PROPER AND EXPEDITIOUS PROSECUTION OF THE CONTRACT WORK, INCLUDING JOB SITE TELEPHONE. MAKE ALL TEMPORARY CONNECTIONS TO EXISTING UTILITIES IN LOCATIONS ACCEPTABLE TO LOCAL AUTHORITIES

12. A COMPLETE SET OF AS-BUILTS SHALL BE FURNISHED TO THE ARCHITECT AT COMPLETION OF THE PROJECT. THE CLOSE OUT PACKAGE IN A FORM OF A HARD BINDER, INDEXED, LABELED AND DIVIDERS FOR THE CLIENT INCLUDES COPIES OF PERMITS AND THE CERTIFICATE OF OCCUPANCY, A LIST OF SUB-CONTRACTOR AND PHONE NUMBERS, ALL WARRANTIES AND MANUALS, ETC. LIST OF PAINT TYPES AND FORMULAS. ONE COPY SHOULD GO DIRECTLY TO THE OWNER.

- 13. GENERAL CONTRACTOR AND SUB-CONTRACTOR ARE TO BID THIS PROJECT AS DESIGNED. VALUE ENGINEERING IS WELCOMED IN AN EFFORT TO GET THE BEST VALUE. GENERAL CONTRACTOR SHALL SUBMIT HIS BID PER PLANS AND SPECIFICATIONS AND SUBMIT VALUE ENGINEERING ITEMS SEPARATELY.
- 15. CONSTRUCTION DRAWINGS AND DOCUMENTS ARE GENERAL IN NATURE AND DO NOT INCLUDE OR ANTICIPATE EVERY CONDITION POSSIBLE. CONDITIONS . ANY INCONSISTENCY , DISCREPANCY , AMBIGUITY , OR ANY OTHER QUESTIONS SHALL BE IMMEDIATELY REPORTED TO THE ARCHITECT AND/OR OWNER FOR CLARIFICATION AND RESOLUTION PRIOR TO THE DELIVERY OF ANY BID AND PRIOR TO PROCEEDING WITH THE WORK IN QUESTION AND/OR OTHER RELATED WORK. FAILURE TO DO SO SHALL CAUSE THE CONTRACTOR TO BE INELIGIBLE FOR EXTRAS RELATING TO SUCH MATTERS AND SHALL RELIEVE THE ARCHITECT FROM ANY CONSEQUENCES THEREBY ARISING.
- 16. CONTRACTOR IS RESPONSIBLE FOR ALL FEES AND PERMITS REQUIRED FOR CONSTRUCTION.
- 17. ALL DESIGN OF STRUCTURAL COMPONENTS INCLUDING THE FOUNDATION, BEAMS, POSTS, STRUCTURAL FRAMING, CONNECTORS, AND FASTENERS ARE NOT IN THE ARCHITECT'S SCOPE AND MUST BE PROVIDED BY OTHERS PRIOR TO CONSTRUCTION .
- 18. THE CONTRACTOR SHALL PROVIDE ALL LABOR, MATERIALS, EQUIPMENT AND SERVICES NECESSARY TO COMPLETE THE WORK, ALL OF WHICH SHALL BE PROVIDED IN FULL ACCORDANCE WITH AND REASONABLY INFERABLE FROM THE CONTRACT DOCUMENTS AS BEING NECESSARY TO PRODUCE THE INDICATED
- 19. DRAWINGS AND NOTES TO DRAWINGS, INCLUDING THOSE OF THE ENGINEER OR CONSULTANT, ARE CORRELATIVE AND HAVE EQUAL AUTHORITY AND PRIORITY . SHOULD THERE BE DISCREPANCIES IN THEMSELVES OR BETWEEN THEM, CONTRACTOR SHALL BASE BID PRICING ON THE MOST EXPENSIVE COMBINATION OF QUALITY AND/OR QUANTITY OF THE WORK INDICATED. IN THE EVENT OF DISCREPANCIES, THE APPROPRIATE INTENT AND/OR ITEMS TO BE INCORPORATED INTO THE SCOPE OF THE WORK SHALL BE DETERMINED BY THE ARCHITECT OR ENGINEER.
- 20. WRITTEN DIMENSIONS SHALL GOVERN THESE DRAWINGS . THESE DRAWINGS ARE NOT TO BE SCALED .
- 21. CONTRACTOR IS SOLELY RESPONSIBLE FOR THE SAFETY, ACTIONS, AND CONDUCT OF HIS EMPLOYEES AND HIS SUBCONTRACTOR'S EMPLOYEES WHILE IN THE PROJECT AREA, ADJACENT AREAS AND IN THE BUILDING AND ITS VICINITY.
- 22. CONTRACTOR SHALL COORDINATE WITH ALL TRADES AND SUBCONTRACTORS TO PROVIDE COMPLETE WORKING SYSTEMS THROUGHOUT PROJECT.
- 23. CONTRACTOR TO SUBMIT ALL REQUIRED SHOP DRAWINGS TO ARCHITECT AND/OR OWNER BEFORE PROCEEDING WITH THE WORK RELATED TO THE SHOP
- 24. ALL WORK NOTED "BY OTHERS" OR "NOT IN CONTRACT" IS TO BE ACCOMPLISHED BY A CONTRACTOR OTHER THAN THE GENERAL CONTRACTOR AND IS NOT TO BE A PART OF THE CONSTRUCTION AGREEMENT. THE GENERAL CONTRACTOR IS TO COORDINATE WITH OTHER CONTRACTORS AS REQUIRED AND SHALL
- 25. PRIOR TO THE START OF CONSTRUCTION, CONTRACTOR SHALL FURNISH THE ARCHITECT AND/OR OWNER A SCHEDULE OF VALUES THAT INCLUDES A DETAILED LIST OF ENTIRE SCOPE OF WORK AND THE MATERIAL QUANTITIES INVOLVED IN THE PROJECT AND THEIR RESPECTIVE CONTRACT DOLLAR AMOUNTS, INCLUDING A SEPARATE COLUMN FOR SALES TAX.
- 26. CONTRACTOR SHALL FURNISH THE ARCHITECT AND/OR OWNER A PUNCH LIST INCLUDING ALL THE ITEMS TO BE COMPLETED PRIOR TO THE PROJECT'S SUBSTANTIAL COMPLETION. ARCHITECT AND/OR OWNER SHALL REVIEW CONTRACTOR'S PUNCH LIST AND PROVIDE ADDITIONAL ITEMS TO BE INCLUDED IN THE
- 27. ALL MATERIALS, FINISHES, MANUFACTURED ITEMS, AND EQUIPMENT SHALL BE INSTALLED IN FULL ACCORDANCE WITH THE SUPPLIER'S OR MANUFACTURER'S WRITTEN RECOMMENDATIONS OR CODE OR THESE DOCUMENTS, WHICHEVER IS MORE STRINGENT.
- 28. ALL DIMENSIONS, NOTES, FINISHES, AND FIXTURES SHOWN ON TYPICAL DRAWINGS SHALL APPLY TO ALL SIMILAR, SYMMETRICAL, OR OPPOSITE HAND
- 29. STORE AND HANDLE ALL MATERIALS IN STRICT COMPLIANCE WITH MANUFACTURER'S INSTRUCTIONS AND RECOMMENDATIONS. PROTECT ALL MATERIALS FROM DAMAGE, WEATHER, EXCESSIVE TEMPERATURES, AND CONSTRUCTION OPERATIONS.
- 30. REQUESTS TO SUBSTITUTE ANY PRODUCT OR MATERIAL SHALL BE SUBMITTED IN WRITING TO THE ARCHITECT AND/OR OWNER FOR APPROVAL. SAMPLES, PRODUCT INFORMATION , AND DRAWINGS SHALL BE REQUIRED PRIOR TO SUBSTITUTION APPROVAL. PROPOSED SUBSTITUTION SHALL BE OF EQUAL QUALITY AND PERFORMANCE SPECIFICATION TO THAT ORIGINALLY SPECIFIED.
- 31. CONTRACTOR SHALL REVIEW ALLOWANCES AND NOTIFY THE ARCHITECT AND/OR OWNER OF AMOUNTS THAT SEEM INSUFFICIENT OR NOT ACCURATE. ALLOWANCE AMOUNTS INCLUDE ONLY THE COST OF MATERIAL, DELIVERY, AND SALES TAX.

32. ALL WORKMANSHIP, MATERIAL, AND EQUIPMENT SHALL BE GUARANTEED FOR THE GREATER OF THE MANUFACTURER'S WARRANTY OR ONE YEAR FROM

- DATE OF OWNER ACCEPTANCE . ANY FAILURE OR DETERIORATION WITHIN THIS PERIOD SHALL BE CORRECTED BY THE CONTRACTOR AT THE CONTRACTOR'S 33. CONTRACTOR SHALL EXERCISE REASONABLE PRECAUTION IN THE PROTECTION OF THE OWNER'S PROPERTY, SITE VEGETATION, AND ALL TREES THAT ARE TO
- 34. CONTRACTOR SHALL BE RESPONSIBLE ON A DAILY BASIS FOR SITE CLEAN UP AND REMOVAL OF ANY AND ALL DEBRIS GENERATED BY CONSTRUCTION OPERATIONS, MAKING READY FOR ALL SUBSEQUENT SUBCONTRACTORS
- 35. PROVIDE CONSTRUCTION WASTE MANAGEMENT INCLUDING THE SEPARATION OF REUSABLE OR RECYCLABLE MATERIALS INTO SEPARATE CONTAINERS

PROJECT DESCRIPTION

New construction of home in Smoot/Terrace Park Historic District.

ASSOCIATED PERMITS & DOCUMENTS

City of Austin SP-2017-0455C

PROJECT TEAM

CLIENT	ARCHITECT
701 HL AVENUE GP, LLC	DESIGNTRAIT
CONTACT: PATRICK O'SHAUGHNESSY	CONTACT: BECKY JEANES
805 WINFLO DR	2525 SOUTH LAMAR STE #9
AUSTIN, TX 78703	AUSTIN, TX 78704
PH: (512) 633-0968	PH: (512) 542-0073
E-MAIL: patrick@lonestardevelopmentpartners.com	E-MAIL: becky@designtrait.cor

DRAWING INDEX

ARCHITECURAL

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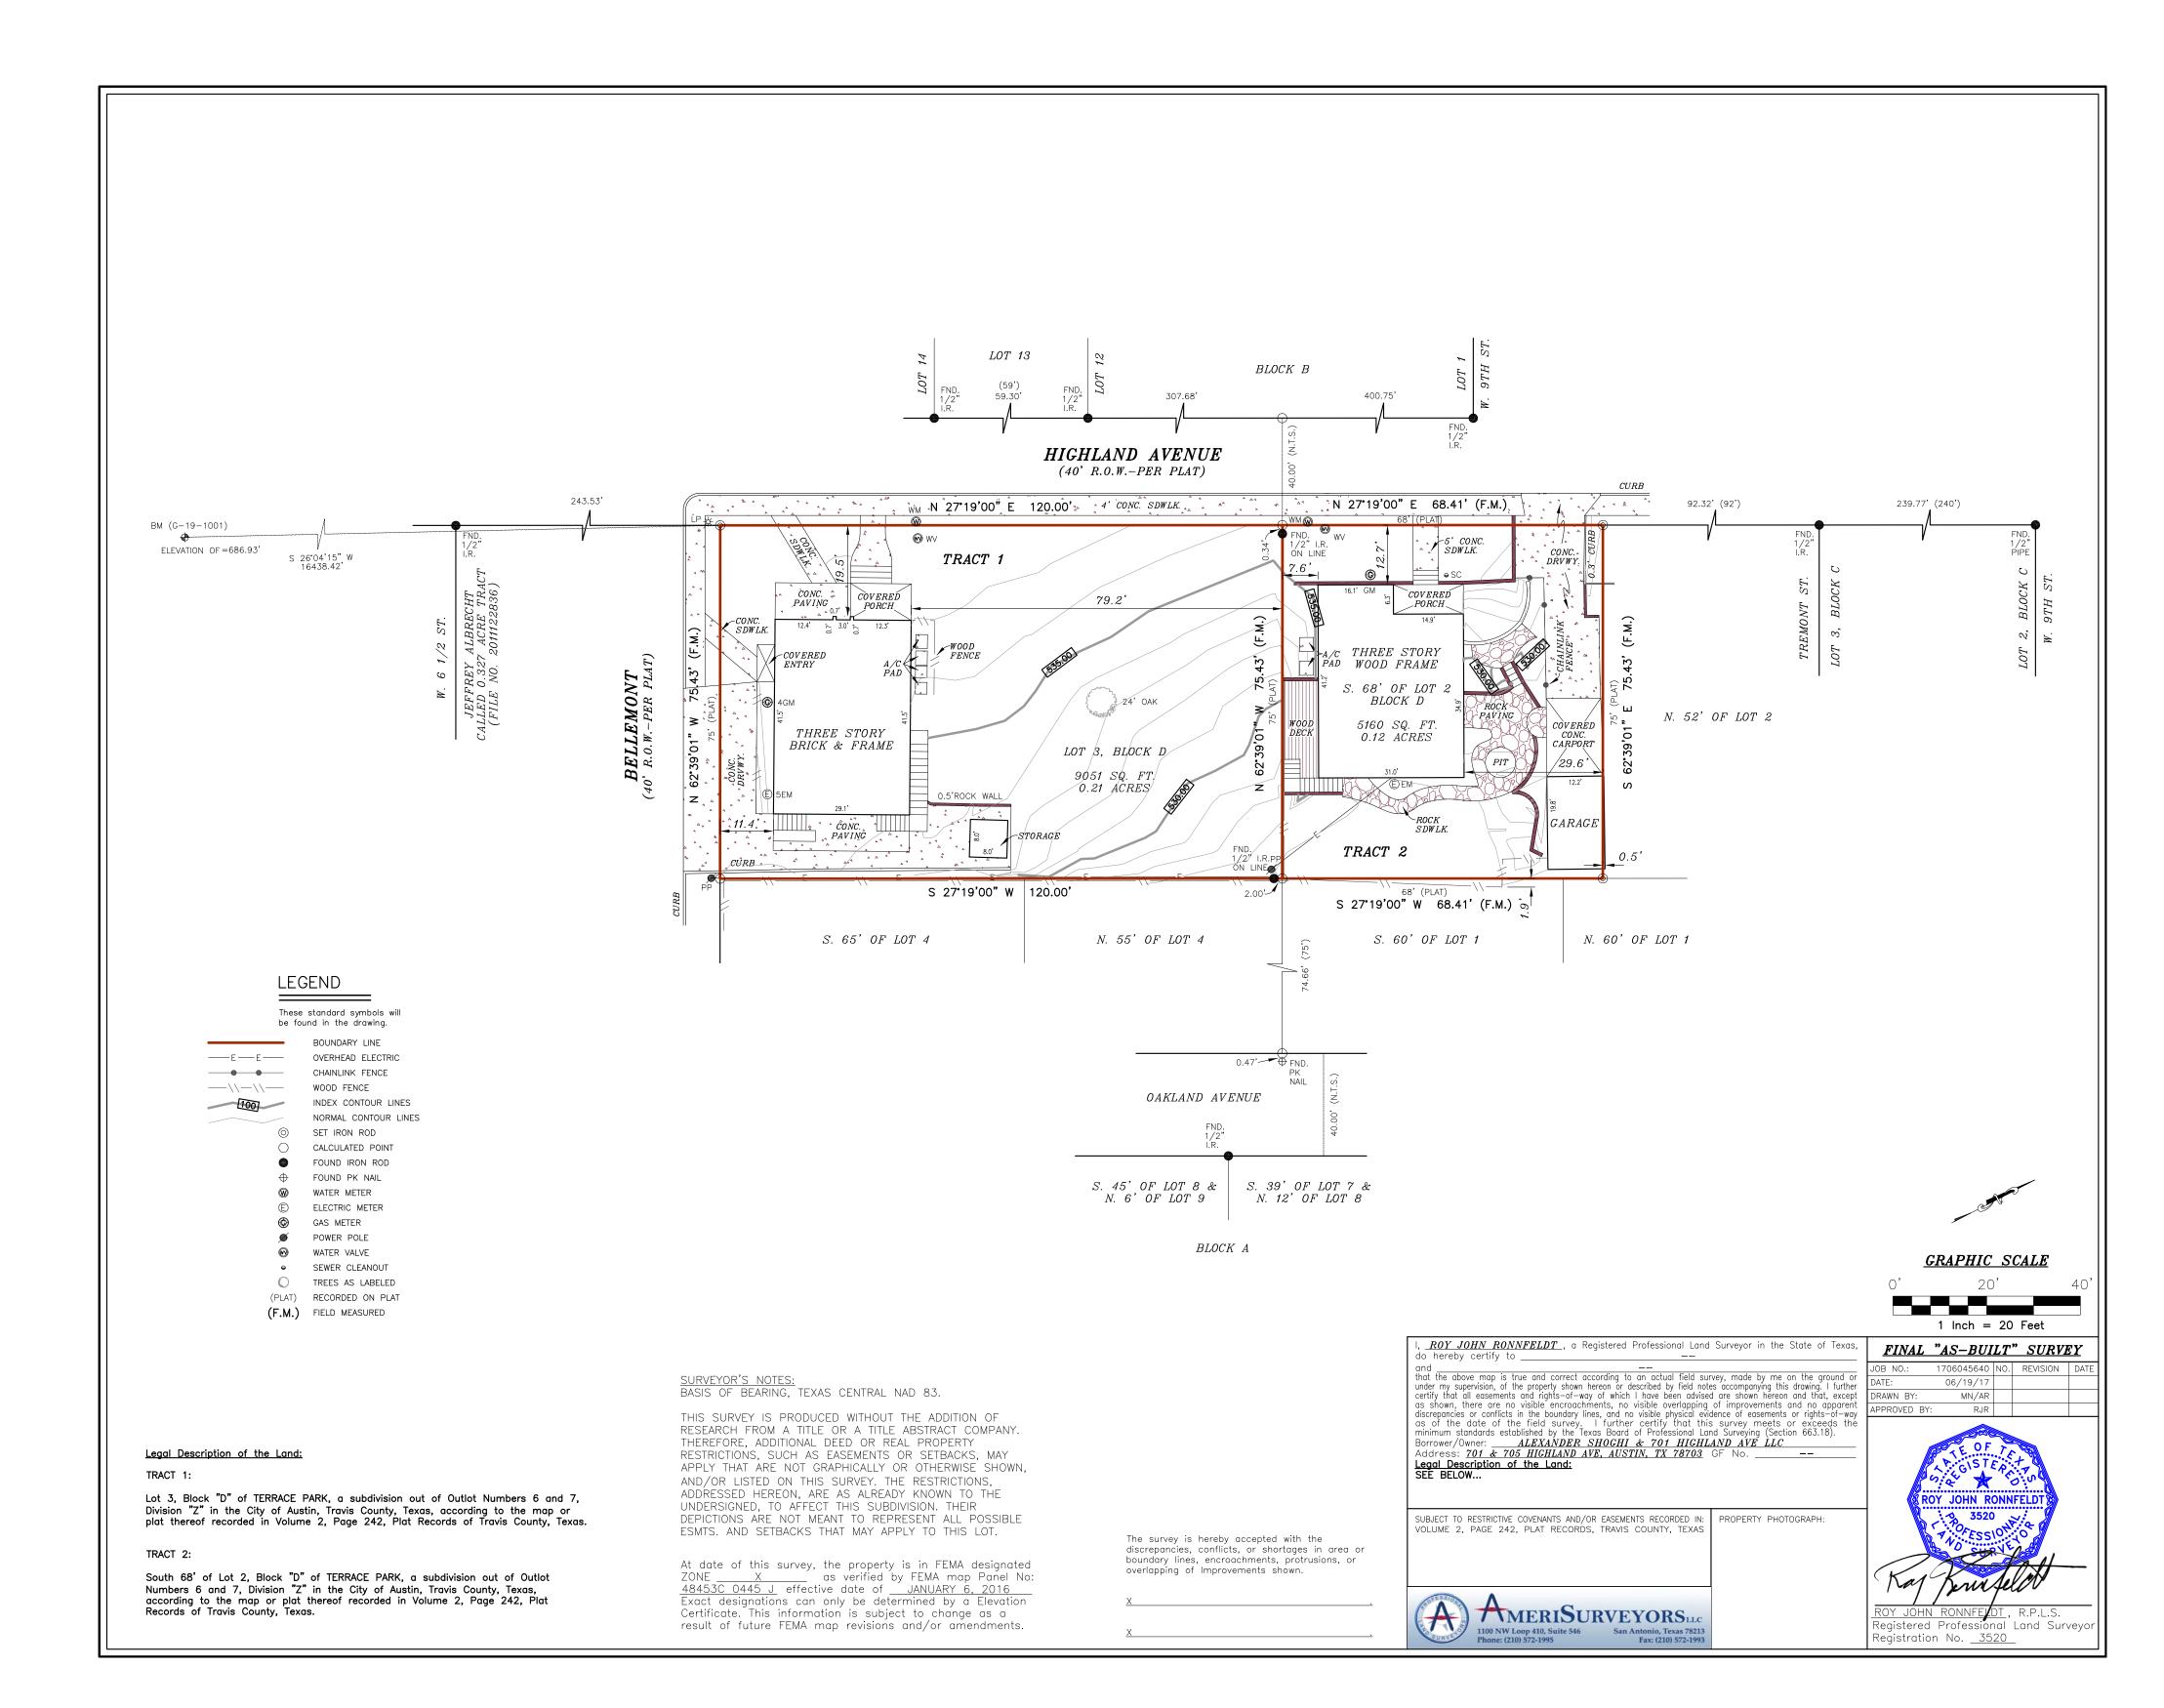
- ARCHITECTURAL SITE PLAN
- FLOOR PLAN LEVEL FLOOR PLAN - LEVEL 2 FLOOR PLAN - LEVEL 3 A1.4 ROOF PLAN
- A2.0 BUILDING ELEVATIONS A2.1 BUILDING ELEVATIONS
- A3.0 BUILDING SECTIONS A3.1 BUILDING SECTIONS


GRAPHIC LEGEND

2X NEW STUD V	VALL		
2X PARTIAL HEIG	HT WALL		
AREA DRAIN	DROP	HOSE BIB	TREE TRUNKS

- FOR INTERIOR WALL FINISHES REVIEW INTERIOR ELEVATIONS
- FOR EXTERIOR WALL FINSH- SEE EXTERIOR ELEVATIONS
- VERIFY ALL DIMENSIONS IN FIELD

SHEET TITLE Survey



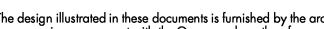

GENERAL NOTES | ARCHITECTURAL SITE PLAN

- The design illustrated in these documents is furnished by the architect under a limited scope services agreement with the Owner and are therefore provided as a "builder's set" for general intent only. All products and the detailing of their installation, including flashing, underlayments, and weather resistive barriors, should be installed in strict compliance with manufacturer's recommendations and in compliance with all applicable codes as mandated by all governing jurisdictions.
 Tree protection must remain in place through the landscaping and sprinklers need to be placed to stay out of the 1/4 CRZ with a preferred drip system in the 1/2 / full CRZ if possible.
 Tree protection fencing is required for all trees within the limits of construction.
- CRZ if possible.
 Tree protection fencing is required for all trees within the limits of construction.
 Fencing should be indicated to protect the entitire Critical Root Zone (CRZ) area or as much of the CRZ as is practical. Fencing is required to be chain-link mesh at a minimum height of five feet. When the tree protection fencing cannot incorporate the entire 1/2 Critical Root Zone, an eight inch layer of mulch within the entire available root zone area is required for all trees which have any disturbance indicated within any portion of the Critical Root Zone.
 Foot traffic is considered a root zone disturbance, as well. 2x4 or greater size planks to tall minimum are required to be strapped securely ground protected trees trunks.
- (6' tall minimum) are required to be strapped securely around protected trees trunks and root flares when protective fencing does not incorporate the entire 1/2 CRZ for any reason at any time in the project.

KEY NOTES | ARCHITECTURAL SITE PLAN

- French drain, verify in field.
 Demo existing shed.
 Proposed material staging area. Dump ster and spoils placement cannot be located within the 1/2 CRZ of any protected frees. Use existing driveway as an access route.
 Area designated for portable tollet and concrete washout these cannot be within the full CRZ of any protected tree.
 8" inch layer of much within the entire available root zone area is required for all trees which have any disturbance indicated within any portion of the Critical Root Zone.

SITE	SITE PLAN LEGEND		
		WOOD FENCE	
	— γ ——	UTILITY LINE	
	AC	A/C UNIT	
	G	GAS METER	
		IRON ROD FND.	
		NAIL FND.	
	0	PIPE FND.	
	Ø	UTILITY POLE	

		THE TIND.	
()-		UTILITY POLE	
	M	METER POLE	
	KEY I PLOT PLAN		
	FIRST FLOOR		ROOF

PATIO

ADJACENT BUILDING

NOT CLASSIFIED AS A TREE

TREE LEGEND		
TREE #	SIZE & SPECIES	NOTES
326	25" WHITE OAK	HERITAGE
331	23.5" WHITE OAK	TO BE REMOVED
421	6", 6", 5", 5", 5" CRAPE MYRTLE	NOT CLASSIFIED AS A TREE
526	9', 8" CRAPE MYRTLE	NOT CLASSIFIED AS A TREE
591	22" PECAN	
<i>7</i> 21	16" PECAN	
722	7" PALM	NOT CLASSIFIED AS A TREE

ı	
ı	CONCRETE FOUNDATION NOTE
ı	{
ı	CONTRACTED CONTRACTOR INCIDENCE
ı	COLICKETE LOOP ADVITION A LIGHT

SECOND FLOOR

•Concrete line pump: Wrap connections of concrete line pump with plastic to prevent concrete slurry from leaching into ground and near roots of trees.

•Concrete truck: If heavy equipment of any kind will be rolling over any area of the full CRZ of protected trees, provide 3/4" plywood over 2x4 lumber over 12" layer of mulch to bridge over the roots and prevent soil/root compaction. After construction is completed, spread mulch around site to leave a max layer of 3" within root zones.

Tree protection must remain in place through the landscaping and sprinklers need to be placed to stay out of the 1/4 CRZ with a preferred drip system in the 1/2 / full CRZ if

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 \bigcirc

Becky Jeanes - Texas Architect
Registration #21297
[current date]
This document is incomplete and

approval, permitting or construction.

may not be used for regulatory

Tray Toungate - Texas Architect
Registration # 21509
[current date]
This document is incomplete and may not be used for regulatory approval, permitting or construction

Residence
701 Highland Ave.
Austin, TX 78703

Highland

SHEET TITLE Arch. Site Plan

CAUTION: DO NOT SCALE DRAWINGS THESE DRAWINGS ARE THE PROPERTY OF THE ARCHITECT AND MAY ONLY BE USED IN CONJUNCTION WITH THIS PROJECT

ARCHITECTURAL SITE PLAN

| Scale: 1/8" = 1'-0"

Tray Toungate - Texas Architect
Registration # 21509
[current date]
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Highland Residence

Floor Plan -Level 3

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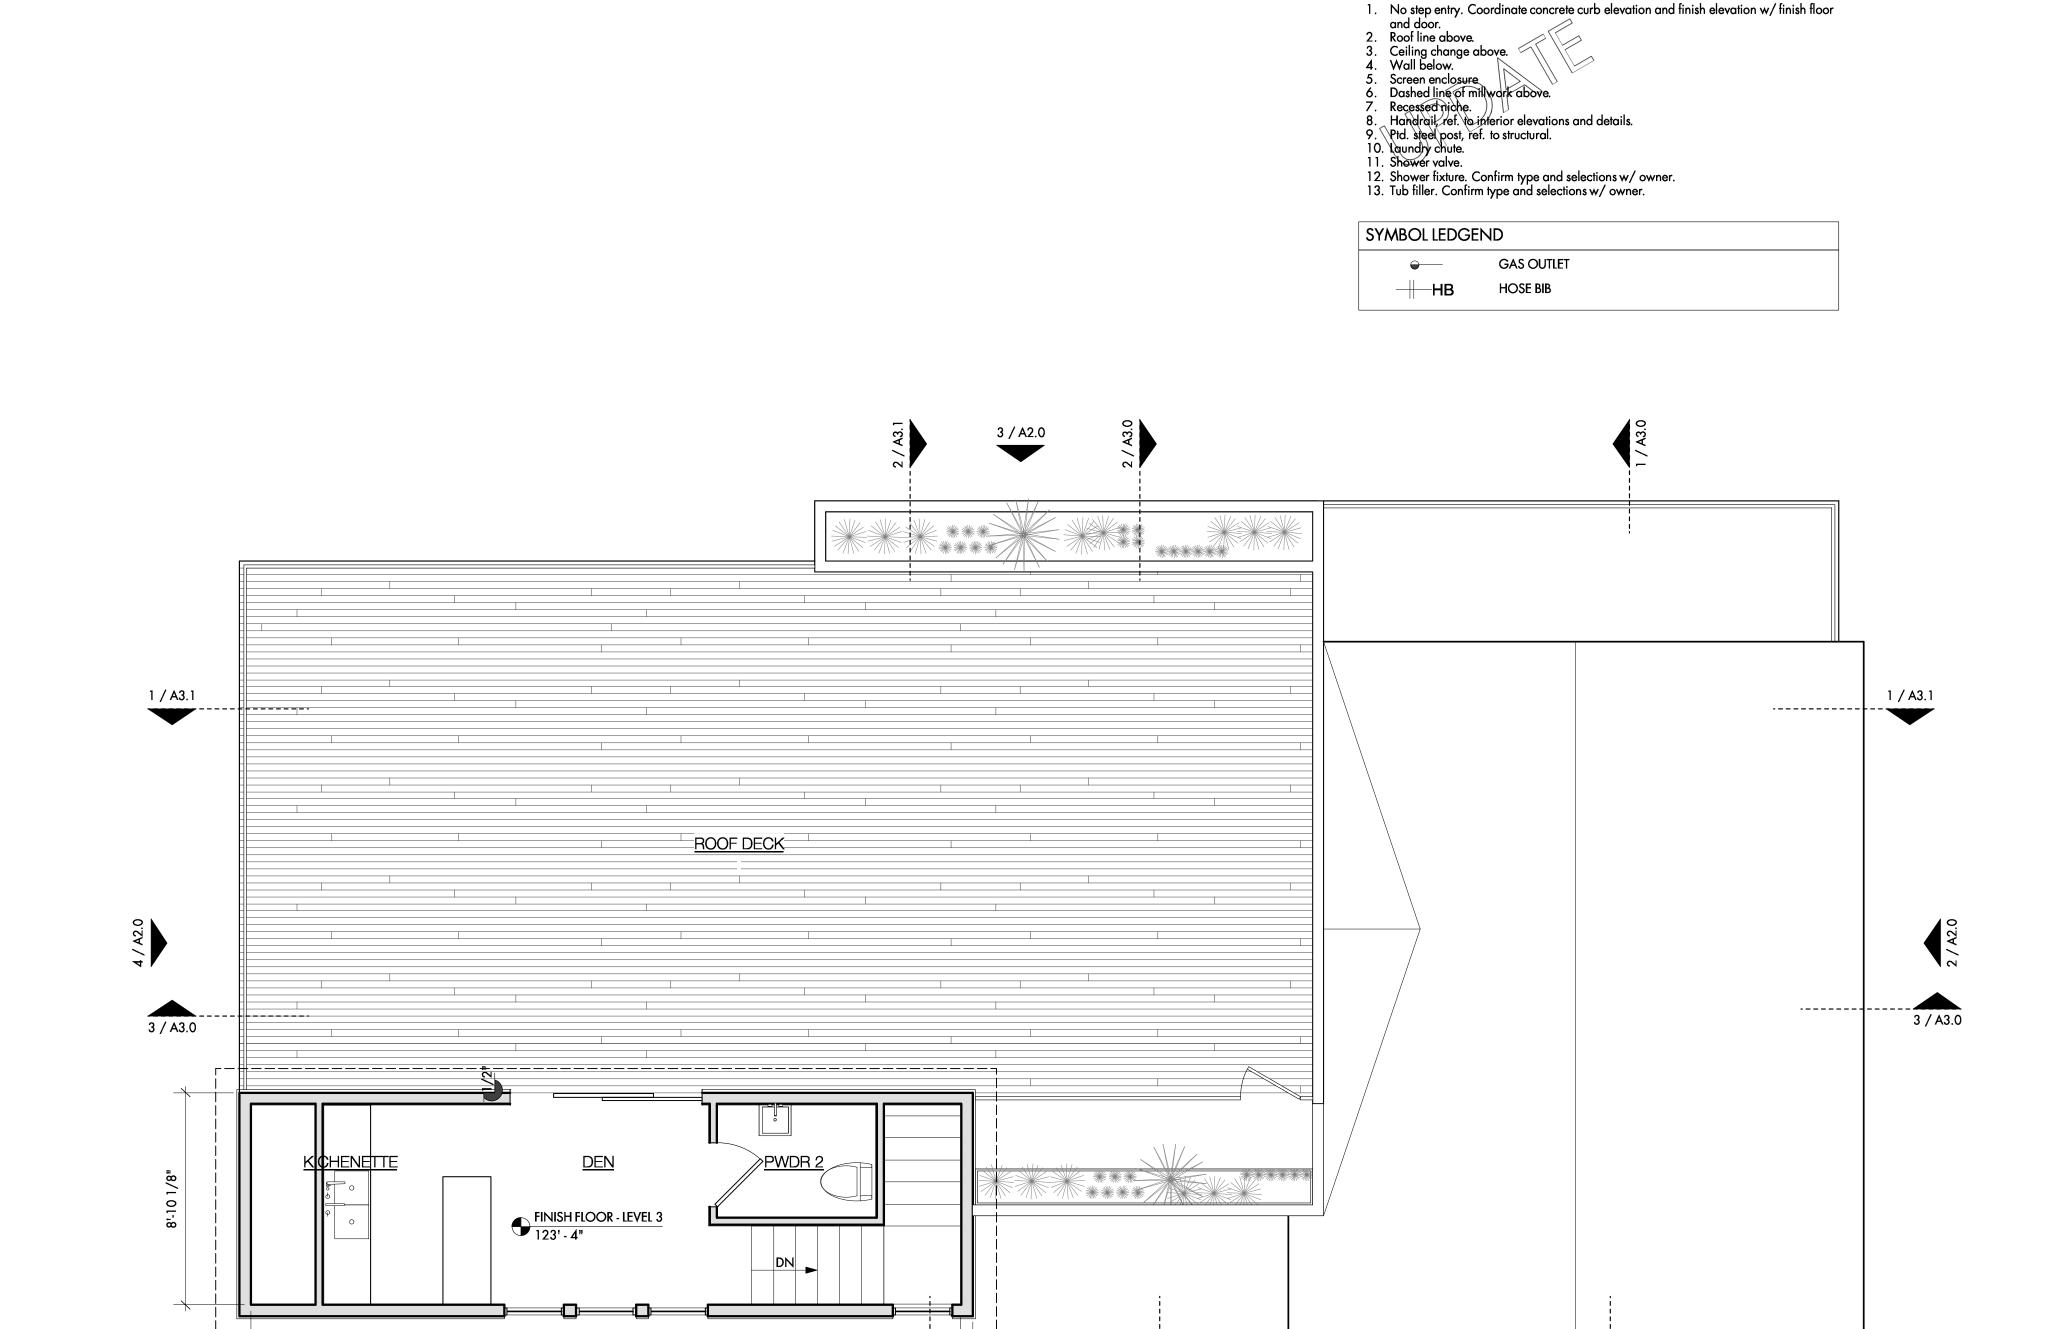


GENERAL NOTES

KEYNOTES I PLAN

1. Do not scale the drawings. If a specific dimension is not given, contact Designtrait for

Do not scale the drawings. If a specific dimension is not given, contact Designtrait for clarification.
 Dimensions are to face of frame or centerline of frame as noted.
 Keynotes located on this sheet are for this sheet only.
 Provide tempered glazing as required by local codes.
 Provide submittals and shop drawings showing number of windows, locations of tempered glazing, etc.
 Window and door types indicate rough sizes only. GC shall field verify the appropriate glazing and leaf sizes in the field prior to ordering. For any questions contact Designtrait.
 GC responsible for removing any temporary infill panels at all window locations.
 Verify final finishes with owner.
 Verify and coordinate appliance selections and locations w/ owner.




30'-1"

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Highland Residence

SHEET TITLE Roof Plan


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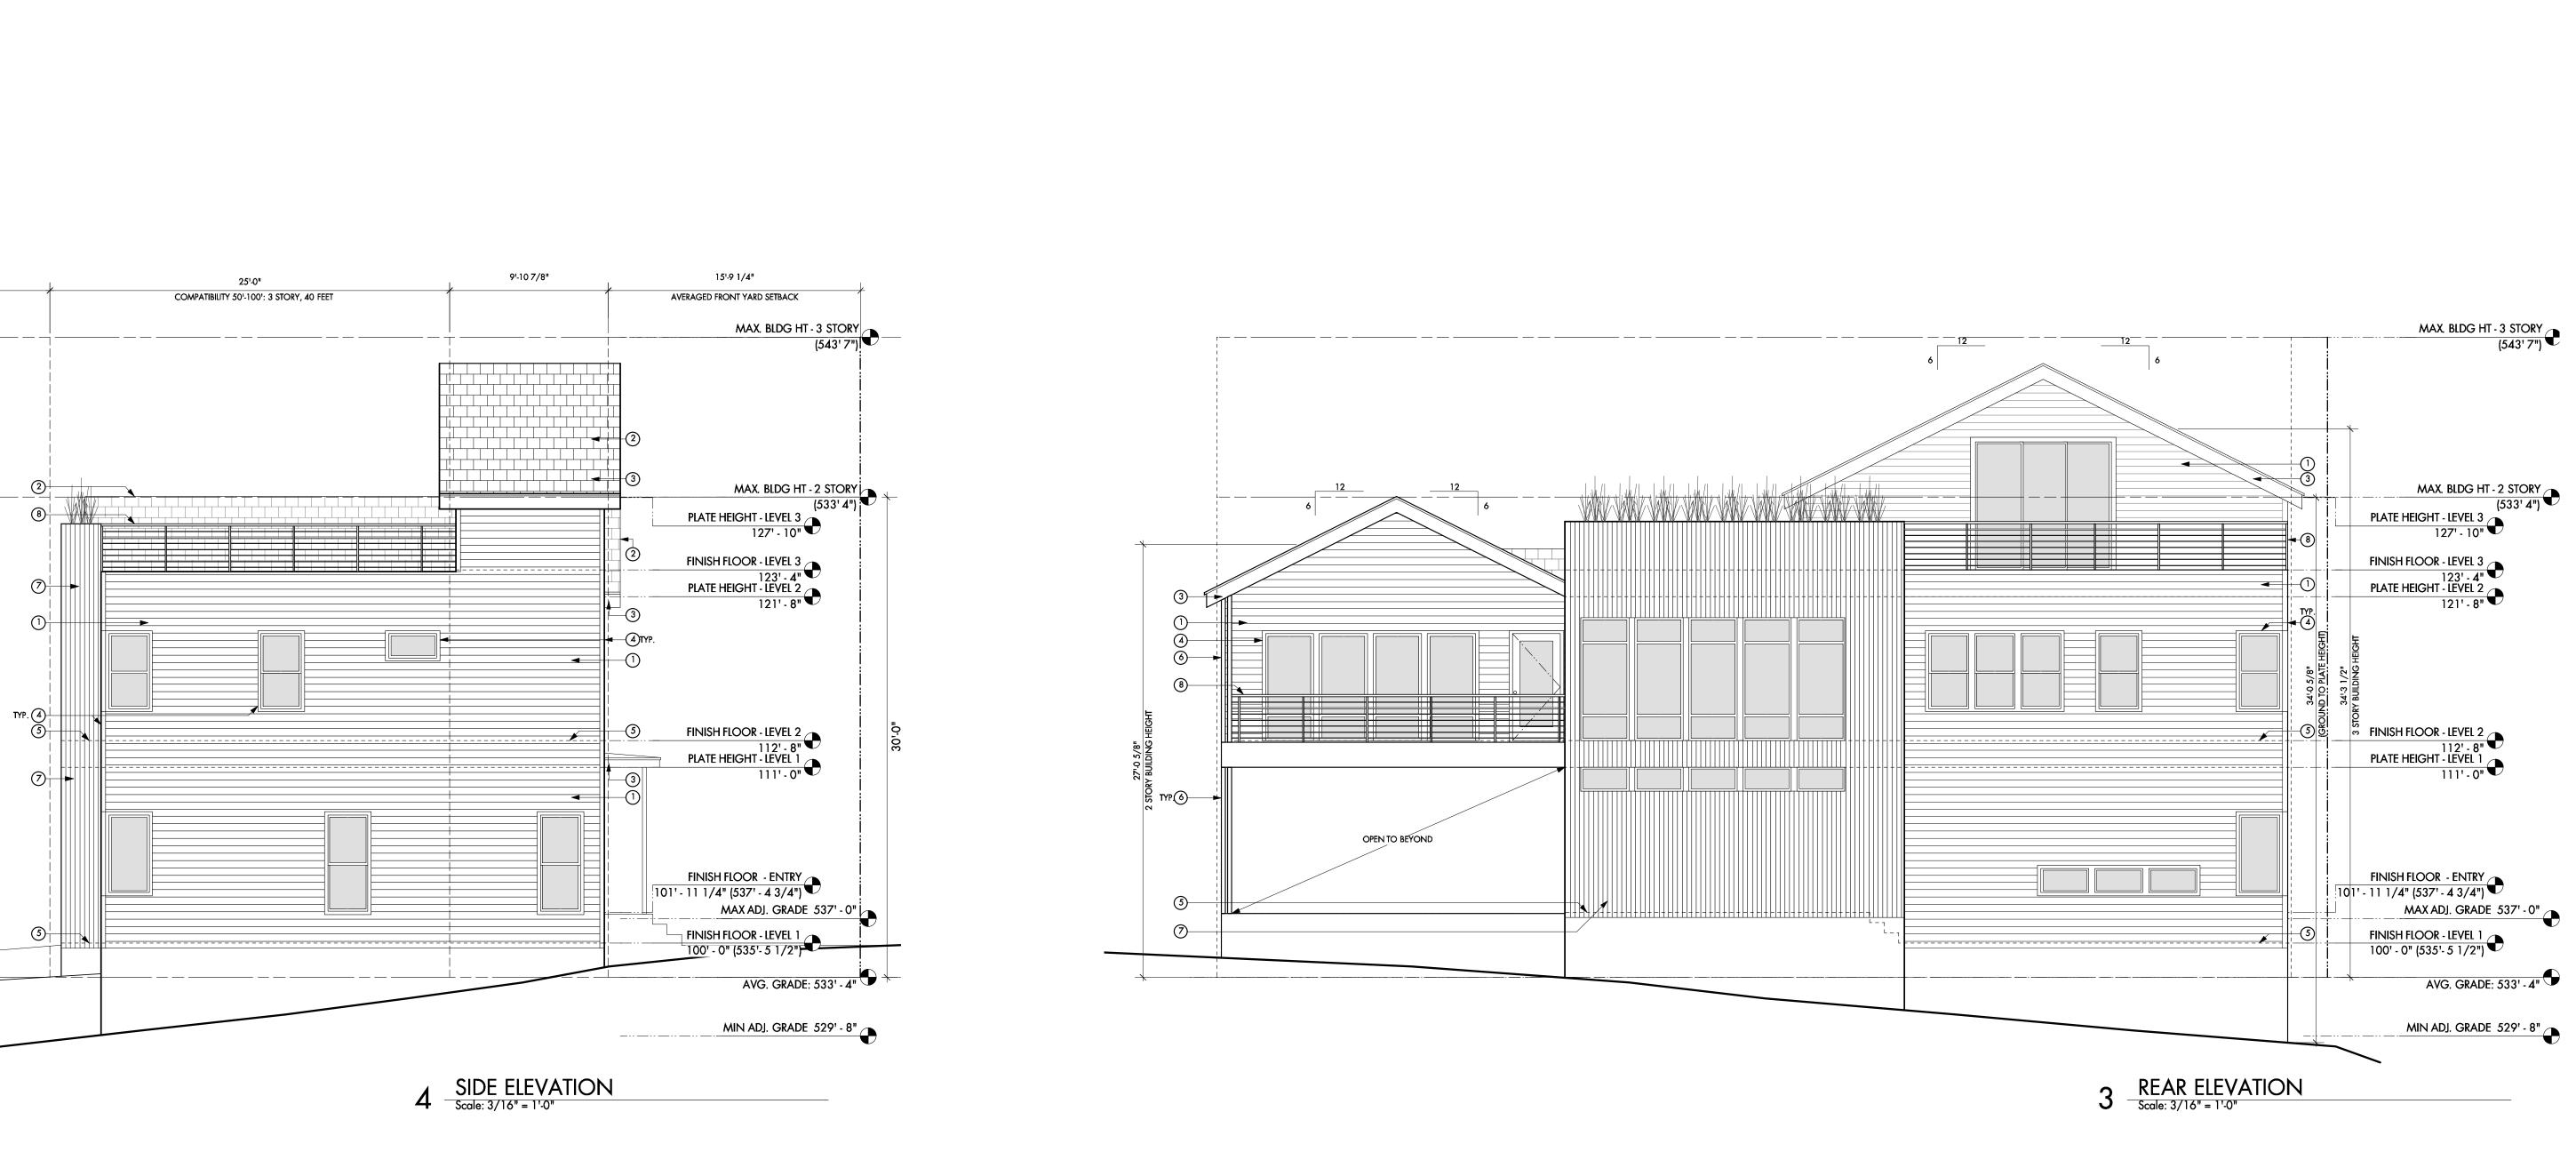


GENERAL NOTES | ROOF PLAN

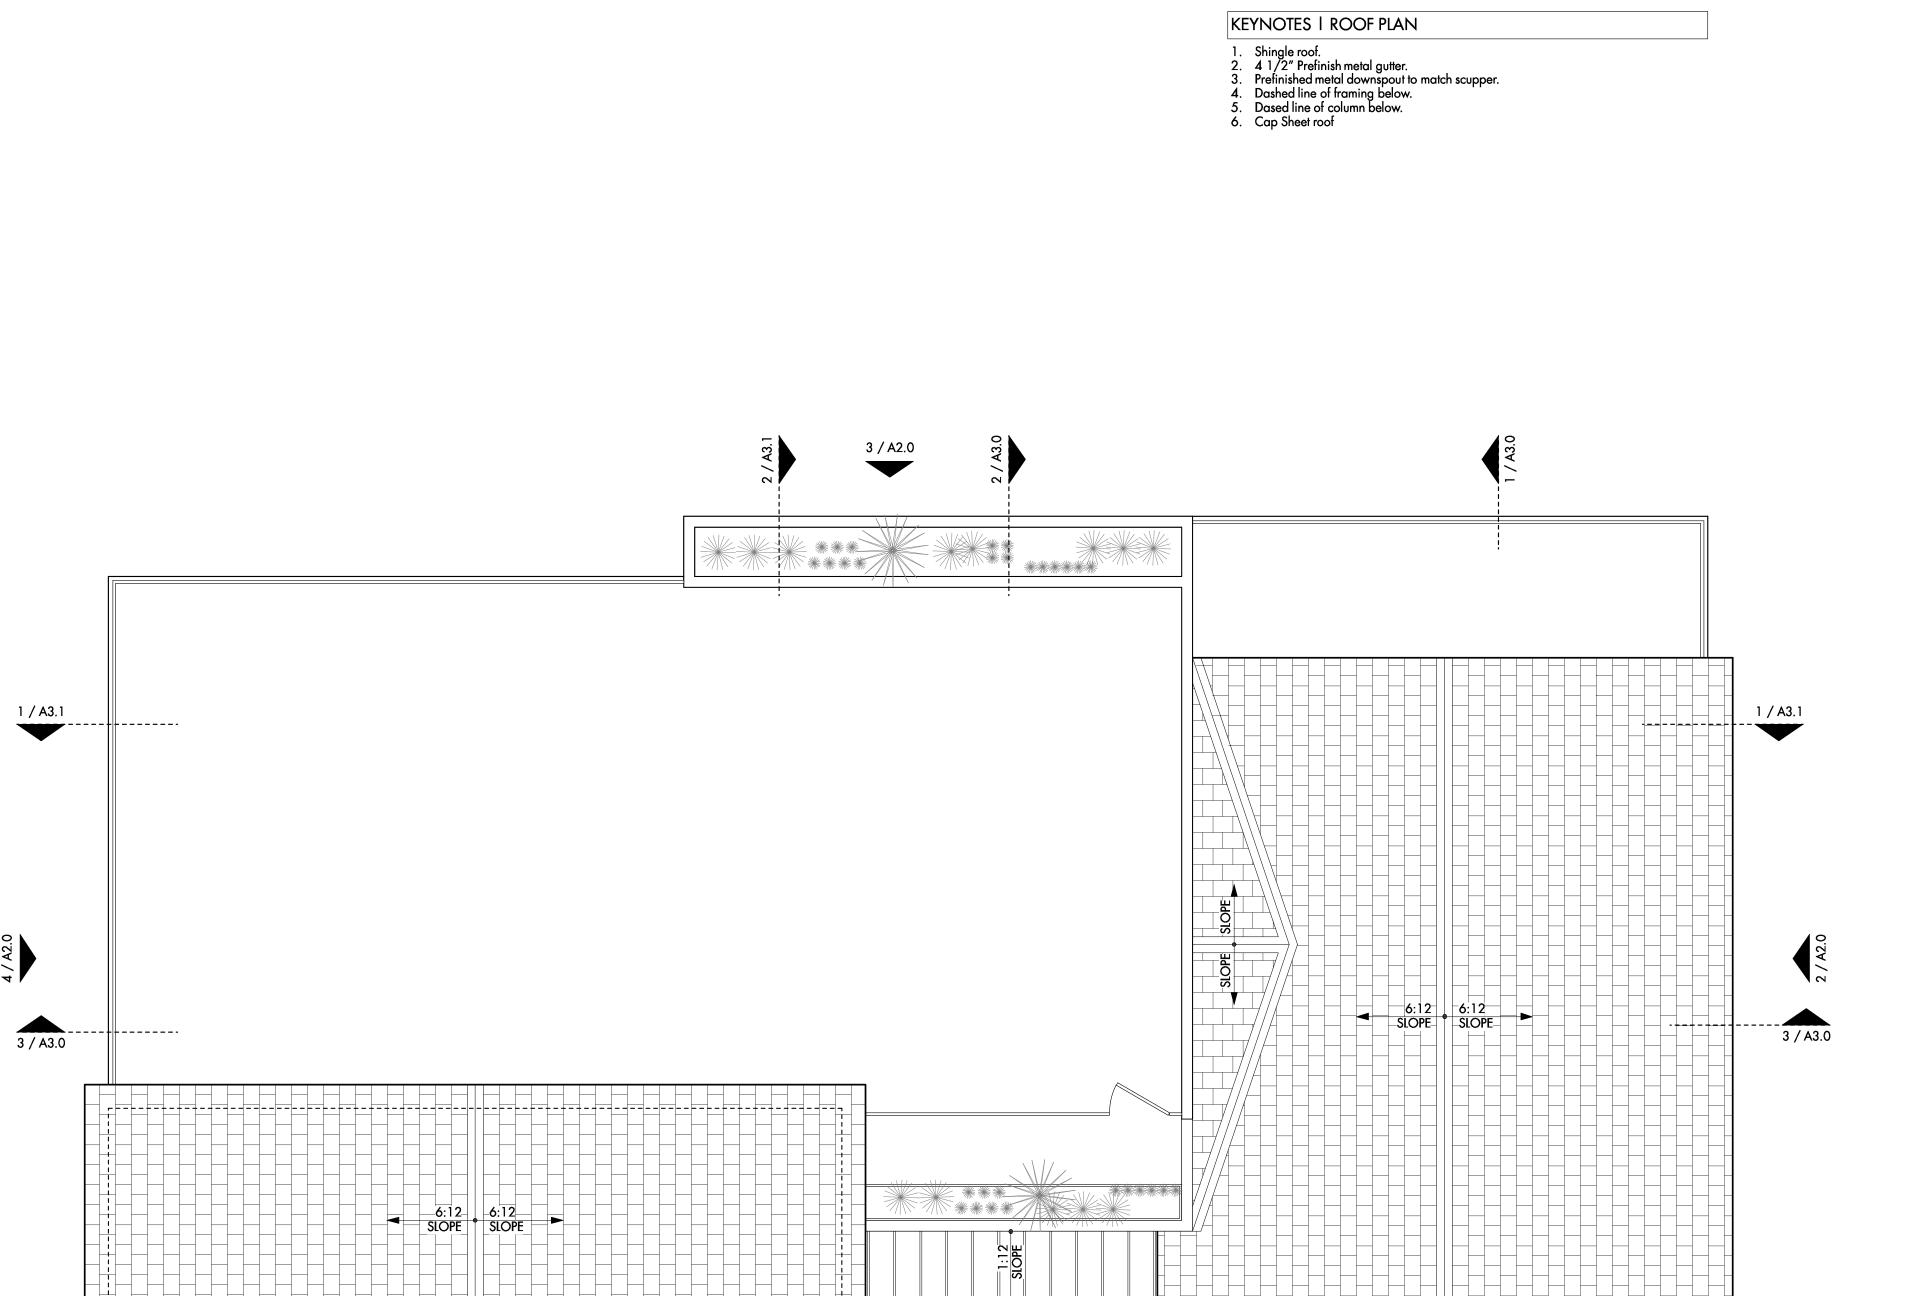Do not scale the drawings. If a specific dimension is not given, contact Designtrait for clarification.

clarification.
 Dimensions are to face of frame or centerline of frame as noted.
 Keynotes located on this sheet are for this sheet only.
 Window and door types indicate rough sizes only. GC shall field verify the appropriate glazing and leaf sizes in the field prior to ordering. For any questions contact Designtrait.
 Verify final finishes with owner.



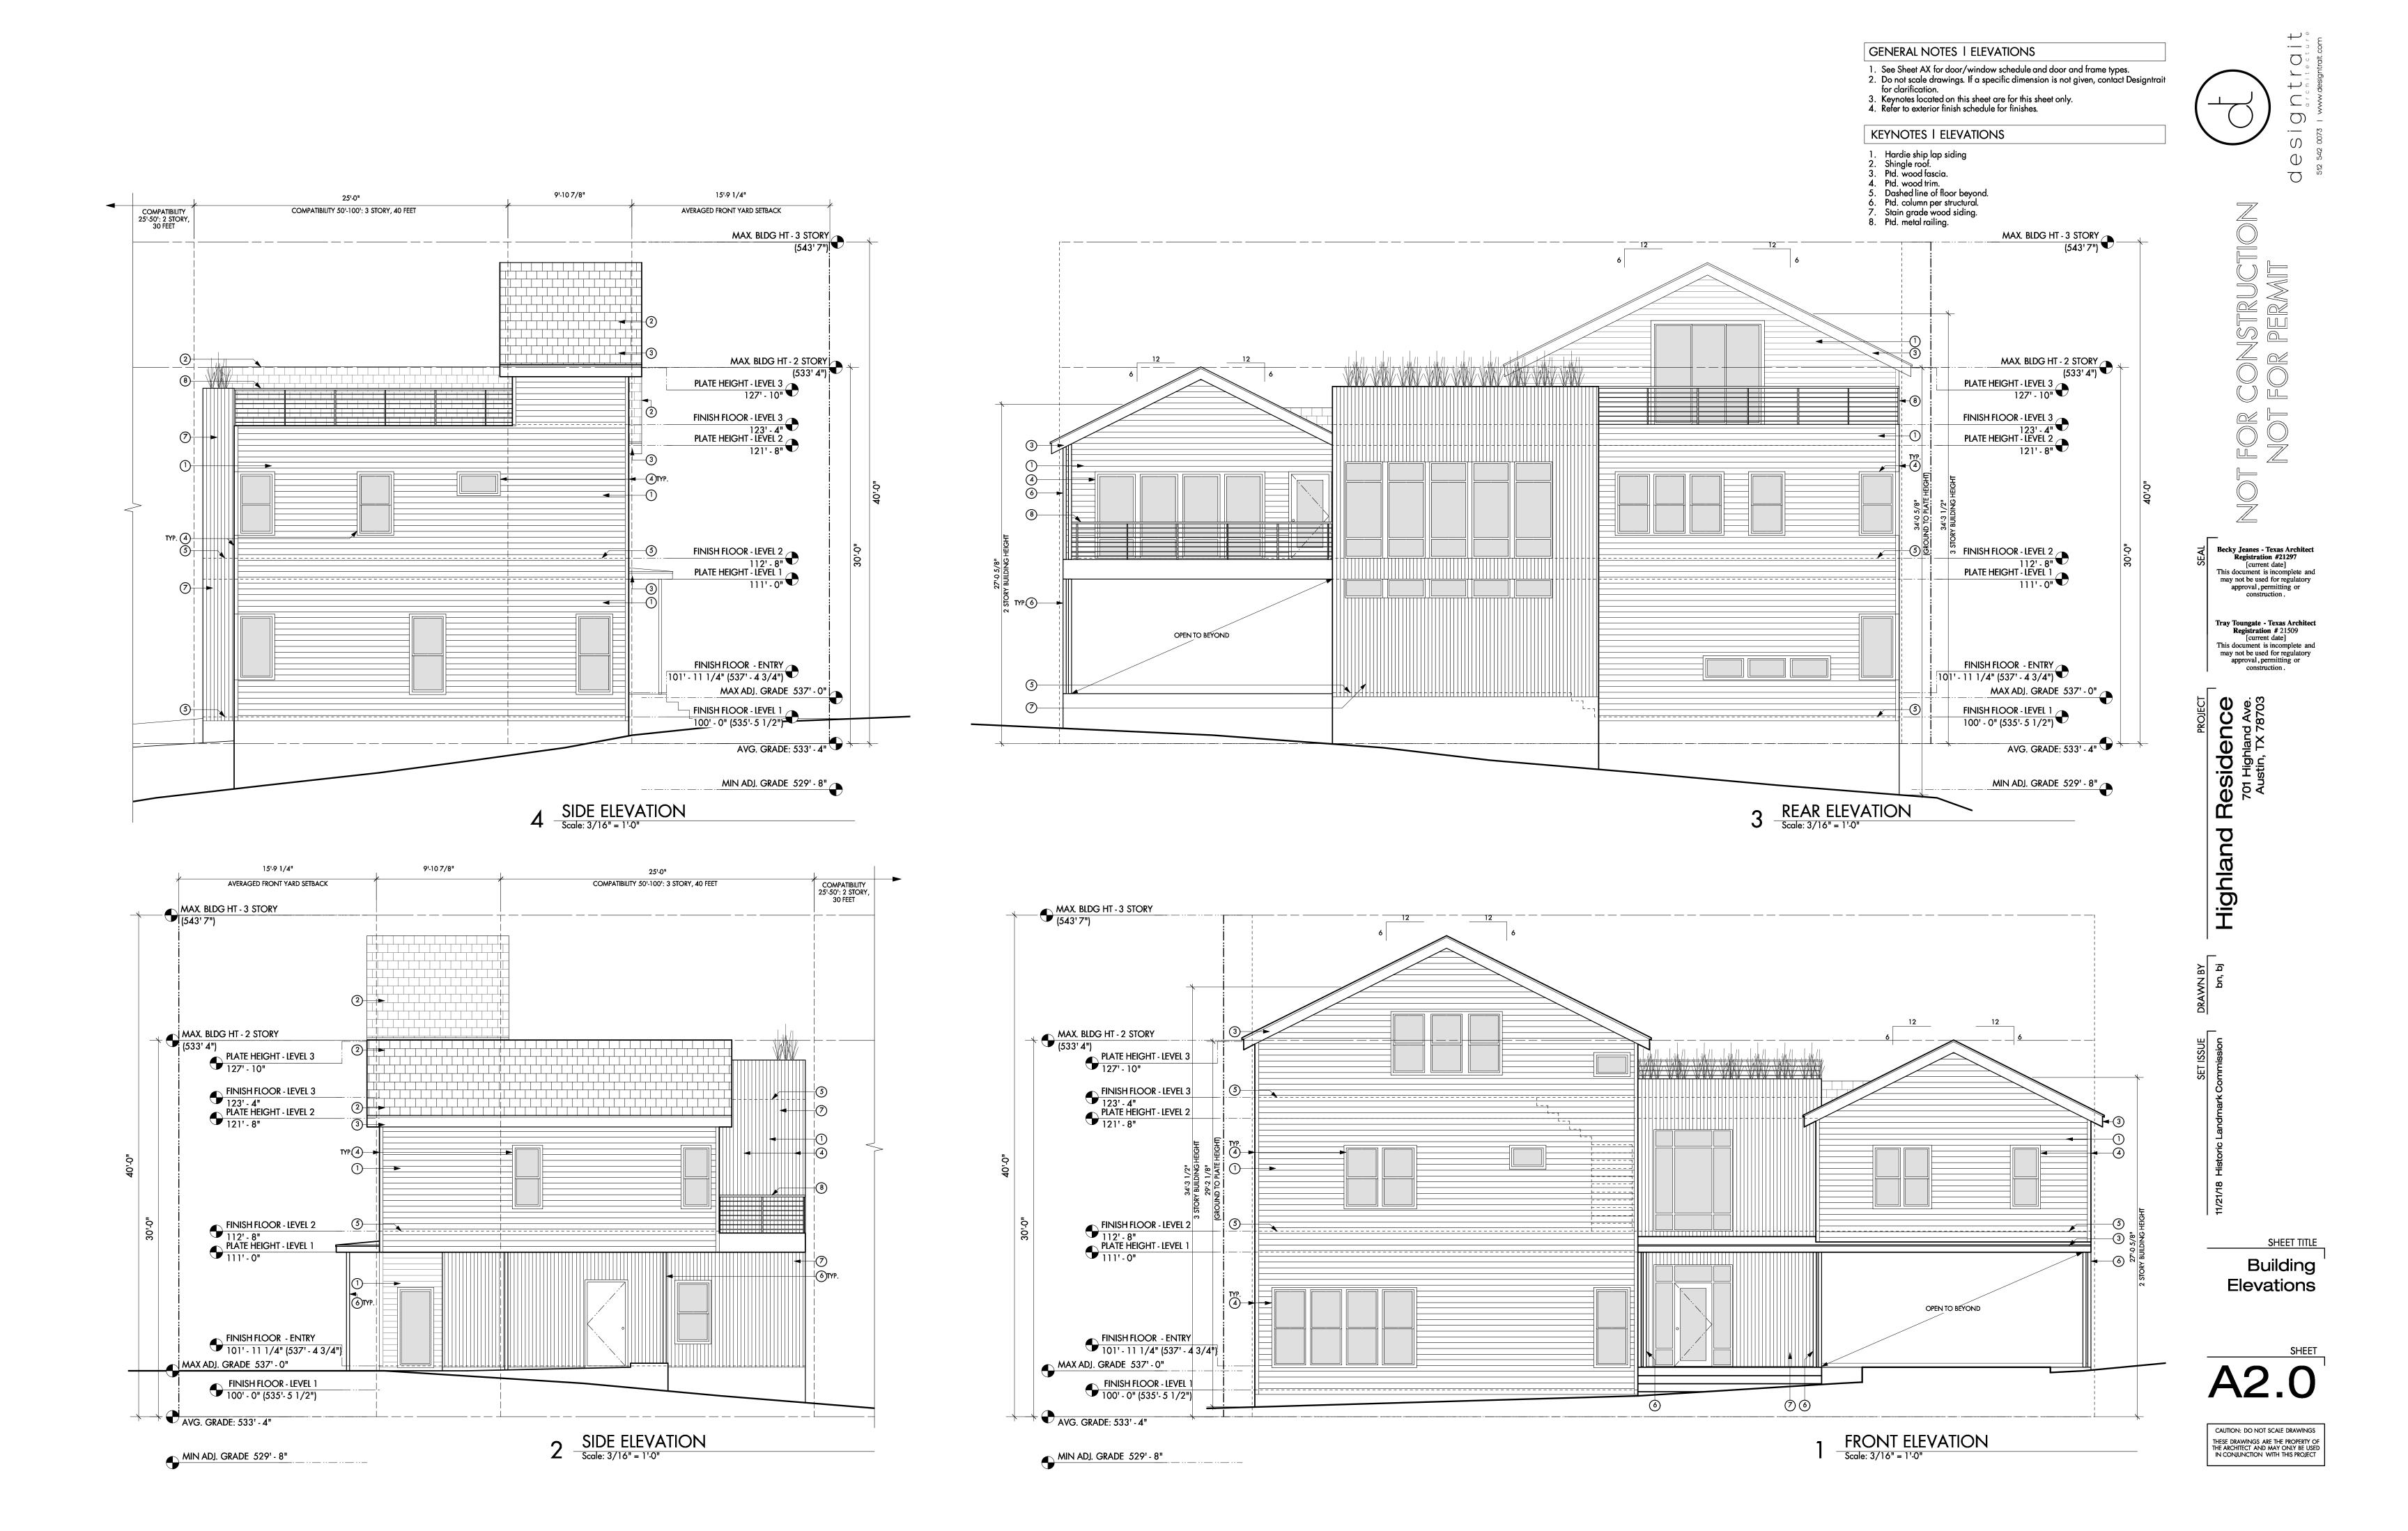

GENERAL NOTES | ELEVATIONS

See Sheet AX for door/window schedule and door and frame types.
 Do not scale drawings. If a specific dimension is not given, contact Designtrait for clarification.

Keynotes located on this sheet are for this sheet only.
 Refer to exterior finish schedule for finishes.

KEYNOTES | ELEVATIONS

Hardie ship lap siding
 Shingle roof.
 Ptd. wood fascia.

4. Ptd. wood trim.

Dashed line of floor beyond.
 Ptd. column per structural.
 Stain grade wood siding.
 Ptd. metal railing.


Becky Jeanes - Texas Architect
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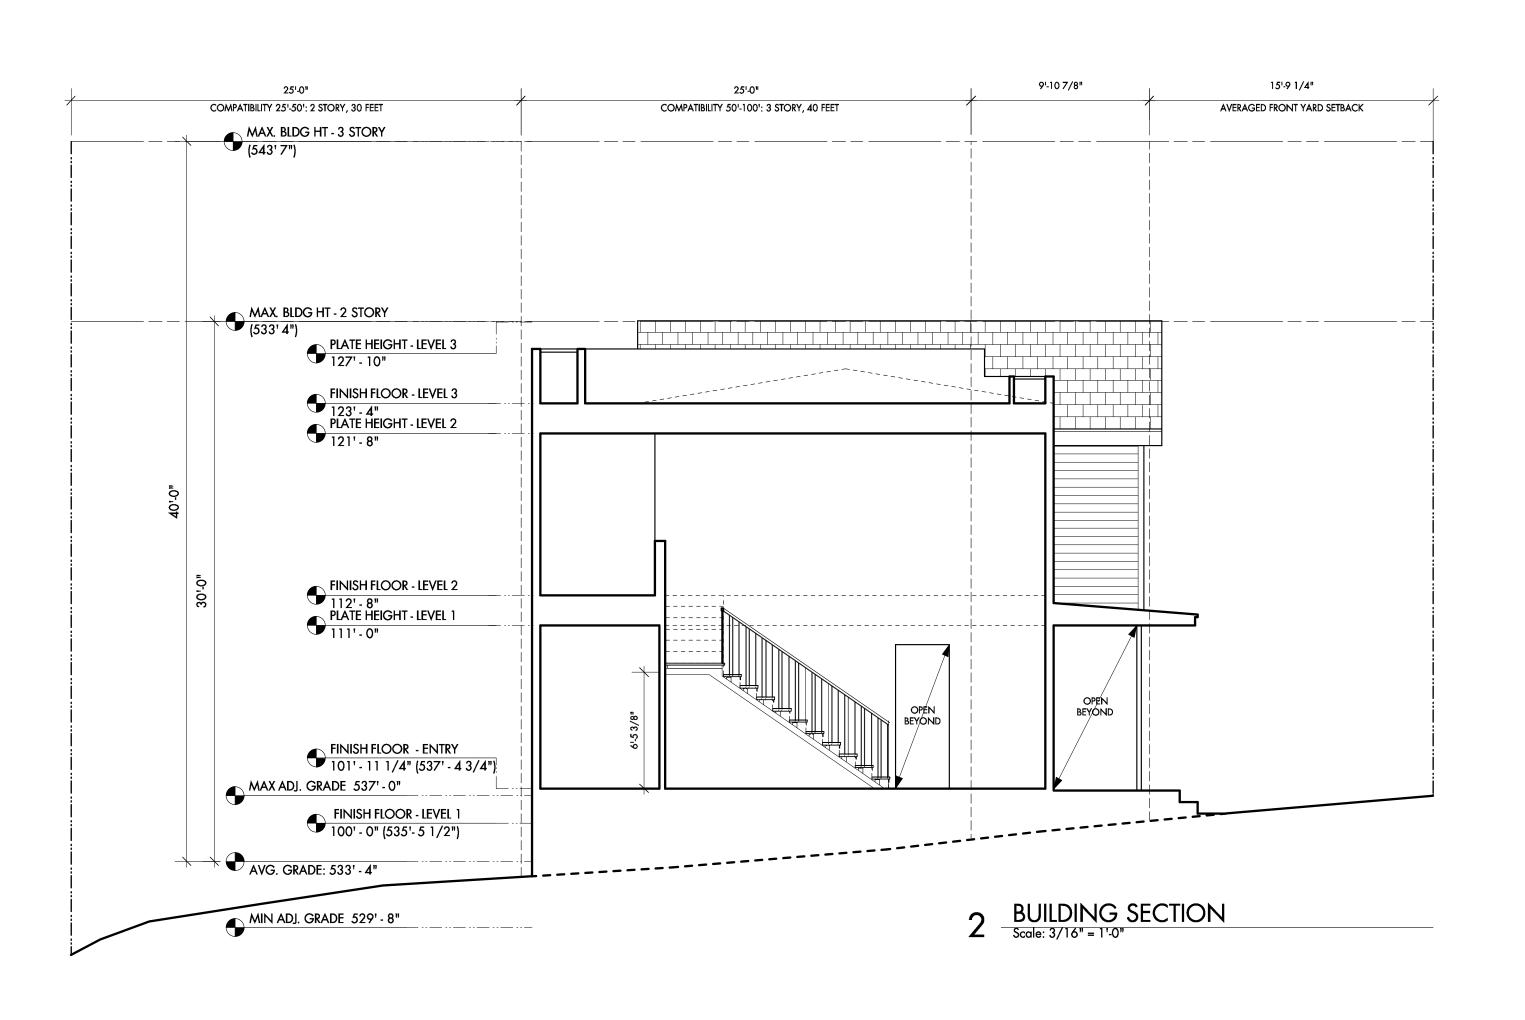
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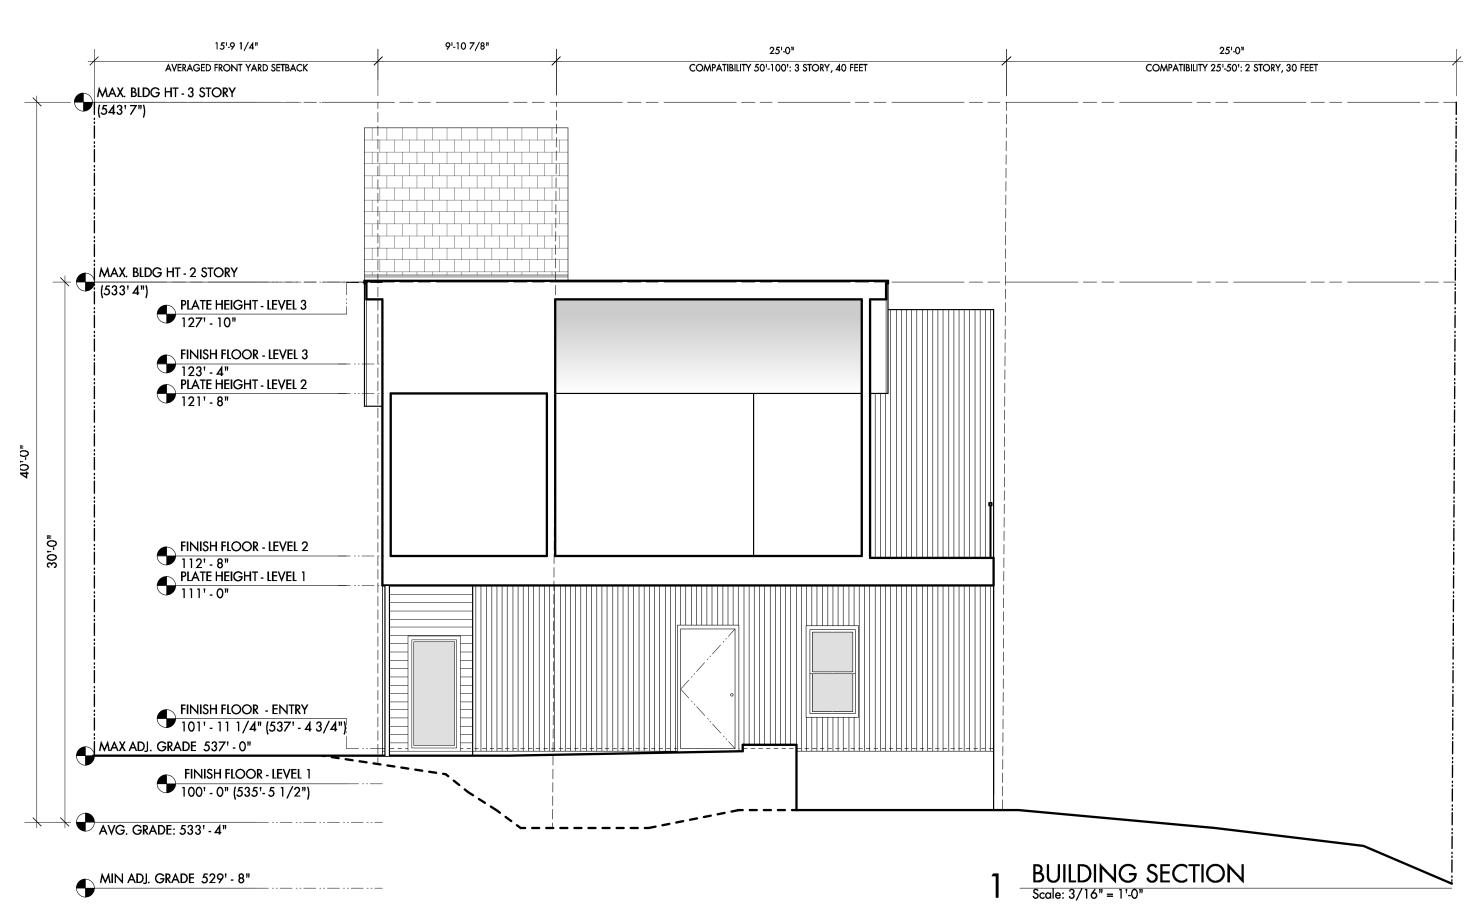
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SHEET TITLE Building Elevations







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SHEET TITLE Building Sections

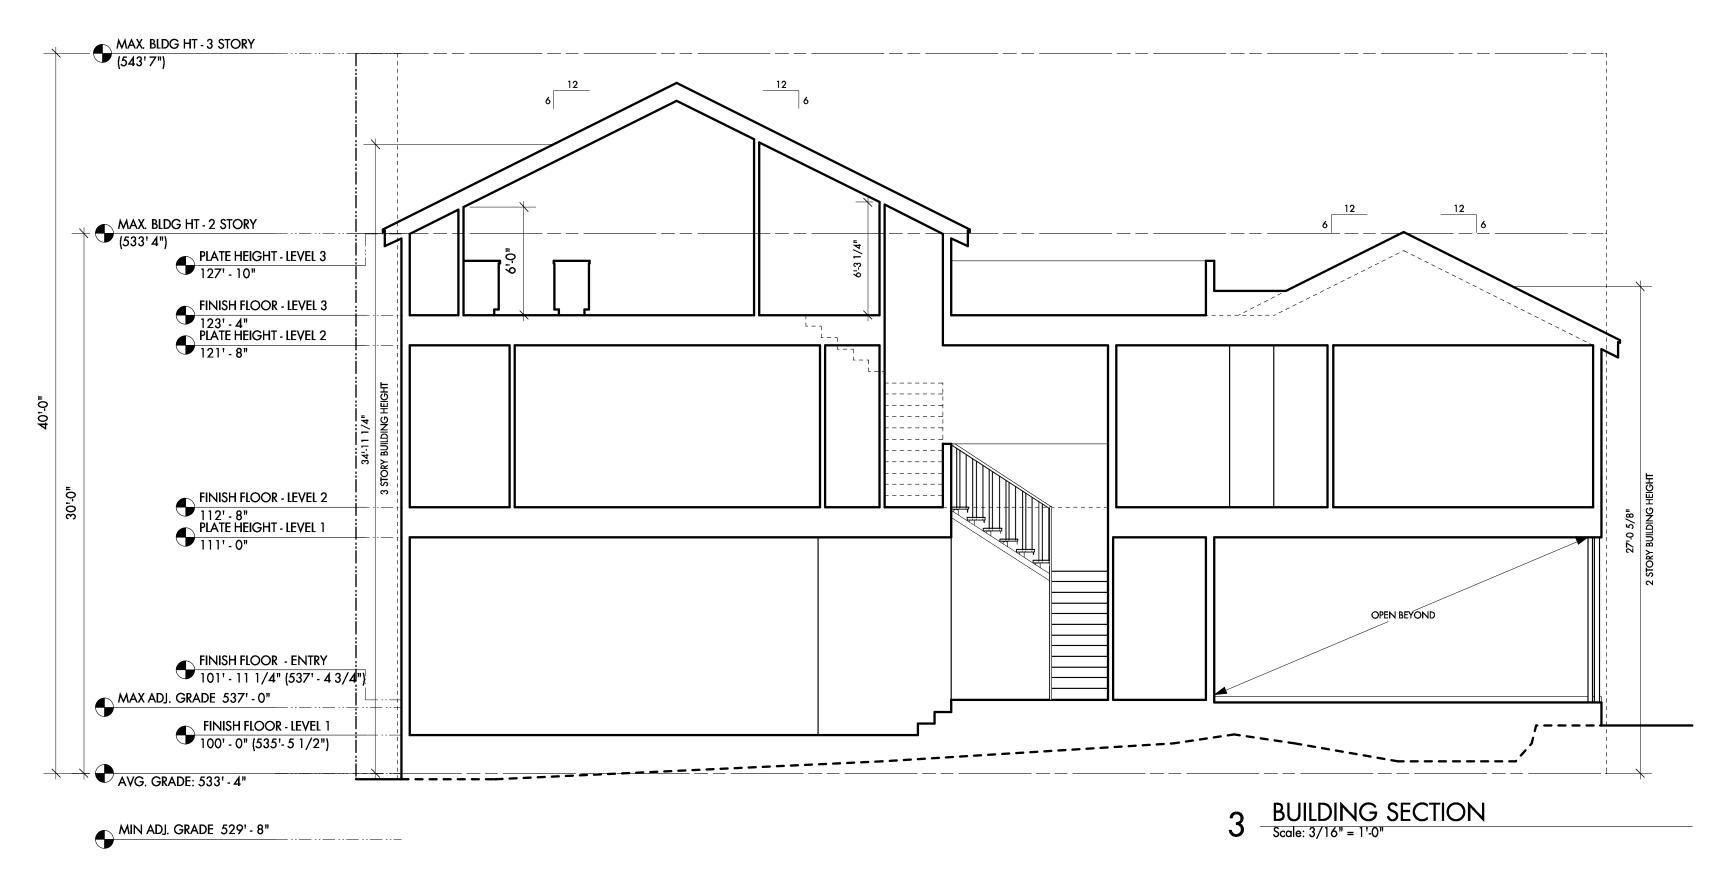