


Site Plan

A-2



Site Plan A-1 1 OF 20




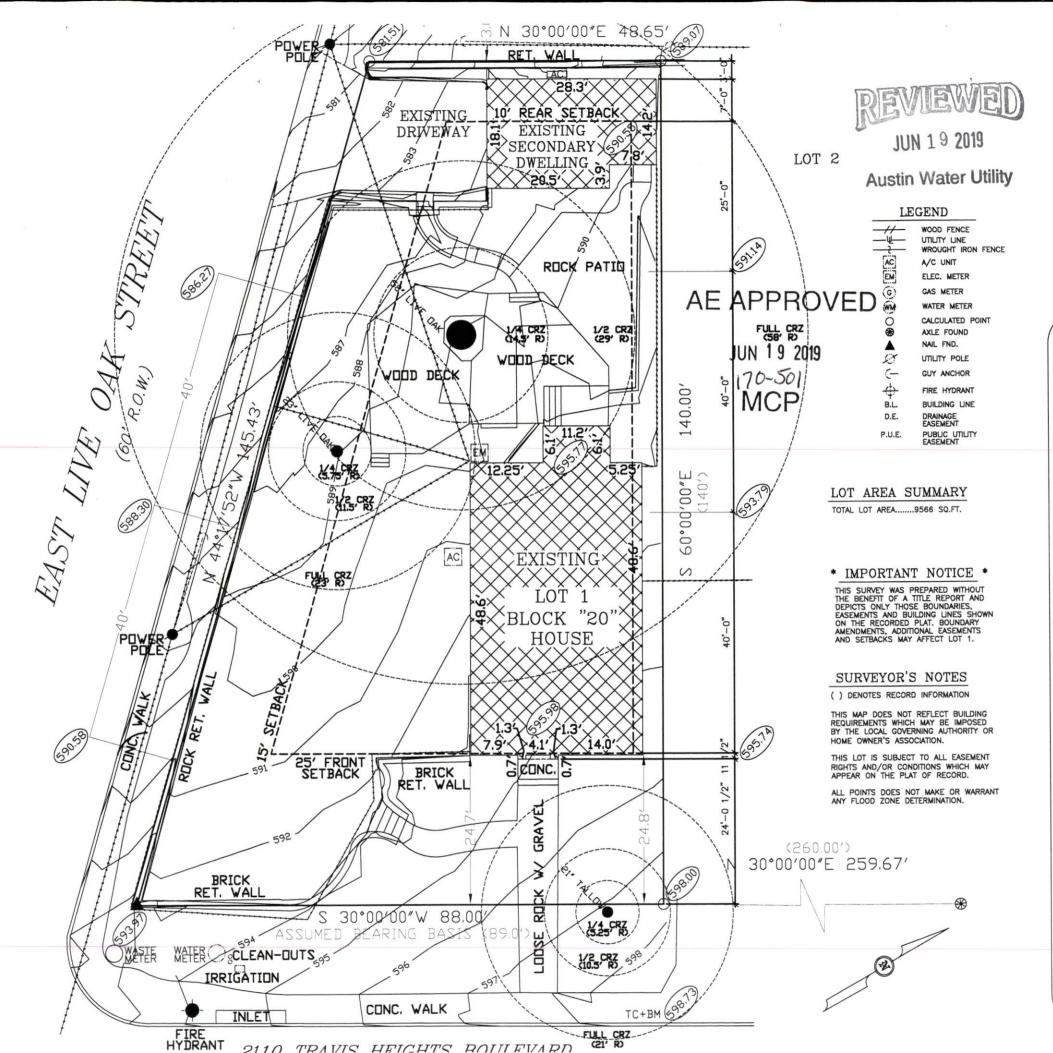

S-7 MAIN HOUSE TYPICAL CROSS SECTION


S-2 SECONDARY DWELLING FOUNDATION DETAILS S-3 SECONDARY DWELLING BSMT WALL FRAMING

S-5 SECONDARY DWELLING MAIN LVL WALL FRAMING S-6 SECONDARY DWELLING MAIN LVL CLNG FRAMING S-7 SECONDARY DWELLING ROOF WALL FRAMING

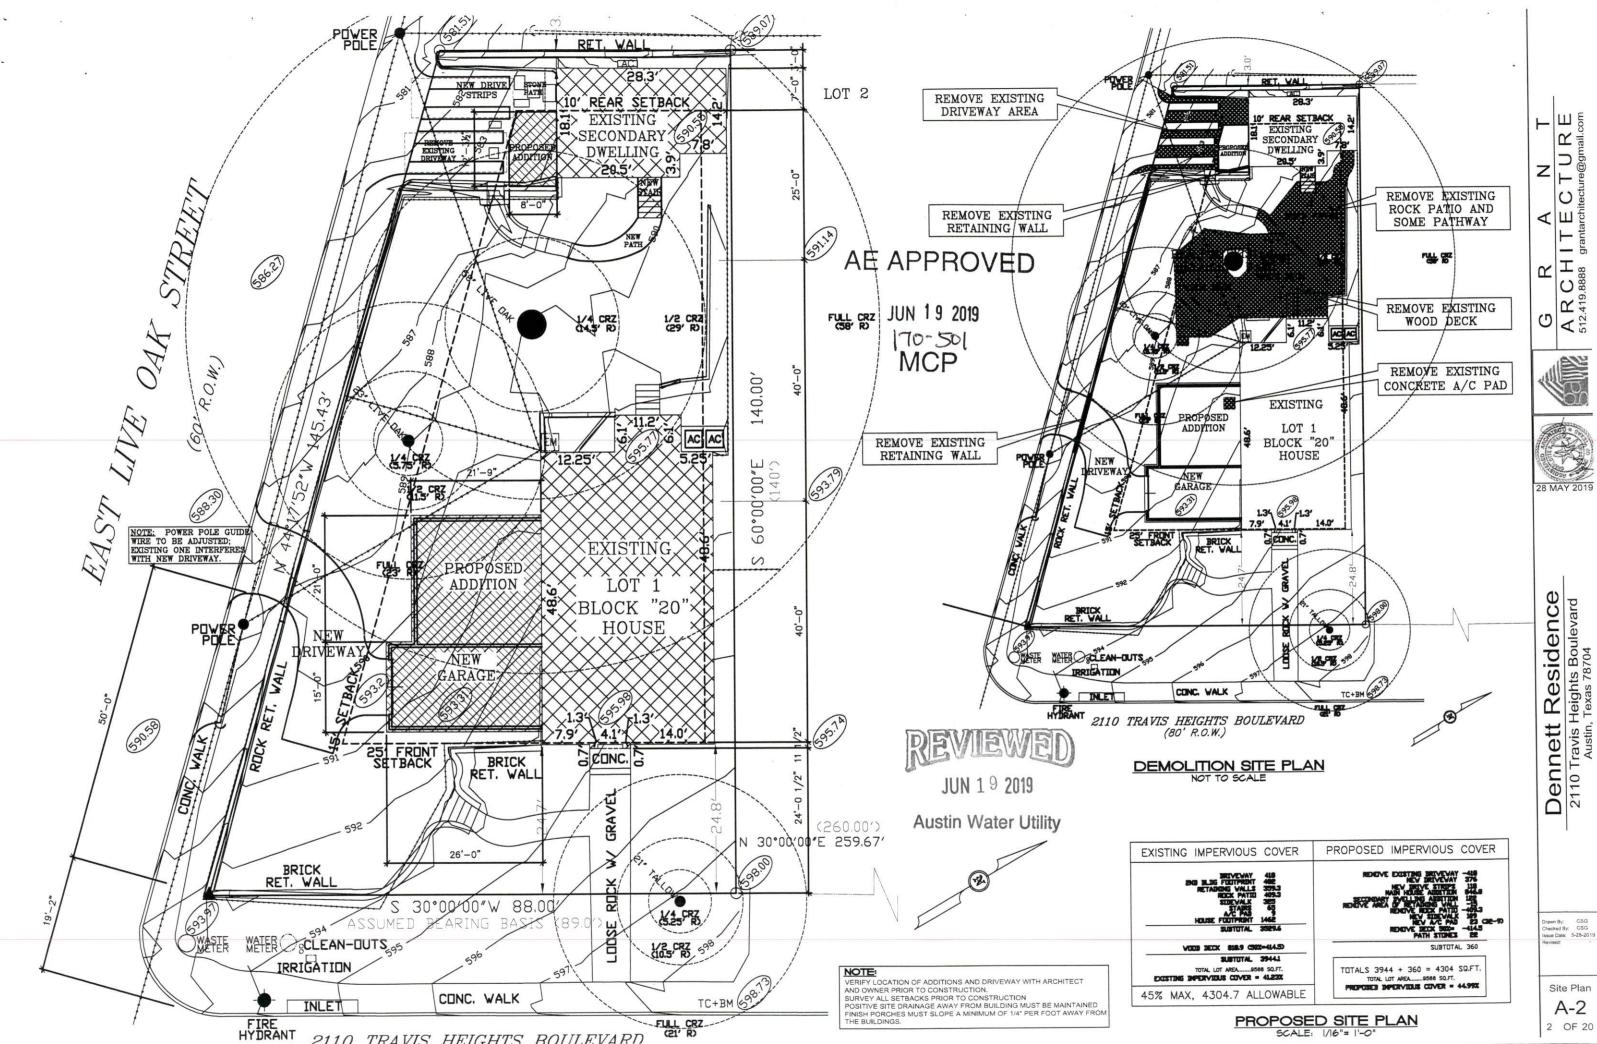

FULL CRZ

2110 TRAVIS HEIGHTS ROULEVARD

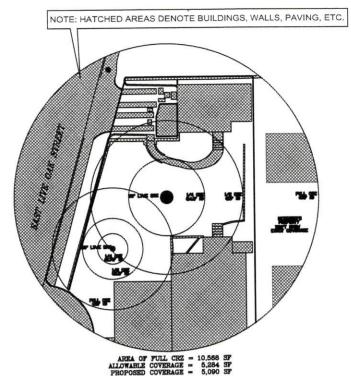

CRZ TREE COVERAGE DIAGRAM

NOTE: IF LOCATIONS NEED TO BE ADJUSTED THEN

NO ACCESS ROUTES, DUMPSTERS, MATERIAL STAGING, OR SPOILS PLACEMENT WITHIN ½ CRZ

NO PORTABLE TOILETS, PAINT AND CONCRETE WASHOUT AREAS WITHIN FULL CRZ.

WASTEWATER AND WATER LINES WILL NOT BE ALTERED DURING CONSTRUCTION UNLESS ABSOLUTELY NECESSARY.

VERIFY LOCATION OF ADDITIONS AND DRIVEWAY WITH ARCHITECT AND OWNER PRIOR TO CONSTRUCTION.

SURVEY ALL SETBACKS PRIOR TO CONSTRUCTION
POSITIVE SITE DRAINAGE AWAY FROM BUILDING MUST BE MAINTAINED
FINISH PORCHES MUST SLOPE A MINIMUM OF 1/4" PER FOOT AWAY FROM

Site Plan A-3

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TREE PROTECTION AND CONSTRUCTION STAGING SITE PLAN SCALE: 1/16"= 1'-0" OR AS NOTED

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28 MAY 2019

Residence

Dennett Residence 2110 Travis Heights Boulevard Austin, Texas 78704

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Dennett Residence 2110 Travis Heights Boulevard Austin, Texas 78704

Drawn By: CSG Checked By: CSG Issue Date: 5-28-2019 Revised: 6-17-2019

Ext Elevs A-5

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28 MAY 2019

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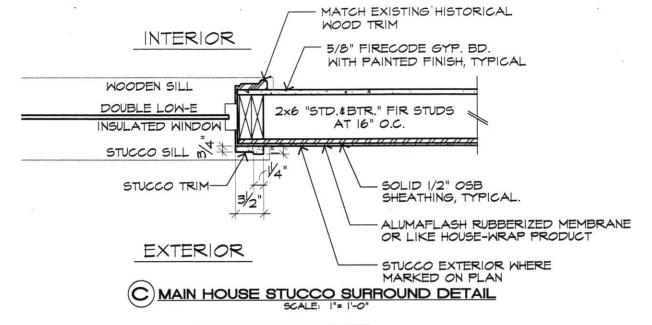
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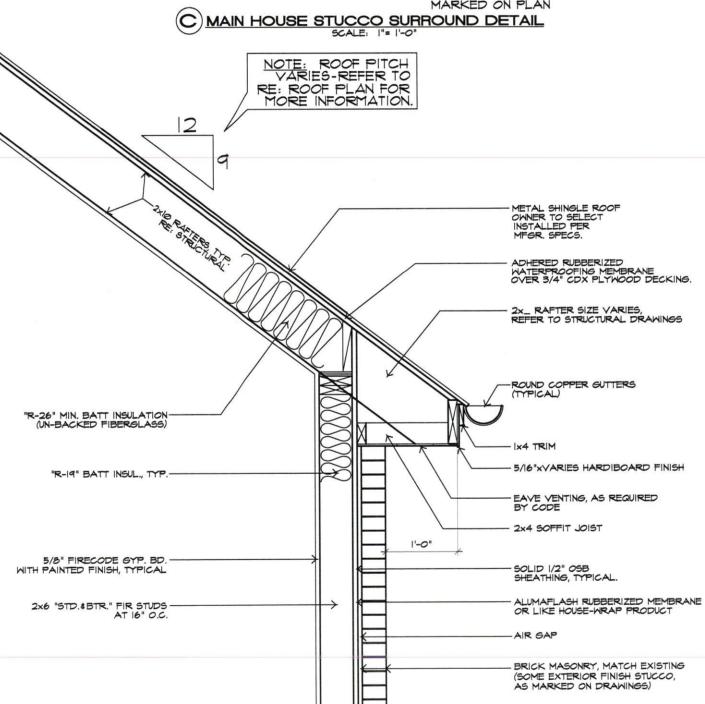
Drawn By: CSG Checked By: CSG Issue Date: 5-28-2019 Revised:

Ext Elevs A-11

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A-14 14 OF 20





(D) MAIN HOUSE TYPICAL EAVE DETAIL

## **GENERAL PROJECT NOTES:**

Concrete to be 3000 psi on compacted fill, 95% density with continuous waterproof underlayment. Slope finish concrete on exposed porch a minimum of 1/8" per foot; refer structural. Refer to structural for all foundation and fill details and information.

Wall framing to be "standard and better" 2x6 fir studs at 16" o.c. with 1/2" OSB sheathing. Secondary Dwelling exterior wall material to be Hardi-board product with Trim or Stucco with Trim as noted on elevation, verify with architect and owner.

Main house exterior wall material to be Stucco with Trim or Brick masonry finish as noted on elevation, verify with architect and owner.

Match new brick to existing brick finish.

Masonry ties and weep holes to be installed per architect's drawings and building codes.

Use Alumaflash rubberized membrane or similar house-wrap product Minimum of R-19 batts to be installed in wall cavity; R-26 to be installed in roof framing.

Refer to structural drawings for all roof framing details, member sizes and connection details. Secondary dwelling roof material to be asphalt shingle or metal roof shingles. Samples to be provided to owner, owner to select style and color, install per manufacturer specifications. New eave condition with 4x6 shaped outriggers and gutter/downspouts, refer to drawings. Use rubberized waterproofing membrane, Alumaflash or similar material, under roofing material Gutters and Downspouts to be installed per drawings, verify on site with architect

Main house roof to be replaced with diamond pattern metal roof tiles, install per manufacturer specifications. Provide samples of size, style and color to owner for approval. Match existing eave conditions. Eave vents required, contractor follow code requirements. Use rubberized waterproofing membrane, Alumaflash or similar material, under roofing material Gutters and Downspouts to be installed per drawings, verify on site with architect

Windows to be double-paned, insulated glass; owner to select material. Slope all exposed exterior horizontal surfaces to drain min. 1/8" per foot. Provide owner with window manufacturer and pricing options.

For interior finish-out verify with Owner; painted gypsum board walls and ceilings assumed. 1x4 painted trim at windows, typical. 1x8 painted wood base, typical at secondary dwelling. Match existing trim and base in Main House unless otherwise directed by owner.


Painted doors with divided lights as marked on plans, typical. 2 panel painted interior doors. Floors as noted on drawings. Assume painted cabinetry, typical - verify with Owner.

For electrical and lighting refer to drawings, provide walk-through prior to sheetrock For mechanical and plumbing coordinate with subcontractors and architect on-site. BBQ, Ranges, Dryers and Fireplaces require venting requirements per code and manufacturer's specifications--.

coordinate with Architect on site. Contractor is responsible to uphold all code requirements.

Maintain positive drainage away from structure. Coordinate drainage with Architect on-site Contractor is to coordinate with Owner and Architect regarding site landscape and lighting during

Contractor is to provide shop drawings for all cabinetry and cut stone work prior to installation. Contractor is responsible for meeting all building safety and local building codes.

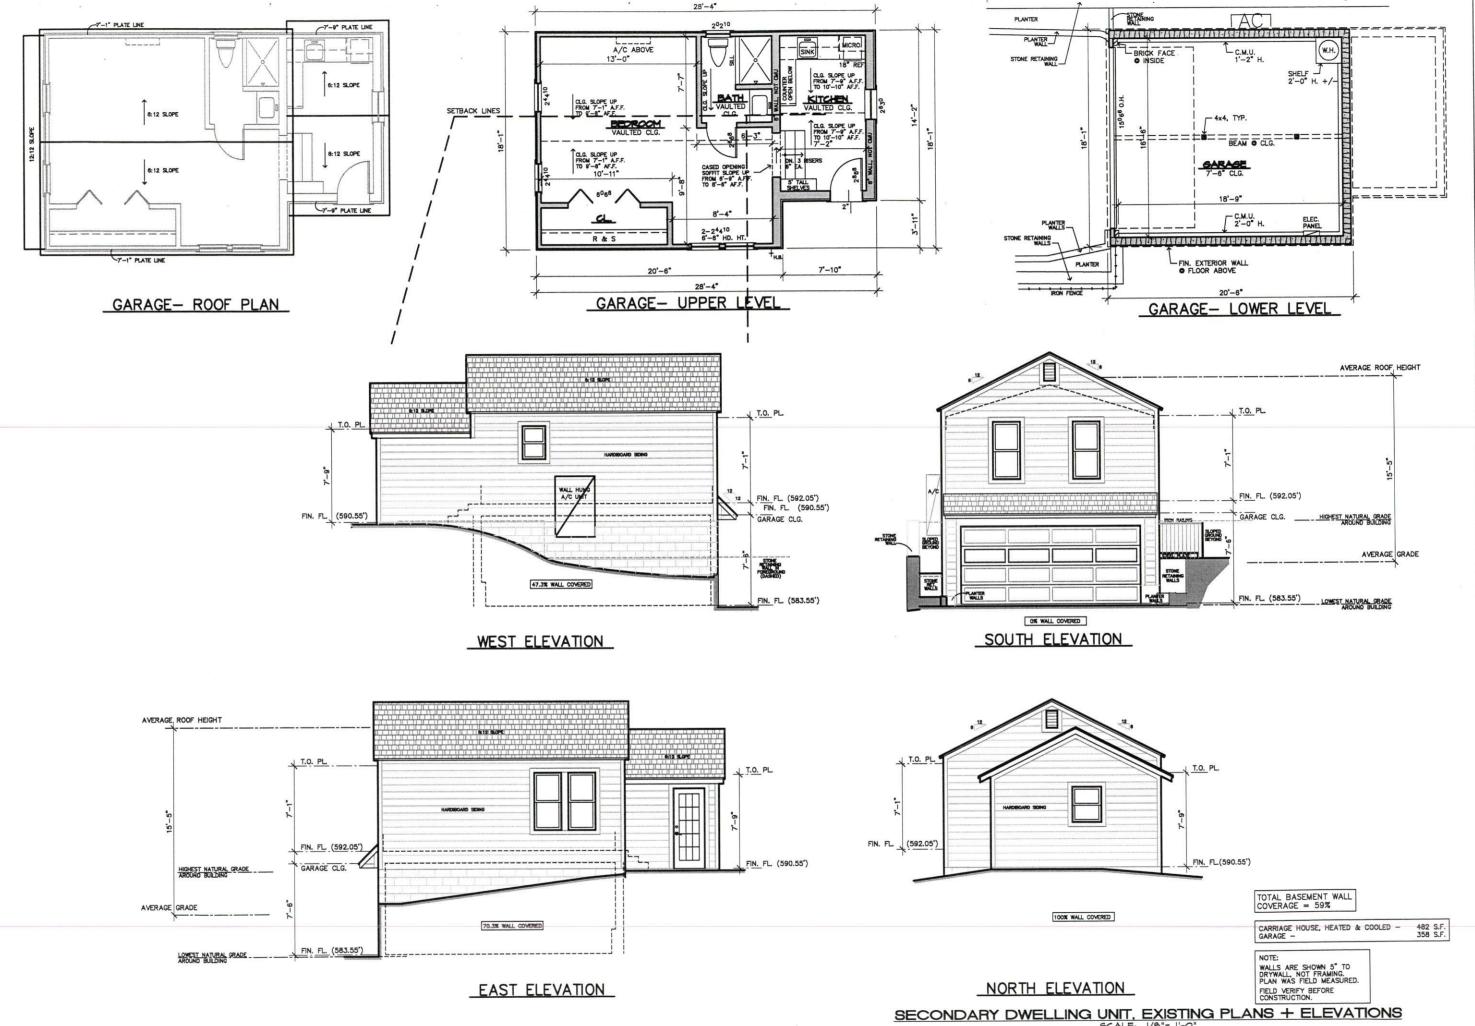

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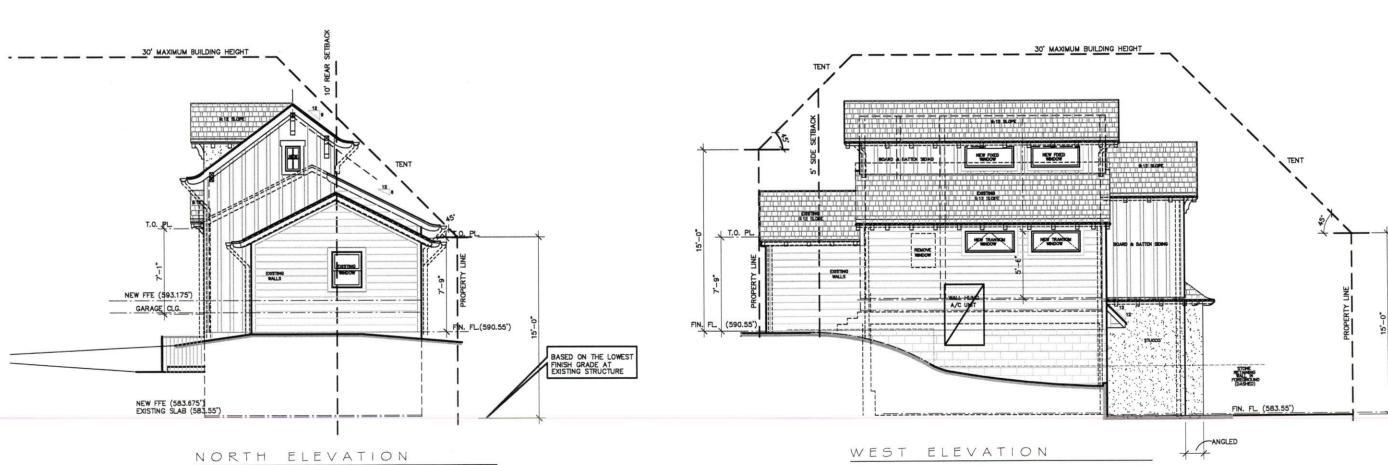
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Plans/Elevs A-15

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Elevations A-18 18 OF 20

30' MAXIMUM BUILDING HEIGHT AVERAGE, ROOF HEIGHT W12 SLOPE BASED ON THE LOWEST FINISH GRADE AT EXISTING STRUCTURE DESTRICT 6:12 S.OFE EXISTING NON-COMPYING WALLS AND ROOF TO REMAIN. NEW FFE (593.175') GARAGE CLG. 7'-4" HEAD HEIGHT HIGHEST NATURAL GRADE AROUND BUILDING AVERAGE GRADE STONE RETARNING WALLS NEW FFE (583.675') EXISTING SLAB (583.55'), STORE LOWEST NATURAL GRADE WALL AT AN ANGLE EAST ELEVATION SOUTH ELEVATION



30' MAX HEIGHT

