

## GENERAL NOTES | PLOT PLAN

- Do not scale the drawings. If a specific dimension is not given, contact designtrait for clarification.
- Dimensions are to face of frame or centerline of frame as noted.
- . Keynotes located on this sheet are for this sheet only.
- 4. Frame sample and all hardware to be approved by designtrait. 5. Provide submittals & shop drawings showing number of windows, locations, of
- tempered glazing, etc. 6. Tree locations are approximate.
- 7. Provide french drain to divert water away from house as required.

# KEYNOTES | PLOT PLAN #

- Existin planter
- Existing water meter. 3. Existing retaining wall, as required by grading.
- Demo tree. Proposed material staging area. Dumpster and spoils placement cannot be located within the 1/2 CRZ of any protected trees. Use existing driveway as an
- 6. Assumed location of gas and wastewater lines. Verify locations prior to construction. Tie new utilities into existing lines. New lines should be routed
- around CRZ of existing trees.

  7. Area designated for portable toilet and concrete washout. Cannot be within the
- full CRZ of any protected tree.
- 8. Protect trees on site as required in the Environmental Criteria Manual section 3.5.2. Do not cut or fill greater than 4" in the 1/2 CRZ of protected trees. No impact allowed within the 1/4 CRZ of protected trees.
- 9. Tree protection zone. 10. Concrete driveway paths w/ gravel or crushed granite between. In place of
- existing driveway.
- 11. Concrete path. 12. Existing curb.
- 13. Existing driveway apron.14. Bench mark, refer to survey.

## LEGEND | PLOT PLAN

|       | WOOD FENCE   | $\triangle$  | BENCH MARK      |
|-------|--------------|--------------|-----------------|
| — ų — | UTILITY LINE | 0            | PIPE FND.       |
| AC    | A/C UNIT     |              | UTILITY POLE    |
| G     | GAS METER    | _ <b>M</b> _ | ELECETRIC METER |
|       |              |              |                 |

Tree protection must remain in place through the landscaping and sprinklers need to be placed to stay out of the 1/4 CRZ with a preferred drip system in the 1/2 / full CRZ if possible.

Tree protection fencing is required for all trees within the limits of construction. Project designers are required to show the specific locations of tree protection fencing on the grading and tree protection plan. Fencing should be indicated to protect the entire Critical Root Zone (CRZ) area or as much of the CRZ as is practical. Fencing is required to be chain-link mesh at a minimum height of five feet. When the tree protection fencing cannot incorporate the entire 1/2 Critical Root Zone, an eight inch layer of mulch within the entire available root zone area is required for all trees which have any disturbance indicated within any portion of the Critical Root Zone.


#345 11" Hackberry

Fire, gas and water service lanes to be coordinated with general contractor based on site conditions.

Avoid the 1/2 Critical Root Zones of Protected Trees with any newly proposed work. If trenching within the 1/2 CRZ of Protected Trees cannot be avoided, the trenches will have to be air spaded by a Certified Arborist for the 30" to avoid damaging roots 1.5"+ in diameter and the paid receipt for the work will be required by the Final Tree Inspector.

## The design illustrated in these documents is furnished by the architect under a limited scope services agreement with the Owner and are therefore provided as a "builder's set" for general intent only. All products and the detailing of their installation, including flashing, underlayments, and weather resistive barriors, should be installed in strict compliance with manufacturer's recommendations and in compliance with all applicable codes as mandated by all governing jurisdictions.

| TREE LEGEND        | NOTE      | KEY PLOT PLAN         |
|--------------------|-----------|-----------------------|
| #219 24" Ash       | Protected |                       |
| #220 14" Elm       |           | FIRST FLOOR EXISTING  |
| #224 8" Live Oak   |           |                       |
| #236 13" Elm       | Demo      | FIRST FLOOR ADDITION  |
| #292 10" Hackberry | Removed   | SECOND FLOOR ADDITION |
| #293 8" Pecan      | Removed   | SECOND FLOOR ADDITION |
| #294 11" Hackberry | Removed   | ROOF                  |
| #295 7" Hackberry  | Removed   |                       |
| #296 15" Bois Arc  |           | COVERED AREA          |
| #297 Bois Arc      |           |                       |
| #298 18" Elm       |           | PROTECTED AREA        |
| #311 11" Pecan     |           |                       |
| #319 11" Hackberry | Removed   | STAGING AREA          |
| #340 12" Hackberry |           |                       |
| #342 13" Hackberry |           |                       |

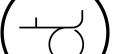



 $\bigcirc$ 

09-27-19


Addition 906 Maufrais St Austin, TX 78703 ais Maufr

SHEET TITLE PLOT PLAN

CAUTION: DO NOT SCALE DRAWINGS THESE DRAWINGS ARE THE PROPERTY OF THE ARCHITECT AND MAY ONLY BE USED IN CONJUNCTION WITH THIS PROJECT



- Do not scale the drawings. If a specific dimension is not given, contact Designtrait for clarification.
   Dimensions are to face of frame or centerline of frame as noted.
   Keynotes located on this sheet are for this sheet only.
   Window and door types indicate rough sizes only. GC shall field verify the appropriate glazing and leaf sizes in the field prior to ordering. For any questions contact Designtrait.
   Verify final finishes with owner.

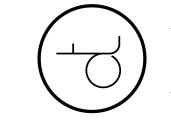

 $\bigcirc$ 

## KEYNOTES | ROOF PLAN

- Metal roofing panel.
   4 1/2" Prefinish metal gutter.
   Dashed line of framing below.
   Dased line of column below.
   Low pitch metal roof.



09-27-19

rais Addition 906 Maufrais St Austin, TX 78703 Maufr

SHEET TITLE ROOF PLAN

CAUTION: DO NOT SCALE DRAWINGS
THESE DRAWINGS ARE THE PROPERTY OF
THE ARCHITECT AND MAY ONLY BE USED IN
CONJUNCTION WITH THIS PROJECT

ROOF PLAN | EXISTING/ ADDITION

Scale: 1/4" = 1'-0" 24" x 36"
1/16" = 1'-0" 11" x 17"


### GENERAL NOTES | ELEVATIONS

- Do not scale the drawings. If a specific dimension is not given, contact designtrait for clarification.
   Keynotes located on this sheet are for this sheet only.
   Frame sample and all hardware to be approved by designtrait.
   Provide submittals & shop drawings showing number of windows, locations, of tempered glazing, etc.

## KEYNOTES | ELEVATIONS

- 1. Downspout, coordinate size accordingly w/ roof area for efficient
- drainage.
  2. Stl. Col. Refer to structural.
  3. Lap siding to match existing.
  4. Dashed line of ceiling.
  5. Dashed line of stairs.
- Dashed line of stairs.
   Adjust grading to drain away from structure.
   Decorative gusset, match profile of existing, typ.
   Trim, match to existing.
   Existing lap siding
   Existing crawl space skirt.
   Skirt to match existing.

- 11. Skirt to march existing.
  12. Existing trim.
  13. Match trim similar to existing attic vent.
  14. Rain gutter, typ.
  15. Existing crawl space access.
  16. Existing column

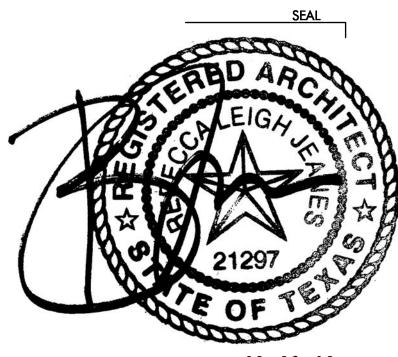

09-27-19


 $\bigcirc$ 

Addition 906 Maufrais St Austin, TX 78703 ais Maufr

SHEET TITLE


**ELEVATIONS** 

CAUTION: DO NOT SCALE DRAWINGS THESE DRAWINGS ARE THE PROPERTY OF THE ARCHITECT AND MAY ONLY BE USED IN CONJUNCTION WITH THIS PROJECT

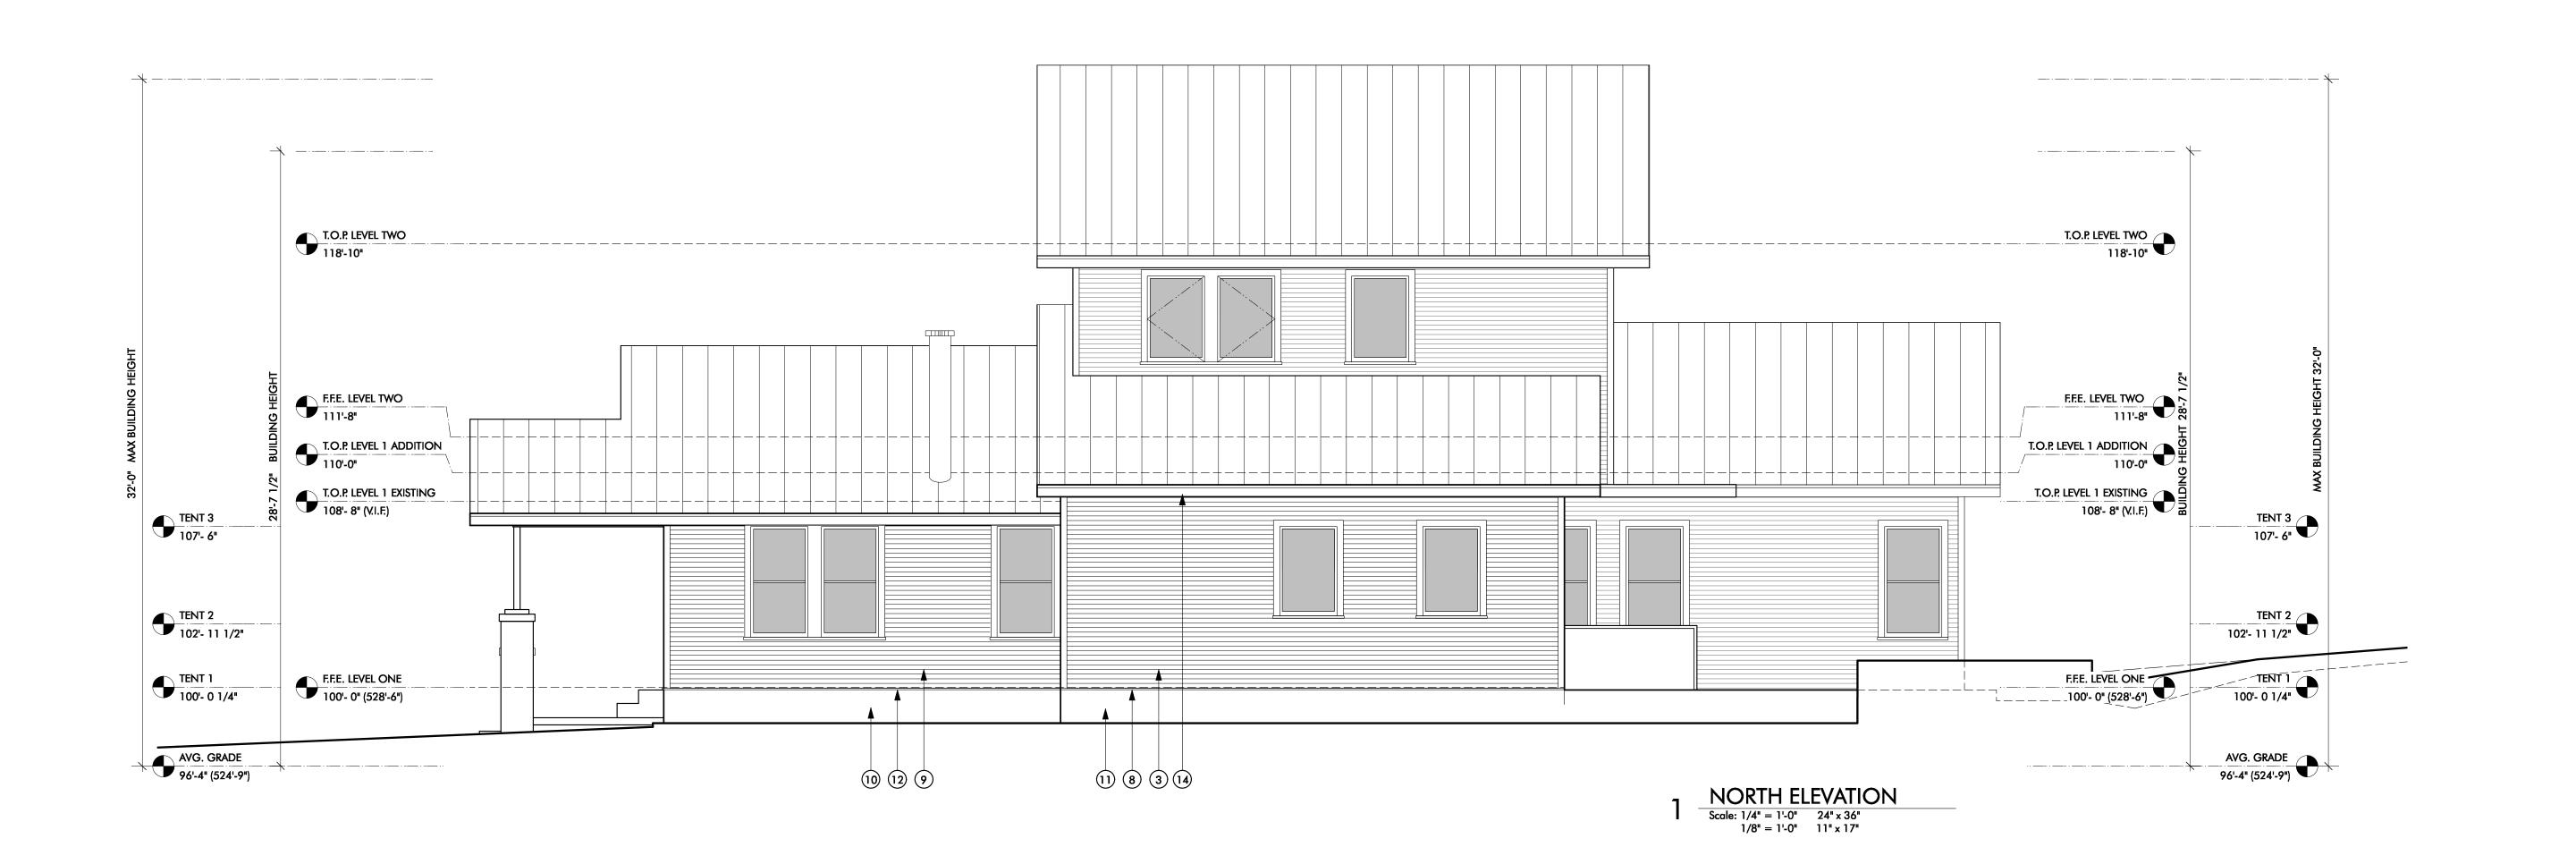

### GENERAL NOTES | ELEVATIONS

- Do not scale the drawings. If a specific dimension is not given, contact designtrait for clarification.
   Keynotes located on this sheet are for this sheet only.
   Frame sample and all hardware to be approved by designtrait.
   Provide submittals & shop drawings showing number of windows, locations, of tempered glazing, etc.

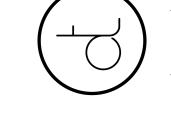

 $\bigcirc$ 

KEYNOTES | ELEVATIONS

- 1. Downspout, coordinate size accordingly w/ roof area for efficient
- drainage.
  2. Stl. Col. Refer to structural.
  3. Lap siding to match existing.
  4. Dashed line of ceiling.
  5. Dashed line of stairs.
- Dashed line of stairs.
   Adjust grading to drain away from structure.
   Decorative gusset, match profile of existing, typ.
   Trim, match to existing.
   Existing lap siding
   Existing crawl space skirt.
   Skirt to match existing.
   Existing trim.
   Match trim similar to existing attic vent.
   Rain gutter, typ.
   Existing crawl space access.
   Existing column



09-27-19

Addition 906 Maufrais St Austin, TX 78703 ais Maufr

SHEET TITLE
ELEVATIONS

CAUTION: DO NOT SCALE DRAWINGS
THESE DRAWINGS ARE THE PROPERTY OF
THE ARCHITECT AND MAY ONLY BE USED IN
CONJUNCTION WITH THIS PROJECT

