#### **LOT INFORMATION**

TOTAL LOT AREA: 6,759.02 SF

ZONING: SF-?

MAXIMUM ALLOWED MAXIMUM ALLOWED BUILDING COVERAGE @ 40% = 2,703.61 SF IMPERVIOUS COVERAGE

@ 45% = 3,041.56 SF

# CITY of AUSTIN AREA CALCULATIONS

Coa area name	EXISTING	NEW	TOTAL
a) 1ST FLOOR CONDITIONED AREA	0.00 SF	1,255.71 SF	1,255.71 SF
b) 2ND FLOOR CONDITIONED AREA	0.00 SF	1,225.88 SF	1,225.88 SF
c) 3RD FLOOR CONDITIONED AREA	0.00 SF	95.15 SF	95.15 SF
d) BASEMENT	0.00 SF	0.00 SF	0.00 SF
e) ATTACHED COVERED PARKING	0.00 SF	0.00 SF	0.00 SF
f) DETACHED COVERED PARKING	0.00 SF	400.00 SF	400.00 SF
g) COVERED WOOD DECKS	0.00 SF	0.00 SF	0.00 SF
h) COVERED PATIO	0.00 SF	0.00 SF	0.00 SF
i) COVERED PORCH	0.00 SF	604.00 SF	604.00 SF
j) BALCONY	0.00 SF	0.00 SF	0.00 SF
k) OTHER:	0.00 SF	0.00 SF	0.00 SF
TOTAL BUILDING AREA	0.00 SF	3,580.74 SF	3,580.74 SI
TOTAL BUILDING COVERAGE	0.00 SF	2,259.71 SF	2,259.71 SE
I) DRIVEWAY	0.00 SF	187.50 SF	187.50 SF
m) SIDEWALKS	0.00 SF	75.70 SF	75.70 SF
n) UNCOVERED PATIO	0.00 SF	0.00 SF	0.00 SF
o) UNCOVERED WOOD DECKS (COUNTED AT 50%)	0.00 SF	0.00 SF	0.00 SF
p) AC PADS AND OTHER CONCRETE FLATWORK	0.00 SF	62.22 SF	62.22 SF
q) other (pool coping, retaining walls)	0.00 SF	173.00 SF	173.00 SF
r) POOL	0.00 SF	0.00 SF	0.00 S
s) SPA	0.00 SF	0.00 SF	0.00 S
TOTAL SITE IMPERVIOUS COVERAGE	0.00 SF	2,758.13 SF	2,758.13 SF

TOTAL PROJECT BUILDING COVERAGE @ 2,259.71 SF = 33.43%

TOTAL PROJECT IMPERVIOUS COVERAGE @ 2,758.13 SF = 40.81%

#### **LOT 12** S 60° 23' 00" E 26'-4 1/2" SETBACK TENT 2 130.08 SETBACK PORTION 2 SETBACK TENT 1 HIGHEST ADJ. GRADE RETAINING WALL PER BLDR. SETBACK TENT 3 SETBACK PORTION 3 HIGHEST ADJ. GRADE SETBACK PORTION 1 → 548.05' → → SWALE → → → /= 548.375<sup>'</sup> SWALE HIGHEST ADJ. GRADE = 548.22' HIGHEST ADJ. NATURAL GRADE POOL B¥ = 548.07' DRAINAGE T752 HIGHEST ADJ. **CUSTOM HOME** NATURAL GRADE F.F.E.= 547.67' = 547.56' CONCRETE WALKWAY CONCRETE <u>CARPORT</u> LQT 13 DRIVEWAY CANTILEVER SLAB @ 1/2 CRZ | DRAINAGE NATURAL GRADE = 546.56' T755( DRAINAGE 5' SIDE SETBACK NATURAL GRADE = 545.73' O T753 N 60° 28' 07" W/ T754 **○**T757 130.13' 40'-0'' SETBACK PORTION 3 SETBACK PORTION 2 SETBACK PORTIÓN 1 LOT 15

1 SITE PLAN
1" = 10'-0"

## CITY of AUSTIN FAR CALCULATIONS

MAXIMUM ALLOWABLE @ 40% = 2,703.61 SF FLOOR TO AREA RATIO (FAR)

	(,			
COA FAR AREAS	existing	NEW	EXEMPTION	TOTAL
a) 1st FLOOR	0.00 SF	1,255.71 SF	0.00 SF	1,255.71
b) 2nd FLOOR	0.00 SF	1,225.88 SF	0.00 SF	1,225.88
c) 3rd FLOOR	0.00 SF	95.15 SF	0.00 SF	95.15
d) AREA W/ CEILINGS > 15'	0.00 SF	12.36 SF	0.00 SF	12.36
e) GROUND FLOOR PORCH	0.00 SF	604.00 SF	-604.00 SF	0.00 \$
f) BASEMENT	0.00 SF	0.00 SF	0.00 SF	0.00 \$
g) ATTIC	0.00 SF	454.03 SF	-454.03 SF	0.00
h) ATTACHED GARAGE	0.00 SF	0.00 SF	0.00 SF	0.00
i) DETACHED GARAGE	0.00 SF	0.00 SF	0.00 SF	0.00
j) ATTACHED CARPORT	0.00 SF	0.00 SF	0.00 SF	0.00
k) DETACHED CARPORT	0.00 SF	400.00 SF	-400.00 SF	0.00
<ol> <li>ACCESSORY BUILDING(S)</li> </ol>	0.00 SF	291.65 SF	-291.65 SF	0.00
TOTAL GROSS FLOOR AREA	0.00 SF	4,338.78 SF	-1,749.68 SF	2,589.10


TOTAL PROJECT @ 2,589.10 SF = 38.31% FLOOR TO AREA RATIO (FAR)

# **ZONING: SF-3**

#### LEGAL DESCRIPTION

1 104 MAUFRAIS STREET LOT 13 BLK 4 OLT 4 DIV Z SHELLEY HEIGHTS 2 AUSTIN, TEXAS 78703 TRAVIS COUNTY

## TREE LEGEND

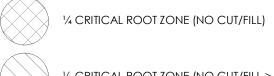

1/2 CRITICAL ROOT ZONE (NO CUT/FILL > 4")

DRIP ZONE

## TREE LIST

	1181	L LIJ	<u>-</u>
DEMO	TAG NO.	SIZE	DESCRIPTION
	T755	29"	ELM
	T754	6''	HACKBERRY
MOVE	<del>- 1756</del>	8''	<del></del>
	T757	18"	OAK
MOVE	<del>- 1758</del>	9''	HACKBERRY -
MOVE	<del>- 1759</del>	6''	HACKBERRY
	T753	10"	HACKBERRY
	T752	12"	PECAN

# **GENERAL SITE NOTES**

- BUILDER TO RESCULPTURE TOPO/FINISH GRADE TO PROVIDE PROPER DRAINAGE OF SURFACE WATER AWAY FROM BUILDING AS REQ'D.
- 2. FINAL LOCATION OF PROPOSED RESIDENCE TO BE DETERMINED BY BUILDER.
- 3. EXPOSED FOUNDATION TO BE MINIMUM OF 8" AND A MAXIMUM OF 18" ABOVE FINISHED GRADE OR PER SUBDIVISION REQUIREMENTS. UNDERPIN ALL EXPOSED FOUNDATIONS.
- 4. THERE ARE NO STORM SEWER INLETS WITHIN THE LOT FRONTAGE OR 10'-0" BEYOND THE SIDE PROPERTY LINES.
- 5. UTILITY LINE LOCATIONS ARE APPROXIMATES- GENERAL CONTRACTOR TO FIELD VERIFY FOR EXACT LOCATIONS.
- 6. VERIFY METER AND UTILITY SERVICE LOCATIONS PRIOR TO installation.
- 7. EROSION CONTROL BARRIERS TO BE INSTALLED PRIOR TO COMMENCEMENT OF CONSTRUCTION.
- 8. STABILIZED TEMPORARY CONSTRUCTION DRIVEWAY TO BE IN PLACE PRIOR TO COMMENCEMENT OF CONSTRUCTION.
- 9. CONFIRM ALL DRIVEWAY, WALKWAY AND PVC LAYOUTS/LOCATIONS PRIOR TO COMMENCING WORK.
- 10. PROVIDE CONTROL AND EXPANSION JOINTS AS REQUIRED ON CONCRETE DRIVES, WALKS AND PATIOS.
- 11. ALL EXTERIOR HVAC EQUIPMENT TO BE SCREENED PER CITY REQUIREMENTS, DEED RESTRICTIONS OF SUBDIVISION OR NEIGHBORHOOD ASSOCIATION.
- 12. GARBAGE RECEPTACLES TO BE STORED IN GARAGE OR

SCREENED FROM VIEW AND ANIMAL ACCESS.

- 13. LOCATION OF MAILBOX AND EXTERIOR DRIVEWAY LIGHT(S) TO BE VERIFIED PRIOR TO INSTALLATION.
- 14. ALL CONSTRUCTION MATERIALS AND WASTE TO BE STORED ON SITE DURING CONSTRUCTION.
- 15. LANDSCAPE PLANS TO BE PROVIDED BY OTHERS AND PERMIT
- FOR SAME TO BE OBTAINED SEPARATELY FROM THESE PLANS. 16. NO EXISTING TREES TO BE REMOVED OR DISTURBED WITHOUT
- OWNER APPROVAL. 17. ALL STUMPS AND ROOTS SHALL BE REMOVED FROM THE SOIL TO A DEPTH OF 12" BELOW THE SURFACE OF THE GROUND IN THE AREA OF THE BUILDING.
- 18. CONTRACTOR SHALL CLEAN UP AREAS AFFECTED BY DAILY WORK AND REMOVE DEBRIS AND MATERIALS FROM THE SITE UPON COMPLETION OF THE WORK.



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THESE DESIGNS/ DRAWINGS ARE THE SOLE PROPERTY OF CORNERSTONE ARCHITECTS AND MAY NOT BE REPRODUCED IN ANY FORM, BY PREVIOUS WRITTEN PERMISSION.

NOT FOR REGULATORY APPROVAL, PERMITTING, OR CONSTRUCTION. THIS DOCUMENT IS RELEASED FOR THE PURPOSE OF INTERIM REVIEW UNDER THE AUTHORITY OF ARCHITECT:

RODNEY PALMER

/RH MAUFRAIS SPEC

**A**1 1 of 6

SRK, MD

PROJECT NO: DRAWN BY: 11/18/2019 CHECKED BY: PROJECT MGR:

#### **GENERAL PROJECT NOTES**

MATERIALS BEING ORDERED.

- 1. THESE CONSTRUCTION DOCUMENTS ARE INTENDED TO MEET ALL APPLICABLE CODES AND ORDINANCES. CONTRACTOR TO COMPLY WITH ALL LOCAL CODES, ORDINANCES AND DEED RESTRICTIONS. CONTRACTOR SHALL ALSO REQUIRE ALL
- SUBCONTRACTORS TO COMPLY WITH THESE REGULATIONS. ANY DISCREPANCIES IN CONSTRUCTION DOCUMENTS OR NONCOMPLIANCE TO BE BROUGHT TO THE ATTENTION OF THE ARCHITECT PRIOR TO ANY WORK BEING PERFORMED OR
- 3. BUILDER ACCEPTS FULL RESPONSIBILITY FOR CHECKING PLANS TO ASSURE CONFORMITY TO CURRENT LOCAL BUILDING CODES. SHOULD ANY CHANGES BE MADE TO THESE PLANS BY BUILDER OR HIS REPRESENTATIVES WITHOUT CONTACTING THE ARCHITECT, THE BUILDER WILL ACCEPT FULL LIABILITY FOR AMENDED PLANS.
- 4. ARCHITECTS ARE GOVERNED BY THE TEXAS BOARD OF ARCHITECTURAL EXAMINERS, (512)458-1363.
- 5. WHILE THESE DRAWINGS ARE INTENDED TO SHOW SAME, THE ARCHITECT IS NOT RESPONSIBLE FOR GOVERNING AUTHORITY INTERPRETATIONS WHERE THOSE INTERPRETATIONS CONFLICT WITH THESE DRAWINGS &/OR SPECS.
- 6. PORTIONS OF THIS WORK MAY NOT HAVE BEEN DRAWN BY A REGISTERED ARCHITECT.
- 7. THESE DRAWINGS/SPECS ARE INSTRUMENTS OF SERVICE AND SHALL REMAIN THE PROPERTY OF THE ARCHITECT WHETHER THE PROJECT IS EXECUTED OR NOT. THESE DRAWINGS SHALL NOT BE USED BY THE CLIENT FOR OTHER PROJECTS, FOR ADDITIONS TO THIS PROJECT, OR FOR COMPLETION OF THIS PROJECT BY OTHERS WITHOUT PERMISSION OF THIS ARCHITECT.
- 8. THESE DOCUMENTS DO NOT SHOW TYPICAL DETAILING &/OR WATERPROOFING.

- 9. WHEN THESE DOCUMENTS DO NOT SPECIFY ACTUAL PRODUCTS, MATERIALS OR SYSTEMS. CONTRACTOR ACCEPTS FULL RESPONSIBILITY FOR APPROPRIATE AND PROPER DETAILING FOR AND BETWEEN ALL ACTUAL PRODUCTS, MATERIALS AND SYSTEMS SELECTED WHEN INSTALLED.
- 10. ALL COMPONENTS, MATERIALS, SYSTEMS AND FINISHES TO BE CONSTRUCTED AND INSTALLED PER MANUFACTURER'S RECOMMENDATIONS, CODE REQUIREMENTS AND REGULATED BUILDING PRACTICES. IF CONFLICTS ARRISE BEWTEEN ARCHITECTURAL PLANS OR SPECIFICATIONS AND MANUFACTURER'S SPECIFICATIONS CONTRACTOR IS TO CONTACT ARCHITECT PRIOR TO PURCHASE AND OR
- 11. ARCHITECT IS NOT RESPONSIBLE FOR MEANS AND METHODS OF CONSTRUCTION WHICH ARE NOT DETAILED IN THESE CONSTRUCTION DOCUMENTS. CONTRACTOR WILL BE RESPONSIBLE FOR ALL ASPECTS OF CONSTRUCTION INCLUDING BUT NOT LIMITED TO ALL WATER AND DAMP PROOFING, LOAD CONNECTIONS AND MECHANIC,

INSTALLATION OF MATERIALS FOR DIRECTION.

ELECTRICAL AND PLUMBING SYSTEMS.

- 12. ALL MATERIALS AND LABOR TO BE GUARANTEED FOR ONE YEAR FROM THE DATE OF FINAL PAYMENT, IN ADDITION TO ALL WARRANTIES THAT ARE STANDARD TO THE INDUSTRY. CONTRACTOR TO PROVIDE (SUPPLY AND INSTALL) ALL EQUIPMENT, LABOR SERVICES, AND MATERIALS REQUIRED FOR THE COMPLETE APPROVED INSTALLATION OF THE SYSTEMS
- 13. THESE DRAWINGS DO NOT INCLUDE NECESSARY COMPONENTS FOR CONSTRUCTION SAFETY. THE CONTRACTOR IS RESPONSIBLE FOR INITIATING, MAINTAINING AND SUPERVISING ALL SAFETY PRECAUTIONS AND PROGRAMS NECESSARY FOR COMPLETION OF WORK.

- 14. ALL DIMENSIONS TO BE VERIFIED IN THE FIELD. REPORT ANY AND ALL DISCREPANCIES, ERRORS OR OMISSIONS TO THE ARCHITECT PRIOR TO COMMENCING WORK AND/OR ORDERING MATERIALS. MINOR DEVIATIONS, SUBJECT TO CONSTRUCTION REQUIREMENTS AND FIELD CONDITIONS, CAN
- 15. UNDER NO CIRCUMSTANCES SHALL ANY DIMENSION BE SCALED FROM THESE DRAWINGS. ANY CRUCIAL DIMENSION NOT GIVEN SHALL BE BROUGHT TO THE ATTENTION OF THE
- 16. ALL DIMENSIONS SHOWN ON PLAN ARE TO THE STRUCTURAL FACE OF WALL AND DO NOT INCLUDE WALL FINISHES OR
- 17. THE CONTRACTOR SHALL GIVE NOTICE TO ALL AUTHORIZED INSPECTORS, SUPERINTENDENTS OR PERSONS IN CHARGE OF UTILITIES AFFECTED BY HIS OPERATIONS PRIOR TO COMMENCING WORK.
- 18. THE CONTRACTOR IS TO FILE FOR, AND SECURE ALL APPROVALS, PERMITS, TESTS, INSPECTIONS AND CERTIFICATES OF COMPLIANCE AS REQUIRED. THE CONTRACTOR IS RESPONSIBLE FOR ASSURING THAT ALL PERMITS NECESSARY TO LEGALLY PERFORM THE WORK HAVE BEEN OBTAINED PRIOR TO COMMENCING CONSTRUCTION.
- 19. VERIFY EXISTING CONDITIONS AND DIMENSIONS PRIOR TO CONSTRUCTION START.
- 20. IN CASE OF DISCREPANCIES OR CONFLICTS ON THE DRAWINGS AND SPECIFICATIONS, OR BETWEEN THE DRAWINGS AND THE EXISTING CONDITIONS, CONTACT THE ARCHITECT OR OWNER BEFORE PROCEEDING WITH THE WORK.
- 21. CONTRACTOR SHALL CLEAN UP CONSTRUCTION AREAS AFFECTED BY DAILY WORK AND MAINTAIN A CLEAN AND ORDERLY WORK AREA AT ALL TIMES. REMOVE MATERIALS TO APPROVED DUMP SITES ONLY.

POOL BY OTHER

9'-9"

COMPRESSOR

20'-0"

FLR: CONC. CLG:10'-0"

8'-6"

## **SQUARE FOOTAGE CALCULATIONS**

NAME	AREA
MAIN HEATED	1,243.51 SF
UPPER HEATED	1,212.33 SF
HEATED	2,455.84 SF
ATTIC	454.03 SF
BONUS	291.65 SF
CARPORT	400.00 SF
COV'D. ENTRY	135.55 SF
COV'D. OUTDOOR LIVING	383.62 SF
COV'D. PORCH	84.83 SF
MASONRY	25.75 SF
UNHEATED	1,775.43 SF
TOTAL COVERED AREA	4,231.27 SF

\*ALL WINDOWS WITH MATCHING PREFIX TO BE MULLED

	MAIN FLOOR WINDOW SCHEDULE						
	WIDTH	HEIGHT	STYLE	Н. Н.	TEMP.	EGRESS	COMMENTS
101.1	2'-4"	6'-0''	FX	9'-0"			
101.2	4'-6''	6'-0''	FX	9'-0"			
101.3	2'-4"	6'-0''	FX	9'-0"			
102	2'-0''	4'-0''	FX	10'-0"			MTL.
103	2'-6"	10'-0"	FXDL	10'-0"	TEMP		
104	5'-5"	10'-0"	FXDL	10'-0"	TEMP		
105	5'-5"	10'-0"	FXDL	10'-0"	TEMP		
203	2'-6"	5'-6"	FX	21'-2 1/4"	TEMP		A.F.F. MAIN FLR.
204	3'-0"	8'-0"	FX	17'-2 1/4"			A.F.F. MAIN FLR.
302	6'-0''	2'-6"	FX	26'-4 1/2"			A.F.F. MAIN FLR.

## **GENERAL PLAN NOTES**


- 1. THESE DOCUMENTS REFLECT NOMINAL WINDOW SIZES. WINDOW MANUFACTURER TO USE STANDARD SIZES UNLESS NOTED OTHERWISE.
- 2. ALL WINDOWS WILL BE DIMENSIONED TO CENTER LINE UNLESS OTHERWISE NOTED. GLASS SIZE PER MFR. SPECS.
- 3. WINDOW MANUFACTURER & BUILDER TO VERIFY EGRESSABLE WINDOWS INSTALLED WHERE REQUIRED BY CODE.
- 4. ALL WINDOWS WITHIN 24" OF AN EXTERIOR OR INTERIOR DOOR TO BE TEMPERED GLASS. WINDOW MANUFACTURER TO VERIFY FOR ALL TEMPERED GLASS LOCATIONS AS PER APPLICABLE
- 5. ALL OPENINGS BETWEEN THE GARAGE AND THE RESIDENCE SHALL BE EQUIPPED WITH SOLID CORE WOOD DOORS 1 3/8" MIN THICKNESS, AND EQUIPPED WITH A SELF CLOSING DEVICE
- 6. ALL HINGED SHOWER DOORS SHALL SWING OUTWARD. GLAZING USED IN DOORS AND PANELS OF BATHTUB/SHOWER ENCLOSURES AND BUILDING WALLS ENCLOSING THESE COMPARTMENTS SHALL BE FULLY TEMPERED OR LAMINATED SAFETY GLASS.
- 7. IF PLATE HEIGHT IS 9'-0" OR HIGHER, ALL DOORS AND CASED OPENINGS TO BE 8'-0" HT. UNLESS NOTED OTHERWISE. IF PLATE HEIGHT IS LESS THAN 9'-0", ALL DOORS AND CASED OPENINGS TO BE 6'-8" HT. UNLESS NOTED OTHERWISE. EXCEPTION...IF A 7'-0" HT. DOOR IS USED ADJUST WINDOWS TO 7'-0" HEADER HT.

- 8. PROVIDE WEATHERSEAL AND DOOR SILL AT ALL EXTERIOR DOOR THRESHOLDS.
- 9. THE DROP FROM INTERIOR FINISH FLOOR TO ANY EXTERIOR FINISH FLOOR IS TO BE A MINIMUM OF 1 1/2". CONTRACTOR TO VERIFY MATERIALS USED FOR DECK CONSTRUCTION AND FINISH FLOORING TO MAINTAIN MINIMUM DROP.
- 10. ALL BEARING WALLS OVER 9'-0" IN HEIGHT TO BE FRAMED WITH 2x6 STUDS. IF WALLS OVER 9'-0" IN HEIGHT ARE NOT BUILT WITH
- 11. PROVIDE BLOCKING FOR HANDRAIL MOUNTING AT STAIRS AS NECESSARY.
- 12. PROVIDE BLOCKING FOR CEILING FANS WHERE SPECIFIED.
- 13. CONTRACTOR TO PROVIDE A 3/4" PLYWOOD CATWALK FROM ATTIC ACCESS TO HVAC UNITS (IF APPLICABLE). UNITS TO BE LOCATED WITHIN 20'-0" OF ACCESS.
- 14. WEATHERSTRIP ATTIC ACCESS DOOR(S).
- 15. IN VENTED ROOF ASSEMBLIES PROVIDE 1 S.F. NET FREE AREA OF ATTIC VENTILATION PER 150 S.F. OF TOTAL COVERED ROOF AREA AS PER CODE.
- 16. ALL PLUMBING, APPLIANCE AND GAS VENTS TO VENT TO REAR OF ROOF RIDGE WHEREVER POSSIBLE. ALL VENTS TO BE GANGED TO THE FEWEST NUMBER POSSIBLE PENETRATING THE


- 17. BUILDER TO VERIFY SIZING AND LOCATION OF ALL APPLIANCES & RELATED COMPONENTS.
- 18. PROVIDE ELECTRIC FOR POOL &/OR SPA EQUIP. & LIGHTS. PROVIDE NECESSARY PLUMBING FOR POOL &/OR SPA. VERIFY LOCATION WITH BUILDER OR OWNER.
- 19. THE STANDARD MOUNTING HEIGHT FOR SHOWER HEADS IS 7'-0"
- ABOVE FINISH FLOOR UNLESS NOTED OTHERWISE. 2X6 STUDS THEY MUST BE BUILT WITH DOUBLE 2X4 STUDS AT 12" 20. UNLESS NOTED OTHERWISE STANDARD PANTRY SHELVING TO BE AS FOLLOWS:
  - A. LOWEST 2 SHELVES TO BE 16" D. WITH HEIGHT SPACING OF 14" CLEAR.
  - B. REMAINING SHELVES TO BE 12" D. WITH HEIGHT SPACING
  - . PROVIDE CONTROL AND EXPANSION JOINTS AS REQUIRED ON
  - CONCRETE DRIVES, WALKS AND PATIOS. 22. ALL FIREPLACES TO HAVE 20" DEEP HEARTH& 12" NON-

COMBUSTIBLE SURROUND.

F GAS BIBB T GAS KEY + T SHOWER HEAD THOSE BIBB

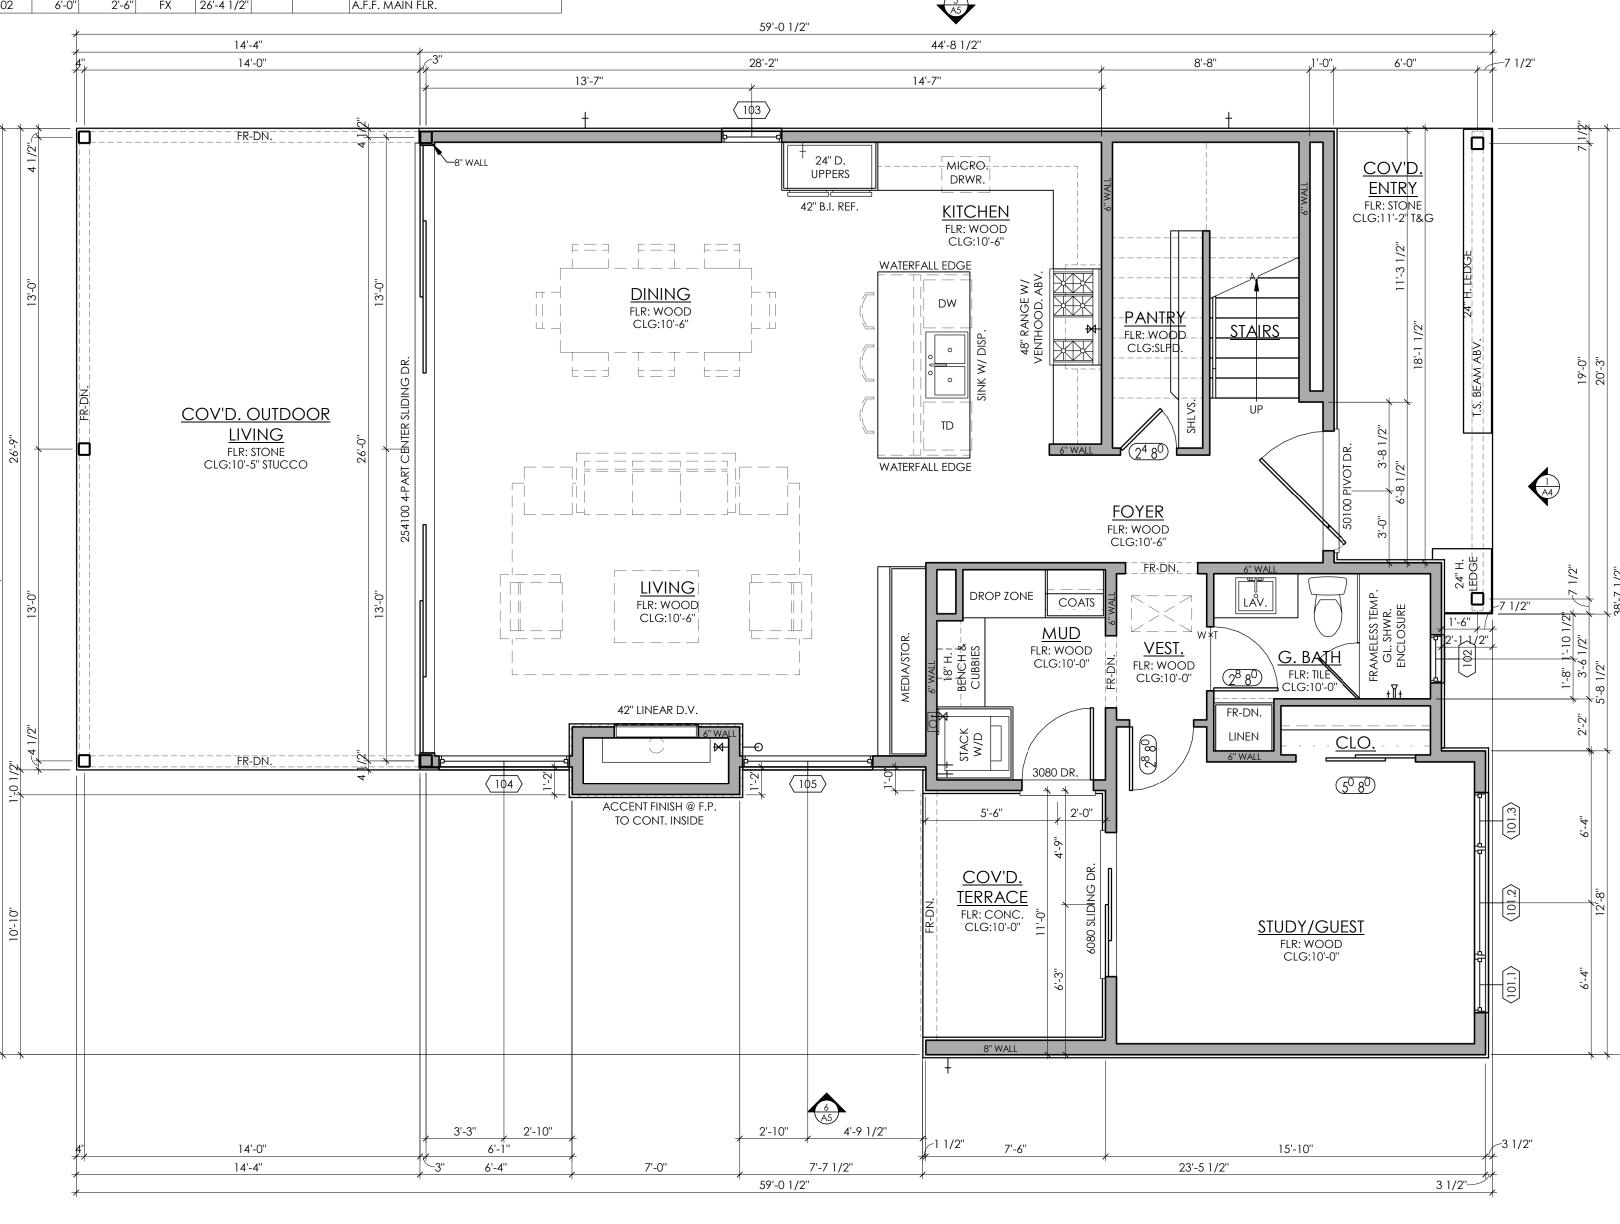




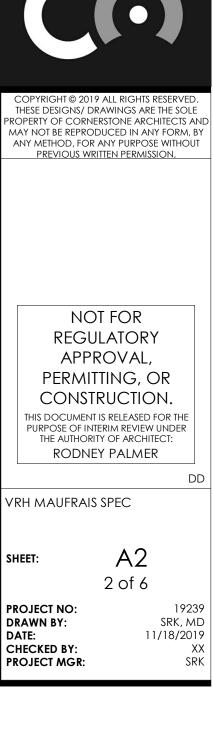


NOTE: ALL EXTERIOR WALLS TO

BE FRAMED W/ 6" STUDS U.N.O. ALL INTERIOR WALLS TO BE FRAMED W/ 4" STUDS U.N.O.

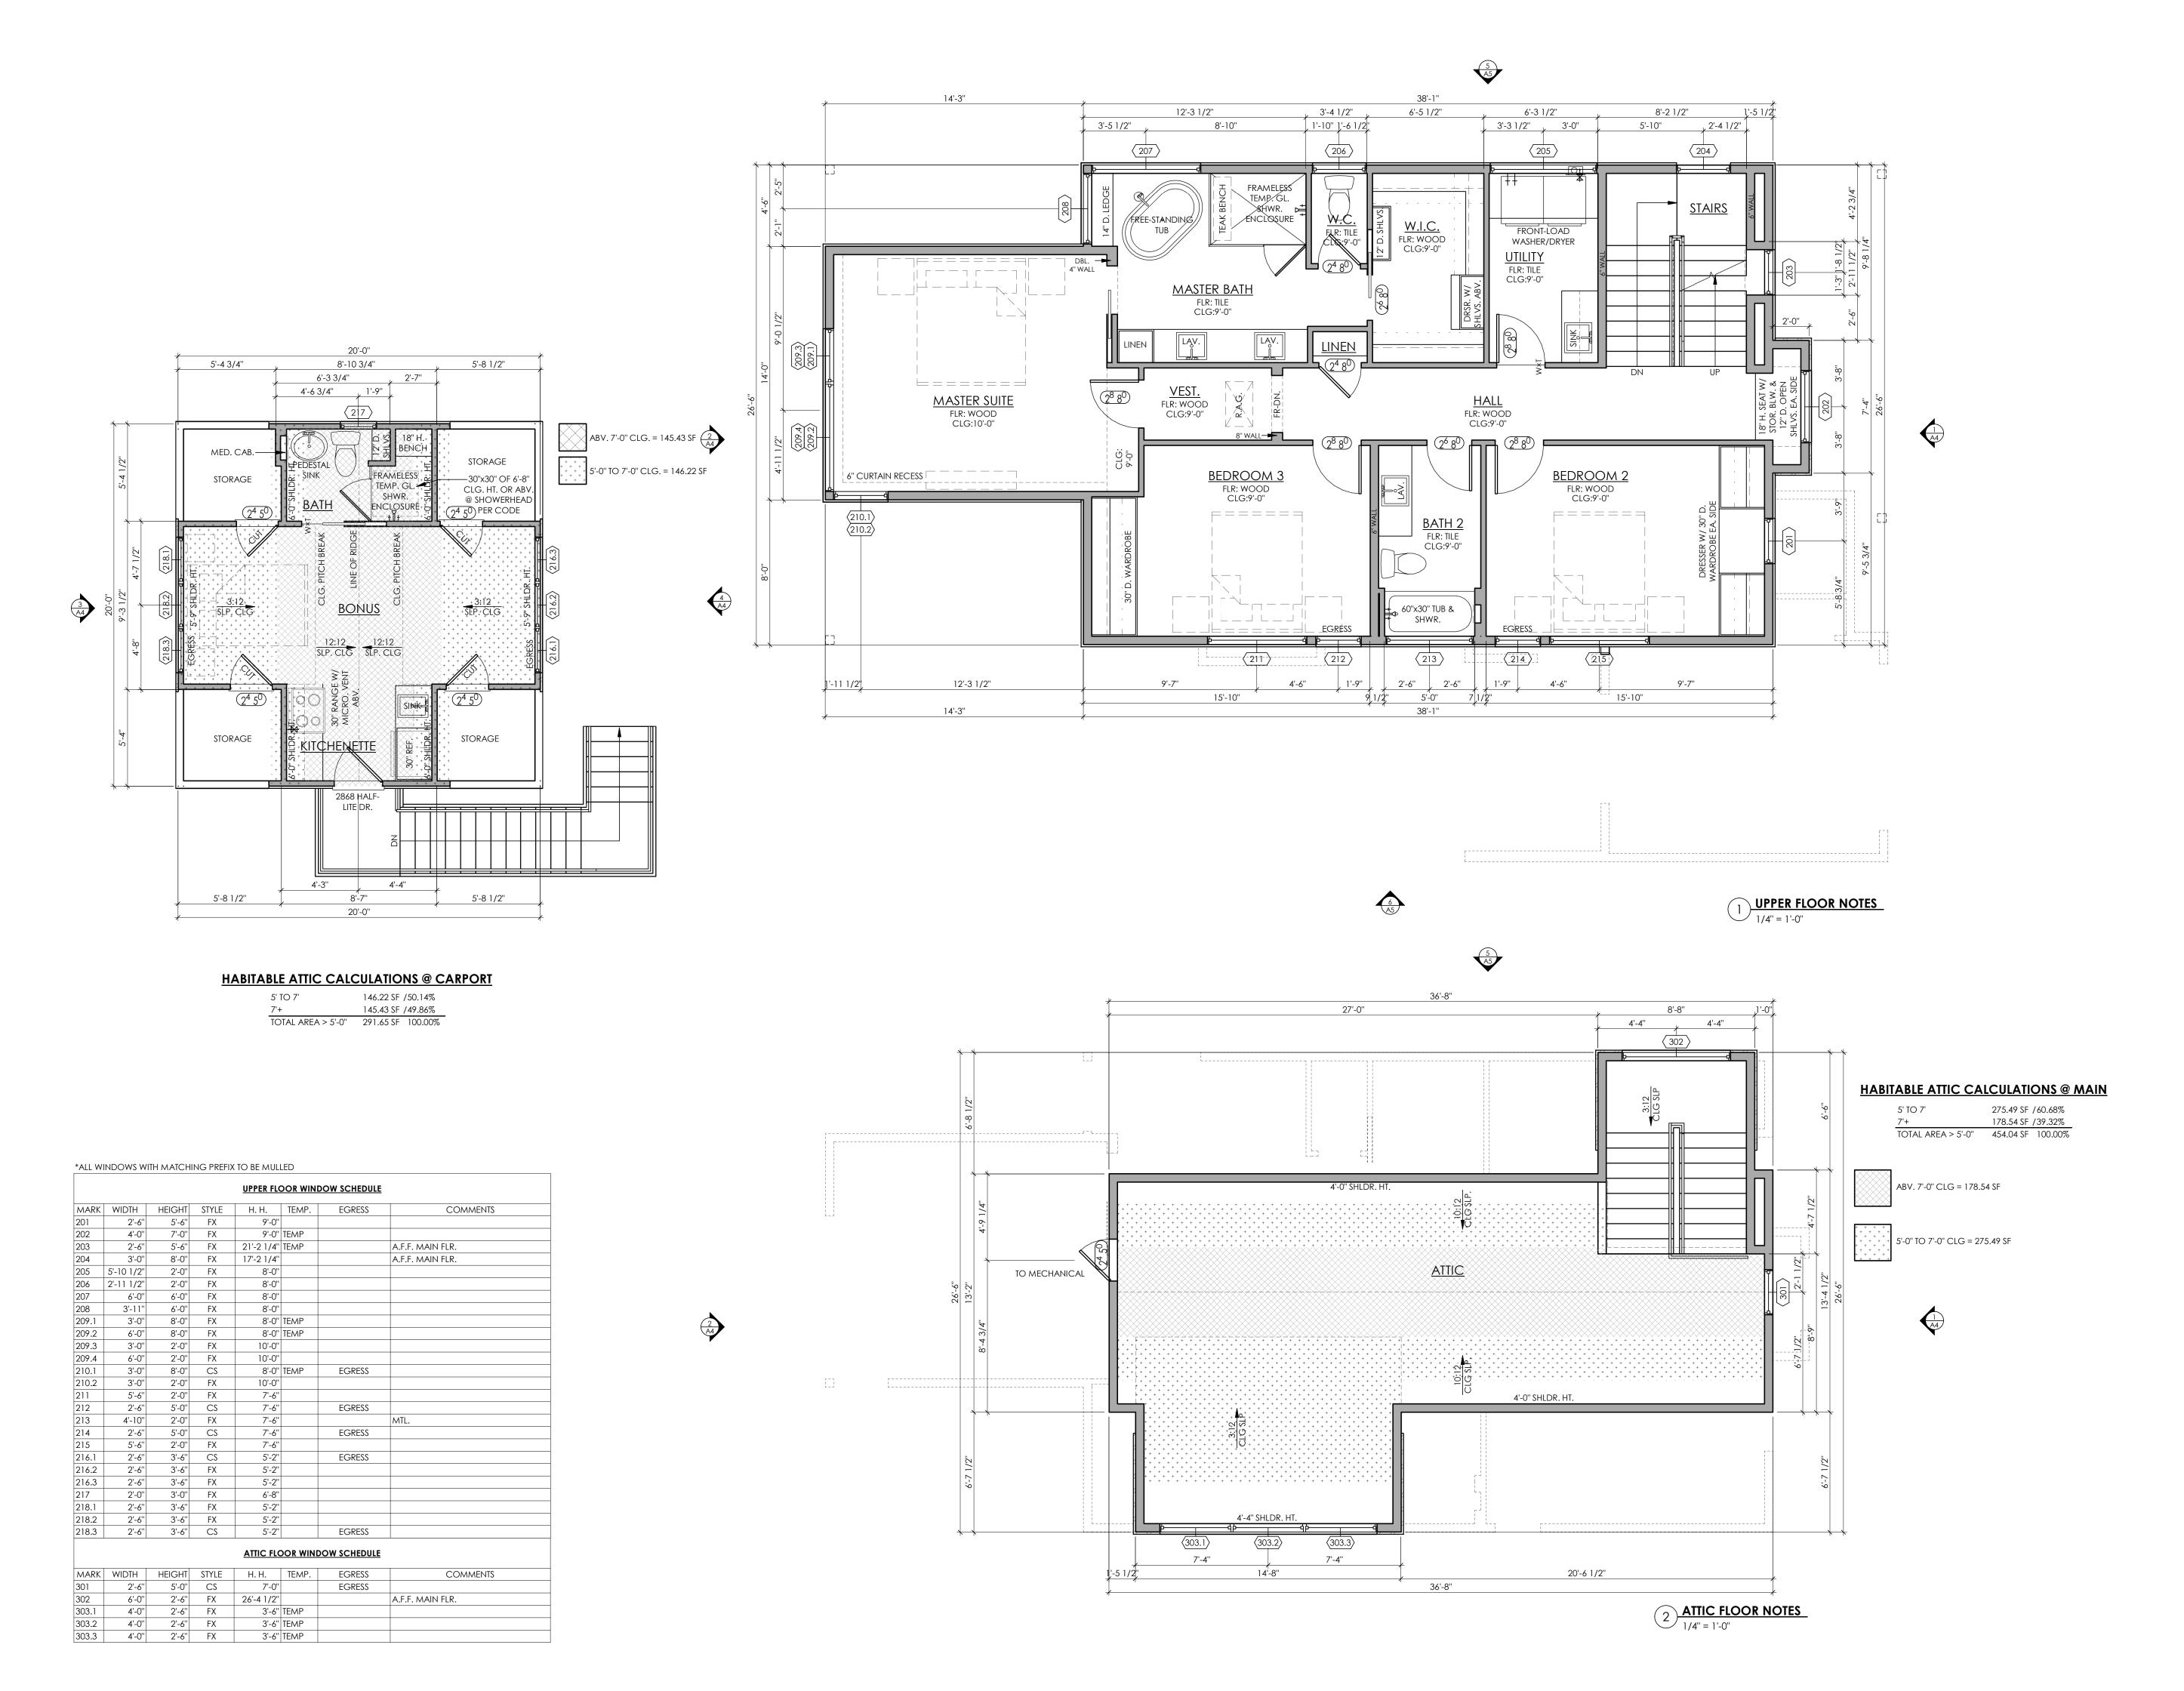

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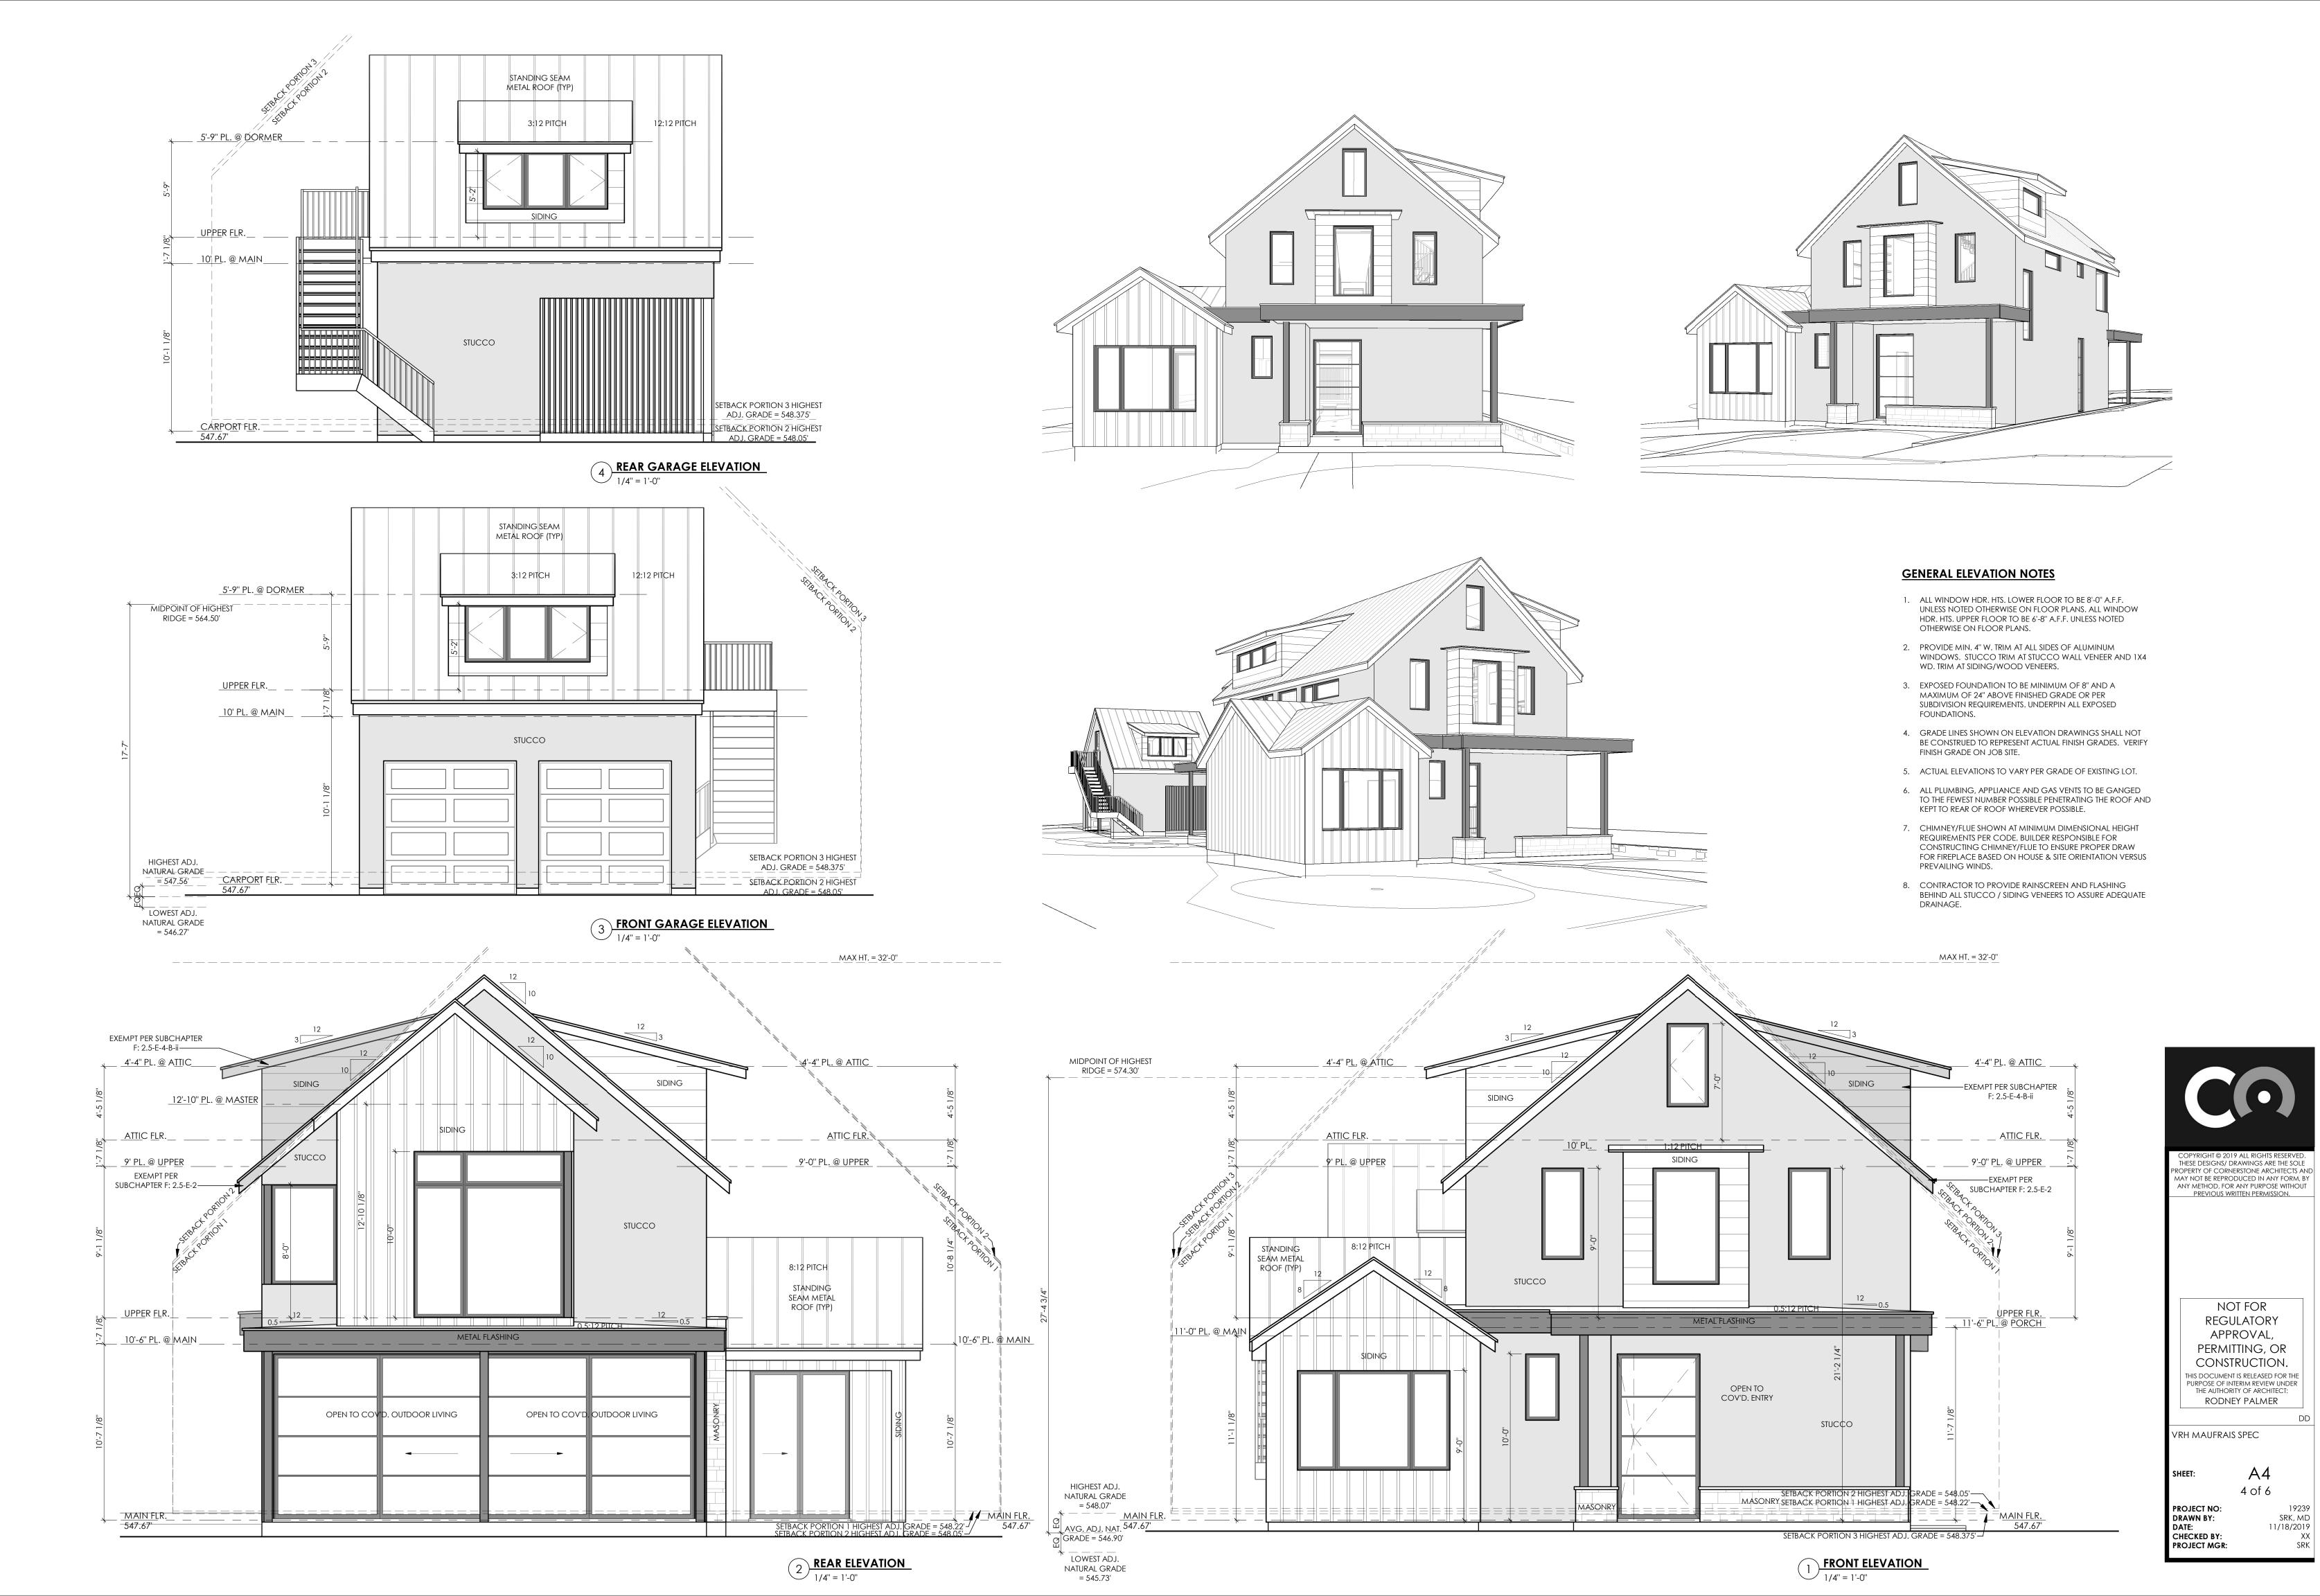

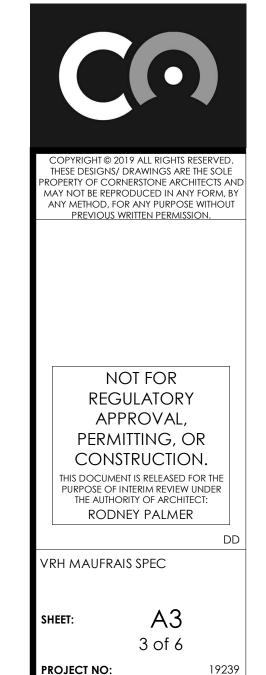
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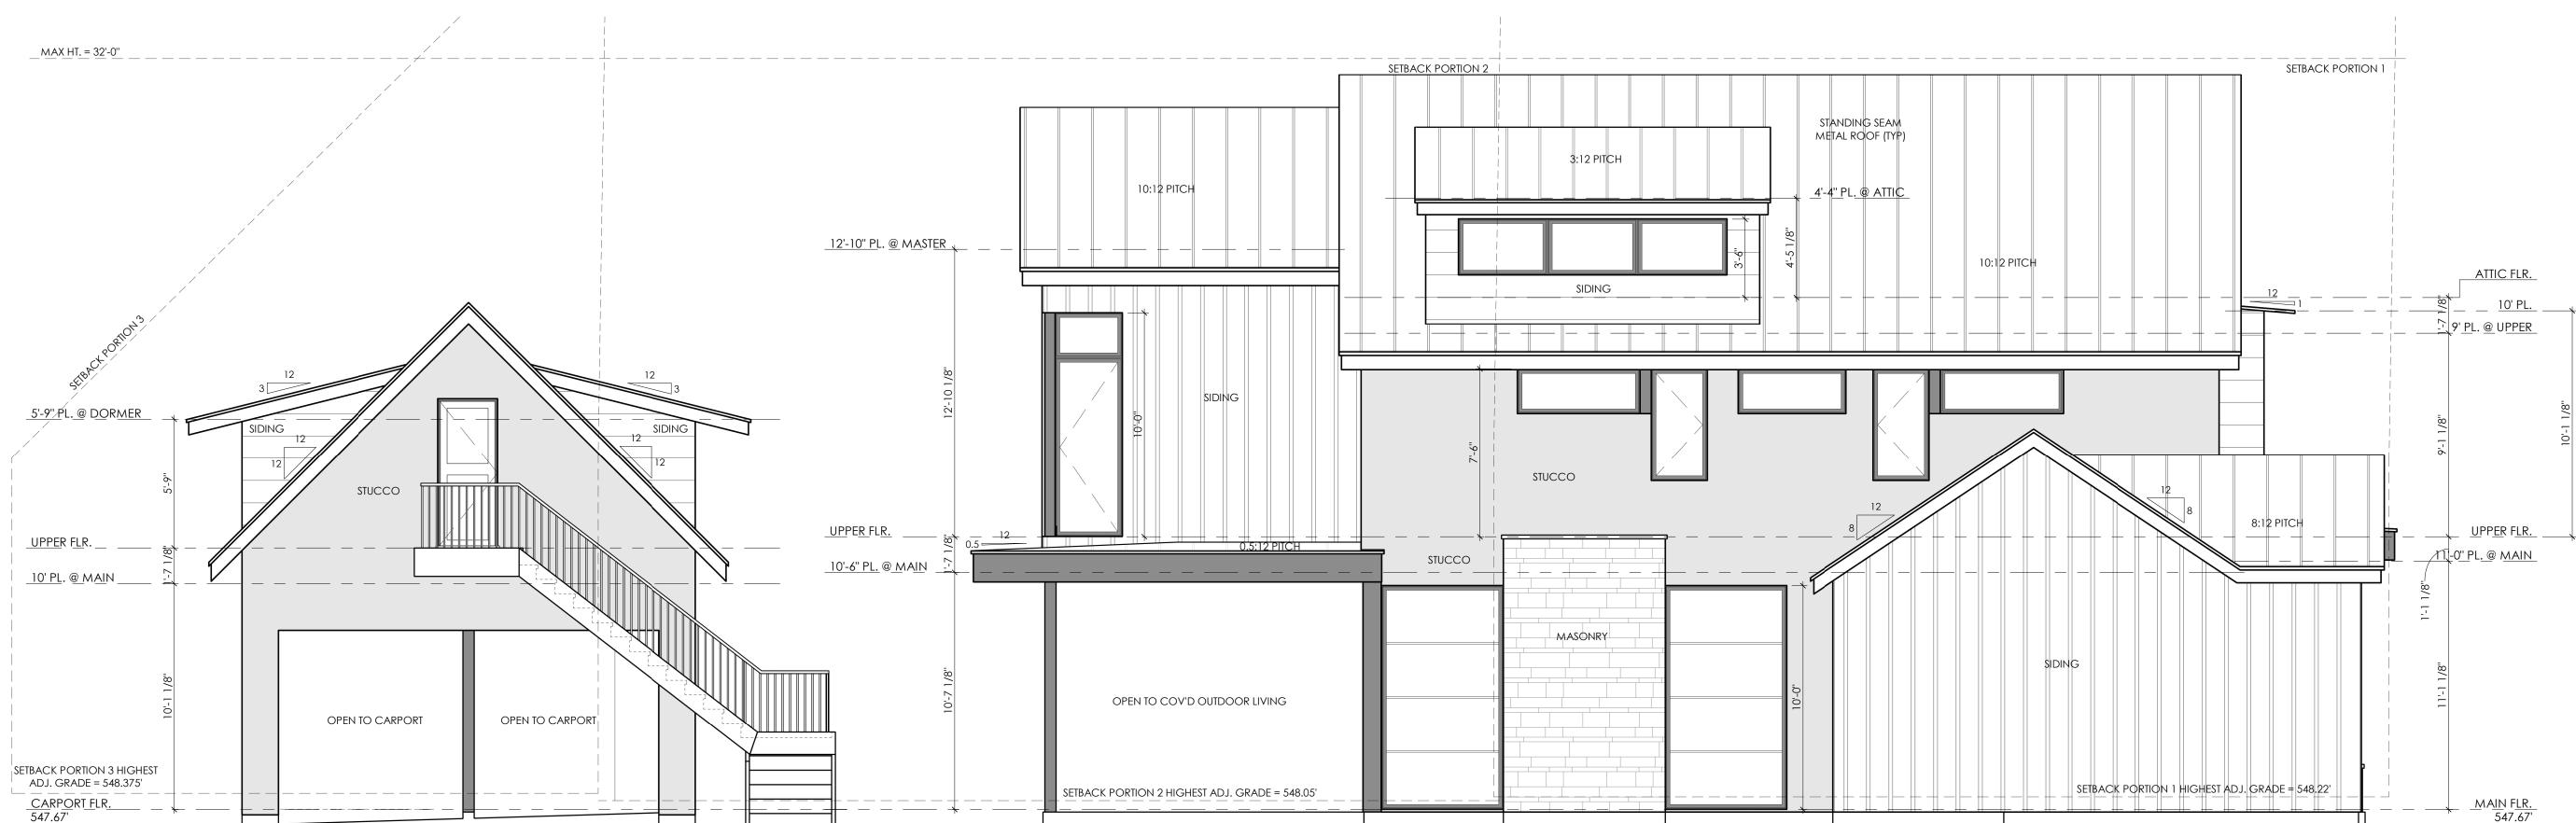
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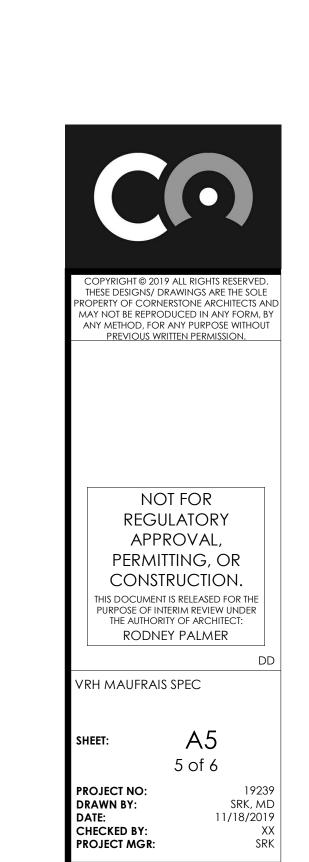
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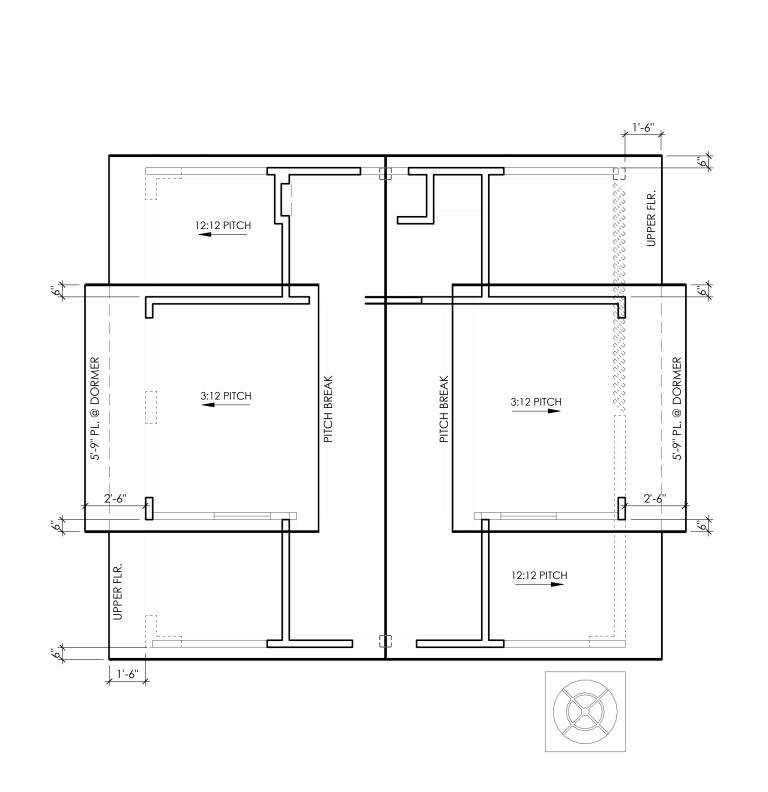
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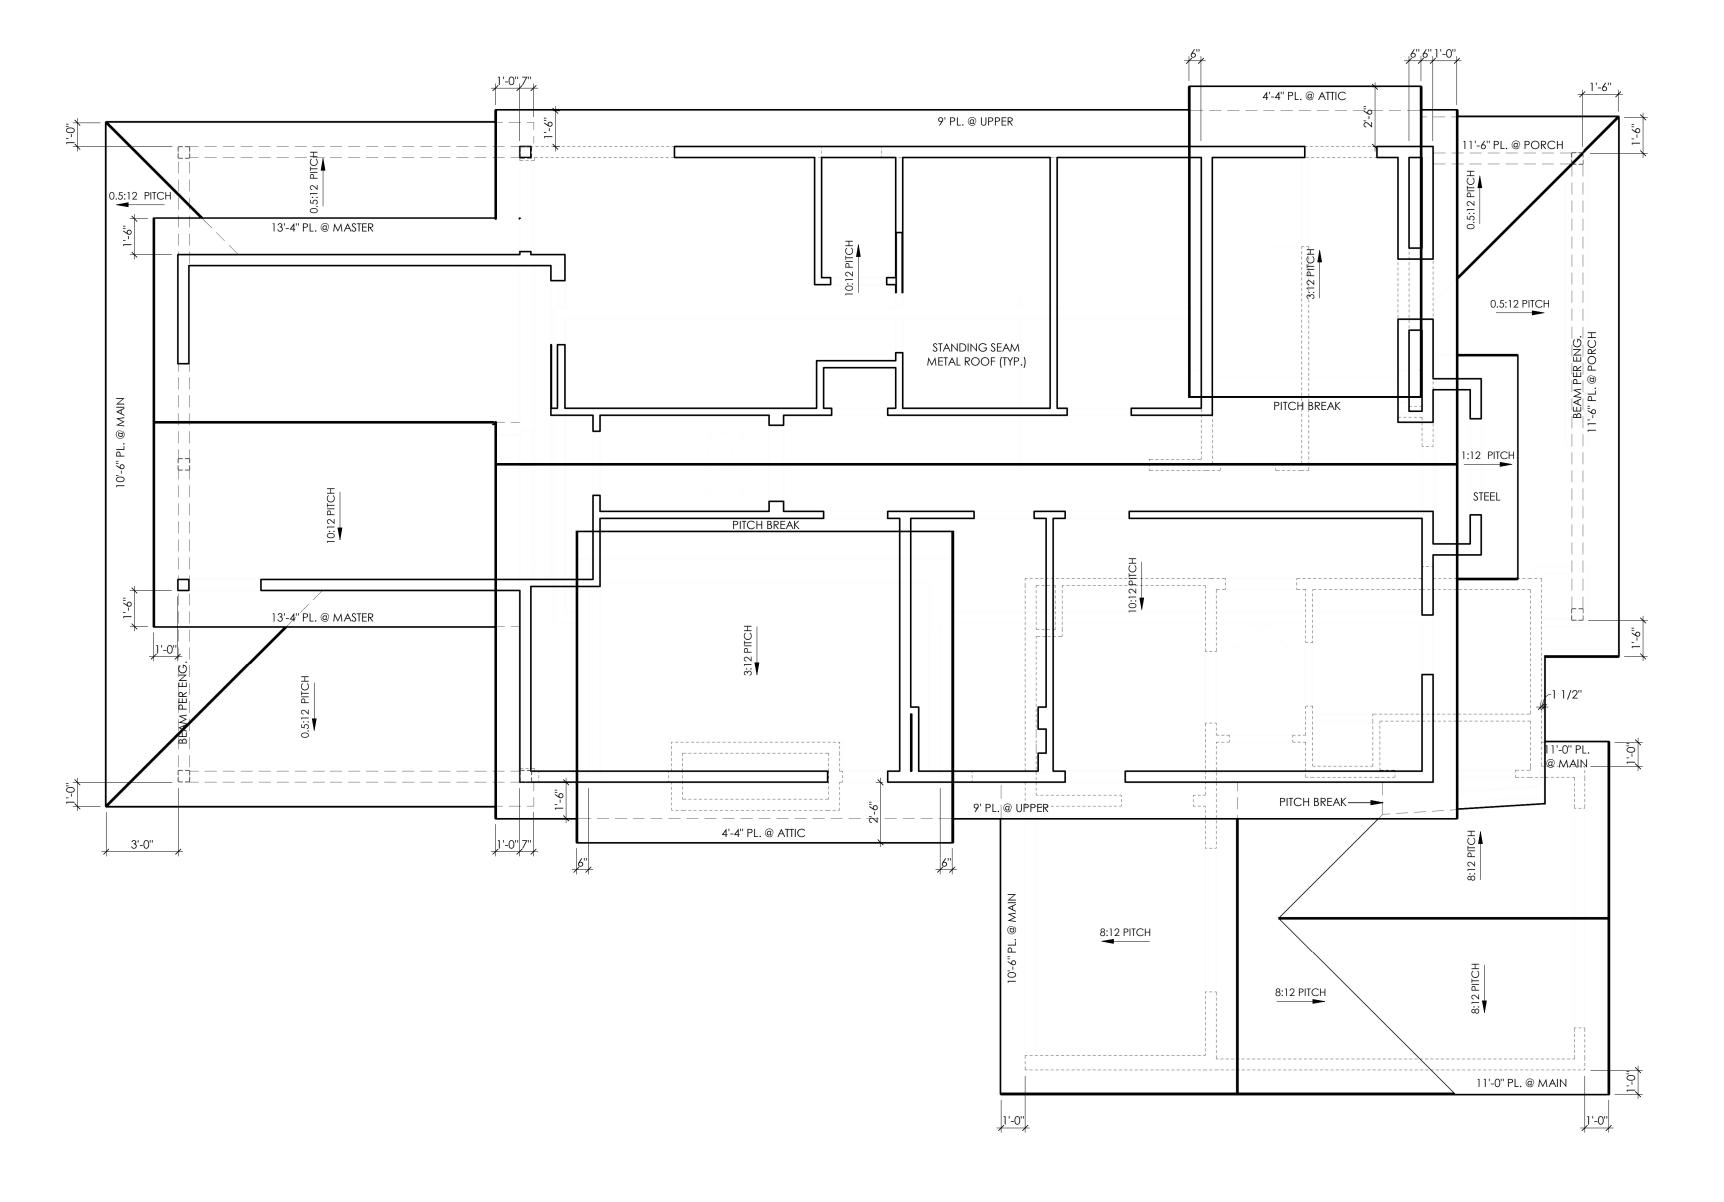













1 ROOF PLAN
1/4" = 1'-0"

# **GENERAL ROOF NOTES**

- 1. PITCHES TO BE AS NOTED ON PLANS.
- HIPS, VALLEYS & RIDGES TO BE FRAMED ONE SIZE LARGER THAN RAFTERS.
- 3. ALL PLUMBING, APPLIANCE AND GAS VENTS TO VENT TO REAR OF ROOF RIDGE WHEREVER POSSIBLE.
- 4. ALL VENTS TO BE GANGED TO THE FEWEST NUMBER POSSIBLE PENETRATING THE ROOF.
- 5. ALL OVERHANGS TO BE 18" FROM THE FRAMEWALL UNLESS NOTED OTHERWISE.
- 6. U.N.O. ALL INTERIOR WALLS OF ONE STORY PLANS TO BE LOAD
- 7. ALL EXTERIOR OPENINGS TO BE LOAD BEARING.
- 8. WHEN ENGINEERED TRUSSES TO BE USED TRUSS DESIGN & SPACING TO BE PER ENGINEER'S SPECIFICATIONS.
- 9. BUILDER ACCEPTS FULL RESPONSIBILITY FOR CHECKING PLANS TO ASSURE CONFORMITY TO CURRENT LOCAL BUILDING CODES. SHOULD ANY CHANGES BE MADE TO THESE PLANS BY BUILDER OR HIS REPRESENTATIVES WITHOUT CONTACTING THE ARCHITECT, THE BUILDER WILL ACCEPT FULL LIABILITY FOR
- 10. THE DESIGN & SIZING OF ALL LOAD BEARING HEADERS, STRUCTURAL BEAMS AND TRUSSES IS THE RESPONSIBILITY OF THE AGENT (ENGINEER/TRUSS MANUFACTURER, ETC.) CHOSEN BY THE BUILDER/OWNER TO DO SAID DESIGN.

NOTE: PROVIDE ICE & WATER SHIELD @ ALL ROOF PITCHES 3:12 & BELOW

AMENDED PLANS.

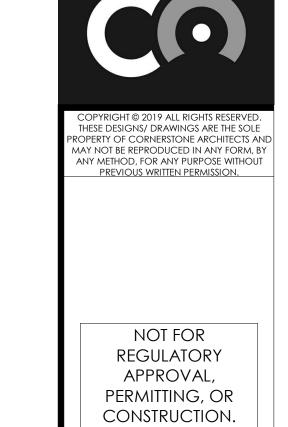

VRH MAUFRAIS SPEC

THIS DOCUMENT IS RELEASED FOR THE PURPOSE OF INTERIM REVIEW UNDER THE AUTHORITY OF ARCHITECT:

RODNEY PALMER

HEET: A6 6 of 6

PROJECT NO: DRAWN BY: DATE: CHECKED BY: PROJECT MGR:

19239 SRK, MD 11/18/2019 XX SRK