


KEYNOTES - DEMO SITE & ROOF PLAN

- 1. REMOVE EXISTING SHRUBS
- 2. REMOVE EXISTING STAIRS AND LANDING
- 3. REMOVE EXISTING WOOD AND STONE DECK AND STAIRS
- 4. REMOVE EXISTING FENCE
- 5. REMOVE EXISTING A/C UNIT AND PAD
- 6. PREP AND CLEAR AREA FOR MASONRY REPAIR
- 7. REMOVE METAL BOX
- 8. REMOVE AND PREPARE TO REPLACE ROOF
- 9. REMOVE FAILED RETAINING WALL
- 10. REMOVE EXISTING MECHANICAL BUILDING
- 11. REMOVE SIGN
- 12. REFER TO ELECTRICAL PLANS FOR ELECTRICAL DEMO SCOPE
- 13. REMOVE MAILBOX
- 14. REMOVE DAMAGED STONE CURB
- 15. REMOVE MASONRY STAINING WITH PROSOCO 942 LIMESTONE AND MARBLE CLEANER

2 DEMO SITE PLAN
Scale: 1/8" = 1'-0"

NOTES: REF: A-101 FOR SITE PROTECTION PLAN
REF: A-121 FOR ROOF DEMO PLAN

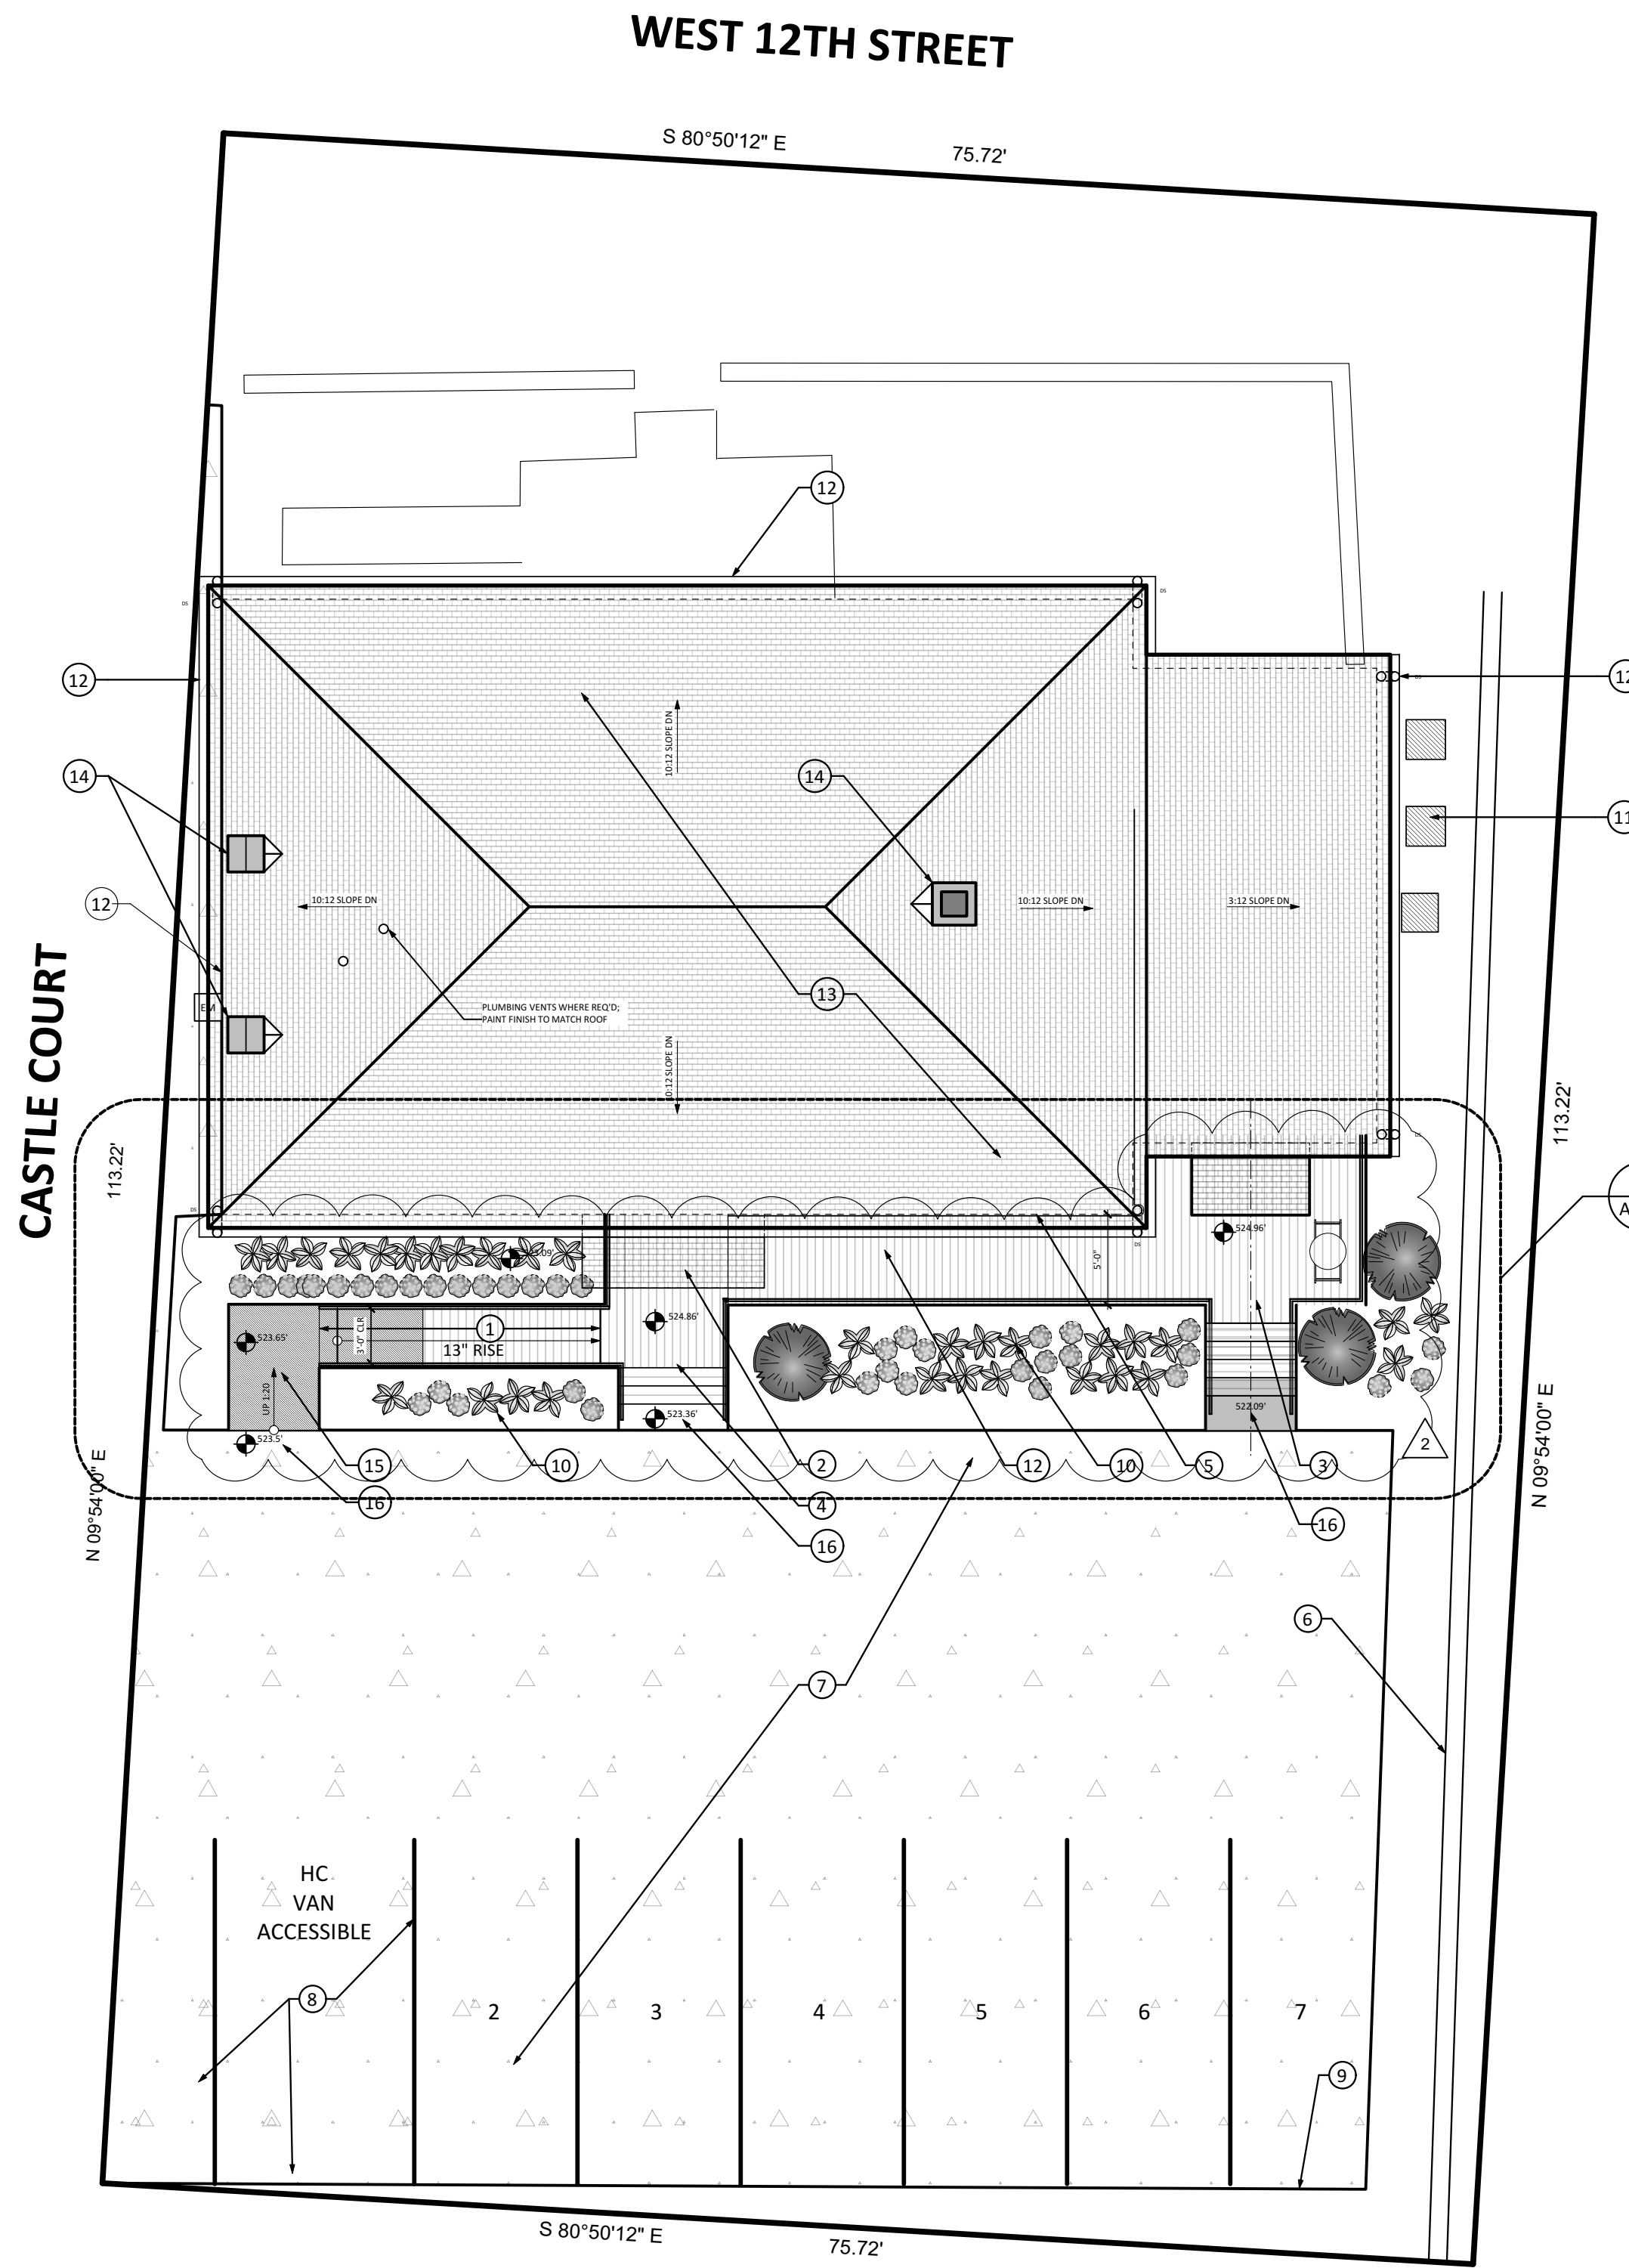


KEYNOTES - NEW SITE & ROOF PLAN

- 1. NEW RAMP AND METAL HANDRAILS
- 2. NEW 4' X 10' AWNING
- 3. NEW WOOD DECK, STAIR, AND HANDRAILS
- 4. NEW LIMESTONE ENTRY STAIRS AND METAL HANDRAILS
- 5. INVESTIGATE CAUSE OF DAMAGE, THEN REPOINT MASONRY BELOW WINDOW TO MATCH ORIGINAL MORTAR
- 6. NEW FENCE AND 2' TALL RETAINING WALL
- 7. RESEAL AND RESTRIPE PARKING LOT
- 8. VAN ACCESSIBLE SPACE STRIPING AND SIGNAGE
- 9. SIGNAGE FOR BICYCLE PARKING
- 10. NEW LANDSCAPING BY OWNER
- 11. NEW MECHANICAL PAD AND EQUIPMENT
- 12. NEW 6" HALF ROUND GUTTERS AND 4" DOWNSPOUTS (PAINT GRIP OR COPPER)
- 13. NEW METAL SHINGLE ROOF: MATTERHORN "TIMBER ASH" BY CERTAINTED OR APPROVED EQUAL
- 14. EVALUATE MASONRY CHIMNEYS FOR REPAIR
- 15. NEW CONCRETE LANDING
- 16. FIELD VERIFY ELEVATION MARK IS LEVEL WITH EXISTING CONCRETE PARKING TO REMAIN. ADJUST IF NEEDED IN CONSULTATION WITH ARCHITECT.


1 NEW SITE PLAN
Scale: 1/8" = 1'-0"

NOTES: REF: A-101 FOR SITE PROTECTION PLAN
REF: A-122 FOR NEW ROOF PLAN

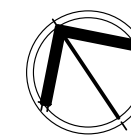


SITE PLAN LEGEND


- WM WATER METER
- W WATER
- WW WASTEWATER
- CO CLEANOUT
- EM ELECTRIC METER
- E OVERHEAD ELECTRIC
- GAS METER
- C CABLE

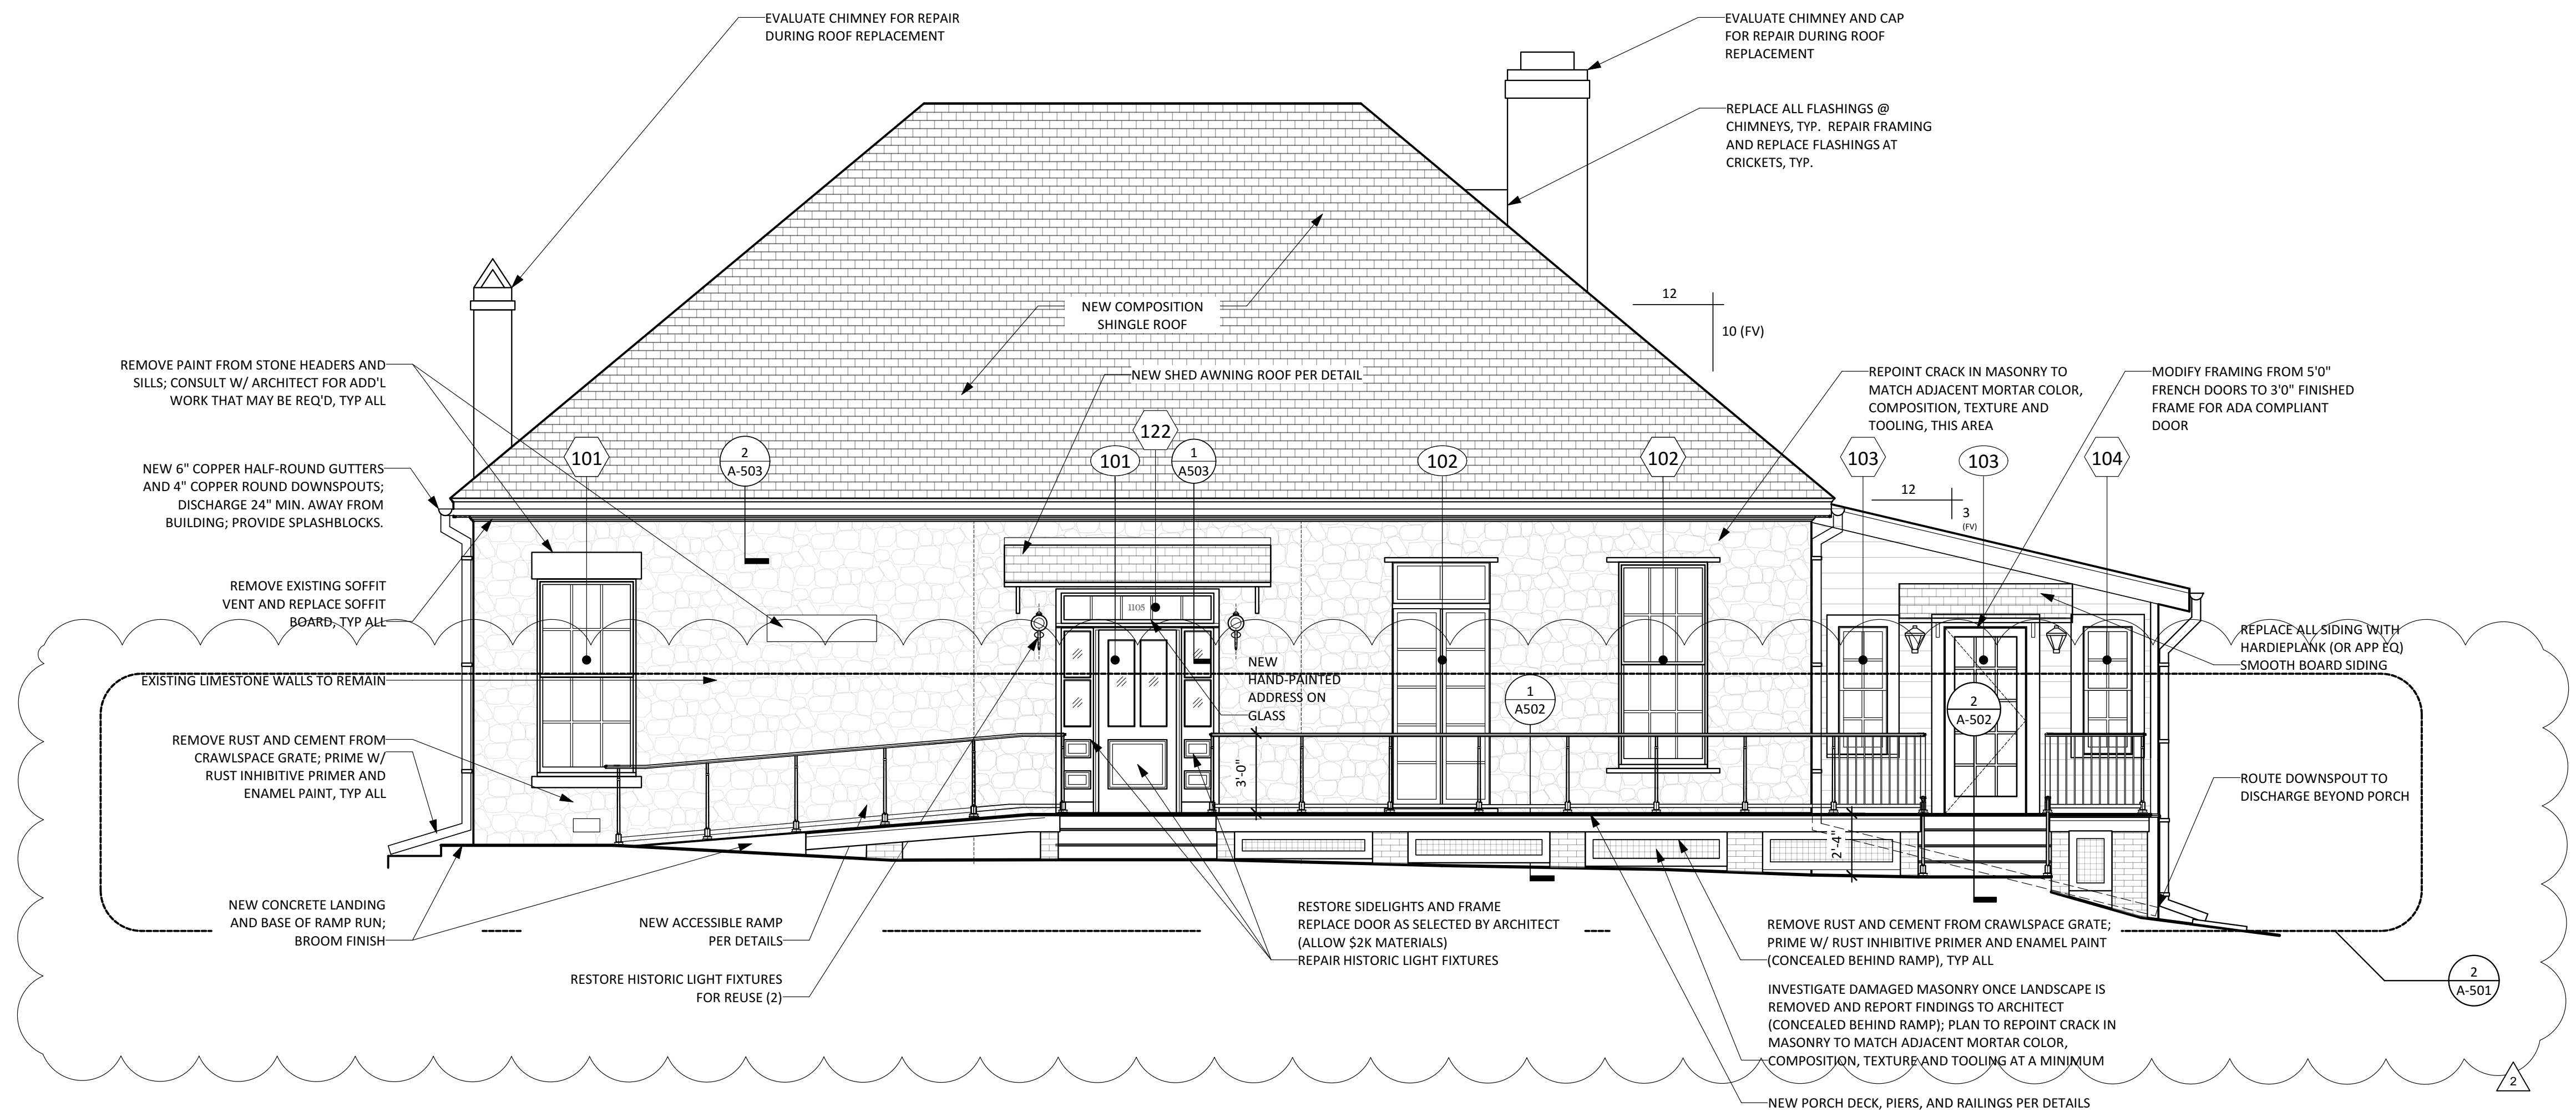


2 SOUTH ELEVATION - RESTORATION
Scale: 1/4" = 1'-0"

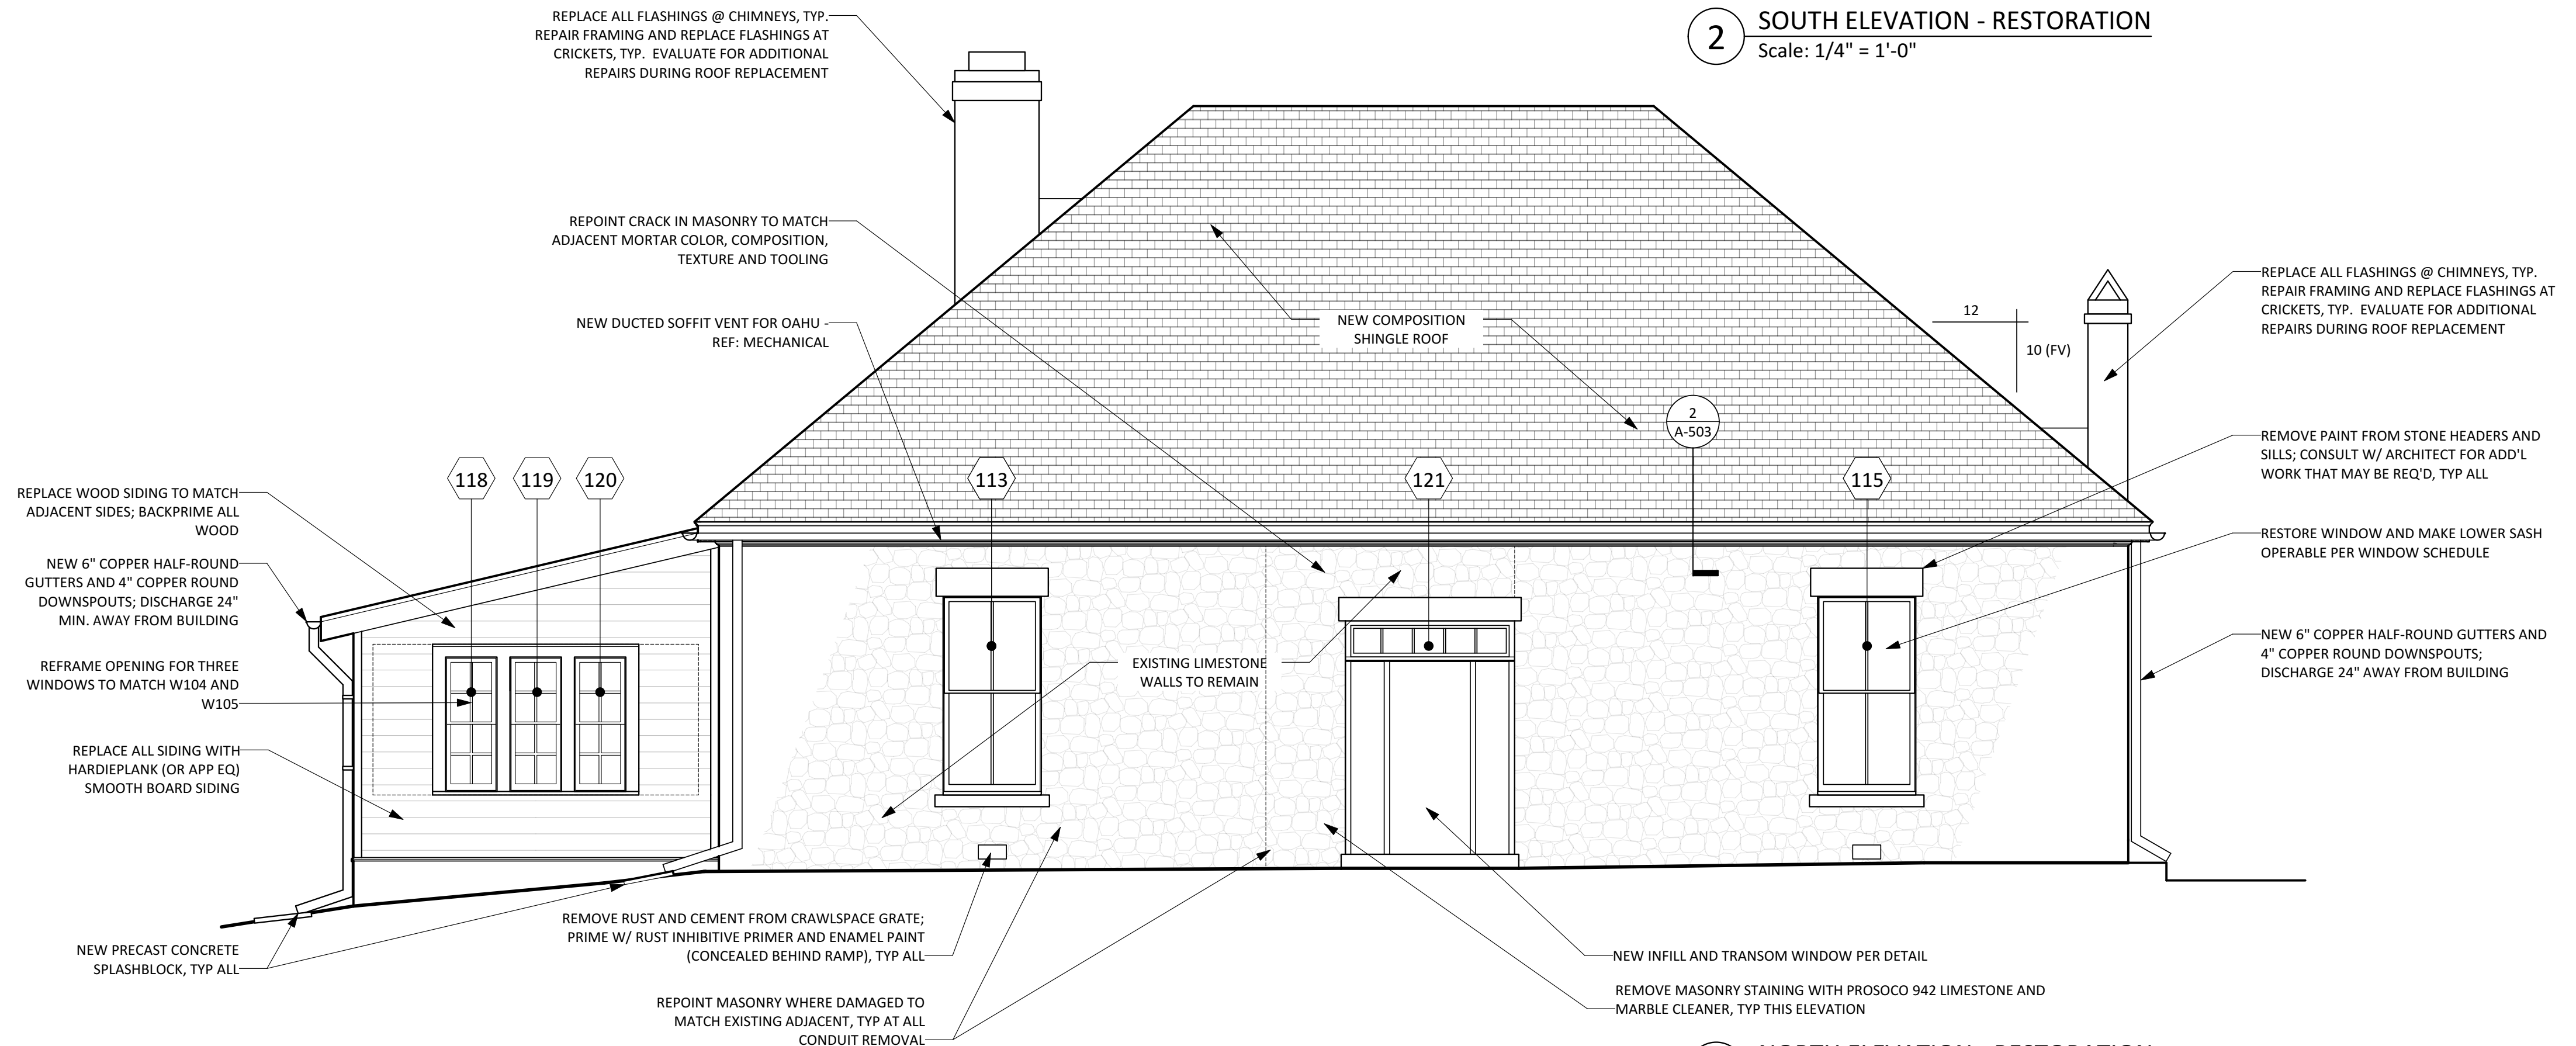


1 NORTH ELEVATION - RESTORATION
Scale: 1/4" = 1'-0"

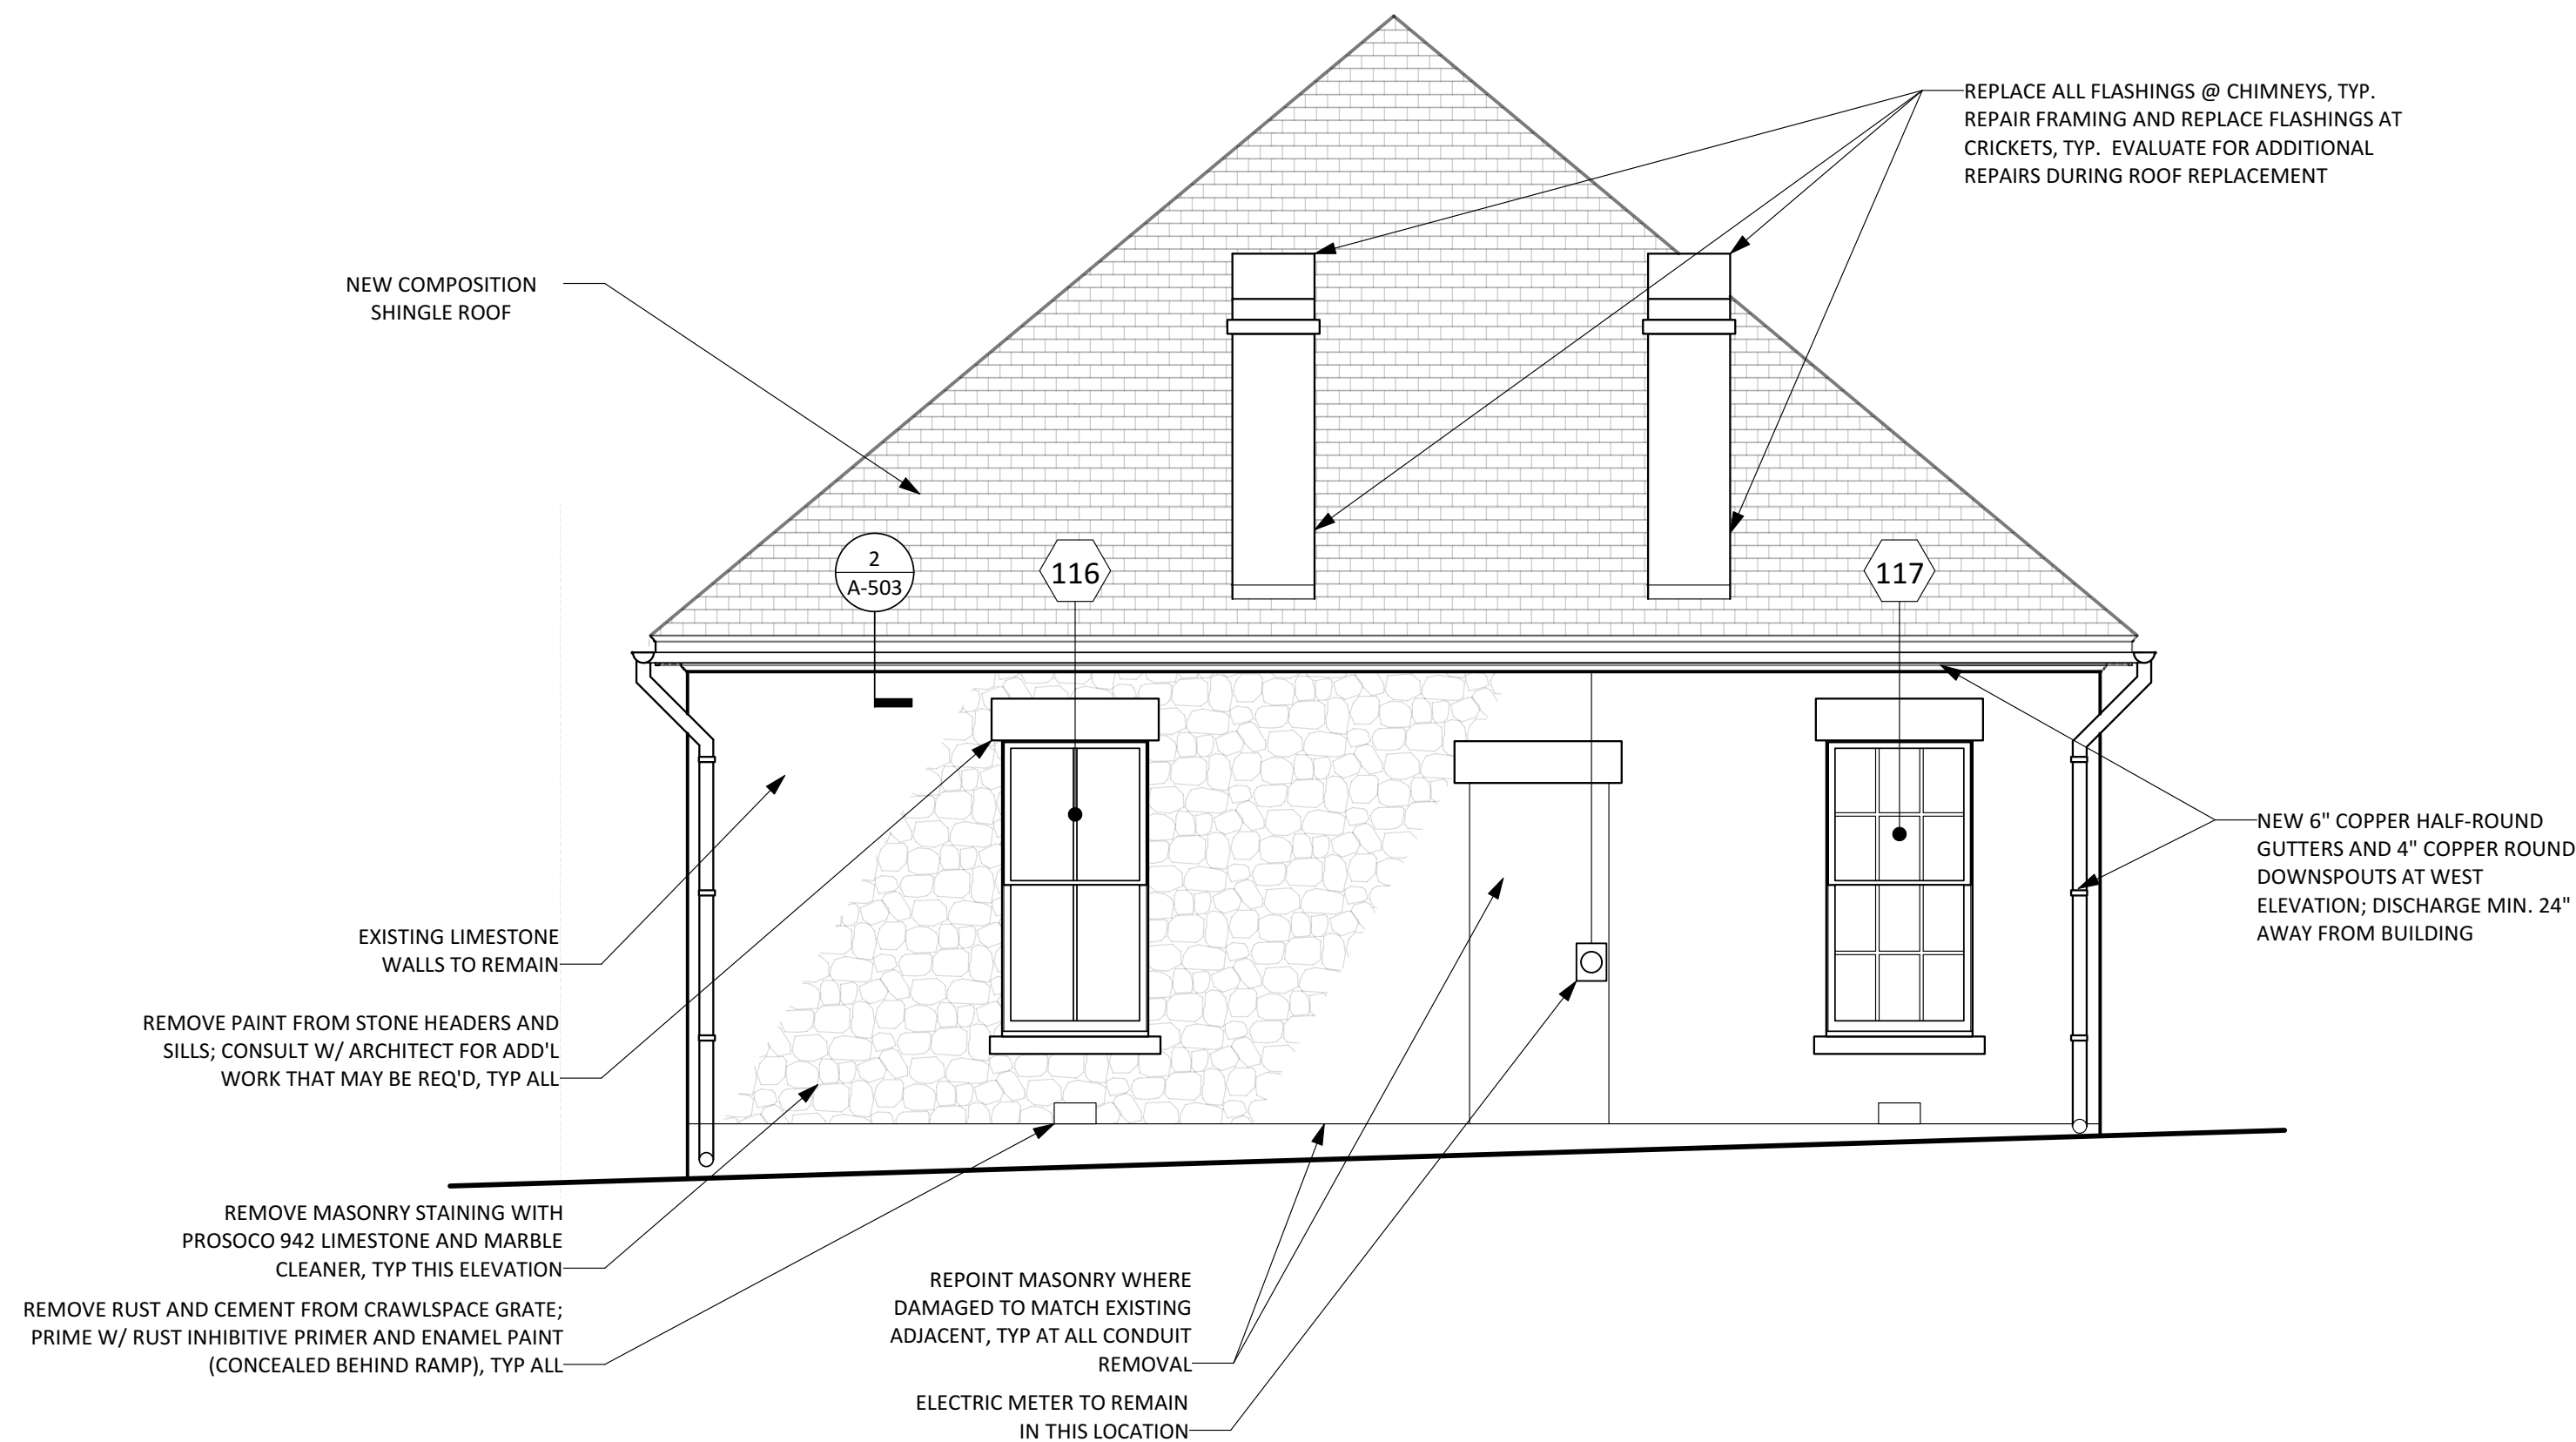

2 WEST ELEVATION - RESTORATION
Scale: 1/4" = 1'-0"

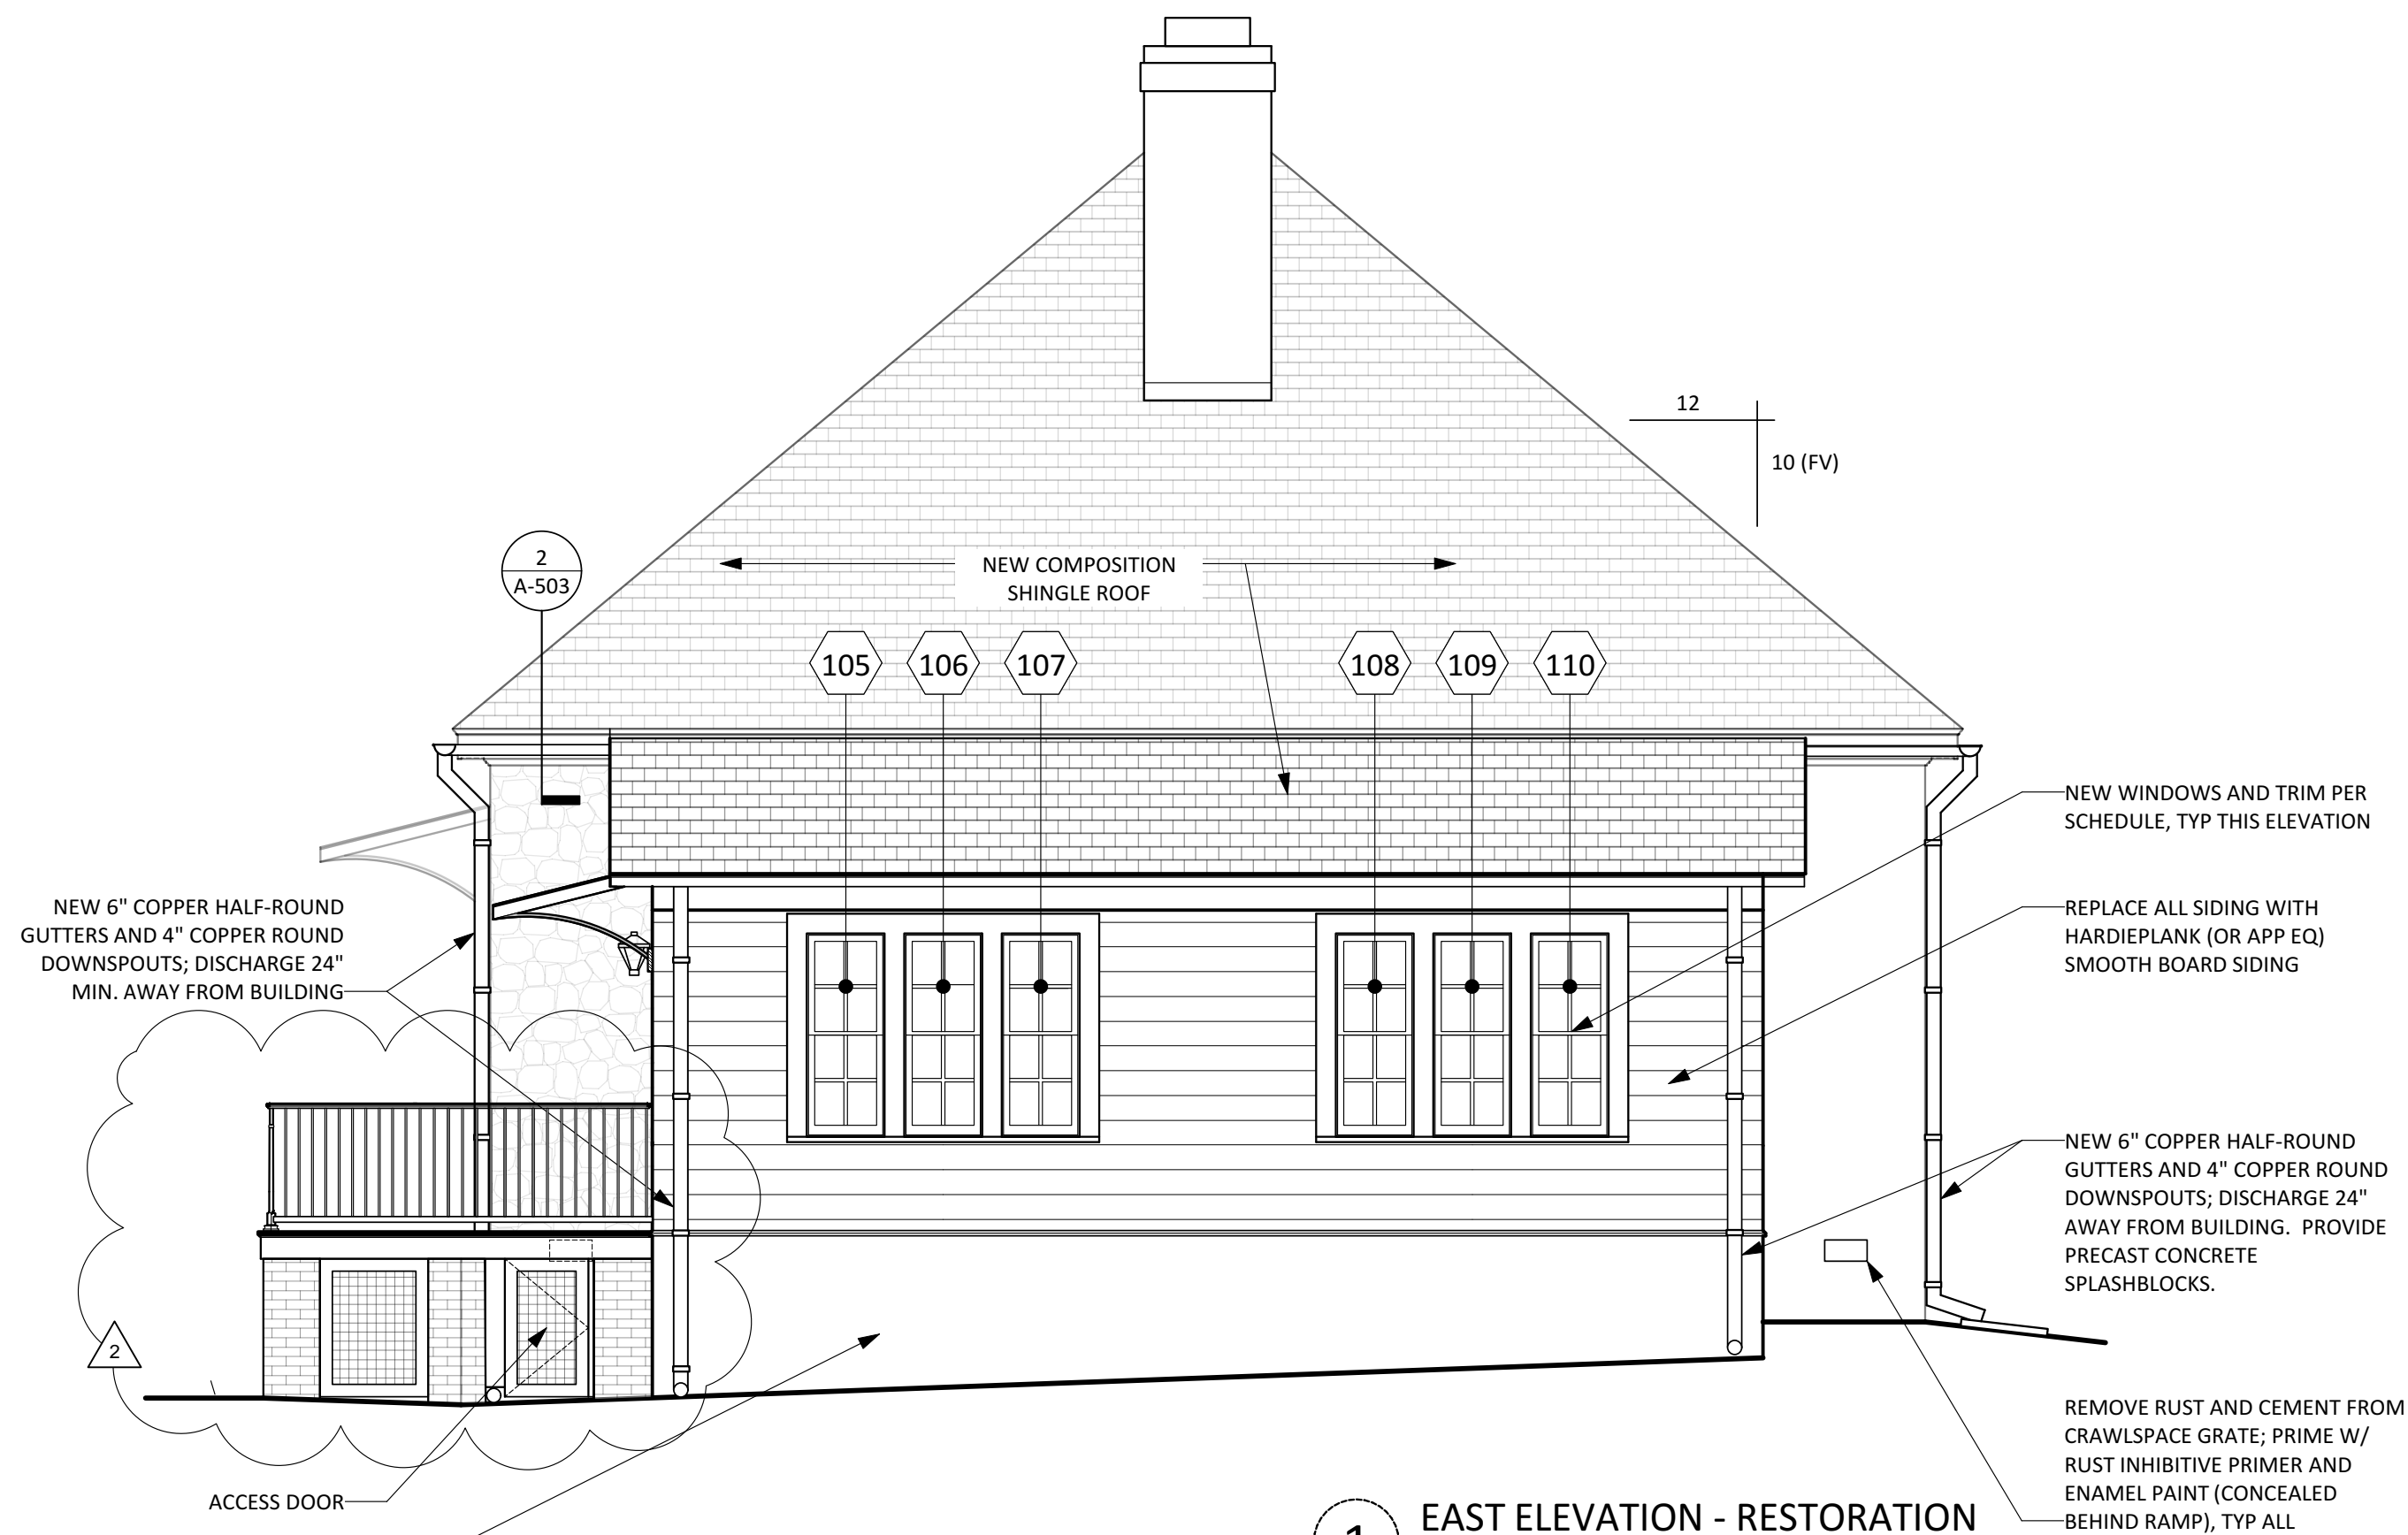


1 EAST ELEVATION - RESTORATION
Scale: 1/4" = 1'-0"

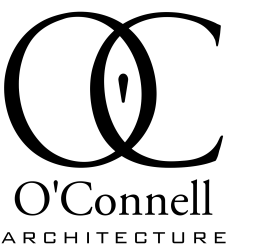

O'Connell
ARCHITECTURE

702 Rio Grande Street
Austin, Texas 78701
512/751-1374

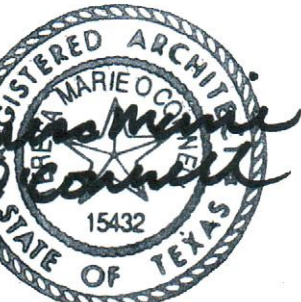

EXP 10/31/20

MESS HALL
RENOVATION
1105 CASTLE COURT, AUSTIN, TEXAS 78703

ISSUE DATE

1/28/2020

2 2/14/2020

SHEET NAME


EAST/WEST
RESTORATION
ELEVATIONS

SHEET NUMBER


A-212



SOUTH RAMP AND ENTRY DETAIL
Scale: 3/8" = 1'-0" 2

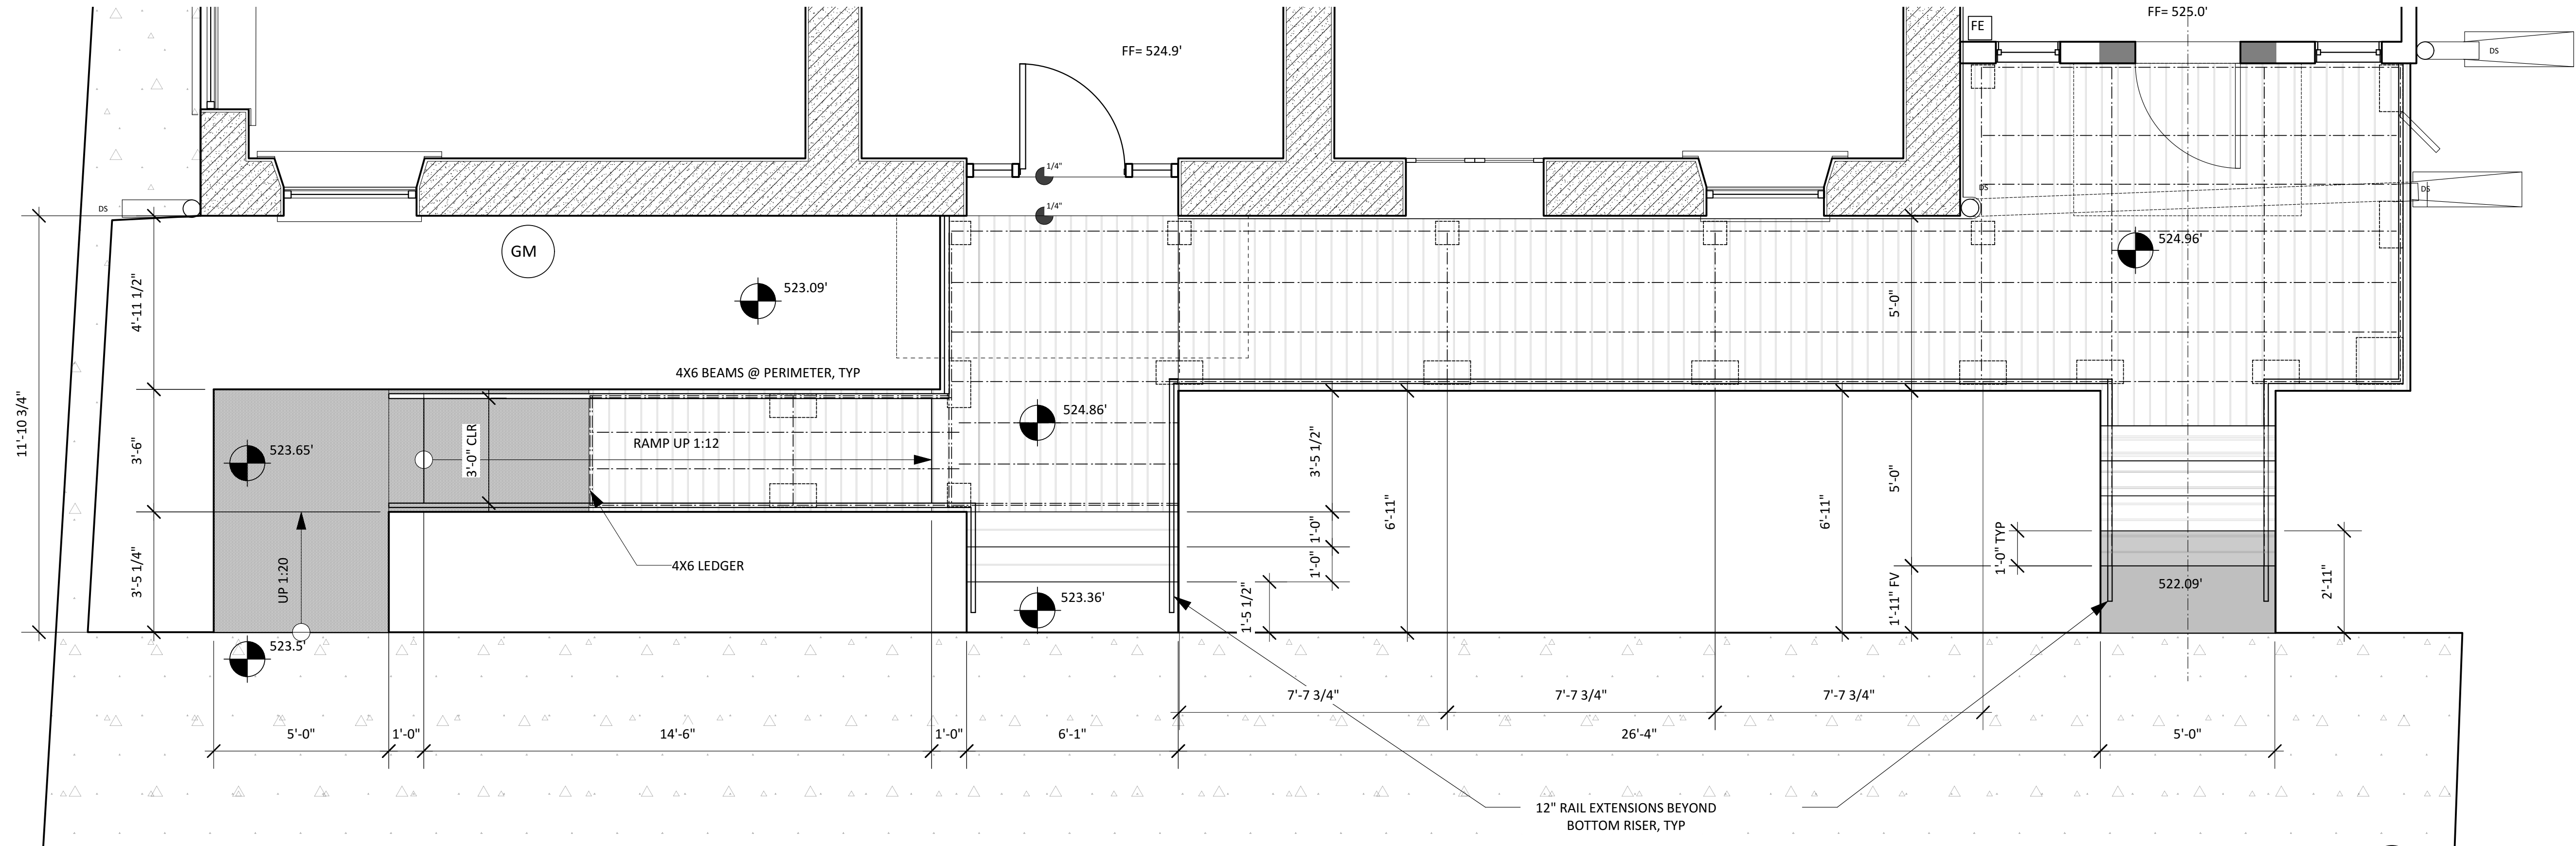


RAMP AND DECK PLAN
Scale: 3/8" = 1'-0" 1

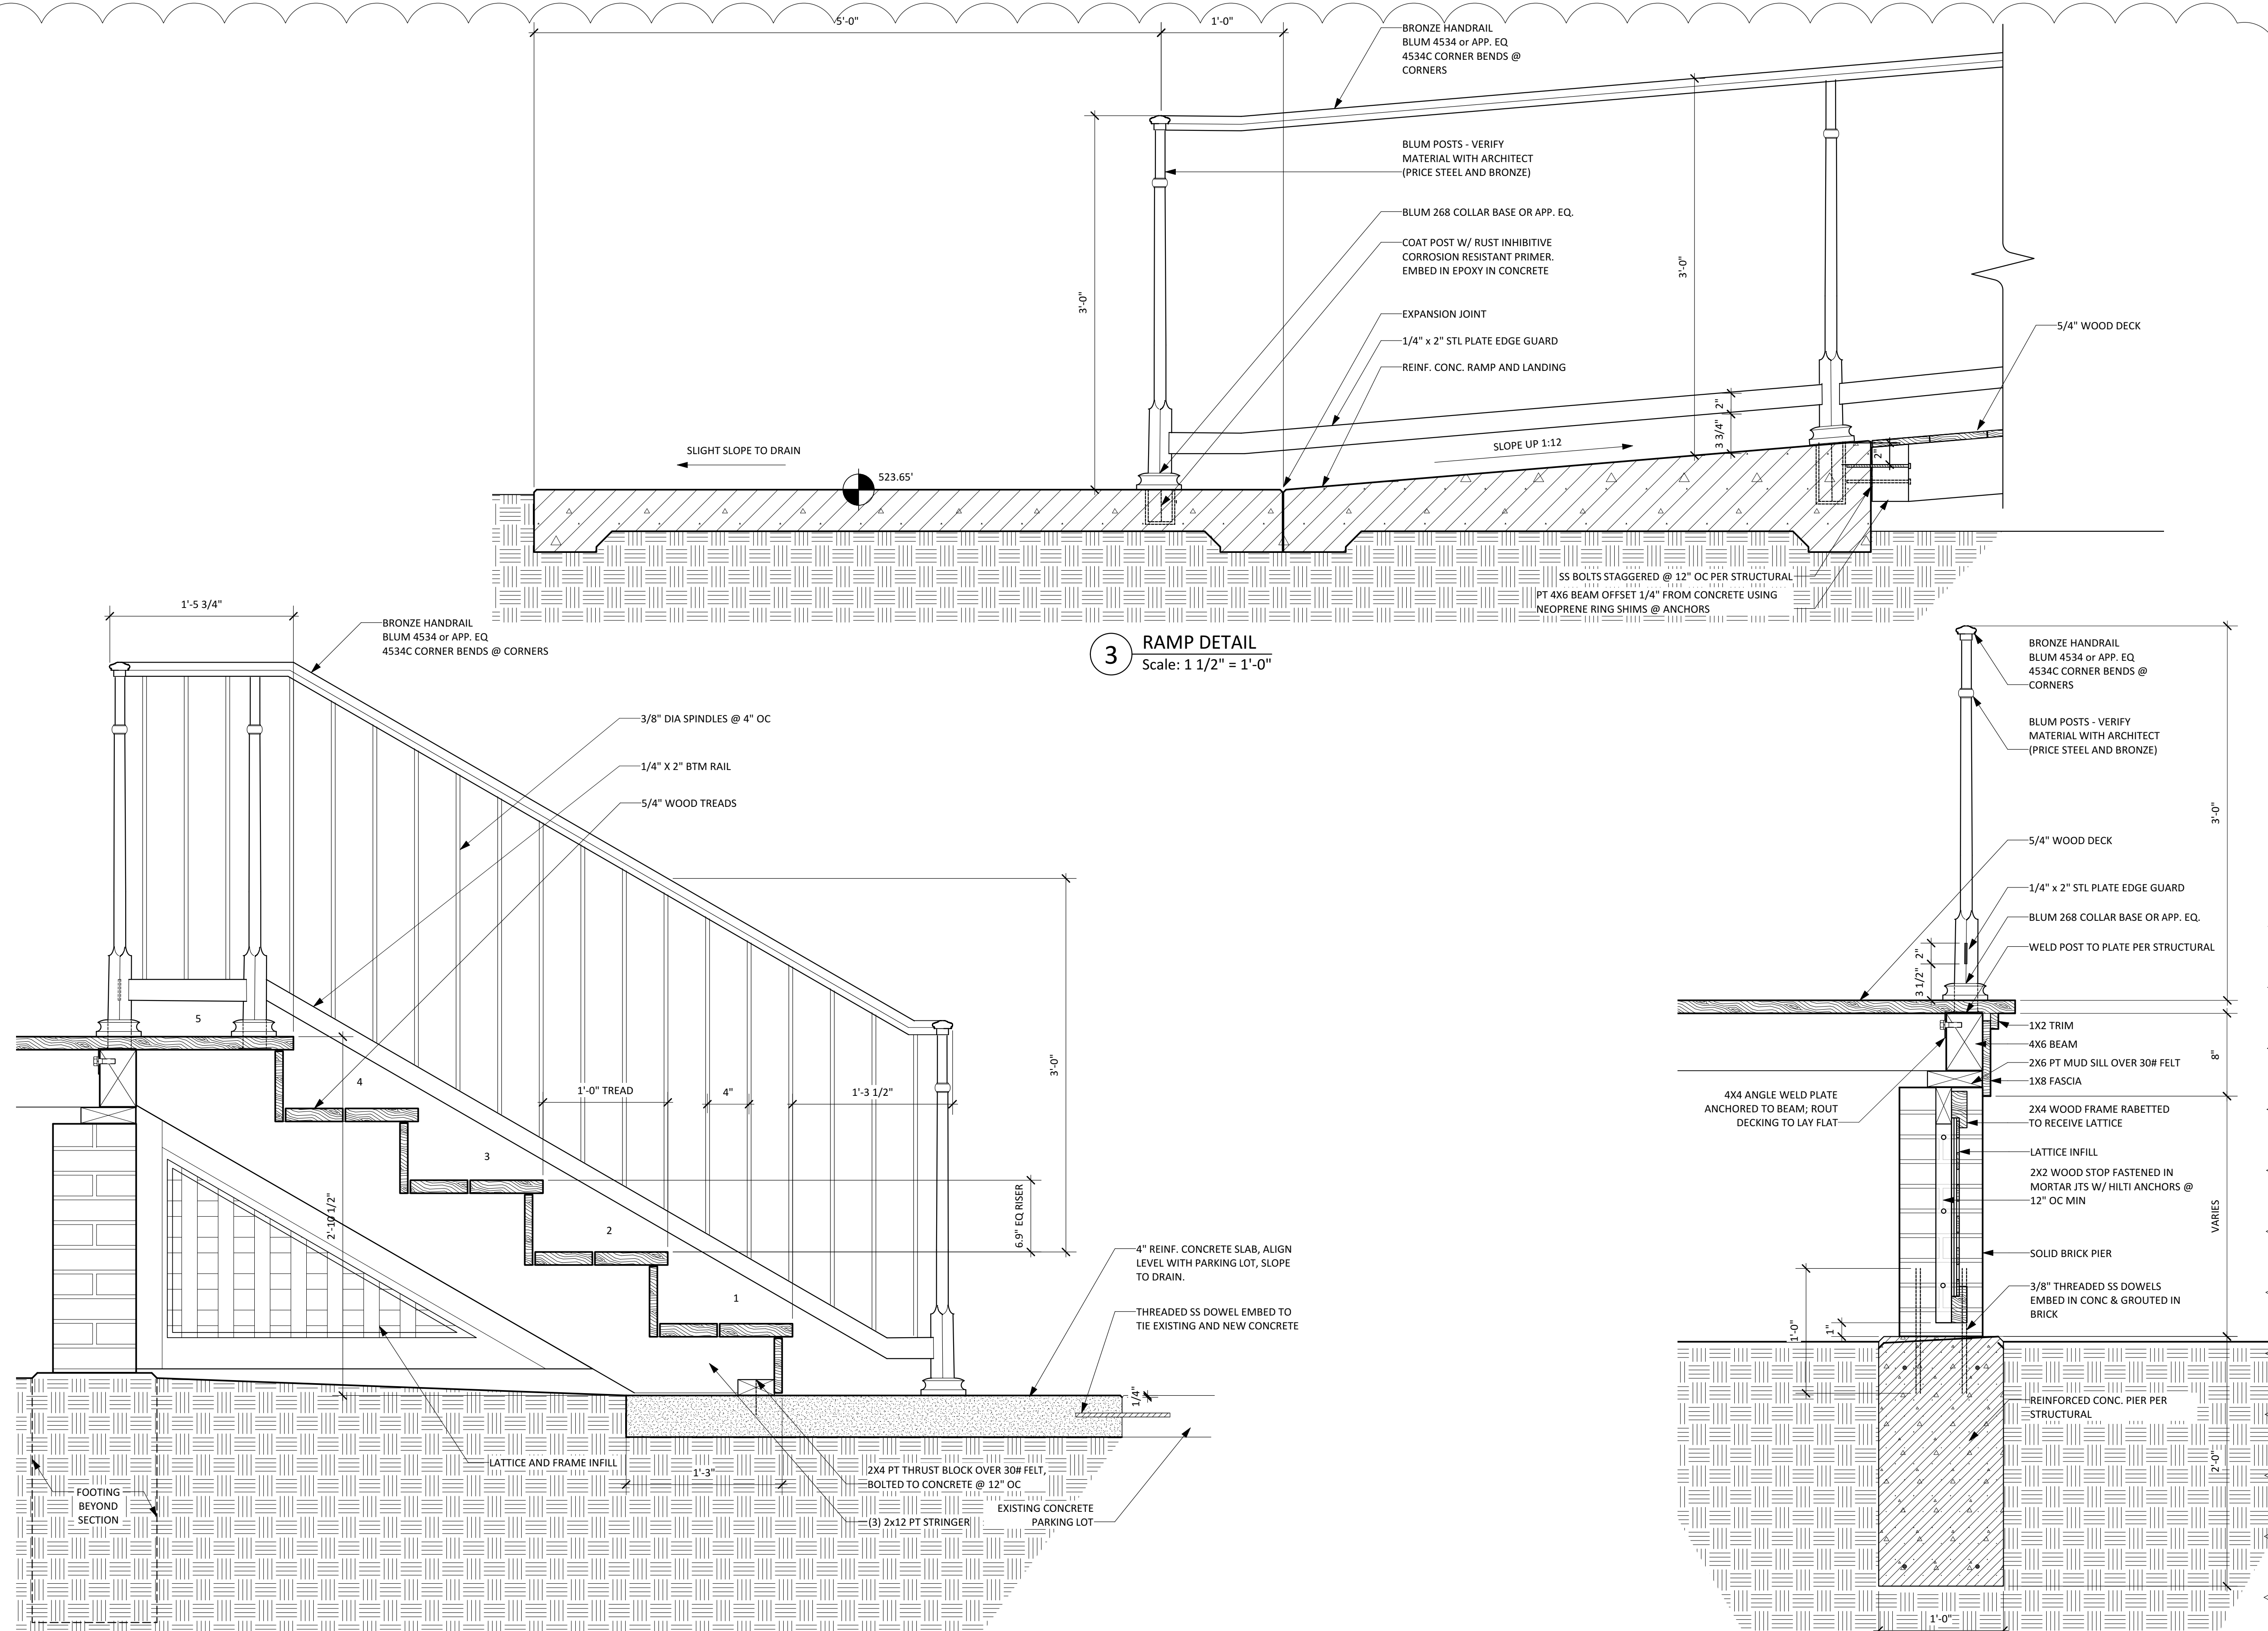

2 STAIR SECTION
Scale: 1 1/2" = 1'-0"



3 RAMP DETAIL
Scale: 1 1/2" = 1'-0"

1 RAILING AND PIER DETAIL
Scale: 1 1/2" = 1'-0"

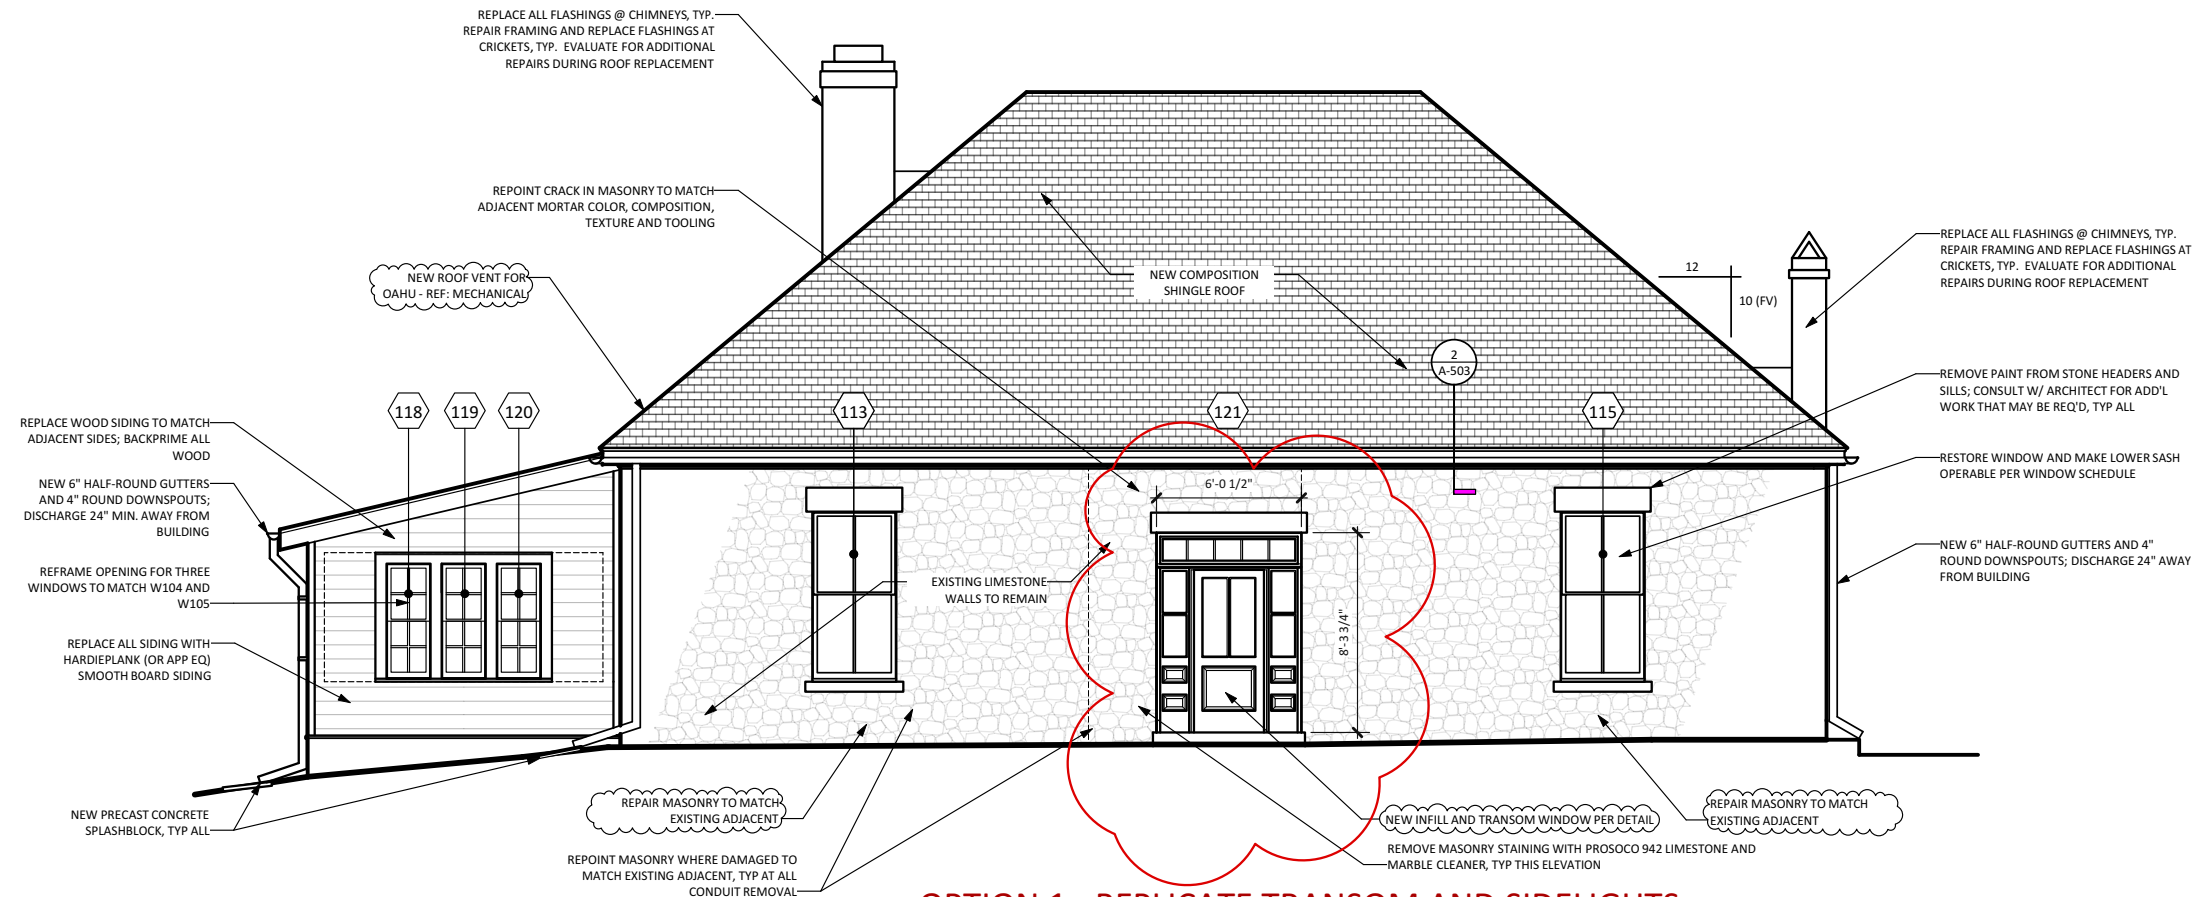


1 NORTH ELEVATION - OPTION 1
Scale: 1/8" = 1'-0"

**OPTION 1 - REPLICATE TRANSOM AND SIDELIGHTS
MAKE DOOR INOPERABLE**

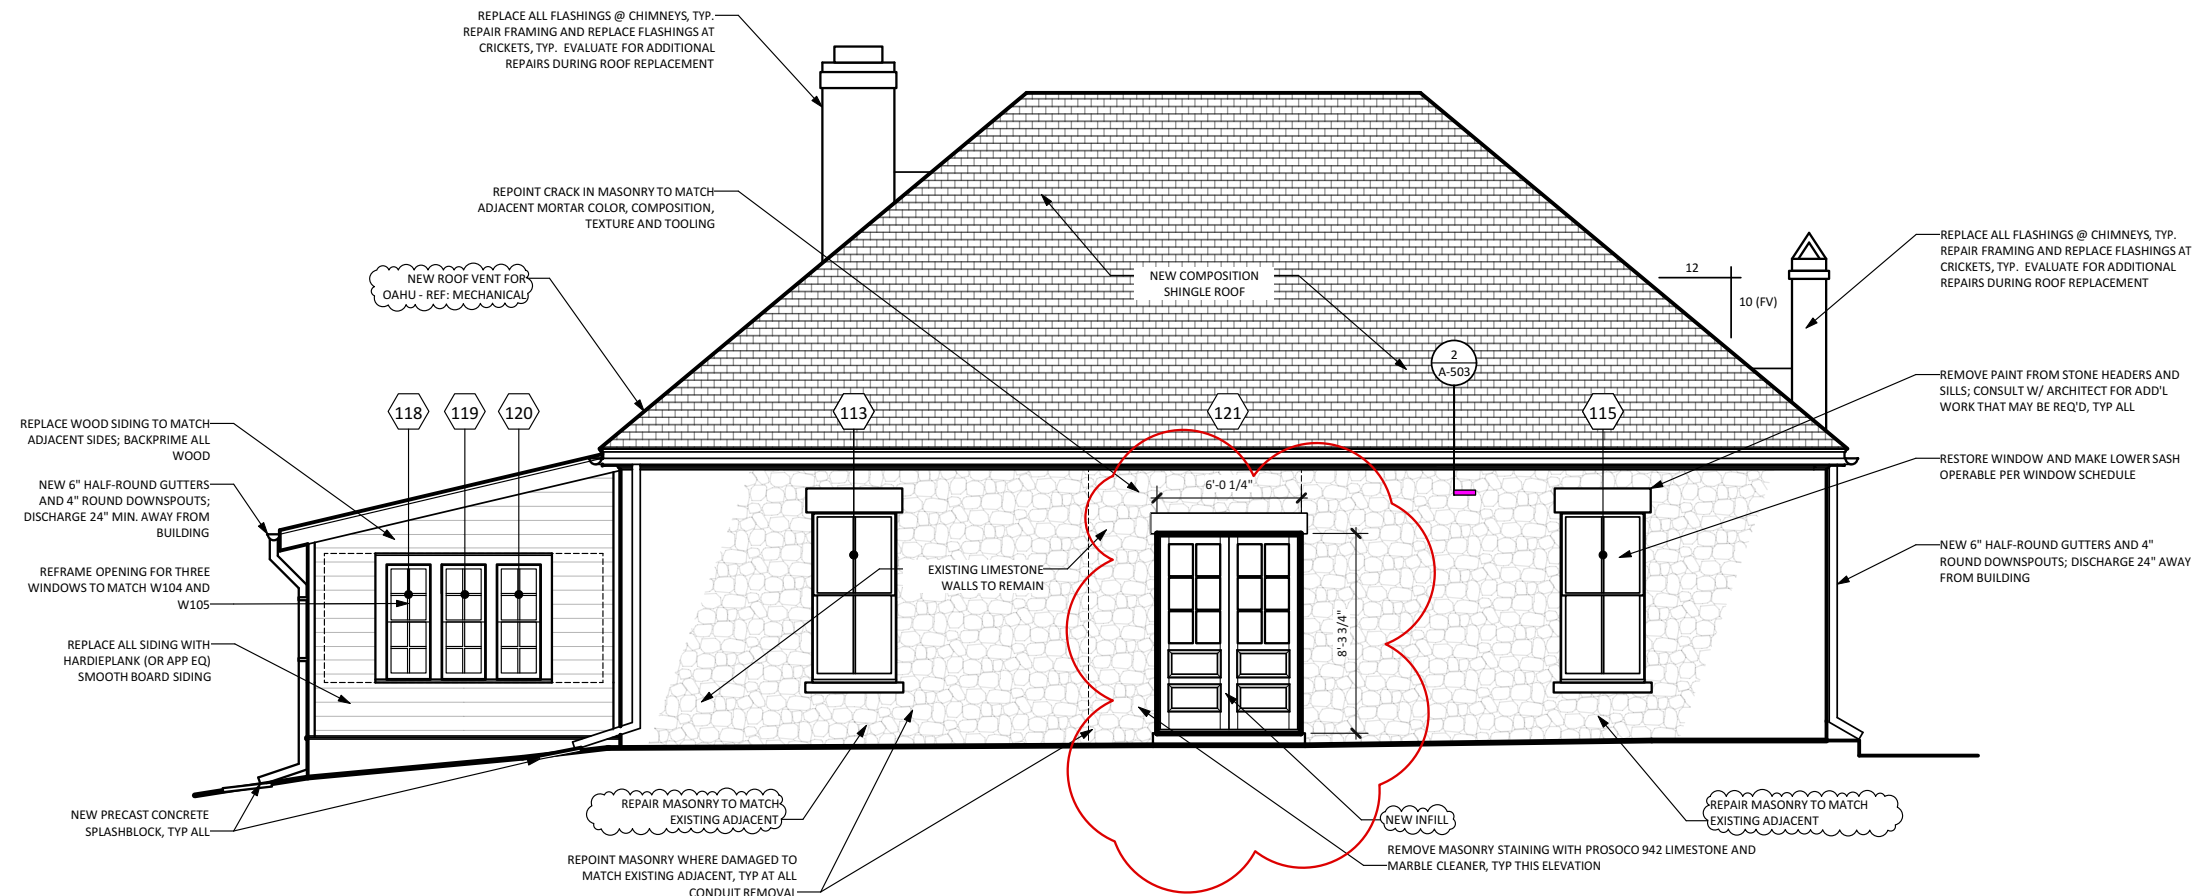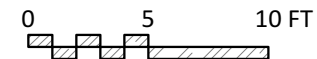

2 NORTH ELEVATION - OPTION 2
Scale: 1/8" = 1'-0"

**OPTION 2 - NEW INFILL IN PROPORTION TO THE NORTH ELEVATION WINDOWS
NO REAL HISTORIC REFERENCE. FROM INSIDE, CAN BE TRIMMED TO LOOK LIKE WINDOWS**

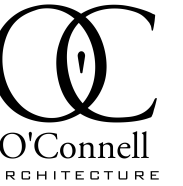

702 RIO GRANDE STREET
AUSTIN, TEXAS 78701
512.751.1374

TERESA O'CONNELL
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MESS HALL
RENOVATION
1105 CASTLE COURT, AUSTIN, TEXAS 78703

SUBMITTED TO HLC
FOR INPUT 3/17/20

SK-1