

## Architectural Site Plan & Awning Elevation General Notes:

- A. The dimensions on this sheet are based off of the face of finish material or masonry. All dimensions are to face of finish material, edge of awning, or centerline of support, unless otherwise noted.
- B. Contractor (GC) to field verify all dimensions prior to construction and/or installation of any equipment, accessories, etc. If a discrepancy is identified, notify NolanStudio immediately.
- C. Elevations are shown for reference only. Refer to Building Plans, Sections, Wall
- Sections and Window Elevations for additional information. D. All glass to be tempered in areas required by applicable code.
- E. Refer to appropriate sheet and/or schedule for additional information/detail regarding items shown herein.
- Keynotes located on this sheet are for this sheet only. G. Do not scale the drawings. If a specific dimension is not given, contact
- NolanStudio for clarification. H. Refer to Sheet A0.01-General Conditions for additional information associated
- with, but not limited to: submittals, shop drawings, samples, cutting and patching, coordination and staging, protection of work.

## Architectural Site Plan & Awning Elevation Key Notes:

I. Install all products per manufacturer's recommendations.

- Building mounted awning to match design of existing above entrance to building lobby. Coordinate with Building Owner for paint color & finish during construction.
- 3. Location, spacing, & size of overhead hanger and turn-buckle shown for
- reference only. Refer to Structural Drawings for specifications and layout. 4. Existing entrance to tenant space to remain.
- 5. Slope in existing sidewalk not shown here, vertical dimensions taken from interior finish floor of restaurant tenancy, coordinate with Owner during installation for height above sidewalk.
- 6. Existing window to remain, cover and protect throughout construction process as necessary.
- 7. Sign mounted to face of awning structure by others, shown here for reference only, coordinate with Building Owner and Restaurant Tenant for power and
- lighting specifications. 8. Existing entrance to building lobby to remain.
- 9. Estimated location of existing awning shown for clarity only; verify in field as




NOLAN


**STUDIO** 


708 Rio Grande

Austin Texas 78701

JANUARY 29, 2020

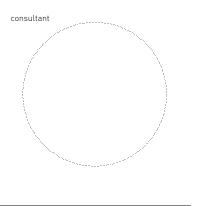

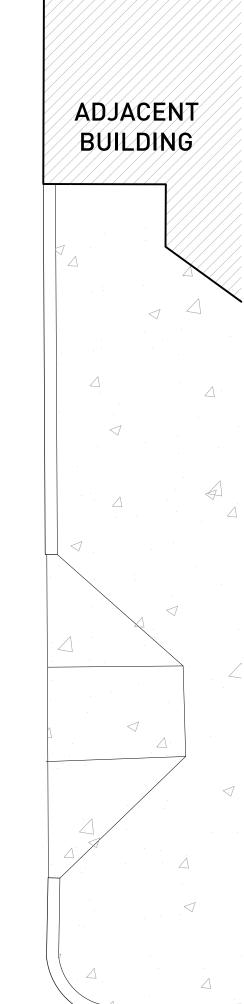

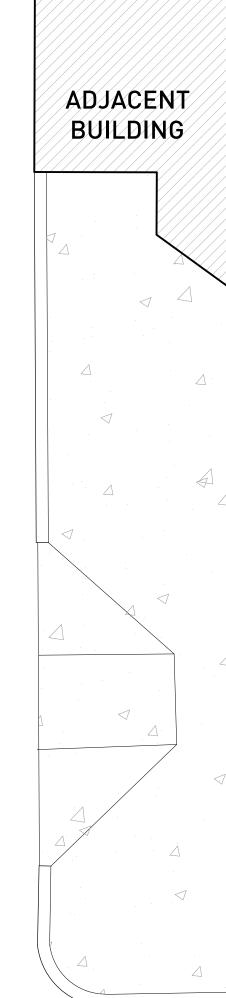

CITY OF AUSTIN


20' ALLEY

CONSTRUCTION SET

JANUARY 29, 2020

AWNING PLAN & ELEVATION

This drawing and all copyright therein are the sole and exclusive property of NolanStudio. Reproduction or use of this drawing in whole or part by any means in any way whatsoever without the prior written consent of NolanStudio is strictly prohibited.

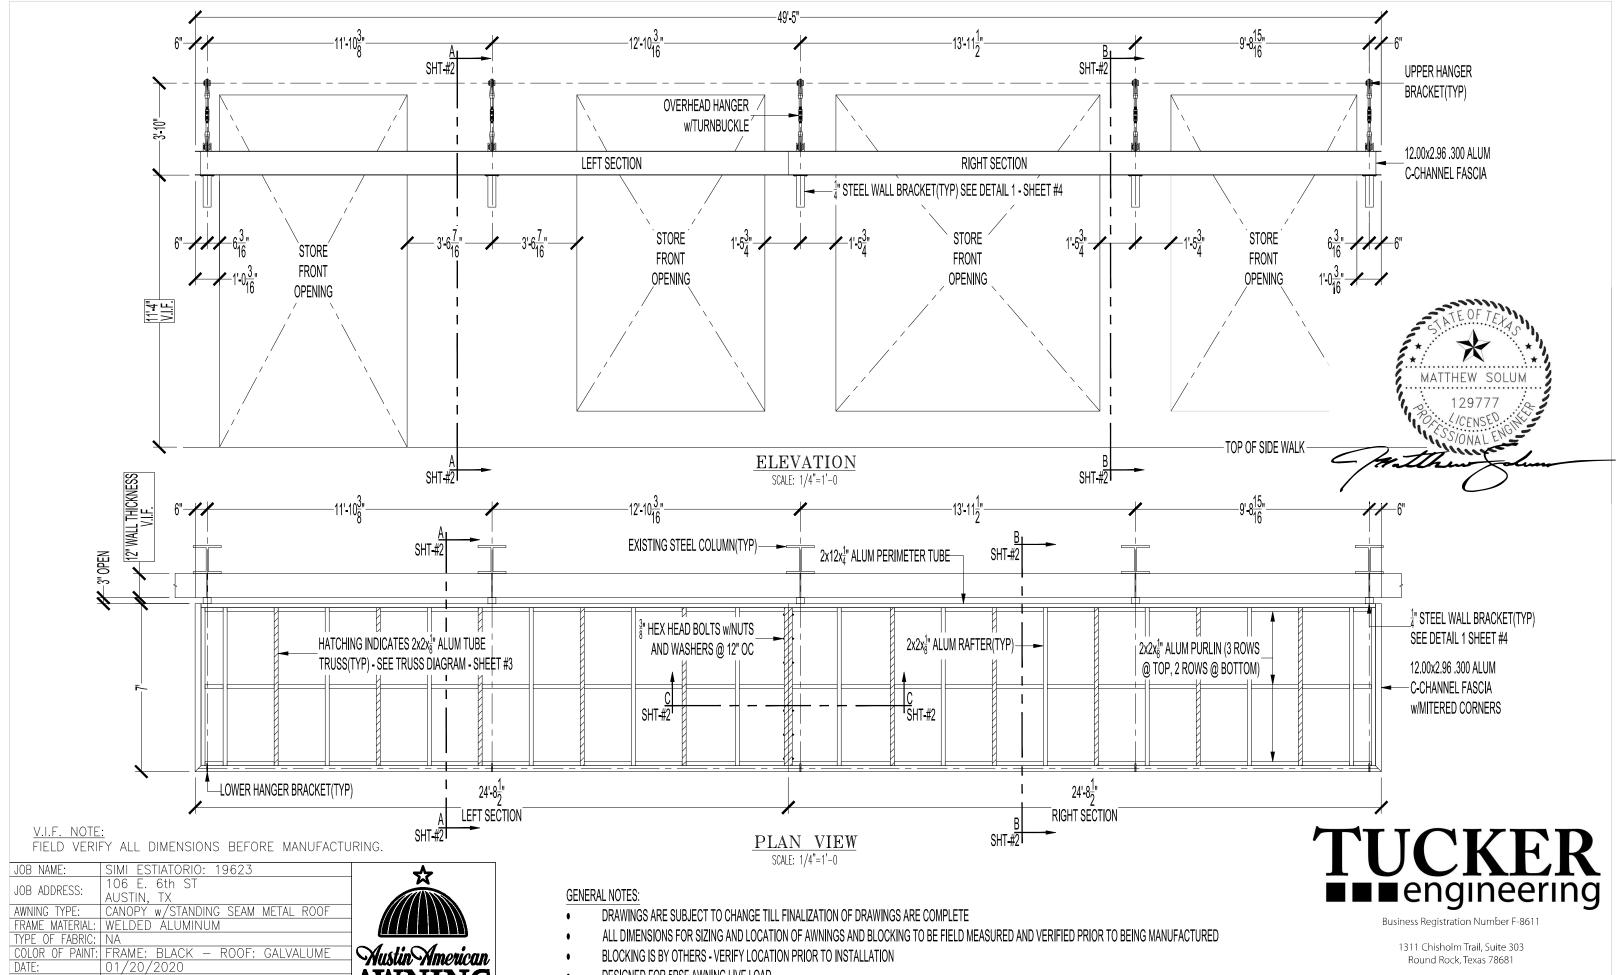


AJK #1 of 4 This document and the information contained within is confidential and is the property of Austin American Awning. It cannot be copied or disclosed in whole or in part without the express written consent of Austin American Awning.


DRAWN BY


600 E SAINT ELMO RD, AUSTIN TX 78745 TEL:(512)326-1670 FAX:(512)326-1658 WWW.AUSTINAWNING.COM


- DESIGNED FOR 5PSF AWNING LIVE LOAD
- RISK CATEGORY 1, 110 MPH WIND SPEED, 20PSF UPLIFT


(512) 255-7477 tuckerengineering.net

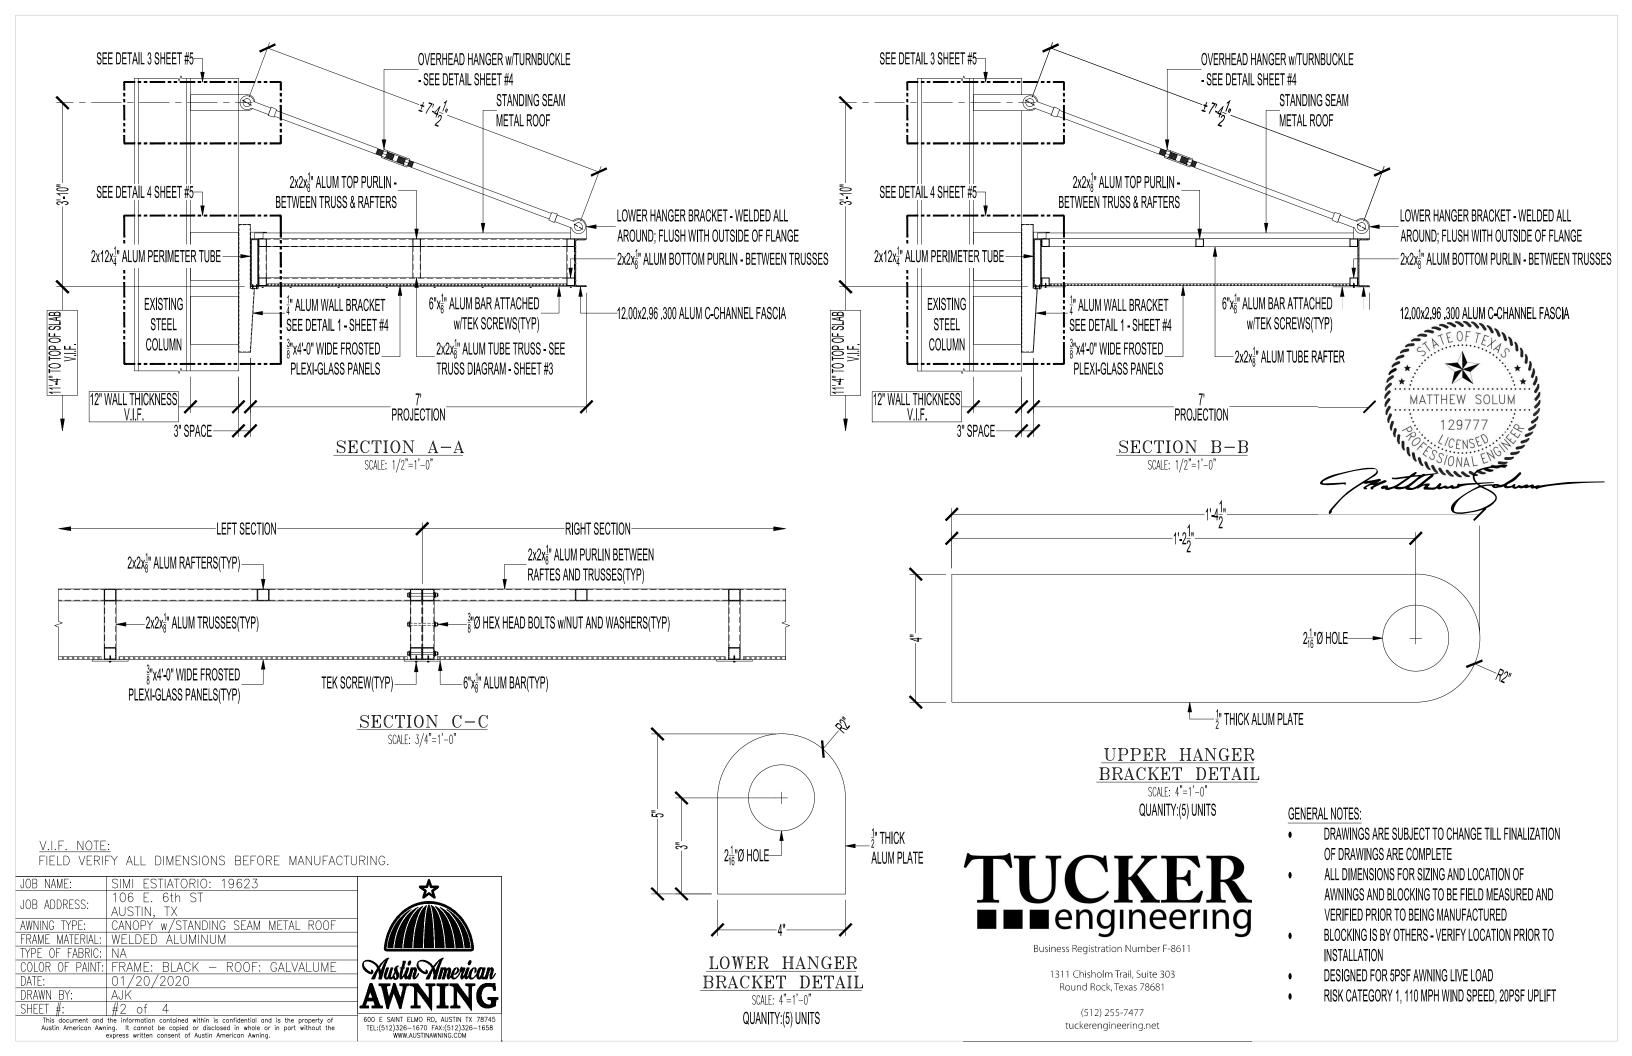

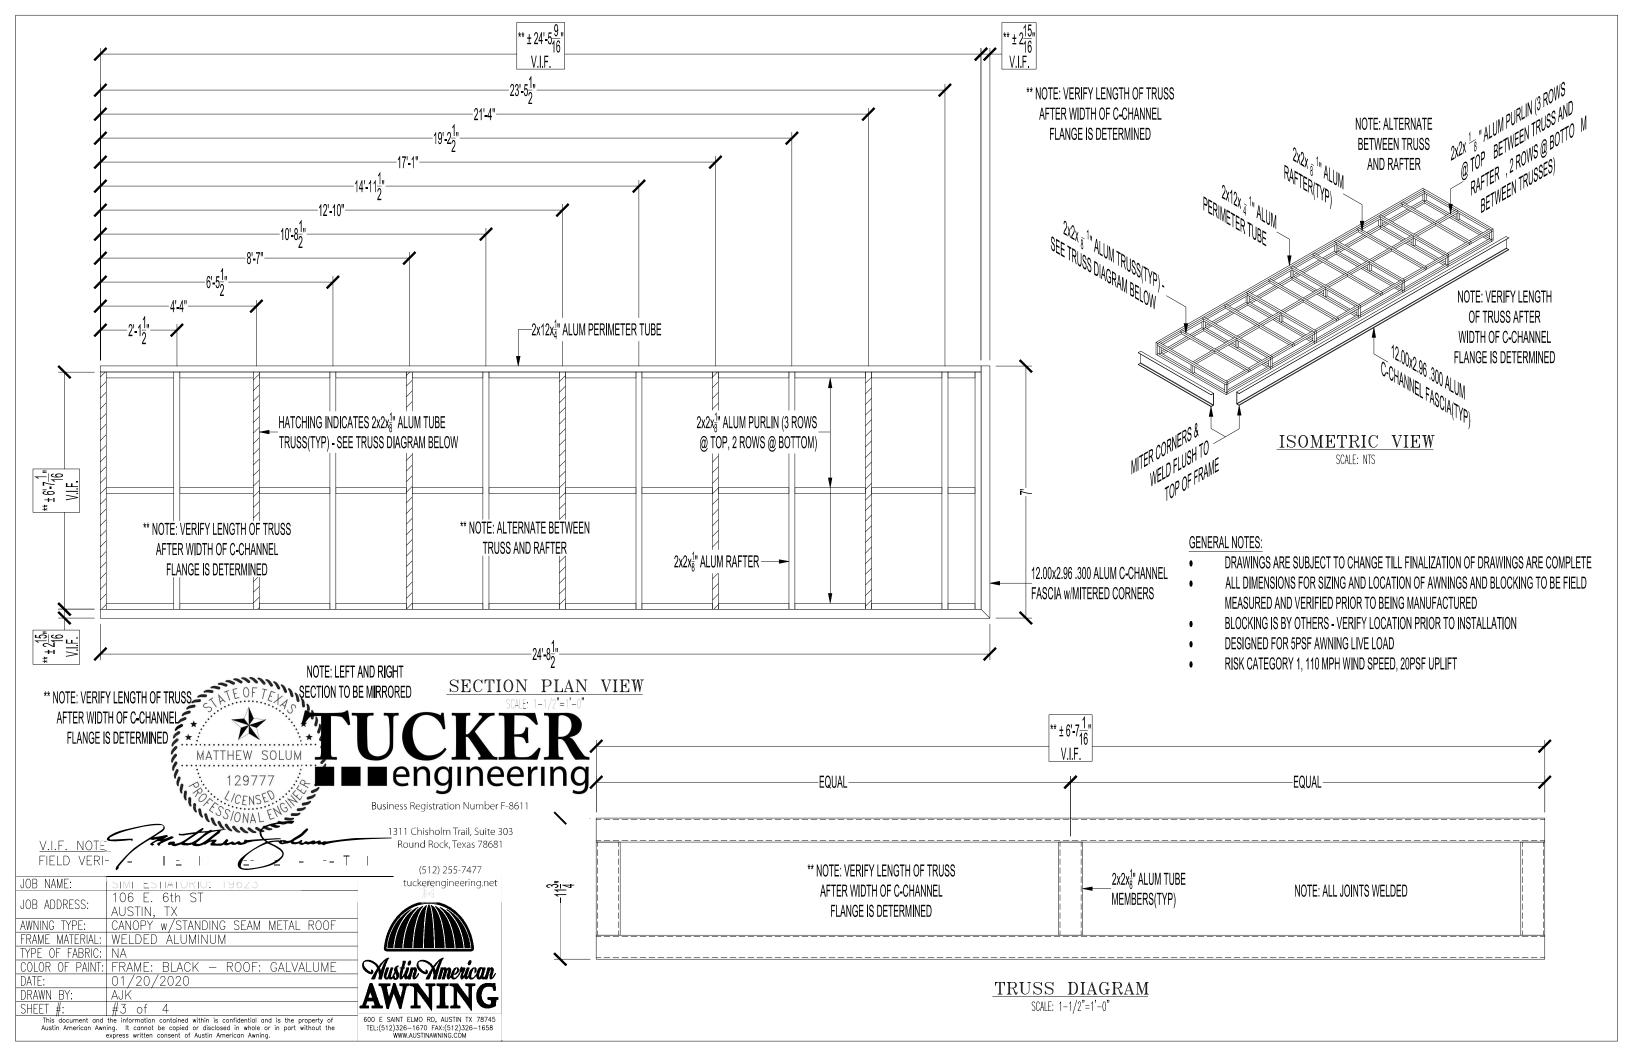

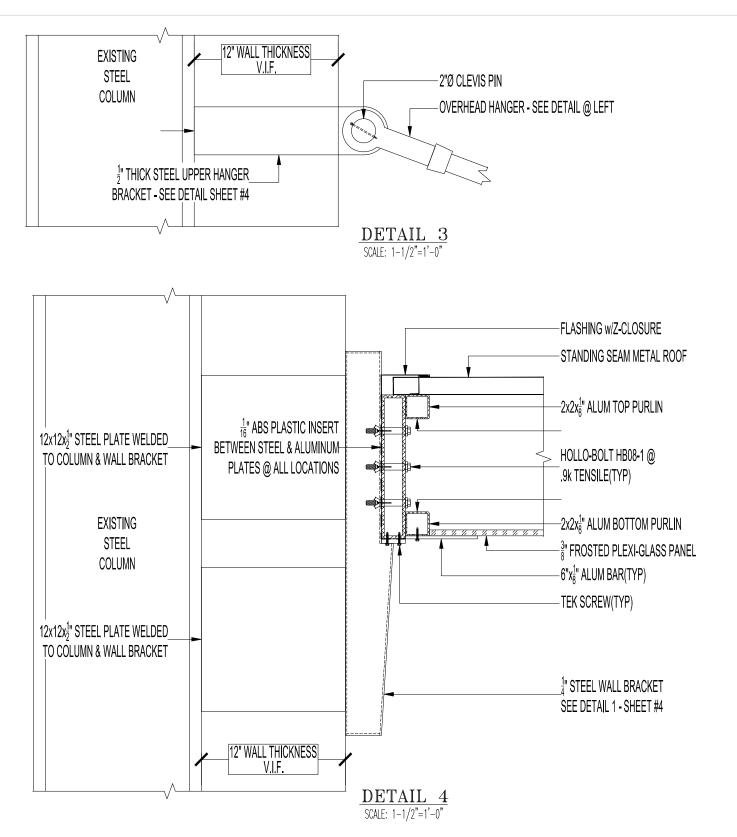

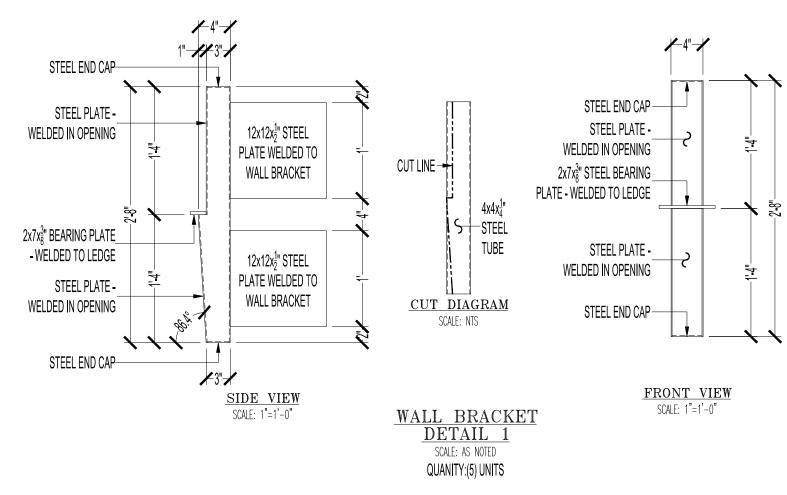

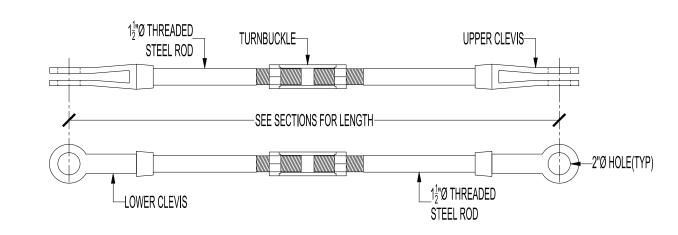

SCALE: NTS

V.I.F. NOTE: FIELD VERIFY ALL DIMENSIONS BEFORE MANUFACTURING.

JOB NAME:	SIMI ESTIATORIO: 19623	<b>~</b>
JOB ADDRESS:	106 E. 6th ST	N N
JOD ADDINESS.	AUSTIN, TX	
AWNING TYPE:	CANOPY w/STANDING SEAM METAL ROOF	
FRAME MATERIAL:	WELDED ALUMINUM	<i>([1111</i> 1111\
TYPE OF FABRIC:	NA	
COLOR OF PAINT:	FRAME: BLACK - ROOF: GALVALUME	Mustin American
DATE:	01/20/2020	21000101 21010 110 0001
DRAWN BY:	AJŔ	AWNING
SHEET #:	#4 of 4	<b>17111110</b>
This document and the information contained within is confidential and is the property of Austin American Awning. It cannot be copied or disclosed in whole or in part without the		600 E SAINT ELMO RD, AUSTIN TX 78745 TEL:(512)326-1670 FAX:(512)326-1658
	express written consent of Austin American Awning.	WWW.AUSTINAWNING.COM

## GENERAL NOTES:

- DRAWINGS ARE SUBJECT TO CHANGE TILL FINALIZATION OF DRAWINGS ARE COMPLETE
- ALL DIMENSIONS FOR SIZING AND LOCATION OF AWNINGS AND BLOCKING TO BE FIELD MEASURED AND VERIFIED PRIOR TO BEING MANUFACTURED
- BLOCKING IS BY OTHERS VERIFY LOCATION PRIOR TO INSTALLATION
- DESIGNED FOR 5PSF AWNING LIVE LOAD
- RISK CATEGORY 1, 110 MPH WIND SPEED, 20PSF UPLIFT



■engineering

Business Registration Number F-8611

1311 Chisholm Trail, Suite 303 Round Rock, Texas 78681

(512) 255-7477 tuckerengineering.net