

#### **Historic Review Application**

For Office Use Only
Date of Submission:
Plan Review #:

Property Address:					
Historic Landmark	Historic District (Local)	National Register Historic District			
Historic Landmark or Historic District Name:					
Applicant Name:	Phone #:	Email:			
Applicant Address:	City:	State:	Zip:		
Please describe all proposed exterior work with location and materials. If you need more space, attach an additional sheet.					
PROPOS	ED WORK	LOCATION OF PROPOSED WORK	PROPOSED MATERIAL(S)		

2)	
3)	 

#### Submittal Requirements

1. One set of dimensioned building plans. Plans must: a) specify materials and finishes to be used, and b) show existing *and* proposed conditions for alterations and additions.

Site Plan Elevations Floor Plan Roof Plan

2. Color photographs of building and site:


Elevation(s) proposed to be modified

Detailed view of each area proposed to be modified

Any changes to these plans must be reviewed and approved by the Historic Preservation Office and/or Historic Landmark Commission.

Applicant Signature: \_\_\_\_\_


### SITE LOCATION MAP

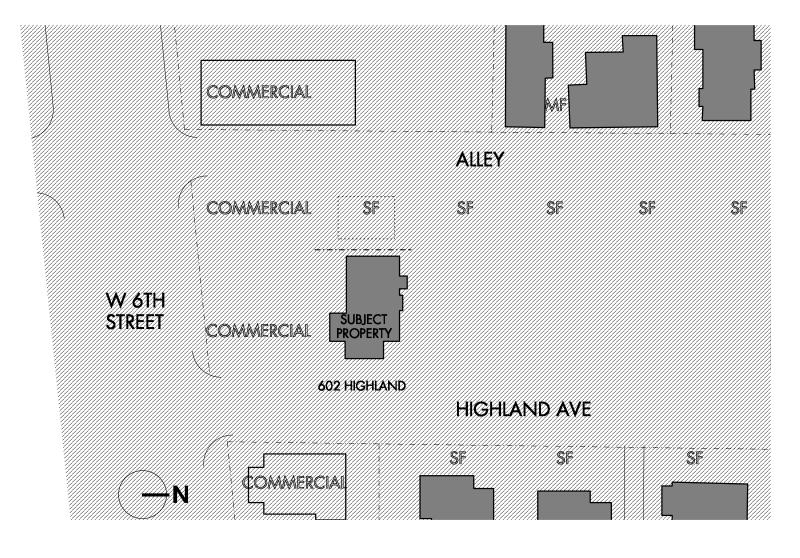

SUBJECT PROPERTY IS ONE LOT IN FROM W 6TH STREET WITH A COMMERCIAL PROPERTY TO THE SOUTH AND REAR, AND A SINGLE FAMILY PROPERTY TO THE NORTH

PROPERTY WAS CONDO'D INTO A FRONT AND REAR UNIT. UNIT 1 REPRESENTS SUBJECT PROPERTY. UNIT 2 IS A FUTURE CONSTRUCTION NOT YET PERMITTED.

### CONDO SITE ALLOCATIONS

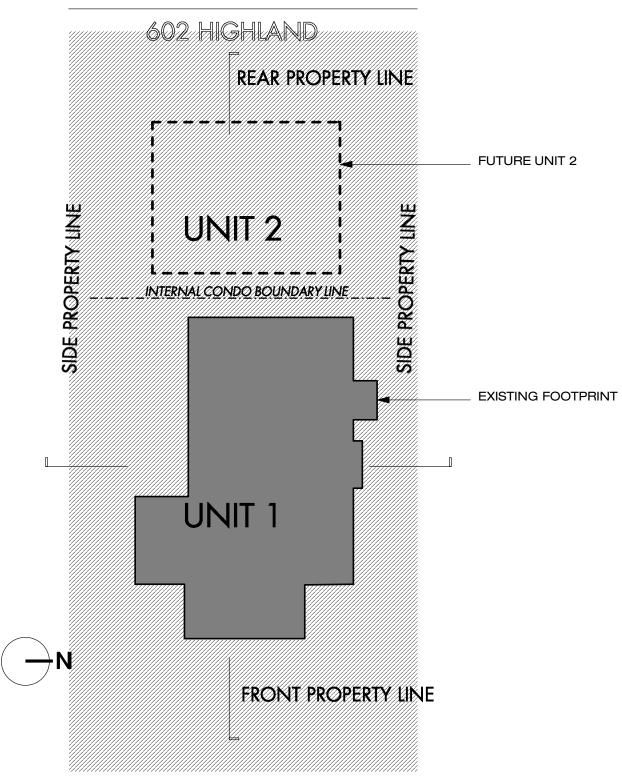

# HIGHLAND AVE. 2ND FLOOR ADDITION 602 HIGHLAND AVE. AUSTIN, TEXAS 78703


### FLOOR AREA RATIO & IMPERVIOUS COVERAGE BREAKDOWNS

	MAX ALLOWABLE	CONDO'D MAX		PROPOSED UNIT 1
	FOR FUTURE LOT	UNIT 1	UNIT 2	(subject property)
FAR	2829 sf	1769 sf	1060 sf	1769 sf (incl 1345 sf basement exemption)
IMPERVIOUS COVER	3182 sf	2198 sf	984 sf	2190 sf

CONSTRUCTION ALLOWANCES/LIMITATIONS PER CONDOMINIUM DOCUMENTS

	Unit 1		Unit 2		Combined Total	
	Sq. Ft.	%	Sq. Ft.	%	Sq. Ft.	%
Maximum Floor Area Ratio (FAR)	1,769	25.0%	1,060	15.0%	2,829	40.0%
Maximum Impervious Coverage	2,198	31.1%	984	13.9%	3,182	45.0%

## TRANSVERSE SITE SECTION

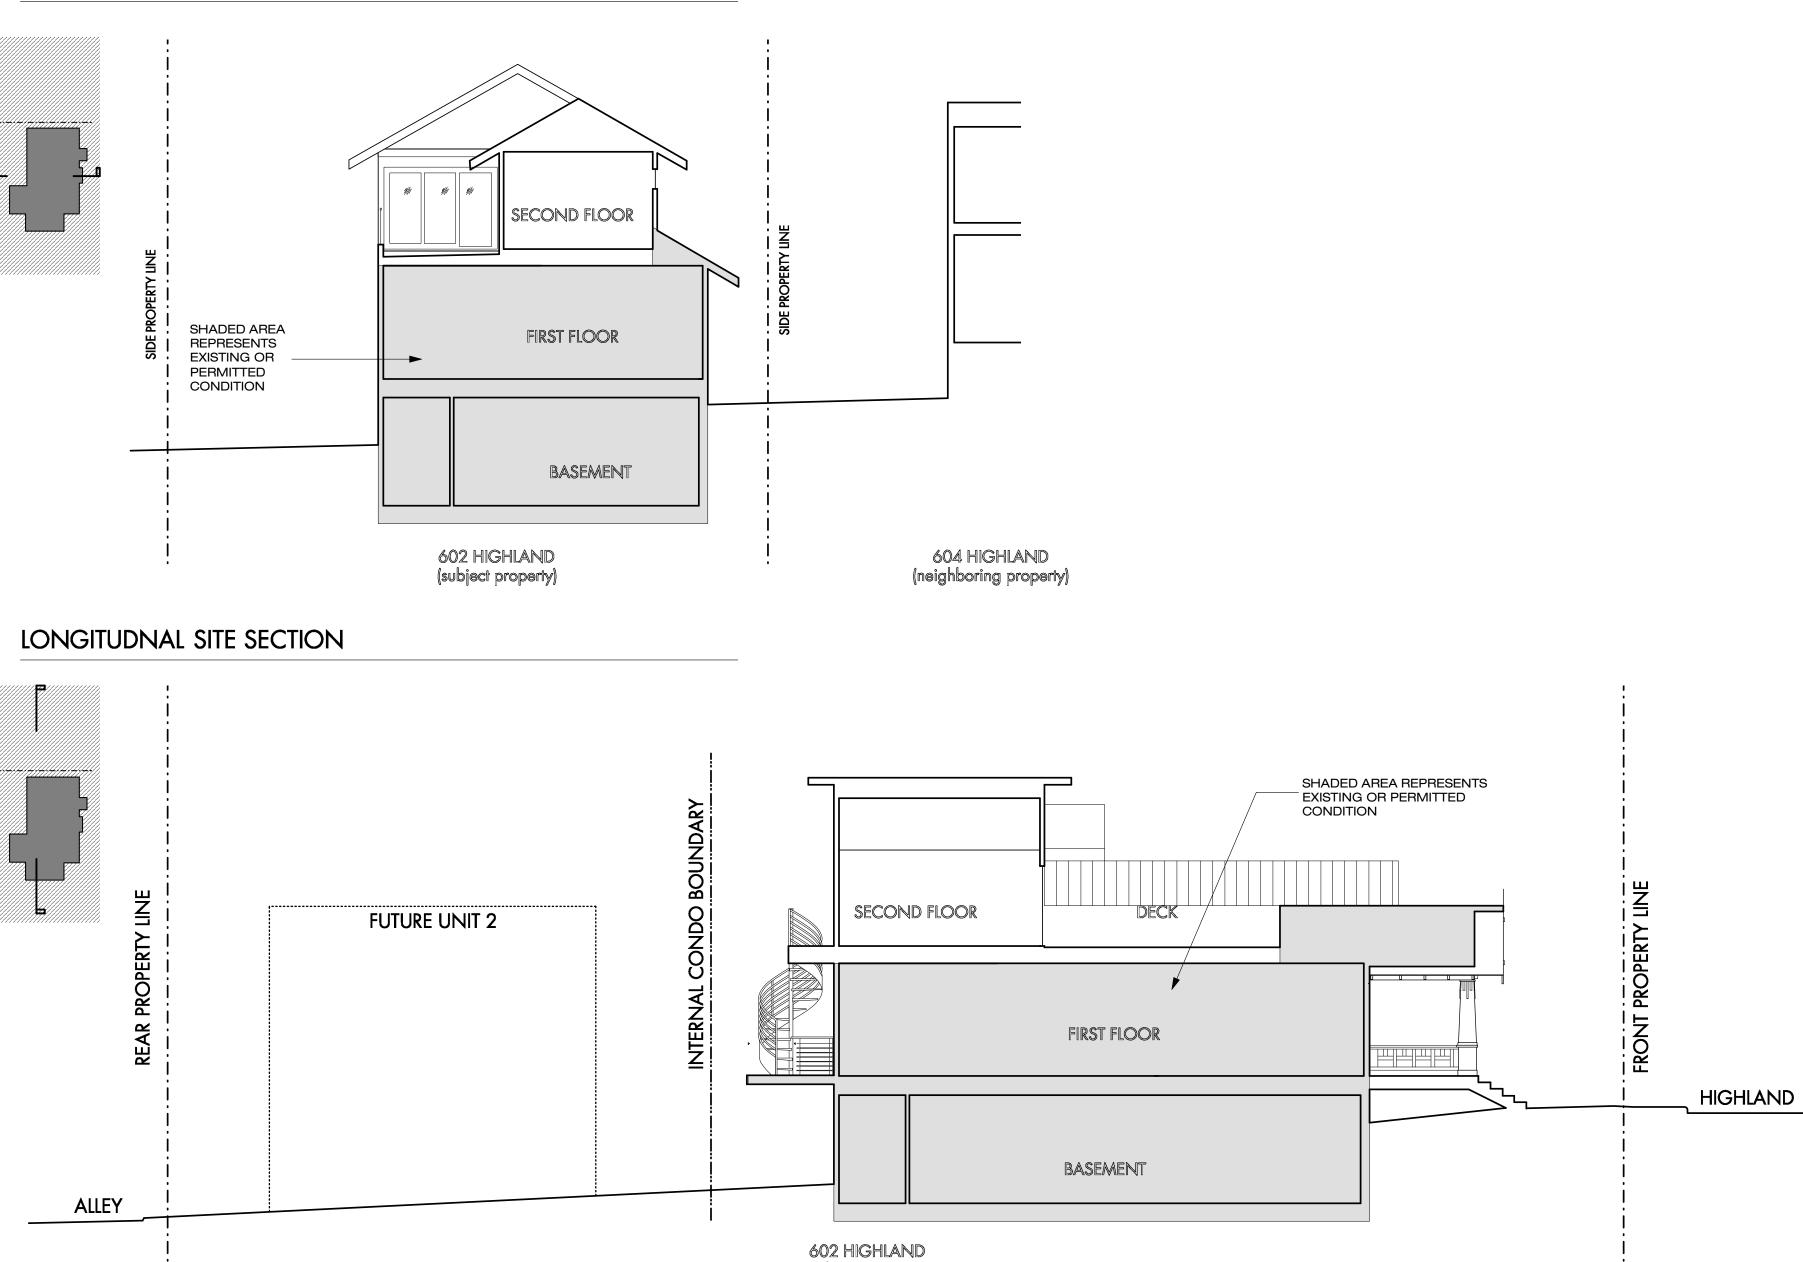

(subject property)

### PROJECT DESCRIPTION


ADDITION OF SECOND FLOOR OFFICE AND DECK TO EXISTING SINGLE FAMILY RESIDENCE.

## **PROJECT TEAM**

CLIENT CONTACT: CLAYTON SIGNOR 602 HIGHLAND AVE. AUSTIN, TX 78703 PH: (XXX) XXXXXX E-MAIL: CLAYTON@TXPILE.COM

STRUCTURAL ENGINEER MJ STRUCTURES CONTACT: RICHARD MARTIN 812 SAN ANTONIO ST. AUSTIN, TX 78701 PH: (512) 693-9500 E-MAIL: RICHARD@MJSTRUCTURES.COM

ARCHITECT DESIGNTRAIT CONTACT: BECKY JEANES 2525 SOUTH LAMAR STE #6 AUSTIN, TX 78704 PH: (512) 542-0073 E-MAIL: BECKY@DESIGNTRAIT.COM

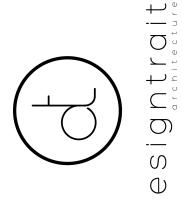

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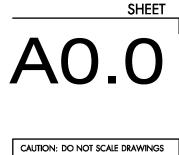
Addition 502 Highland Ave. Austin, TX 78703 602 Floor 2nd σ

Highlan


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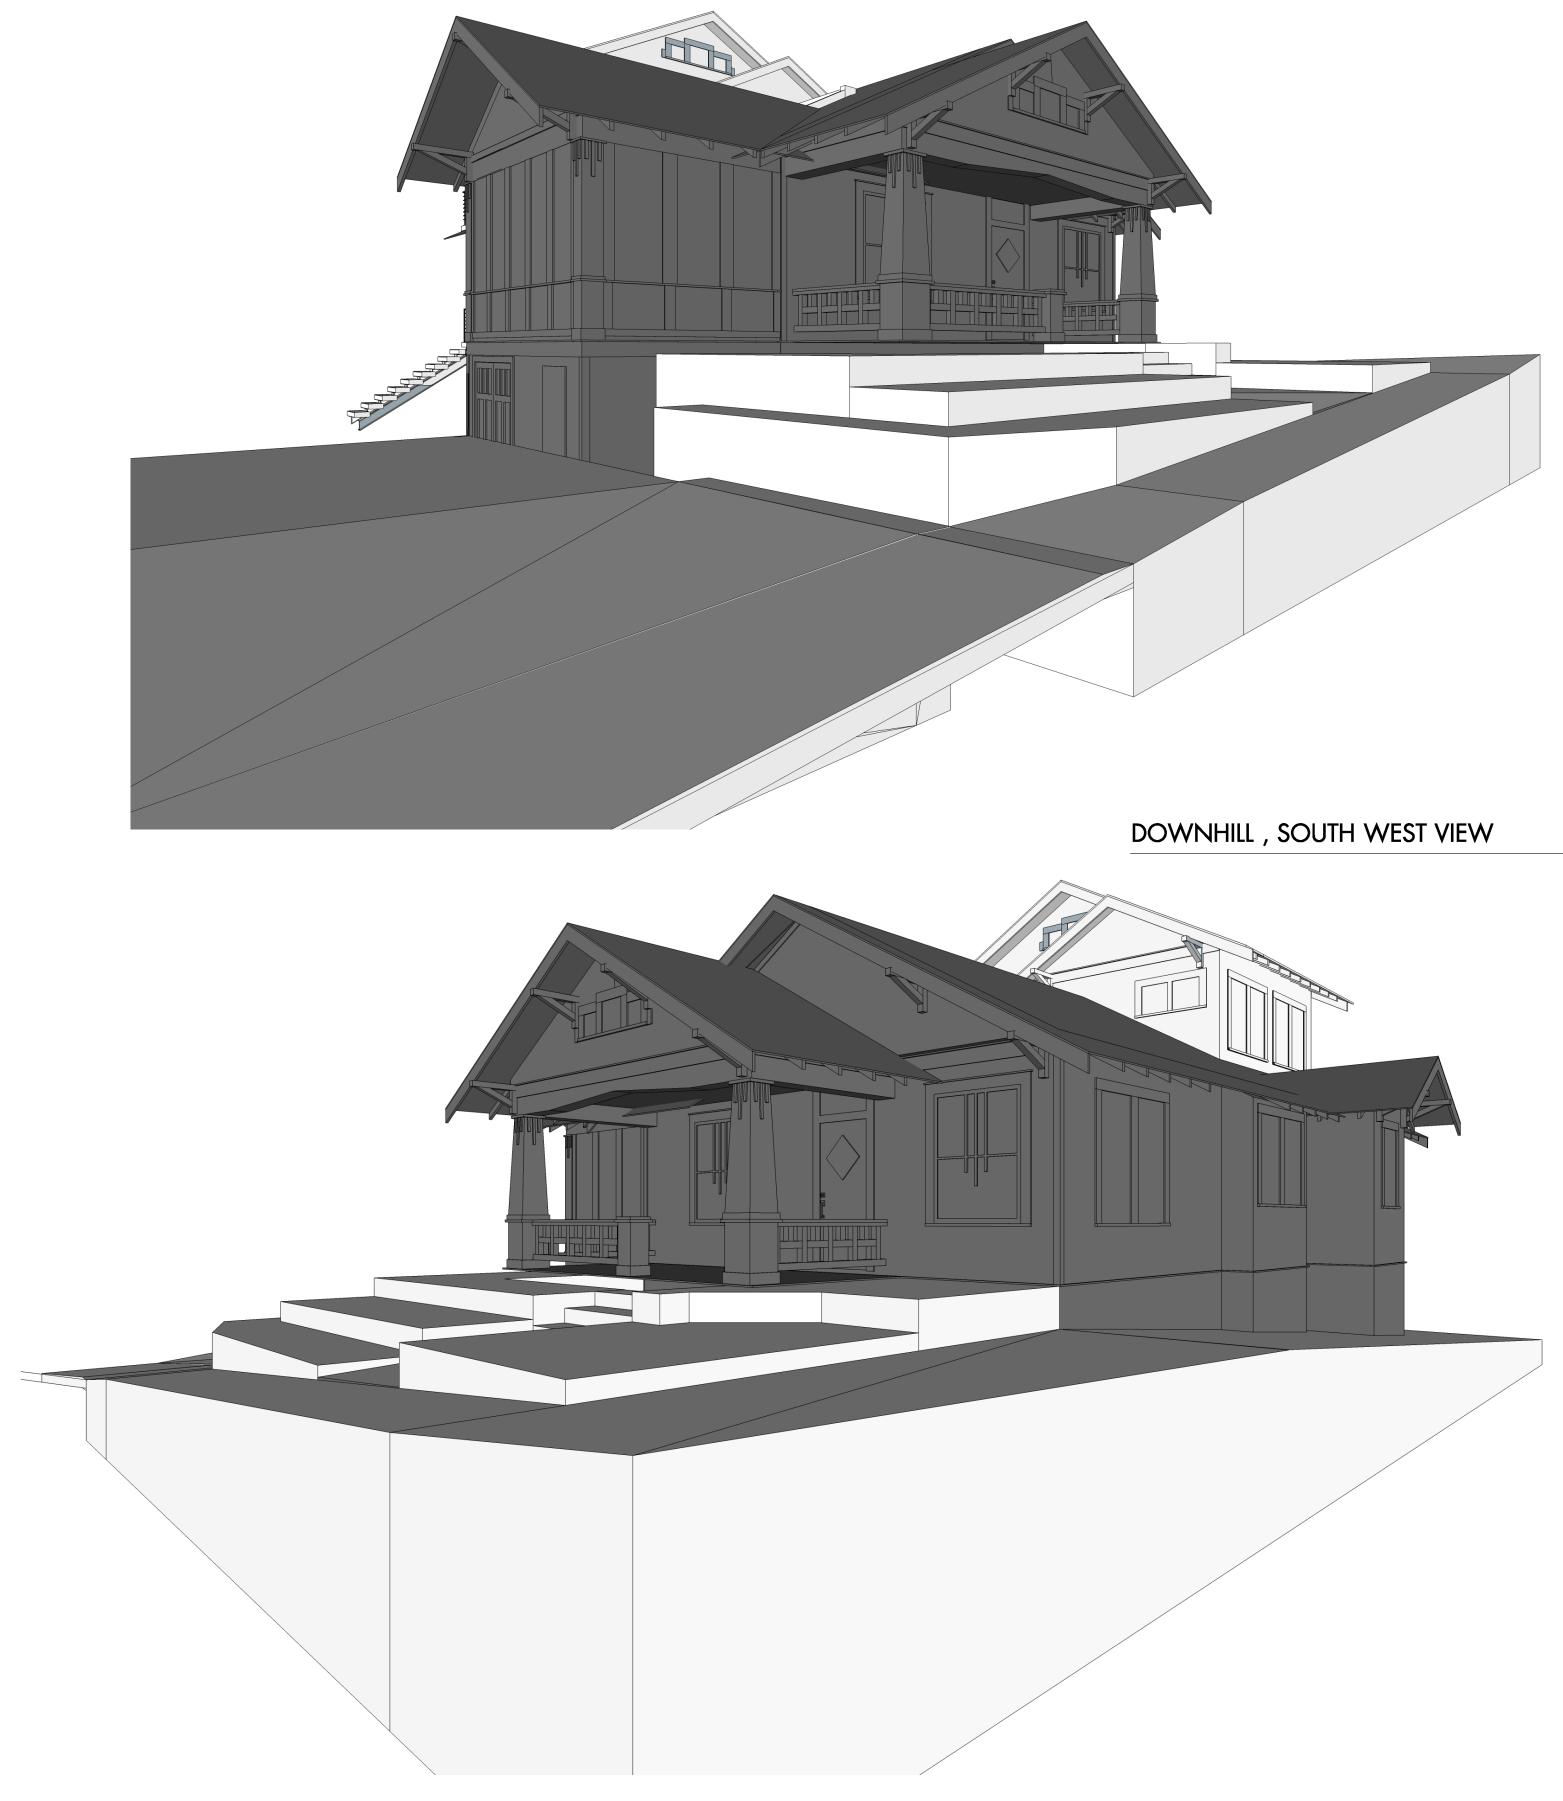
SHEET TITLE COVER SHEET

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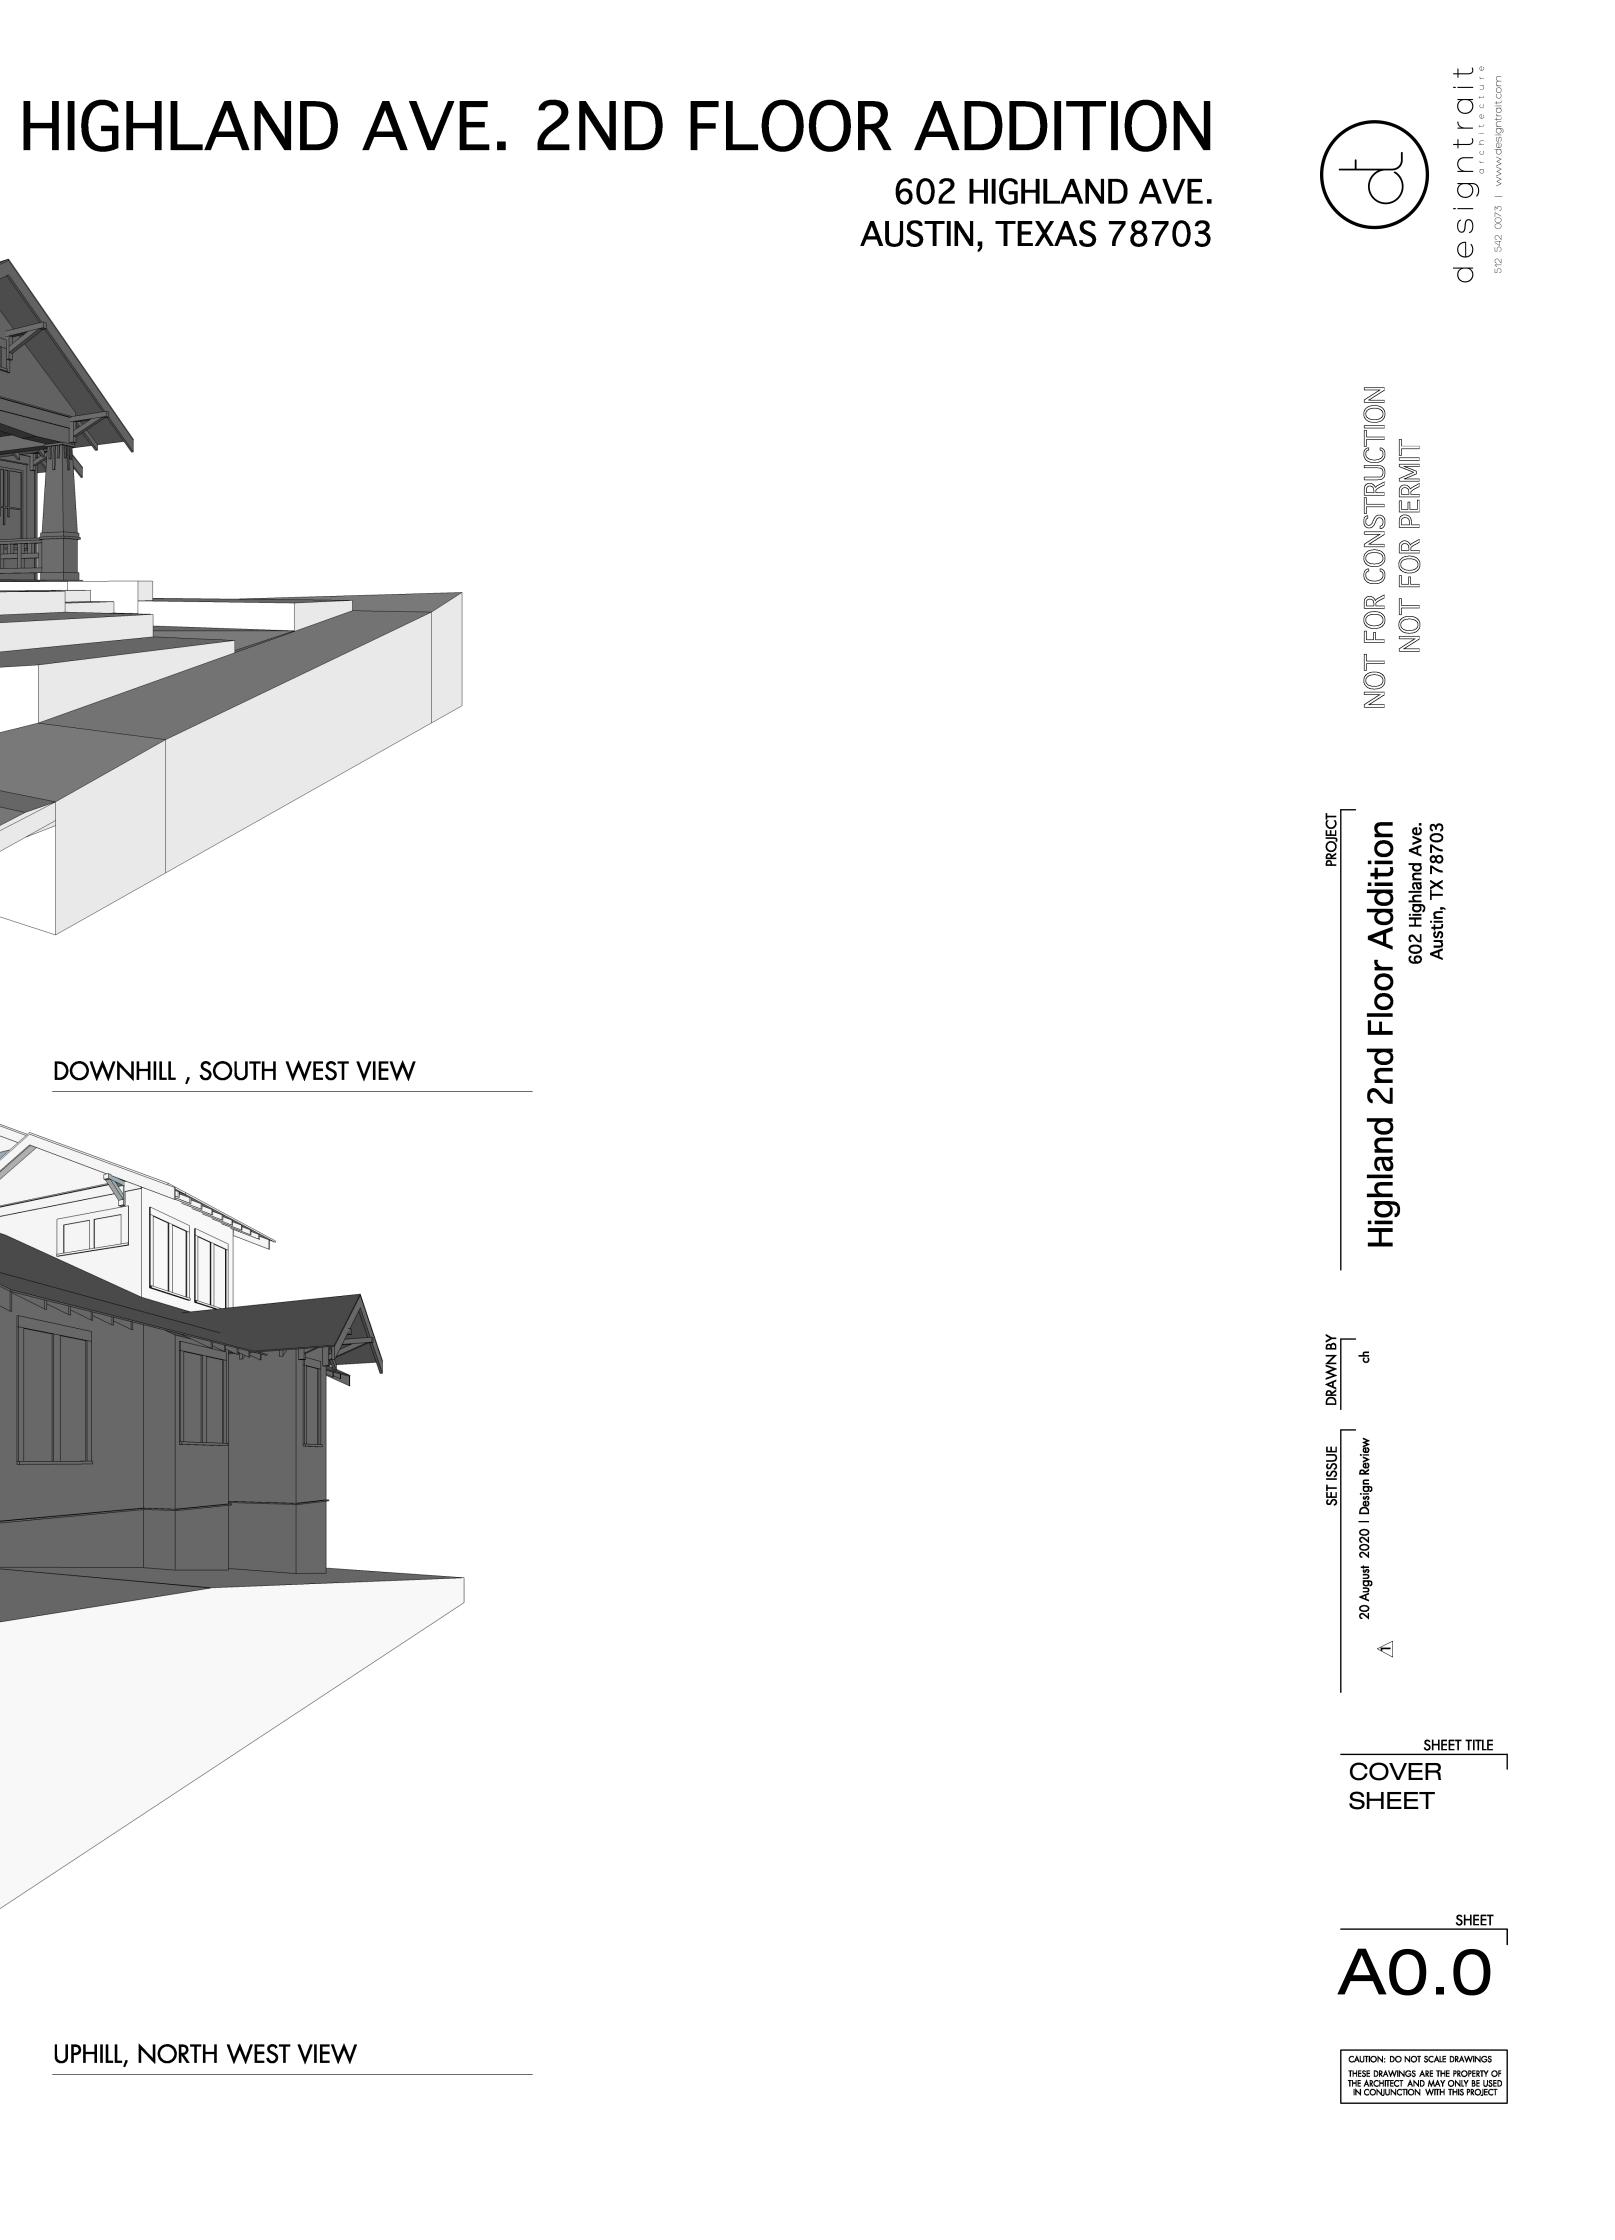



THESE DRAWINGS ARE THE PROPERTY OF THE ARCHITECT AND MAY ONLY BE USED IN CONJUNCTION WITH THIS PROJECT



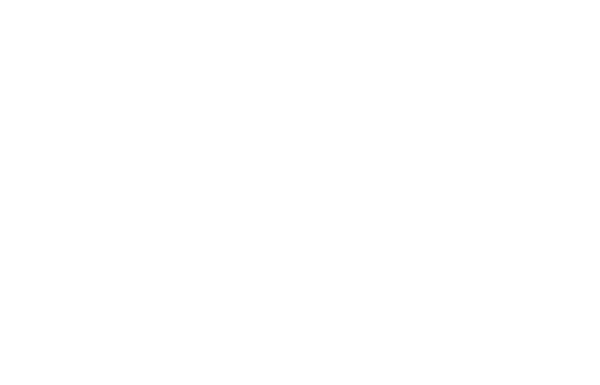

UPHILL, NORTH WEST VIEW



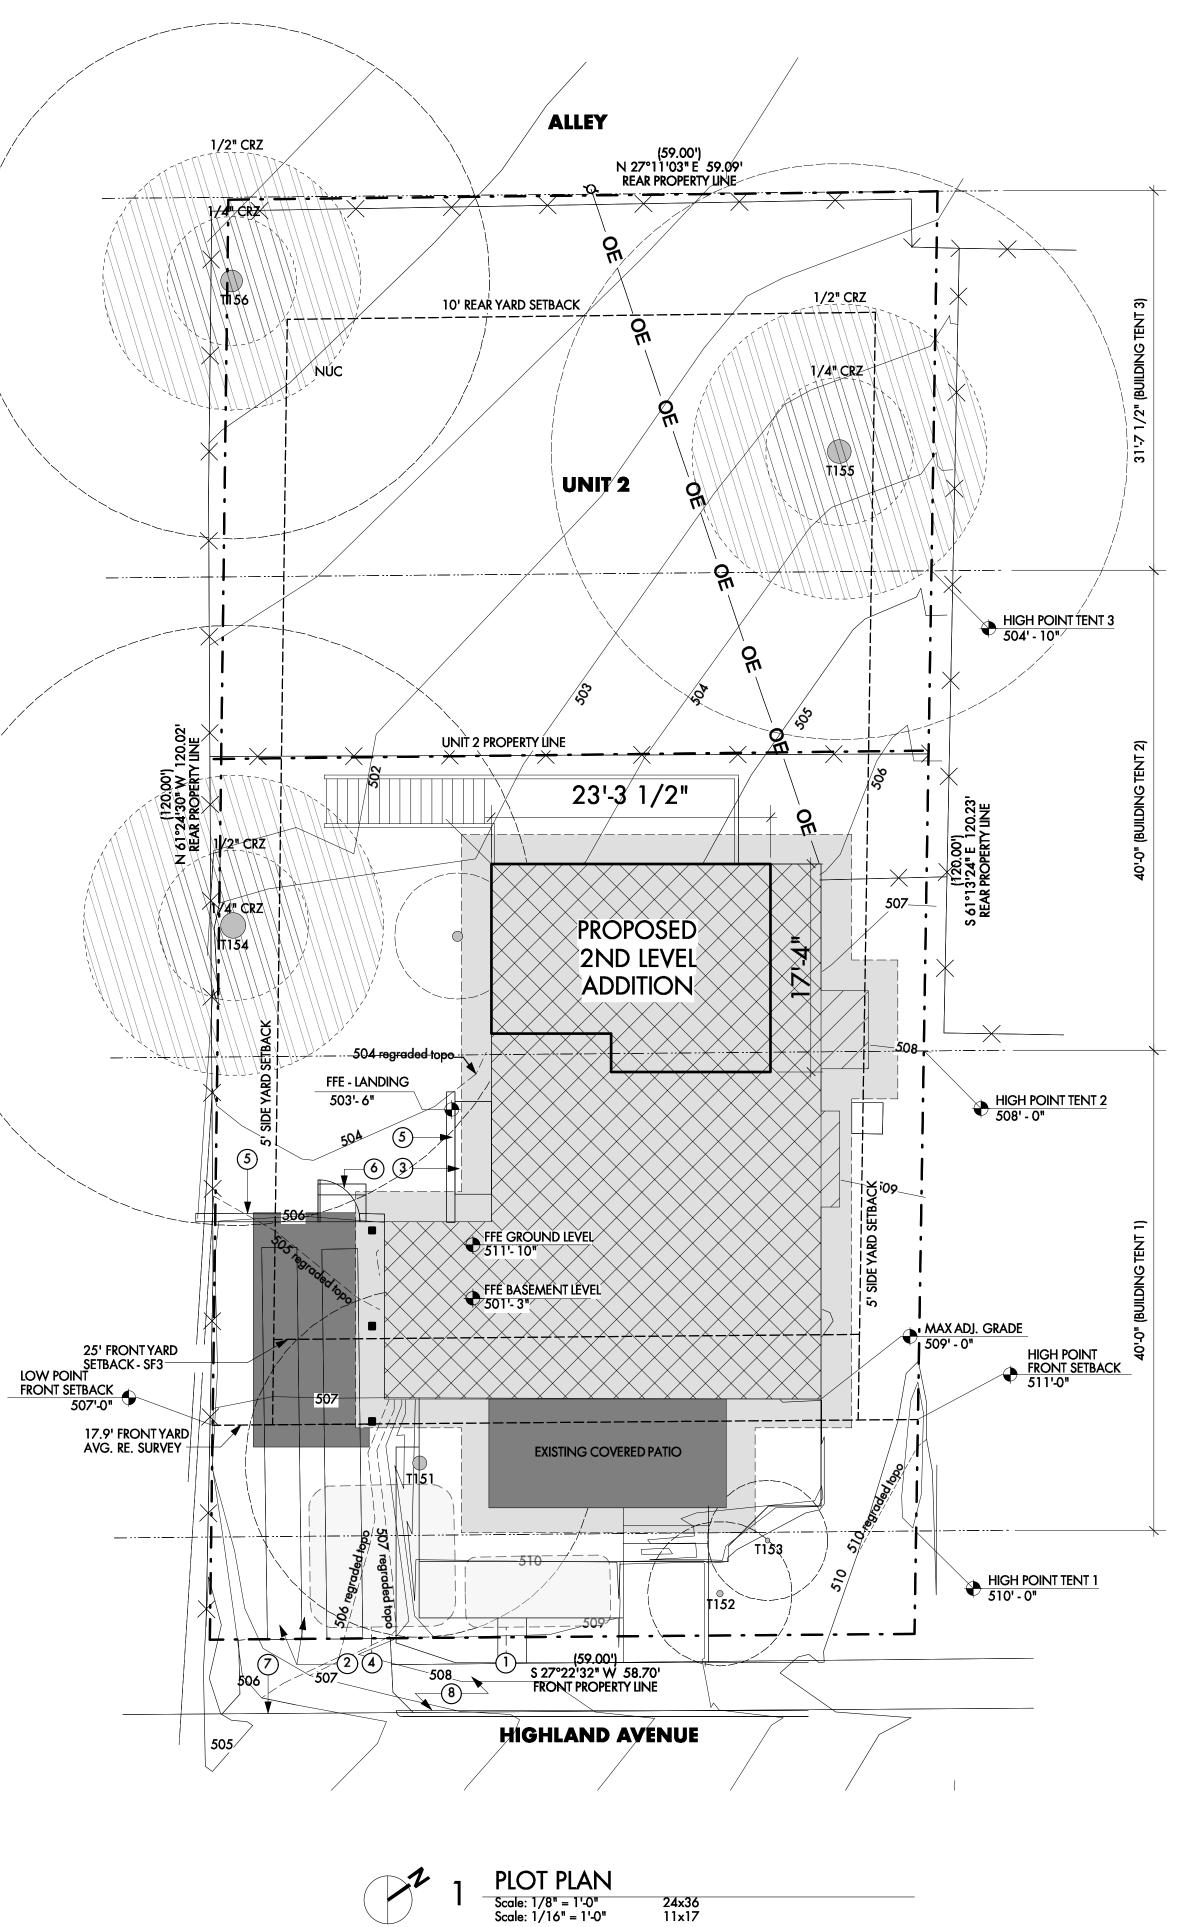

24x36 11x17

#### GENERAL NOTES | ARCHITECTURAL SITE PLAN

- The design illustrated in these documents is furnished by the architect under a limited scope services agreement with the Owner and are therefore provided as a "builder's set" for general intent only. All products and the detailing of their installation, including flashing, underlayments, and weather resistive barriors, should be installed in strict compliance with manufacturer's recommendations and in compliance with all applicable codes as mandated by all governing jurisdictions.
   Tree protection must remain in place through the landscaping and sprinklers need to be placed to stay out of the 1/4 CRZ with a preferred drip system in the 1/2 / full CRZ if possible.
   Tree protection fencing is required for all trees within the limits of construction
- CRZ if possible.
  3. Tree protection fencing is required for all trees within the limits of construction. Fencing should be indicated to protect the entire Critical Root Zone (CRZ) area or as much of the CRZ as is practical. Fencing is required to be chain-link mesh at a minimum height of five feet. When the tree protection fencing cannot incorporate the entire 1/2 Critical Root Zone, an eight inch layer of mulch within the entire available root zone area is required for all trees which have any disturbance indicated within any portion of the Critical Root Zone.
  4. Foot traffic is considered a root zone disturbance, as well. 2x4 or greater size planks (6' tall minimum) are required to be strapped securely around protected trees trunks and root flares when protective fencing does not incorporate the entire 1/2 CRZ for any reason at any time in the project.

#### PLOT PLAN LEGEND

A/C UNIT GAS METER 1/2" REBAR FND. NAIL FND. PIPE FND. UTILITY POLE	

#### KEY NOTES | PLOT PLAN

- 1. Proposed material staging area. Dumpster and spoils placement cannot be located within the 1/2 CRZ of any protected trees. Use existing driveway as an access route.

- Edge of existing driveway.
   New landing.
   Area designated for portable toilet and concrete washout. Cannot be within the full CRZ of any protected tree.
   Retaining wall, as required by grading. Determine height in field. Coordinate wall location and shape in field.
- 6. New stairs.
- 7. Existing driveway.
   8. Existing sidewalk.

#### CONCRETE FOUNDATION NOTES:

•Concrete line pump: Wrap connections of concrete line pump with plastic to prevent concrete slurry from leaching into ground and near roots of trees.

•Concrete truck: If heavy equipment of any kind will be rolling over any area of the full CRZ of protected trees, provide 3/4" plywood over 2x4 lumber over 12" layer of mulch to bridge over the roots and prevent soil/root compaction. After construction is completed, spread mulch around site to leave a max layer of 3" within root zones.

NOTE: Fire, gas and water service lanes to be coordinated with general contractor based on site conditions.

Avoid the 1/2 Critical Root Zones of Protected Trees with any newly proposed work. If trenching within the 1/2 CRZ of Protected Trees cannot be avoided, the trenches will have to be air spaded by a Certified Arborist for the 30" to avoid damaging roots 1.5" + in diameter and the paid receipt for the work will be required by the Final Tree Inspector.

#### TREE LEGEND

TAG NO. | TREE DESCRIPTION T151 T152 T153 T154 T155 T156 14.5" LIGUSTRUM 6" CEDAR ELM 5" CEDAR ELM 25" CREPE MYRTLE 24" LIVE OAK 21.5" POST OAK

### **KEY PLOT PLAN**

FIRST FLOOR EXISTING


NEW BASEMENT

ROOF

COVERED AREA

PROTECTED AREA

STAGING AREA

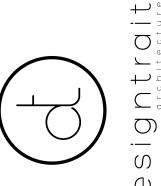



NOT FOR CONSTRUCTION NOT FOR PERMIT

PROJECT IF Addition 602 Highland Ave. Austin, TX 78703 2nd Floor

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Highland







SHEET TITLE PLOT PLAN & SITE DIAGRAMS



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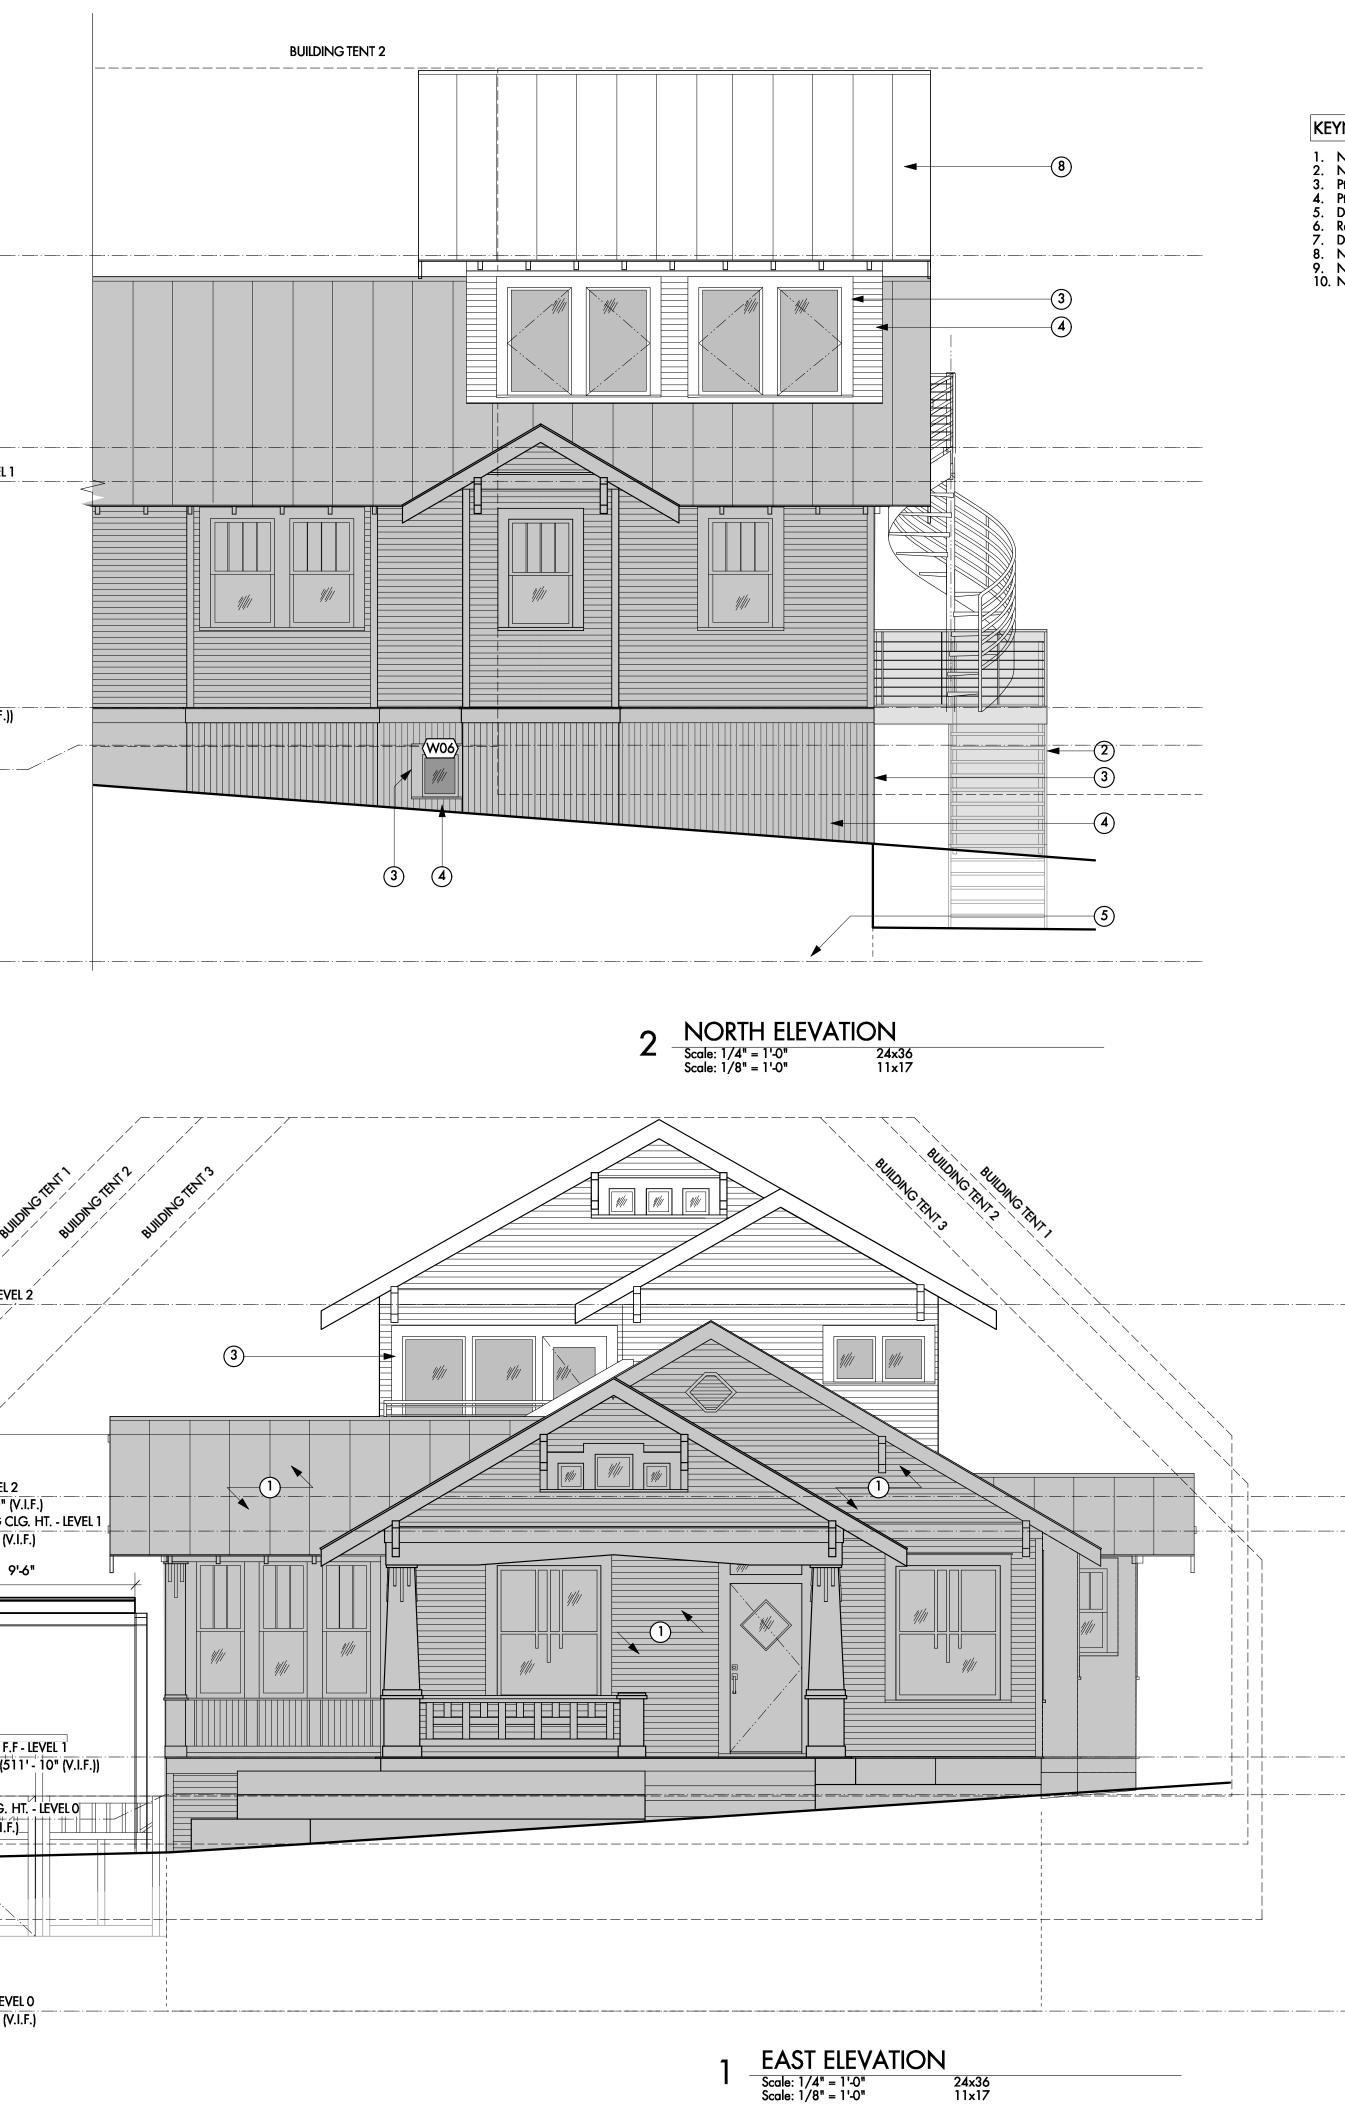


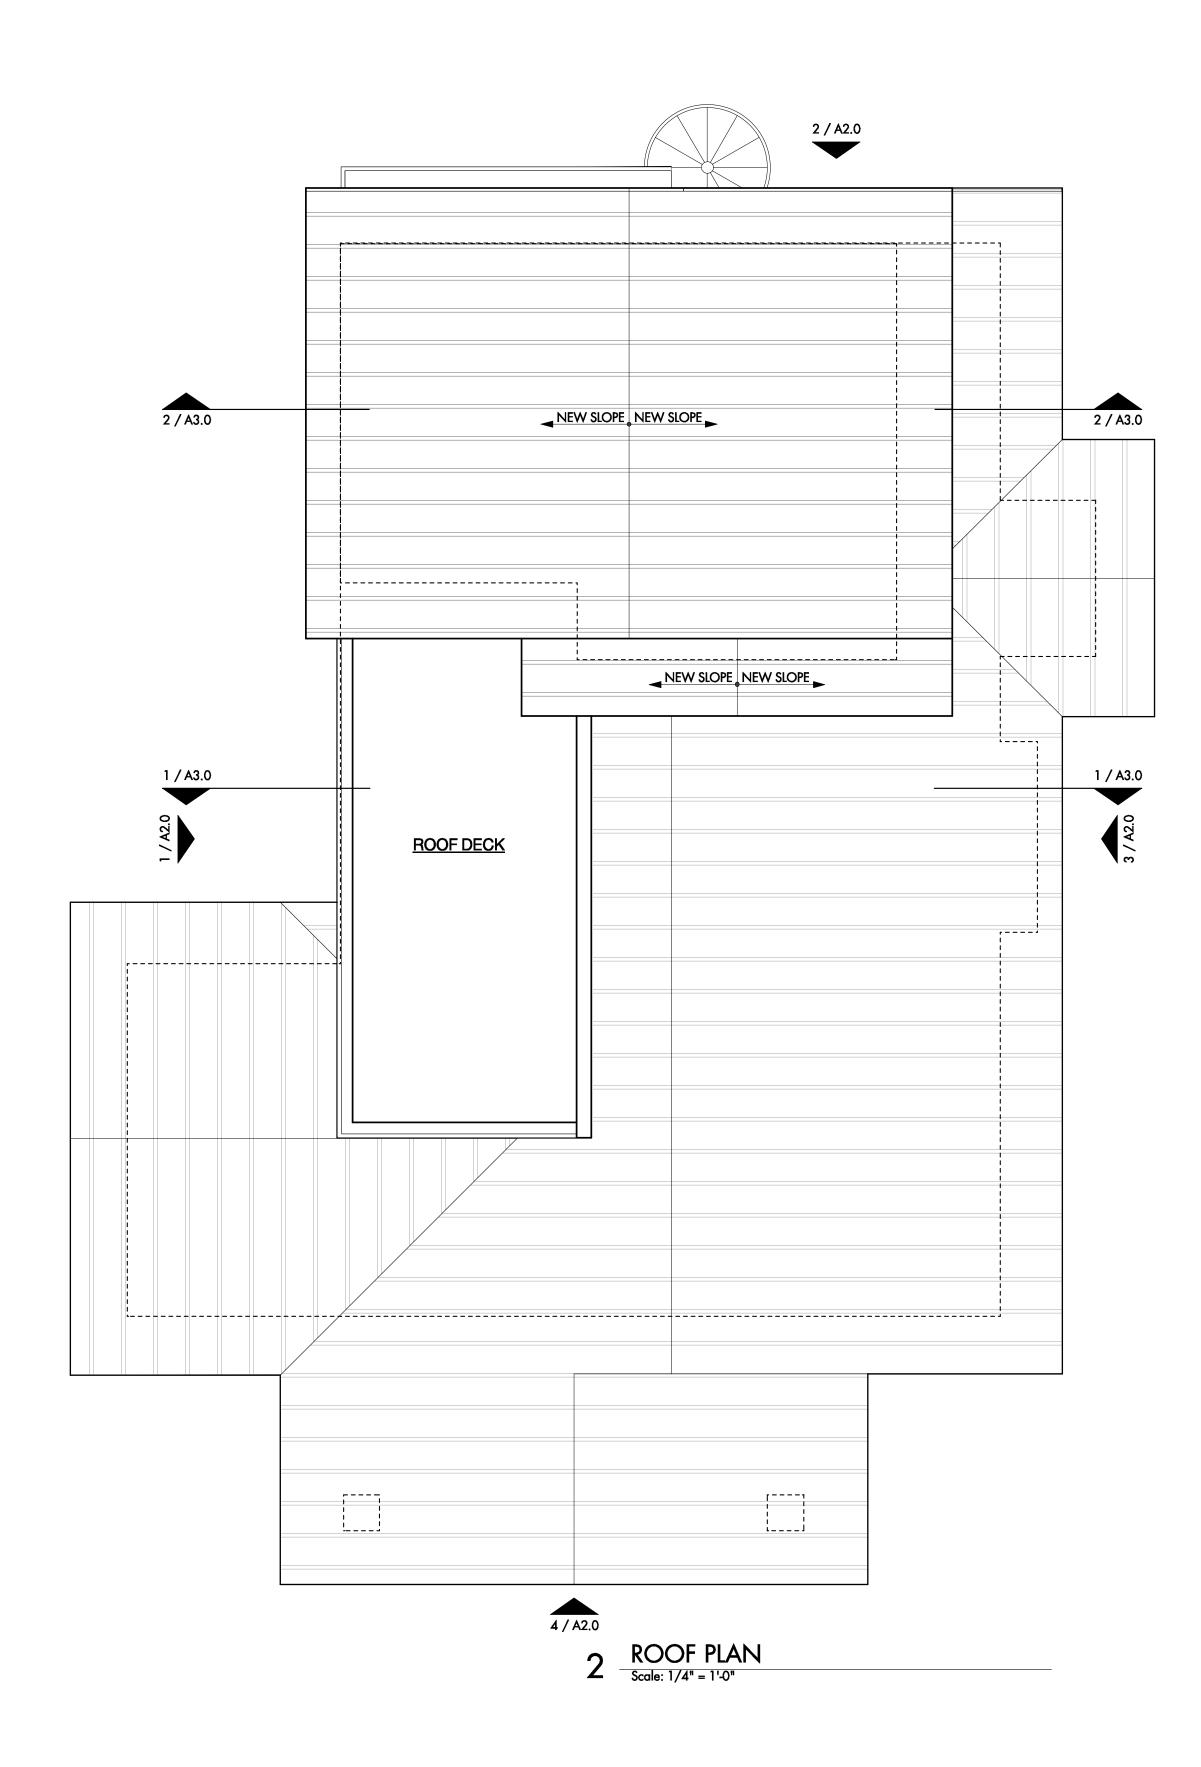
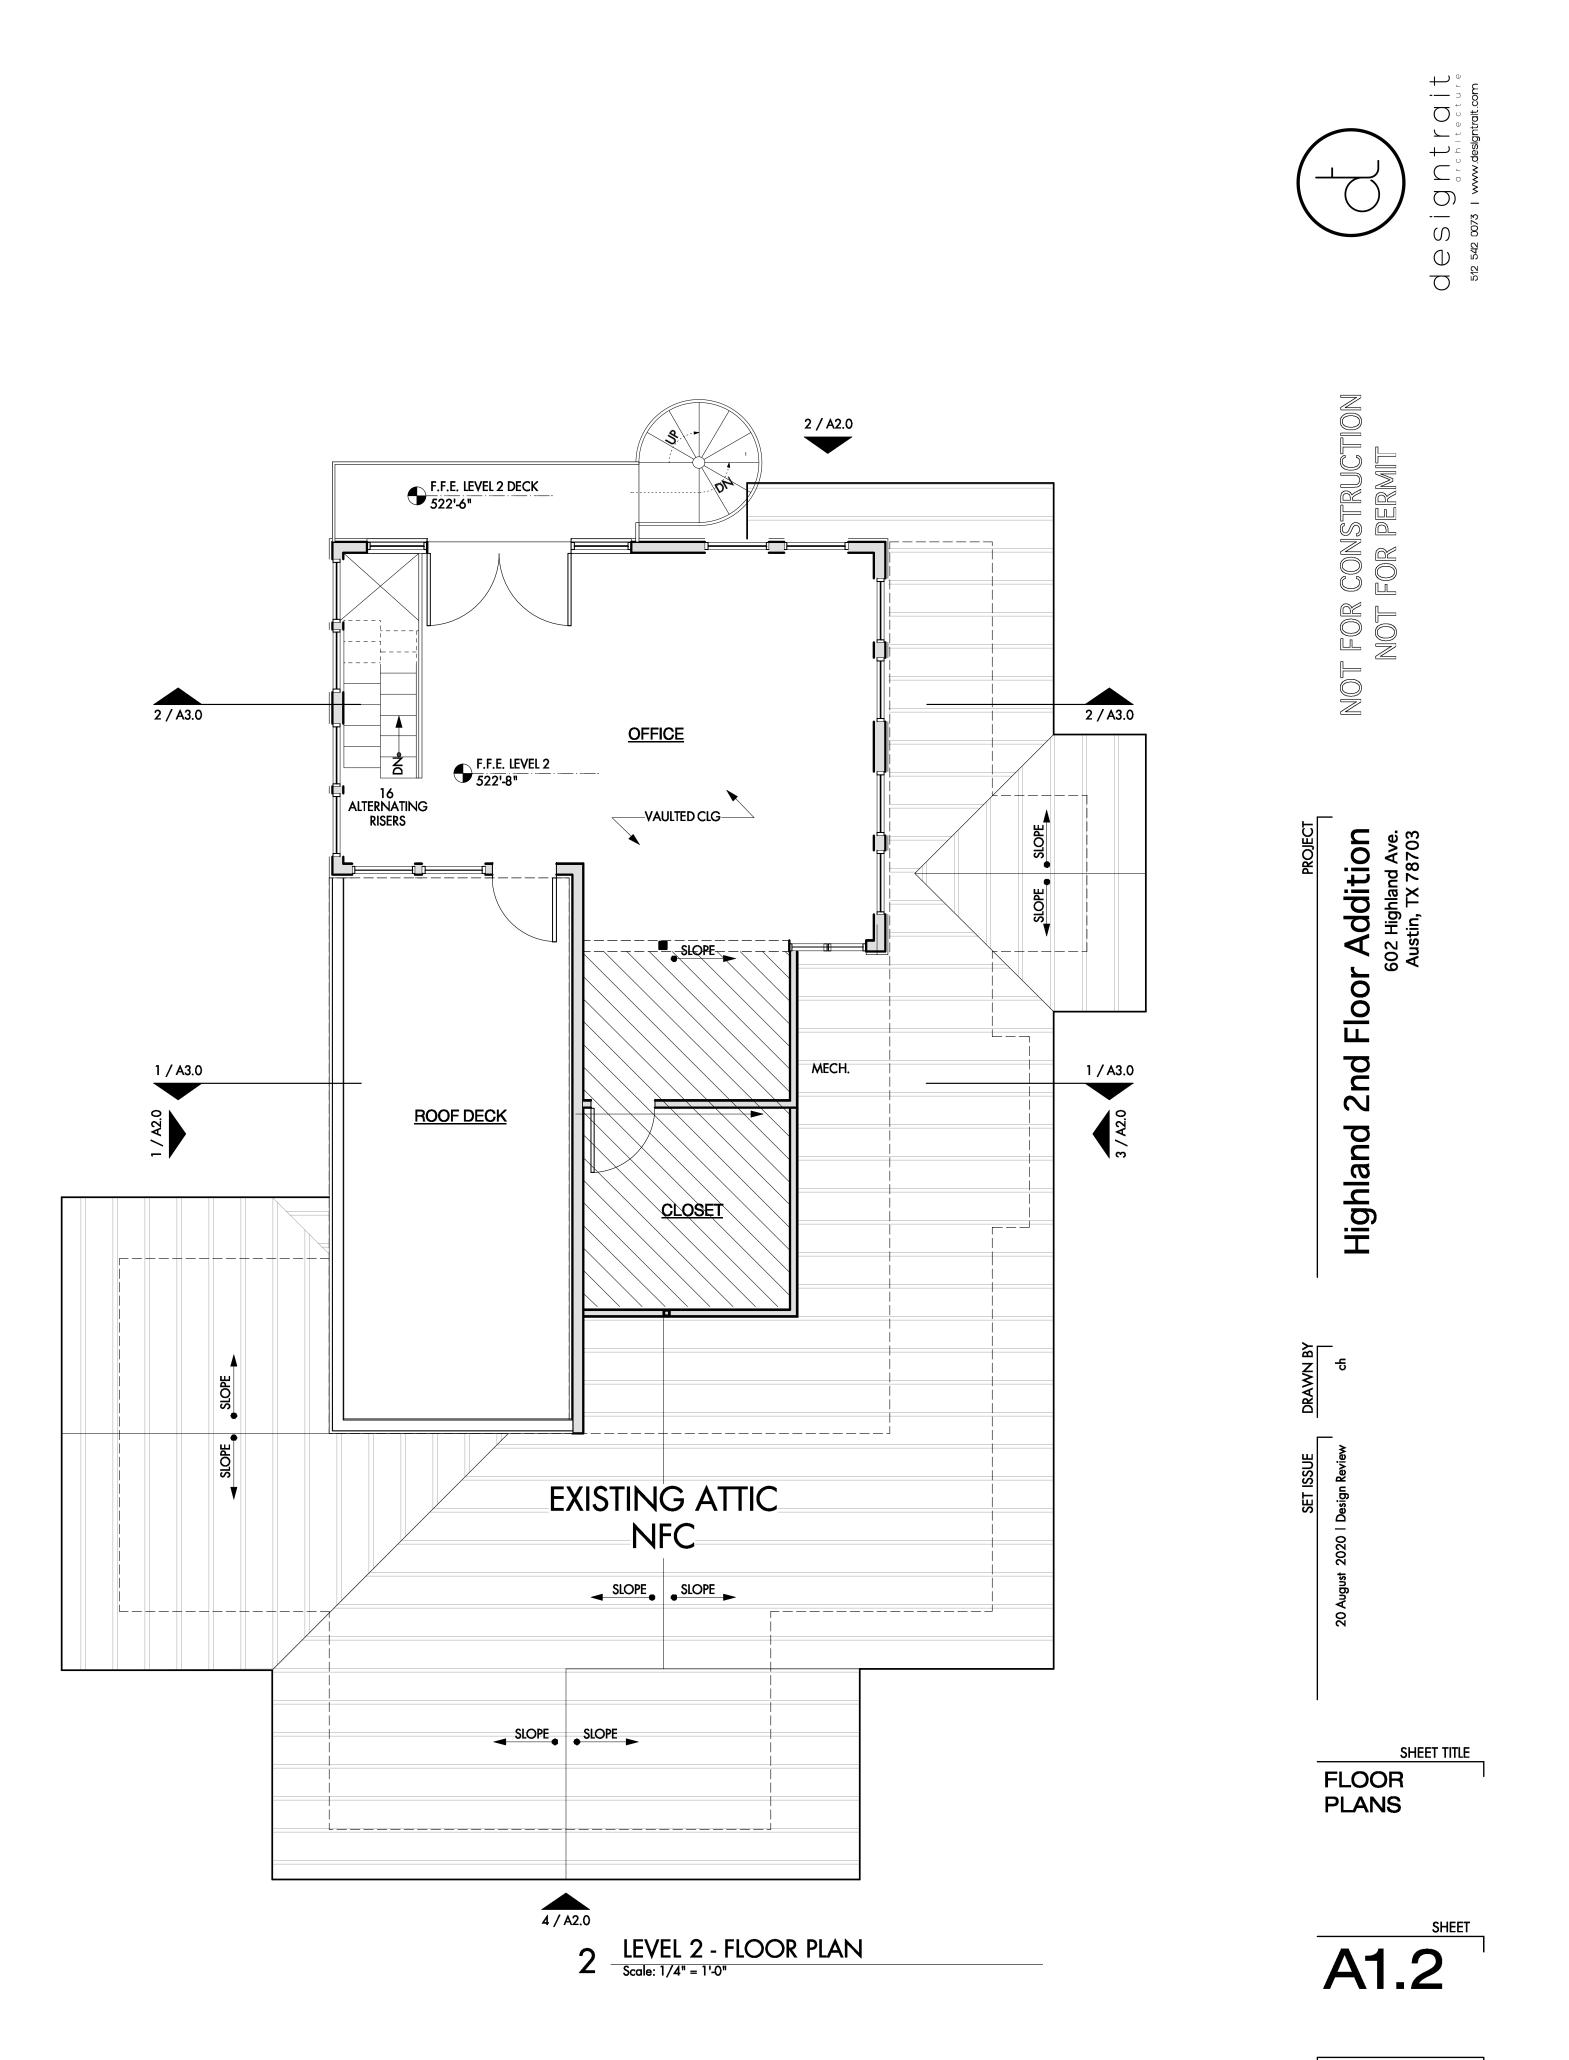
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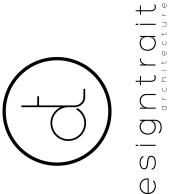
MAX. BUILDING HEIGHT 146' - 10" CLG. HT. - LEVEL 2 119'-10" F.F. - LEVEL 2 110' - 10" (V.I.F.) EXISTING CLG. HT. - LEVEL 1 109' - 5" (V.I.F.) EXISTING F.F - LEVEL 1 100' - 0" (511' - 10" (V.I.F.)) TENT 1: 510' - 0" TENT 2: 508' - 0" - - AVG GRADE: 506'-3" TENT 3: 504' - 10" F.F. - LEVEL 0 89'-5" (V.I.F.) MAX. BUILDING HEIGHT CLG. HT. - LEVEL 2 119'-10" F.F. - LEVEL 2 110' - 10" (V.I.F.) EXISTING CLG. HT. - LEVEL 1 109' - 5" (V.I.F.) EXISTING F.F - LEVEL 1 100' - 0" (511' - 10" (V.I.F.)) TENT 1: 510'- 0"\_ NEW CLG. HT. - LEVEL 0 98'-5" (V.I.F.) **TENT 2: 508' - 0** AVG GRADE: 506'-3" ● TENT 3: 504' - 10"\_


F.F. - LEVEL 0 89'-5" (V.I.F.)




#### KEYNOTES | BUILDING ELEVATIONS

- Not in scope, not in construction.
   New steel framed stairs to replace existing wood stairs, verify design w/ owner.
   Ptd. wood trim, match existing.
   Ptd. wood siding, match existing.
   Dashed line of floor beyond.
   Retaining wall, as required by grading. Determine height in field.
   Dashed line of retaining wall.
   New metal roof to match existing.
   New steel framed spiral stair.
   New steel railing.




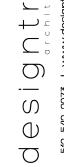

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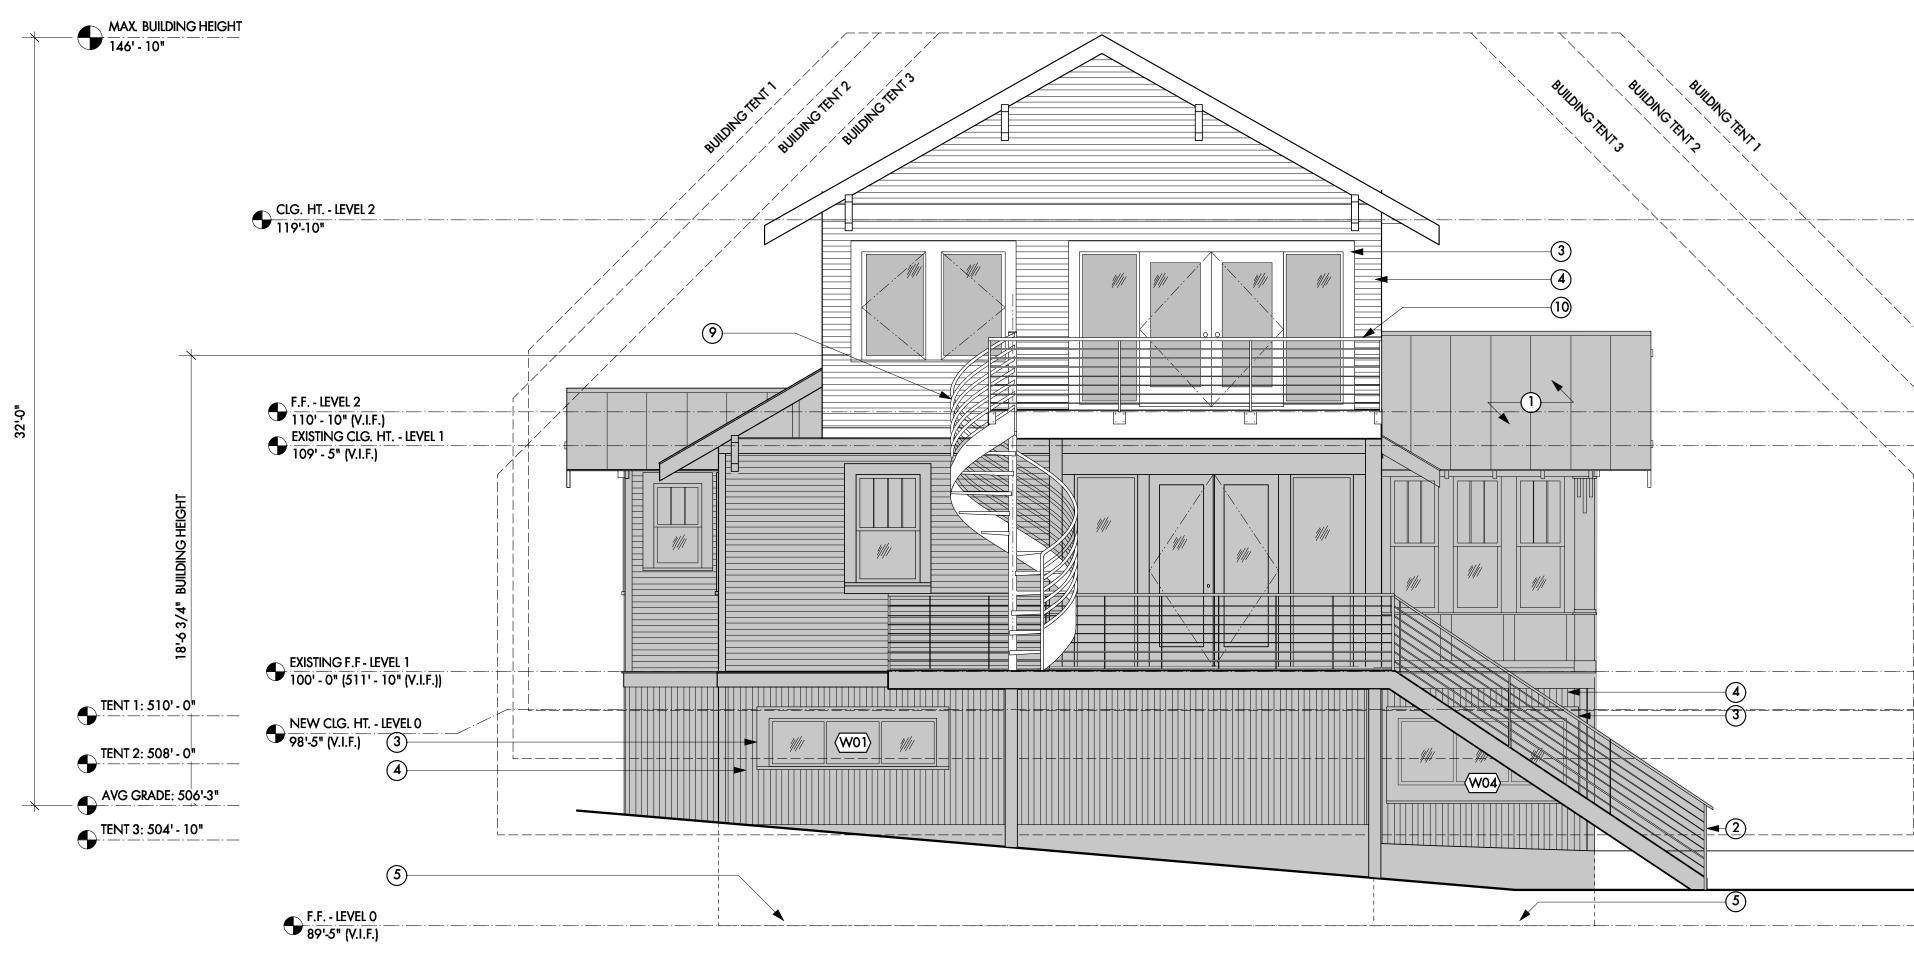


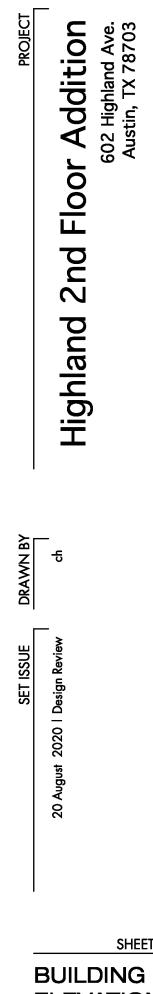


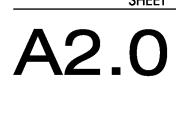

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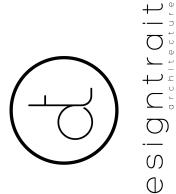
 South Elevation


 Scale: 1/4" = 1'-0"
 24x36

 Scale: 1/8" = 1'-0"
 11x17
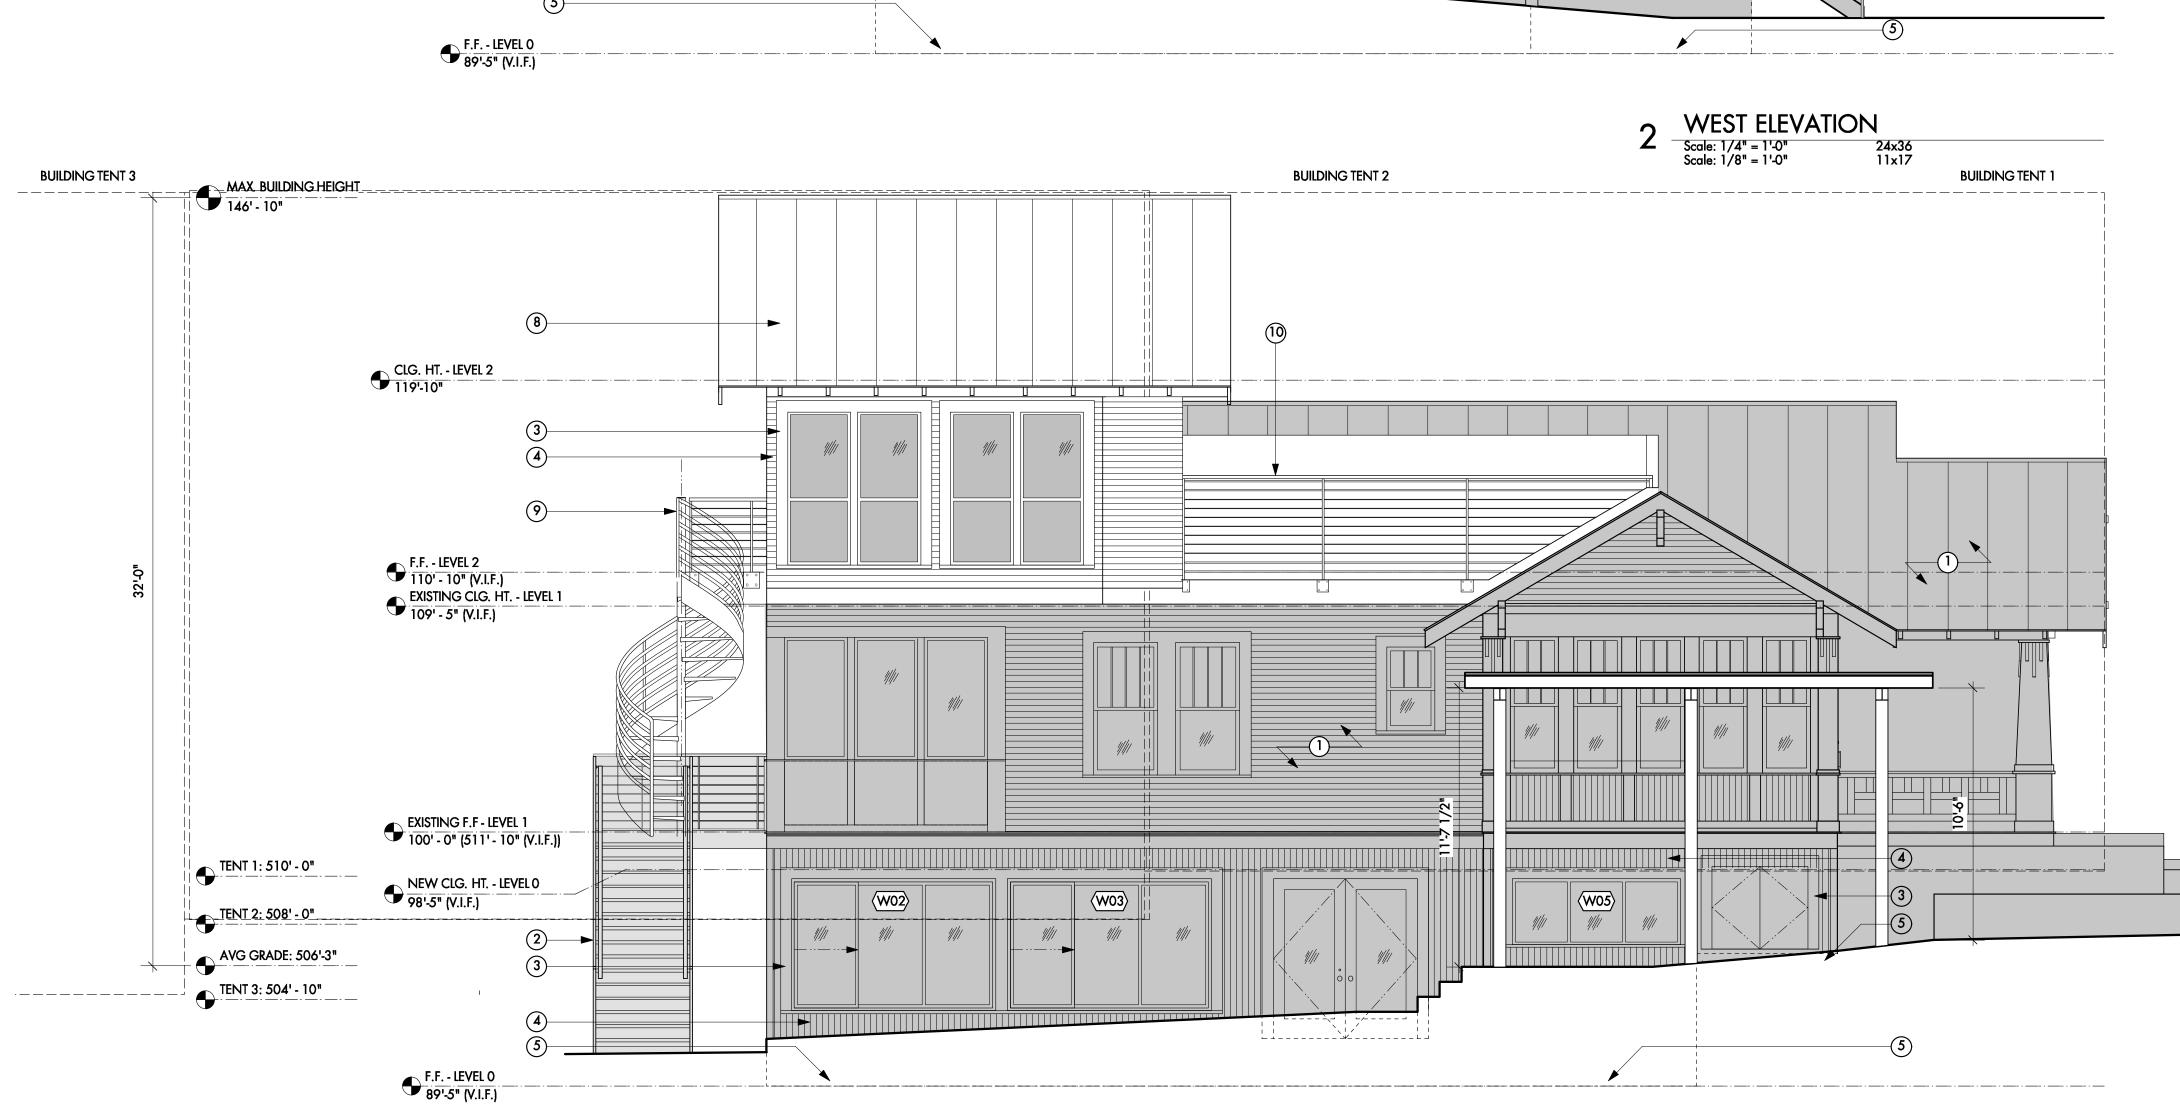
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PROJECT r Addition 602 Highland Ave. Austin, TX 78703 2nd Floor Highland




SHEET TITLE

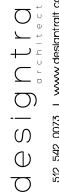BUILDING ELEVATIONS







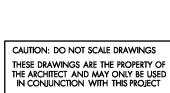





Partial west elevation (rear) portion of wall and roof to be demolished



Partial west elevation (rear)

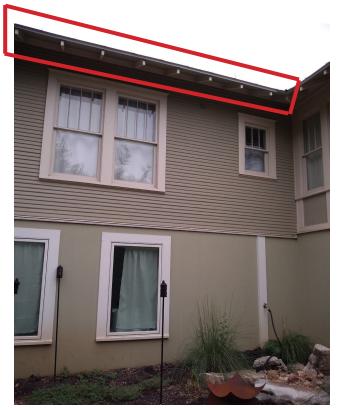

Partial south elevation portion of eave and roof to be demolished

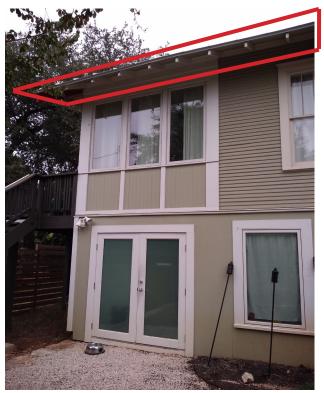

Partial south elevation