

Residential Review – One Texas Center 505 Barton Springs Road, Austin, TX 78704; Phone 3-1-1

Residential New Construction and Addition Permit Application

To Barrett Opinigo Troda, Madrit, 177 707 0-4, 1 Hotte o-1-1					
Property Information					
Project Address: 4509 BALCONES DR.	Tax Parcel ID: /24633				
Legal Description: LOT 5, BLOCK M, BALCONES PART ADDITION SUBDIVISION, SECTION FIVE					
Zoning District: SF-3	Lot Area (sq ft): 29,185.00				
Neighborhood Plan Area (if applicable):	Historic District (if applicable):				
Required Reviews					
Is project participating in S.M.A.R.T. Housing? Y N (If yes, attach signed certification letter from NHCD, and signed conditional approval letter from Austin Energy Green Building)	Does project have a Green Building requirement? Y N N (If yes, attach signed conditional approval letter from Austin Energy Green Building)				
Is this site within an Airport Overlay Zone? Y N N (If yes, approval through Aviation is required)	Does this site have a septic system? Y N (If yes, submit a copy of approved septic permit. OSSF review required)				
Does the structure exceed 3,600 square feet total under roof?	Y N (If yes, Fire review is required)				
Is this property within 200 feet of a hazardous pipeline?	Y N (If yes, Fire review is required)				
Is this site located within an Erosion Hazard Zone? Y N (If yes, EHZ review is required)	Is this property within 100 feet of the 100-year floodplain? Y N (Proximity to floodplain may require additional review time.)				
Are there trees 19" or greater in diameter on/adjacent to the					
If yes, how many? (Provide plans with a tree survey, tree review r	Down and Province of the form of the same				
Was there a pre-development consultation for the Tree Review?	Y N Root zone Canopy Removal / None/Uncertain				
Is this site in the Capital View Corridor? Y N N (If yes, a preliminary review through land use is needed to determine if full view corridor review is required.)	this site within the Residential Design and Compatibility Standards rdinance Boundary Area? (LDC 25-2 Subchapter F) Y N				
Does this site currently have: water availability? Wastewater availability? Wastewater availability? N (If no, contact Austin Water Utility to apply for water/wastewater taps and/or service extension request.)					
Does this site have or will it have an auxiliary water source? Y IN (If yes, submit approved auxiliary and potable plumbing plans.) (Auxiliary water supplies are wells, rainwater harvesting, river water, lake water, reclaimed water, etc.)					
	Y N (If yes, contact the Development Assistance Center for a Site Plan Exemption)				
Is this site within the Waterfront Overlay? Y N (LDC 25-2 Subchapter C Article 3)	Is this site within the Lake Austin Overlay? Y N (LDC 25-2-180, 25-2-647)				
Does this site front a paved street? N	Is this site adjacent to a paved alley? Y N				
(If no, contact Development Assistance Center for Site Plan requirements.)	(Public Works approval required to take access from a public alley.)				
Does this site have a Board of Adjustment (BOA) variance?	Y ■ N Case # (if applicable)				
(If yes, provide a copy of decision sheet. Note: A permit cannot be approved with the control of March.	thin 10 days of approval of a variance from BOA.)				
Description of Work					
	N (If yes, construction material recycling is required per LDC 25-11-39)				
	duplex residential two-family residential other:				
	duplex residential two-family residential other:				
Project Type: new construction addition	addition/remodel other:				
Will all or part of an existing exterior wall, structure, or roof be (Notes: Removal of all or part of a structure requires a Demolition Permit Applie of an interior wall, floor or ceiling)	removed as part of the project? Y N cation per LDC 25-11-37. A demo permit is not required for the removal of all or part				
# existing bedrooms: 3 # bedrooms upon completion: 3 # baths existing: 2.0 # baths upon completion: 2.0					
Project Description: (Note: Please provide thorough description of project.	Attach additional pages as necessary.)				
Studio addition with bathroom and laundry.					
Trades Permits Required (Check as applicable):	plumbing mechanical (HVAC) concrete (R O W)				

Total Remodeled Floor Area (if applicable)						
165 sq ft. (work within existing habitable	square footag	e)				
Job Valuation — For Properties in a Floodplian Only						
300 Valuation – Por i Toperties in a Fioodphan Or	T			. 3.44	<u> </u>	
Total Job Valuation: \$_300,000.00		for Primary S Y □N Plr	structure: nbg: 🔲 Y 🔲	\$ 300, N Mech:	\square Y \square N	
Note: The total job valuation should be the sum total of all valuations		for Accessor		\$		
noted to the right. Labor and materials only, rounded to nearest dollar.	1	•	nbg: 🔲Y 🔲		□Y □N	
Site Development Information						
Area Description		g sq. ft. to main	New/Added sq. ft.		Total sq. ft.	
Note: Provide a separate calculation for each distinct area. Attach additional sheets as necessary. Measurements are to the outside surface of the exterior wall.	Bldg. 1	Bldg. 2	Bldg. 1	Bldg. 2	Bldg. 1	Bldg. 2
a) 1st Floor conditioned area	1,492		806	D1016. 2		8815-A5160 7838, W. \$4625
b) 2 nd Floor conditioned area	1,432		600		2,298	- 0
c) 3 rd Floor conditioned area					0	0
d) Basement					0	22
e) Covered parking (garage or carport)	398				398	0
f) Covered patio, deck, porch, and/or balcony area(s)	242	STATE OF STREET			242	0
g) Other covered or roofed area	250				250	0
h) Uncovered wood decks	437				437	0
Total Building Area (total a through h)	2,819	******************************	806	0		0
i) Pool	111				111	0
j) Spa	24				24	0
k) Remodeled Floor Area, excluding Addition /	327				327	0
New Construction						
The Calculation Aid on page 7 is to be used to con information.	aplete the	following c	alculations a	and to prov	vide additio	nal
Building Coverage Information						
Note: Building Coverage means the area of a lot covered by buildings or						acilities,
incidental projecting eaves, balconies, and similar features. Pools, ponds			l in this measuren	nent. (LDC 25-	1-21)	
Total Building Coverage (sq ft): 3,515.00 % o	f lot size: 1					
Impervious Cover Information				<i>f</i>		
Note: Impervious cover is the total horizontal area of covered spaces inc	luding building	coverage, pave	d areas, walkway	s, and driveway	s. The term exclusion	ides pools,
ponds, fountains, and areas with gravel placed over pervious surfaces the drainage spaces between the deck boards and that is located over a pervi						
impervious cover. (LDC 25-1-23)						^{tor} y
Total Impervious Cover (sq ft): 11,621.00 % o	f lot size: 4	0				
Setbacks						
Are any existing structures on this site a non-compliant str						Y
Does any structure (or an element of a structure) extend or					Y ■ N Y ■ N	
Height Information (LDC 25-1-21 or 25-2 Subchapter F, Section 3.4) Building Height: 15 ft 1 in Number of Floors: 1 # of spaces required: 2 # of spaces provided: 2					2	
	# 0	1 spaces requ	<u> </u>	# 01 spac	provided.	
Right-of-Way Information Is a sidewalk required for the proposed construction? (LDC)	25-6-353)	Υ	N			
*Sidewalks are to be installed on any new construction of a single family, two-family or duplex residential structure and any addition to an existing building that increases the building's gross floor area by 50 % or more.						
Will a Type I driveway approach be installed, relocated, removed or repaired as part of this project? Y N						
Width of approach (measured at property line):						
Are storm sewer inlets located along the property or with	in ten (10)				Y II N	
(If driveway is located within 10 feet of driveway, Drainage review is required)						

Subchapter F

Gross Floor Area

This section is only required for projects located within the Residential Design and Compatibility Standards Ordinance Boundaries as defined and illustrated in Title 25-2 Subchapter F of the Land Development Code. The Gross Floor Area of each floor is measured as the area contained within the outside edge of the exterior walls.

		Existing sq. ft. to remain	New/Added sq. ft.	Proposed Exemption (check article utilized)	Applied Exemption sq. ft.	Total sq. ft.
1st Floor		1,819	806			2,625
2 nd Floor	V					C
3rd Floor,					The second secon	C
Area w/ ceili	ngs > 15'			Must follow article 3.3.5		
Ground Floo (check article				☐ Full Porch sq. ft. (3.3.3.A) ☐ 200 sq. ft. (3.3.3 A 2)	:	(
Basement 4				Must follow article 3.3.3B, see note below		. (
Attic 5				Must follow article 3.3.3C, see note below		(
Garage ² (check	Attached	398		200 sq. ft. (3.3.2 B 1)	200	198
article utilized)	Detached			☐ 450 sq. ft. (3.3.2 A 1 / 2a) ☐ 200 sq. ft. (3.3.2 B 2a / 2b)		(
Carport ² : (check	Attached		,	☐ 450 sq. ft. (3.3.2 A 3) ☐ 200 sq. ft. (3.3.2 B 1) ³		(
article utilized)	Detached			☐ 450 sq. ft. (3.3.2 A 1)		(
Accessory B (detached)	uilding(s)				and Separate	(
Totals		2,217	806	TOTAL GR	OSS FLOOR AREA	2,823
(Total Gros	s Floor Area	÷ Lot Area) x 100	10	Floor-To-Area Ratio	(FAR)	(i)
		required for this proper, within 9 feet of a side	-	■ N Inds further than 36 feet in length per art	ticle 2.7.1)	
		tructure extend bey		ane/exemption exhibit (aka "te	nt")? Y ■ N	

1 Ground Floor Porch exemption: A ground floor porch, including a screened porch, may be exempted, provided that the porch is not accessible by automobile and is not connected to a driveway; and the exemption may not exceed 200 square feet if a porch has habitable space or a balcony above it.

- 2 Garage and carport exemptions (in relation to primary structure): Exemptions must follow the code as outlined in Title 25-2 Subchapter F 3.3.2. Each amount listed (450 or 200) is the maximum exclusion allowed per the article designated. Note: Article 3.3.2 C, "An applicant may receive only one 450-square foot exemption per site under paragraph A. An applicant who receives a 450-square foot exemption may receive an additional 200-foot exemption for the same site under paragraph B, but only for an attached parking area used to meet minimum parking requirements."
- 3Ordinance article 3.3.2 B 1 is 200 sq. ft. exemption may be combined with a 450 sq. ft. exemption. Otherwise only one 450 exemption or one 200 sq. ft. exemption may be taken.
- **4 Basement exemption:** A habitable portion of a building that is below grade may be exempted if the habitable portion does not extend beyond the first-story footprint and is below natural or finished grade, whichever is lower; and it is surrounded by natural grade for at least 50% of its perimeter wall area and the finished floor of the first story is not more than three feet above the average elevation at the intersections of the minimum front yard setback line and the side property lines.
- 5 Habitable Attic exemption: A habitable portion of an attic may be exempted if: 1) The roof above it is not a flat or mansard roof and has a slope of 3 to 12 or greater; 2) It is fully contained within the roof structure; 3) It has only one floor; 4) It does not extend beyond the footprint of the floors below; 5) It is the highest habitable portion of the building, or a section of the building, and adds no additional mass to the structure; and 6) Fifty percent or more of the area over 5 feet has a ceiling height of seven feet or less.

Contact Informat			A CONTRACTOR OF THE CONTRACTOR			
Owner	Carlas Trempla	Applicant/Agent	Ken Burger-Wilmingto-Gordon			
Mailing Address	4509 Balcones Dr	Mailing Address	1209 W. 49th S4 78756			
Phone		Phone	512-454-7070			
Email		Email (1000)	unting @wilmington gordon.			
1000		7,000	Contract of the contract of th			
General Contractor	Wil minaton-Gordon Inc	Design Professional	Nick Draver			
Mailing Address		Mailing Address	606 Highland Ave 78703			
Phone	512-454-7070	Phone	5/2-494-9808			
Email <i>accol</i>	enting @ wilmington gordon	Email				
Authorization	0 0 0	com				
I understand tha	t in accordance with Sections 25-1-411 and 2	25-11-66 of the Land De	evelopment Code (LDC), non-compliance			
with the LDC m	ay be cause for the Building Official to suspension	end or revoke a permit a	and/or license.			
I further underst	and that no portion of any roof structure may	overhang in any public	c utility or drainage easement. I acknowledge			
that customer w	ill bear the expense of any necessary relocati	on of existing utilities to	o clear this driveway location and/or the cost			
to repair any dai	mage to existing utilities caused during const	ruction. Water services	, meters, and wastewater cleanouts are not			
permitted withir	or beneath driveways or sidewalks. Private	plumbing appurtenance	s will not be located in public right-of-way or			
	ts. Private plumbing lines will not cross lot ling application is good for twelve (12) month					
compliance wit	hin that time frame. If the application exp	is after the date it is fil viras, a naw submittal s	ed, and will expire it not approved for			
current code m	ay be required.	nies, a new submittal v	will be required and compliance with			
	that to the best of my knowledge and ability,	the information provide	ed in this application is complete and			
accurate. I furth	er acknowledge that, should any information	contained herein prove	incorrect, the building official may suspend			
or revoke any re	esulting permit and/or license.					
As owner or aut	horized agent, my signature authorizes staff t	to visit and inspect the p	property for which this application is being			
submitted. I understand that without consent the review process may be delayed.						
I also understand	d that if there is a septic system located on th	e property, I am require	d to complete an On-site Sewage Facility			
(a.k.a. an OSSF	or septic system) application by contacting A	Austin Water at (512) 97	72-0050 or ossf@austintexas.gov . This			
initiates the sept	tic system permitting requirement needed to p	proceed with the develo	pment review process.			
Erosion and Sed	limentation Controls are required per Section	25-8-181 of the LDC.	Failure to comply with this requirement			
\$2,000.00 per d	Stop Work Order and/or legal action by t	ne City of Austin inclu	iding criminal charges and fines of up to			
	owner of this property and authorize the agen	nt/annlicant listed above	to apply for and aggrees a requisit an area			
behalf.	where of this property and dumorize the agen	wappheant fisted above	to apply for and acquire a permit on my			
I have checked f	or any property-specific information that ma	v affect the review and	or construction of this project, including but			
not limited to: as	ny subdivision notes, deed restrictions, restric	ctive covenants, zoning	conditional overlays, and/or other			
requirements spe	ecific to proposed development on this prope	erty (collectively, the "P	roperty Information"), located at:			
		• • •	,,,,,,,,,,,,,,,,,,,,,,,,,,,,,,,,,,,,,,,			
Tundomstand that	t the neview of this was in the the City of A	-41				
deed restrictions	t the review of this project by the City of Aus that may apply to this property.	sun will not include a re	eview of any private restrictive covenants or			
	of that may apply to this property. If or any conflicts between the Property Infor	mation and the request	submitted to the City of Austin I forther			
acknowledge that	at I understand the implications of use and/or	development restriction	ns that are a result of the Property			
Information, Ad	ditionally. I understand that the issuance of a	City permit for this pro	oject does not affect the enforceability of any			
private restrictiv	e covenants applicable to the property.	, and become for my big	geet does not direct the chilofocubility of any			
	at if requested I must provide copies of any ar	nd all of the Property In	formation that may apply to this property.			
	ner Letter of Author	int in				
Owner's signature:	12	ization Atto	49 EC 8-18- ZO			
	TE DIDINA		m/ /			
Applicant's signature		_	Date: 7/28/2020			
Design Professional'	s signature		Date: 07/28/2020			
General Contractor's	signature: TEN BULK	ER	Date: 4/28/2020			

Owner's Authorization Letter Valid for Planning and Development Review Department Applications

Address:

4509 Balcones Dr

Austin, TX 78731

To Whom It May Concern:

We hereby certify that we are the owners of the above described property. We hereby authorize Wilmington-Gordon, Inc. (applicant) to act on our behalf to apply for all permits related to the above address.

 $\frac{2}{2028}$

Sworn and subscribed before me this U day of August 20 CO

Notary Public in and for the State of Texas

My Commission expires on 02-12-2023



Residential Review – One Texas Center 505 Barton Springs Road, Austin, TX 78704; Phone 3-1-1

Residential New Construction and Addition Permit Application

Additional Information

Application Process

Please submit all documents single-sided. Submission requirements:

- □ Completed application
- □ 2 large-format sets of permit exhibits (11"x17", 12"x18", 18"x24", or 24"x36")
- □ 1 small-format set of permit exhibits (11"x17", 8.5"x14", or 8.5"x11")
- Austin Energy Building Service Plan Application (BSPA)`
 Note: The BSPA and the small-format plot plan must be stamped by AE in the Development Assistance Center on the first (1st) floor of the One Texas Center prior to submittal
- Austin Water Utility W&WW Service Plan Verification, if water demand is to increase or a dwelling is added. (e.g. addition of a bath)
 - Note: The AWU form and the small-format plot plan must be stamped by AWU in the Development Assistance Center on the first (1st) floor of the One Texas Center prior to submittal
- Completed Demolition application with all required documentation, if any portion of an exterior wall is to be removed or modified. If submitting for a total demolition for new construction, demolition application must be submitted separately.

All drawings must be to a City of Austin verifiable scale, see <u>Building Criteria Manual</u> for additional details and a list of acceptable scales.

Check for expired permits: https://abc.austintexas.gov/web/permit/public-search-other?resét=true If there are expired permits associated with this property, they must be resolved. This can be done in the following ways:

Submit an Acknowledgement of Expired Permits form with this application if the work is not related to the work being permitted. OR Include it in the description of work on this application and reference expired permits to be resolved

If the Acknowledgement of Expired Permits form is used for this project, information about what will be required to resolve the expired permit(s) can be obtained during Residential Review General Information Walk-in hours.

All new construction must comply with the Visitability Ordinance.

Submit application package during Intake hours. For hours and additional information go to our website at http://www.austintexas.gov/department/residential-building-review

About the Review Disciplines

Technical Review – Any permit exhibits not sealed and signed by a Texas-registered architect or certified building designer will be subject to a limited technical review. The technical review is not intended to be exhaustive of all possible building code requirements. Erosion Hazard – There is a review of structural design if a property is located in the Erosion Hazard Zone, as defined by the boundaries located on the City of Austin GIS map. These zones align with locations where water flow and watershed could lead to erosion damage of the surrounding land features (e.g creeks, stream beds, ...).

Fire Review – There is additional review of a project if the square footage of a structure exceeds 3,600 square feet in area. The 3,600 sq. ft. includes the total goss building area: all first, second, and additional floor areas; attached covered porches, patios, decks, and balconys; attached garages; and any other attached roofed areas. The review ensures adequate proximity to fire hydrants and sufficient water supply to the hydrants based on the total gross area of the structure. Properties within 200 feet of a hazardous pipeline may also require additional review.

Floodplain Review – Any work requiring a permit on property located within 100 feet of the 100-Year floodplain will require additional review. If review is anticipated, include supporting information such as FEMA elevation certificate form 086-0-033 and/or topographic surveys referencing NAVD88. To check your property for proximity to a flood plain visit www.ATXFloodPro.com or the City's Floodplain Development Information website.

Historic Review – There is additional review of exterior changes if property is a City Landmark or located in a Local Historic District, National Register Historic District, H or HD zoned district, or partial demolition of exterior features on property over 45 years old.

Tree Review – All design proposals must abide by the Tree Preservation Criteria set forth in Section 3.5.2 of the City of Austin's Environmental Criteria Manual. Cut and fill is limited to 4" within ½ Critical Root Zones (foundations cannot adhere to this), canopy removal is limited to 25% or less per tree, and 50% or more of the full Critical Root Zone must be kept at natural grade with natural ground cover. If proposing to remove a tree that is dead, diseased or an imminent hazard, please provide a Tree Risk Assessment from a Certified Arborist and/ or photographic evidence

Additional Information, Continued

Documentation Explanations and Definitions

Permit Exhibits:

<u>Plot Plan</u> — Plot Plans must be drawn to a standard scale and are to include but are not limited to the following items: property address and legal description, north arrow, drawing scale, trees within the ROW or trees equal to or greater than 19 inches in diameter located on the property and immediately adjacent to the property, property lines, building lines for both existing and proposed improvements, easements, required zoning setbacks and roof overhangs, water meter and wastewater cleanout locations, underground and overhead utility lines and appurtenances, and water and/or wastewater line size and material.

Floorplan(s) – Floorplans must be drawn to a standard scale and are to include (but are not limited to) the following items: drawing scale, room labels, new wall measurements, new ceiling heights, new door and window schedule, smoke detector* and carbon monoxide detector** specifications and locations, dimensioned locations of new plumbing fixtures, handrail/guardrail locations and room square footages. Please provide Existing and Proposed Floor plan if part of the improvements includes removing or adding any wall, window, door, plumbing fixtures, etc. Clearly differentiate between existing, demolished, and new items.

*provide smoke detector system (hardwired, interconnected, battery back-up) at each sleeping room and vicinity in accordance with IRC R314

**provide carbon monoxide detector in immediate vicinity of sleeping rooms in accordance with IRC R315.

<u>Exterior Elevations</u> — Elevation plans must be drawn to a standard scale are are to include front, rear, and sides of the structure. For additions, elevations are required of all sides of the new portion of the structure. Height deminsions are required on all elevations. If building height exceeds 20' or building is multi-story include deminsions of high, low, and average elevations at grade.

Setback Plane Compliance Plan – If subject to Subchapter F - A separate exhibit must be submitted showing topographic elevations on 1-foot intervals on the property, including the top of foundation spot elevation and intersections of the property boundary with the building line segments per Subchapter F, Section 2.6. All topographic information must be prepared and sealed by a Texas-registered professional land surveyor.

Structural Drawing(s) -

Foundation plan of sufficient detail to show conformance to the provisions of the currently adopted IRC including but not limited to:
1) size, spacing and strength of reinforcing steel 2) foundation requirements for braced wall panels required in braced wall plan.

Wall and floor/ceiling/roof sections and details, framing plans and/or framing design information as follows:

General – lumber size, grade, species and spacing of all wood elements.

Wood framed floors - spans and intermediate girders

Wood framed walls – wall type (e.g. 2x4's @ 16 in. o.c.), wall height, headers.

Wood framed roofs - roof framing plan to include rafters and girders as a minimum.

Brace wall plan showing compliance with the currently adopted IRC. The plan shall clearly indicate the braced wall lines and the braced wall method use for compliance to expedite review.

Additional Requirements:

Non-complying Structures (applicable to all work types) –

A separate exhibit must be submitted showing the existing building footprint location in relation to the property boundaries and required setbacks. Exterior walls and supporting structural elements must be clearly labeled and dimensioned showing walls to be removed per Land Development Code Section 25-2-963.

Setback Averaging -

If using setback averaging, one copy of the Contextual Site Plan showing four adjacent properties with location of existing buildings and existing front yard setbacks identified for front yard setback averaging per the provisions of Subchapter F, Residential Design and Compatibility Standards, Section 2.3.

Surveys must be provided by a Texas-registered professional land surveyor showing existing buildings and their distance from the front lot line.

Design Professionals -

For any project exceeding 20 feet in height or more than one-story within the Subchapter F boundaries, all permit exhibits must be sealed and signed by a Texas-registered architect or certified building designer (National Council of Building Designers or Texas Institute of Building Design)

Localized flooding -

If there is a storm drain inlet or pipe, drainage ditch, or drainage easement on or near the property or the property is at the low point of a roadway, there may be a chance of flooding from the local drainage system. The proposed development cannot cause additional flooding on other property nor have an adverse impact on the existing local drainage system. Contact the Development Assistance Center for more information

.Tree Survey -

Provide a tree survey per ECM 3.3.2 that labels the ¼, ½ and full Critical Root Zones and provides the diameter and species of each protected tree (a Tree Legend is recommended). Depict proposed access routes and material staging. Show all proposed and existing utilities. Show specific locations of tree protection fencing and mulching per requirements of ECM 3.5.2.

Calculation Aid			
Area Description Note: Provide a separate calculation for each distinct area. Attach additional sheets as necessary. Measurements are to the outside surface of the exterior wall.	Existing Sq Ft	New/Added Sq Ft	Total Sq Ft
a) 1st floor conditioned area	1,813	806	2,619
b) 2 nd floor conditioned area			0
c) 3 rd floor conditioned area			0
d) Basement			0
e) Attached Covered Parking (garage or carport)	398		398
f) Detached Covered Parking (garage or carport)			0
g) Covered Wood Decks (counted at 100%)			0
h) Covered Patio			0
i) Covered Porch			0
j) Balcony			0
k) Other - Specify: WOOD SHED AND OVERHANG BEYOND 2FT	492		492
Total Building Area (TBA) (add: a through k)	2,703	806	3,509
Total Building Coverage (TBC) (from TBA subtract, if applicable: b, c, d, and j)	(<u>A</u>) 2,703	806	(<u>B</u>) 3,509
1) Driveway	6,286		6,286
m) Sidewalks			0
n) Uncovered Patio		<u> </u>	0
o) Uncovered Wood Decks (counted at 50%)	219		219
p) AC pads and other concrete flatwork	18		18
q) Other (Pool Coping, Retaining Walls)	1,583		1,583
Total Site Impervious Coverage (add: TBC and 1 through q)	(<u>C</u>) 10,809	806	(<u>D</u>) 11,615
r) Pool	111		111
s) Spa	24		24

Building Coverage Information

Note: Building Coverage means the area of a lot covered by buildings or roofed areas, but excludes ground level paving, landscaping, open recreational facilities, incidental projecting eaves, balconies, and similar features. Pools, ponds, and fountains are not included in this measurement. (LDC 25-1-21)

Lot Area (sq. ft.): 29,185.00 Existing Building Coverage (see above $\underline{\mathbf{A}}$, sq. ft.): $\underline{\mathbf{2},703.00}$ Existing Coverage % of lot (<u>A</u> ÷ Lot Area) x 100 : 9 Final Building Coverage (see above **B**, sq. ft.): 3,509.00 Final Coverage % of lot ($\underline{\mathbf{B}} \div \mathbf{Lot} \mathbf{Area}$) x 100 : 12

Impervious Cover Information

Note: Impervious cover is the total horizontal area of covered spaces including all building coverage, paved areas, walkways, and driveways. The term excludes pools, ponds, fountains, and areas with gravel placed over pervious surfaces that are used only for landscaping or by pedestrians. (LDC 25-1-23)

Existing Impervious Coverage (see above <u>C</u>, sq. ft.): <u>10,809.00</u>

Existing coverage % of lot ($\underline{\mathbf{C}} \div \mathbf{Lot} \mathbf{Area}$) x 100 : $\underline{\mathbf{37}}$

Final Impervious Coverage (see above <u>D</u>, sq. ft.): <u>11,615.00</u>

Final coverage % of lot ($\underline{\mathbf{D}} \div \mathbf{Lot} \mathbf{Area}$) x 100 : $\underline{\mathbf{40}}$



Demolition Permit Application

POLINIED 1830	SERVICES DEPARTMENT	Application			
505 Barton Spring	One Texas Center gs Road, Austin, TX 78704 Phone: 3-1-1	Application Type: Fee Paid: \$	Commercial Submission Date:	Residential	
For Office Use	Only – Permit Information				
BP-	PR-	LHD_NRD_HDP-		Ca	
Referred By:		NRHD/LHD:			
☐ Release Pe	ermit Do Not Release Permit	☐ HLC Review-	•		
Historic Preservation	Office		Date		
expire after twelve will be required to s	ections are required for all demolition proje (12) months from the time of applying for to submit a NEW application for the project ar	he permit. In order to c	ose out an expired p		
	R PERMIT EXPIRE!!!!				
National Register H	IARKS AND DISTRICTS: If this property is listoric District, additional applications and (see <u>www.austintexas.gov/department/his</u>	fees will apply. For mo			
Submittal Requ	iirements				
OR a l 2. Dimensioned 3. Certified tax 4. Photos of eastreet 5. Review Fee	orization/signature, NOTARIZED at the bot NOTARIZED letter of authorization from the d Site Plan or Survey that shows all existing certificate(s) from the Travis County Tax A each side of structure; the front photo needs (see fee schedule for applicable fees)	e owner giving the app og structures and what ossessor's Office (5501	s being demolished Airport Boulevard, 5	12-854-9473)	
6. Approved/Re	ements for Commercial Demolitions: ed-stamped Site Plan OR an approved Site Fexas Department of Health Asbestos Notin	· · · · · · · · · · · · · · · · · · ·		d inspector or	
Property Infor	mation	Demolition Type	•		
Address: 4509 B	alcones Dr		al – identify the exter		
City: Austin	Zip: 78731	portion of wall(s) and		1,	
Current Use: Sing	gle family residence	Partial e	exterior wa		
Demolition Cor	ntractor Information	Structural Infor	mation		
Company: Will	minaton-Gordon, Inc	Square Feet:	97	4	
Address: 1209	9 W 49+4 St	Building Materials:	Good framing.	wood siding	
City: Austi	'n TX zip78756	•	Pier & Dean		
Phone: 51.	2-517-1351	Estimated Cost of De	emolition: \$5,00	0.	

Applicant	Owner			
Name: Ken Burger / Wilmington-Gordon, Inc.	Name: Carla & David Tremblay			
Address: 1209 W 49th St	Address: 4509 Balcones Dr			
City: Austin Zip: 78756	City: Austin	Zip: <u>78731</u>		
Phone: 512-454-7070	Phone:			
Email: accounting@wilmingtongordon.com	Email:	//////////////////////////////////////		
Additional Questions				
Are there trees 19 inches or greater in diameter on the site or	along neighboring properties?	☐ No		
Was the structure inhabited within the last 12 months?	□ Yes	☐ No		
What is the total number of housing units that will be demolish	ned? <u>-</u>			
What is the total number of bedrooms in the units that will be	demolished?			
How many currently occupied residential units will be demolis	hed?			
If 5 or more, tenant notification may be required and a certified	d form may be required with your application	n (LDC 25-1-712).		
Consent, Authorizations, and Signatures				
I understand and will adhere to the following rules or regulation. 1. No work may begin prior to issuance of this permit.				
It is important to verify with the Development Assistance Cen this location PRIOR to filing this application.	ter (DAC) that new construction will be permitte	d on the property at		
If the structure to be demolished is currently tied into water a Austin Water Utility at 512-494-9400 to obtain specific water		stin, you must contact		
 Erosion and Sedimentation Controls are required per Se Failure to comply with this requirement may result in a Stop \ charges and fines of up to \$2,000.00 per day. 	ction 25-8-181 of the City of Austin Land Dev			
4a. Inspection of erosion, sedimentation controls, and construction begins (25-1-288.A & 25-1-288.F): (512)				
 If the proposed work will require use of City right-of-way, a Ri Applications may be obtained from the City of Austin Transpo austintexas.gov/rowman. 				
6. The Historic Preservation Office will review this applicate application is potentially historic as defined by Section 2 Additional review by the Historic Landmark Commission	25-11-214 of the City of Austin Land Develop	nent Code.		
All demolition permitted commercial and multifamily projects 11-39)."				
Once this review is complete and approved, the permit may lassessed at that time.	be obtained from the Permit Center and addition	nal fees will be		
I, the undersigned, hereby swear or affirm that the information my knowledge and is an accurate reflection of my intentions for omission or incorrect information herein will render this applic	or the above structure and/or property. I un			
As owner(s) of the property described in this application, I/we hereby authorize the Applicant listed on this application to act on my/our behalf during the processing and presentation of this request. They shall be the principal contact with the City in processing this application.				
Signature of Applicant (if different than owner): Signature of Owner: Letter of Author Sworn and subscribed before me this day of	D	ate: 7/28/2020		
Signature of Owner: Letter of, Author	ization Attached D	ate:		
Sworn and subscribed before me this day of	, 20			
Signature of Public Notary:	My commission expir	es: ,		
Notary Public in and for the State	e ot lexas			

TAX CERTIFICATE Bruce Elfant Travis County Tax Assessor-Collector P.O. Box 1748 Austin, Texas 78767 (512) 854-9473

ACCOUNT NUMBER: 01-2804-0422-0000

PROPERTY OWNER:

BALCONES TRUST DECLARATION 4509 BALCONES DR AUSTIN, TX 78731

PROPERTY DESCRIPTION:

LOT 5 BLK M BALCONES PARK ADDN SEC

ACRES .6940 MIN% .00000000000 TYPE

* NONE *
ALL PAID

SITUS INFORMATION: 4509 BALCONES

 DR

This is to certify that after a careful check of tax records of this office, the following taxes, delinquent taxes, penalties and interests are due on the described property of the following tax unit(s):

YEAR ENTITY
2019 AUSTIN ISD
CITY OF AUSTIN (TRAV)
TRAVIS COUNTY
TRAVIS CENTRAL HEALTH
ACC (TRAVIS)

TOTAL SEQUENCE

TOTAL TAX:
UNPAID FEES:
INTEREST ON FEES:
COMMISSION:
TOTAL DUE ==>

ALL PAID

ALL PAID

ALL PAID

ALL PAID

ALL PAID *ALL PAID* * NONE *
* NONE *

TAXES PAID FOR YEAR 2019 \$14,978.75

ALL TAXES PAID IN FULL PRIOR TO AND INCLUDING THE YEAR 2019 EXCEPT FOR UNPAID YEARS LISTED ABOVE.
The above described property may be subject to special valuation based on its use, and additional rollback taxes may become due. (Section 23.55, State Property Tax Code).
Pursuant to Section 31.08 of the State Property Tax Code, there is a fee of \$10.00 for all Tax Certificates.

GIVEN UNDER MY HAND AND SEAL OF OFFICE ON THIS DATE OF 08/13/2020

Fee Paid: \$10.00

Bruce Elfant Tax Assessor-Collector















AUSTIN ENERGY

One Texas Center | 505 Barton Springs Road Phone: (512) 974-2632, (512) 974-9112 Email: aebspaespa@austinenergy.com

This project will require a Temporary Loop

☐ Design Required

Building Service Planning Application (BSPA)

This form to be used for review of Residential Building Permits only

For use in DAC only

Person Responsible for Request: Marty M	Cracken		
Email: accounting@wilmingtongordon.com			
Project Address: 4509 Balcones Dr, Aust	in TX 78731	:	-OR-
Legal Description:		Lot:	Block:
Who is your electrical provider?	Other:		
Overhead Service 💢 Underground Service	rice OS	ingle-Phase (1Ø)	○ Three-Phase (3Ø)
Location of meter: North side of	f house		
Location of meter: North side of Scope of work: Room addit	on		
			,
1 P			
			MOVINIANIANIANIANIANIANIANIANIANIANIANIANIA
Marty McCracken	g	•	512-517-1351
BSPA Completed by (print name)			Phone
Marty Mc Cracher			8/28/20
BSPA Completed by (signature)			Date '

(Any change to the above information requires review and re-approval)

AE Representative Use Only


APPROVED

By PaceM at 11:33 am, Aug 28, 2020

ALL structures MUST maintain 7' 6" clearance from AE energized Distribution power lines (this includes eaves and overhangs).

Enforced by AE and NESC codes.

This review DOES NOT include Transmission lines.

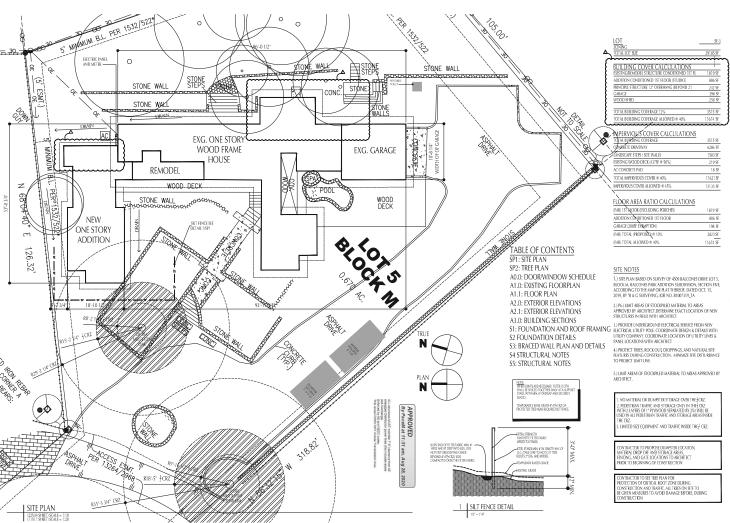

NICK DEAVER Architect 606 Highland Avenue Austis, Texas 78703 www.nickdeaver.com

REVISIONS

07.27.20
PHASE
CONSTRUCTION
DOCUMENTS

PROJECT: TREMBLAY Residence


> 4509 BALCONES DR. AUSTIN, TX 78731 PROJECT MANAGER:


DRAWING NAME:

SITE PLAN

DRAWN BY: JD
CHECKED BY: ND
JOB 4: 278
FILE 278 TREMBLAY
02000 nickdeavesarchitec
DATE: 07.27.20
SCALE

SP1

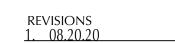

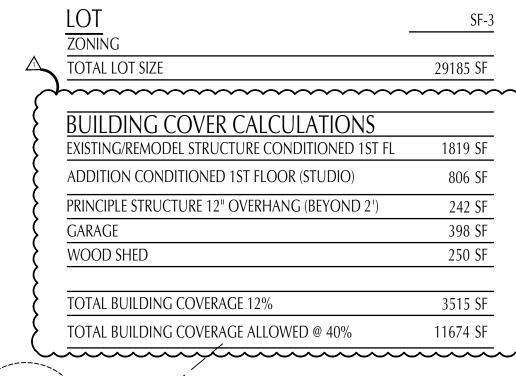

MPERVIOUS COVER CALCULATIONS

	TOTAL BUKDING COVERAGE	3515 SF
	CONCRETE DRIVEWAY	6286 SF
	LANDSCAPE STEPS / SITE WALLS	1583 SF
	EXISTING WOOD DECK (437SF @ 50%)	219 SF
	AC CONCRETE PAD	18 SF
	TOTAL IMPERVIOUS COVER @ 40%	11621 SF
	IMPERVIOUS COVER ALLOWED @ 45%	13133 SF

FLOOR AREA RATIO CALCULATIONS

(FAR) 1ST FLOOR (EXCLUDING PORCHES)	1819
ADDITION CONDITIONED 1ST FLOOR	806
GARAGE (200SF EXEMPTION)	198
(FAR) TOTAL (PROPOSED) @ 10%	2823
(FAR) TOTAL ALLOWED @ 40%	- 11674

SITE NOTES

1.) SITE PLAN BASED ON SURVEY OF 4509 BALCONES DRIVE LOT 5, BLOCK M, BALCONES PARK ADDITION SUBDIVISION, SECTION FIVE, ACCORDING TO THE MAP OR PLAT THEREOF, DATED OCT. 15, 2019, BY "B & G SURVEYING. JOB NO. B1007319_TA

2.) P6.) LIMIT AREAS OF STOCKPILED MATERIAL TO AREAS APPROVED BY ARCHITECT. DETERMINE EXACT LOCATION OF NEW STRUCTURES IN FIELD WITH ARCHITECT

3.) PROVIDE UNDERGROUND ELECTRICAL SERVICE FROM NEW ELECTRICAL UTILITY POLE. COORDINATE DESIGN & DETAILS WITH UTILITY COMPANY. COORDINATE LOCATION OF UTILITY LINES & PANEL LOCATIONS WITH ARCHITECT

4.) PROTECT TREES, ROCK OUT CROPPINGS, AND NATURAL SITE FEATURES DURING CONSTRUCTION. MINIMIZE SITE DISTURBANCE TO PROJECT LIMIT LINE.

5.) LIMIT AREAS OF STOCKPILED MATERIAL TO AREAS APPROVED BY ARCHITECT.

1. NO MATERIAL OR DUMPSTER STORAGE OVER THE \(\frac{1}{4}\) CRZ.

2. PEDESTRIAN TRAFFIC AND STORAGE ONLY IN THE \(\frac{1}{2}\) CRZ

WITH 2 LAYERS OF 1" PLYWOOD SEPARATED BY 2X4 WILL BE

USED IN ALL PEDESTRIAN TRAFFIC AND STORAGE AREAS INSIDE

THE CRZ.

3. LIMITED SIZE EQUIPMENT AND TRAFFIC INSIDE THE $\frac{1}{2}$ CRZ.

CONTRACTOR TO PROPOSE DUMPSTER LOCATION, MATERIAL DROP OFF AND STORAGE AREAS, FENCING, AND GATE LOCATIONS TO ARCHITECT PRIOR TO BEGINNING OF CONSTRUCTION

CONTRACTOR TO SEE TREE PLAN FOR
PROTECTION OF CRITICAL ROOT ZONE DURING
CONSTRUCTION AND TRAFFIC. ALL TREES ON SITE TO
BE GIVEN MEASURES TO AVOID DAMAGE BEFORE, DURING
CONSTRUCTION

NICK DEAVER Architect

506 Highland Avenue Austin, Texas 78703 www.nickdeaver.com



NICH DEANET

07.27.20 ASE:

CONSTRUCTION DOCUMENTS

PROJECT:

TREMBLAY
Residence
4509 BALCONES DR.

AUSTIN, TX 78731

PROJECT MANAGER:

DRAWING NAME:


SITE PLAN

DRAWN BY:	JD		
CHECKED BY	: ND		
JOB #:	278		
FILE: 278	TREMBLAY		
© 2020 nickdeaverarchitect			
DATE: 07	27.20		

SHEET:

SCALE:

SP1

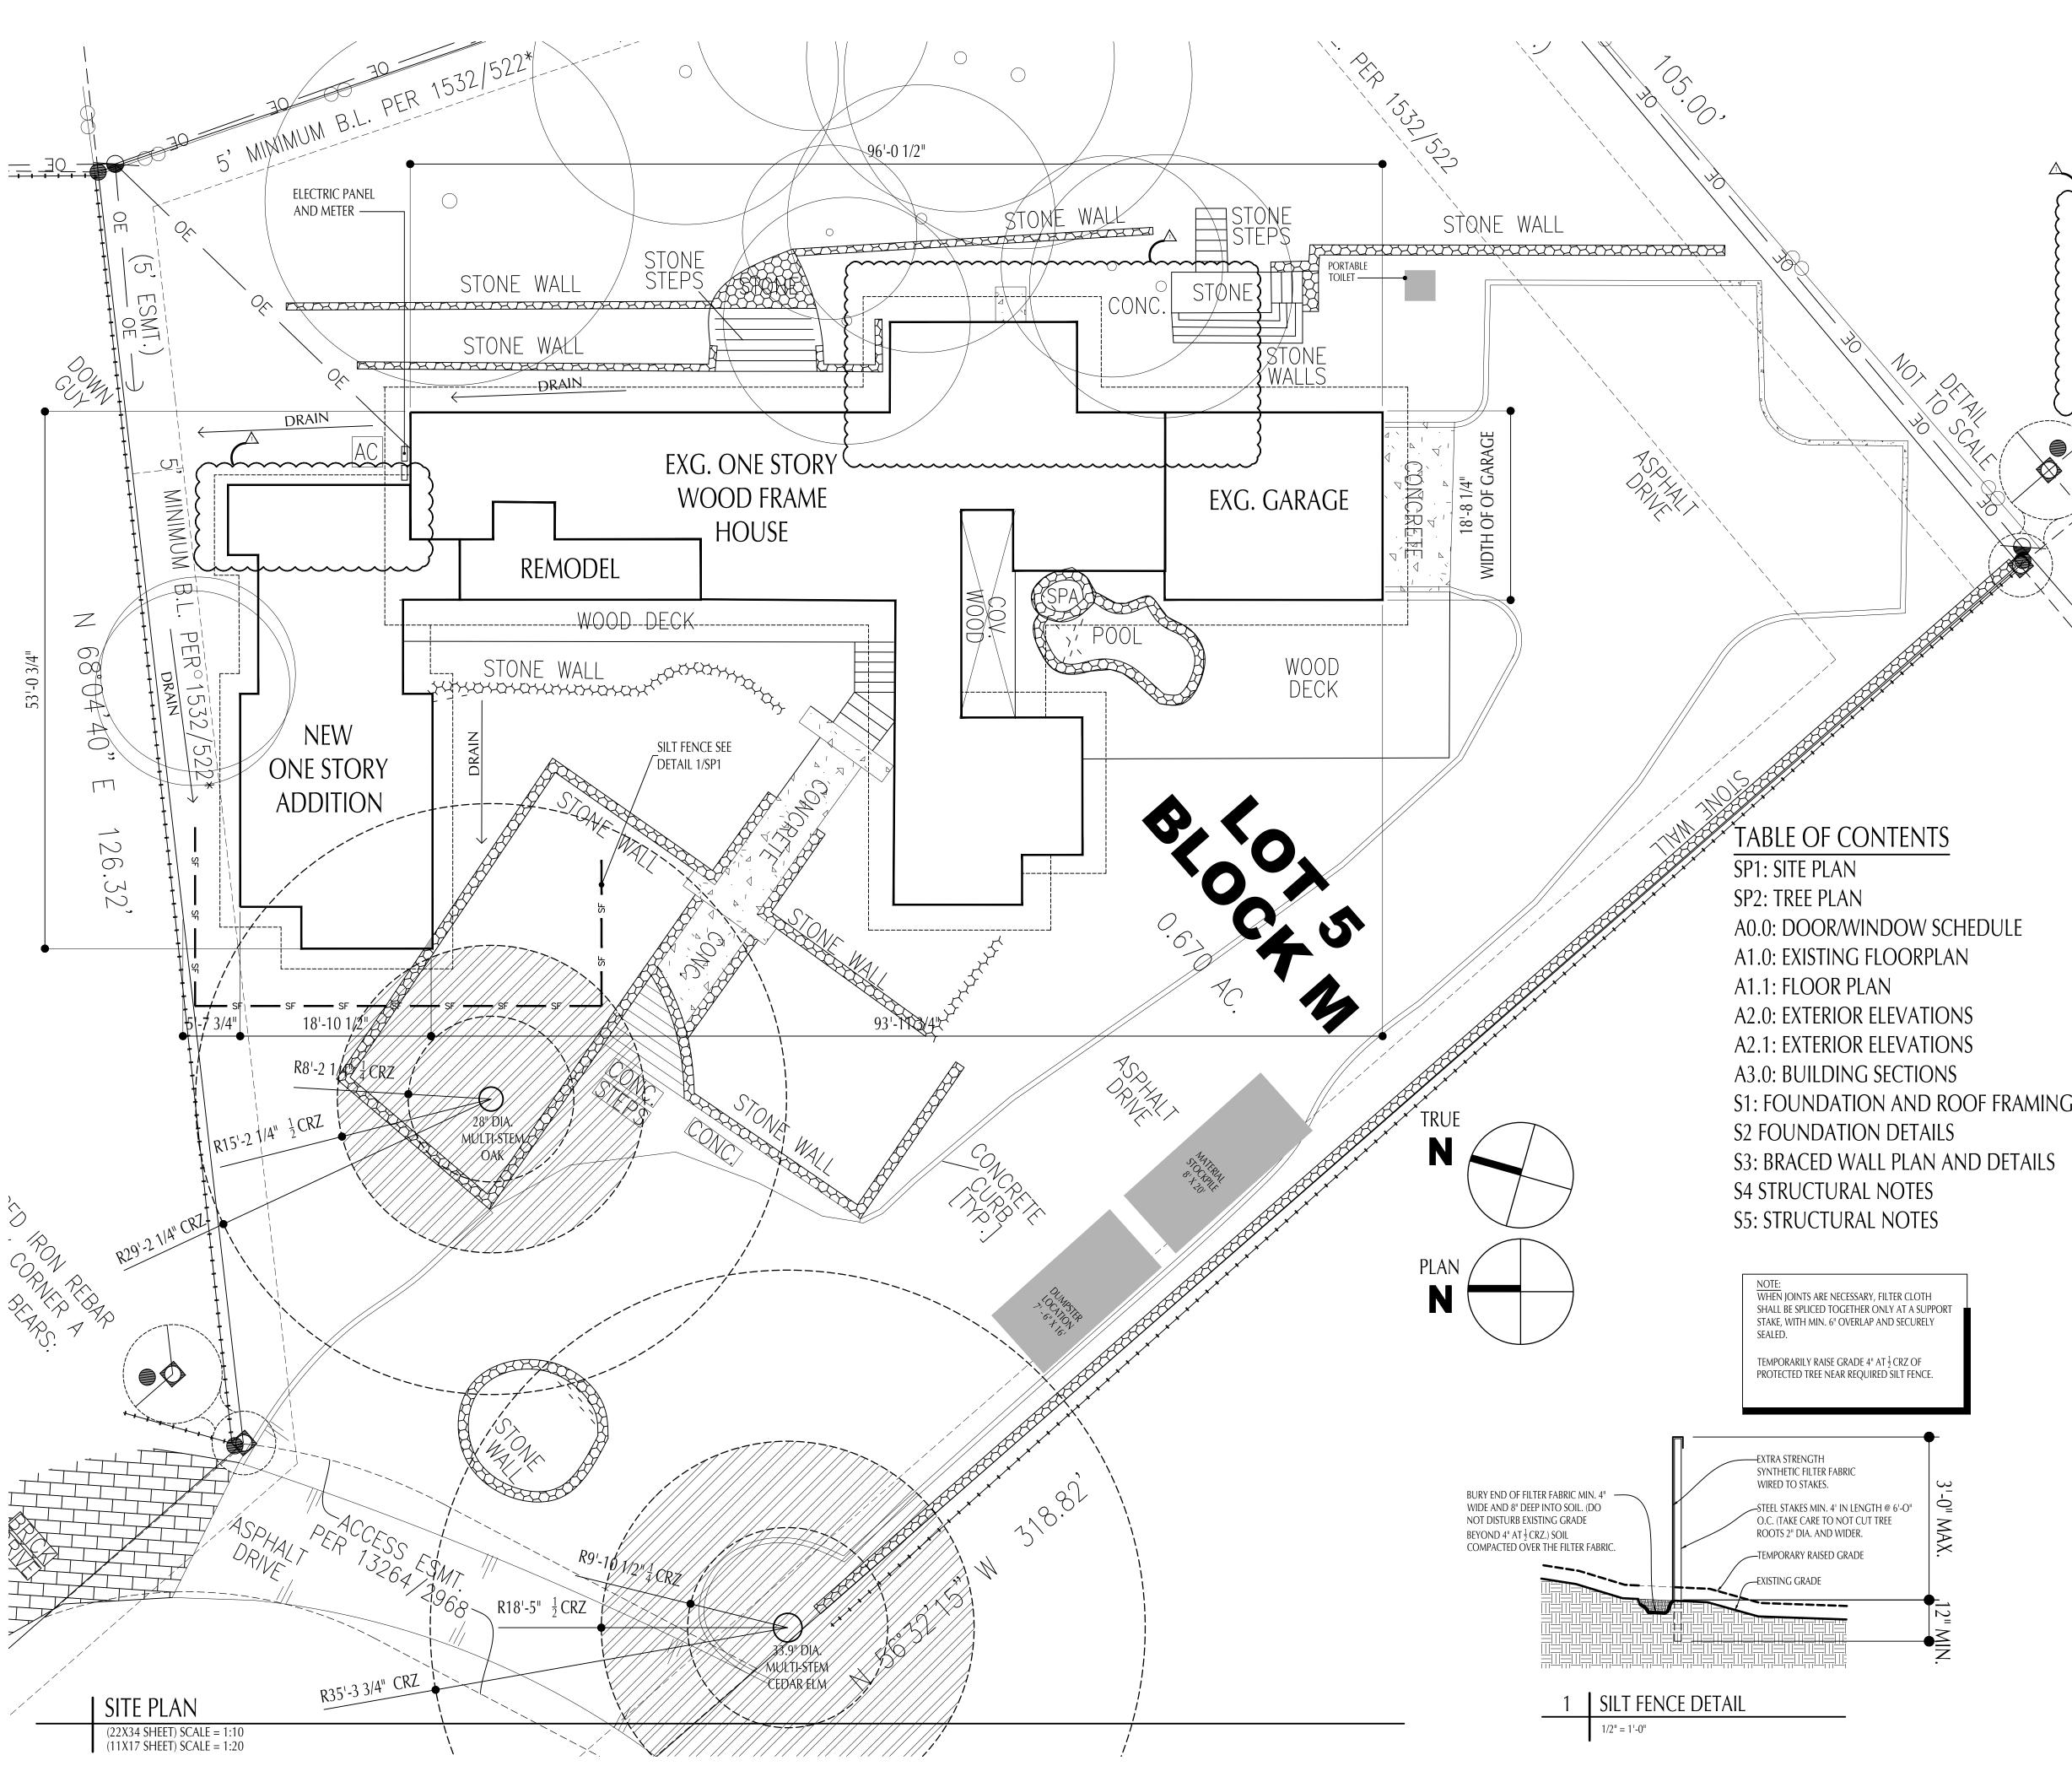

AREA = 156 SF
(NEW)

28" DIA.
MUTLI-STEM OAK

O

TOTAL AREA = 2674 SF
COVERED AREA = 1164 SF

TREE CRZ COVERAGE DIAGRAM

 $\frac{1}{16}$ " = 1'-0"

ALL IMPACTS TO TREE CRITICAL ROOT ZONES

PER ECM 3.5.2

% COVERED AREA = 43.5%

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PHASE:
CONSTRUCTION
DOCUMENTS

PROJECT:

TREMBLAY Residence

4509 BALCONES DR. AUSTIN, TX 78731

PROJECT MANAGER:

DRAWING NAME:

TREE PLAN

DRAWN	N BY:	JD
CHECKI	ED BY:	ND
JOB #:		278
FILE:	278 TR	EMBLAY
©2020	nickdeav	erarchitect
DATE:	07.2	7.20
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SHEET:


SP2

DOOR SCHEDULE

DOOR	SCHEL	<u>Jule</u>					
I.D.	TYP.	NOMINAL R.O. W x H	DESCRIPTION	REMARKS	S" (VERIFY)		WOOD POCKET DOOR
1	Α	3'-6" X 6'-8 "	CUSTOM FRENCH DOORS				
2	В	2'-6" X 6'-8"	GUEST BATHROOM DOOR	PAINTED, FLUSH SOLID CORE RIGHT SWING DOOR	1'-9" 1'-9"	<u>/</u>	
3	С	2'-6" X 6'-8"	GUEST LAV POCKET DOOR	FLUSH SOLID CORE POCKET DOOR, $\frac{3}{4}$ PLYWOOD POCKET DOOR SIDES	A	B	©

E

4 D 2'-8" X 6'-8" LAUNDRY POCKET DOOR FLUSH SOLID CORE POCKET DOOR, ³/₄" PLYWOOD POCKET DOOR SIDES

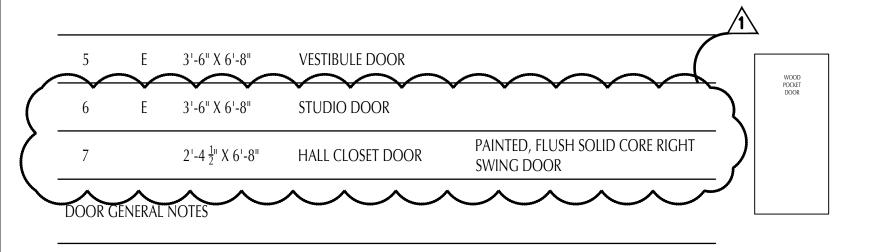

1. ALL DOORS TO BE HINGED AS SHOWN ON PLAN AND ELEVATIONS.

2. CONTRACTOR TO SUBMIT SHOP DWGS. TO ARCHITECT AND VERIFY ALL ROUGH OPENINGS PRIOR TO ORDERING ANY DOORS.

3. ALL DOORS TO BE SOLID CORE UNLESS OTHERWISE NOTED.

4. ALL DOORS ARE 6'-8" HIGH UNLESS OTHERWISE NOTED.

WINDOW SCHEDULE

NO. TYP.

NO.	111.	NOMINAL K.O. W X FI	DESCRIPTION	KLWAKKS (ONIQUE FROI EKTIES)
A	1	8'-1 ½" X 8'-0"	FLEETWOOD 3000 SERIES SLIDING DOOR WITH NARROW 1-1/4" THRESHOLD	
В	FIXED	2'-11 " X 6'-0"	MARVIN ELEVATE DIRECT GLAZE PROFILE	
С	CASEMENT	3'-6½" X 6'-6"	MARVIN ELEVATE	
D	FIXED	3'-7" X 6'-0"	MARVIN ELEVATE DIRECT GLAZE PROFILE	
E	FIXED	6'-7 ½" X 6'- 0"	MARVIN ELEVATE OR FULL LINE	
F	FIXED	3'-5" X 6'-6"	MARVIN ELEVATE DIRECT GLAZE PROFILE	
G	CASEMENT	3'-8" X 6'-0"	MARVIN ELEVATE	
Н	FIXED	3'-5" X 6'-6"	MARVIN ELEVATE DIRECT GLAZE PROFILE	
J	FIXED	1'-3 ½ " X 6'-0"	MARVIN ELEVATE DIRECT GLAZE PROFILE	
K	CASEMENT	2'-0" X 6'-0"	MARVIN ELEVATE	
L	FIXED	4'-0" X 3'-0"	MARVIN ELEVATE	
М	AWNING	2'-4 ¹ / ₄ " X 3'-0"	MARVIN ELEVATE DIRECT GLAZE PROFILE	
N	FIXED	2'-4 ¹ / ₄ " X 3'-0"	MARVIN ELEVATE DIRECT GLAZE PROFILE	
Р	2	3'-5" X 8'-0"	MARVIN ELEVATE	FIXED / ELAWN4127
Q	FIXED	5'-6 ½ " X 2'-6"	MARVIN ELEVATE DIRECT GLAZE PROFILE	
R	AWNING	3'-2" X 2'-6"	MARVIN ELEVATE	
S	AWNING	3'-0" X 2'-6"	MARVIN ELEVATE	1
T	CASEMENT	3'-1" X 4'-11 ⁵ / ₈ "	MARVIN ELEVATE ELCA3759 E	
WINDO	DW GENERAL NOTES			

NOMINAL R.O. W x H DESCRIPTION

1. ALL WINDOWS ARE MARVIN ELEVATE.

2. ALL FIXED WINDOWS ARE MARVIN ELEVATE "DIRECT GLAZE"

3. ALL WINDOW SIZES ARE NOMINAL. CONTRACTOR TO COORDINATE ACTUAL WINDOW FRAME SIZES & ROUGH OPENINGS.


4. TEMPERED GLASS FOR ALL UNITS WITHIN 18" AFF.

5. CONTRACTOR TO SUBMIT SHOP DWGS. TO ARCHITECT AND VERIFY ALL ROUGH OPENINGS PRIOR TO ORDERING ANY WINDOWS.

6. WINDOW HARDWARE "MATCH EXISTING".

WINDOW TYPES

REMARKS (UNIQUE PROPERTIES)

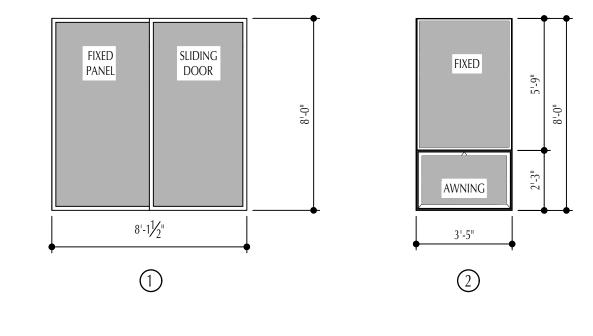

NICK DEAVER

REVISIONS 1. 08.20.20

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NICH Deaver 07.27.20

CONSTRUCTION DOCUMENTS

PROJECT:

TREMBLAY Residence

4509 BALCONES DR. AUSTIN, TX 78731


PROJECT MANAGER:

DRAWING NAME:

NOTES AND SCHEDULES

DRAWN BY: JD CHECKED BY: ND FILE: 278 TREMBLAY © 2020 nickdeaverarchitect DATE: 07.27.20

SCALE:

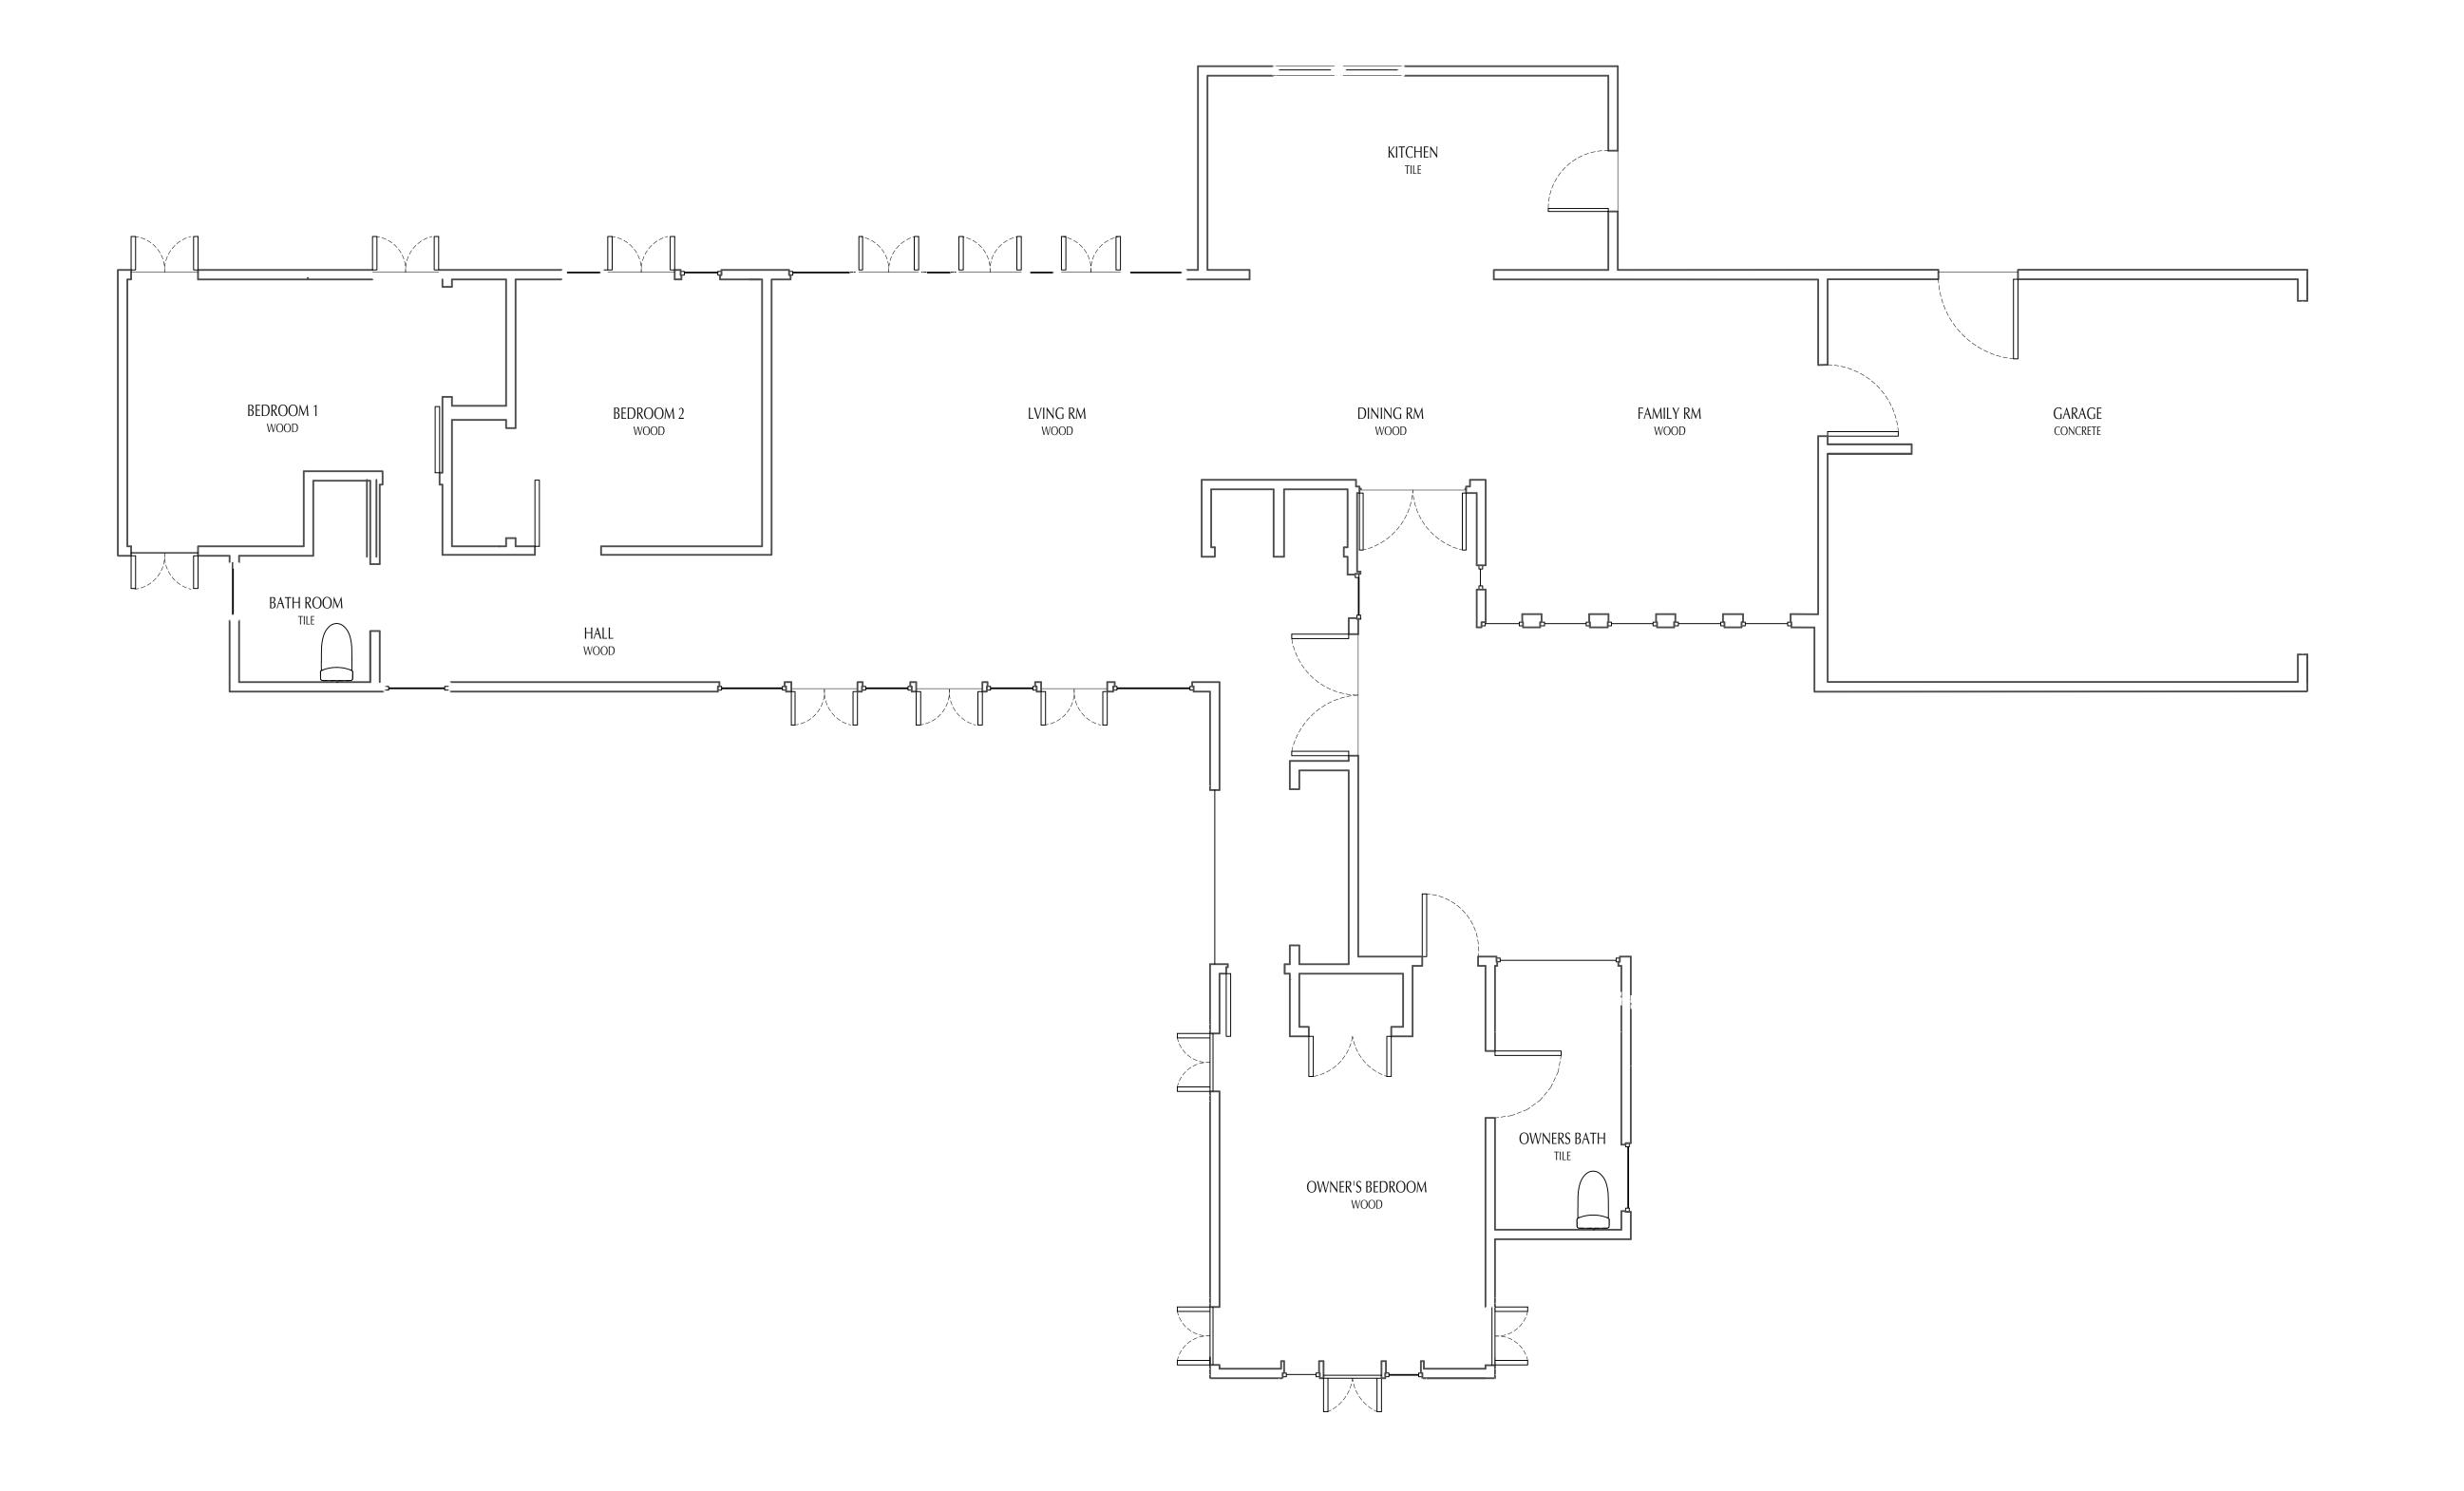

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CONSTRUCTION

DOCUMENTS
PROJECT:

TREMBLAY
Residence
4509 BALCONES DR.
AUSTIN, TX 78731

PROJECT MANAGER:

DRAWING NAME:

EXISTING FLOOR PLANS

DRAWN BY: JD

CHECKED BY: ND

JOB #: 278

FILE: 278 TREMBLAY

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DATE: 07.27.20

SCALE:


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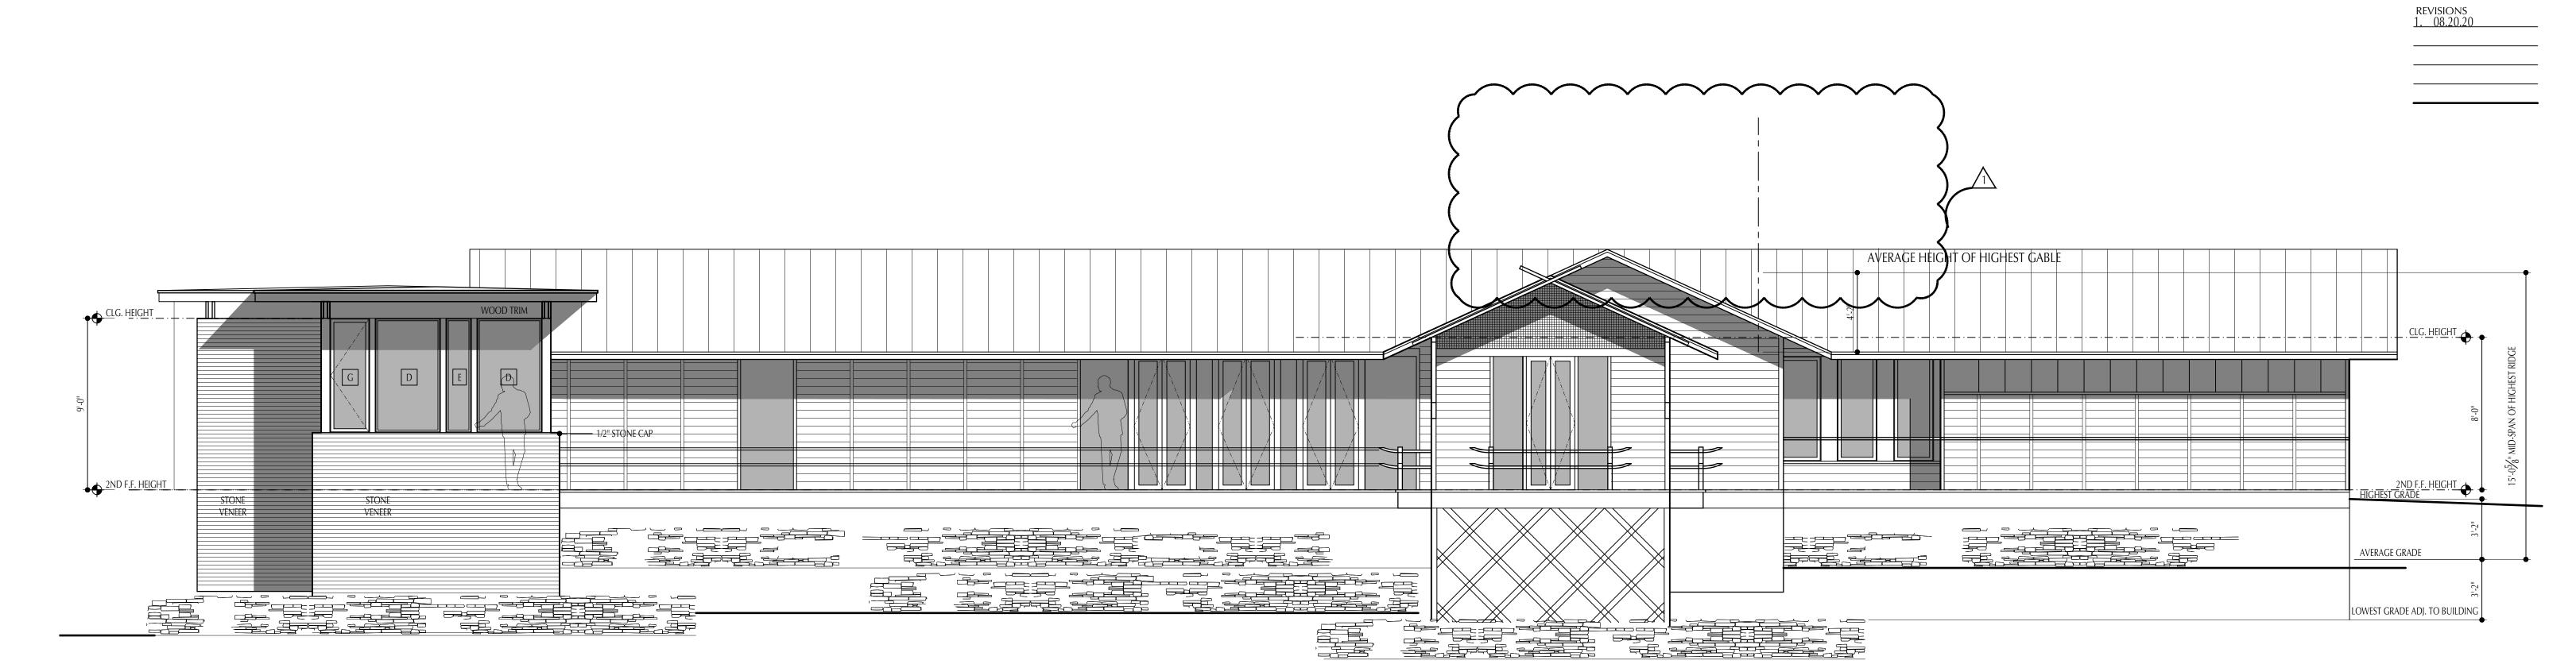
410

EXISTING FLOOR PLAN

1/8" = 1'-0" (11X17) 1/4" = 1'-0" (22X34)






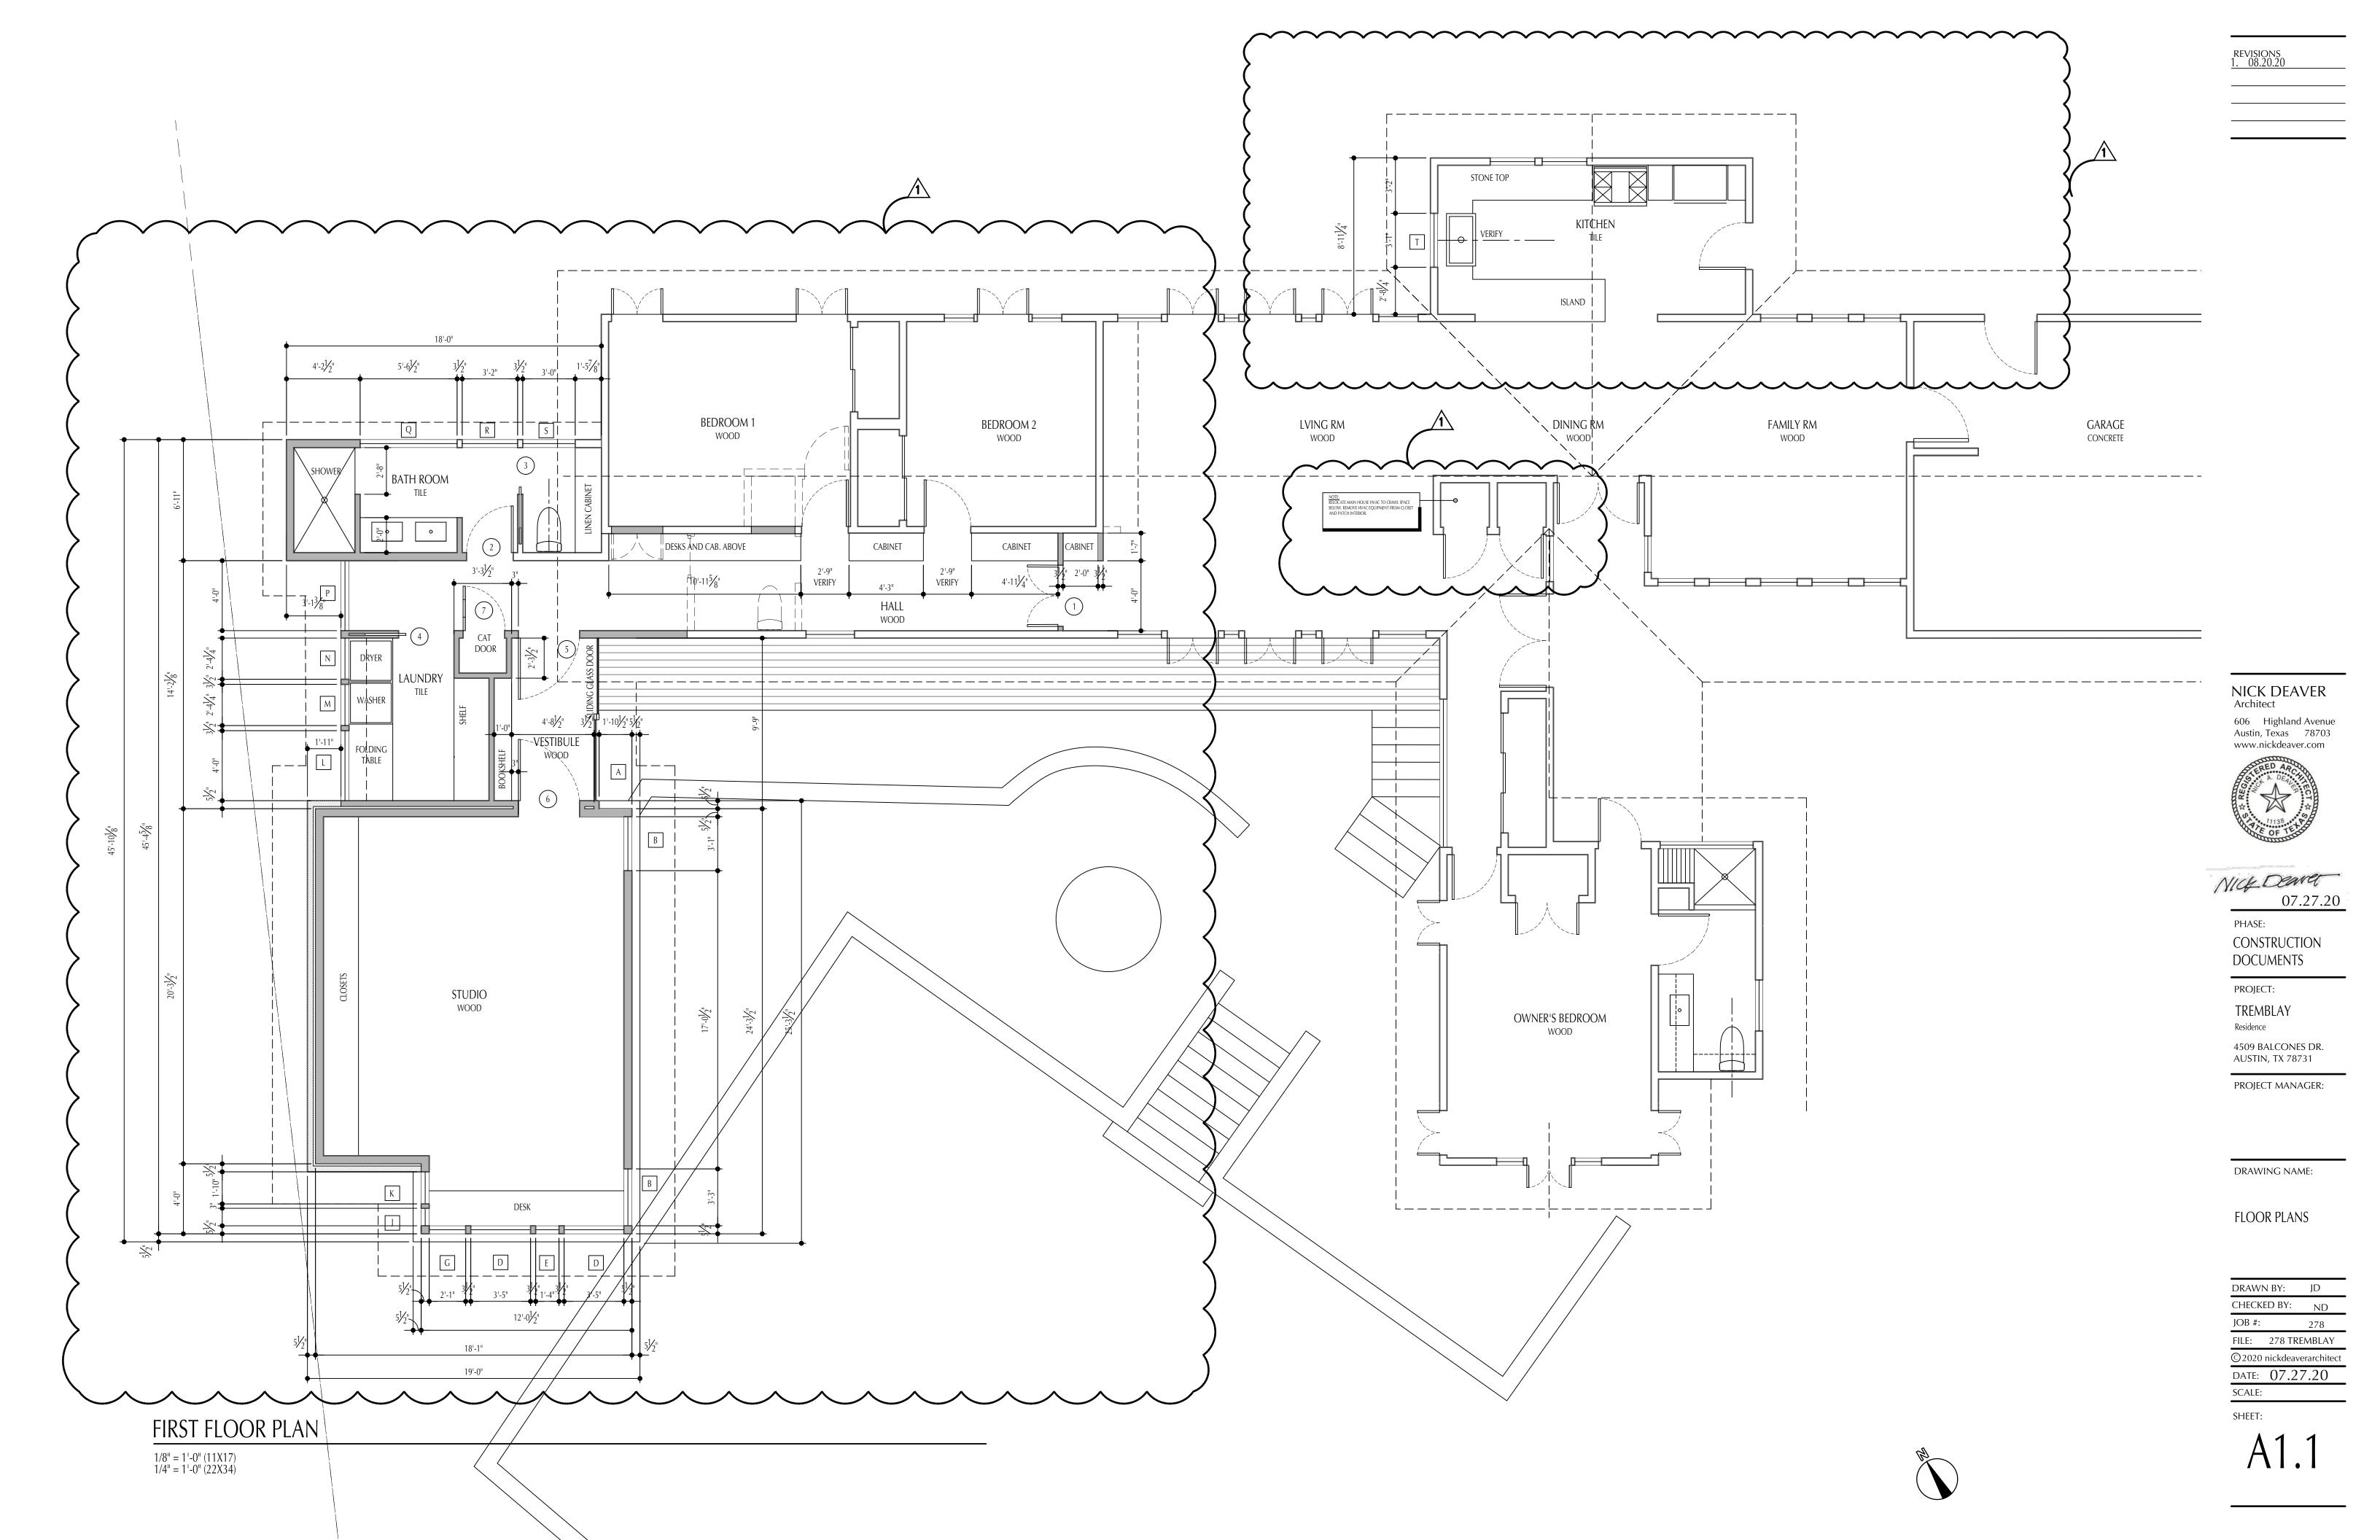

WEST EXTERIOR ELEVATION

1/4" = 1'-0" (22X34) 1/8" = 1'-0" (11X17)

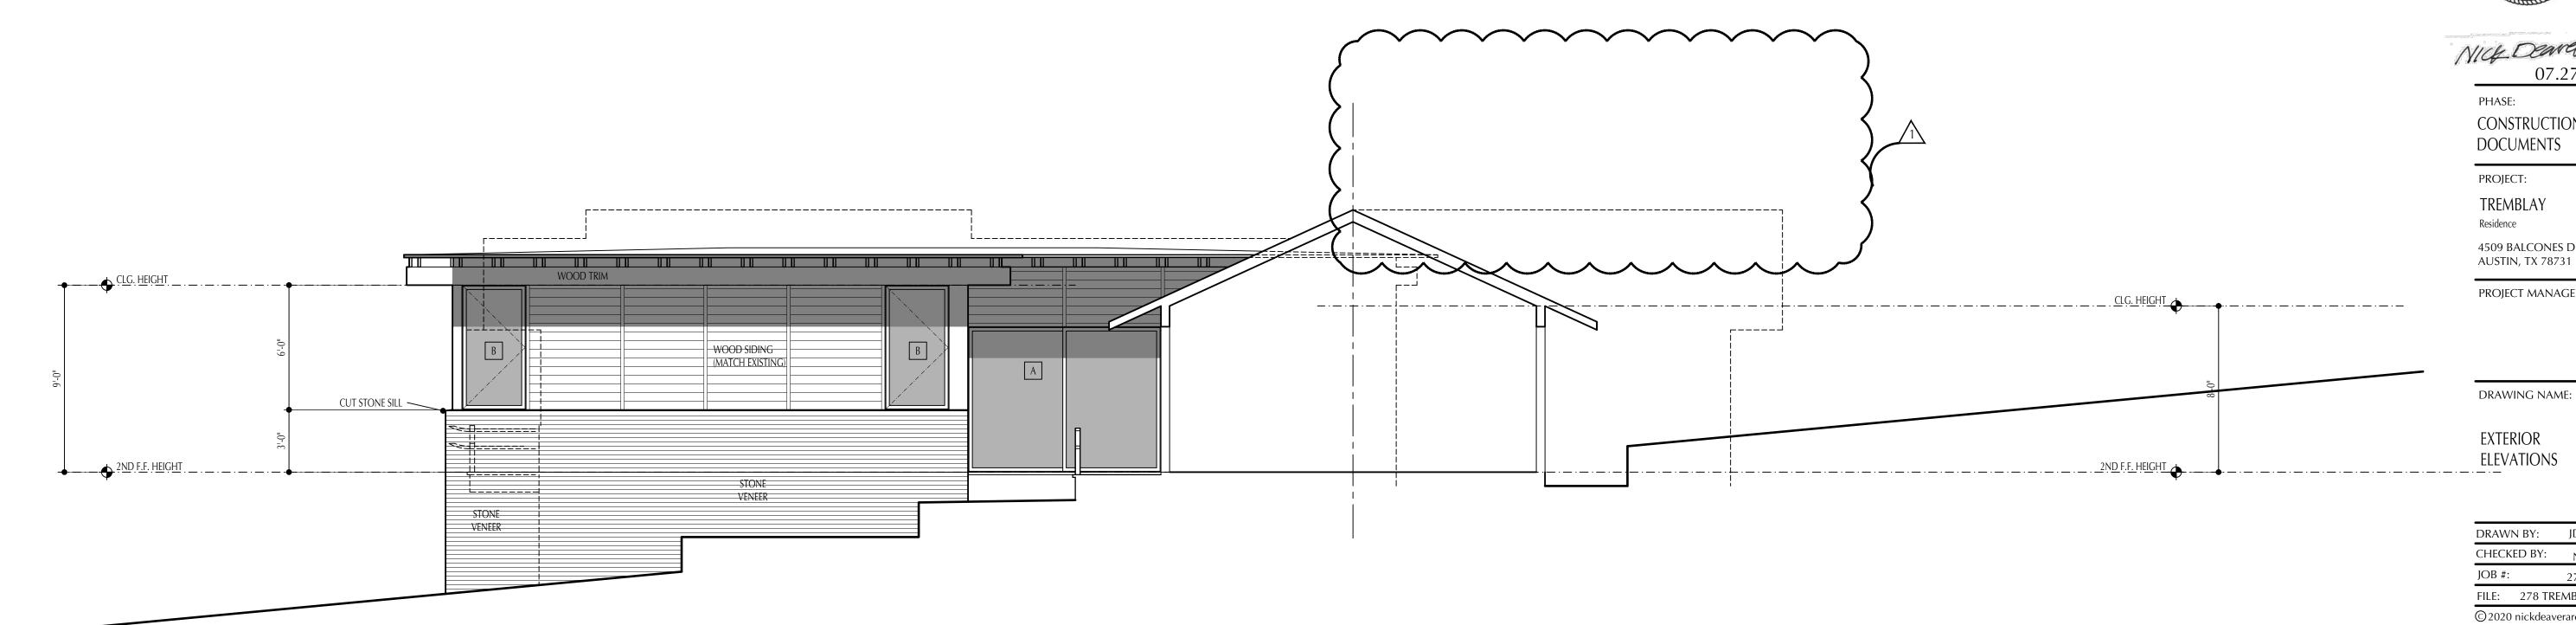

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07.27.20

CONSTRUCTION DOCUMENTS

PROJECT: TREMBLAY

4509 BALCONES DR.

PROJECT MANAGER:

DRAWING NAME:

EXTERIOR ELEVATIONS

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SOUTH EXTERIOR ELEVATION NEW ADDITION

1/4" = 1'-0" (22X34) 1/8" = 1'-0" (11X17)



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CONSTRUCTION DOCUMENTS

PROJECT:

TREMBLAY Residence

4509 BALCONES DR. AUSTIN, TX 78731

PROJECT MANAGER:

DRAWING NAME:


EXTERIOR

ELEVATIONS

DRAWN BY: JD


CHECKED BY: ND


FILE: 278 TREMBLAY
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1/4" = 1'-0" (22X34) 1/8" = 1'-0" (11X17)

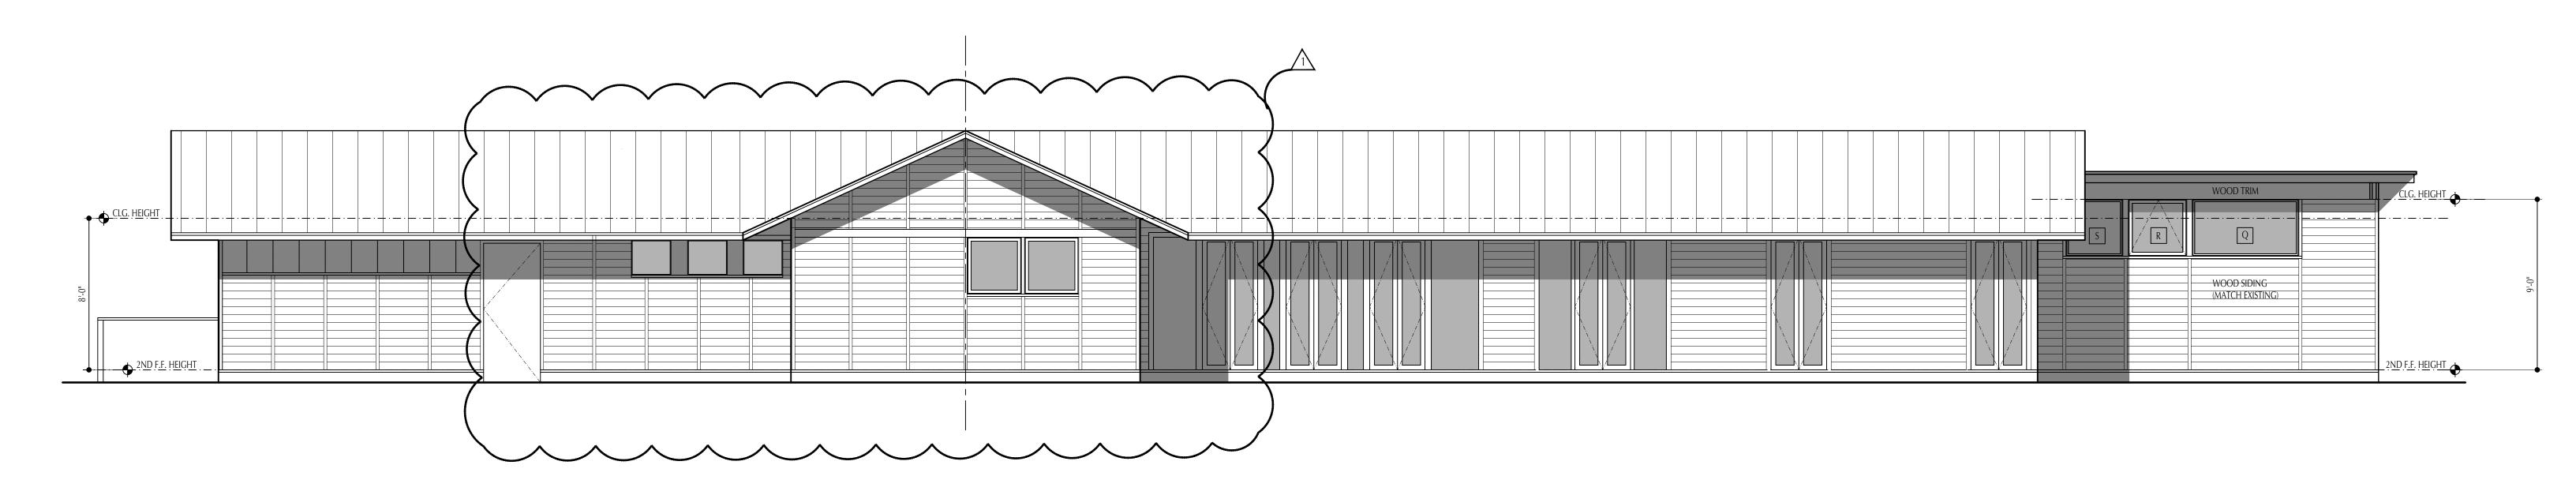




CHECKED BY: ND JOB #: FILE: 278 TREMBLAY © 2020 nickdeaverarchitect DATE: 07.27.20

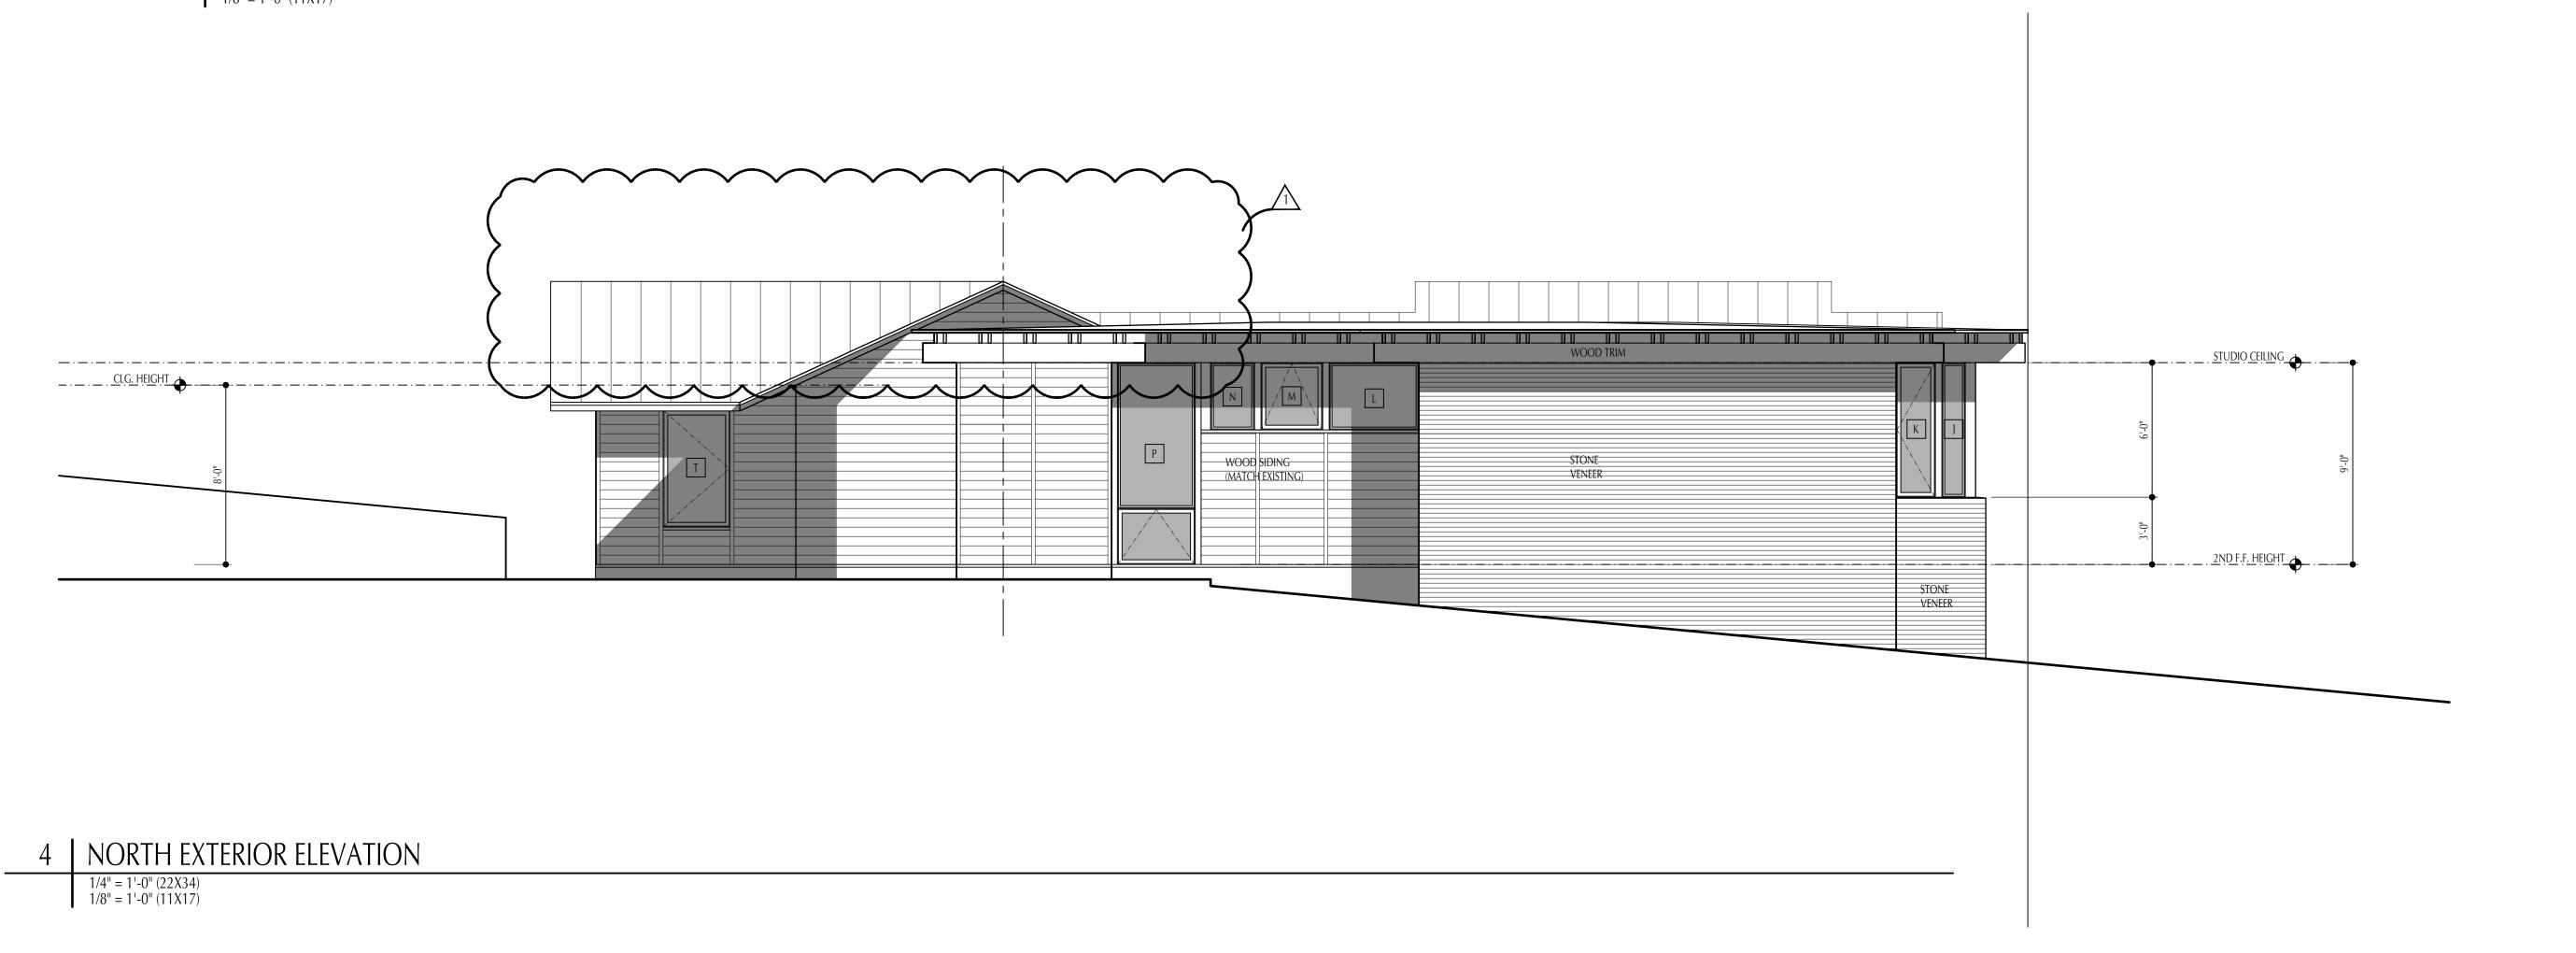SHEET:

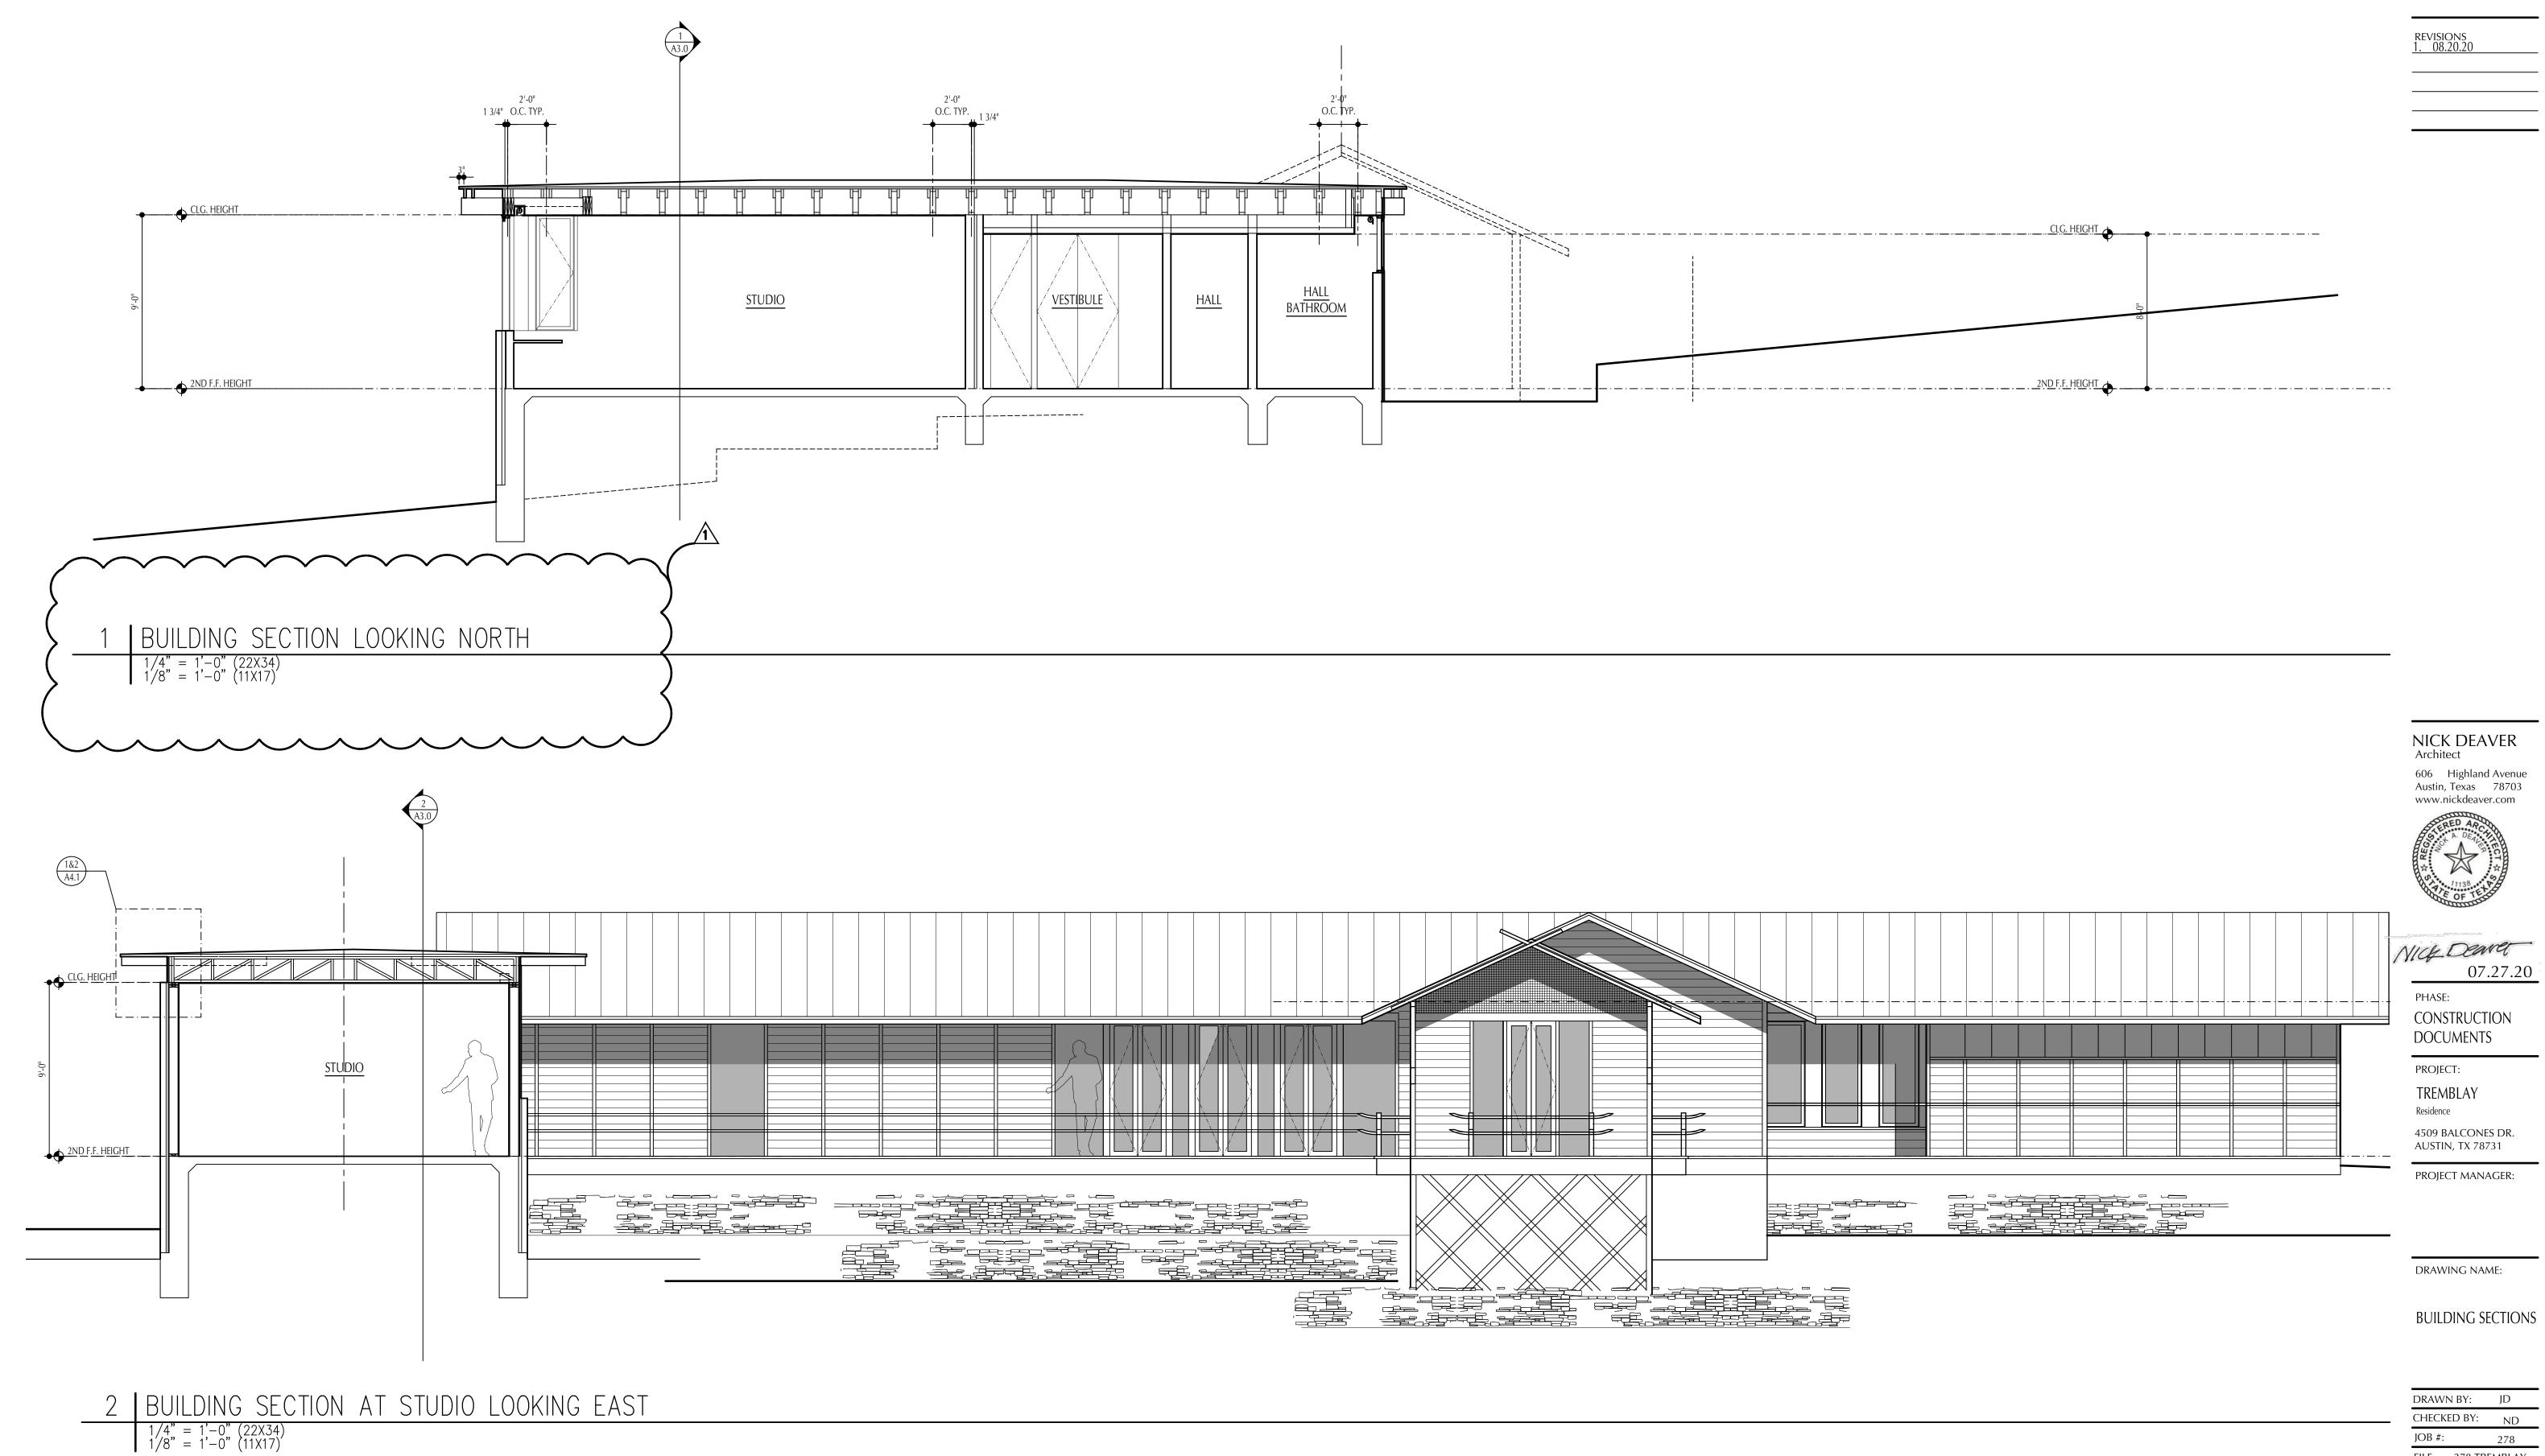SCALE:

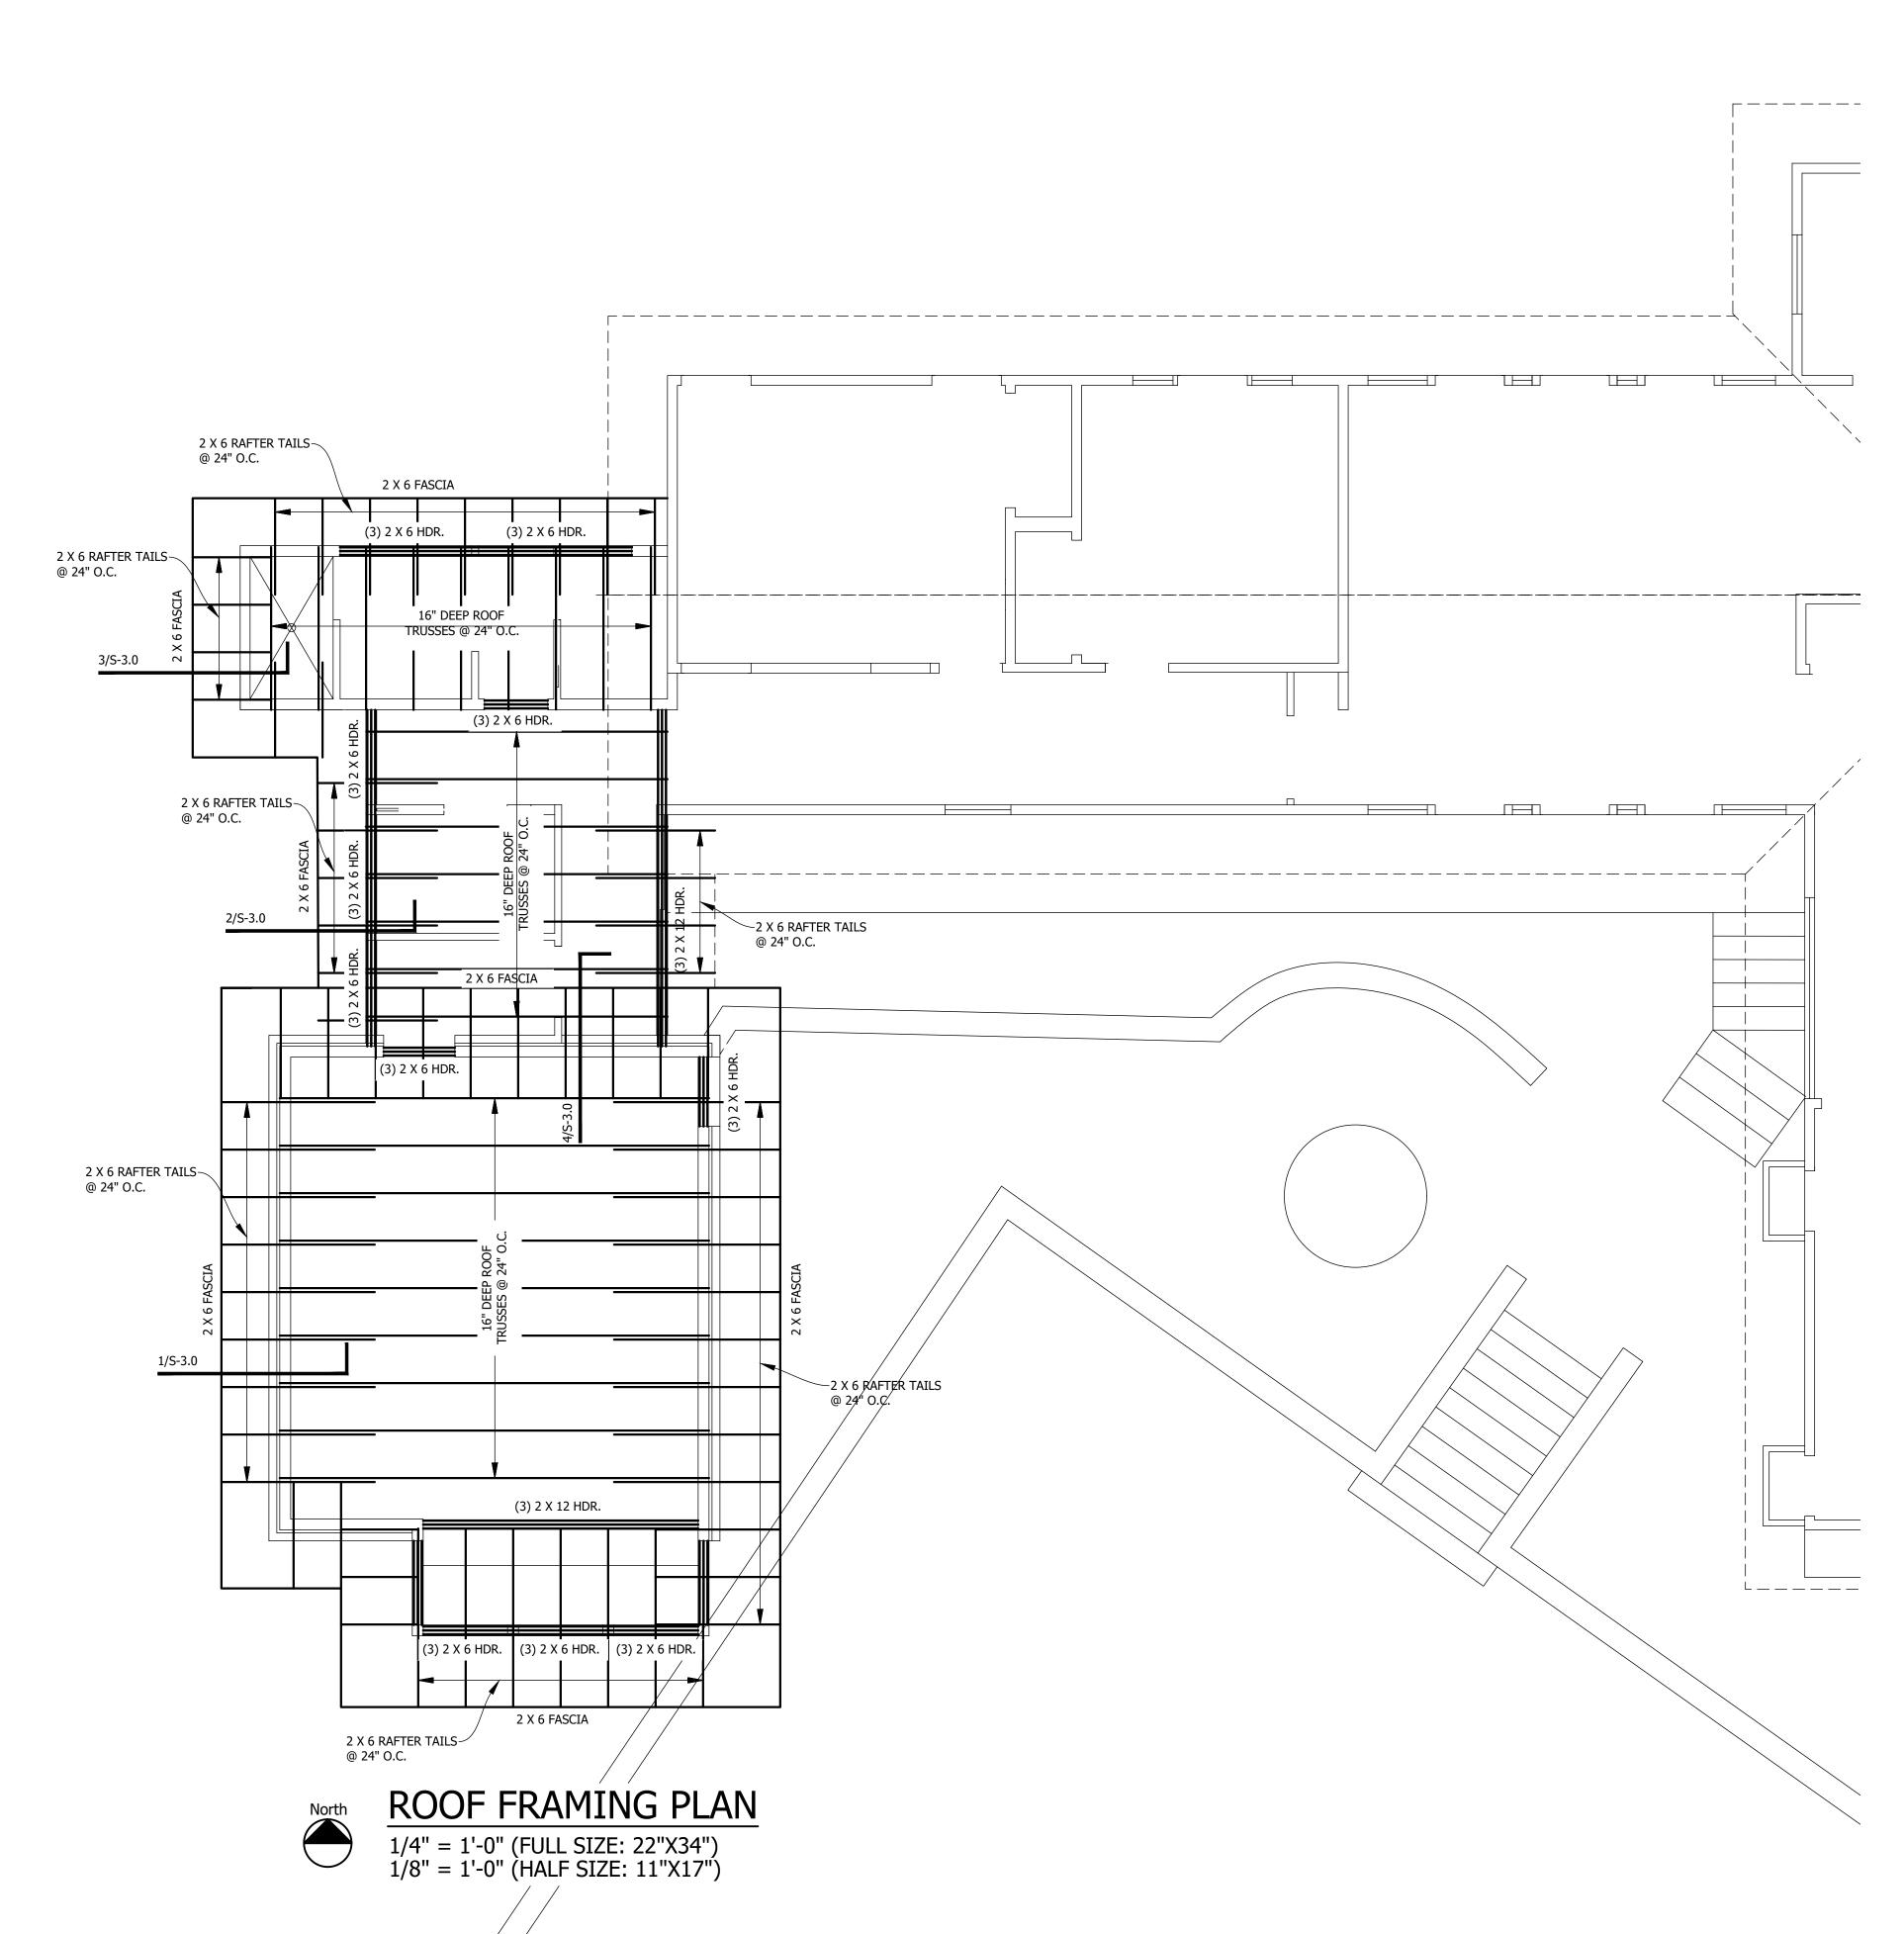





08/12/20 Project Number:

Revisions:

Framing Plan

3 of 6