


SCALE: 1" = 10'-0"

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1806 TRAVIS HEIGHTS BLVD

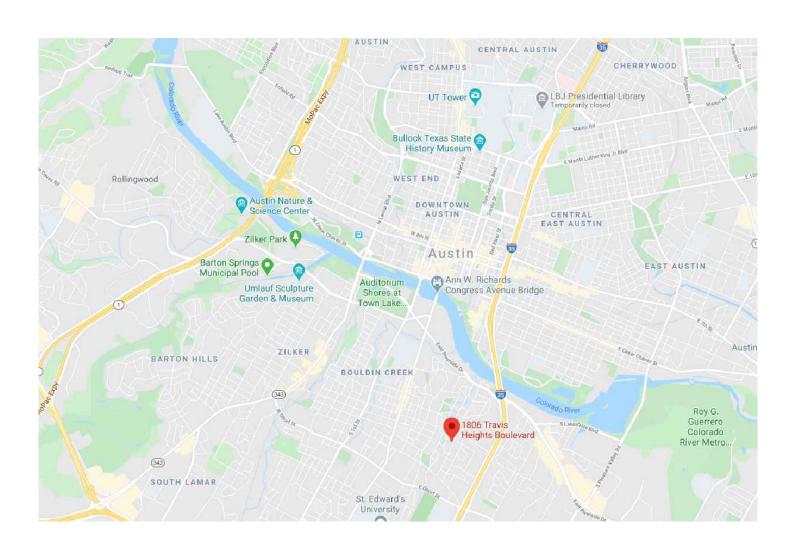

LOCATION MAP SCALE: N/A

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REMODEL/ADDITION

LEGAL DESCRIPTION: LOT 11 BLK 21 TRAVIS HEIGHTS

ZONING: SF-3-NP

PROJECT SUMMARY:

I KOJECI JUM	
TOTAL SITE:	6,847 SF
REMODEL AREA: ADDITION AREA: NEW DECK (100%):	708 SF
ZONING: WATERSHED: BLUI FLOODPLAIN:	SF-3-NP NN CREEK NO
BUILDING AREA	
BLDG COVERAGE: New Bldg CVRG:	1,160 SF 1,278 SF 18.67%
ALLOWABLE FAR:	2,739 SF
EXISTING FAR: EXISTING % FAR:	1,160 SF 16.94 %
Proposed far: Proposed % far:	1,868 SF 27.28 %
IMPERVIOUS COVER	
ALLOWABLE I.C:	3,081 SF
EXISTING I.C.	2,502 SF 36.54%

PROPOSED I.C.	2,601 SF 37.98 %
EXISTNG FOOTRPINT:	1,160 SF
ADTL. FOOTPRINT:	118 SF
CONC. DRIVE/STAIRS	S: 636 SF
NEW DECK 754SF@50	0% 377 SF
SET STONE WALL/EDG	GE 192 SF
EXISTING CONC. WA	LL 100 SF

NEW IMPERVOUS: 2,601 SF

2 AC PADS:

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NOTES:

SHEET INDEX.

SHEET INDEX:	
00 L0	DCATION/SUMMARY
01	RENDERINGS
SP1	EXIST/NEW SITEPLAN
SP2	SITE AREA TOTALS
SP3	FRONT YARD TOTALS
A.1.0	DEMO PLAN
A1.1	FLOOR PLANS
A1.2	ROOF PLAN
A1.3	FLOORING
A1.4	CEILING MTRLS
A1.5	LIGHTING
A1.6	POWER
A1.7	HVAC
A1.8	WINDOWS
A1.9	DOORS
A2.1	EXTERIOR ELEVS
A2.2	EXTERIOR ELEVS
A3.1	EXTERIOR ELEVS
A3.2	INTERIOR ELEVS
A3.3	INTERIOR ELEVS
A3.4	INTERIOR ELEVS

A4,1	DETAILS
SO.0 S1.0 S1.1 S2 S3.0 S4.0 S4.1 S5.0	STRUCTURAL NOTES FOUNDATION 2ND/ROOF FRAMING DORMER FRAMING FRAMING DETAILS ROOF DETAILS TRUSS DETAILS BRACING/DECKING
\$5.1	HEADER/STUD DTILS

INTERIOR ELEVS

A3.4

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ALL LANDSCAPING TO PROMOTE DRAINAGE AWAY FROM THE STRUCTURE & FOUNDATION. PROVIDE SILT FENCING AND/OR MULCH SOCKS AT PERIMETER OF SITE.



RB ARCHITECT, PLLC



hollingsworth pack austin

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GENERAL CONTRACTOR: JV GENERAL CARPENTRY JUAN VARELA

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PRICING SET

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NEW REMODEL 1806 TRAVIS HEIGHTS BLVD AUSTIN, TX 78704

DATE 8 / 14 / 20 10 / 15 / 20 REV1 10 / 30 / 20

SCALE

Sheet Name



Q R

18 SF









15

1806 TRAVIS HEIGHTS BLVD

REMODEL/ADDITION

LEGAL DESCRIPTION: LOT 11 BLK 21 TRAVIS HEIGHTS

ZONING: SF-3-NP

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SP1 EXIST/NEW SITEPLAN SP2 SITE AREA TOTALS SP3 FRONT YARD TOTALS

A.1.0 A1.1 A1.2 A1.3 A1.4 A1.5 A1.6 A1.7 A1.8 A1.7 A1.8 A1.7 A2.1 A2.1 A2.2 A3.1 A3.2 A3.3 A3.4 A3.4 A3.4	D DEMO PLAN FLOOR PLANS ROOF PLAN FLOORING CEILING MTRLS LIGHTING POWER HVAC WINDOWS DOORS EXTERIOR ELEVS EXTERIOR ELEVS INTERIOR ELEVS INTERIOR ELEVS INTERIOR ELEVS INTERIOR ELEVS INTERIOR ELEVS INTERIOR ELEVS INTERIOR ELEVS
S0.0	STRUCTURAL NOTES
S1.0	FOUNDATION
S1.1	2ND/ROOF FRAMING
S2	DORMER FRAMING
S3.0	FRAMING DETAILS
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CARBON MONOXIDE ALARM: THE GENERAL CONTRACTOR IS RESPONSIBLE THAT THE DWELLING UNIT BE EQUIPPED WITH AN APPROVED CARBON MONOXIDE ALARM AT CORRESPONDING LOCATIONS, IN ACCORDANCE WITH 2015 IRC SECTION R315.

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hollingsworth pack austin -

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NEW REMODEL 1806 TRAVIS HEIGHTS BLVD AUSTIN, TX 78704

8 / 14 / 20 10 / 15 / 20 10 / 30 / 20

SCALE

DATE

REV1

Sheet Name


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ENCLOSURES.

ACCORDANCE WITH 2015 IRC SECTION R314. 36" AWAY FROM HORIZONTAL PATH OF MECHANICAL AIR FLOW. PER NFPA 72 CHAPTER 11.

INSTALL POLYISOCYANURATE FOAM TYPE INSUATION - OR EQUIVALENT - AT FLOOR CAVITIES.

EXHAUST ALL VENTS AND FANS DIRECTLY OUTSIDE VIA METAL DUCTS.

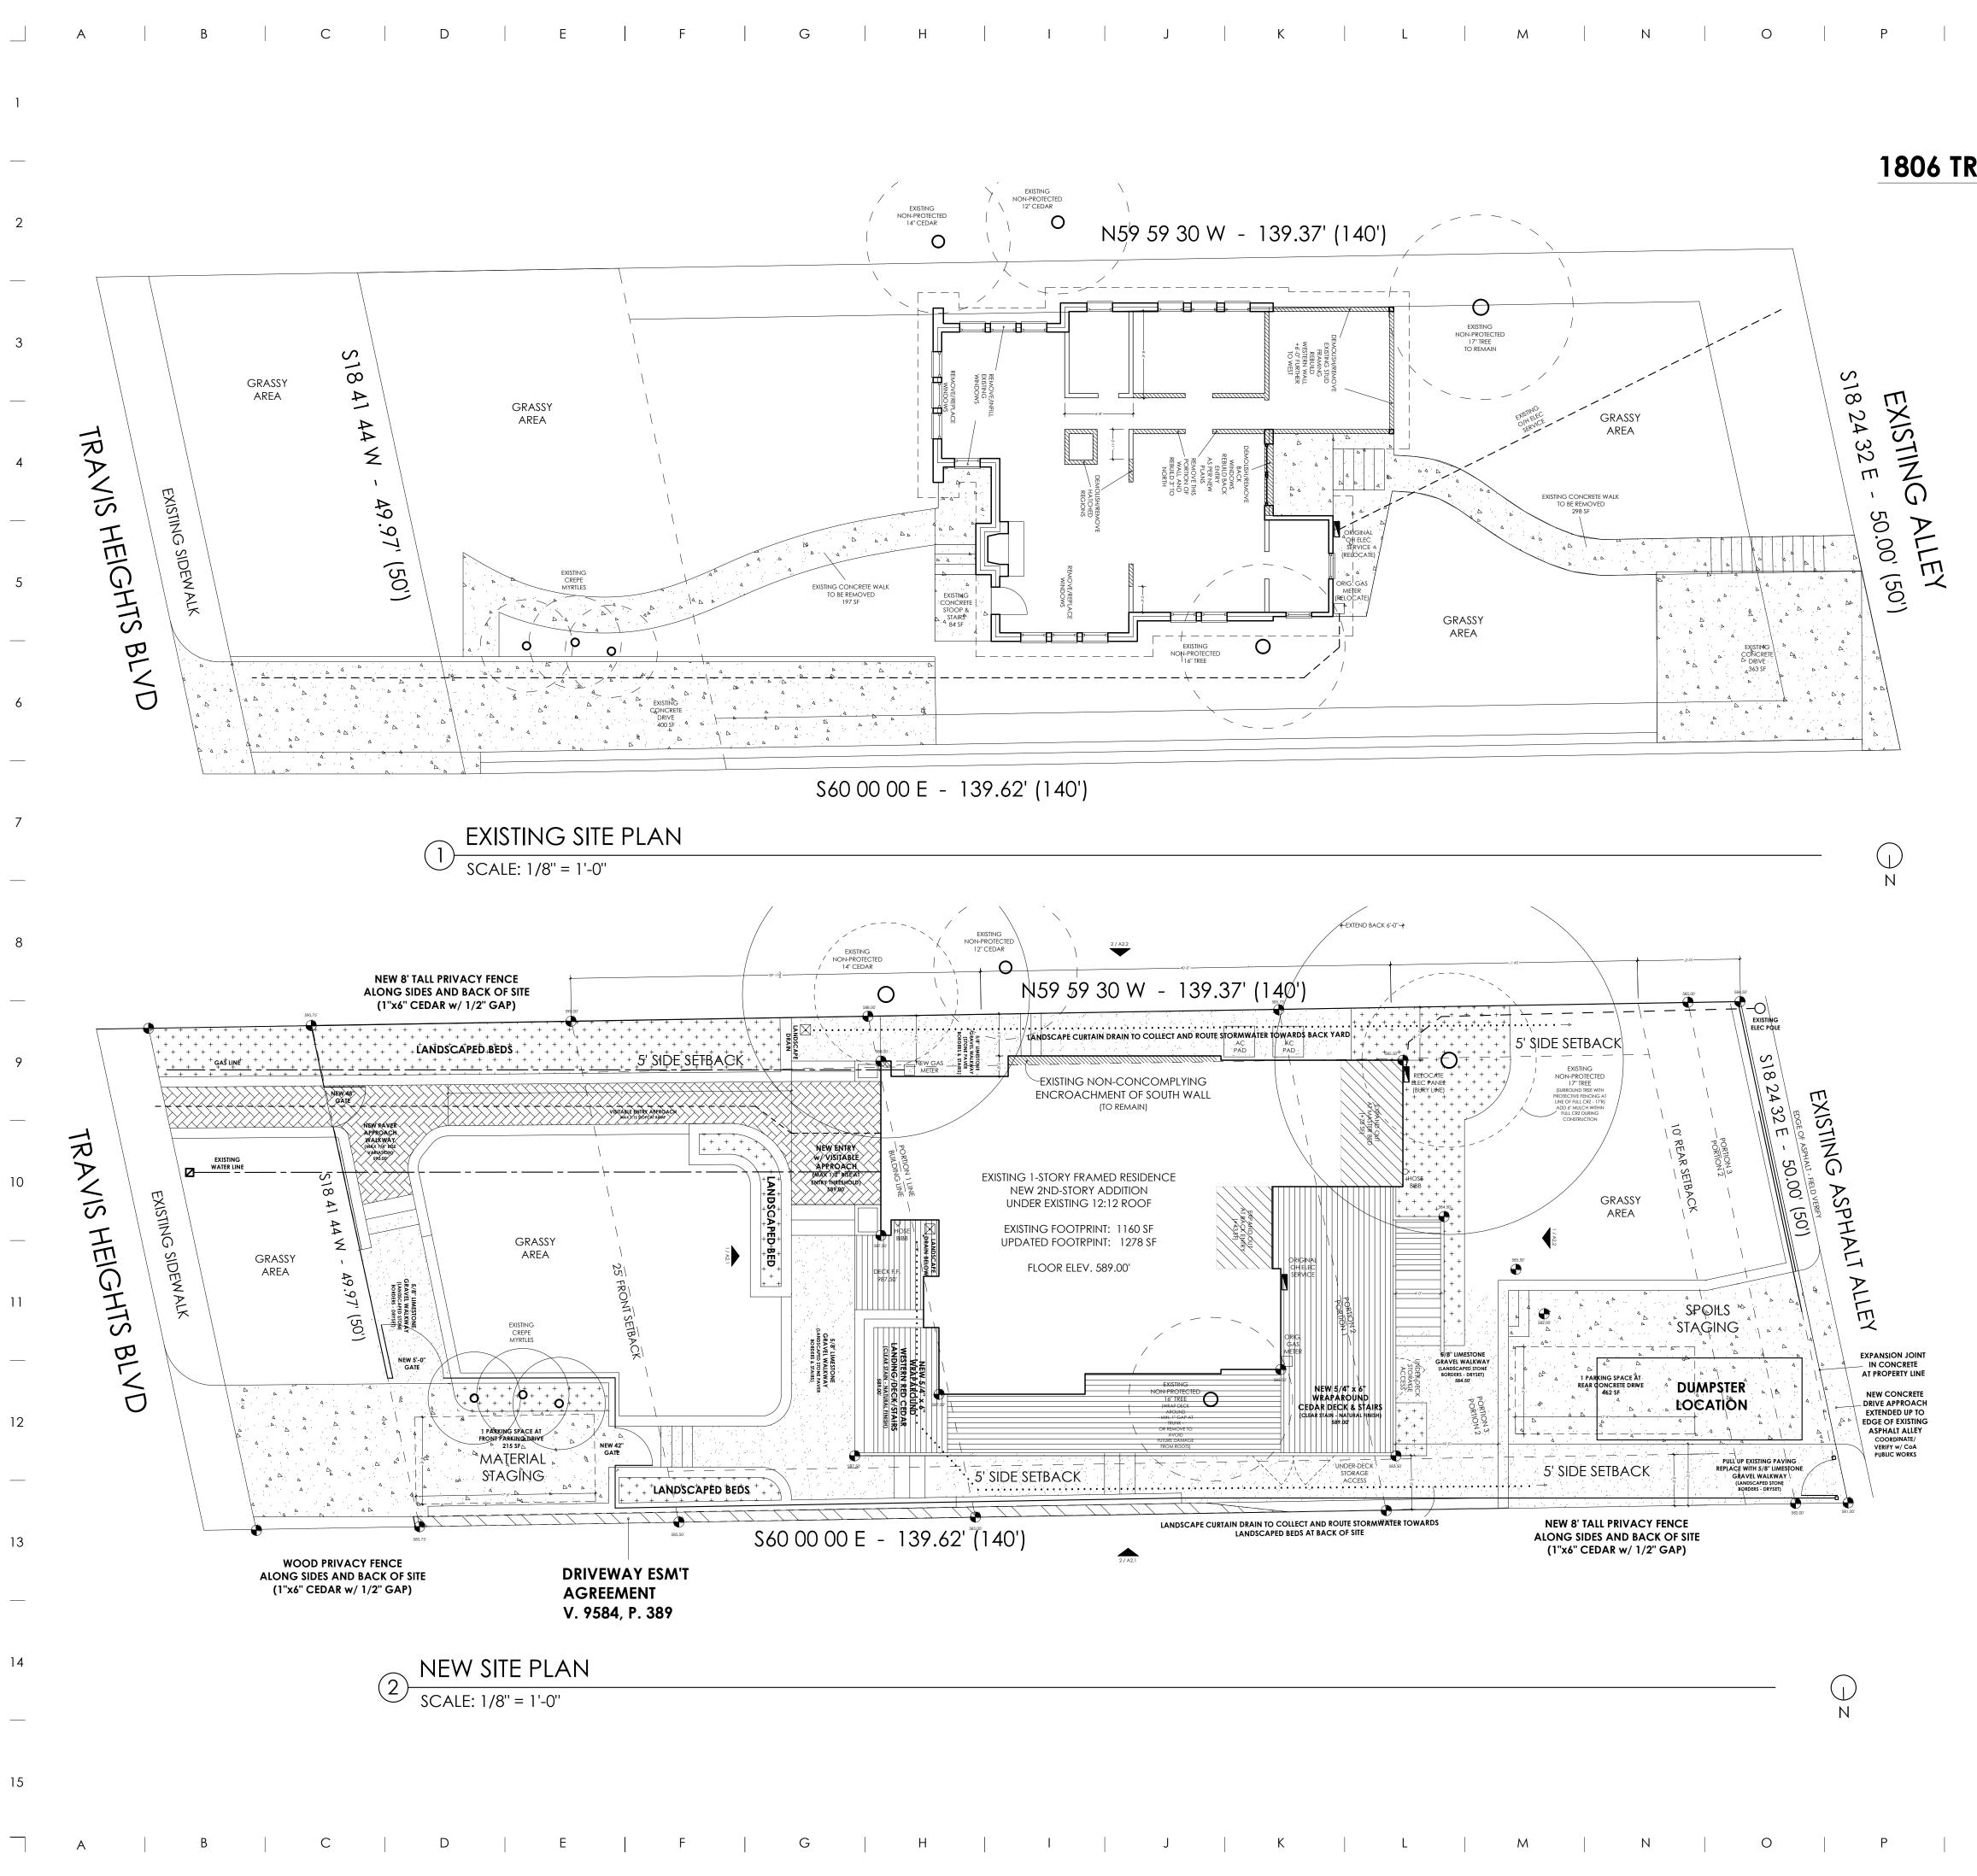

NOTES:

1806 TRAVIS HEIGHTS BLVD REMODEL/ADDITION

GENERAL NOTES:

HIGH PERFORMANCE WINDOWS:

New Glazing to achieve Austin Energy Code requirements: U-Value of 0.35 / SHGC Factor of 0.25.

INSULATION: New Walls: Minimum of **R19** New Roof: Minimum of **R38**. Floor Insulation: Minimum or **R13**.

SAFETY GLAZING: Safety Glazing to be installed as per IRC section R308.4. (Noted locations: glass in doors, windows 24" or less from a door jamb, glazing less than 5'-0" above tub floor if applicable, and at tub/shower enclosures.)

SMOKE DETECTOR SYSTEM:

General Contractor is responsible that the dwelling unit to be equipped with an APPROVED SMOKE DETECTOR system at corresponding locations, in accordance with 2015 IRC Section R314.

General Contractor to verify Smoke Detectors are located at least 36" away from horizontal path of mechanical air flow. **Per 2007 NFPA 72 Chapter 11**.

CARBON MONOXIDE ALARM:

General Contractor is responsible that the dwelling unit to be equipped with an Approved CARBON MONOXIDE ALARM at corresponding locations, in accordance with **2015 IRC Section R315**.

VISITABILITY NOTES:

EXTERIOR ROUTE:	

POINT OF ORIGIN: FRONT SIDEWALK ELEVATION 590'-0" VISITABLE ENTRANCE: FRONT ENTRY DOOR

WALK FROM FRONT SIDEWALK VISITABLE ROUTE:

MAX. SLOPE 1:12 / 8.3% VISITABLE DOORWAY: 1) 36" WIDE x 6'-8" TALL DOOR (MIN. 32" CLEAR WIDTH) 2) BEVELED THRESHOLD w/ 1/2" MAX RISE

TO FRONT DOOR: 70'-0" LENGTH

LANDING ELEV: 589'-0"

INTERIOR COMPLIANCE:

BATHROOM ROUTE: FRONT ENTRY DOOR TO BATH 1, KITCHEN, FRONT LIVING/DINING, AND BEDROOMS.

1) MINIMUM CLEAR WIDTH OF 32". 2) THRESHOLDS AND TRANSITIONS TO BE RAMPED OR


1) MINIMUM CLEAR OPENING OF 30" AT DOOR.

2) LATERAL 2"x6" WOOD BLOCKING SHALL BE INSTALLED FLUSH WITH STUD EDGES OF BATHROOM WALLS. CENTERLINE OF BLOCK AT 34" A/F/F/ EXCEPT FOR PORTION OF THE WALL LOCATED DIRECTLY BEHIND THE LAVATORY.

ELECTRICAL:

1) LIGHT SWITCHES AND ENVIRONMENTAL CONTROLS NO HIGHER THAN 48" ABOVE FINISHED FLOOR LEVEL. (TO TOP OF DEVICE/SWITCH)

2) OUTLETS AND RECEPTICALS MINIMUM OF 15" ABOVE INTERIOR FLOOR LEVEL EXCEPT FOR FLOOR OUTLETS.

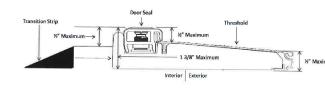

TYPICAL VISITABLE THRESHOLD Coa Detail: CI2013-0002







hollingsworth pack austin

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NEW REMODEL 1806 TRAVIS HEIGHTS BLVD AUSTIN, TX 78704

DATE	8 / 14 / 20
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	10 / 30 / 20

SCALE

SHEET NAME

ALL LANDSCAPING TO PROMOTE DRAINAGE AWAY FROM THE STRUCTURE & FOUNDATION.

PROVIDE SILT FENCING AND/OR MULCH SOCKS AT PERIMETER OF SITE.

Q R

(SEE DETAIL BELOW)

BEVELED.

VISITABLE BATHROOM:

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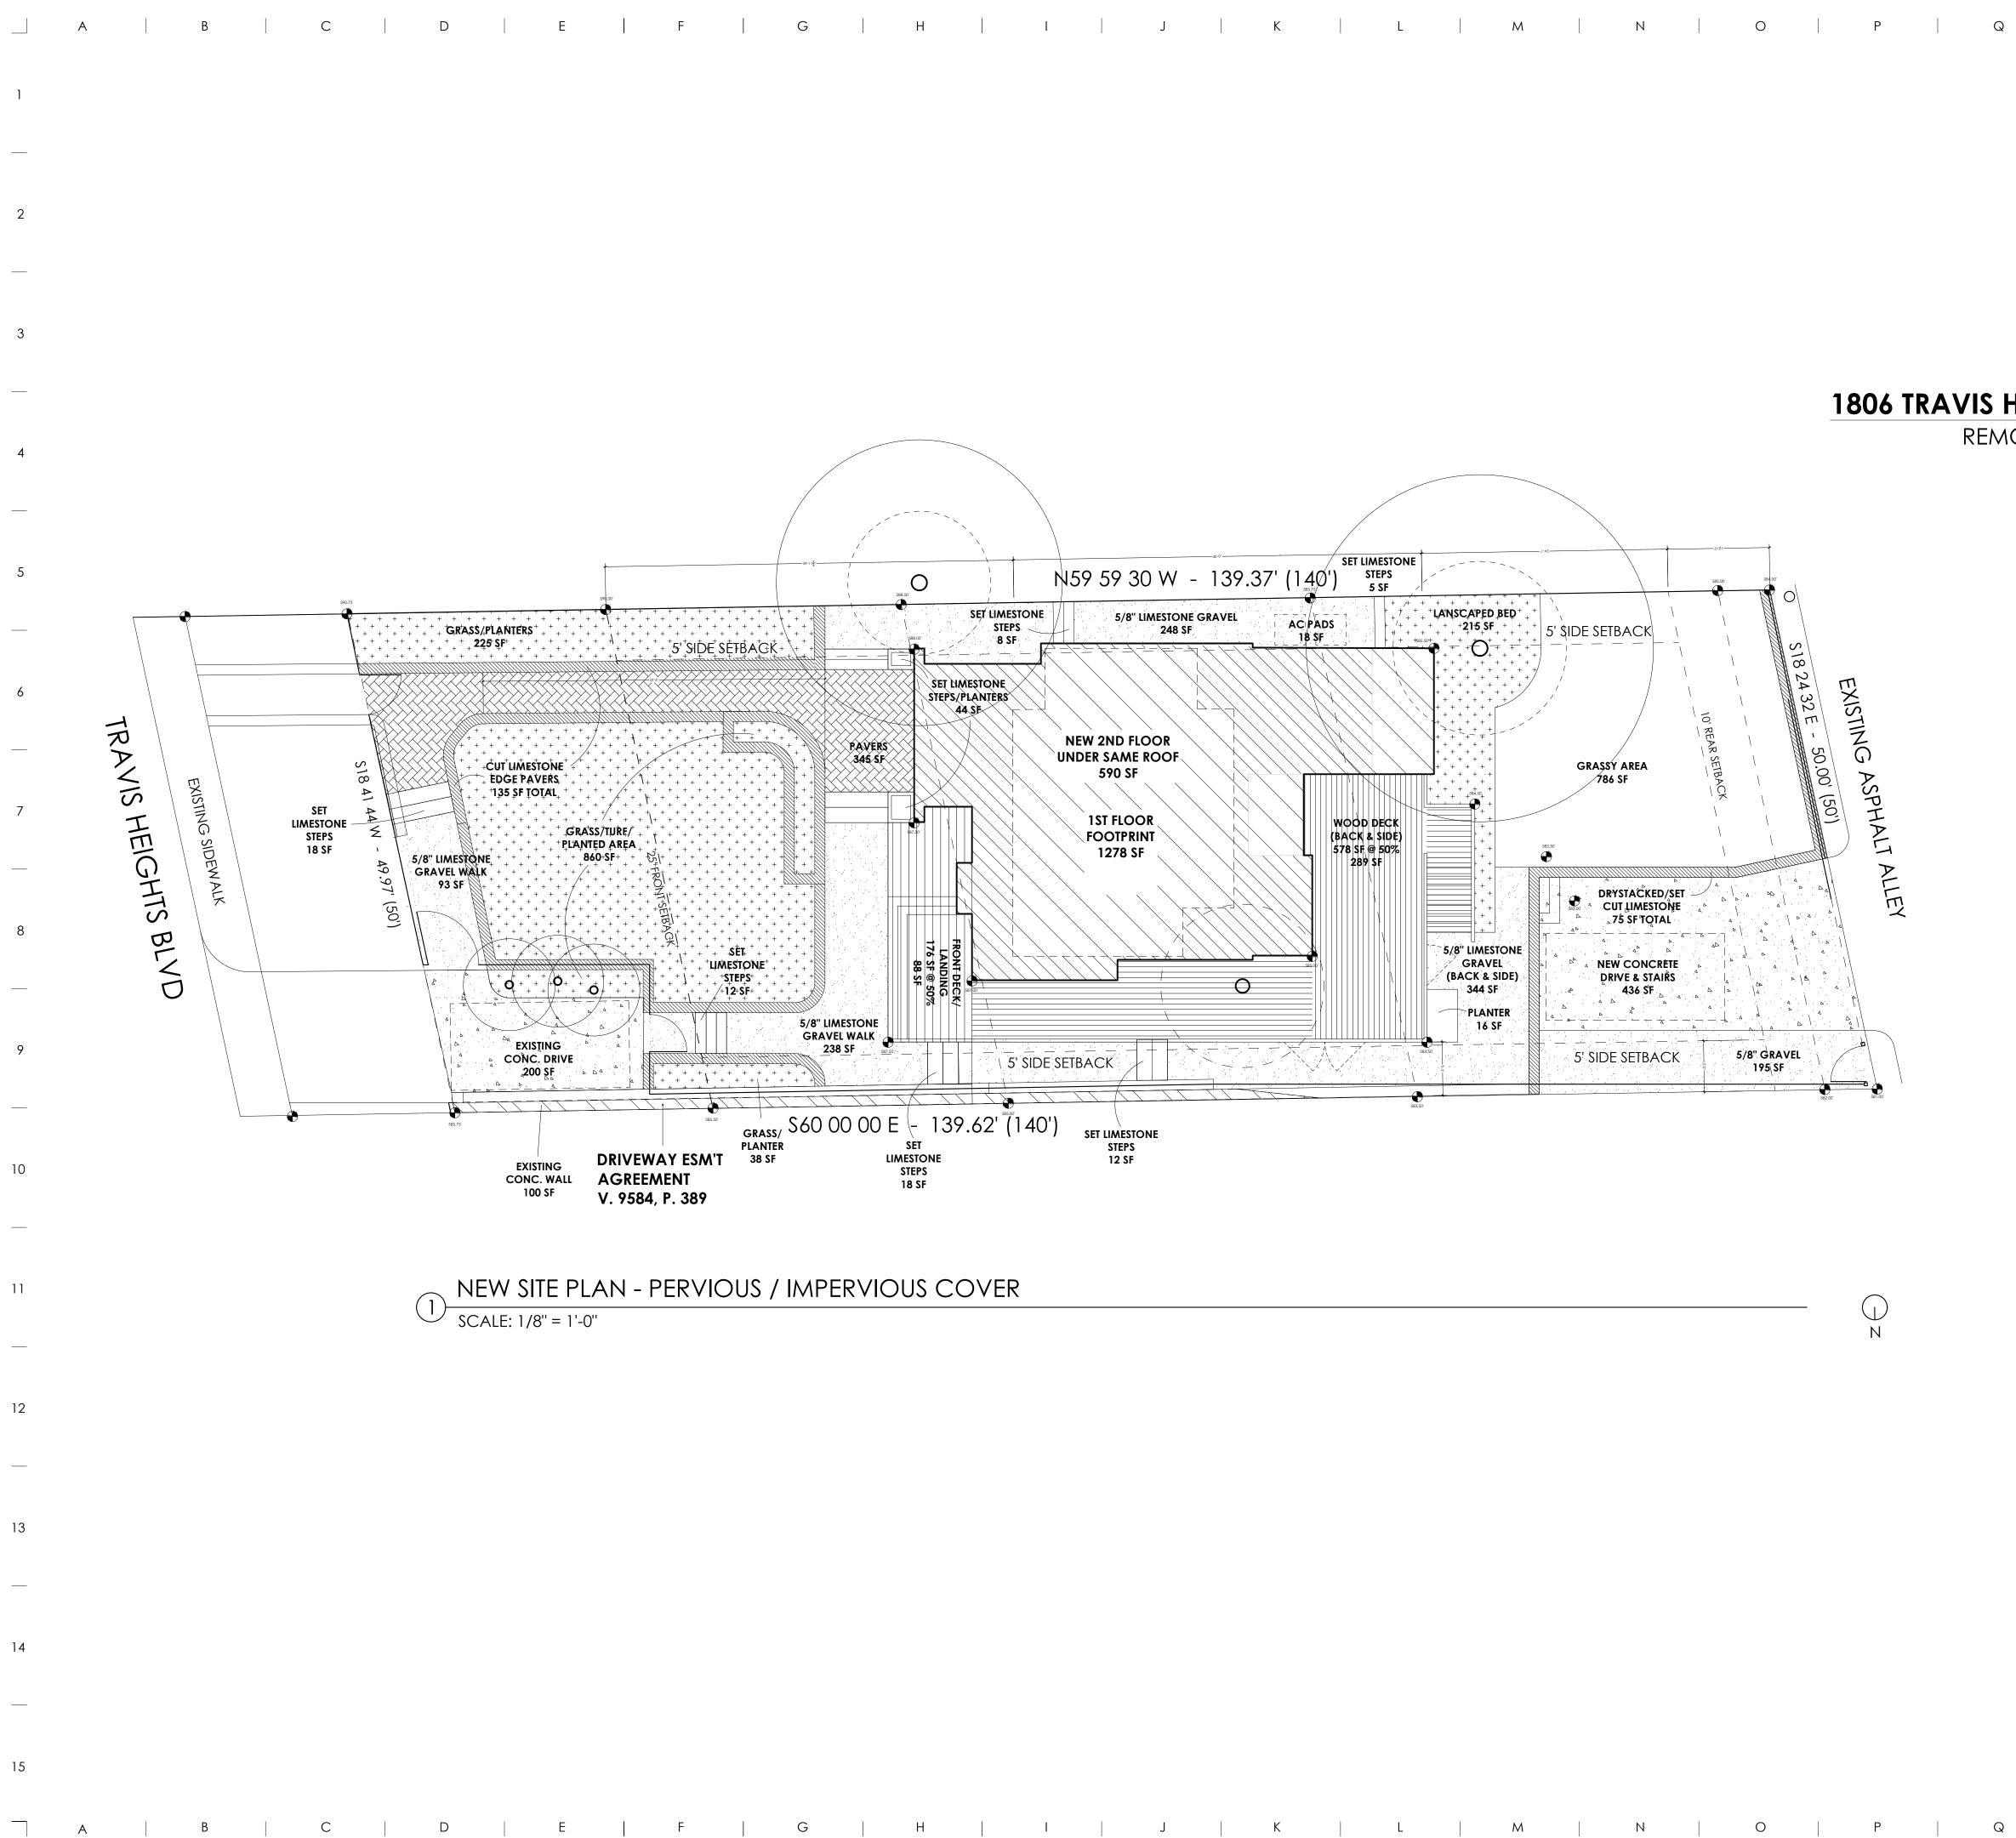
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1806 TRAVIS HEIGHTS BLVD

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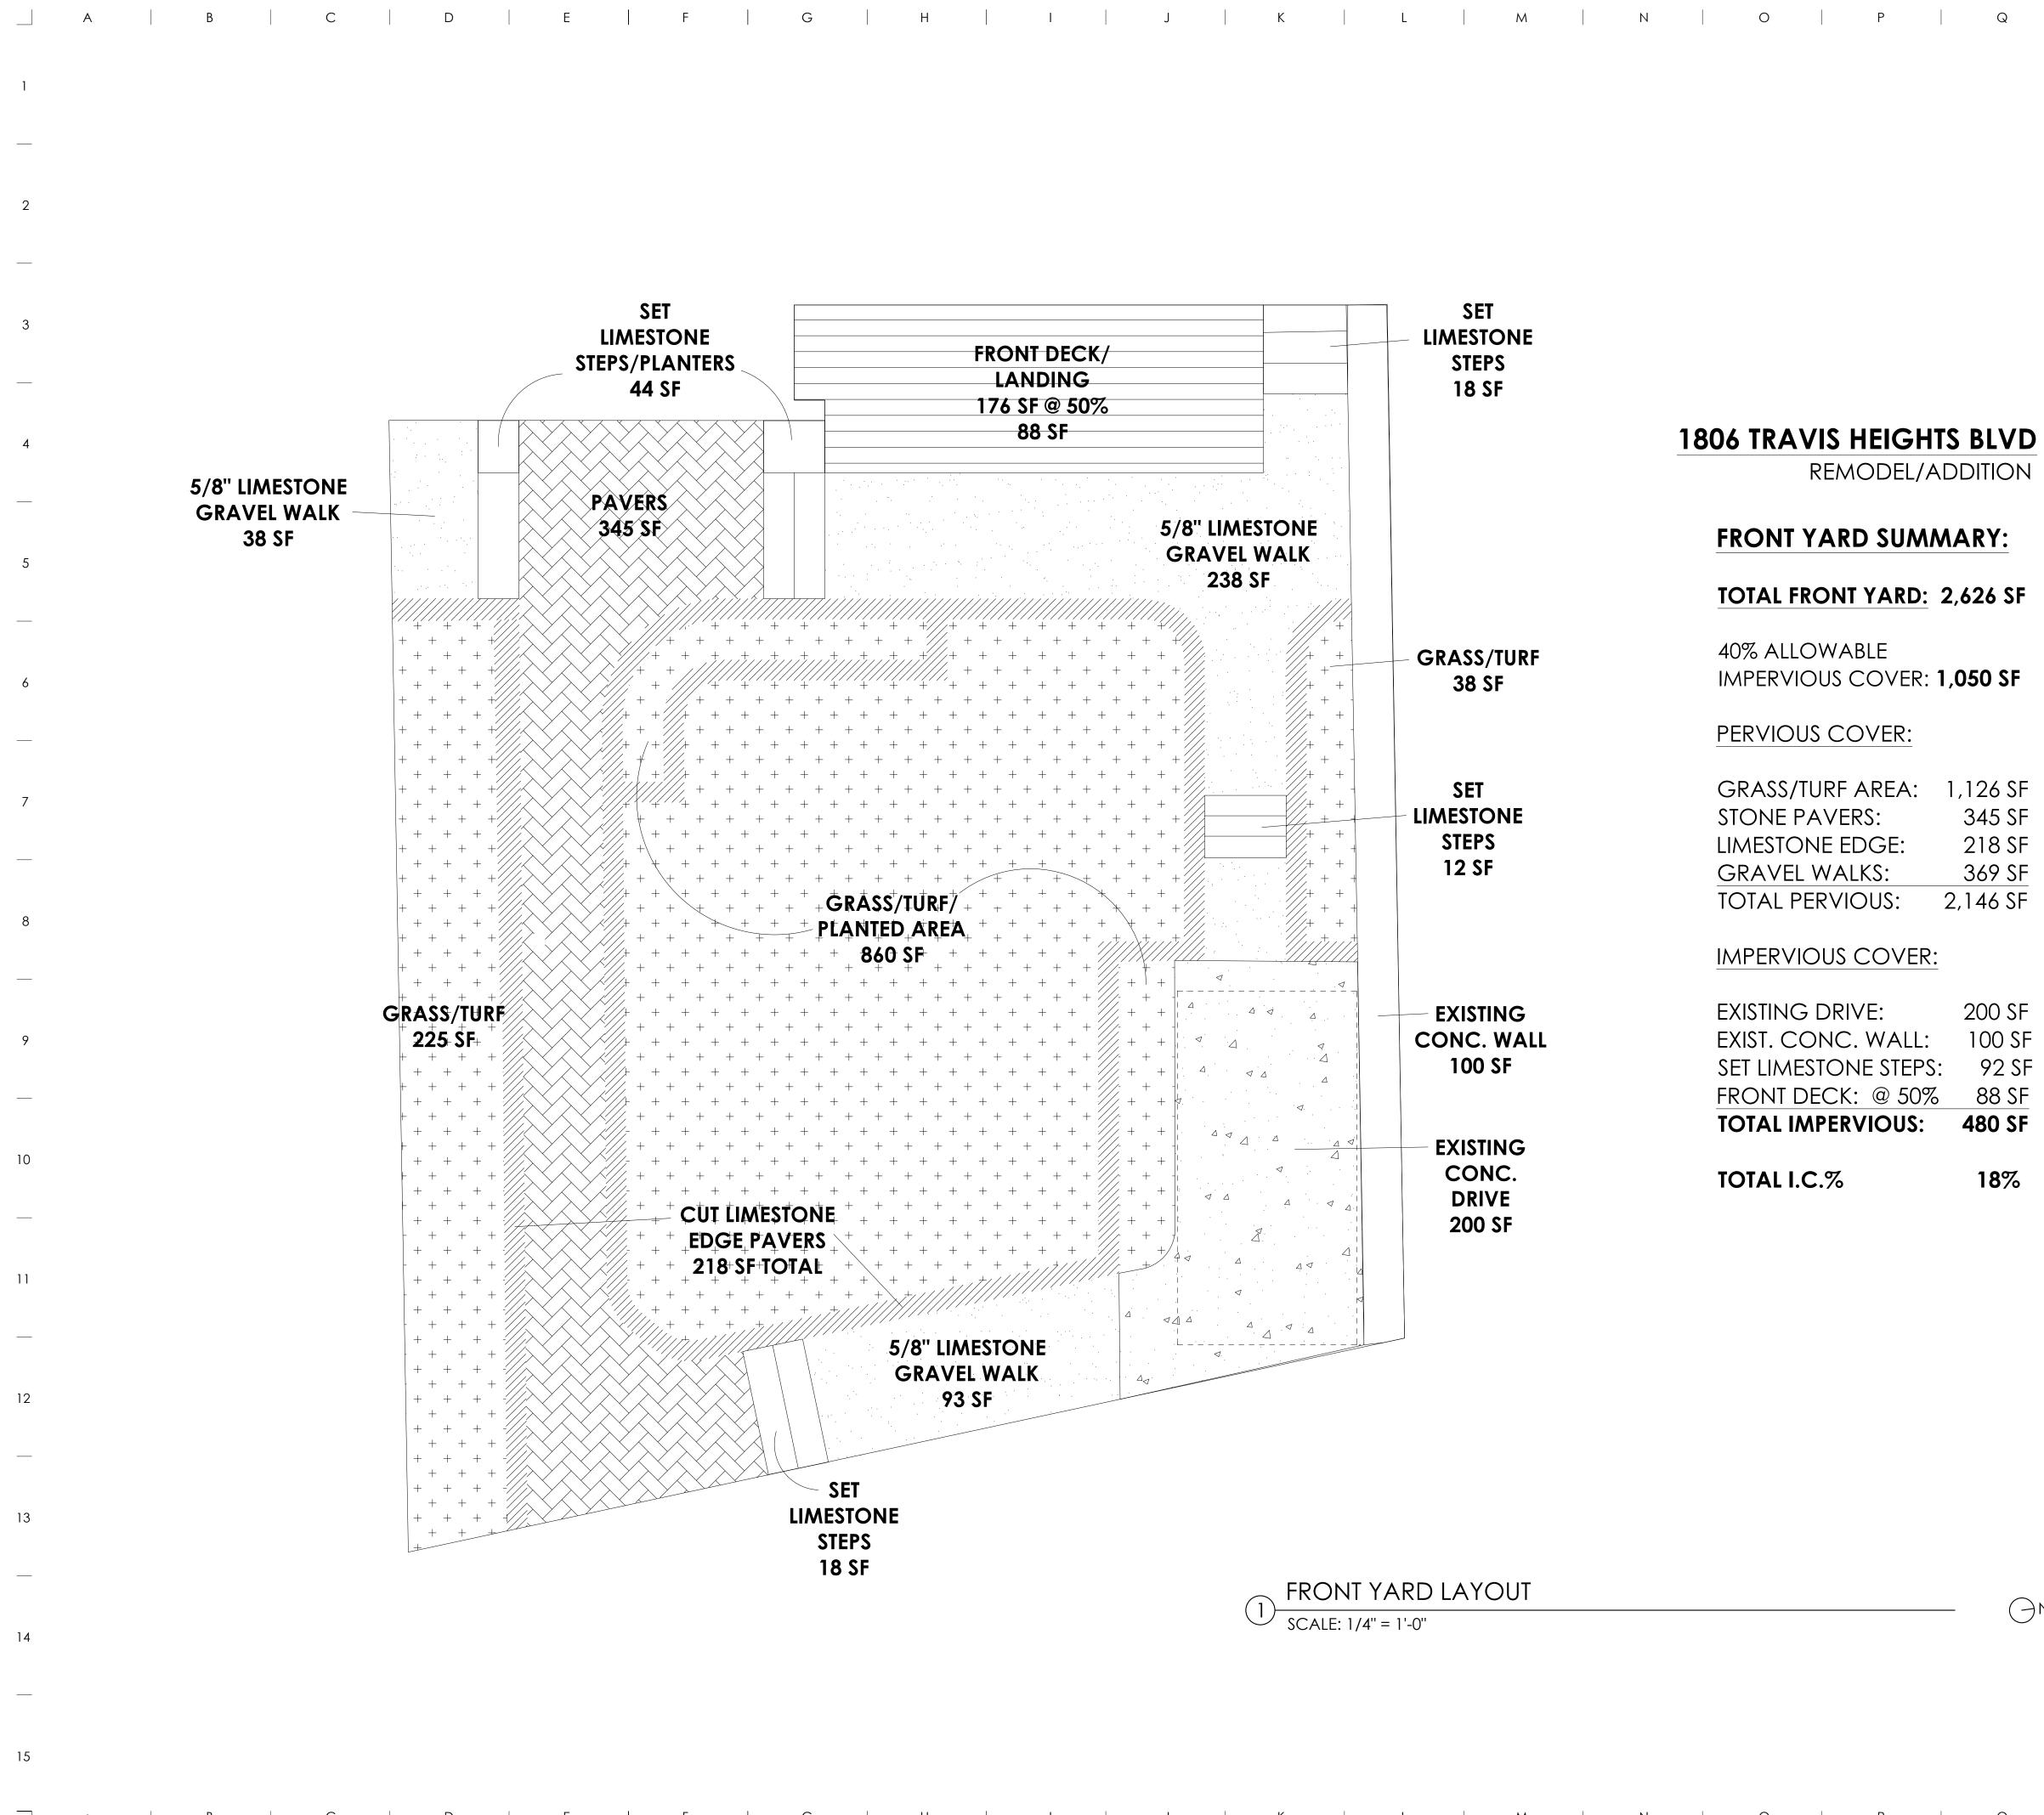
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REMODEL/ADDITION

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US:	2,146 SF

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88 SF
92 SF
100 SF
200 SF

18%



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CARBON MONOXIDE ALARM: THE GENERAL

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EXHAUST ALL VENTS AND FANS DIRECTLY

ALL LANDSCAPING TO PROMOTE DRAINAGE AWAY FROM THE STRUCTURE & FOUNDATION.

PROVIDE SILT FENCING AND/OR MULCH SOCKS AT PERIMETER OF SITE.

OUTSIDE VIA METAL DUCTS.

INSTALL POLYISOCYANURATE FOAM TYPE INSUATION - OR EQUIVALENT - AT FLOOR AND PLATE LINES, OPENINGS IN PLATES, CORNER STUD CAVITIES AND AROUND DOOR AND WINDOW ROUGH OPENING

36" AWAY FROM HORIZONTAL PATH OF MECHANICAL AIR FLOW.

PER NFPA 72 CHAPTER 11.

CAVITIES.

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hollingsworth pack austin

PROJECT TEAM:

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ARCHITECT: BR ARCHITECT PLLC roel bazan 512.791.2986 roelbazan48@gmail.com

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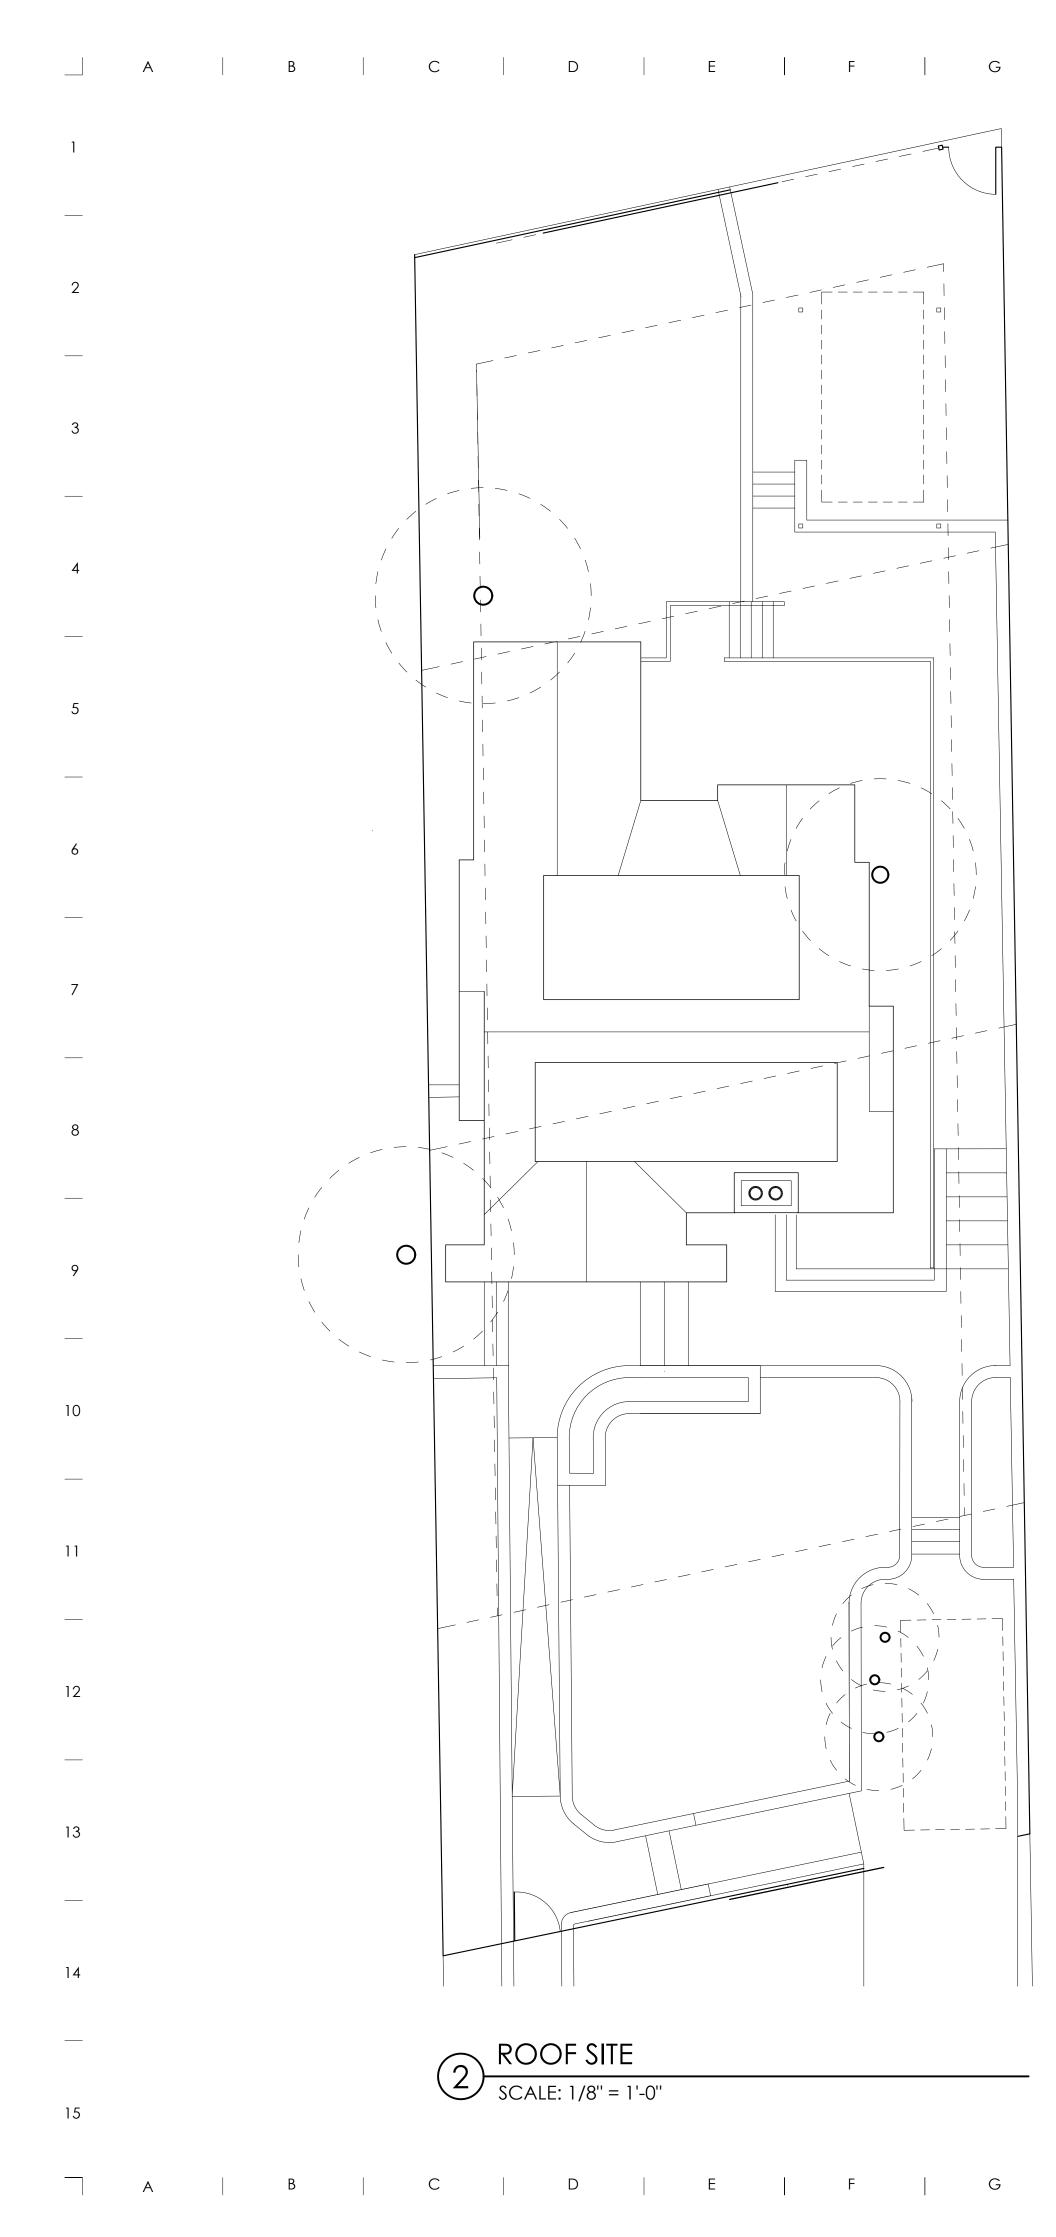
NEW REMODEL 1806 TRAVIS HEIGHTS BLVD AUSTIN, TX 78704

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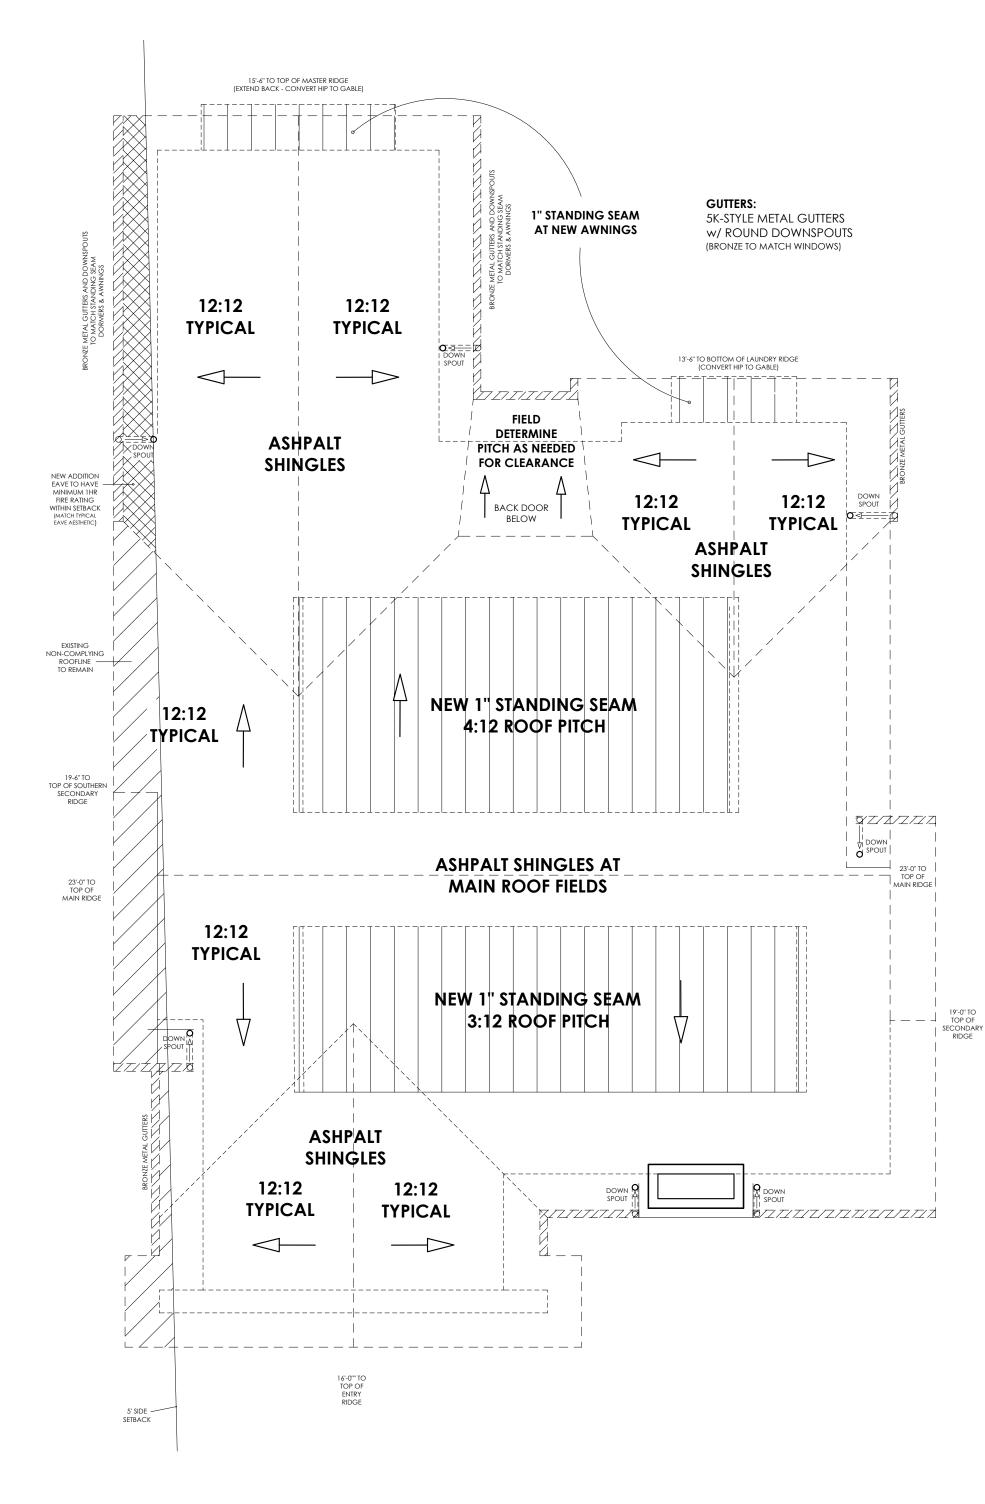
SCALE

SHEET NAME

SP







1) ROOF PLAN SCALE: 1/4" = 1'-0"



NOTES:







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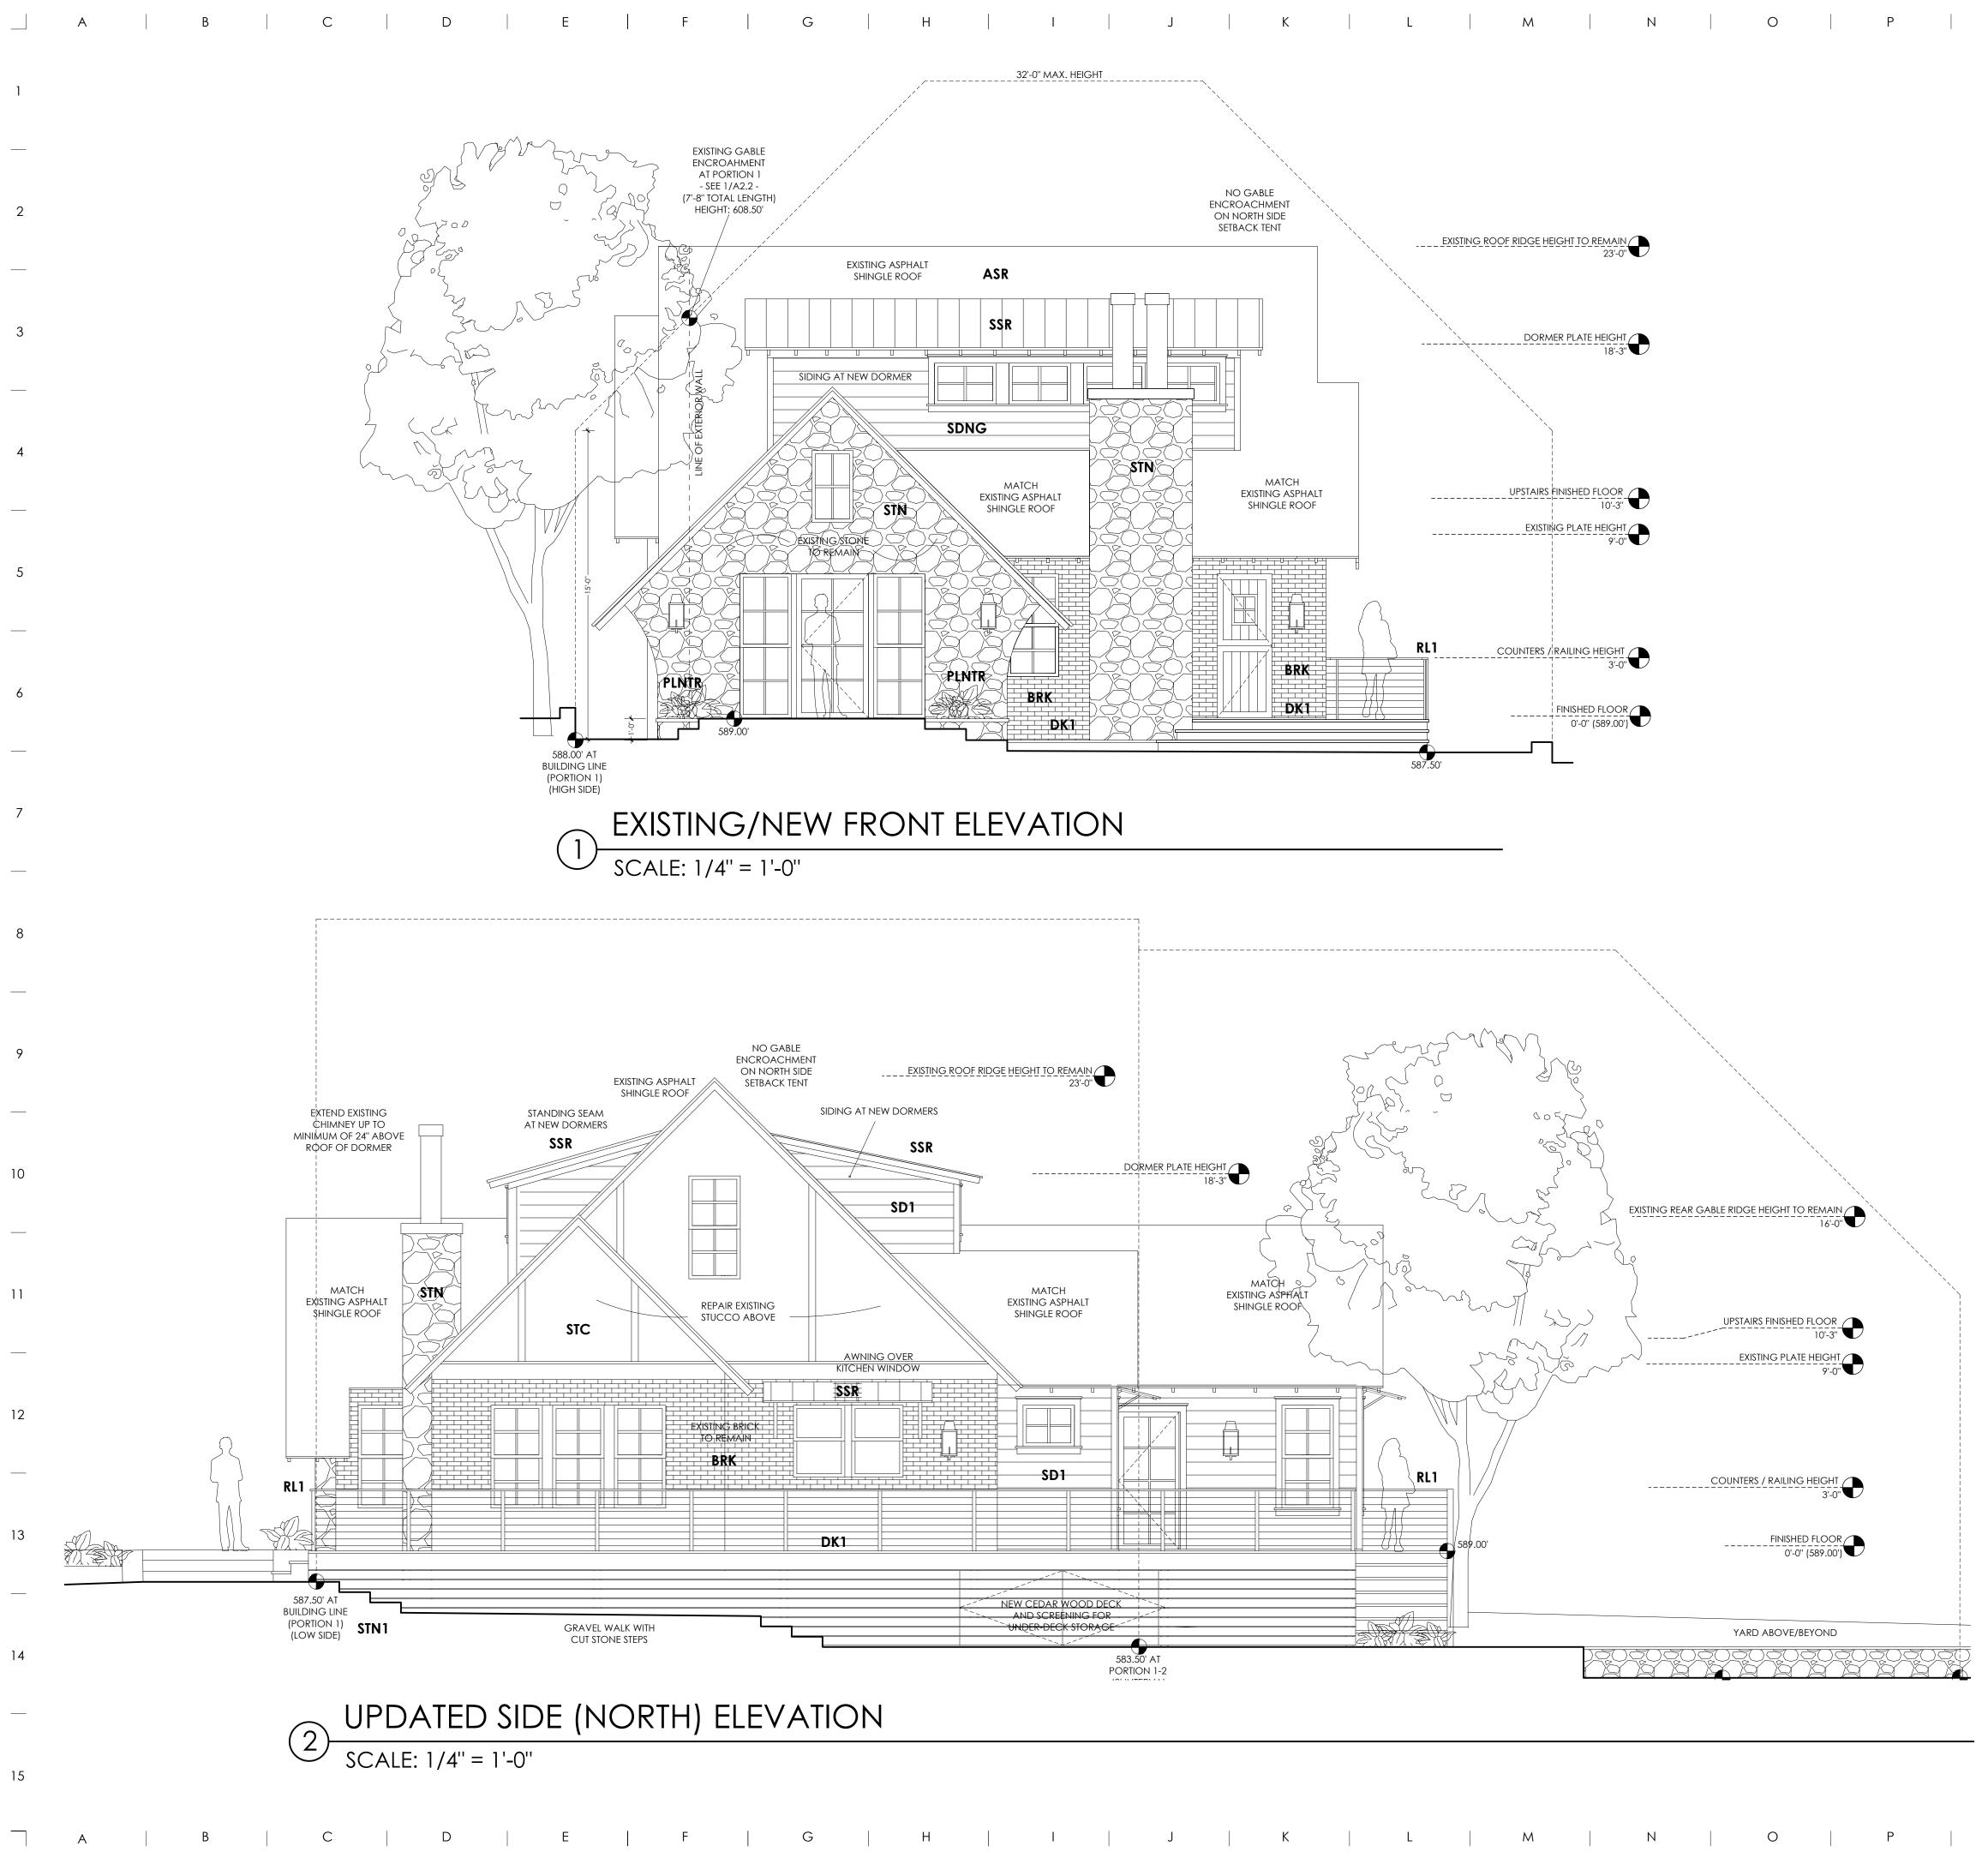
SCALE

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Q R





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EXTERIOR FINISHES:

Q

** ALL EXPOSED WOOD TO BE CLEAR HEART NO.2 OR BETTER (KILN DRIED TO 16-18%)

- **CNC** CONCRETE DRIVE/STAIRS SALTED NON-SLIP FINISH
- **DK1** 5/4" x 6" WR CEDAR DECKING w GAP (CLEAR SEALER - NATURAL FINISH)
- **ASR** ASPHALT SHINGLE ROOF (MATCH EXISTING)
- SSR STANDING SEAM METAL (1" SEAM - CHARCOAL)
- **STC** NEW STUCCO EXTERIOR (TYPICAL 3-COAT - HAND-TROULED)
- **STN** EXISTING EXTERIOR STONE TO BE WHITE-WASHED/ SLURRY-COATED
- SD1 LAP-SIDING MATCH EXISTING AND/OR REPLACE WITH EQUIVALENT (PAINTED - COLOR TBD)
- **RL1** 1/2" x 3" FLATBAR STEEL VERTICAL POSTS w/ 1/2" x 1/2" SQUARE BAR TACK-WELDED TO OUTSIDE OF FLATBAR POSTS (RE: STRUCTURAL/MAX. 4" OPENING)
- WD1 1"x10" WOOD SOFFIT (EXISTING - MATCH) PAINT-GRADE PINE/FIR (REPAIR OR REPLACE AS NEEDED) (REPLACEMENT/NEW SOFFIT MATERIAL LOCATED WITHIN THE SETBACK TO BE 1HR FIRE RATED ASSEMBLY/MATERIAL)
- **WD2** 1"x4" HANDRAIL TOPPER VG/CLEAR HEART WESTERN RED CEDAR (CLEAR COAT SEALER - NATURAL FINISH)
- **STN1** CUT STONE WALKS/STAIRS (FLAGSTONE/LEUTERS/PAVERS)
- **PLNTR** LANDSCAPED BEDS 12" CUT LIMESTONE CAPS w/ DRYSTACK CUT STONE TO MATCH EXISTING -(MORTAR AT BACK OF COURSE IF NEEDED - PROVIDE ADEQUATE WEEP AND DRAINAGE)

CASE TRIM: 1x4 TO MATCH SIDING (PAINT TO MATCH)

CASE TOP ACCENT TRIM:

DOUBLE STEPPED CROWN CAP (1x2 + RIPPED 1x4 STEPPED CASE CAPS or ALTERNATE CAP PROFILE TBD WITH OWNER)

SILLS/STOOLS: 2x THICKNESS w 1x4 APRON SLOPE AWAY FROM WINDOW (PAINT TO MATCH)

FLASH ALL WINDOWS/DOORS AS PER MANUFACTURER SPECS


GUTTERS:

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5K-STYLE METAL GUTTERS w/ ROUND DOWNSPOUTS AS SHOWN ON ROOF PLAN (A1.2) (BRONZE TO MATCH WINDOWS)





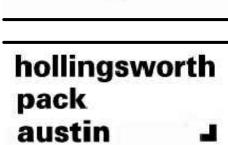

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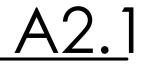
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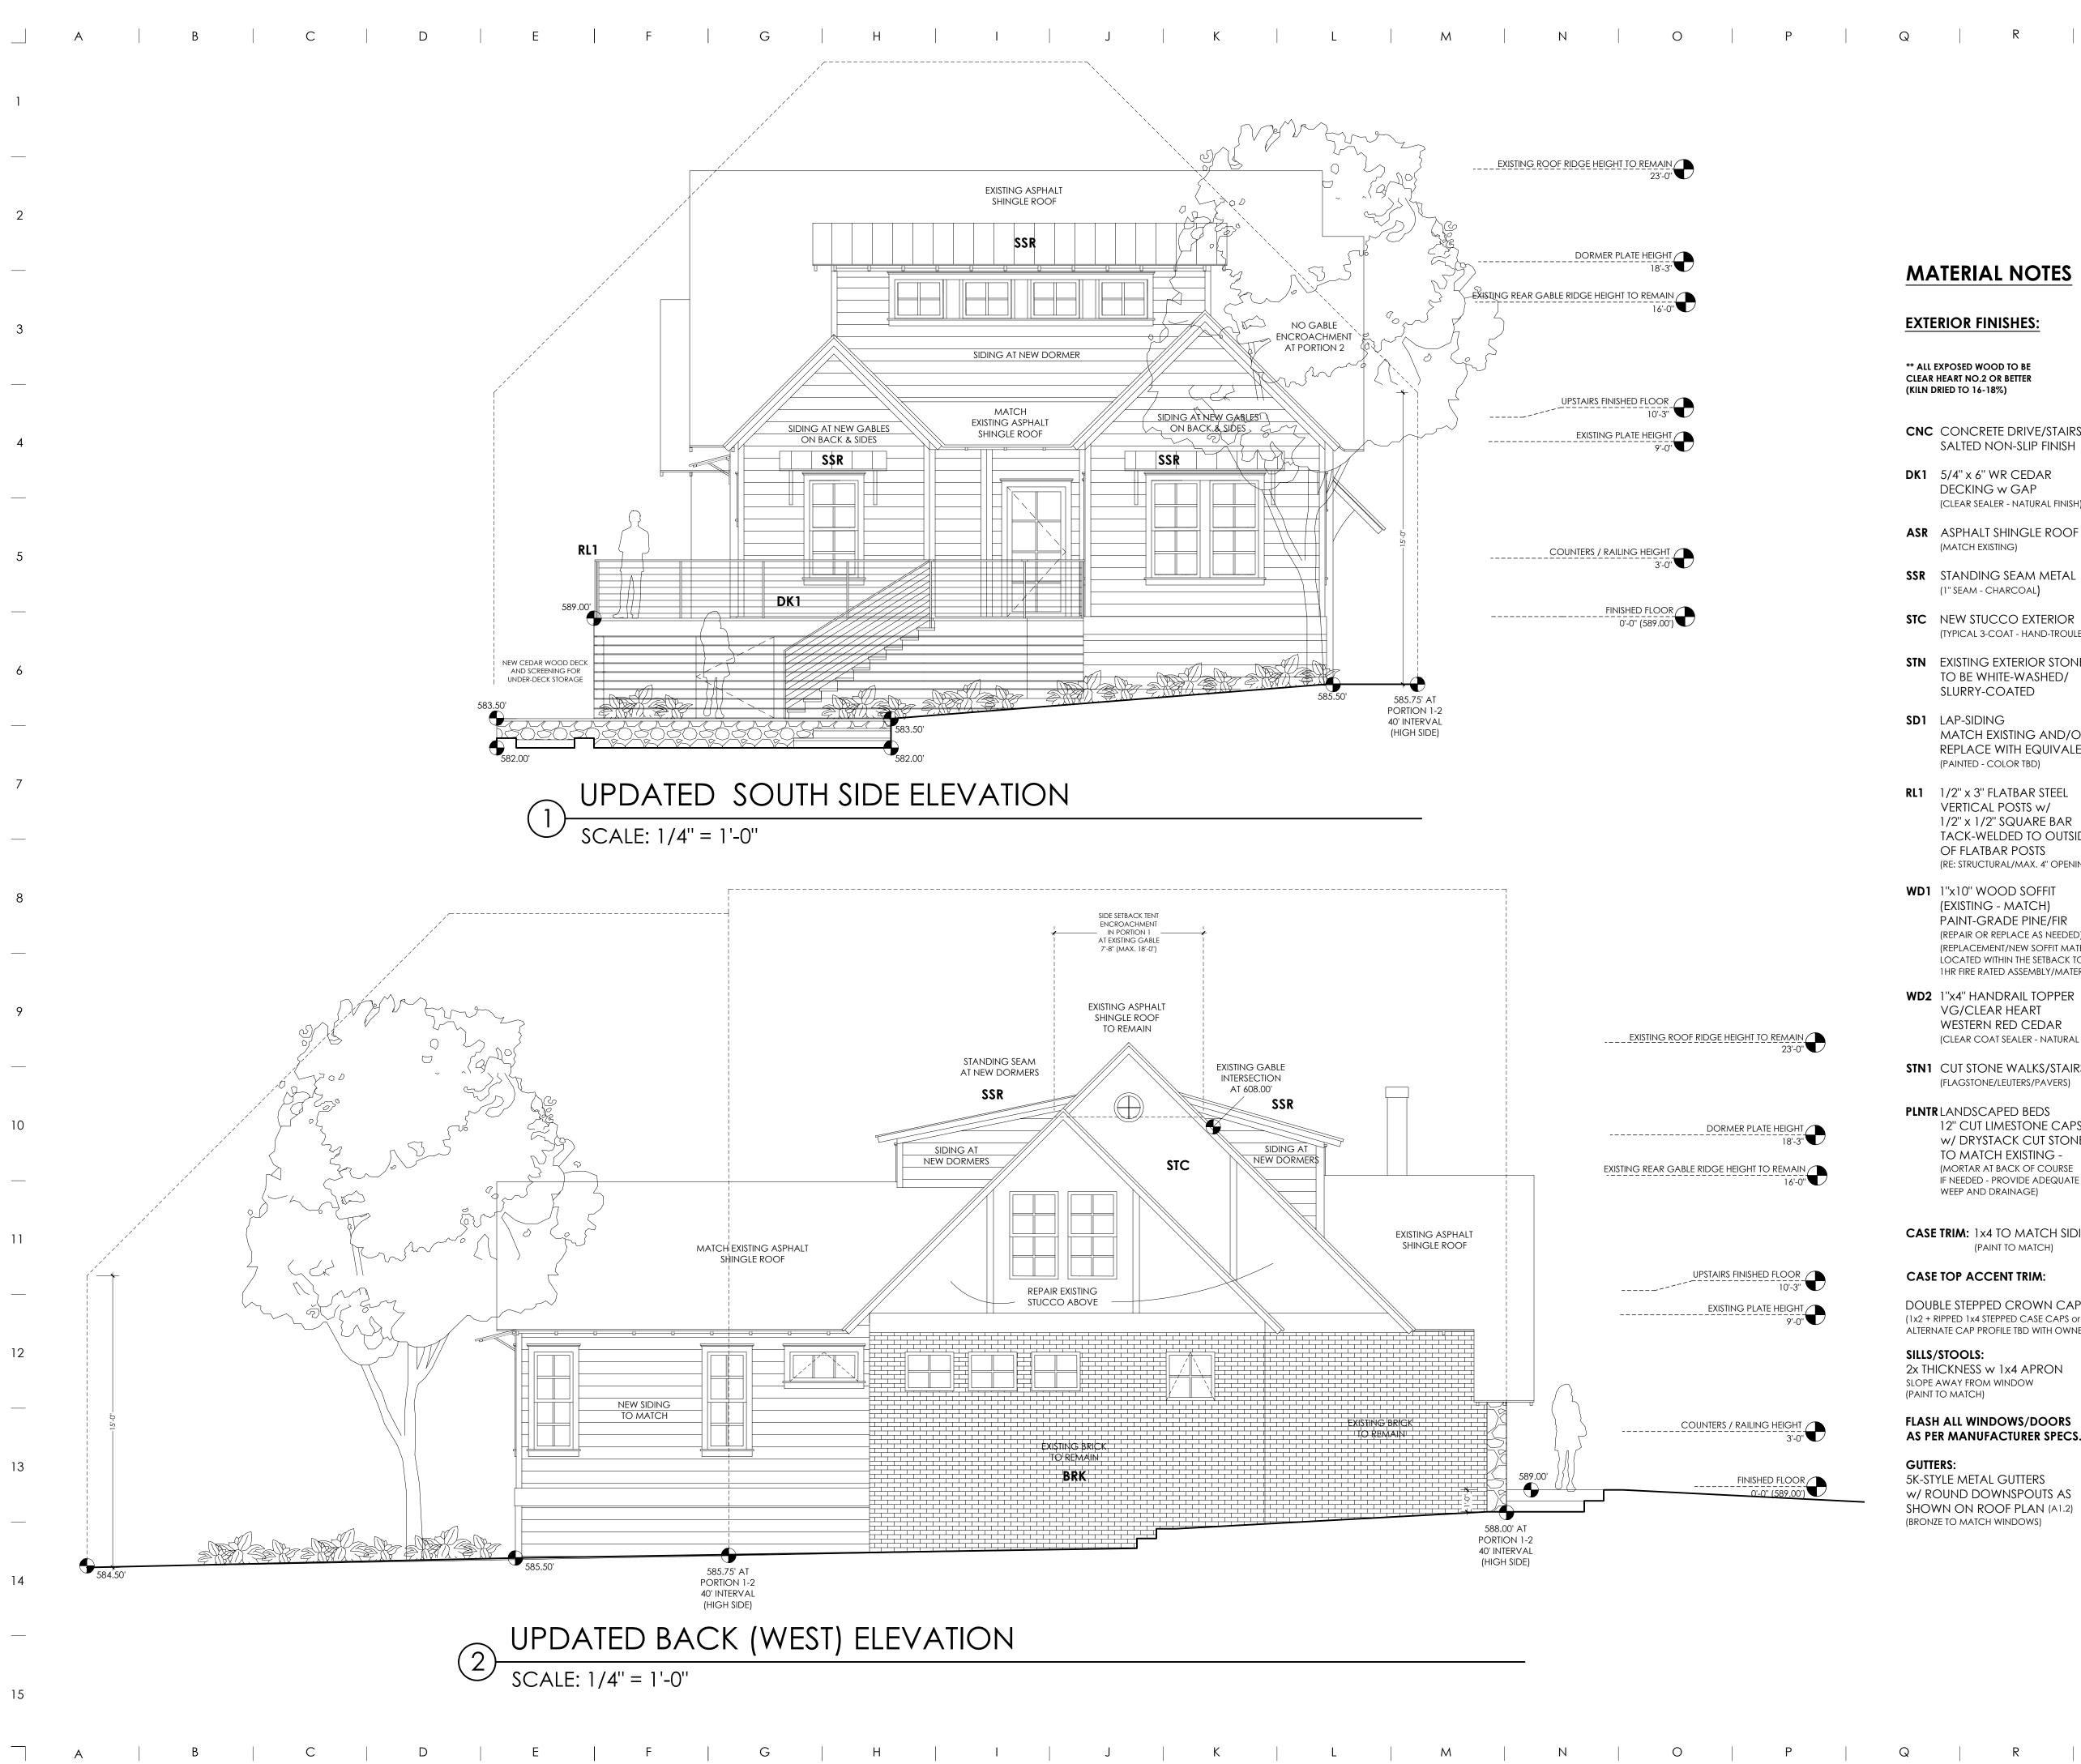
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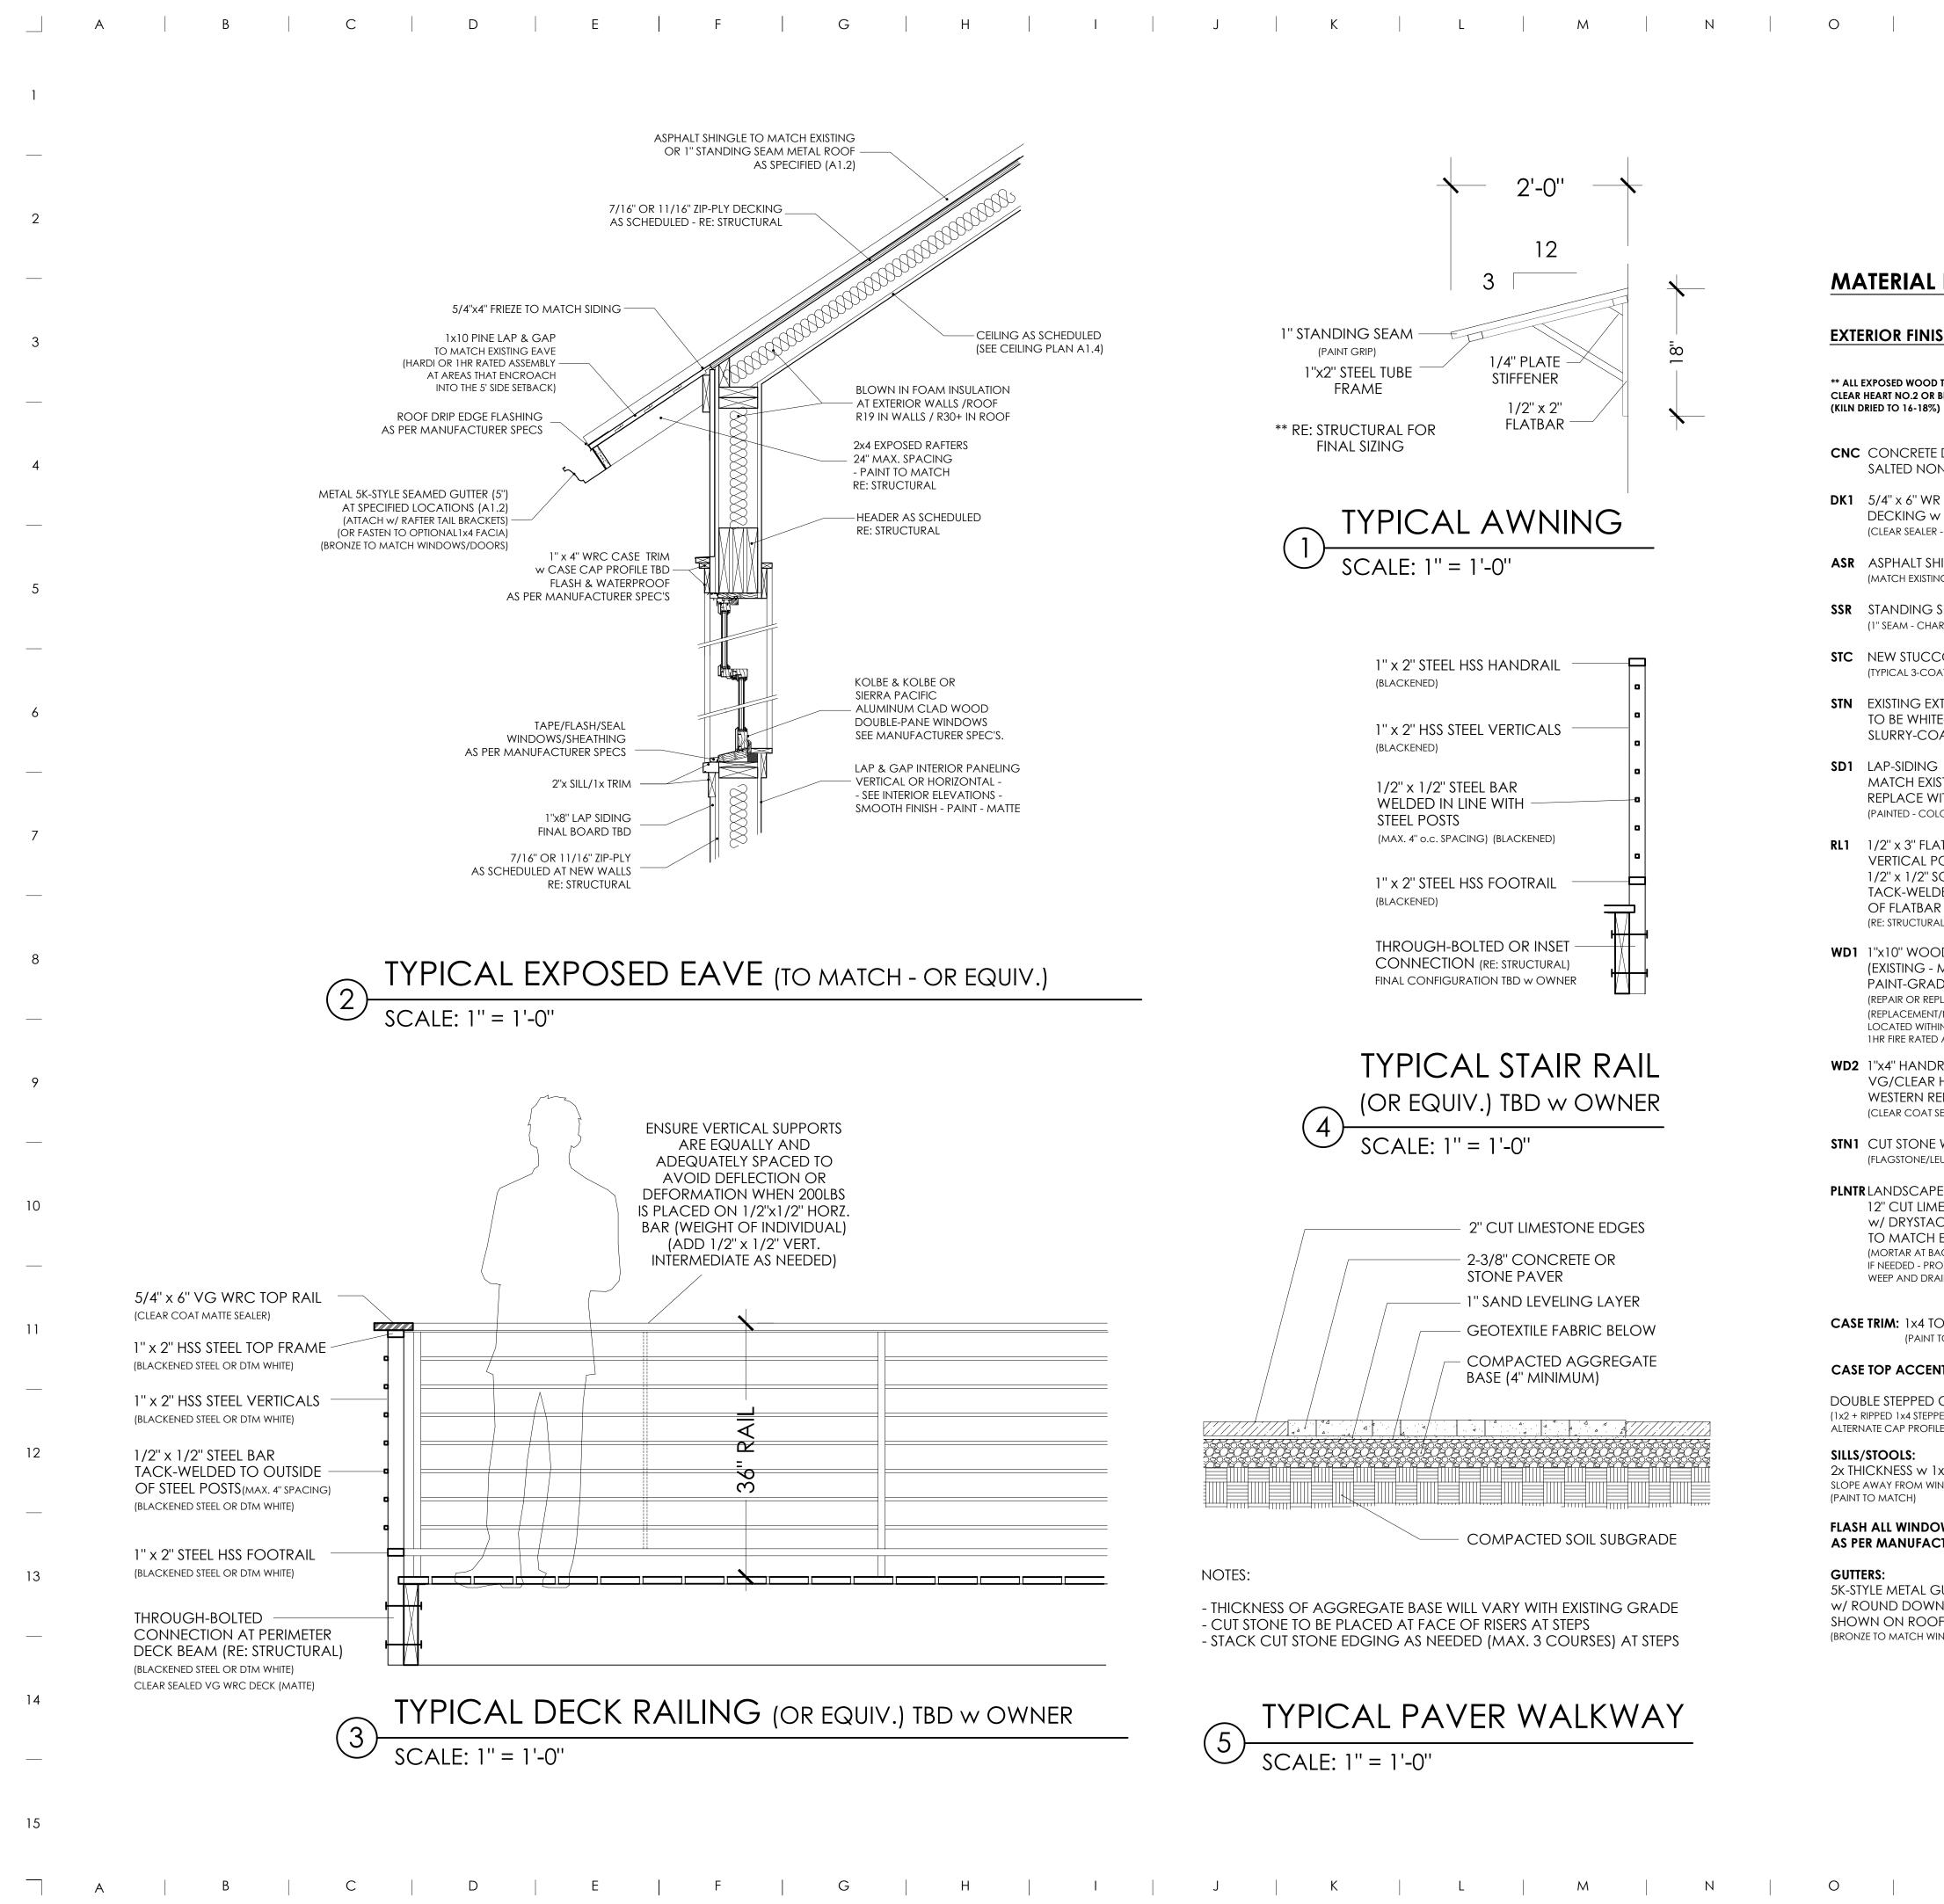
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AUSTIN, TX 78704

8 / 14 / 20 DATE 10 / 15 / 20 REV1 10 / 30 / 20

SCALE

SHEET NAME



H I J K L M N O	

	INTERIOR FINIS	<u>SHES:</u>	
	BASE TRIM 2ND FL	AINT GRADE	
	CASE TRIM: 1x4 P.	AINT GRADE	
NOTES	CASE ACCENT:		
	STEPPED 1x PROF (PROFILE TO BE 1x2 + 1x	ILES PAINT GRADE «3 STEPPED)	
SHES:	SILLS: 2x PAINT C	GRADE	
TO BE Setter	TRIM IN WET AREA WET RATED MATE ALL TRIM (PAINTED - SE/		
DRIVE/STAIRS	CABINETS/BUILT-I		
N-SLIP FINISH	BT1 PAINT-GRA	DE BUILT-INS	
CEDAR GAP NATURAL FINISH)	CB1 PAINT-GRAD (SATIN FINISH)	DE SHAKER CABS	
INGLE ROOF	COUNTERS: (SEAL A	AS PER MNFCTR SPECS)	
G) SEAM METAL RCOAL)		VHITE MARBLED MARBLE TOP	
O EXTERIOR AT - HAND-TROULED)	WALLS/CEILING:		
TERIOR STONE E-WASHED/ ATED	W1 1x10 LAP & HORIZONTA (PAINT WHIT		
STING AND/OR ITH EQUIVALENT	W2 1x12 LAP & VERTICALLY (BATTENS O (PAINT WHIT	Y RUN PTIONAL)	
OR TBD) TBAR STEEL	W3 1x8 LAP & C (PAINT WHIT	GAP AT CEILING TE - MATTE)	
DSTS w/ QUARE BAR	WP1 POWDER B	ATH WALLPAPER	
ED TO OUTSIDE POSTS /MAX. 4'' OPENING)	WP2 MASTER WO	C WALLPAPER	GENERAL CONTRACTOR NOTES:
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WALKS/STAIRS JTERS/PAVERS)	GYP LEVEL 4 DR' (PAINTED - SATI		DIMENSIONS SHOWN ARE TO FACE OF FINISHED MATERIALS. THE GC SHALL VERIFY AND IS RESPONSIBLE
d beds stone caps	PLSTR PLASTER FIN	IISH	FOR ALL DIMENSIONS (INCLUDING ROUGH OPENINGS) AND CONDITIONS ON THE JOB AND MUST NOTIFY THIS OFFICE OF ANY VARIATIONS FROM THESE DRAWINGS.
K CUT STONE XISTING - CK OF COURSE	SH1 FRAMELESS	GLASS SHOWER	THE GC IS RESPONSIBLE FOR THE DESIGN AN PROPER FUNCTION OF PLUMBING, HVAC, AND ELECTRICAL SYSTEMS. THE GC SHALL NOTIFY THIS OFFICE WITH ANY PLAN
VIDE ADEQUATE NAGE)	FLOORS:		CHANGES REQUIRED FOR DESIGN AND FUNCTION OF PLUMBING, HVAC AND ELECTRICAL SYSTEMS.
) MATCH SIDING 0 match)	FLR1 REFINISH / M WOOD FLC (STAIN / SEAL)	MATCH EXISTING DORS	THIS OFFICE SHALL NOT BE RESPONSIBLE FOR CONSTRUCTION MEANS AND METHODS, ACTS OR OMISSIONS OF THE CONTRACTOR OR SUBCONTRACTOR, OR FAILURE OF ANY OF THEM TO CARRY OUT WORK IN ACCORDANCE WITH THE CD'S, ANY DEFECT
T TRIM:	FLR2 MEDIUM PIL (FINAL SELECTION	LE CARPET & PAD ON APRV'D BY OWNER)	OR DISCREPENCY FOUND WITH THE CD'S SHALL BE BROUGT TO THE ATTENTION OF THIS OFFICE BY WRITTEN NOTICE PRIOR TO PROCEEDING WITH WORK. REASONABLE TIME NOT ALLOWED THIS OFFICE TO
CROWN CAP ED CASE CAPS or E TBD WITH OWNER)		'd by owner - Ly Seal - matte **	CORRECT THE DEFECT SHALL PLACE THE BURDEN OF COST AND LIABILITY FROM SUCH DEFECT UPON THE GC. SAFETY GLAZING: ALL HAZARDOUS GLASS MUST BE IN ACCORDANCE WITH 2015 IRC
APRON NDOW	FLR4 8" HEX TILE	O SHOWER & TOILET, D, SLOPE TO DRAIN) @LAUNDRY/PANTRY	SECTION R308.4. (NOTED LOCATIONS: GLAS IN DOORS, WINDOWS 24" OR LESS FROM DOOR JAMB, GLAZING LESS THAN 5'-0" ABOVE TUB FLOOR, AND SHOWER OR TUB ENCLOSURES.
WS/DOORS IURER SPECS.	INSULATION:	ON APRV'D BY OWNER)	SMOKE DETECTOR SYSTEM: GENERAL CONTRACTOR IS RESPONSIBLE THAT THE DWELLING UNIT TO BE EQUIPPED WITH AN APPROVED SMOKE DETECTOR SYSTEM AT CORRESPONDING LOCATIONS, IN ACCORDANCE WITH 2015 IRC SECTION R31
JTTERS SPOUTS AS PLAN (A1.2)	CLOSED CELL BLC INSULATION AT EX R19 IN WALLS / R3	(TR WALLS /ROOF	GENERAL CONTRACTOR SHALL VERIFY FOR SMOKE DETECTORS TO BE LOCATED AT LEAS 36" AWAY FROM HORIZONTAL PATH OF MECHANICAL AIR FLOW. PER NFPA 72 CHAPTER 11.
IDOWS)	Sound Batt Insu Placed in all W Bathrooms/util Living Rooms C	ALLS BETWEEN LITY ROOMS AND	CARBON MONOXIDE ALARM: THE GENERAL CONTRACTOR IS RESPONSIBLE THAT THE DWELLING UNIT BE EQUIPPED WITH AN APPROVED CARBON MONOXIDE ALARM AT CORRESPONDING LOCATIONS, IN ACCORDANCE WITH 2015 IRC SECTION R31.
		ILATION IN ALL WALL' N/LIVING AREAS AND	INSTALL POLYISOCYANURATE FOAM TYPE INSUATION - OR EQUIVALENT - AT FLOOR AND PLATE LINES, OPENINGS IN PLATES, CORNER STUD CAVITIES AND AROUND DOOR AND WINDOW ROUGH OPENING CAVITIES.
	Sound Batt Insu Floor/Ceiling (1st and 2nd Flo	CAVITY BETWEEN	WATERPROOF ALL WATER/SPLASH AREAS TO A MINIMUM OF 60" ABOVE FINISHED FLOOR. INSULATE MEP LINES FOR SOUND CONTROL. EXHAUST ALL VENTS AND FANS DIRECTLY OUTSIDE VIA METAL DUCTS.





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NEW REMODEL 1806 TRAVIS HEIGHTS BLVD AUSTIN, TX 78704

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SCALE

Sheet NAME







