ABOVE FINISHED FLOOR

ANCHOR, ANCHORED

AUTHORITY HAVING JURISDICTION

AMERICAN NATIONAL STANDARDS

ARCHITECTURAL PRECAST

ARCHITECT, ARCHITECTURAL

AMERICAN SOCIETY FOR TESTING

ASPHALT, ASPHALTIC

BITUMEN, BITUMINOUS

BUILDING MOVEMENT JOINT

BOTTOM OF DOUBLE TEE

CAVITY DRAINAGE MATERIAL

COLD FORMED METAL FRAMING

CEMENT, CEMENTITIOUS

CUBIC FOOT, CUBIC FEET

CONCRETE MASONRY UNIT

COMPRESSIBLE, COMPRESSED

COUNTERFLASHING

CORNER GUARD

CONTROL JOINT

CENTER LINE

BOTTOM OF STEE!

BOTTOM-OF-WALL

AND MATERIALS

ATTENUATION

AUDIO VISUAL

AUTOMATIC

BELOW

BUILDING

BEAM

BLOCKING

BULLNOSE

BATHROOM

BRACKET

BOTTOM

BEVELED

CENTER

CHANNEL

CEILING

CLOSET

COUNTER

COLUMN

CLEAN OUT

CONCRETE

CONDITION

CONSTRUCTION

CARPET, CARPETED

COURSE, COURSES

COUNTERSUNK

CURTAINWALL

CUBIC YARD

DEEP, DEPTH

DATA AND COMMUNICATION

CONTINUOUS

CORRIDOR

CUBIC

CLEAR

BETWEEN

CHALKBOARD

AROVE

ALTERNAT

ALUMINUM

ANODIZED

INSTITUTE

CONCRETE

ASSEMBLY

ACCESS PANEL

APPROXIMATE

ACM

ACOUS

ALUM

ANOD

ANSI

ARCH

ASPH

ASTM

AUTO

BLDG

BLKG

BODT

BOST

BOW

BRKT

BTM

CDM

CEM

CEN

CLOS

CLR

CMU

CNTR

COMP

CONC

COND

CONST

CONT

CORR

CRS

DATACOM

INV

JAN

JBOX

KDAT

KIT

LAT

LAV

LB, #

LBS

LF

LIN

LLH

LLV

LOC

LS

LVL

LVR

MACH

MAS

MAX

MB

MBR

MECH

MEMB

MEP

MFR

MIR

MISC

MOD

MTD

MTL

NO

OD

OH

OPCI

OPOI

PERF

PLBG

PROV

PΤ

PTD

PLYWD

NSMF

MIFRC

INTERIOR

JUNCTION BOX

JANITOR, JANITOR CLOSET

KILN DRIED AFTER TREATMENT

INVERT

JOIST

JOINT

KILN DRIED

KITCHEN

LADDER

LATERAL

POUND

POUNDS

LINEAR

LEVEL

LOUVER

MACHINE

MASONRY

MAXIMUM

MEMBER

MARKERBOARD

MECHANICAL

MEMBRANE

PI UMBING

MINIMUM

MIRROR

MINERAL

MODIFIED

MOUNTED

MFTAI

NORTH

NUMBER

FRAMING

RESISTIVE COATING

MISCELL ANEOUS

NOT IN CONTRACT

NOT TO SCALE

OPPOSITE HAND

ON CENTER

INSTALLED

INSTALLED.

PLASTER

PLUMBING

PLYWOOD

PROVIDE

PAINTED

PARTITION

PAIR

PERFORATED

PLASTIC LAMINATE

PRESSURE TREATED

NON-STRUCTURAL METAL

OUTSIDE DIAMETER, OVERFLOW

OWNER PROVIDED, CONTRACTOR

OWNER PROVIDED, OWNER

LAVATORY

KNEE SPACE

LONG, LENGTH

LAMINATE, LAMINATED

LINEAR FOOT, LINEAR FEET

LANDSCAPE, LANDSCAPING

MECHANICAL, ELECTRICAL, AND

MANUFACTURER, MANUFACTURED

MASTIC AND INTUMESCENT FIRE

LONG LEG HORIZONTAL

LONG LEG VERTICAL

LOCATE, LOCATION

DOOR

DRAIN

DETAIL

FACH

DOWNSPOUT

DISHWASHER

EXTERIOR INSULATION AND FINISH

DRAWING

DRAWER

SYSTEM

ELEVATION

FLEVATOR

ENCLOSURE

EQUIPMENT

EACH WAY

EXHAUST

EXISTING

EXTERIOR

FABRICATOR

FLOOR DRAIN

EXPANSION

EXPANSION JOINT

ELECTRIC, ELECTRICAL

EXISTING TO REMAIN

ELECTRIC WATER COOLER

FABRICATE, FABRICATED

FIRE ALARM CONTROL PANEL

FIRE EXTINGUISHER CABINET

FIRE HOSE AND VALVE CABINET

FIREPROOFED, FIREPROOFING

FIRE DEPARTMENT VALVE

FIRE EXTINGUISHER

FINISHED FLOOR

FIREBLOCKING

FIXTURE

FLEXIBLNE

FLASHING

FACE OF

FASTENER

FURRING

FUTURE

FIXED

GAUGE

GYPSUM

FURNITURE

GALVANIZED

GLASS, GLAZING

HANDICAPPED

HEAD-OF-WALL

HEADER

HARDWARE

HORIZONTAL

HEIGHT

HOLLOW METAI

HOUR, HANDRAIL

GUARD, GUARDRAIL

HOT FLUID-APPLIED RUBBERIZED

ASPHALT WATERPROOFING

FOOT, FEET

FLOOR-TO-FLOOR

FLOOR-TO-WALL

FOUNDATION

FINISH, FINISHED

FLOOR, FLOORING

FIRE RESISTIVE JOINT

FRAME, FRAMED, FRAMING

FIRE RETARDANT TREATED

FIRE HOSE CABINET

DRN

DTL

DWR

ELEC

ELEV

ENCL

ETR

EW

EWC

EXP

EXST

FACP

FD

FDV

FEC

FIXT

FLEX

FLR

FLSHG

FNDN

FRT

FSTN

FTF

FTW

FURN

FXD

GALV

HDOW

HDR

HOR

EXT

REFLECTED CEILING PLAN REFER, REFERENCE REQD REQUIRED **RESIL** RESILIENT REV

SALVAGE

SECTION

MATERIAL

SINGLE

SHEET

SHOWER

SIMILAR

SEALANT

SOFFIT

SQUARE

STAINED

STRUCTURAL

SURFACE

SYSTEM

STANDARDS

TACKBOARD

TELEPHONE

TEMPORARY

THROUGH

TRFAD

STEEL

STAINLESS STEEL

STORAGE, STOREFRONT

SUSPEND, SUSPENDED

TONGUE AND GROOVE

TEXAS ACCESSIBILITY

TILE BACKER PANEL

TO MATCH EXISTING

TOP OF DOUBLE TEE

THROUGH WALL FLASHING

UNLESS INDICATED OTHERWISE

UNDERWRITERS LABORATORIES

TOP OF CONCRETE

TOP OF STEEL

TOP OF WALL

TELEVISION

UNDERLAYMENT

VAPOR BARRIER

VERIFY IN FIELD

WASHER AND DRYER

WORKPOINT, WATERPROOFING

UNFINISHED

VERTICAL

VESTIBULE

WIDE, WIDTH

WALL BOARD

VENEER

WITHOUT

WOOD

WINDOW

WATERSTOP

WALL-TO-WALL

WELDED WIRE FABRIC

WELDED WIRE MESH

TRACK

TYPICAL

SIDE

RFG

SALV

SBR

SECT

SFRM

SHWR

SIM

SLNT

SOF

SQ

STL

STND

STOR

STRUCT

SURF

SUSP

SYS

TAS

TEL

TEMP

THRU

TME

TOC

TODT

TOST

TOW

TRK

UIO

UNDRLA

VERT

VNR

W/O

WNDW

WTW

WWF

WWM

REVISION ROOFING ROOM **ROUGH OPENING** RESTROOM, RAILROAD SOUND ATTENUATION BLANKET

SQUARE FOOT, SQUARE FEET

SPRAY APPLIED FIRE-RESISTIVE

SEALANT & BACKER ROD

CONCRETE **EARTH**

abla
abl

SPRAY FOAM

STONE

PLYWOOD

WOOD

ALUMINUM

STEEL

WALL BOARD

PLASTER

CONCRETE BLOCK

 \times \leftarrow JOINT FORMING MATERIAL

> TOSL 100'-0" 100'-0" J"

SCALE | A101

4 **◄** A101 ▶ 2

⟨PT-1⟩-

14C-

(EW-1) -

W-1

SE-1 —

CONFERENCE

A:15 —

100 SF_7 ~

LEVEL 1

MATCHLINE REFERENCE

DETAIL REFERENCE

DETAIL REFERENCE

REFERENCED PHOTOGRAPH

INDICATED OTHERWISE SURFACE FINISH CALLOUT - SURFACE THAT CALLOUT

ACCORDING TO PARTITION SIZE SCHEDULE

CONSTRUCTION ASSEMBLY CALLOUT

FENESTRATION CALLOUT

FURNITURE & FURNISHINGS REFERENCE

EQUIPMENT REFERENCE 100 -ACCESSORIES REFERENCE

DOOR REFERENCE 100

OCCUPANCY TYPE : OCCUPANT LOAD FACTOR

- EGRESS DIRECTION EXIT LOAD (OCCUPANTS)

 EXIT CAPACITY (OCCUPANTS) PANIC HARDWARE (WHERE OCCURS)

FLOOR AREA

 EGRESS DIRECTION — OCCUPANTS

MATERIALS LEGEND SYMBOLS LEGEND

<u>/1\</u> 10/10/10

×----

EXECUTIVE OFFICE ROOM NAME & NUMBER REFERENCE 510

> REVISION REFERENCE - SEE REVISION SCHEDULE IN TITLEBLOCK OF THE SHEET WHERE REFERENCE IS INDICATED

> DIMENSION POINT SYMBOL - DIMENSIONS INDICATED IN PLAN AND SECTION DRAWINGS REFERENCE EXACT LOCATIONS INDICATED BY DIMENSION POINT SYMBOLS WHEN USED IN DETAIL DRAWINGS

WORK POINT SYMBOL - DIMENSIONS INDICATED IN PLAN AND SECTION DRAWINGS REFERENCE EXACT LOCATIONS INDICATED BY WORK POINT SYMBOLS WHEN USED IN DETAIL DRAWINGS

FINISH START POINT SYMBOL - LOCATION INDICATES A SEPARATION POINT OF TWO FINISHES OR AN ORIGIN POINT FOR ONE FINISH WHERE A FULL FORMAT PATTERN STARTS AND PROCEEDS IN THE DIRECTION OF THE ARROW

DIRECTION SYMBOL - ARROWS INDICATE DIRECTION OF GRAIN, PLANK, OR SPAN

ELEVATION SYMBOL

SPOT ELEVATION SYMBOL ELEVATION CHANGE SYMBOL

EXTERIOR ELEVATION REFERENCE

WALL SECTION REFERENCE

BUILDING SECTION REFERENCE

DRAWING TITLE - THE DRAWING NUMBER REFERS TO THE DRAWING, THE SHEET NUMBER REFERS TO THE SHEET FROM WHICH THE DRAWING IS FIRST REFERENCED

INTERIOR ELEVATION REFERENCE

PHOTOGRAPH REFERENCE - INDICATES APPROXIMATE LOCATION AND DIRECTION OF

ROOM FINISH CALLOUT - SPACE WHERE CALLOUT IS LOCATED HAS WALL FINISH PT-1, BASE RA-1, AND FLOOR FINISH T-1 ON ALL SURFACES, UNLESS

IS LOCATED ON OR IS POINTING TO HAS FINISH PT-1 PARTITION & CEILING CALLOUT - NUMBER INDICATES PARTITION OR CEILING TYPE, LETTER INDICATES SIZE

PS-1) -SIGN CALLOUT

KEY NOTE REFERENCE - SEE KEY NOTES ON THE SHEET WHERE REFERENCE IS INDICATED

NEW COLUMN GRID TAG

EXISTING COLUMN GRID TAG

OCCUPANCY DESCRIPTION

- OCCUPANT LOAD TOTAL

TRUE NORTH - PLAN NORTH

GENERAL NOTES

- 1. DIMENSIONS GOVERN. DO NOT SCALE DRAWINGS.
- 2. THE INTENT OF THE CONTRACT DOCUMENTS IS TO INCLUDE ALL ITEMS NECESSARY FOR THE PROPER EXECUTION AND COMPLETION OF THE WORK BY THE CONTRACTOR. THE CONTRACT DOCUMENTS ARE COMPLEMENTARY, AND WHAT IS REQUIRED BY ONE SHALL BE AS BINDING AS IF REQUIRED BY ALL; PERFORMANCE BY THE CONTRACTOR SHALL BE REQUIRED ONLY TO THE EXTENT CONSISTENT WITH THE CONTRACT DOCUMENTS AND REASONABLY INFERABLE FROM THEM AS BEING NECESSARY TO PRODUCE THE INDICATED RESULTS.
- 3. UNLESS OTHERWISE STATED IN THE CONTRACT DOCUMENTS, WORDS THAT HAVE WELL-KNOWN TECHNICAL OR CONSTRUCTION INDUSTRY MEANINGS ARE USED IN THE DRAWINGS IN ACCORDANCE WITH SUCH RECOGNIZED MEANINGS.
- IN THE INTEREST OF BREVITY THE CONTRACT DOCUMENTS FREQUENTLY OMIT $\frac{25\lambda}{100}$ MODIFYING WORDS SUCH AS "ALL" AND "ANY" AND ARTICLES SUCH AS "THE" AND "AN", BUT THE FACT THAT THE MODIFIER OR AN ARTICLE IS ABSENT FROM ONE STATEMENT AND APPEARS IN ANOTHER IS NOT INTENDED TO AFFECT THE INTERPRETATION OF EITHER STATEMENT.
- EXECUTION OF THE CONTRACT BY THE CONTRACTOR IS A REPRESENTATION THAT THE CONTRACTOR HAS VISITED THE SITE, BECOME GENERALLY FAMILIAR WITH THE LOCAL CONDITIONS UNDER WHICH THE WORK IS TO BE PERFORMED AND CORRELATED PERSONAL OBSERVATIONS WITH REQUIREMENTS OF THE CONTRACT DOCUMENTS.
- BECAUSE THE CONTRACT DOCUMENTS ARE COMPLEMENTARY, THE CONTRACTOR SHALL, BEFORE STARTING EACH PORTION OF THE WORK, CAREFULLY STUDY AND COMPARE THE VARIOUS CONTRACT DOCUMENTS RELATIVE TO THAT PORTION OF THE WORK. AS WELL AS THE INFORMATION FURNISHED BY THE OWNER. SHALL TAKE FIELD MEASUREMENTS OF ANY EXISTING CONDITIONS RELATED TO THAT PORTION OF THE WORK, AND SHALL OBSERVE ANY CONDITIONS AT THE SITE AFFECTING IT. THESE OBLIGATIONS ARE FOR THE PURPOSE OF FACILITATING COORDINATION AND CONSTRUCTION BY THE CONTRACTOR AND ARE NOT FOR THE PURPOSE OF DISCOVERING ERRORS, OMISSIONS, OR INCONSISTENCIES IN THE CONTRACT DOCUMENTS HOWEVER, THE CONTRACTOR SHALL PROMPTLY REPORT TO THE ARCHITEC ANY ERRORS, INCONSISTENCIES OR OMISSIONS DISCOVERED BY OR MADE KNOWN TO THE CONTRACTOR AS A REQUEST FOR INFORMATION IN SUCH FORM AS THE ARCHITECT MAY REQUIRE. IT IS RECOGNIZED THAT THE CONTRACTOR'S REVIEW IS MADE IN THE CONTRACTOR'S CAPACITY AS A CONTRACTOR AND NOT AS A LICENSED DESIGN PROFESSIONAL, UNLESS OTHERWISE SPECIFICALLY PROVIDED IN THE CONTRACT DOCUMENTS
- 7. THE CONTRACTOR IS NOT REQUIRED TO ASCERTAIN THAT THE CONTRACT DOCUMENTS ARE IN ACCORDANCE WITH APPLICABLE LAWS, STATUTES, ORDINANCES, CODES, RULES AND REGULATIONS, OR LAWFUL ORDERS OF PUBLIC AUTHORITIES, BUT THE CONTRACTOR SHALL PROMPTLY REPORT TO THE ARCHITECT ANY NONCONFORMITY DISCOVERED BY OR MADE KNOWN TO THE CONTRACTOR AS A REQUEST FOR INFORMATION IN SUCH FORM AS THE ARCHITECT MAY REQUIRE.
- 8. THE ARCHITECT AND THE ARCHITECT'S CONSULTANTS SHALL BE DEEMED THE AUTHORS AND OWNERS OF THEIR RESPECTIVE INSTRUMENTS OF SERVICE, INCLUDING THE DRAWINGS AND SPECIFICATIONS, AND WILL RETAIN ALL COMMON LAW, STATUTORY AND OTHER RESERVED RIGHTS, INCLUDING COPYRIGHTS. THE CONTRACTOR, SUBCONTRACTORS, SUB-SUBCONTRACTORS, AND MATERIAL OR EQUIPMENT SUPPLIERS SHALL NOT OWN OR CLAIM A COPYRIGHT IN THE INSTRUMENTS OF SERVICE. SUBMITTAL OR DISTRIBUTION TO MEET OFFICIAL REGULATORY REQUIREMENTS OR FOR OTHER PURPOSES IN CONNECTION WITH THIS PROJECT IS NOT TO BE CONSTRUED AS PUBLICATION IN DEROGATION OF THE ARCHITECT'S OR ARCHITECT'S CONSULTANTS' RESERVED
- THE CONTRACTOR, SUBCONTRACTORS, SUB-SUBCONTRACTORS AND MATERIAL OR EQUIPMENT SUPPLIERS ARE AUTHORIZED TO USE AND REPRODUCE THE INSTRUMENTS OF SERVICE PROVIDED TO THEM SOLELY AND EXCLUSIVELY FOR EXECUTION OF THE WORK. ALL COPIES MADE UNDER THIS AUTHORIZATION SHALL BEAR THE COPYRIGHT NOTICE. IF ANY, SHOWN ON THE INSTRUMENTS OF SERVICE. THE CONTRACTOR. SUBCONTRACTORS. SUB-SUBCONTRACTORS. AND MATERIAL OR EQUIPMENT SUPPLIERS MAY NOT USE THE INSTRUMENTS OF SERVICE ON OTHER PROJECTS OR FOR ADDITIONS TO THIS PROJECT OUTSIDE THE SCOPE OF THE WORK WITHOUT THE SPECIFIC WRITTEN CONSENT OF THE OWNER, ARCHITECT AND THE ARCHITECT'S CONSULTANTS.

CUTTING AND PATCHING

- 1. THE CONTRACTOR SHALL BE RESPONSIBLE FOR CUTTING, FITTING OR PATCHING REQUIRED TO COMPLETE THE WORK OR TO MAKE ITS PARTS FIT TOGETHER PROPERLY. ALL AREAS REQUIRING CUTTING, FITTING AND PATCHING SHALL BE RESTORED TO THE CONDITION EXISTING PRIOR TO CUTTING, FITTING AND PATCHING, UNLESS OTHERWISE REQUIRED BY THE CONTRACT DOCUMENTS.
- 2. PATCH HOLES AND DAMAGED AREAS THAT ARE CREATED BY DEMOLITION OF ITEMS INDICATED ELSEWHERE.
- 3. PATCH FINISH MATERIALS WHERE ITEMS ARE REMOVED.
- 4. PATCH SUBSTRATES WHERE ITEMS ARE REMOVED.
- 5. PATCH HOLES AND DAMAGED AREAS OF MASONRY, PLASTER, AND CONCRETE SURFACES THAT ARE CREATED BY DEMOLITION OF ITEMS MOUNTED WITH MECHANICAL FASTENERS, ADHESIVES, AND SETTING BEDS.
- 6. REPLACE MASONRY WHERE CUTTING AND DEMOLITION EXPOSES MASONRY
- 7. WHERE EXCESSIVE CUTTING CANNOT BE AVOIDED AND PATCHING IS NOT FEASIBLE, REMOVE AND RECONSTRUCT ITEM TO MATCH EXISTING.

PROJECT NOTES

ABOVE SEA LEVEL.

WALL DIMENSIONS ARE TO THE FACE OF STUD, UNLESS INDICATED OTHERWISE. 2. PLAN ELEVATION OF 100'-0" IS EQUAL TO ACTUAL SURVEY ELEVATION OF **581.38'** **DRAWING INDEX**

EXISTING CONDITIONS PHOTOS GO12 ARCHITECTURAL

GENERAL

DEMO SITE PLAN A121 SITE PLAN

TITLE SHEET

A211 LEVEL 1 & LEVEL 2 DEMO FLOOR PLANS A221 LEVEL 1 DEMO REFLECTED CEILING PLANS A231 LEVEL 1 & LEVEL 2 FLOOR PLANS

A233 ROOF PLAN LEVEL 1 & LEVEL 2 REFLECTED CEILING PLANS AND POWER PLANS A241 A311 **EXTERIOR ELEVATIONS**

EXTERIOR ELEVATIONS - SUBCHAPTER F TENT A312

BUILDING SECTIONS A431 STAIR DETAILS A611 EXTERIOR DETAILS A612 EXTERIOR DETAILS

INTERIOR ELEVATIONS WINDOW AND DOOR TYPES & SCHEDULES

TYPICAL DETAILS

STRUCTURAL

S2.3


A711

GENERAL NOTES FOUNDATION PLAN & WIND BRACING PLAN S1.0 ROOF FRAMING PLAN & 1ST FLOOR CEILING FRAMING PLAN

S1.1 S2.0 DETAILS S2.1 DETAILS S2.2 TYPICAL DETAILS

1301 E. 7th Stree Austin, TX 78702 ph: 512 476 0201 fx: 512 476 0216 www.mckinneyyork.com



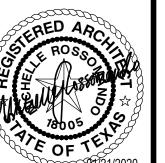

MICHELLE ROSSOMANDO 01/21/2020

STRUCTURAL ENGINEER FORT STRUCTURES PH: 512-817-9264 CONTACT: SAM COVEY

> ш SID RYAL

PLEASE RECYCLE

4 6/23/2020

5 8/12/2020

#\ REVISION


CONSTRUCTION DOCUMENTS PROJECT NO. DATE 01/21/2020

TITLE SHEET


CONTACT: MICHELLE ROSSOMANDO

REVISION

EXISTING CONDITIONS PHOTOS

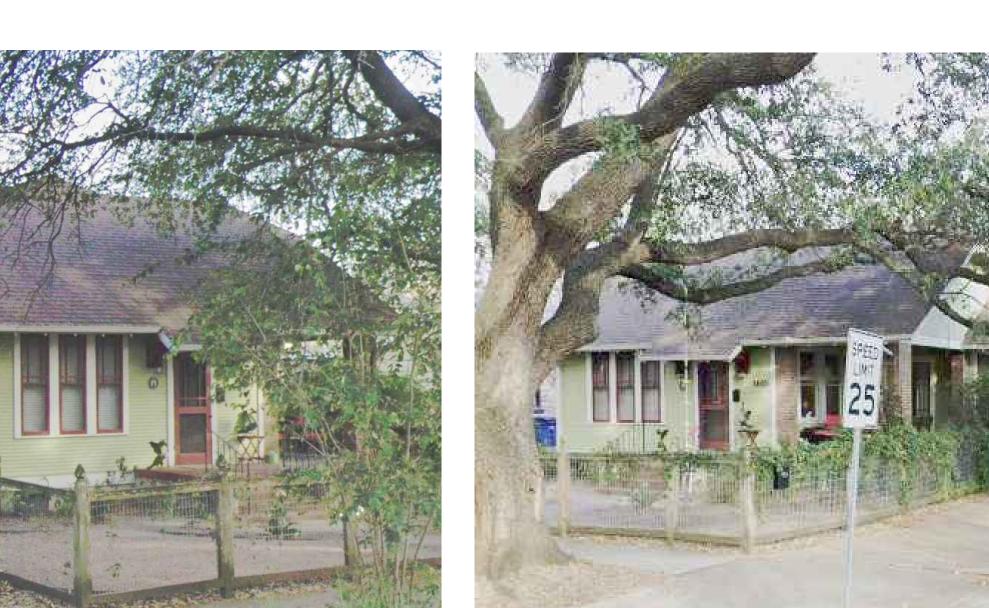

STREET VIEW SOUTHWEST OS

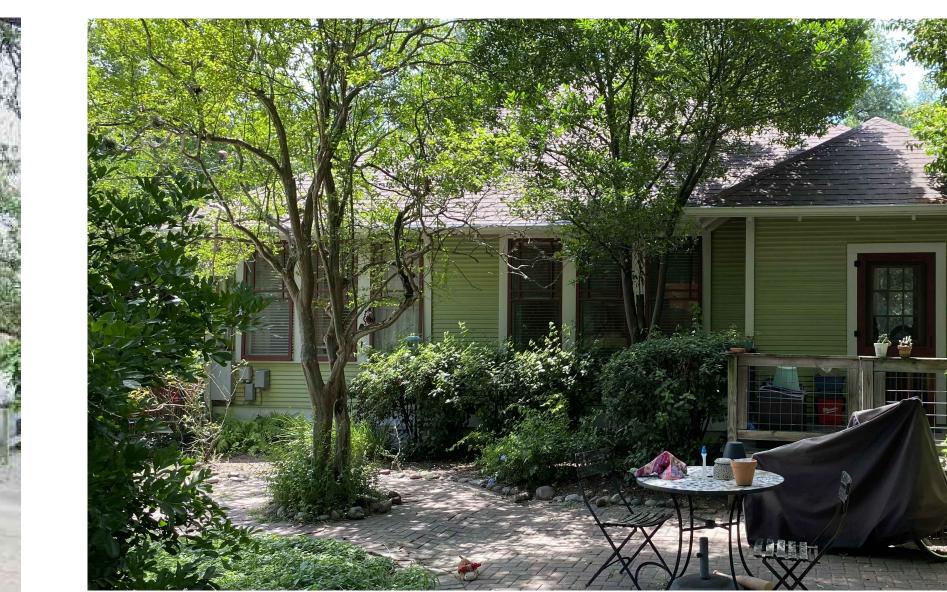



PARTIAL SOUTH ELEVATION SCALE: NTS 05



SOUTHWEST CORNER O4

EAST ELEVATION SCALE: NTS 07



STREET VIEW NORTHWEST 09


NORTHEAST CORNER O3




PARTIAL NORTH ELEVATION SCALE: NTS 02




NORTHWEST CORNER 01

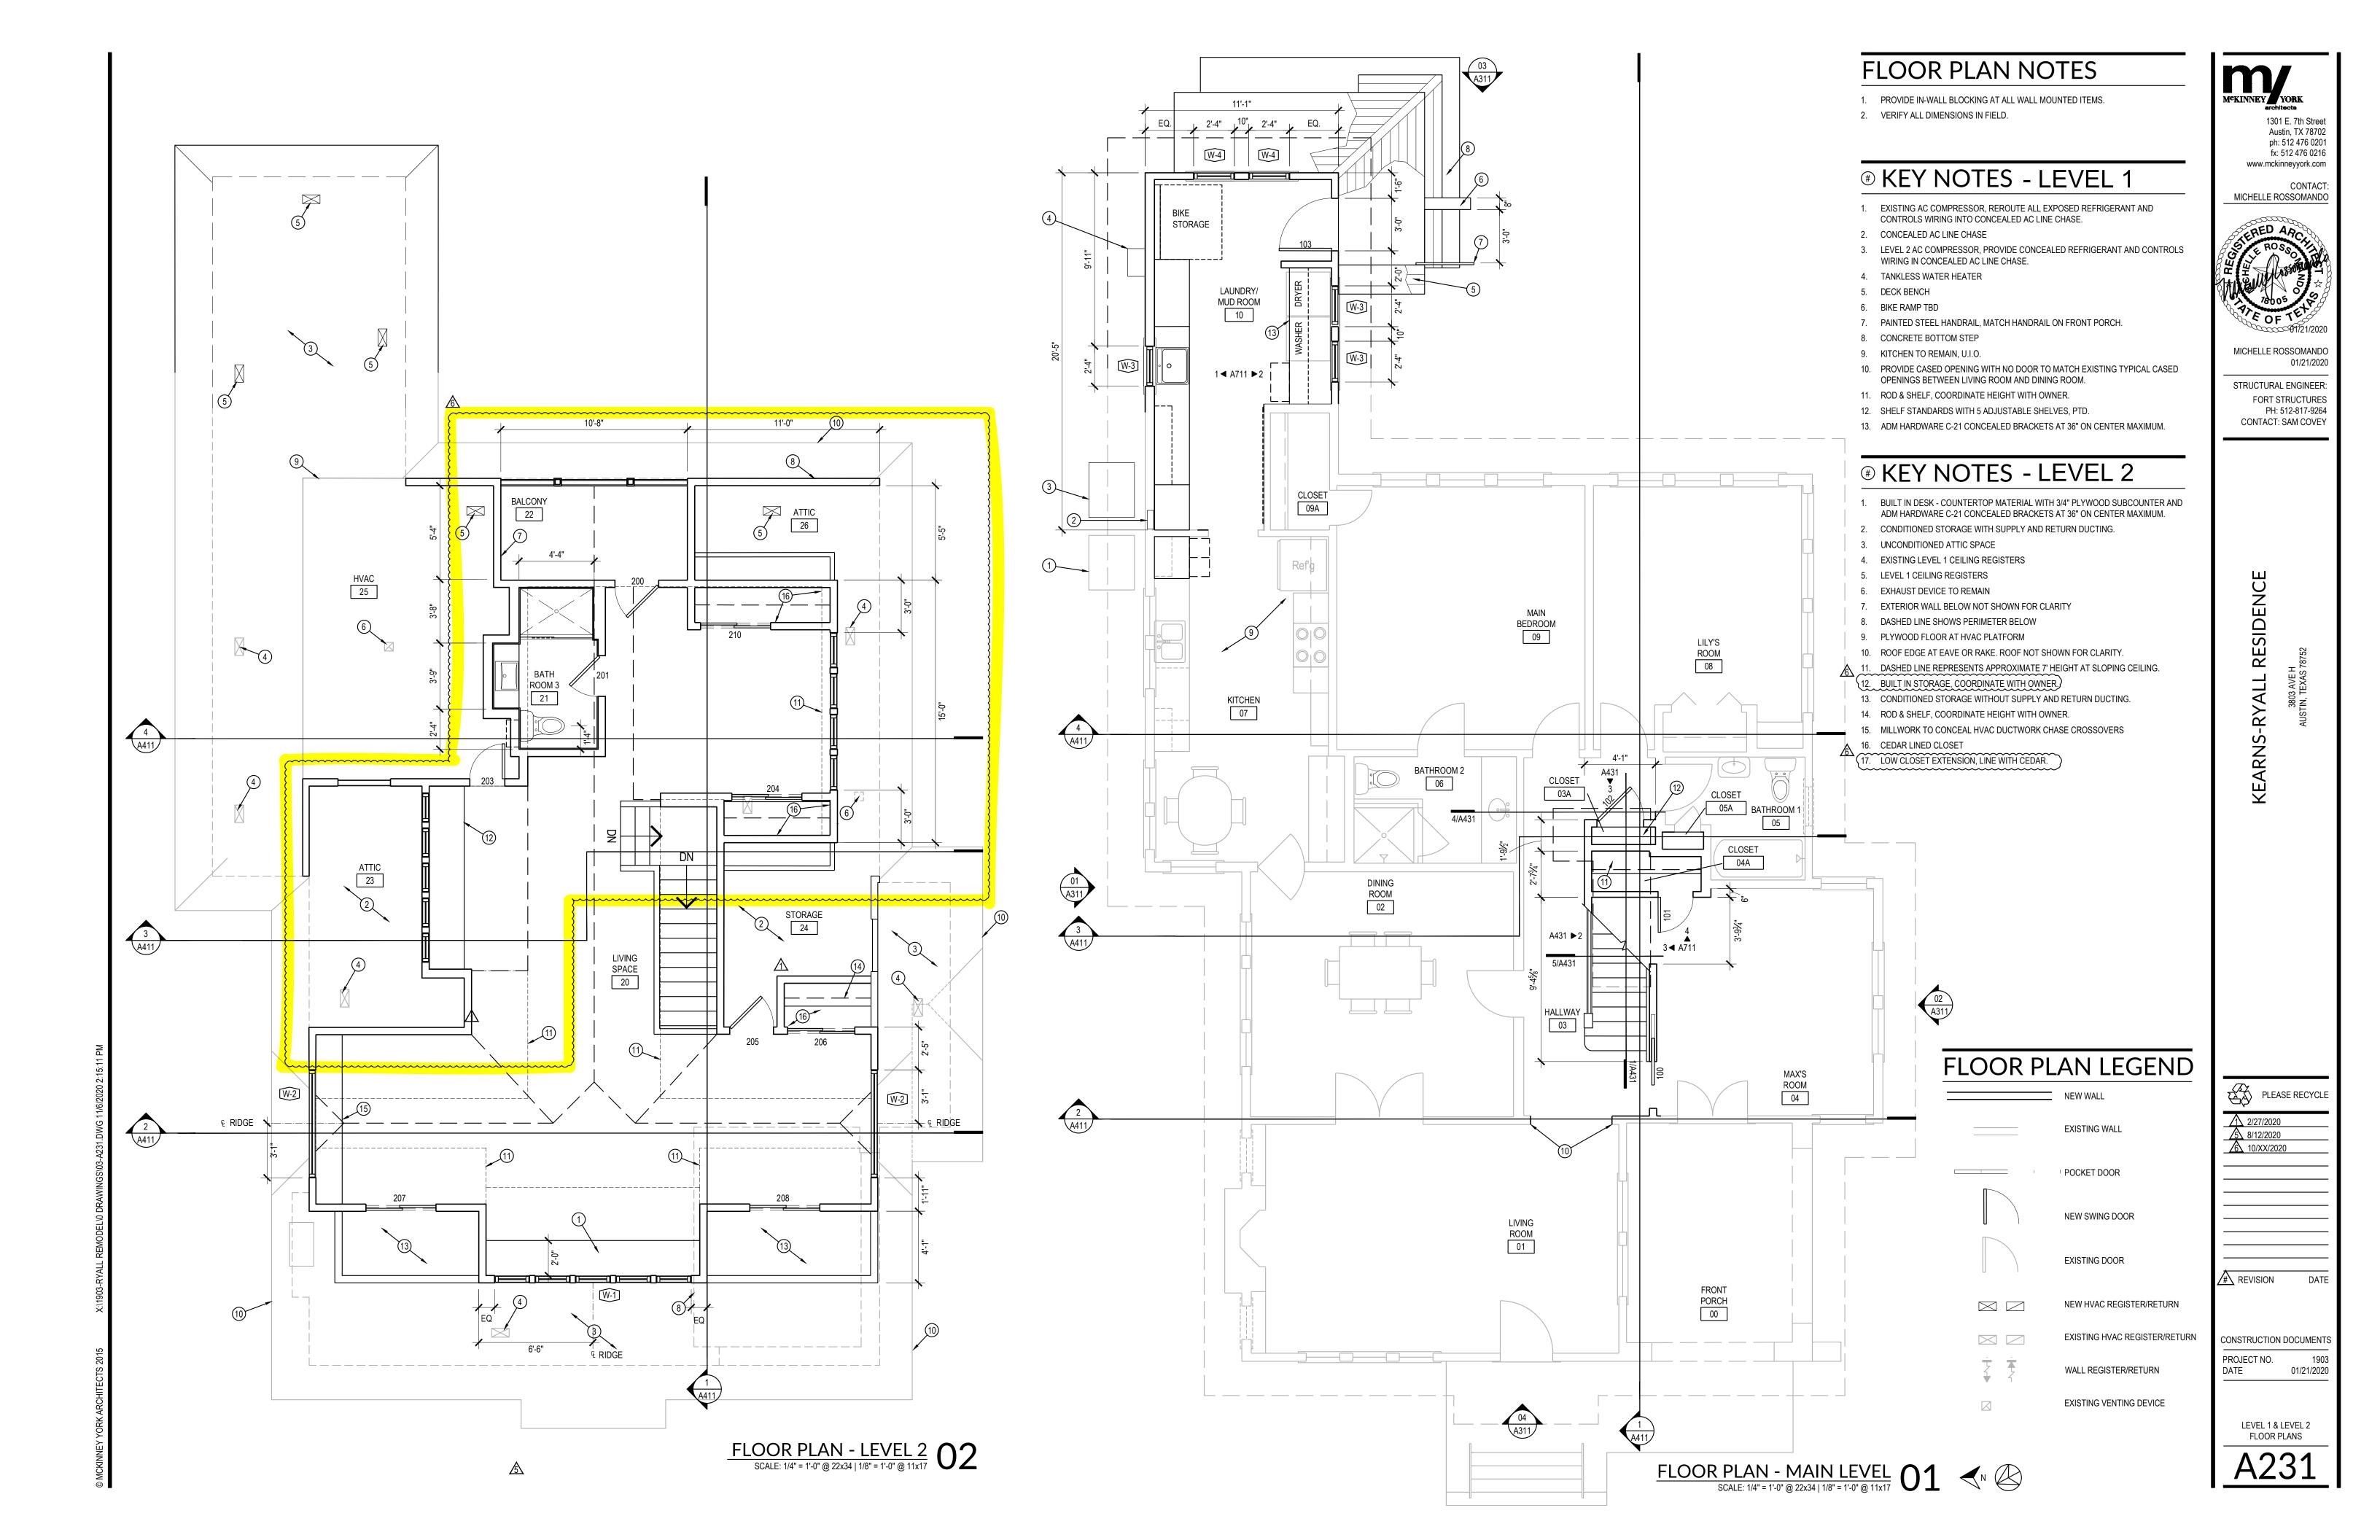

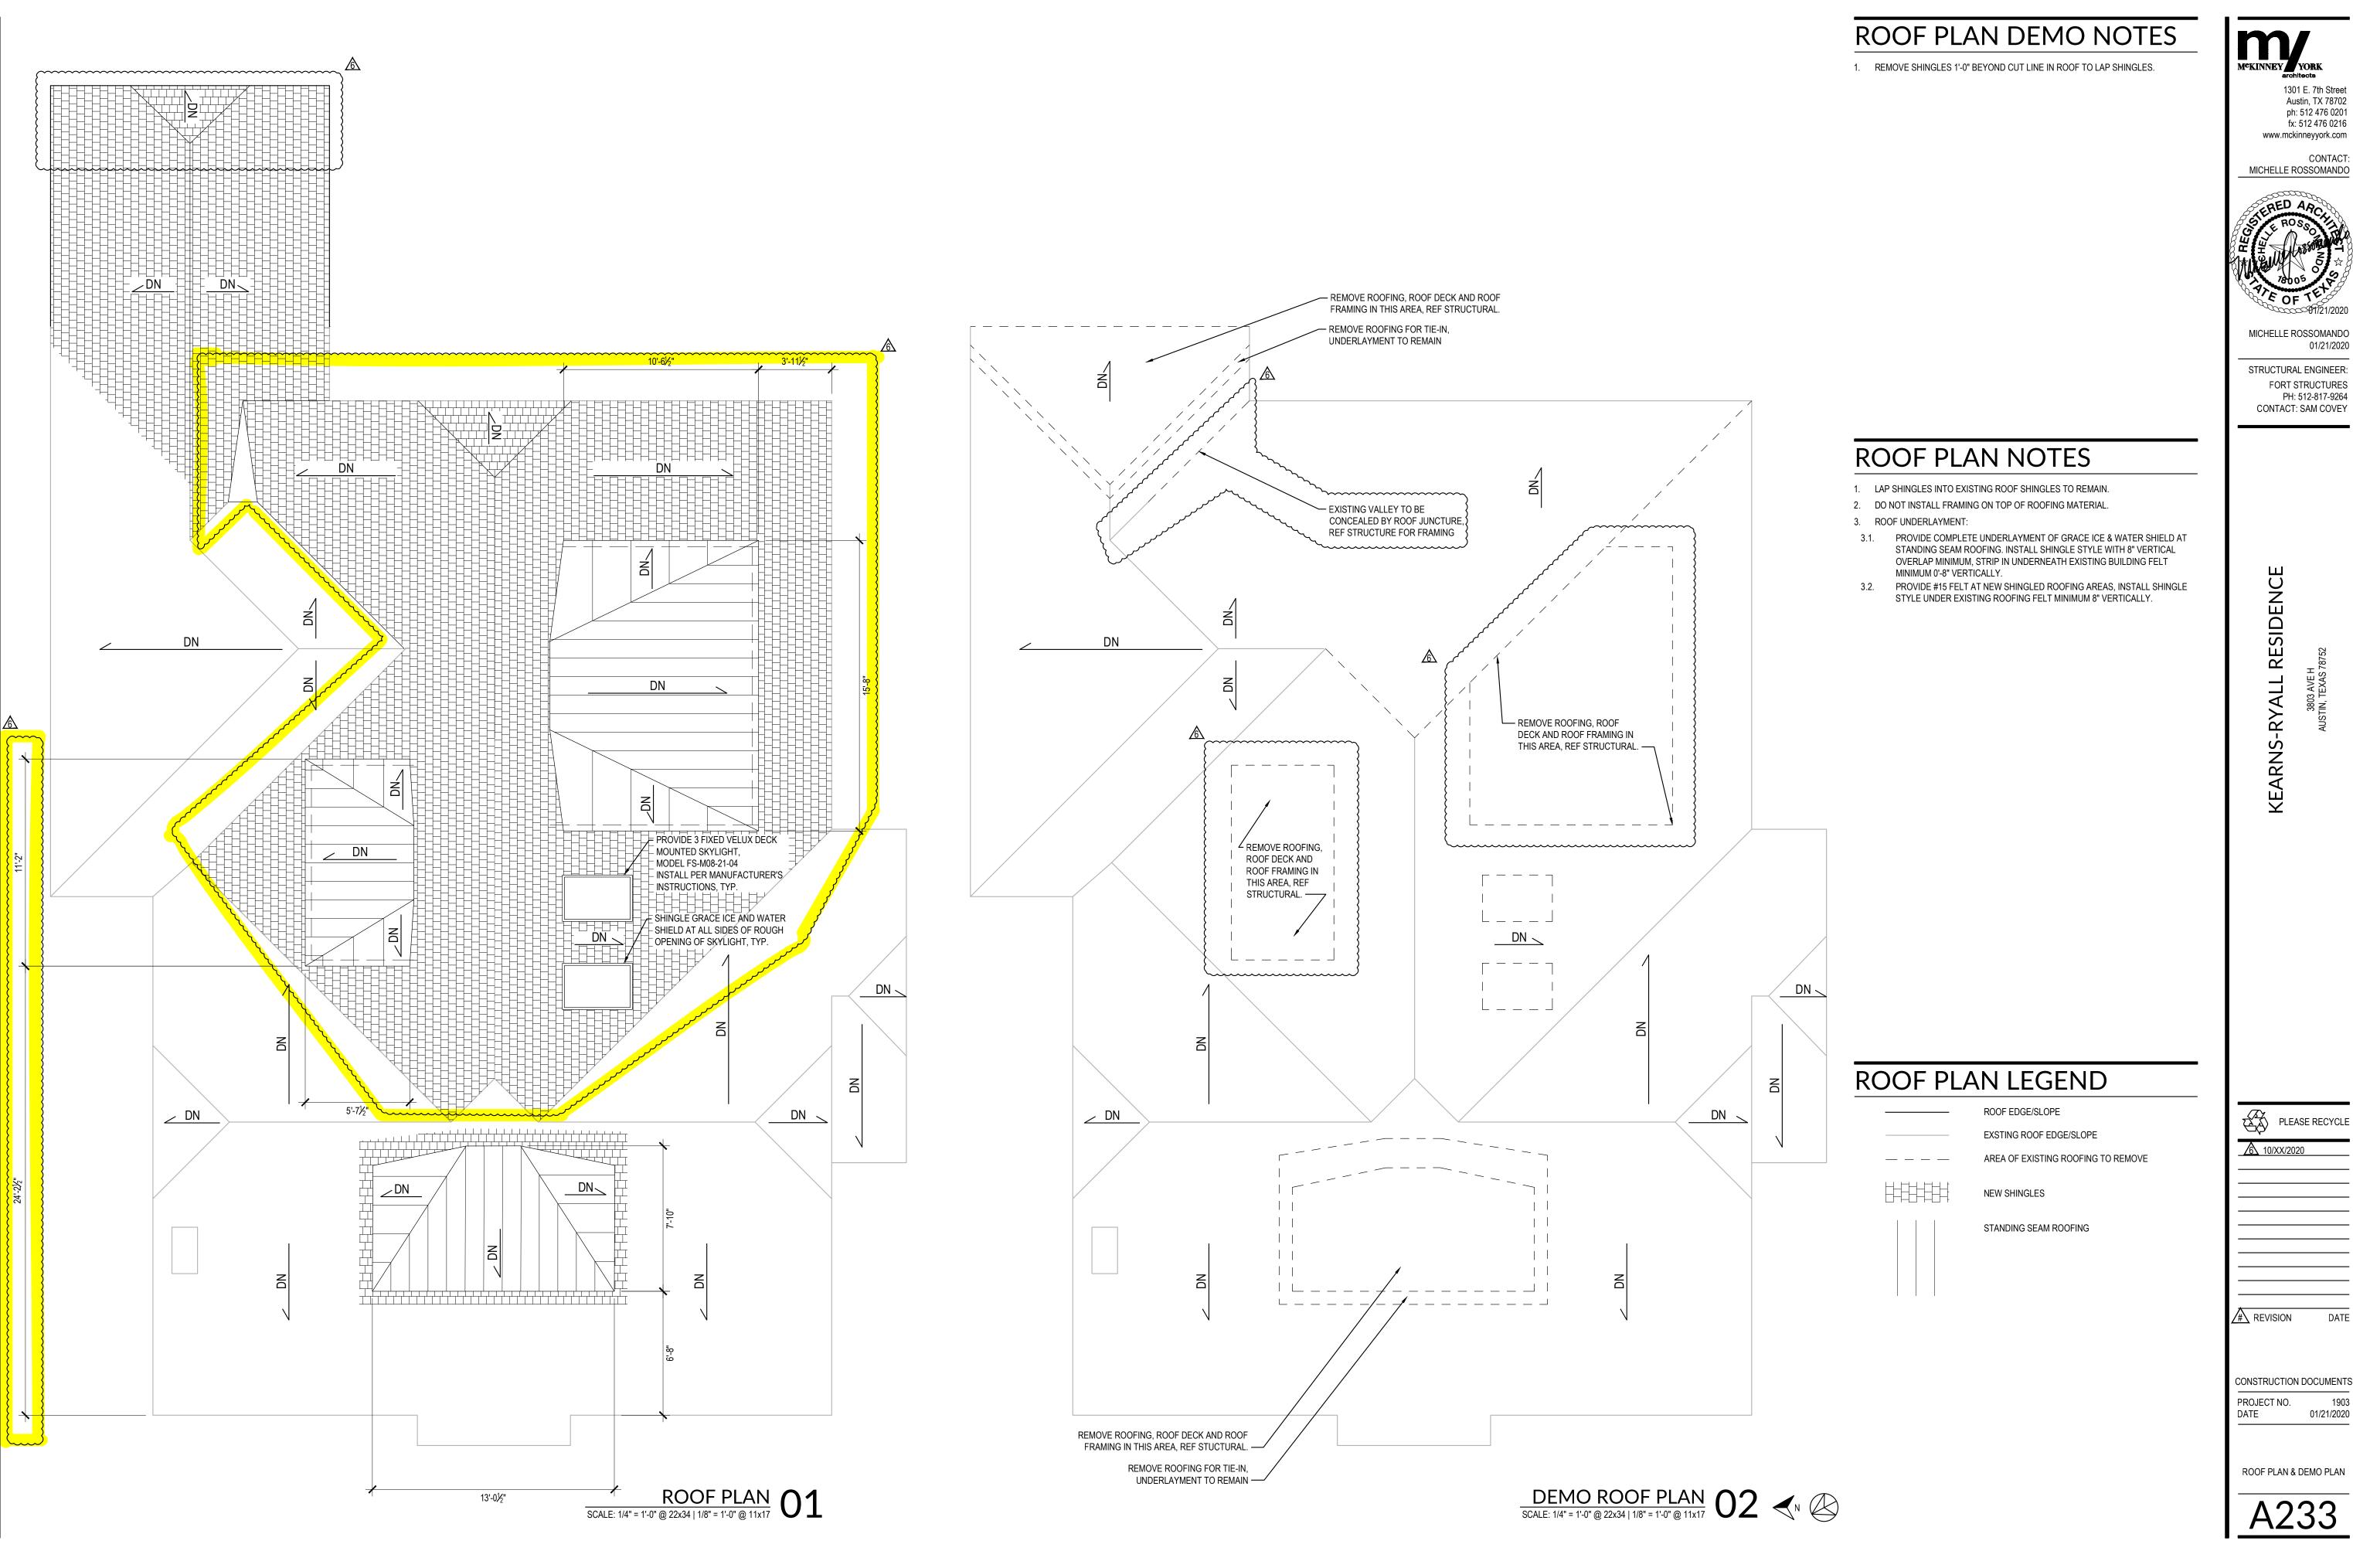

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CONTACT: MICHELLE ROSSOMANDO

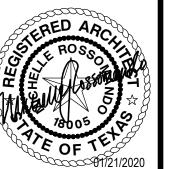

MICHELLE ROSSOMANDO

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CONTACT: SAM COVEY

KEARNS-RYALL RESIDENCE


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CONSTRUCTION DOCUMENTS PROJECT NO.

01/21/2020

ROOF PLAN & DEMO PLAN




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CONSTRUCTION DOCUMENTS 1903 01/21/2020

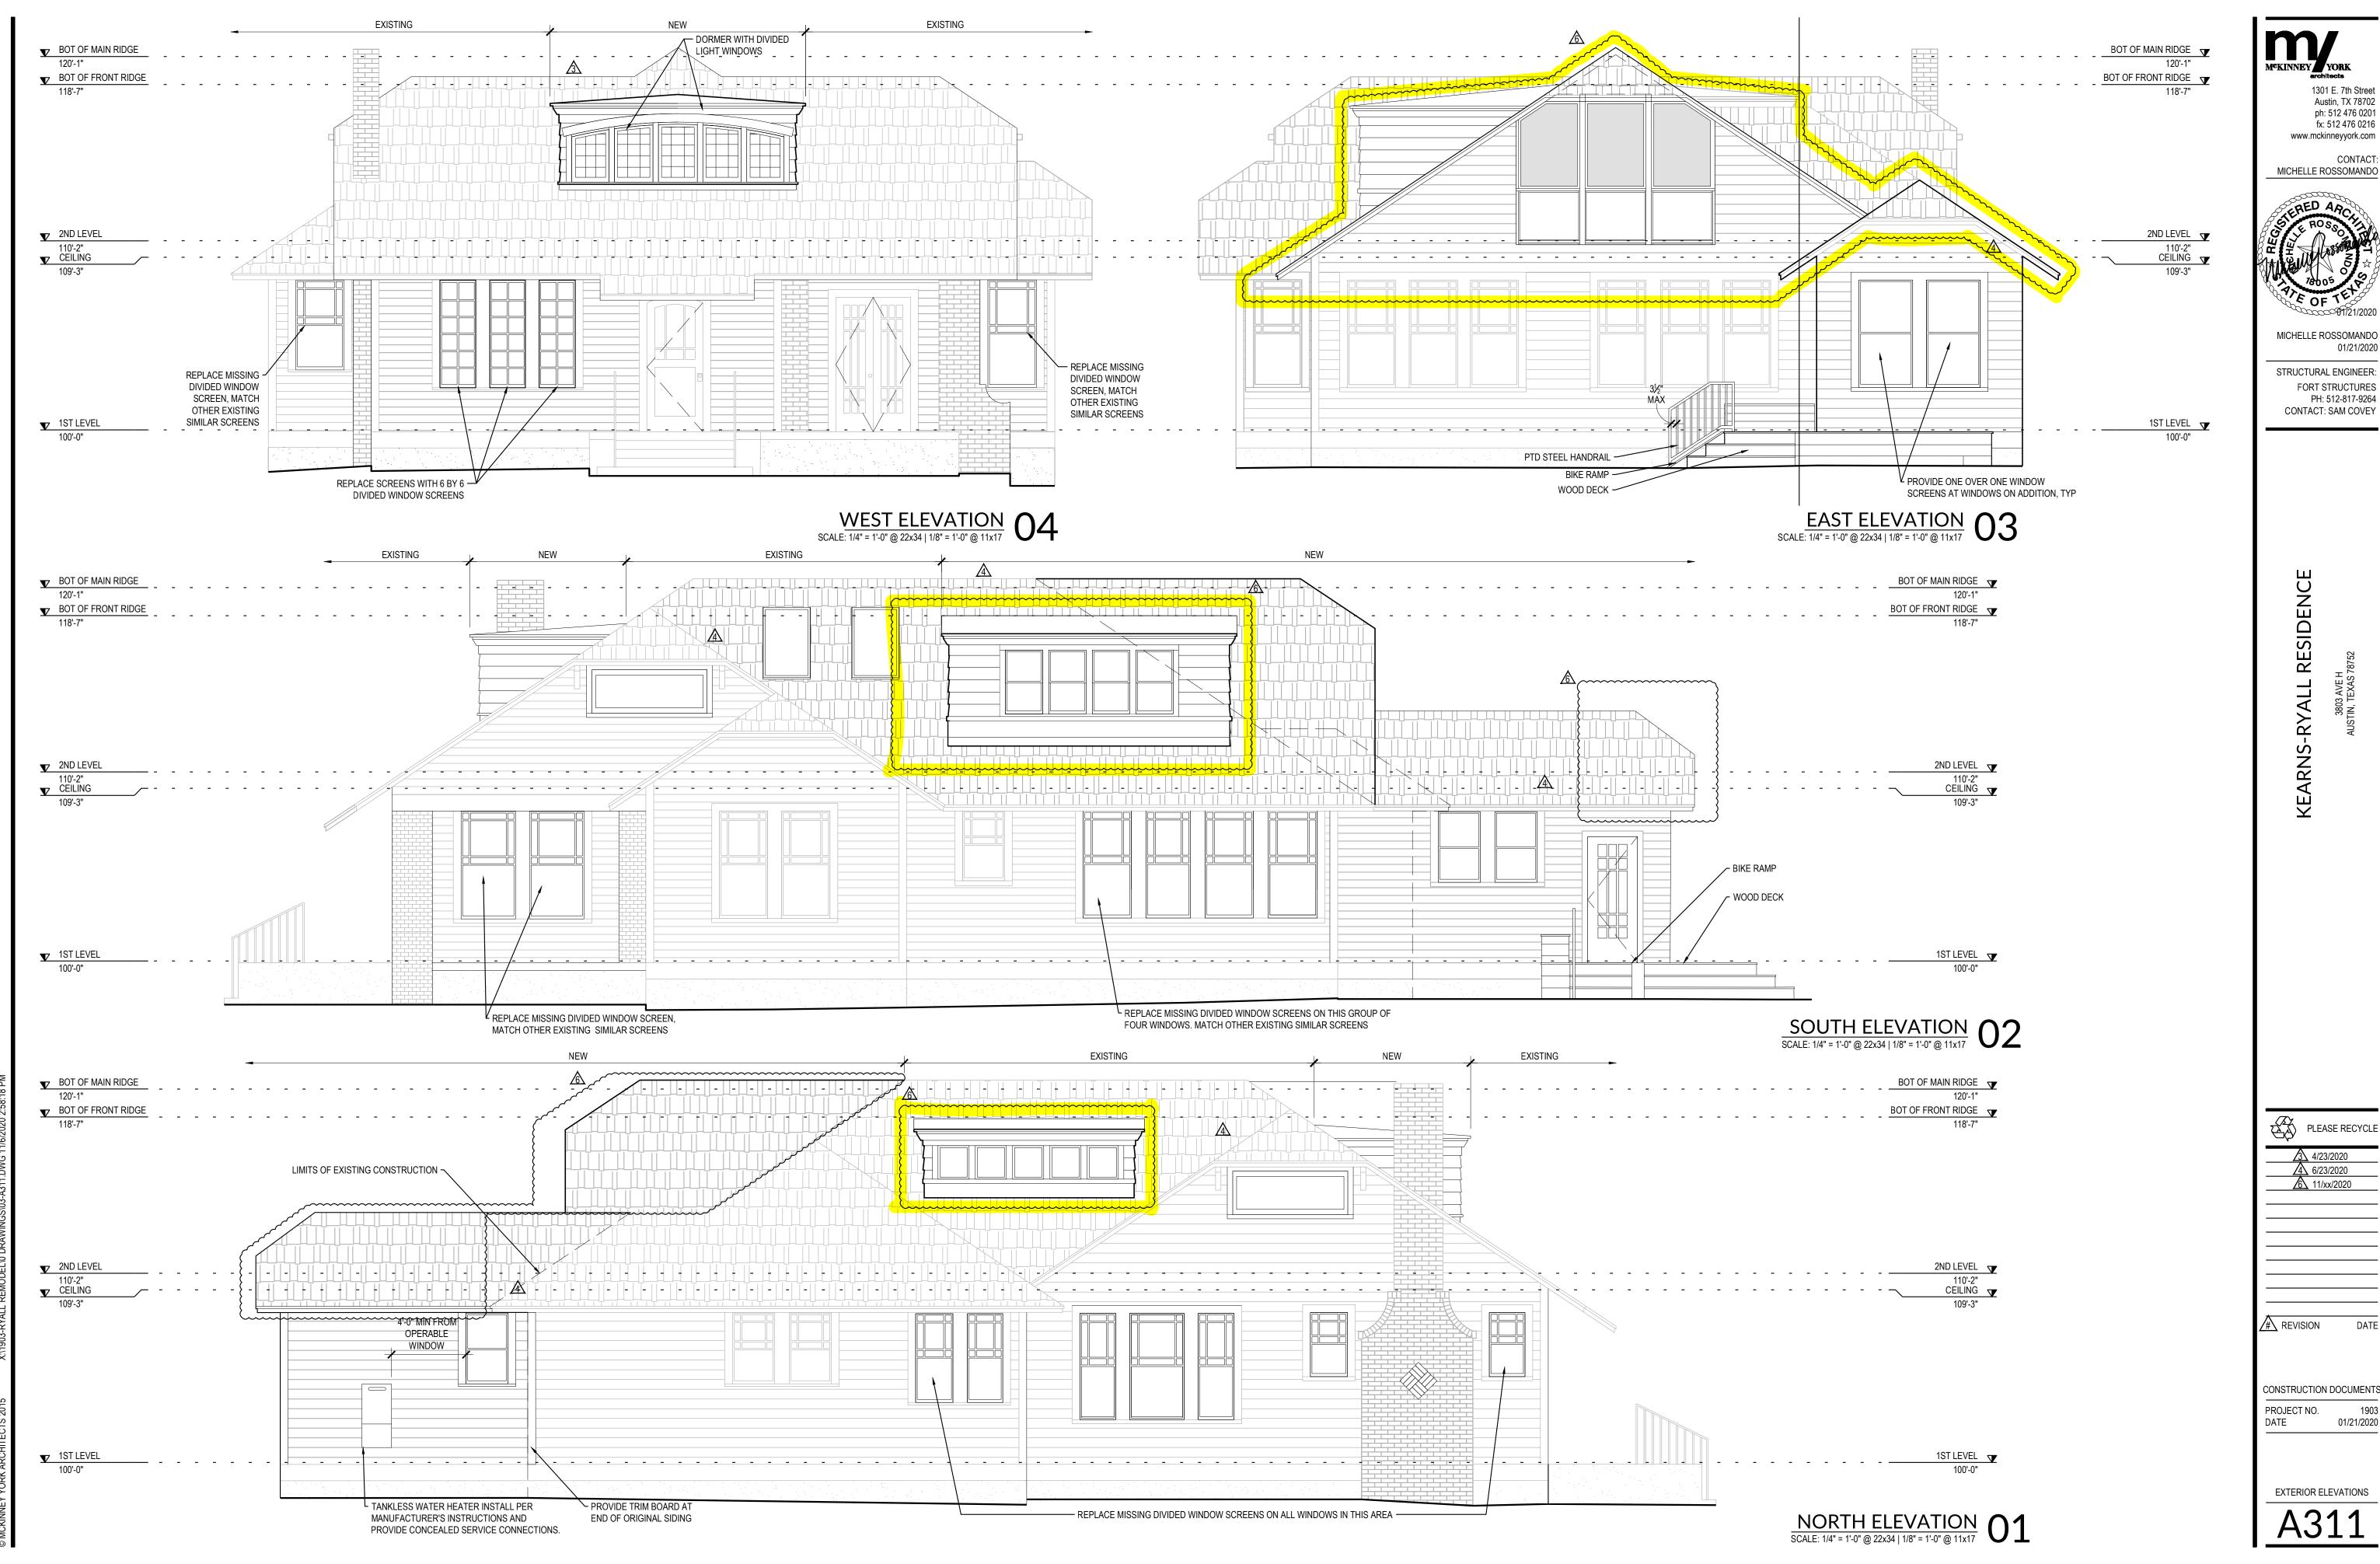SOUTH ELEVATION 02

SECOND LEVEL 110'-2"



NORTH ELEVATION 01
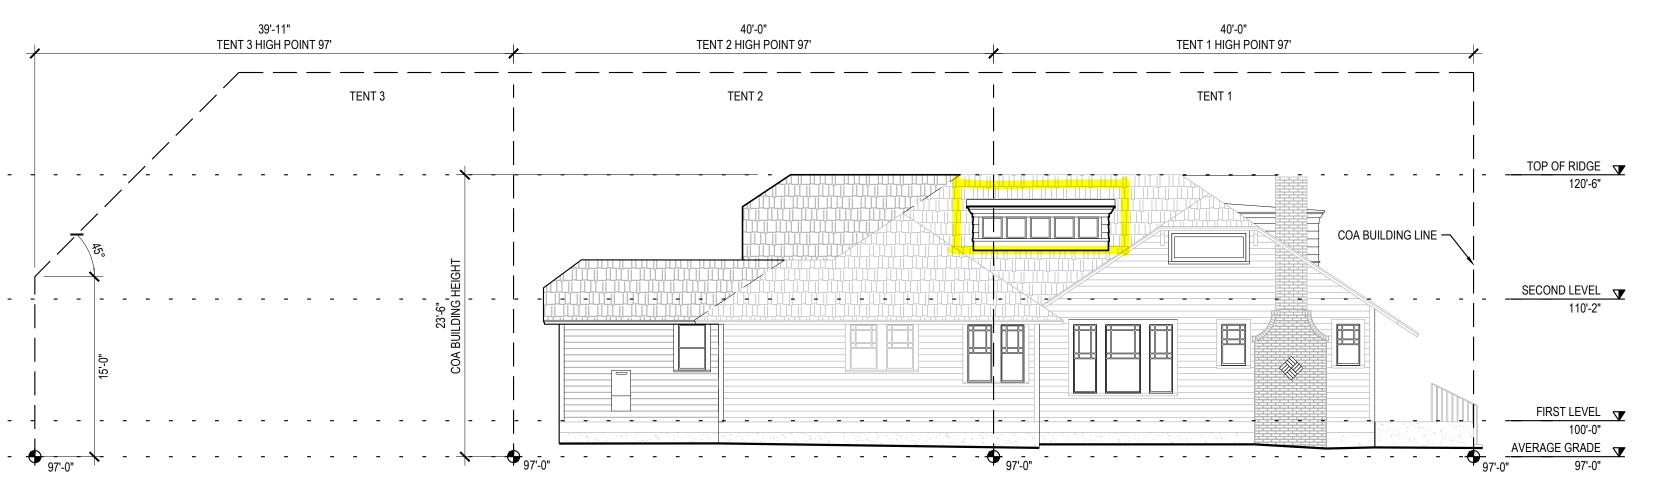
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MICHELLE ROSSOMANDO 01/21/2020

STRUCTURAL ENGINEER:

FORT STRUCTURES PH: 512-817-9264 CONTACT: SAM COVEY

KEARNS-RYALL RESIDENCE

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REVISION

CONSTRUCTION DOCUMENTS PROJECT NO. DATE 1903 01/21/2020

EXTERIOR ELEVATIONS SUBCHAPTER F TENT