BOA GENERAL REVIEW COVERSHEET

<u>CASE</u>: C15-2020-0074 <u>BOA DATE</u>: December 14th, 2020

ADDRESS: 1501 Nickerson St
OWNER: Michele Connor

COUNCIL DISTRICT: 9
AGENT: William Burkhardt

ZONING: SF-3-NCCD-NP (Fairview Park NCCD, South River City NP)

LEGAL DESCRIPTION: LOT 1 BLK 17 SWISHER ADDN

VARIANCE REQUEST: increase of FAR from 40% to 41%

SUMMARY: remodel/addition to existing Single-Family residence

ISSUES: configuration, layout and design constraints of existing primary structure

	ZONING	LAND USES
Site	SF-3-NCCD-NP	Single-Family
North	CS-NCCD-NP	General Commercial Services
South	SF-3-NCCD-NP	Single-Family
East	SF-3-NCCD-NP	Single-Family
West	SF-3-NCCD-NP	Single-Family

NEIGHBORHOOD ORGANIZATIONS:

Austin Independent School District

Austin Lost and Found Pets

Austin Neighborhoods Council

Bike Austin

Friends of Austin Neighborhoods

Greater South River City Combined Neighborhood Plan Contact Team

Homeless Neighborhood Association

Neighborhood Empowerment Foundation

Preservation Austin


SELTexas

Sierra Club, Austin Regional Group

South Central Coalition

South River City Citizens Assn.

Zoning Committee of South River City Citizens

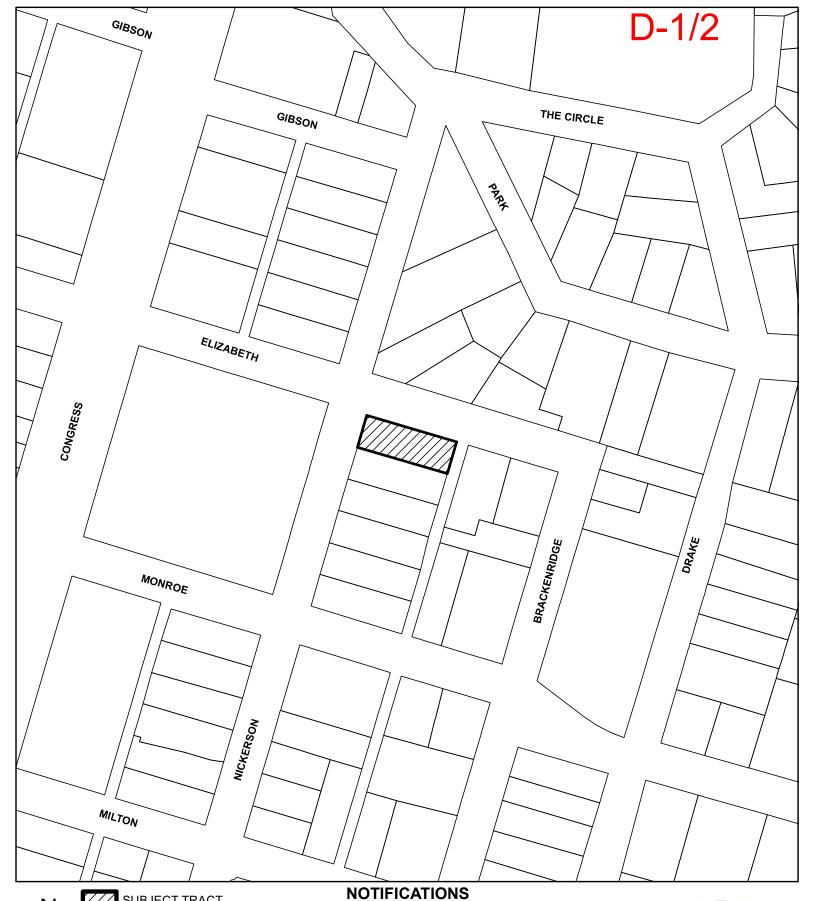






PENDING CASE

ZONING BOUNDARY

CASE#: C15-2020-0074 LOCATION: 1501 NICKERSON STREET

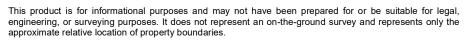



This product has been produced by CTM for the sole purpose of geographic reference. No warranty is made by the City of Austin regarding specific accuracy or completeness.





Board of Adjustment General/Parking Variance Application

<u>DevelopmentATX.com</u> | Phone: 311 (or 512-974-2000 outside Austin) For submittal and fee information, see <u>austintexas.gov/digitaldevelopment</u>

WARNING: Filing of this appeal stops all affected construction activity.

This application is a fillable PDF that can be completed electronically. To ensure your information is saved, <u>click here to Save</u> the form to your computer, then open your copy and continue.

The Tab key may be used to navigate to each field; Shift + Tab moves to the previous field. The Enter key activates links, emails, and buttons. Use the Up & Down Arrow keys to scroll through drop-down lists and check boxes, and hit Enter to make a selection.

The application must be complete and accurate prior to submittal. *If more space is required, please complete Section 6 as needed.* All information is required (if applicable).

For Office Use Only

For Office Use O	IIIy				
Case #	ROW #		Tax #		
G. I'm A. I'					
Section 1: Appli	cant Statemer	π			
Street Address: 1501 N	Nickerson Street				
Subdivision Legal Desc	ription:				
Lot 1, Blk 17 of Swi	sher Addition, Rec	corded in Bk. 1,	Pg. 2, Plat Reco	ords of Trav	. Co., together
w/the Map or Plat r			•		•
Lot(s): 1		Blo	ck(s): <u>17</u>		
Outlot:					
Zoning District: SF-3-N	CCD-NP				
IAA/ Marus D II I					16/
I/We William Burkhardt			on be	enait of mys	self/ourselves as
authorized agent for	Michele Connors	& Seth Bank			affirm that on
Month November	, Day 3	, Year 2020	, hereby ap	oply for a he	earing before the
Board of Adjustment					
○ Erect ○ Attach	○ Complete	Remodel	Maintain	Other:	Remodel/addition
Type of Structure: S	Single Family Resid	dence - Remode	el/Addition		

Portion of the City of Austin Land Development Code applicant is seeking a variance from:

Chapter 25-2, Subchapter F, Paragraph 2.1: Maximum Development Permitted, Maximum Floor-to-Area Ratio - .40 FAR (2,789 SF) is permitted, the request is for 2,874 SF (an additional 85 SF/.41 FAR).

Section 2: Variance Findings

The Board must determine the existence of, sufficiency of, and weight of evidence supporting the

findings described below. Therefore, you must complete each of the applicable Findings Statements as part of your application. Failure to do so may result in your application being rejected as incomplete. Please attach any additional supporting documents.

NOTE: The Board cannot grant a variance that would provide the applicant with a special privilege not enjoyed by others similarly situated or potentially similarly situated.

I contend that my entitlement to the requested variance is based on the following findings:

Reasonable Use

The zoning regulations applicable to the property do not allow for a reasonable use because:

The property is a corner lot with 2 existing modestly-sized houses, one constructed before 1921 and the other by 1950; the main house is 1,431 SF and the secondary house is 622 SF, and as such the zoning regulations do not allow for the design and construction of a workable residential plan under current circumstances without demolishing either the secondary house or the main house.

Hardship

a) The hardship for which the variance is requested is unique to the property in that:

There are currently 2 houses on the property, a primary residence and a 622 SF guest house. Given the configuration, layout and design constraints of the existing primary residence, even the proposed modest addition to the primary residence is not possible to achieve without removing the guest house or significantly impacting the character of the property. <Please see the Notes below for additional comments.>

b) The hardship is not general to the area in which the property is located because:

Many residential properties in this transitional zone have redeveloped into hybrid residential/commercial operations with outsized structures, or have demolished existing structures to construct new residences, or are outright commercial operations which directly impact this property; the request for the minor additional square footage will be unnoticed in context.

Area Character

The variance will not alter the character of the area adjacent to the property, will not impair the use of adjacent conforming property, and will not impair the purpose of the regulations of the zoning district in which the property is located because:

The area is currently comprised of mixed zoning categories in a transitional and heavily-trafficked commercial district and is either adjacent to or in proximity of structures of a variety of sizes, most all of which are significantly larger than is being proposed by the request. The variance request is extremely modest in size and granting it will neither impair the use of adjacent conforming property nor will it impair the purpose of the regulations of the zoning district.

Parking (additional criteria for parking variances only)

Request for a parking variance requires the Board to make additional findings. The Board may grant a variance to a regulation prescribed in the City of Austin Land Development Code Chapter 25-6, Appendix A with respect to the number of off-street parking spaces or loading facilities required if it makes findings of fact that the following additional circumstances also apply:

Neither present nor anticipated future traffic volumes generated by the use of the site or the


	uses of sites in the vicinity reasonably require strict or literal interpretation and enforcement of the specific regulation because:
N	/A
_ 2.	The granting of this variance will not result in the parking or loading of vehicles on public streets in such a manner as to interfere with the free flow of traffic of the streets because:
N	/A
3. N	The granting of this variance will not create a safety hazard or any other condition inconsistent with the objectives of this Ordinance because: /A
4.	The variance will run with the use or uses to which it pertains and shall not run with the site because: /A
_	

Section 3: Applicant Certificate

I affirm that my statements contained in the comple my knowledge and belief.	te application are true a	and correct to the best of
Applicant Signature:		Date: 11/03/2020
Applicant Name (typed or printed): William Burkha	rdt Architect, PLLC	
Applicant Mailing Address: 802 Christopher St.		
City: Austin	State: TX	Zip: 78704
Phone (will be public information): (512) 750-6580		
Email (optional – will be public information):		
Section 4: Owner Certificate		
I affirm that my statements contained in the comple my knowledge and belief. Bank, Seth		and correct to the best of
Owner Signature: Connors, Michele Digital Date Date Date Date Date Date Date Date	tally signed by Connors, Miche e: 2020.11.02 23:56:44 -06'00'	Date: Nov. 2, 2020
Owner Name (typed or printed): Michele Connors a	and Seth Bank	
Owner Mailing Address: 1501 Nickerson St.		
City: Austin	State: TX	Zip: <u>78704</u>
Phone (will be public information):		
Email (optional – will be public information):		
Section 5: Agent Information		
Agent Name: William Burkhardt Architect PLLC		
Agent Mailing Address: 802 Christopher St.		
City: Austin	State: TX	Zip: 78704
Phone (will be public information): (512) 750-6580		
Email (optional – will be public information):		
Section 6: Additional Space (if applied	cable)	
Please use the space below to provide additional in referenced to the proper item, include the Section a		
<hardship additional="" notes=""></hardship>		
Please note the following points in support of this		
1. It was never the intent of the McMansion ordinathe RDCC was specifically established as a vehicle		

Additional Space (continued)

2. Prior to dissolution, the RDCC was the mechanism for meritorious projects to request
additional FAR; 3. If the project were designed from scratch and the site were cleared, compliance with Subchapter
F could be achieved more easily.
4. With the McMansion Task Force, and the RDCC, and to the extent possible within Subchapter F, there had always been noted a special deference to and awareness of the difficulties of adding to
or remodeling existing structures, specifically with the intent to preserve rather than to demolish
them.
5. As a heritage tree or a property quirk on a site can be a hardship, then within reason, an existing
structure can be; to work within the limitations of the existing property, to preserve it and to update
it for present circumstances and living constraints is an analogous hardship.

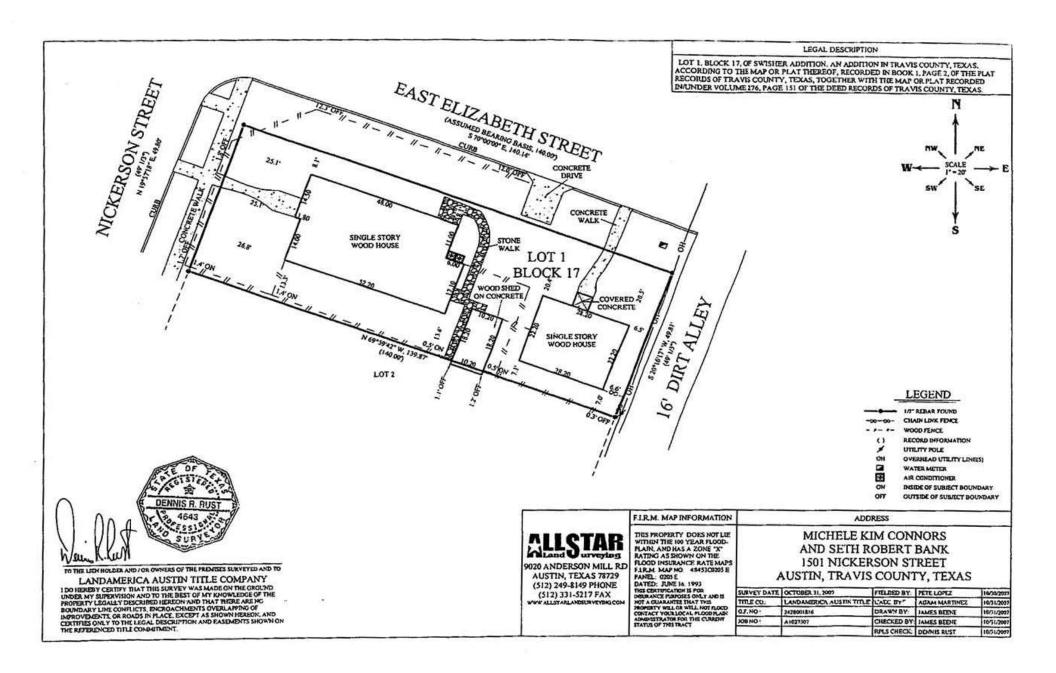

SITE LOCATION - SCALE: N.T.S.

1501 NICKERSON REMODEL-ADDITION

AUSTIN, TX 78704

OCTOBER 28, 2020

		ISSUE/REVI	SION DATE:
		PERMIT MTG. BOA	
INFORMATION		10/13/2020	10/28/2020
COV	COVER SHEET	•	•
ARCHITE	CTURAL DRAWINGS		
A1.1	EXIST. SITE PLAN & LDC CALCULATIONS	•	•
A1.2	DEMOLITION SITE PLAN & NEW SITE PLAN	•	•
A2.1	FIRST FLOOR PLAN & DEMOLITION PLAN	•	•
A2.2	SECOND FLOOR PLAN & ROOF PLAN	ě	ě
A2.3	ENLARGED FIRST FLOOR PLAN	ě	ě
A2.4	ENLARGED SECOND FLOOR PLAN	•	•
A3.1	NORTH & EAST ELEVATIONS	•	
A3.2	SOUTH & WEST ELEVATIONS	ě	ě
A3.3	BUILDING SECTION & DETAILS	ě	ě
A3.4	WINDOW TYPES	•	•
A4.1	INTERIOR ELEVATIONS	•	•
A4.2	INTERIOR ELEVATIONS	ě	ě
A5.1	FIRST FLOOR ELECTRICAL PLAN	•	
A5.2	SECOND FLOOR ELECTRICAL PLAN	Ō	Ō
STRUCTU	IRAL DRAWINGS		
S-1	FOUNDATION PLAN & DETAILS		
S-2	FRAMING PLANS & DETAILS		
S-3	FRAMING DETAILS		



COVER

CONNORS - BANK RESIDENCE 1501 NICKERSON AUSTIN TX 78704

COV




REVISIONS

& CALCS.

EXISTING SITE

Project: CONNORS Issue Dote: OCT. 28, 2020
Phose: CONSTRUCTION
Drawn By: WB

Date: OCT. 28, 2020

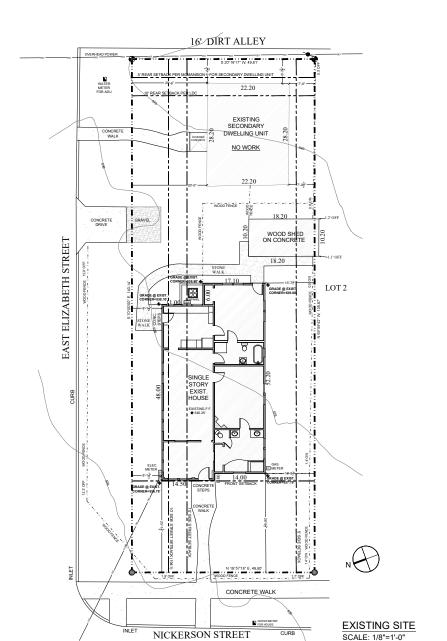

ADDRESS: 1501 NICKERSON STREET AUSTIN, TX 78704

LEGAL DESCRIPTION

LOT 1, BLOCK 17, OF SWISHER ADDITION, AN ADDITION IN TRAVIS COUNTY, TEXAS, ACCORDING TO THE MAP OR PLAT THEREOF, RECORDED IN BOOK 1, PAGE 2, OF THE PLAT RECORDS OF TRAVIS COUNTY, TEXAS, TOGETHER WITH THE MAP OR PLAT RECORDED INJUNDER VOLUME 276, PAGE 151 OF THE DEED RECORDS OF TRAVIS COUNTY, TEXAS.

THIS PROPERTY DOES NOT LIE WITHIN THE
100 YEAR FLOOD- PLAIN, AND HAS A ZONE
RATING AS SHOWN ON THE FLOOD
INSURANCE RATE MAP
F.I.R.M. MAP NO. 484330205 E
PAREL: 0205 E
DATED: JUNE 16, 1993

NEIGHBORHOOD PLAN: SOUTH RIVER CITY GREATER SOUTH RIVER CITY COMBINED NPA FAIRVIEW PARK NCCD

3,113 SF

GRADE/HEIGHT CALCULATIONS:

NATURAL GRADE CALCULATIONS: HIGHEST NATURAL GRADE AT BUILDING= 539.50' LOWEST NATURAL GRADE AT BUILDING = 538.75' AVERAGE NATURAL GRADE AT BUILDING = 538.125'

FINISHED GRADE CALCULATIONS: HIGHEST FINISHED GRADE AT BUILDING = 539.50' LOWEST FINISHED GRADE AT BUILDING = 538.75' AVERAGE FINISHED GRADE AT BUILDING = 538.125'

FINAL GRADE FOR HEIGHT CALCULATION: LOWER OF NATURAL OR FINISHED GRADE = 537.875

IMPERVIOUS COVER:

TOTAL SITE COVERAGE:

PROPOSED BUILDING COVERAGE: % OF LOT SIZE:

PROPOSED IMPERVIOUS COVER: % OF LOT SIZE:

EXISTING IMPERVIOUS COVER:

TOTAL SITE AREA: 6,973 SF 45% OF TOTAL SITE AREA: 3,138 SF	ALLOWABLE		
AREA DESCRIPTION	EXISTING SF	NEW/ADDED SF	TOTAL SF
1ST FLOOR CONDITIONED AREA: MAIN HOUSE: SECONDARY HOUSE:	2,053 SF 1,431 SF 622 SF	266 SF 266 SF 0 SF	2,319 SF 1697 SF 622 SF
2ND FLOOR CONDITIONED AREA: MAIN HOUSE: SECONDARY HOUSE:	0 SF (EXCLUDE BELOW) 0 SF 0 SF	557 SF (EXCLUDE BELOW) 557 SF 0 SF	557 SF (EXCLUDE BELOW) 557 SF 0 SF
3RD FLOOR CONDITIONED AREA: BASEMENT: COVERED PARKING (GARAGE): (SEE SELOW) STORAGE BUILDING: COVERED PORCH:	0 SF (EXCLUDE BELOW) 0 SF (EXCLUDE BELOW) 0 SF 183 SF 24 SF (GUEST HOUSE)		0 SF (EXCLUDE BELOW) 0 SF (EXCLUDE BELOW) 0 SF 0 SF 515 SF
TOTAL BUILDING COVERAGE:	2,260 SF	574 SF	2,824 SF
DRIVEWAY: (LOOSE RIVER ROCK @ 100%) SIDEWALKS & CONC STEPS: UNCOVERED CONC. PORCHES, TERRACES: UNCOVERED WOOD STEPS: A/C PADS: OTHER (RET. WALLS/LANDSCAPE EDGING):	77 SF 410 SF 0 SF 0 SF 12 SF 0 SF	0 SF <-232 SF> 0 SF 0 SF 12 SF 0 SF	77 SF 178 SF 0 SF *** SF 24 SF 0 SF

2.759 SF

2.260 SF

2.824 SF

2,759 SF (2,260 SF + 499 S


F.A.R. CALCULATIONS					
TOTAL SITE AREA: 6,973 SF					
40% OF TOTAL SITE AREA: 2,789 SF					
AREA DESCRIPTION	EXISTING SF	NEW SF	EXEMPTION	TOTAL SF	
1ST FLOOR CONDITIONED AREA:					
MAIN HOUSE:	1,431 SF	266 SF		1,697 SF	
SECONDARY HOUSE:	620 SF	0 SF		620 SF	
2ND FLOOR CONDITIONED AREA:	0 SF	557 SF		557 SF	
3RD FLOOR CONDITIONED AREA:	0 SF	0 SF		0 SF	
BASEMENT:	0 SF	0 SF	0 SF	0 SF	
ATTIC:	0 SF	0 SF	0 SF	0 SF	
GARAGE (DETACHED):	0 SF	0 SF	0 SF	0 SF	
CARPORT (ATTACHED):	0 SF	0 SF	0 SF	0 SF	
(DETACHED):	0 SF	0 SF	0 SF	0 SF	
ACCESSORY BUILDINGS*	183 SF	<-183 SF>	0 SF	0 SF	
COVERED (GROUND-FLOOR) PORCH:					
FRONT:	0 SF	0 SF	0 SF	0 SF	
REAR: (NO HABITABLE SPACE ABOVE)	0 SF	491 SF (EXEMPT)	491 SF (EXEMPT)	0 SF (EXEMPT)	
SIDE: (NO HABITABLE SPACE ABOVE)	24 SF (EXEMPT)	0 SF	24 SF	0 SF (EXEMPT)	
TOTALS:	2,236 SF	553 SF		2,874 SF	
TOTAL S.F. = 2,874 SF = .41 F.A.R. (EXCEEDS BY 85 SF)				2,874 SF	



Sheet Name: SITE PLAN

Project: CONNORS
Issue Date: OCT. 28, 2020
Phase: CONSTRUCTION
Drawn By: WB
Date: OCT. 28, 2020

A1.2

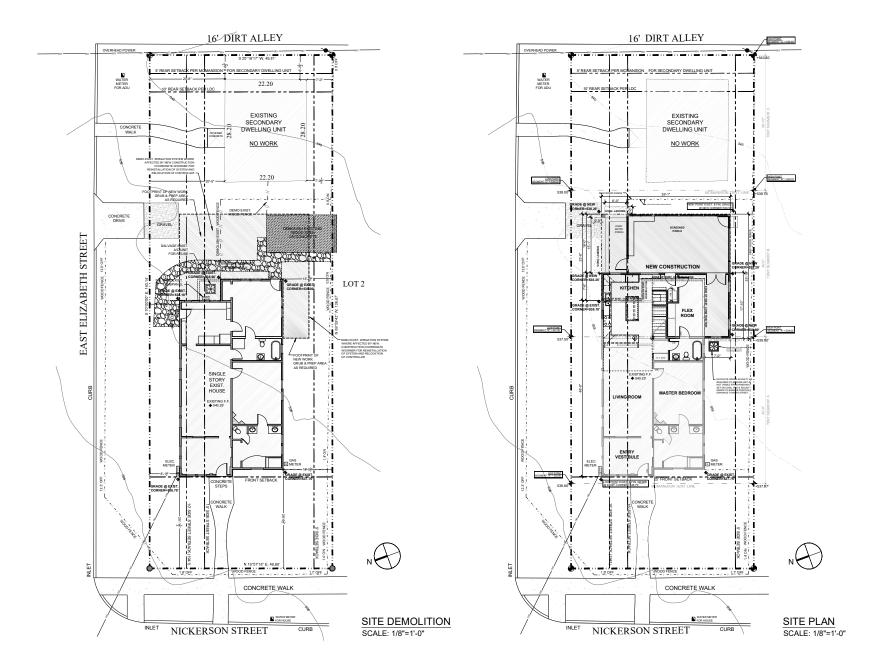


REVISIONS

PLAN DEMO PLAN

Project: CONNORS Issue Date: OCT. 28, 2020 Phase: CONSTRUCTION

Drawn By: WB Date: OCT. 28, 2020

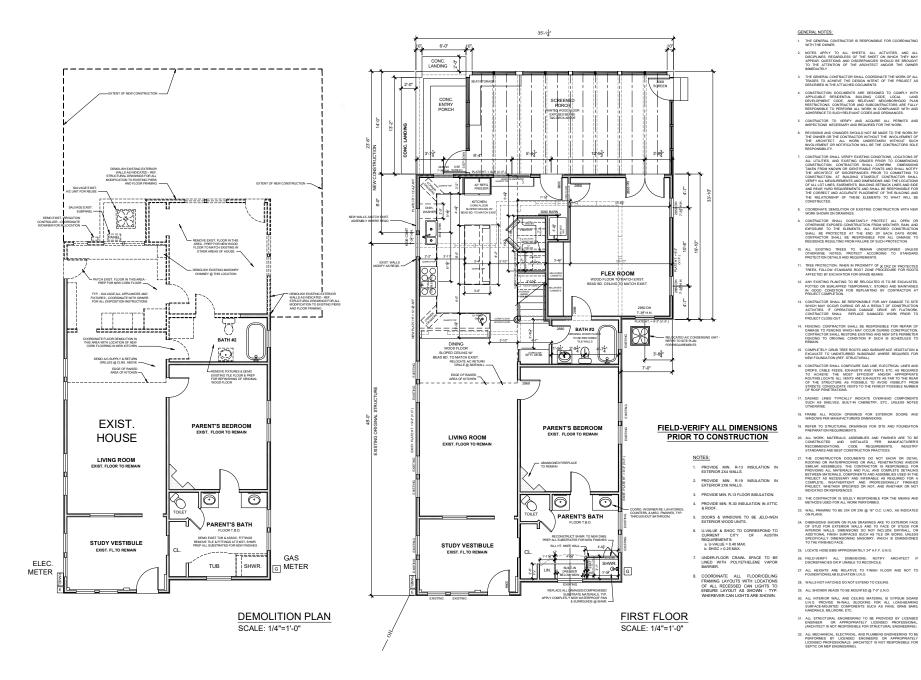


ROOF PLAN

Issue Date: OCT. 28, 2020
Phose: CONSTRUCTION

Drawn By: WB Date: OCT. 28, 2020

A2.2

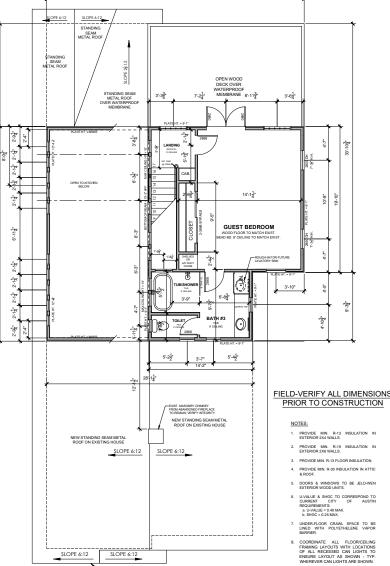

NEW STANDING SEAM METAI ROOF ON EXISTING HOUSE

35'-1¹

SLOPE 2:12 STANDING SEAM METAL ROOF STANDING SEAL METAL ROOF SLOPE 6:12 SLOPE 6:12 SLOPE 6:12 SLOPE 6:12

SLOPE 6:12 SLOPE 6:12

STANDING SEAR METAL ROOF

OPEN WOOD DECK OVER WATERPROOF

SLOPE_6:12

SLOPE 6:12

ROOF PLAN SCALE: 3/16"=1'-0"

GENERAL NOTES:

- THE GENERAL CONTRACTOR IS RESPONSIBLE FOR COORDINATING WITH THE OWNER.
- NOTES APPLY TO ALL SHEETS, ALL ACTIVITIES, AND ALL DISCIPLINES, RECARDLESS OF THE SHEET ON WHICH THEY MAY APPEAR, QUESTIONS AND DISCREPANCIES SHOULD BE BROUGHT TO THE ATTENTION OF THE ARCHITECT AND/OR THE OWNER BAMEDIATED.
- CONSTRUCTION DOCUMENTS ARE DESIGNED TO COMPLY WITH APPLICABLE RESIDENTIA. BUILDING CODE, LOCAL LAND DEVELOPMENT CODE, AND RELEVANT MEDIFISOROGO PLAN RESTRICTIONS. CONTRACTOR AND SUBCONTRACTORS ARE FULLY RESPONSIBLE TO PERFORM ALL WORK IN COMPLIANCE WITH AND ADHERBINGET DUCH RELEVANT CODES AND CORMANCES.
- REVISIONS AND CHANGES SHOULD NOT BE MADE TO THE WORK BY THE OWNER OR THE CONTRACTOR WITHOUT THE INVOLVEMENT OF THE ARCHTECT. ALL WORK WIDERTAKEN WITHOUT SUCH INVOLVEMENT OR NOTIFICATION WILL BE THE CONTRACTORS SOLE RESPONSBLITY.

- CONTRACTOR SHALL CONSTANTLY PROTECT ALL OPEN OR OTHERWISE EXPOSED CONSTRUCTION FROM WEATHER, RAIN, AND EXPOSURE TO THE ELEMENTS, ALL EXPOSED CONSTRUCTION SHALL BE PROTECTED AT THE END OF EACH DAYS WORK, CONTRACTOR SHALL BE RESPONSIBLE FOR ALL DAMAGE TO RESIDENCE BUSINED PROTECTION.
- TREE PROTECTION: WHEN IN PROXIMITY OF X CRZ OF PROTECTED TREES, FOLLOW STANDARD ROOT ZONE PROCEDURE FOR ROOTS AFFECTED BY EXCAVATION FOR GRADE BEAMS.
- ANY EXISTING PLANTING TO BE RELOCATED IS TO BE EXCAVATED.

 POTTED OR BURLAPPED TEMPORARLY, STORED AND MAINTAINED IN GOOD CONDITION FOR REPLANTING BY CONTRACTOR AT PROJECT COMPLETION.
- 14. FENCING: CONTRACTOR SHALL BE RESPONSIBLE FOR REPAIR OF

- FIELD-VERIFY ALL DIMENSIONS 19. REFER TO STRUCTURAL DRAWINGS FOR SITE AND FOUNDATION PREPARATION REQUIREMENTS.
 - 20. ALL WORK, MATERIALS, ASSEMBLIES AND FINISHES ARE TO BE CONSTRUCTED AND INSTALLED PER MANUFACTURER'S RECOMMENDATIONS, CODE REQUIREMENTS, INDUSTRY STANDARDS AND BEST CONSTRUCTION PRACTICES.

 - 22. THE CONTRACTOR IS SOLELY RESPONSIBLE FOR THE MEANS AND METHODS USED FOR ALL WORK PERFORMED.
 - 23. WALL FRAMING TO BE 2X4 OR 2X6 @ 16* O.C. U.NO., AS INDICATED ON PLANS
 - 24. DIMENSIONS SHOWN ON PLAN DRAWINGS ARE TO EXTERIOR FACE OF STUD FOR EXTERIOR WALLS AND TO FACE OF STUDS FOR ADDITIONAL FACE OF STUDS FOR ADDITIONAL FAMILS RANGE SUCH AS THE OR SIDNAL GUARDS STUDY AS THE OWNER OF THE T
 - 25. LOCATE HOSE BIBS APPROXIMATELY 24° A.F.F. U.N.O.
 - 28. FIELD-VERIFY ALL DIMENSIONS; NOTIFY ARCHITECT IF DISCREPANCIES OR IF UNABLE TO RECONCILE.
 - 27. ALL HEIGHTS ARE RELATIVE TO FINISH FLOOR AND NOT TO FOUNDATION/SLAB ELEVATION U.N.O.
 - 28. WALLS NOT HATCHED DO NOT EXTEND TO CEILING.
 - 29. ALL SHOWER HEADS TO BE MOUNTED @ 7:0° U.N.O.

SECOND FLOOR

SCALE: 1/4"=1'-0"


- ALL INTERIOR WALL AND CELING MATERIAL IS GYPSUM BOARD UN O. PROVIDE IN-WALL BLOCKING FOR ALL LOAD-BEARING SURFACE-MOUNTED COMPONITS SUCH AS FANS, GRAB BARS, HANDRAILS, MILLWORK, ETC.
- ALL MECHANICAL, ELECTRICAL, AND PLUMBING ENGINEERING TO BE PERFORMED BY LICENSED ENGINEERS OR APPROPRIATELY LICENSED PROFESSIONALS. (ARCHITECT IS NOT RESPONSIBLE FOR

REVISIONS

Sheet Name: ENLARGED FIRST FLOOR PLAN

A2.3

SCALE: 3/8"=1'-0"

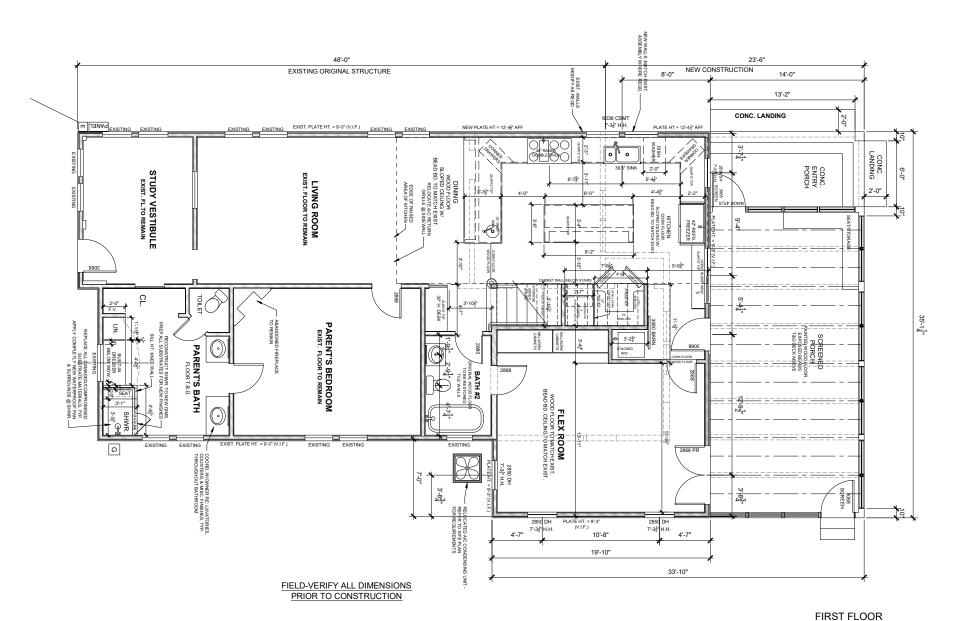






REVISIONS Sheet Name: ENLARGED

SECOND FLOOR PLAN

Project: CONNORS
Issue DeterOCT. 28, 2020
Phase: CONSTRUCTION
Drawn By: WB
Dete: OCT. 28, 2020

A2.4

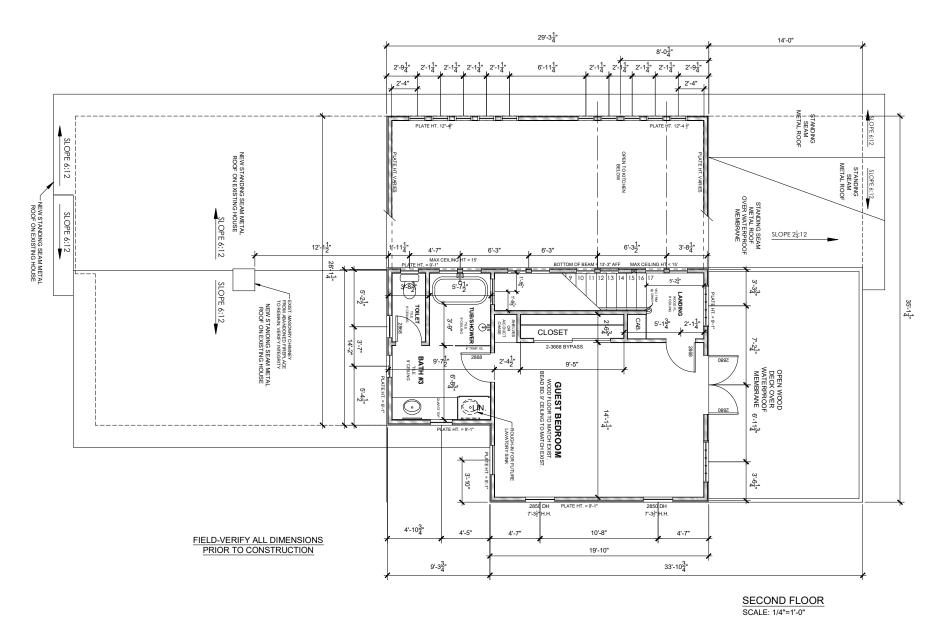

REVISIONS




ELEVATIONS

Project: CONNORS

AVERAGE GRADE = 538.125

536.66' SEGMENT"

A3.1

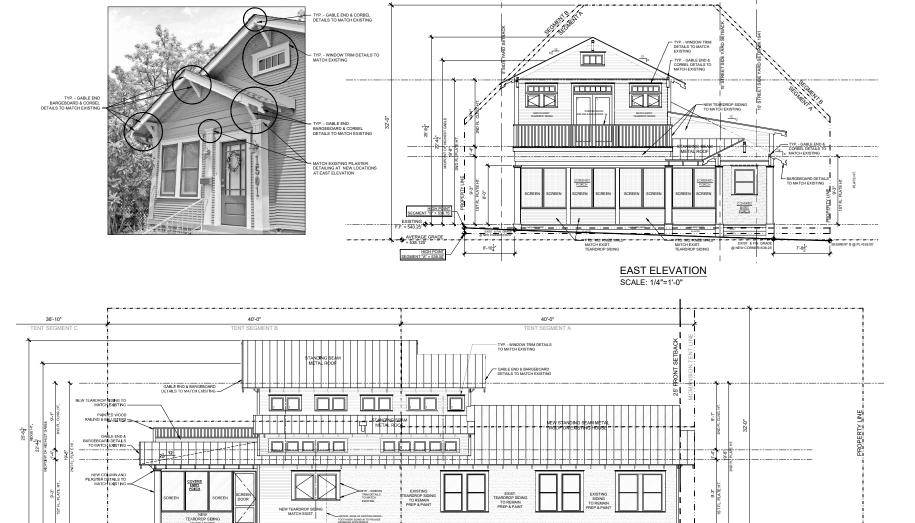

537.50' SEGMENT "A" & "B"

> NORTH ELEVATION SCALE: 1/4"=1'-0"









& WEST ELEVATIONS


Project: CONNORS
Issue Dote: OCT. 28, 2020
Phase: CONSTRUCTION
Drawn By: WB
Date: OCT. 28, 2020

A3.2



SOUTH ELEVATION

SCALE: 1/4"=1'-0"

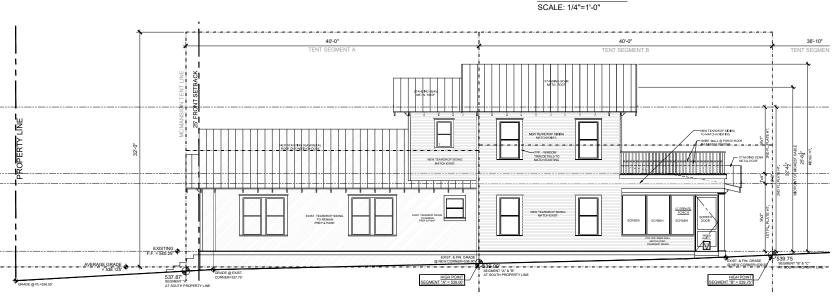


REVISIONS
DATE


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SECTION

Project: CONNORS
Issue Date: OCT. 28, 2020
Phase: CONSTRUCTION
Drawn By: WB
Date: OCT. 28, 2020

A3.3



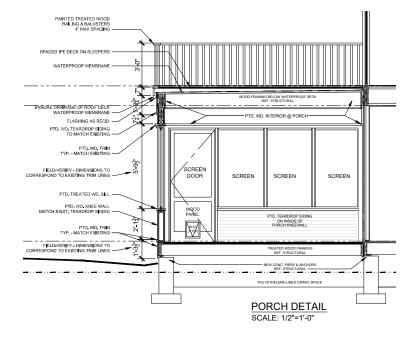

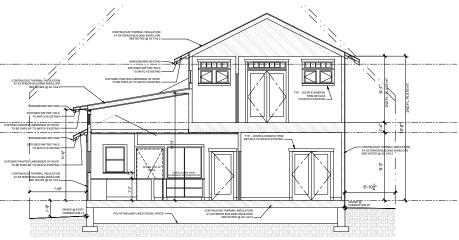
SECTION SCALE: 1/4"=1'-0"






Project: CONNORS
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A3.4



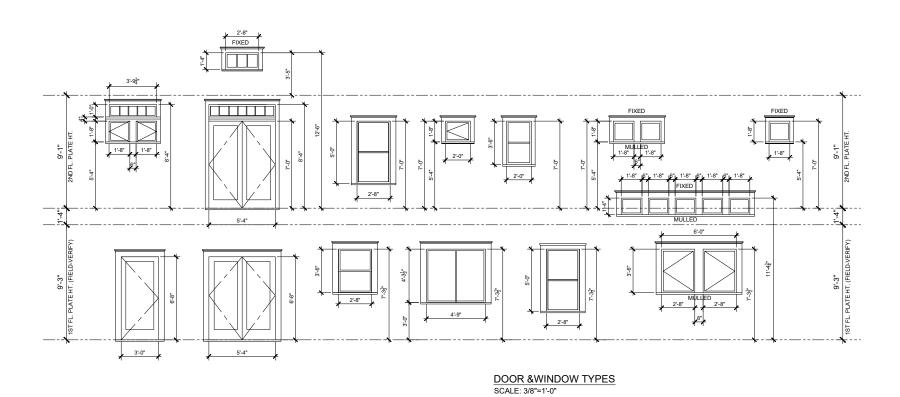




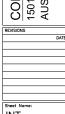



Sheet Name: ELEV'S.


Issue Date: OCT. 28, 2020
Phose: CONSTRUCTION Drawn By: WB
Date: OCT. 28, 2020

A4.1

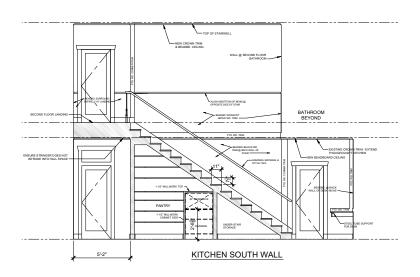

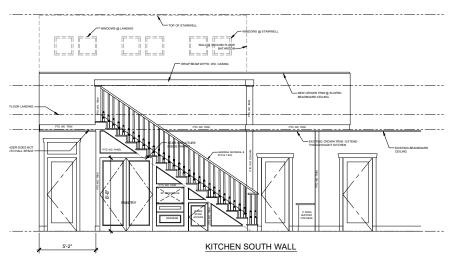

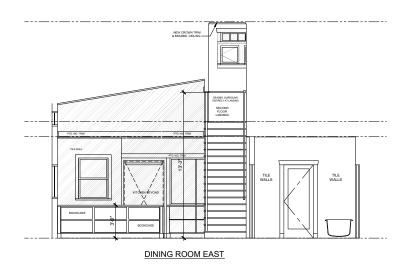

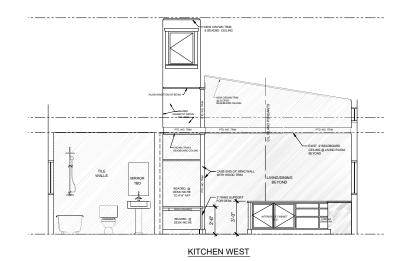

INTERIOR ELEVATIONS SCALE: 3/8"=1'-0"











ELEV'S.


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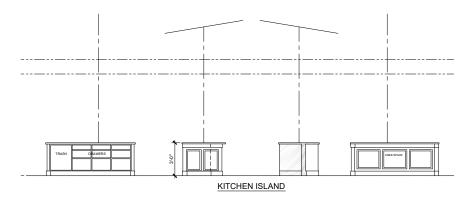
A4.2



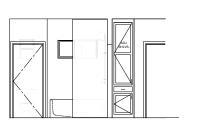

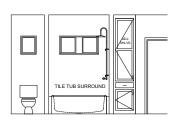
SECOND FLOOR BATHROOM



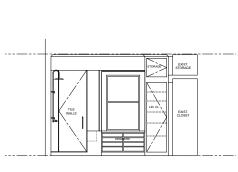

KITCHEN EAST

MAIN BATHROOM

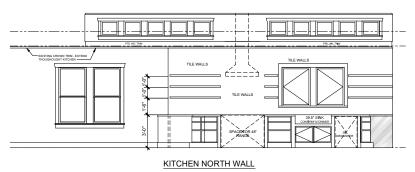



ELECTRICAL SYMBOLS: CEILING SURFACE-MOUNTED FIXTURE RECESSED CEILING LED FIXTURE PENDANT LIGHT FIXTURE WATERPROOF RECESSED CEILING LIGHT FIXTURE

> WALL MOUNTED LIGHT FIXTURE WATERPROOF WALL MOUNTED LIGHT FIXTURE

RECESSED WALL LIGHT FIXTURE DIRECTIONAL RECESSED CEILING LIGHT FIXTURE

■ FLUORESCENT TUBE LIGHT FIXTURE F---- UNDERCABINET STRIP LIGHT FIXTURE UNDERCABINET STRIP RECEPTACLES DUPLEX OUTLET

RECESSED FLOOR LIGHT FIXTURE

GFI DUPLEX OUTLET

220V OUTLET

ILINCTION BOX

ELOOP OLITIET

TELEPHONE JACK

DOORBELL GARBAGE DISPOSAL

EXHAUST FAN

SMOKE DETECTOR

HEAT DETECTOR

ELECTRIC METER

GAS METER

CABLE JACK

ALARM KEYPAD

GARAGE DOOR CONTROLS

1. RECEPTACLE OUTLET LOCATIONS WILL COMPLY WITH NEC. ART. 210-52(A). ALL BRANCH CIRCUITS WILL BE ARC-FAULT CIRCUIT PROTECTED. NEC. ART. 210-12(B). 3. CONTRACTOR TO FURNISH AND INSTALL AND/OR UPGRADE ALL COMPONENTS REQUIRED BY CODE. 4. ALL REQUIRED COMPONENTS ARE THE RESPONSIBILITY OF THE CONTRACTOR. 5. ALL COMPONENTS, WIRING AND CIRCUITING TO MEET ALL THE REQUIREMENTS OF THE NEC AND OF ALL AGENCIES HAVING JURISDICTION OVER THE PROJECT, INCLUDING PROVIDING ADDITIONAL OUTLETS AS REQUIRED BY CODE.

6. OWNER TO REVIEW ALL ROUGH BOX LOCATIONS PRIOR TO INSTALLING CONDUIT AND WIRE.

7. PROVIDE ALL REQUIRED ELECTRICAL POWER, OUTLETS, SWITCHES AND FIXTURES FOR ALL APPLIANCES AND MECHANICAL EQUIPMENT.

ALL OUTDOOR LIGHT FIXTURES SHALL COMPLY WITH APPLICABLE CODES AND REGULATIONS OF AGENCIES HAVING JURISDICTION.

10. HEIGHT OF ALL SWITCHES SHALL BE AT *42" A.F.F. TO THE CENTERINE OF THE SWITCH UNLESS OTHERWISE NOTED (U.O.N.). HEIGHT OF ALL OUTLETS SHALL BE *74 F.F. TO THE CONTERINE OF THE OUTLET UNLESS OTHERWISE NOTED (U.O.N.). NOTED HEIGHTS ARE ABOVE FINSHED PLOOR. LOCATION OF ALL OUTLETS IS TO BE VERFIED WITH INTEROR ELEVATIONS.

11. PROVIDE SMOKE & CARBON MONOXIDE DETECTORS AT ALL LOCATIONS REQUIRED BY CODE. ENSURE COMPLIANCE WITH ALL LIFE-SAFETY CODE REQUIREMENTS.

DOOR CHIME

DATA PORT / MODEM SWITCH

WATERPROOF DUPLEX OUTLET SWITCHED DUPLEX OUTLET

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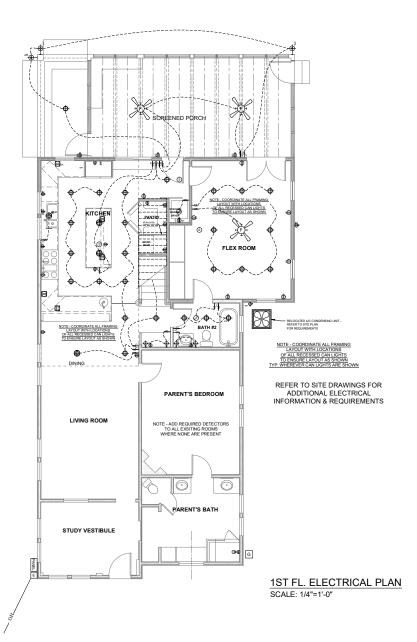
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ELECTRICAL NOTES:

ELECTRICAL PLAN

Project: CONNORS Issue Date: OCT. 28, 2020
Phose: CONSTRUCTION Drawn By: WB Date: OCT. 28, 2020

A5.1





CONNORS - BANK RESIDENCE

1501 NICKERSON AUSTIN TX 78704 REVISIONS

SECOND FLOOR ELECTRICAL


Project: CONNORS Issue Date: OCT. 28, 2020
Phose: CONSTRUCTION

Drawn By: WB

PLAN

Date: OCT. 28, 2020

A5.2

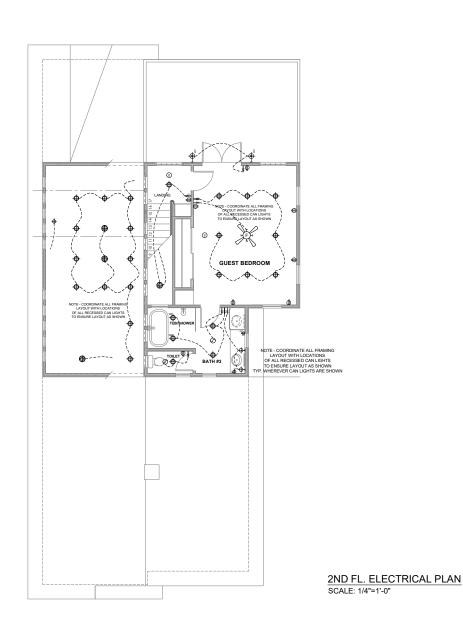

ELECTRICAL SYMBOLS:

Φ CEILING SURFACE-MOUNTED FIXTURE RECESSED CEILING LED FIXTURE PENDANT LIGHT FIXTURE

CEILING FAN WITH LIGHT WATERPROOF RECESSED CEILING LIGHT FIXTURE **ф**... WALL MOUNTED LIGHT FIXTURE

 \oplus WATERPROOF WALL MOUNTED LIGHT FIXTURE **⊢** 모 RECESSED WALL LIGHT FIXTURE

DIRECTIONAL RECESSED CEILING LIGHT FIXTURE ⟨**ф** 0

RECESSED FLOOR LIGHT FIXTURE

■ FLUORESCENT TUBE LIGHT FIXTURE ►---- UNDERCABINET STRIP LIGHT FIXTURE

UNDERCABINET STRIP RECEPTACLES

DUPLEX OUTLET GFI DUPLEX OUTLET

WATERPROOF DUPLEX OUTLET SWITCHED DUPLEX OUTLET

220V OUTLET

JUNCTION BOX FLOOR OUTLET

TELEPHONE JACK DATA PORT / MODEM

DIMMER SWITCH

DOORBELL GARBAGE DISPOSAL

Ø EXHAUST FAN (2) SMOKE DETECTOR

Θ HEAT DETECTOR

CH DOOR CHIME GD GARAGE DOOR CONTROLS

Ε ELECTRIC METER G GAS METER ΗīV CABLE JACK

Α ALARM KEYPAD

ELECTRICAL NOTES:

1. RECEPTACLE OUTLET LOCATIONS WILL COMPLY WITH NEC. ART. 210-52(A).

2. ALL BRANCH CIRCUITS WILL BE ARC-FAULT CIRCUIT PROTECTED. NEC. ART. 210-12(B).

3. CONTRACTOR TO FURNISH AND INSTALL AND/OR UPGRADE ALL COMPONENTS REQUIRED BY CODE.

4. ALL REQUIRED COMPONENTS ARE THE RESPONSIBILITY OF THE CONTRACTOR. 5. ALL COMPONENTS, WIRING AND CIRCUITING TO MEET ALL THE REQUIREMENTS OF THE NEC AND OF ALL AGENCIES HAVING JURISDICTION OVER THE PROJECT, INCLUDING PROVIDING ADDITIONAL OUTLETS AS REQUIRED BY CODE.


6. OWNER TO REVIEW ALL ROUGH BOX LOCATIONS PRIOR TO INSTALLING CONDUIT AND WIRE.


PROVIDE ALL REQUIRED ELECTRICAL POWER, OUTLETS, SWITCHES AND FIXTURES FOR ALL APPLIANCES AND MECHANICAL EQUIPMENT.


8. GROUND FAULT PROTECTION IS REQUIRED FOR ALL RECEPTACLES WITHIN 6 FEET OF ANY WATER SOURCES.

10. HEIGHT OF ALL SWITCHES ANALL BE AT +42" AFF, TO THE CENTERLINE OF THE SWITCH UNLESS OTHERWISE NOTED (ILON.). HEIGHT OF ALL OUTLIETS SHALL BE +9" AFF, TO THE CENTERLINE OF THE OUTLIET UNLESS OTHERWISE NOTED (ILON.). NOTED HEIGHTS ARE ABOVE PINSHED FLOOR, LOCATION OF ALL OUTLIETS IS TO BE VERFIED WITH INTEROR ELEVATIONS.

11. PROVIDE SMOKE & CARBON MONOXIDE DETECTORS AT ALL LOCATIONS REQUIRED BY CODE. ENSURE COMPLIANCE WITH ALL LIFE-SAFETY CODE REQUIREMENTS

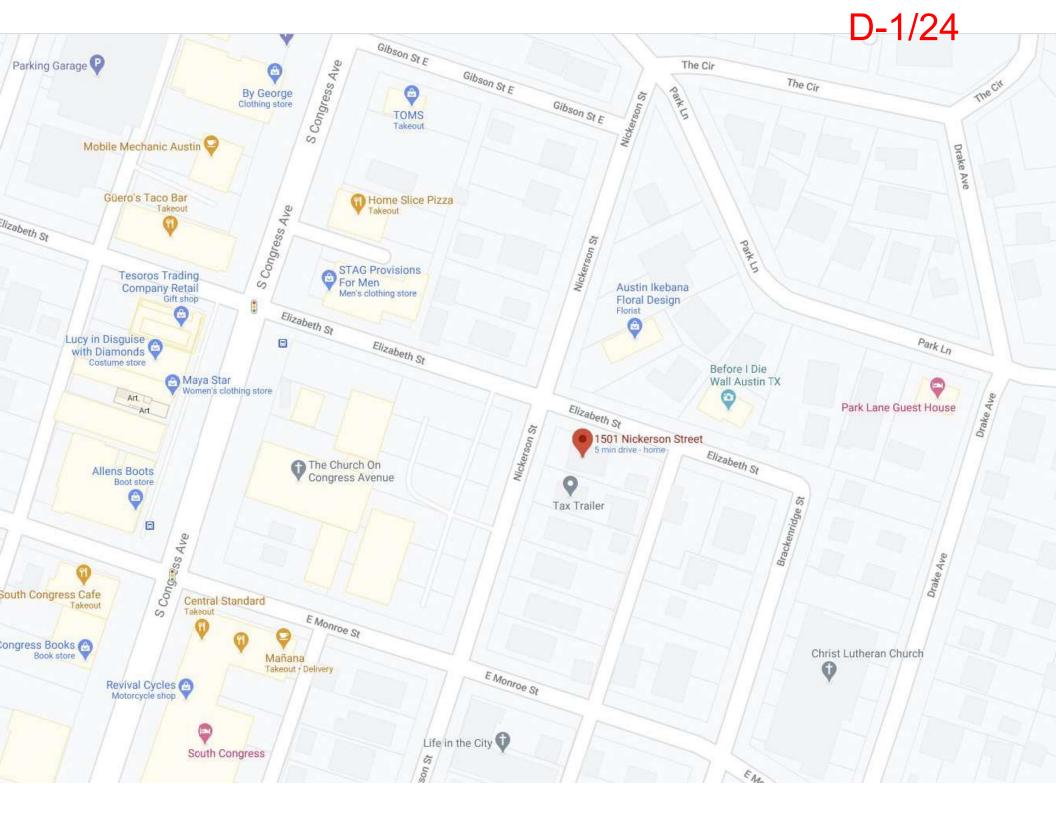

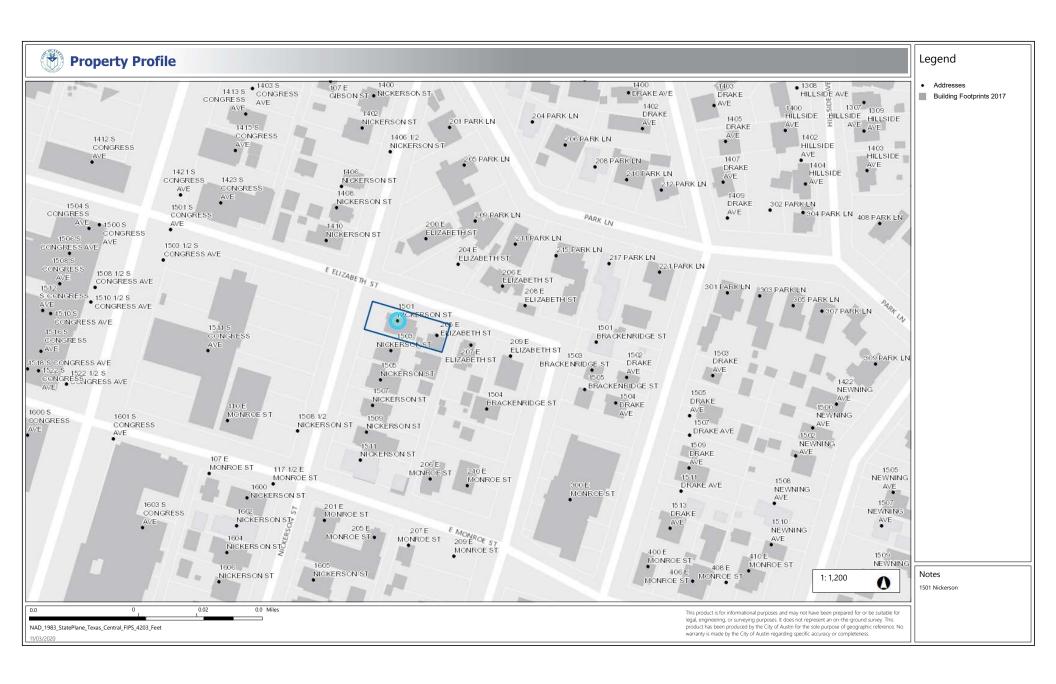

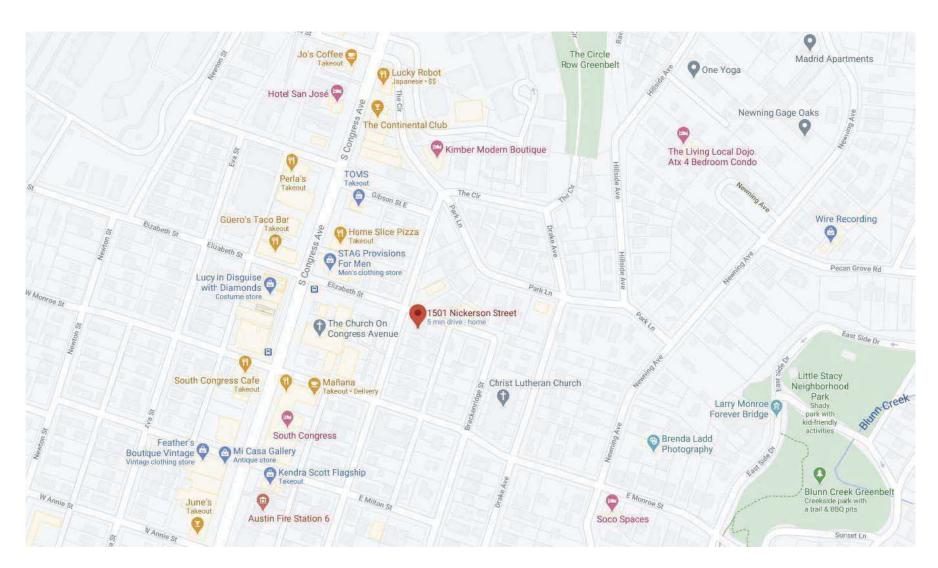

CONTEXT MAP

