
KINGSBURY COMMONS - SUPPORT BUILDINGS

CONCEPT RENDERING

FOR REFERENCE ONLY

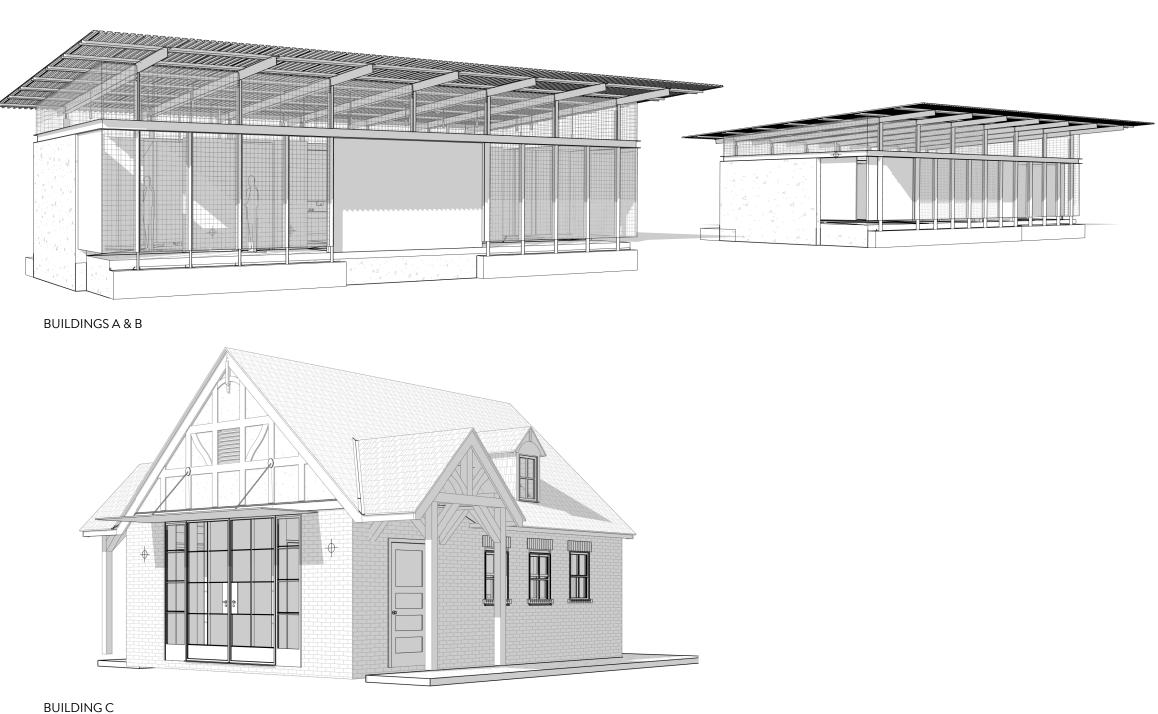



SYMBOL LEGEND

1/A3.0	ELEVATION	ROOM NAME 1.01 200 SF	ROOM NAME NUMBER AREA
A3.0	BUILDING SECTION	(1.01)	DOOR NUMBER
1 A3.0	WALL SECTION	1.01	WINDOW TYPE
A3.0	SECTION DETAIL	A1	PARTITION TYPE
A3.0	DETAIL	⟨AB⟩	PLUMBING FIXTURE TYPE
		TA-1	TOILET ACCESSORY TYPE

ZONING & CODE ANALYSIS

BUILDING A		BUILDING B		BUILDING C	
LEGAL DESCRIPTION	42.26 AC OF OLT 8 DIVISION Z AND 12.85 AC OF OLT 12&13 DIVISION E.	LEGAL DESCRIPTION	42.26 AC OF OLT 8 DIVISION Z AND 12.85 AC OF OLT 12&13 DIVISION E.	LEGAL DESCRIPTION	42.26 AC OF OLT 8 DIVISION Z AND 12.85 AC OF OLT 12&13 DIVISION E.
BUILDING CODES	2015 INTERNATIONAL BUILDING CODE 2015 INTERNATIONAL MECHANICAL CODE 2015 INTERNATIONAL PLUMBING CODE 2014 NATIONAL ELECTRIC CODE 2015 INTERNATIONAL ENERGY CONSERVATION CODE UNIFIED DEVELOPMENT CODE	BUILDING CODES	2015 INTERNATIONAL BUILDING CODE 2015 INTERNATIONAL MECHANICAL CODE 2015 INTERNATIONAL PLUMBING CODE 2014 NATIONAL ELECTRIC CODE 2015 INTERNATIONAL ENERGY CONSERVATION CODE UNIFIED DEVELOPMENT CODE	BUILDING CODES	2015 INTERNATIONAL BUILDING CODE 2015 INTERNATIONAL MECHANICAL CODE 2015 INTERNATIONAL PLUMBING CODE 2014 NATIONAL ELECTRIC CODE 2015 INTERNATIONAL ENERGY CONSERVATION CODE UNIFIED DEVELOPMENT CODE
BUILDING DESCRIPTION	STEEL FRAMED PUBLIC RESTROOMS	BUILDING DESCRIPTION	STEEL FRAMED STORAGE BUILDING	BUILDING DESCRIPTION	HISTORIC TUDOR COTTAGE, ASSEMBLY SPACE. ADAPTIVE REUSE OF HISTORIC TUDOR COTTAGE
LEGAL JURISDICTION	CITY OF AUSTIN, TRAVIS COUNTY, TEXAS	LEGAL JURISDICTION	CITY OF AUSTIN, TRAVIS COUNTY, TEXAS	LEGAL JURISDICTION	CITY OF AUSTIN, TRAVIS COUNTY, TEXAS
OCCUPANCY CLASSIFICATION	I GROUP B	OCCUPANCY CLASSIFICATION	GROUP S-2	OCCUPANCY CLASSIFICATION	GROUP B
TYPE OF CONSTRUCTION	II-B	TYPE OF CONSTRUCTION	II-B	TYPE OF CONSTRUCTION	V-B
FIRE SPRINKLER	NOT REQUIRED PER 903.2.1.3	FIRE SPRINKLER	NOT REQUIRED PER 903.2.1.3	FIRE SPRINKLER	NOT REQUIRED PER 903.2.1.3

GENERAL NOTES

MAINTENANCE ARE PROVIDED.

1. ALL WORK SHALL BE IN CONFORMANCE WITH APPLICABLE BUILDING CODES, AND TO INCLUDE ALL REQUIREMENTS OF OTHER AGENCIES HAVING JURISDICTION.

2. EXAMINATION OF THE SITE AND PORTIONS THEREOF THAT AFFECT THIS WORK SHALL BE MADE BY THE GENERAL CONTRACTOR, WHO SHALL COMPARE EXISTING CONDITIONS WITH THE CONTRACT DOCUMENTS AND SATISFY HIM/HERSELF AS TO THE EXISTING CONDITIONS UNDER WHICH WORK IS TO BE PERFORMED. CONTRACTOR SHALL AT SUCH TIME ASCERTAIN AND VERIFY THE LOCATIONS OF EXISTING STRUCTURES.

3. THE CONTRACT DOCUMENTS DESCRIBE DESIGN INTENT, AND ARE NOT INTENDED TO BE ALL INCLUSIVE. CONTRACTOR IS RESPONSIBLE FOR MEANS AND METHODS TO PROVIDE COMPLETE OPERATIONAL SYSTEMS AND INSTALLATIONS. NO CLAIMS FOR ADDITIONAL WORK WILL BE AWARDED FOR WORK WHICH IS DESCRIBED IN THESE DOCUMENTS OR WHICH IS REASONABLY INFERABLE FROM THEM.

4. CONTRACTOR SHALL BE RESPONSIBLE FOR THOROUGH COORDINATION OF TRADES. ALL CLAIMS FOR ADDITIONAL WORK WILL NOT BE AWARDED FOR ANY AND ALL WORK RELATED TO SUCH COORDINATION.

5. CONTRACTOR SHALL VERIFY ALL DIMENSIONS, ELEVATIONS, AND CONDITIONS AT THE SITE, CONFIRM THAT THE WORK IS BUILDABLE AS SHOWN, AND NOTIFY THE ARCHITECT IN WRITING OF ANY DISCREPANCIES PRIOR TO PROCEEDING WITH ANY AND ALL WORK IN QUESTION.

6. ALL DIMENSIONS ARE TO FINISH FACE OF CONCRETE, CENTERLINE OF STEEL, FACE OF STUD OR CASEWORK UNLESS NOTED OTHERWISE. DIMENSIONS NOTED AS "CLR" MUST BE PRECISELY MAINTAINED. DIMENSIONS ARE NOT ADJUSTABLE WITHOUT ARCHITECTS APPROVAL UNLESS NOTED AS "+/-". VERIFY DIMENSIONS MARKED "V.I.F." PRIOR TO COMMENCEMENT OF CONSTRUCTION, AND NOTIFY ARCHITECT OF ANY INCONSISTENCIES.

7. ALL DIMENSIONS, NOTES AND DETAILS SHOWN ON ONE PORTION OF A DRAWING SHALL APPLY TYPICALLY TO ALL OPPOSITEHAND AND/OR CONDITIONS UNLESS OTHERWISE NOTED.

8. "ALIGN" SHALL MEAN TO ACCURATELY LOCATE FINISH FACES IN THE SAME PLANE.

9. THE CONTRACT DOCUMENTS ARE COMPLIMENTARY. WHAT IS SHOWN OR REFERRED TO PARTIALLY OR WHOLE ON ANY SHALL BE PROVIDED AS THOUGH SHOWN ON ALL.

10. DO NOT SCALE DRAWINGS. DIMENSIONS SHALL GOVERN. DRAWINGS AT A LARGE SCALE SHALL TAKE PRECEDENCE OVER DRAWINGS OF A SMALL SCALE. DETAILS SHALL GOVERN OVER PLANS AND ELEVATIONS.

11. CONTRACTOR SHALL VERIFY LAYOUT OF PARTITIONS, DOORS, ELECTRICAL OUTLETS, DATA AND TELEPHONE OUTLETS, LIGHT FIXTURES, AND SWITCHES WITH ARCHITECT PRIOR TO PROCEEDING WITH CONSTRUCTION. CONTRACTOR SHALL VERIFY THAT NO CONFLICTS EXIST IN LOCATIONS OF ANY MECHANICAL, TELEPHONE, DATA, ELECTRICAL, LIGHTING, PLUMBING, AND SPRINKLER EQUIPMENT (TO INCLUDE BUT NOT LIMITED TO ALL PIPING, DUCTWORK AND CONDUIT AND THAT ALL REQUIRED CLEARANCES FOR INSTALLATION AND

12. DAMAGE TO NEW AND EXISTING MATERIALS, FINISHES, STRUCTURES AND EQUIPMENT SHALL BE REPAIRED OR REPLACED TO THE SATISFACTION OF THE OWNER AT THE EXPENSE OF THE CONTRACTOR.

13. ALL WORK LISTED, SHOWN OR IMPLIED ON ANY CONTRACT DOCUMENT SHALL BE SUPPLIED AND INSTALLED BY THE CONTRACTOR, EXCEPT WHERE NOTED OTHERWISE.

14. IN CASE OF CONFLICTS BETWEEN ARCHITECT'S AND ENGINEER'S DRAWINGS IN THE LOCATION OF MATERIALS AND/OR EQUIPMENT, ARCHITECTURAL DRAWINGS SHALL GOVERN. THE CONTRACTOR SHALL NOTIFY THE ARCHITECT IMMEDIATELY OF SUCH CONFLICT.

15. ALL MANUFACTURED ARTICLES, MATERIALS AND EQUIPMENT SHALL BE INSTALLED, CONNECTED, ERECTED CLEANED, AND CONDITIONED PER THE MANUFACTURER'S INSTRUCTIONS. IN CASE OF DIFFERENCES BETWEEN MANUFACTURER'S INSTRUCTIONS AND THE CONTRACT DOCUMENTS, THE CONTRACTOR SHALL NOTIFY THE ARCHITECT BEFORE PROCEEDING WITH THE WORK IN QUESTION.

16. ALL WORK NOTED AS "BY OTHERS" OR "N.I.C." SHALL BE PROVIDED BY OWNER OR UNDER SEPARATE CONTRACT. SUBMIT TO THE ARCHITECT AND OWNER SCHEDULE REQUIREMENTS FOR THIS "OTHER" WORK IN THE CONSTRUCTION PROGRESS SCHEDULE AND COORDINATE AS REQUIRED TO ASSURE ORDERLY SEQUENCE OF INSTALLATION.

17. THE CONTRACTOR SHALL REMOVE ALL RUBBISH AND WASTE MATERIALS OF ALL SUBCONTRACTORS AND TRADES ON A DAILY BASIS AND SHALL EXERCISE STRICT CONTROL OVER JOB CLEANING TO PREVENT ANY DIRT, DEBRIS, OR DUST FROM AFFECTING ANY FINISHED AREAS IN OR OUTSIDE THE JOB SITE. BURNING OF DEBRIS ON SITE SHALL NOT BE PERMITTED.

18. CONTRACTOR SHALL NOT PROCEED WITH ANY WORK REQUIRING ADDITIONAL COMPENSATION BEYOND THE CONTRACT AMOUNT WITHOUT AUTHORIZATION FROM THE ARCHITECT OR OWNER'S REPRESENTATIVE. FAILURE TO OBTAIN AUTHORIZATION SHALL INVALIDATE ANY CLAIM FOR ADDITIONAL COMPENSATION.

HISTORICAL NOTES

DISCREPENCIES THAT MAY ARISE.

1. THIS IS A HISTORICALLY CONTRIBUTING STRUCTURE, AND PRESERVATION IS EXTREMELY IMPORTANT. EXTREME CARE SHALL BE TAKEN TO PROTECT AND PRESERVE THIS STRUCTURE DURING SELECTIVE DEMOLITION AND CONSTRUCTION. IF ANY UNFORESEEN CONDITIONS ARISE, STOP WORK AND CONTACT THE ARCHITECT IMMEDIATELY.

2. ALL EXISTING COMPONENTS TO REMAIN ARE TO BE PROTECTED DURING DEMOLITION AND CONSTRUCTION BY THE GENERAL CONTRACTOR. ANY DAMAGED MATERIAL IS TO BE REPAIRED, REPLACED OR REBUILT IN A MANNER ACCEPTABLE TO THE OWNER AND ARCHITECT.

3. DEMOLITION PHASE: THIS STAGE IS CRITICAL TO THE SUCCESS OF THIS PROJECT AND MUST BE CONSIDERED A STAGE OF DISCOVERY. EXTREME CARE MUST BE TAKEN, ESPECIALLY IN AREAS OF QUESTION TO NOT DESTROY ORIGINAL MATERIALS. RECKLESS DESTRUCTION OF SALVAGEABLE, RE-USABLE ORIGINAL MATERIALS WILL NOT BE ALLOWED AND CM/GC WILL BE RESPONSIBLE FOR REPLACEMENT OF DAMAGED MATERIALS.

4. IT IS OUR INTENTION THAT ALL WORK CONFORM TO THE SECRETARY OF THE INTERIORS STANDARDS FOR THE TREATMENT OF HISTORICAL PROPERTIES. GC TO BE FAMILIAR WITH THESE STANDARDS AND NOTIFY ARCHITECT OF ANY

CLAYTON & LITTLE

PRELIMINARY NOT FOR CONSTRUCTION

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ISSUED DATE PROJECT NUMBER

KINGSBURY COMMONS

1100 Kingsbury Street Austin, TX 78705

LANDSCAPE ARCHITECT TEN EYCK LANDSCAPE ARCHITECTS 1214 WEST SIXTH STREET, SUITE 100

ARCHITECT - TUDOR COTTAGE, TERRACE, RESTROOM

CLAYTON & LITTLE 2201 N. LAMAR BLVD. AUSTIN, TX 78705 512 477 1727 P ARCHITECT - TREEHOUSE MELL LAWRENCE ARCHITECTS 913 W. GIBSON ST.

512 441 4669 P CIVIL ENGINEER GARZA EMC 7708 RIALTO BLVD. SUITE 125

AUSTIN, TX 78735 512 298 3284 P GRAPHICS AND WAYFINDING DESIGNER PAGE/DYAL BRANDING AND GRAPHICS

400 W. CESAR CHAVEZ ST., SUITE 500 AUSTIN, TX 78701 512 382 3580 P IRRIGATION DESIGNER

3000 JOE DIMAGGIO BLVD. BLDG., 1700 SUITE 61 ROUND ROCK, TX 78665 512 306 9350 P

LIGHTING DESIGNER 9411 CHAPEL DOWN ST. AUSTIN, TX 78729

STRUCTURAL ENGINEER

ARCHITECTURAL ENGINEERS COLLABORATIVE 3800 N. LAMAR BLVD., SUITE 330 MEP ENGINEER

512 382 1656 P

JERRY GARZA & ASSOCIATES 1146 OYSTER CREEK 512 523 8000 P WATER FEATURE DESIGNER

972 446 0037 P

PHASE: CONSTRUCTION DOCUMENTS


DATE	ISSUE
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08/31/2018	50% DESIGN DEVELOP
10/18/2018	100% DESIGN DEVELO
12/20/2018	50% CD
02/07/2019	90% CD
03/29/2019	95% CD
06/28/2019	100% CD

DATE: 09.12.2019

DRAWN: CHECKED:

TELA PROJECT NO: 1832 DRAWING TITLE:

COVER SHEET

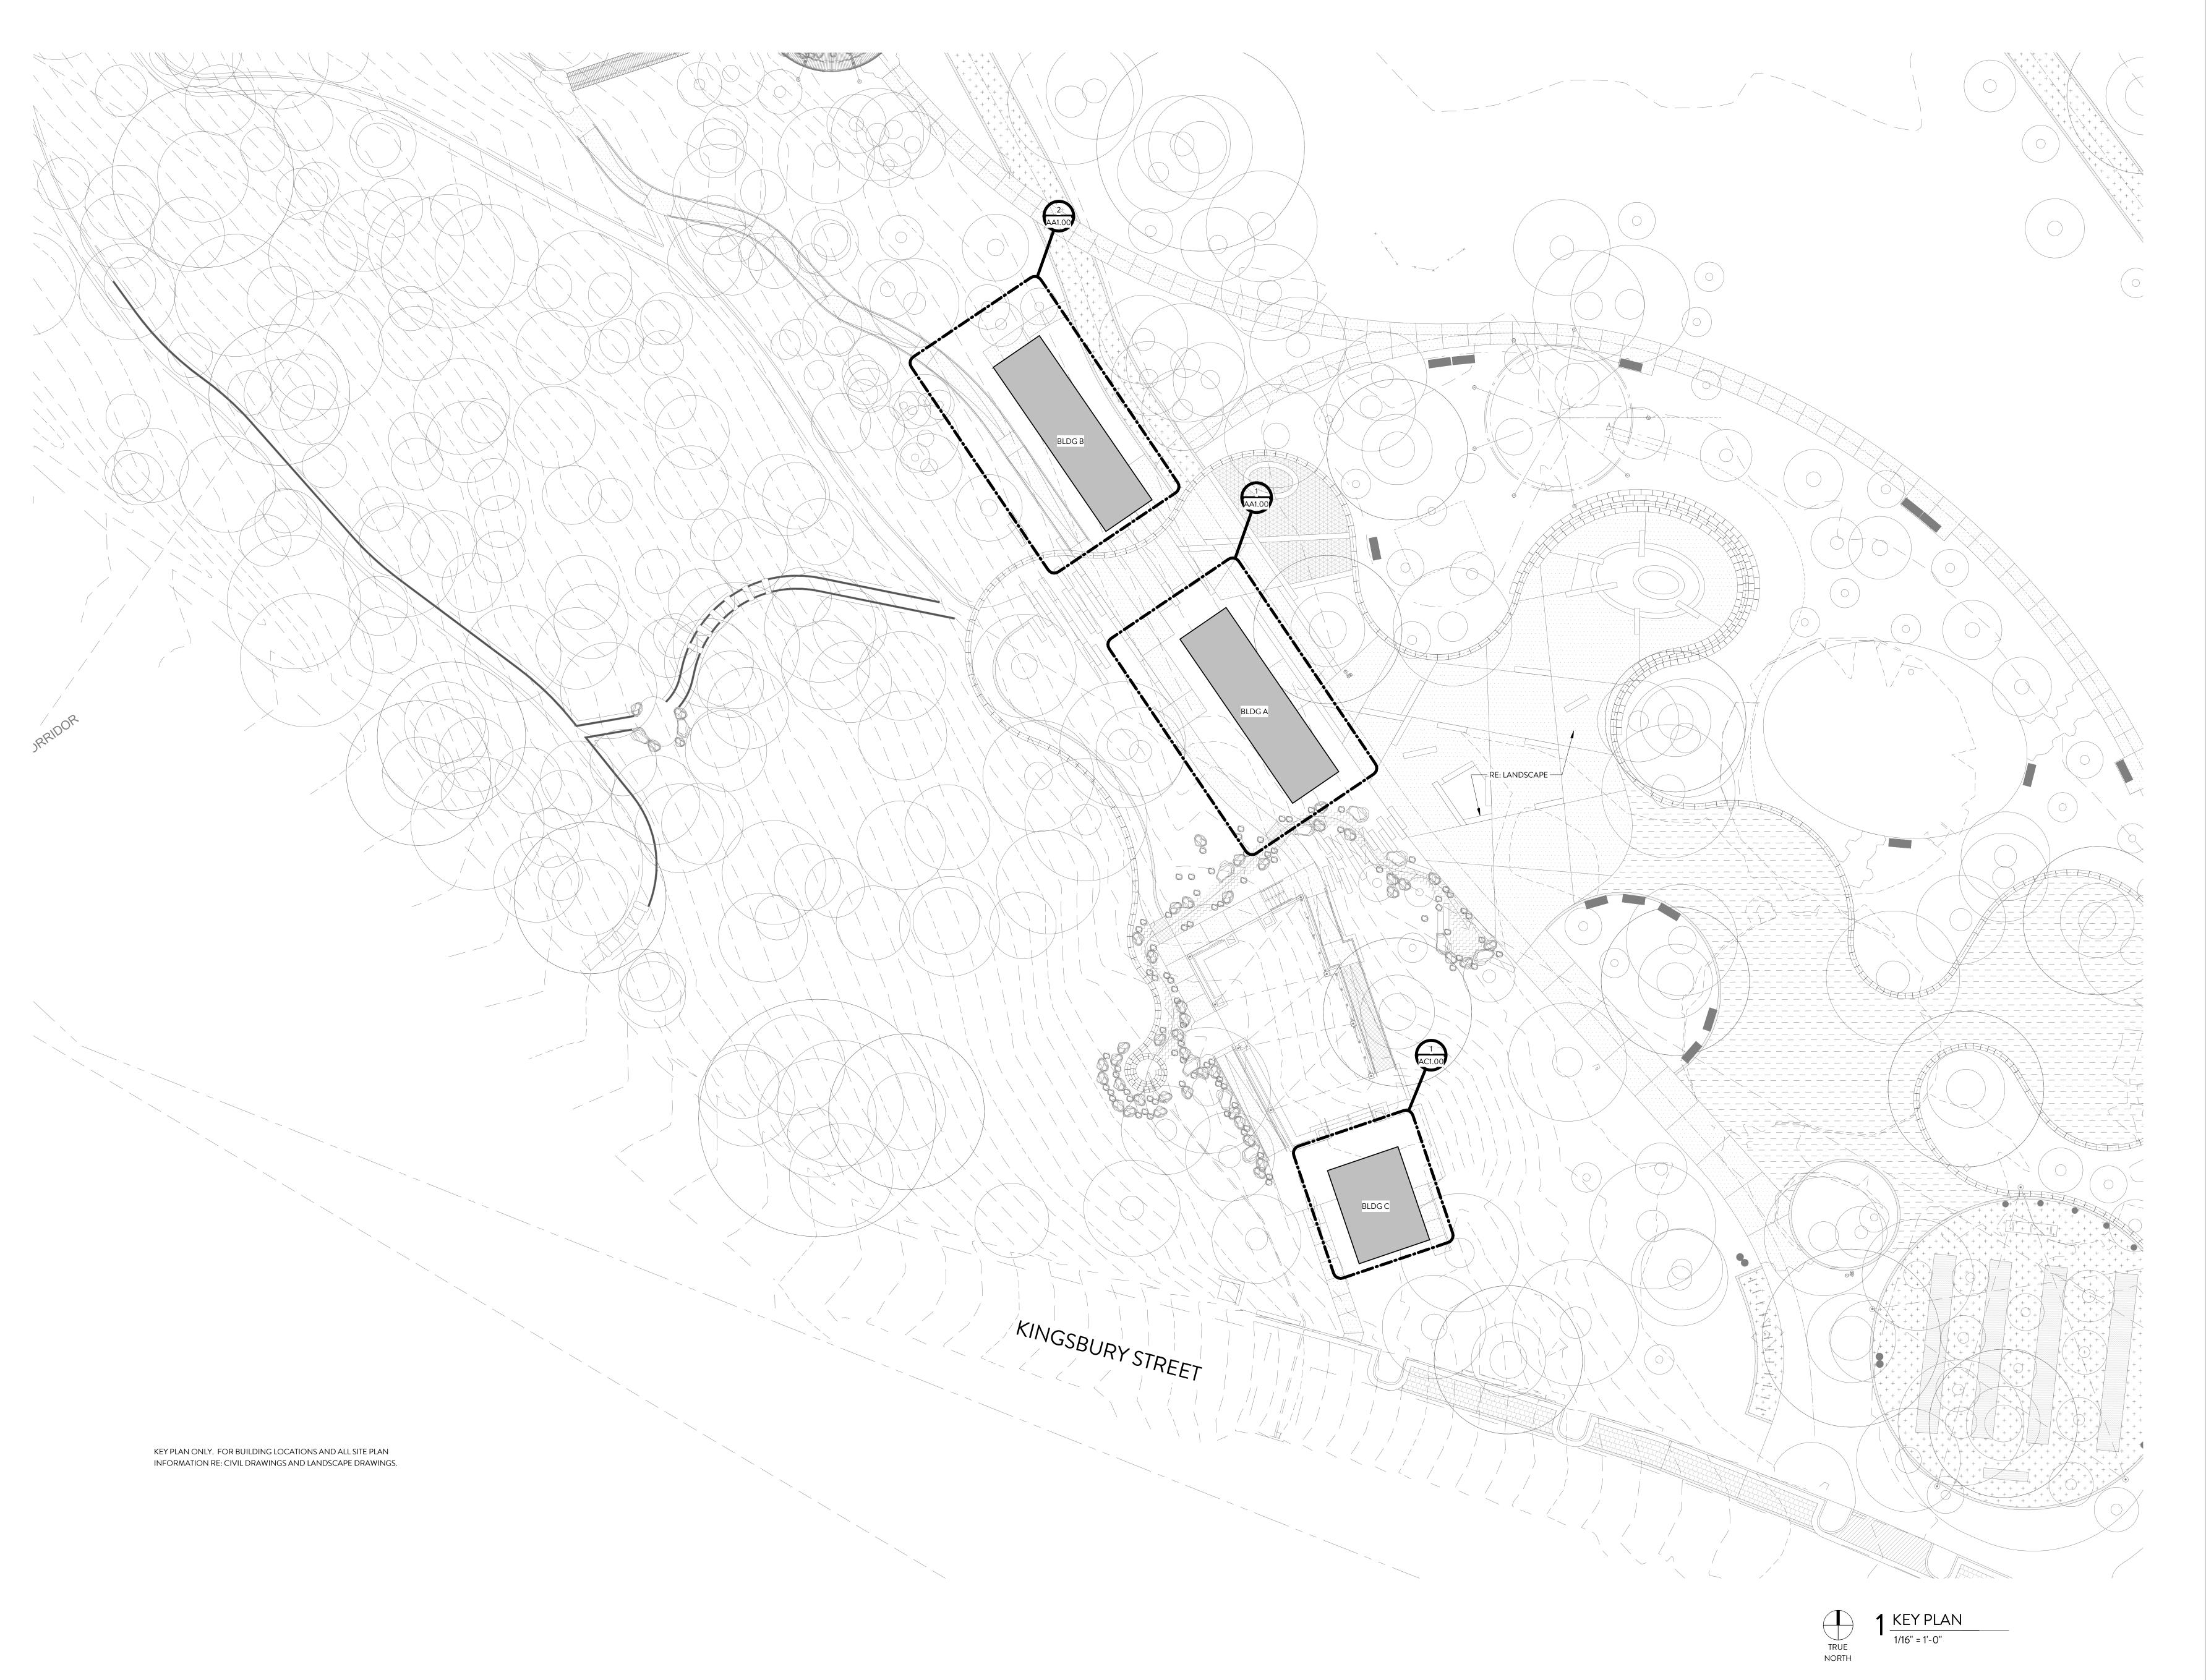

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ISSUED DATE 09.12.2019 PROJECT NUMBER 1832

KINGSBURY COMMONS

1100 Kingsbury Street Austin, TX 78705

LANDSCAPE ARCHITECT
TEN EYCK LANDSCAPE ARCHITECTS
1214 WEST SIXTH STREET, SUITE 100
AUSTIN, TX 78703
512 813 9999 P

ARCHITECT - TUDOR COTTAGE, TERRACE, RESTROOM CLAYTON & LITTLE 2201 N. LAMAR BLVD. AUSTIN, TX 78705 512 477 1727 P

ARCHITECT - TREEHOUSE MELL LAWRENCE ARCHITECTS 913 W. GIBSON ST. AUSTIN, TX 78704 512 441 4669 P

CIVIL ENGINEER GARZA EMC 7708 RIALTO BLVD. SUITE 125 AUSTIN, TX 78735 512 298 3284 P

GRAPHICS AND WAYFINDING DESIGNER
PAGE/DYAL BRANDING AND GRAPHICS
400 W. CESAR CHAVEZ ST., SUITE 500
AUSTIN, TX 78701
512 382 3580 P

IRRIGATION DESIGNER

SWEENEY + ASSOCIATES 3000 JOE DIMAGGIO BLVD. BLDG., 1700 SUITE 61 ROUND ROCK, TX 78665 512 306 9350 P

LIGHTING DESIGNER STUDIO LUMINA 9411 CHAPEL DOWN ST. AUSTIN, TX 78729 512 382 1656 P

STRUCTURAL ENGINEER
ARCHITECTURAL ENGINEERS COLLABORATIVE
3800 N. LAMAR BLVD., SUITE 330
AUSTIN, TX 78756
512 472 2111 P

MEP ENGINEER
JERRY GARZA & ASSOCIATES
1146 OYSTER CREEK
BUDA, TX 78610
512 523 8000 P

WATER FEATURE DESIGNER GPSI 1425 WHITLOCK LANE, SUITE 108 CARROLLTON, TX 75006 972 446 0037 P

PHASE: CONSTRUCTION DOCUMENTS

100% SCHEMATIC DESIGN
50% DESIGN DEVELOPMENT
100% DESIGN DEVELOPMENT


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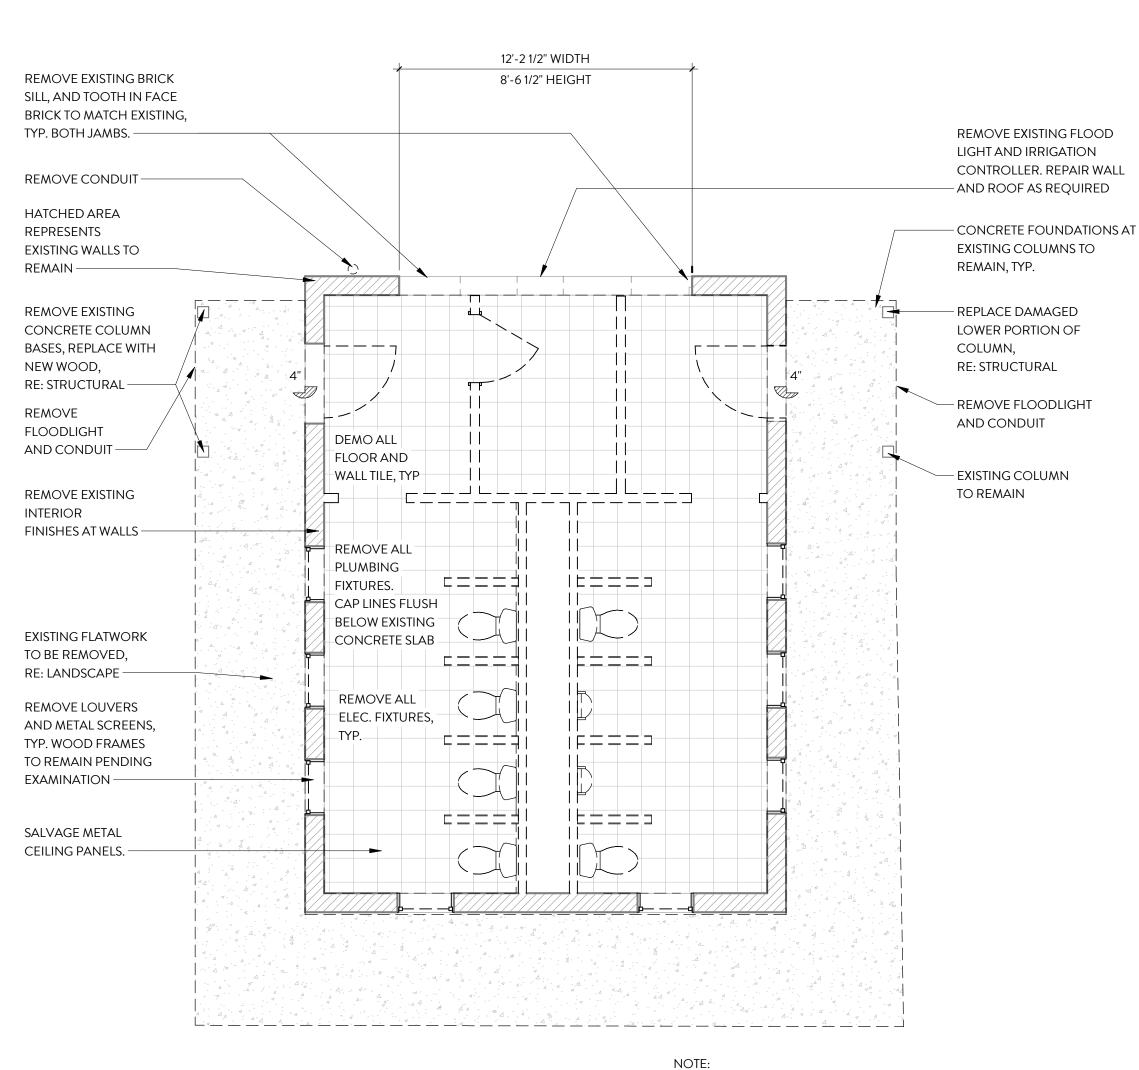
TELA PROJECT NO: 1832

DRAWING TITLE: ARCHITECTURAL KEY PLAN


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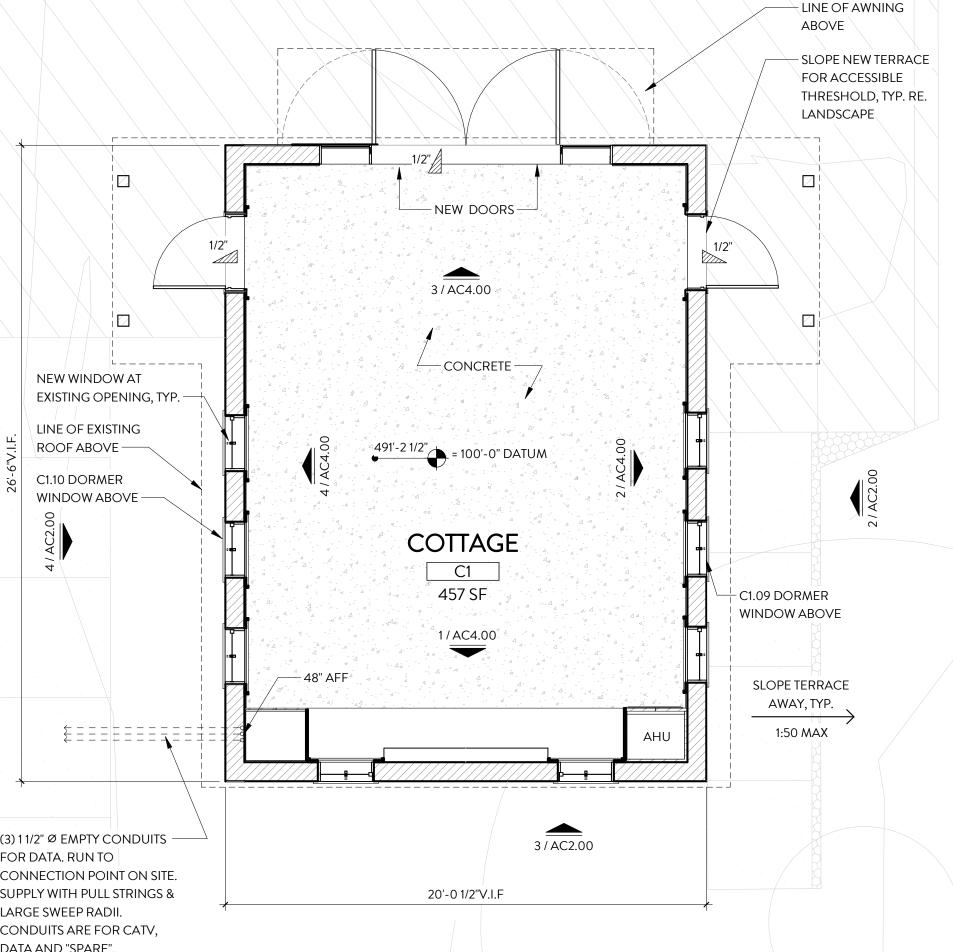




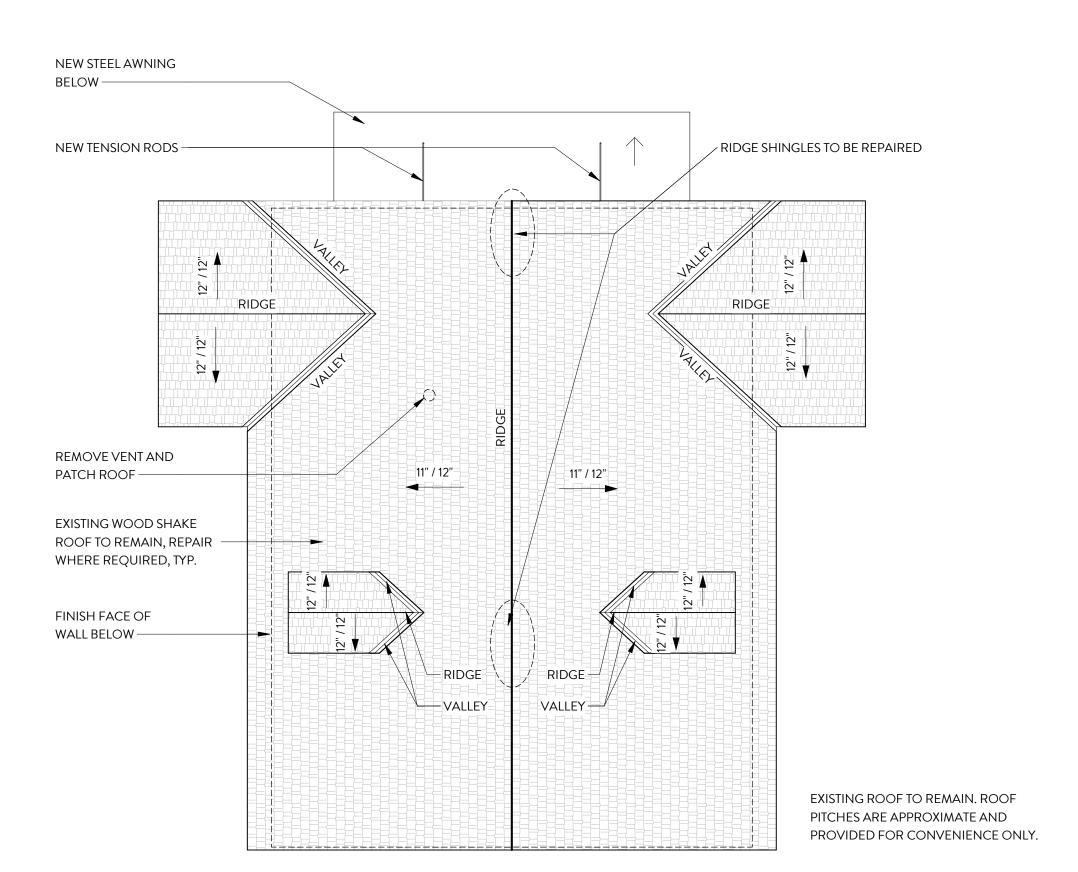

TRUE



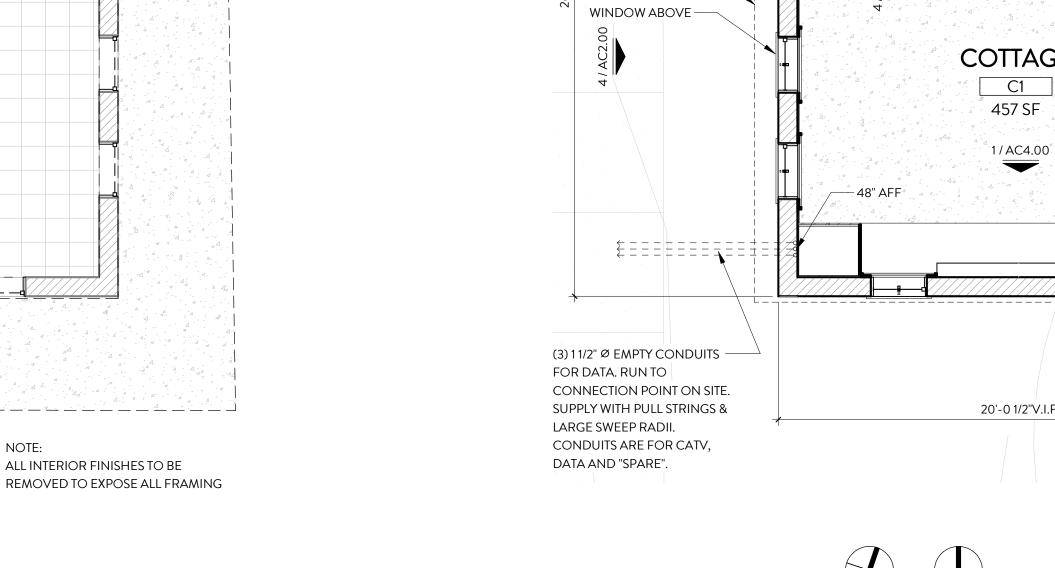

14'-10"

NEW VAULTED

PROJECT

NORTH

TRUE

NORTH

CEILING —

ASTRONOMICAL

LIGHT SWITCH.

GENERAL NOTES

— THERMOSTAT TO BE

LOCATED 4" ABOVE

LIGHT SWITCH BANK

- NEW STEEL COLLAR TIES

IMMEDIATELY ADJACENT

TO DORMER OPENING

RE: STRUCTURAL, TYP.

- COVE LIGHT TYP.

- THIS COLLAR TIE

- LOW VOLTAGE

SPEAKERS, TYP.

? REFLECTED CEILING PLAN

1/AC2.00

- PAINTED GYP BOARD,

FURR-DOWN ABOVE

1. THE CONTRACTOR, IN ACCORDANCE WITH THE PREVISIONS SET FORTH IN THESE CONTRACT DOCUMENTS, SHALL PROVIDE ALL MATERIALS, EQUIPMENT, LABOR AND SUPERVISION REQUIRED TO COMPLETE ALL WORK DESCRIBED HEREIN AND WHICH CAN BE REASONABLY INFERRED TO BE REQUIRED, IN A GOOD WORKMANLIKE MANNER.

2. SUBMISSION OF A BID BY THE CONTRACTOR WILL SIGNIFY THAT THE SITE WAS INSPECTED BY THE APPROPRIATE PERSONNEL AND WORK ASSOCIATED WITH DEALING WITH THE EXISTING CONDITIONS HAS BEEN INCORPORATED INTO THE BID. FAILURE TO OBSERVE THE EXISTING CONDITIONS WILL NOT BE A BASIS FOR ADDITIONAL COMPENSATION. THE CONTRACTOR SHALL VISIT THE JOB SITE TO BECOME FAMILIAR WITH THE EXISTING CONDITIONS AND VERIFY DISCREPANCIES.

3. CONTRACTOR SHALL PERFORM ALL WORK IN ACCORDANCE WITH ALL APPLICABLE CODES, REGULATIONS, ACTS, COVENANTS, ETC. HAVING JURISDICTION.

4. GENERAL CONTRACTOR TO VERIFY LOCATION OF ALL EXISTING PROPERTY UTILITIES PRIOR TO PERFORMING ANY WORK, AND GENERAL CONTRACTOR SHALL TAKE ALL NECESSARY PRECAUTIONS WITH EXISTING UTILITIES DURING DEMOLITION AND CONSTRUCTION PHASES.

5. THE CONTRACTOR IS RESPONSIBLE FOR DISPOSAL OF ALL DEMOLISHED MATERIALS. THE CONTRACTOR SHALL VERIFY ANY REGULATIONS, LAWS AND/OR ORDINANCES AFFECTING THE METHODS OF DEMOLITION AND THE DISPOSAL OF WASTE MATERIALS. THE OWNER ASSUMES NO LIABILITY FOR EXTRA WORK OR ADDITIONAL COMPENSATION DUE TO FAILURE OF THE CONTRACTOR OR SUBCONTRACTORS TO COMPLY WITH APPLICABLE REGULATIONS.

6. THE CONTRACTOR SHALL BE RESPONSIBLE FOR MEANS AND METHODS OF CONSTRUCTION. THE CONTRACTOR SHALL PROVIDE ALL MEASURES NECESSARY TO PROTECT THE STRUCTURE AND PERSONNEL DURING CONSTRUCTION. SUCH METHODS SHALL INCLUDE BUT NOT BE LIMITED TO BRACING, SHORING OF LOADS DUE TO CONSTRUCTION EQUIPMENT, EXCAVATION PROTECTION, SCAFFOLDING, JOB SITE SAFETY, ETC. OBSERVATION VISITS TO THE SITE BY ARCHITECT, OWNER, OWNER'S REP. OR ENGINEER SHALL NOT INCLUDE INSPECTION OF THE ABOVE

7. IT IS THE INTENT OF THE OWNER AND ARCHITECT THAT THIS PROJECT COMPLY WITH THE ADA AND TEXAS ACCESSIBILITY STANDARDS.

8. THE CONTRACTOR AND SUBCONTRACTORS SHALL AGREE TO WARRANTY THE WORK, INCLUDING BOTH MATERIALS AND WORKMANSHIP, FOR A PERIOD OF ONE YEAR FROM THE DATE OF FINAL ACCEPTANCE BY OWNER. CONTRACTOR SHALL REMEDY, AT NO EXPENSE TO THE OWNER, ANY DEFECTS IN THE WORK WHICH BECOME APPARENT DURING THE WARRANTY PERIOD. ADDITIONAL WARRANTY REQUIREMENTS ARE LISTED IN THE SPECIFICATIONS.

9. SEAL ALL CRACKS AROUND STRUCTURAL MEMBERS, BRACING, DUCTS, AND BETWEEN WALLS AND ROOF DECK WHERE AIR INFILTRATION BETWEEN CONDITIONED AND NON-CONDITIONED (EXTERIOR) SPACES MAY OCCUR (I.E. SEAL THE BUILDING ENVELOPE).

10. ALL MATERIALS SHALL BE RECYCLED AS PER SECTION 01 7419 CONSTRUCTION WASTE MANAGEMENT PLAN.

RE: LIGHTING PLANS BY OTHERS. FOR DIMENSIONAL LIGHTING PLAN AND EQUIPMENT SCHEDULE. RE: MEP FOR LIGHTING CONTROL DOCUMENTATION & POWER/DATA INFORMATION.

DEMOLITION NOTES:

1. BEFORE DEMOLITION BEGINS, COORDINATE INITIAL SELECTIVE DEMOLITION INVESTIGATION WITH ARCHITECT

2. DEMOLISH ALL FLOOR FINISHES, TYP.

3. SALVAGE ALL EXISTING METAL CEILING TILE. STRIP PAINT AND PREPARE TILES FOR PRIMING AND PAINTING.

4. WHERE DOORS ARE REMOVED, SALVAGE EXISTING DOOR FRAMES AND

TRIM FOR POSSIBLE RE-USE.

5. ITEMS NOTED TO BE SAVED OR SALVAGED FOR REUSE ARE TO BE STORED ON SITE, FOR REUSE BY THE OWNER OR GENERAL CONTRACTOR AT THIS SITE.

6. THE GC IS RESPONSIBLE FOR ALL NECESSARY DEMOLITION OF THE BUILDING SYSTEMS, AND PATCHING OR REPAIR OF EXISTING BUILDING FINISHES/SITE FEATURES AFFECTED BY NEW CONSTRUCTION.

7. DAMAGES TO THE PROPERTY OF THE OWNER SHALL BE REPAIRED OR PAID FOR BY THE GC. THIS SHALL INCLUDE, BUT NOT BE LIMITED TO, DAMAGE TO THE BUILDING GROUNDS, PLANTINGS, WALLS, PAVEMENT, UTILITIES, ETC.

8. CONTRACTOR TO BRACE/SHORE EXISTING CONSTRUCTION TO REMAIN.

9. PROTECT EXISTING TREES TO CITY OF AUSTIN STANDARDS. ALL DEMOLITION WORK IN CRITICAL ROOT ZONES TO BE DONE WITH HAND TOOLS AND/OR AIR SPADES. CONTACT OWNER'S ARBORIST FOR ANY TREE WORK.

10. REMOVE ROTTED WOOD WHEN ENCOUNTERED. DOCUMENT EXISTING CONDITION FOR REPLACEMENT. REVIEW SCOPE WITH OWNER AND ARCHITECT PRIOR TO REMOVAL.

11. AFTER PARTIAL DEMOLITION, ARCHITECT AND STRUCTURAL ENGINEER TO REVIEW AND ADVISE FOR REPAIR/MODIFICATION SCOPE.

12. EXISTING STRUCTURE IS NOT NECESSARILY SHOWN IN ITS ENTIRETY OR ABSOLUTE CORRECT LOCATION. CONTRACTOR TO VERIFY EXISTING CONDITIONS PRIOR TO BIDDING. ANY DISCREPANCIES TO BE BROUGHT TO THE ATTENTION OF ARCHITECT FOR DIRECTION OR CLARIFICATION.

13. COORDINATE SUPPORT FOR ALL NEW WALL OPENINGS (OR WALLS TO BE REMOVED) WITH STRUCTURAL DRAWINGS. WHERE APPLICABLE, INSTALL NEW STRUCTURAL MEMBERS (OR ADEQUATE SHORING/BRACING) BEFORE CUTTING OPENINGS.

14. ALL DIMENSIONS AND CONDITIONS ABUTTING THE EXISTING CONSTRUCTION ARE APPROXIMATE. ALL SUCH CONDITIONS SHALL BE FIELD VERIFIED BEFORE PROCEEDING WITH THE WORK. THE CONTRACTOR SHALL BRING ANY DISCREPANCIES TO THE ATTENTION OF THE ARCHITECT. OPENING SIZES NOTED ON THE DEMOLITION DRAWINGS ARE TO BE COORDINATED WITH THE ARCHITECTURAL, STRUCTURAL AND MEP DRAWINGS, PRIOR TO CUTTING THE OPENING.

15. DO NOT SCALE DRAWINGS. IF THE DIMENSIONS ARE IN QUESTION, THE CONTRACTOR SHALL BE RESPONSIBLE FOR OBTAINING CLARIFICATION FROM THE ARCHITECT BEFORE CONTINUING WITH CONSTRUCTION.

16. WHERE PORTIONS OF WALLS ARE REMOVED FOR NEW OPENINGS, COORDINATE HEIGHT OF DEMOLISHED OPENING WITH FINISHED OPENING SIZE AND ANY ADDED STRUCTURE REQUIRED.

PLAN LEGEND

EXISTING CONSTRUCTION TO REMAIN [_ _ _] EXISTING CONSTRUCTION TO BE REMOVED

NEW CONSTRUCTION

CONCRETE WOOD TONGUE & GROOVE

WOOD SHAKE

ELECTRICAL LEGEND

RECESSED CAN FIXTURE PENDANT FIXTURE

WALL MOUNTED LIGHT FIXTURE

---- LED COVE LIGHT SWITCH - SINGLE POLE

SWITCH - DIMMER

SWITCH - 3 WAY

FLUSH MOUNT SPEAKER ⊕30" 120V DUPLEX OUTLET

NUMBER INDICATES HEIGHT

⊕GFI 120V DUPLEX OUTLET -GROUND FAULT INTERRUPTER 120V DUPLEX OUTLET **WEATHER PROOF**

120V QUAD OUTLET NUMBER INDICATES HEIGHT TELEPHONE/DATA JACK

THERMOSTAT

CABLE TV JACK

HISTORICAL NOTES

1. THIS IS A HISTORICALLY CONTRIBUTING STRUCTURE, AND PRESERVATION IS EXTREMELY IMPORTANT. EXTREME CARE SHALL BE TAKEN TO PROTECT AND PRESERVE THIS STRUCTURE DURING SELECTIVE DEMOLITION AND CONSTRUCTION. IF ANY UNFORESEEN CONDITIONS ARISE, STOP WORK AND CONTACT THE ARCHITECT IMMEDIATELY.

2. ALL EXISTING COMPONENTS TO REMAIN ARE TO BE PROTECTED DURING DEMOLITION AND CONSTRUCTION BY THE GENERAL CONTRACTOR. ANY DAMAGED MATERIAL IS TO BE REPAIRED, REPLACED OR REBUILT IN A MANNER ACCEPTABLE TO THE OWNER AND ARCHITECT.

3. DEMOLITION PHASE: THIS STAGE IS CRITICAL TO THE SUCCESS OF THIS PROJECT AND MUST BE CONSIDERED A STAGE OF DISCOVERY. EXTREME CARE MUST BE TAKEN, ESPECIALLY IN AREAS OF QUESTION TO NOT DESTROY ORIGINAL MATERIALS. RECKLESS DESTRUCTION OF SALVAGEABLE, RE-USABLE ORIGINAL MATERIALS WILL NOT BE ALLOWED AND CM/GC WILL BE RESPONSIBLE FOR REPLACEMENT OF DAMAGED MATERIALS.

CLAYTON & LITTLE

PRELIMINARY NOT FOR CONSTRUCTION

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ISSUED DATE 09.12.2019 PROJECT NUMBER

KINGSBURY COMMONS

Austin, TX 78705

1100 Kingsbury Street

LANDSCAPE ARCHITECT TEN EYCK LANDSCAPE ARCHITECTS 1214 WEST SIXTH STREET, SUITE 100 AUSTIN, TX 78703 512 813 9999 P

ARCHITECT - TUDOR COTTAGE, TERRACE, RESTROOM 2201 N. LAMAR BLVD.

ARCHITECT - TREEHOUSE MELL LAWRENCE ARCHITECT 913 W. GIBSON ST. 512 441 4669 P CIVIL ENGINEER GARZA EMC 7708 RIALTO BLVD. SUITE 125

GRAPHICS AND WAYFINDING DESIGNER PAGE/DYAL BRANDING AND GRAPHICS 400 W. CESAR CHAVEZ ST., SUITE 500 AUSTIN, TX 78701

AUSTIN, TX 78735

512 298 3284 P

512 382 3580 P IRRIGATION DESIGNER

SWEENEY + ASSOCIATES 3000 JOE DIMAGGIO BLVD. BLDG., 1700 SUITE 61 ROUND ROCK, TX 78665 512 306 9350 P

LIGHTING DESIGNER 9411 CHAPEL DOWN ST. AUSTIN, TX 78729 512 382 1656 P STRUCTURAL ENGINEER

ARCHITECTURAL ENGINEERS COLLABORATIVE

3800 N. LAMAR BLVD., SUITE 330 AUSTIN, TX 78756 MEP ENGINEER

1146 OYSTER CREEK BUDA, TX 78610 512 523 8000 P WATER FEATURE DESIGNER

CARROLLTON, TX 75006

972 446 0037 P

JERRY GARZA & ASSOCIATES

PHASE: CONSTRUCTION DOCUMENTS

1425 WHITLOCK LANE, SUITE 108


ISSUE 100% SCHEMATIC DESIGN

> DATE: 09.12.2019 DRAWN:


CHECKED: TELA PROJECT NO: 1832

DRAWING TITLE: FLOOR PLANS - BLDG C


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ALL INTERIOR FINISHES TO BE

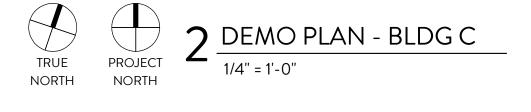



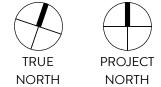

____ FLOOR PLAN- BLDG C 491'-2 1/2"

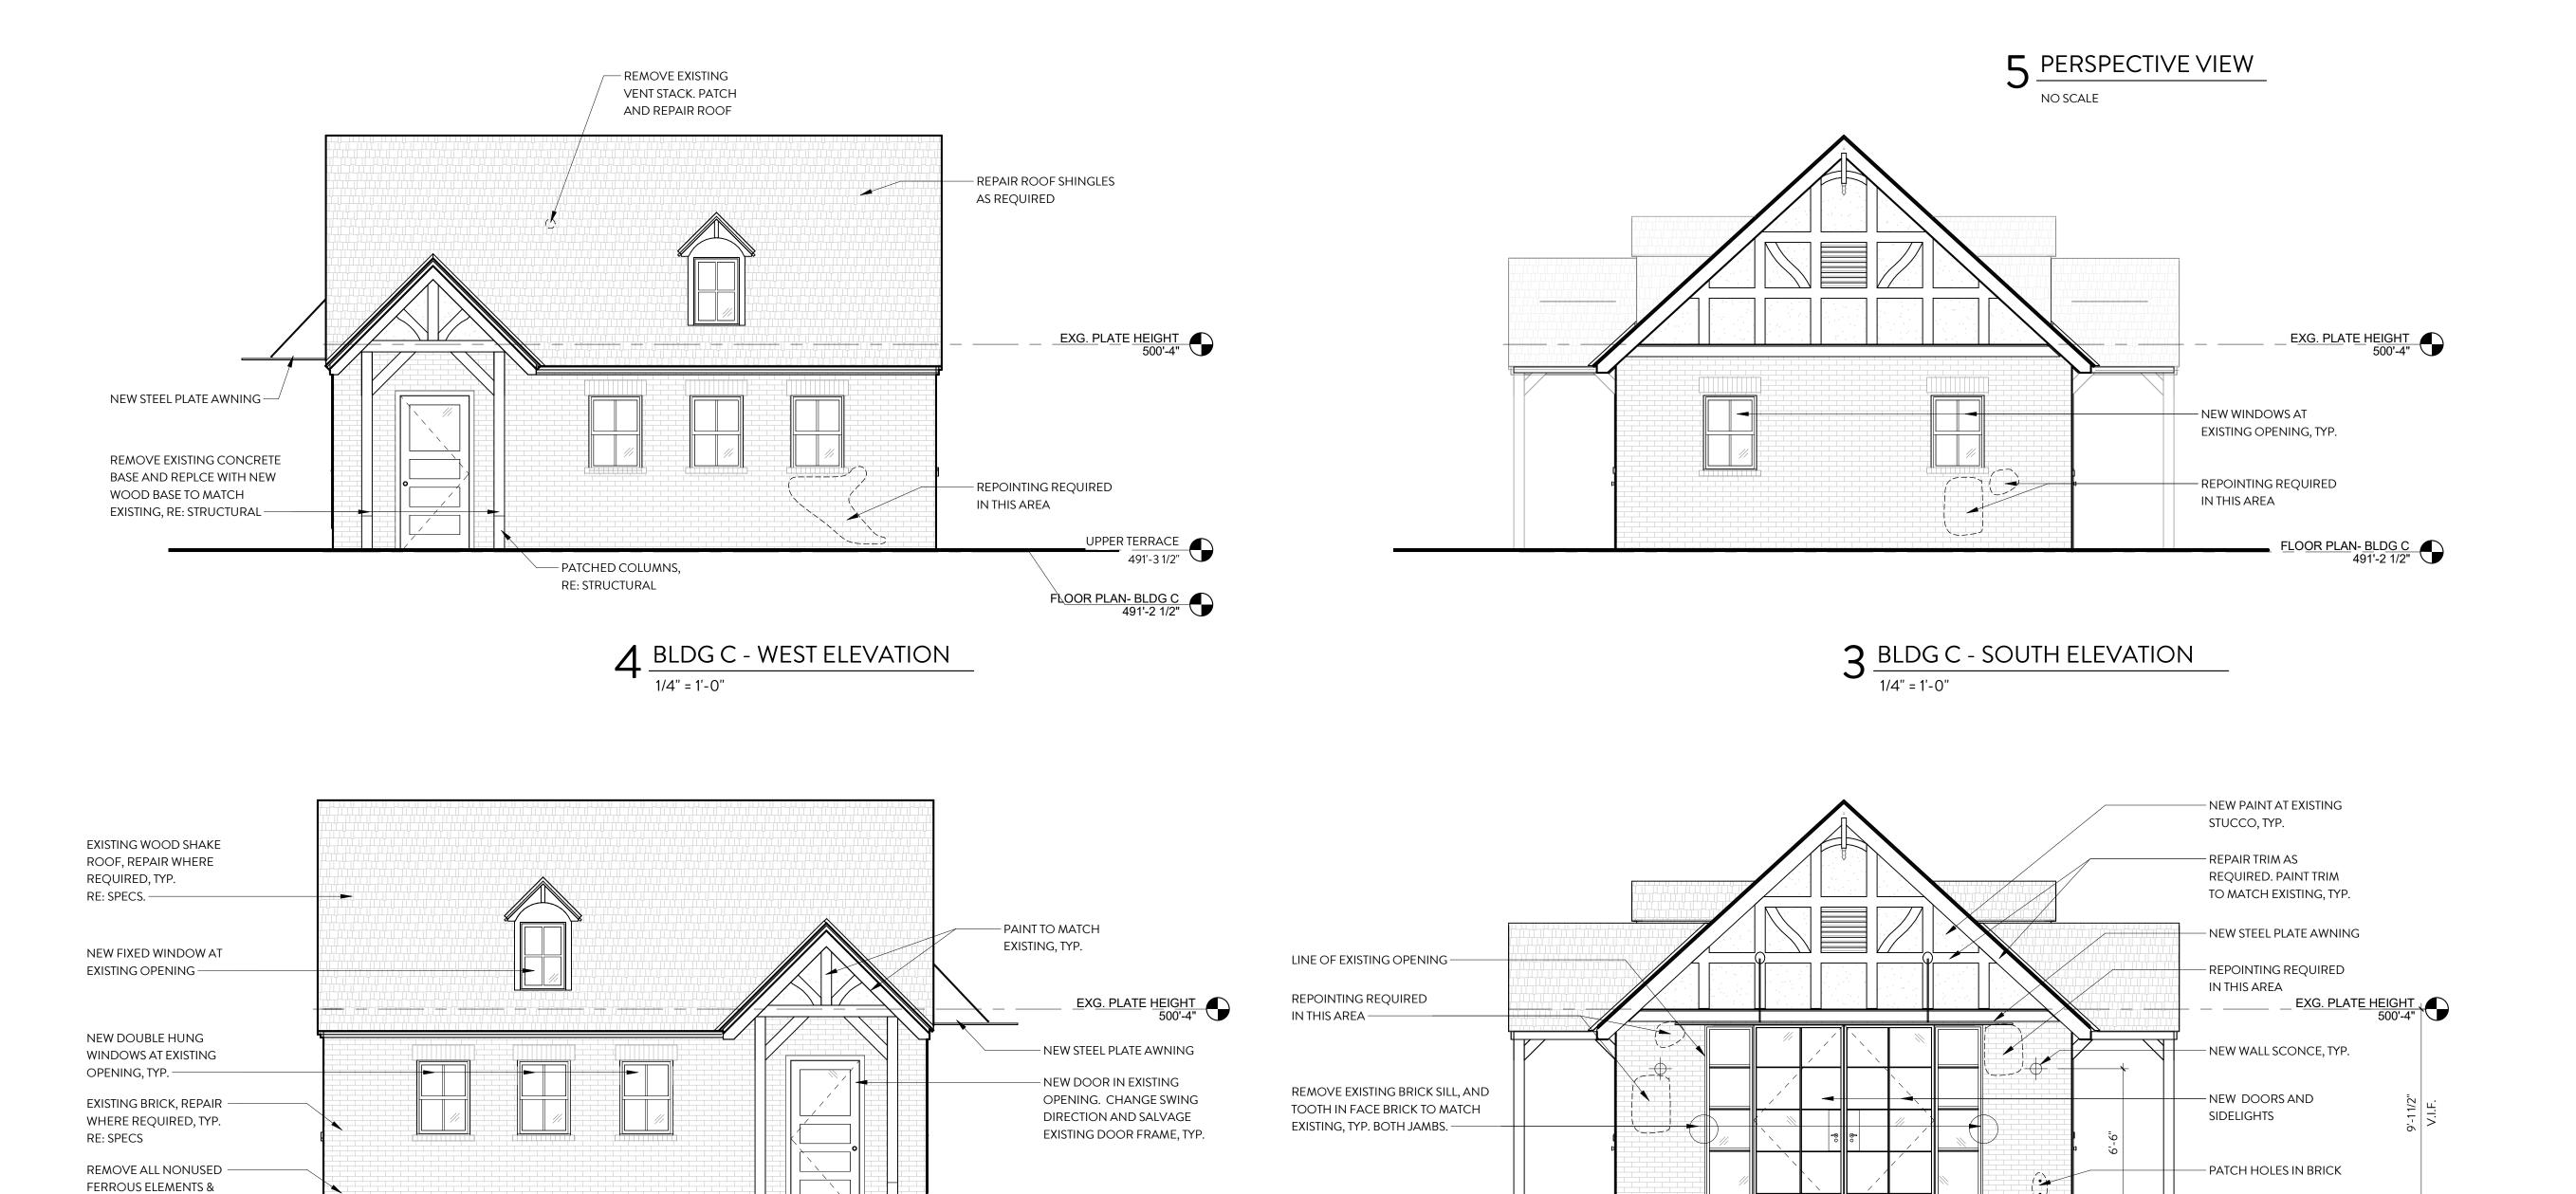PATCHED COLUMN, **RE: STRUCTURAL**

 $\frac{2}{1/4" = 1'-0"}$

ANCHOR SLEEVES

1 BLDG C - NORTH ELEVATION

CLAYTON & LITTLE

PRELIMINARY NOT FOR CONSTRUCTION

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ISSUED DATE 09.12.2019 PROJECT NUMBER 1832

KINGSBURY COMMONS

1100 Kingsbury Street Austin, TX 78705

LANDSCAPE ARCHITECT
TEN EYCK LANDSCAPE ARCHITECTS
1214 WEST SIXTH STREET, SUITE 100
AUSTIN, TX 78703
512 813 9999 P

ARCHITECT - TUDOR COTTAGE, TERRACE, RESTROOM CLAYTON & LITTLE 2201 N. LAMAR BLVD. AUSTIN, TX 78705 512 477 1727 P

ARCHITECT - TREEHOUSE MELL LAWRENCE ARCHITECTS 913 W. GIBSON ST. AUSTIN, TX 78704

512 441 4669 P CIVIL ENGINEER GARZA EMC 7708 RIALTO BLVD. SUITE 125 AUSTIN, TX 78735 512 298 3284 P

GRAPHICS AND WAYFINDING DESIGNER

PAGE/DYAL BRANDING AND GRAPHICS 400 W. CESAR CHAVEZ ST., SUITE 500 AUSTIN, TX 78701

512 382 3580 P IRRIGATION DESIGNER

SWEENEY + ASSOCIATES 3000 JOE DIMAGGIO BLVD. BLDG., 1700 SUITE 61 ROUND ROCK, TX 78665 512 306 9350 P

LIGHTING DESIGNER STUDIO LUMINA 9411 CHAPEL DOWN ST. AUSTIN, TX 78729 512 382 1656 P

STRUCTURAL ENGINEER ARCHITECTURAL ENGINEERS COLLABORATIVE 3800 N. LAMAR BLVD., SUITE 330 AUSTIN, TX 78756 512 472 2111 P

MEP ENGINEER JERRY GARZA & ASSOCIATES 1146 OYSTER CREEK BUDA, TX 78610 512 523 8000 P

WATER FEATURE DESIGNER 1425 WHITLOCK LANE, SUITE 108 CARROLLTON, TX 75006 972 446 0037 P

PHASE: CONSTRUCTION DOCUMENTS

ISSUE 06/28/2018 100% SCHEMATIC DESIGN

DATE: 09.12.2019 DRAWN:

CHECKED: TELA PROJECT NO: 1832

DRAWING TITLE: EXTERIOR ELEVATIONS - BLDG C

6 TUDOR - INTERIOR VIEW NORTH


2 BLDG C - EAST
3/8" = 1'-0"


3/8" = 1'-0"


SLIDE WOOD PTD. PT-2 OPEN SPACE RETURN FOR HVAC UNIT WITHIN CABINET -2'-7" 2'-7" 3'-2" 3'-2" 6'-10" 1 BLDG C - SOUTH

3/8" = 1'-0"


EMERGENCY LIGHTING CONCEALITE 5000 SERIES; RE: MEP —— WOOD LIGHT COVE. PTD, PT-2 — WF-1, TYP. —— TRIM TO MATCH EXISTTING. PTD. PT-2 SALVAGED METAL PANELS FROM EXISTING DROPPED CEILING, PTD. —

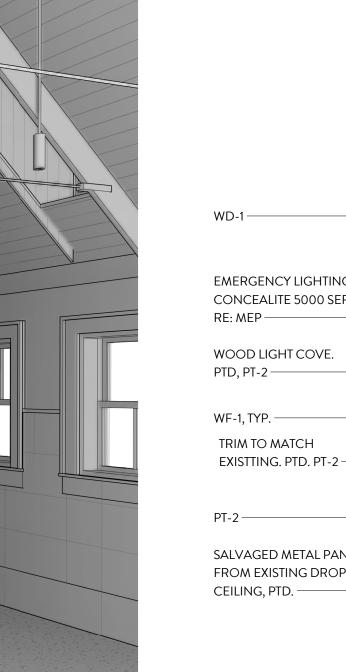

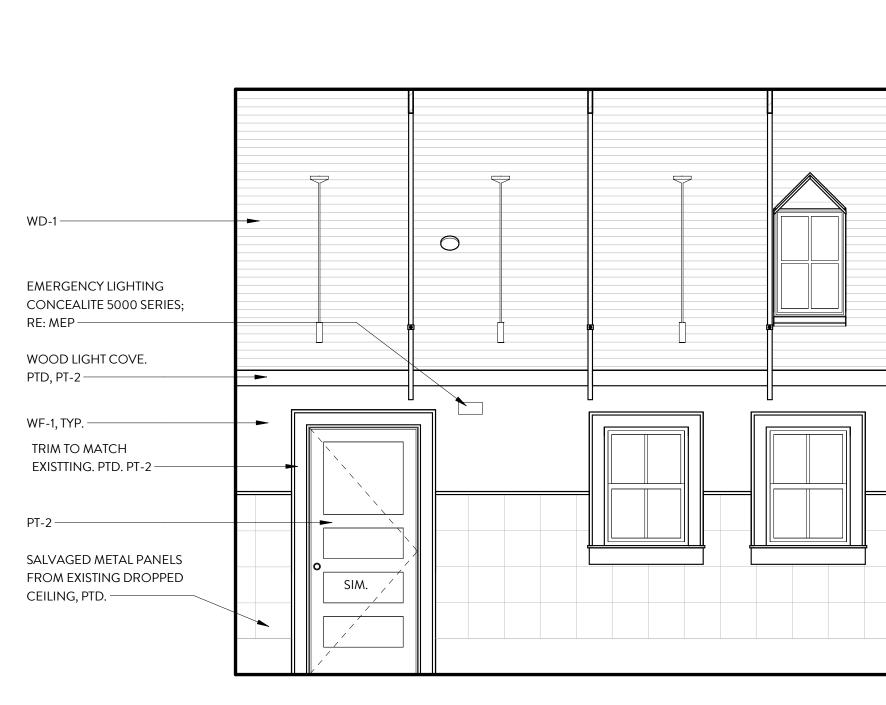


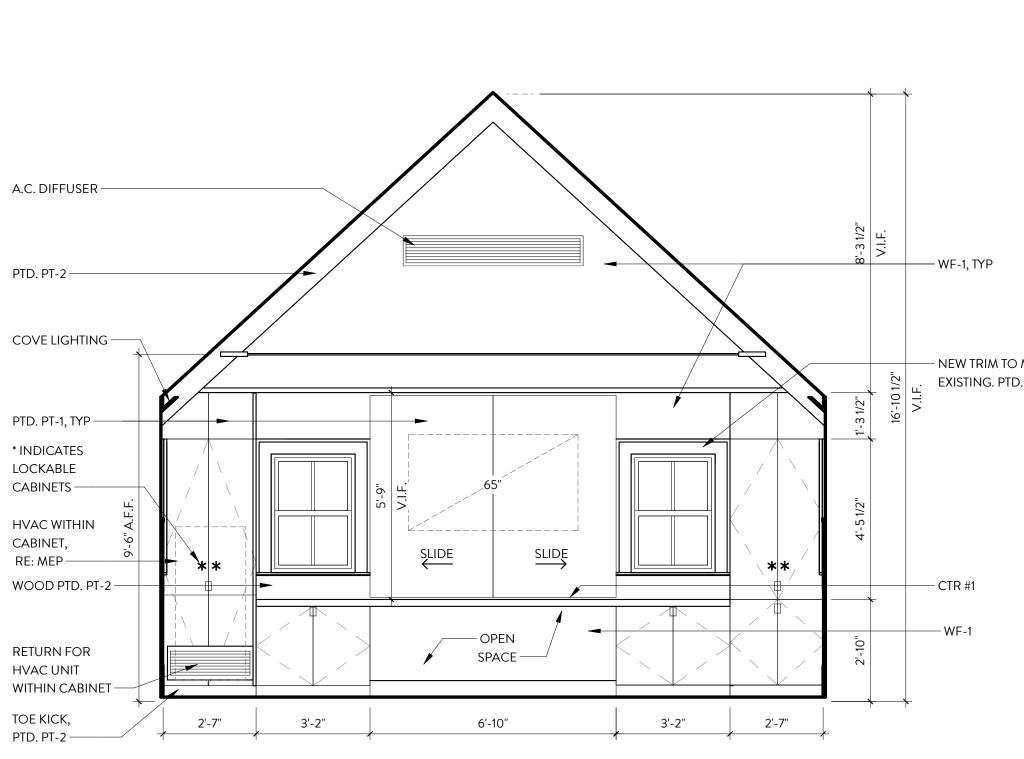



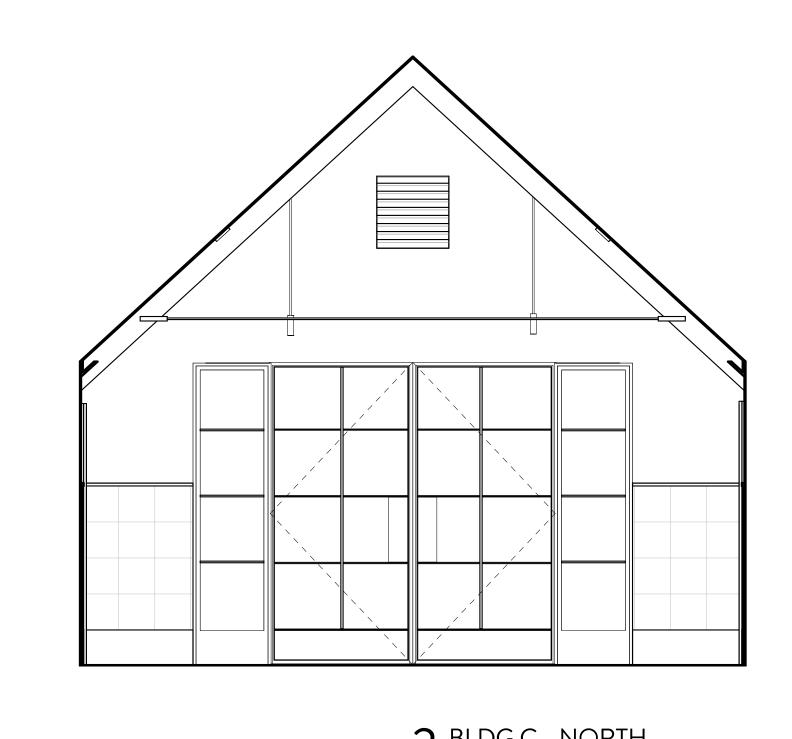



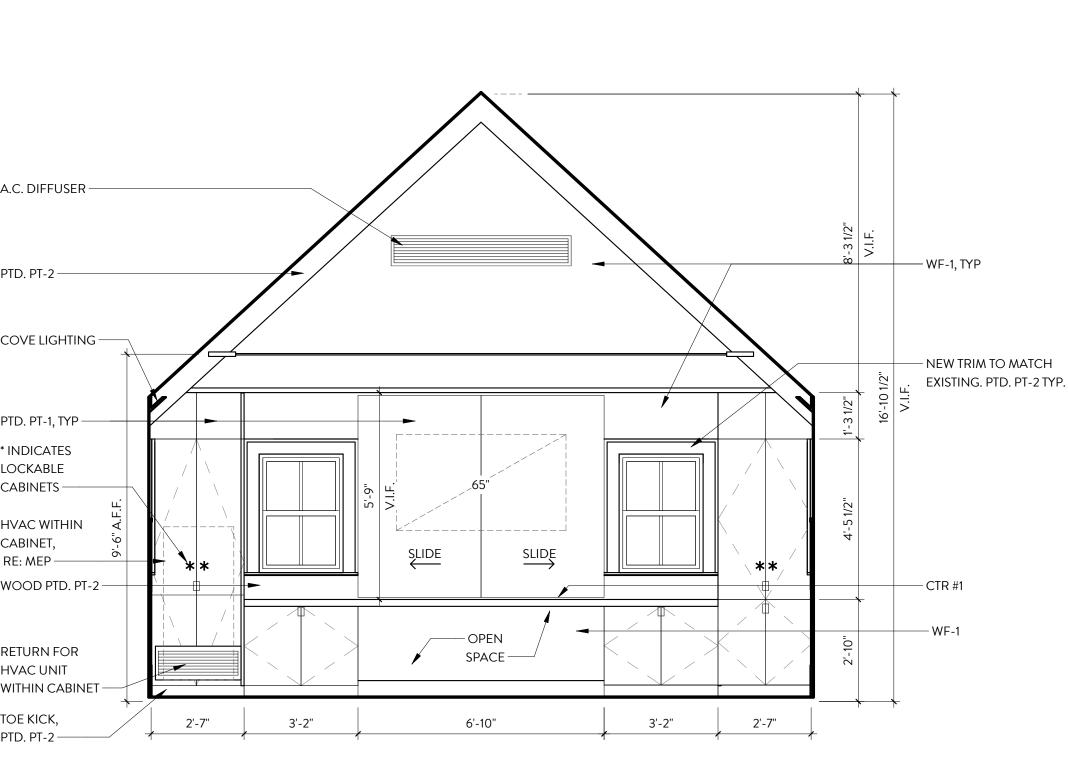

3/8" = 1'-0"

GENERAL NOTE RE: AC6.0 FINISH SCEHDULE FOR MATERIAL CALLOUTS

CLAYTON & LITTLE

PRELIMINARY NOT FOR CONSTRUCTION

This drawing was prepared under the supervision of Paul Clayton. It is not to be used for regulatory approval, permitting, or construction purposes.

ISSUED DATE 09.12.2019 PROJECT NUMBER

KINGSBURY COMMONS

1100 Kingsbury Street Austin, TX 78705

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TEN EYCK LANDSCAPE ARCHITECTS
1214 WEST SIXTH STREET, SUITE 100
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ARCHITECT - TUDOR COTTAGE, TERRACE, RESTROOM CLAYTON & LITTLE 2201 N. LAMAR BLVD. AUSTIN, TX 78705 512 477 1727 P

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CIVIL ENGINEER GARZA EMC 7708 RIALTO BLVD. SUITE 125 AUSTIN, TX 78735 512 298 3284 P

GRAPHICS AND WAYFINDING DESIGNER PAGE/DYAL BRANDING AND GRAPHICS 400 W. CESAR CHAVEZ ST., SUITE 500 AUSTIN, TX 78701 512 382 3580 P

IRRIGATION DESIGNER

SWEENEY + ASSOCIATES 3000 JOE DIMAGGIO BLVD. BLDG., 1700 SUITE 61 ROUND ROCK, TX 78665 512 306 9350 P

LIGHTING DESIGNER STUDIO LUMINA 9411 CHAPEL DOWN ST. AUSTIN, TX 78729 512 382 1656 P

STRUCTURAL ENGINEER ARCHITECTURAL ENGINEERS COLLABORATIVE 3800 N. LAMAR BLVD., SUITE 330 AUSTIN, TX 78756 512 472 2111 P

MEP ENGINEER
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1146 OYSTER CREEK
BUDA, TX 78610
512 523 8000 P

WATER FEATURE DESIGNER 1425 WHITLOCK LANE, SUITE 108 CARROLLTON, TX 75006 972 446 0037 P

PHASE: CONSTRUCTION DOCUMENTS

ISSUE 100% SCHEMATIC DESIGN
50% DESIGN DEVELOPMENT
100% DESIGN DEVELOPMENT

DATE: 09.12.2019

DRAWN: CHECKED:

TELA PROJECT NO: 1832 DRAWING TITLE:

INTERIOR ELEVATIONS - BLDG C

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SOUTH ELEVATION



WEST ELEVATION



EAST ELEVATION



NORTH WEST ELEVATION