

PROPOSED SITE PLAN

SCALE: $\frac{3}{32}$ " = 1'

BUILDING AREA CALCULATIONS

EXISTING HOME 1100 SQ FT
ADDITION 830 SQ FT
CONCRETE 1425 SQ FT
GARAGE TO BE DEMOLISHED -240 SQ FT

TOTAL IMPERVIOUS SQ FT COVERAGE: 3115 SQ FT TOTAL LOT SQ FT: 6892 SQ FT IMPERVIOUS COVERAGE 45.2% BUILDING COVERAGE: 26.56%

TREE NOTES:

1.PROVIDE TREE PROTECTION.

- 2. PRIOR TO CONSTRUCTION, 2X4 LUMBER MUST BE STRAPPED SECURELY TO THE TRUNK OF EACH PROTECTED TREE. ALSO PROVIDE PROTECTIVE FENCING AROUND TREES LOCATED WITHIN THE LIMITS OF CONSTRUCTION TO PROTECT ENTIRE CRITICAL ROOT ZONE AREA OR AS MUCH OF THE CRITICAL ROOT ZONE AS IS PRACTICAL. WHEN PROTECTIVE FENCING CANNOT INCORPORATE THE ENTIRE $\frac{1}{2}$ CRITICAL ROOT ZONE, AN 8" LAYER OF MULCH WITHIN THE ENTIRE AVAILABLE ROOT ZONE AREA IS REQUIRED FOR ALL TREES WHICH HAVE ANY DISTURBANCE INDICATED WITHIN ANY PORTION OF THE CRITICAL ROOT ZONE.
- 3. NO CANOPY PRUNING WILL BE PROVIDED ON PROTECTED TREES.
- 4. ALL DEMOLITION IN THE $\frac{1}{4}$ & $\frac{1}{2}$ CRZ OF PROTECTED TREES MUST BE DONE WITH HAND TOOLS.

SITE PLAN NOTES:

- 1. CONCRETE LINE PUMP: WRAP CONNECTIONS OF CONCRETE LINE PUMP WITH PLASTIC TO PREVENT CONCRETE SLURRY FROM LEACHING INTO GROUND AND NEAR ROOTS OF TREES.
- 2. CONCRETE TRUCK: IF HEAVY EQUIPMENT WILL BE ROLLING OVER ANY AREA OF THE FULL CRZ OF PROTECTED TREES, PROVIDE 3/4" PLYWOOD OVER 2X4 LUMBER OVER 12" LAYER OF MULCH TO BRIDGE OVER THE ROOTS AND PREVENT SOIL/ROOT COMPACTION. AFTER CONSTRUCTION IS COMPLETED, SPREAD MULCH AROUND SITE TO LEAVE A MAX LAYER OF 3" WITHIN ROOT ZONES.
- 3. NO NEW WATER, WASTEWATER, GAS OR ELECTRIC LINES WILL BE ADDED. EXISTING PIPES AND SUPPLY LINES WILL BE USED.

HALSELL DRAFTING & DESIGN

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GENERAL NOTES:

- 1. THE GENERAL CONTRACTOR/BUILDER SHALL EXAMINE AND VERIFY THE ACCURACY OF ALL DIMENSIONS AND CONDITIONS OF THESE PLANS/DOCUMENTS AND SHALL NOTIFY OWNER OF ANY DISCREPANCIES AND/OR OMISSIONS PRIOR TO THE START OF CONSTRUCTION.
- 2. THESE PLANS ARE INTENDED FOR THE GENERAL RESIDENTIAL CONSTRUCTION PURPOSES ONLY AND ARE NOT EXHAUSTIVELY DETAILED OR FULLY SPECIFIED.
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- 6. ALL INFORMATION PROVIDED ON THESE PRINTS SHOULD BE VERIFIED BY G.C, ENGINEER OR A CERTIFIED SPECIALIST.

No.	Description	Date

2102 ALTA VISTA ADDITION

SITE PLAN

 Project number
 7850036

 Date
 08/17/2020

 Drawn by
 DHALSELL

 Sheet Size
 C-SIZE

A112

Scale 1/8" = 1'-0"



close entry way with larger front bouble door





replace front door with larger door

adding window here



replace bathroom window with same size window but different window



adding pocket door here

2102 ALTA VISTA AVE AUSTIN, TX 7804 HOME ADDTION



	Sheet List
Sheet Number	Sheet Name
A101	COVER SHEET
A102	CURRENT ELEVATIONS
A103	CURRENT FLOORPLAN
A104	PROPOSED ELEVATIONS
A105	PROPOSED ELEVATIONS
A106	PROPOSED FLOORPLAN
A107	ELECTRICAL
A108	PLUMBING
A109	DOORS & WINDOWS
A110	CURRENT SURVEY
A111	PROPOSED ROOF PLAN
A112	SITE PLAN

1		

HOME SQUARE FOOTAGE

PROPOSED TOTAL 1930 SQ FT APPROX

CURRENT TOTAL

1100 SQ FT APPROX

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No.	Description	Date

2102 ALTA VISTA ADDITION

COVER SHEET

Project number	7850036
Date	08/17/2020
Drawn by	DHALSELL
Sheet Size	C-SIZE
Officer office	0-0122

A101

Scale 12" = 1'-0"



1 CURRENT FRONT ELEVATION 3/16" = 1'-0"



4 CURRENT REAR ELEVATION 3/16" = 1'-0"



Level 4 23' - 0"

3 CURRENT LEFT SIDE ELEVATION
3/16" = 1'-0"

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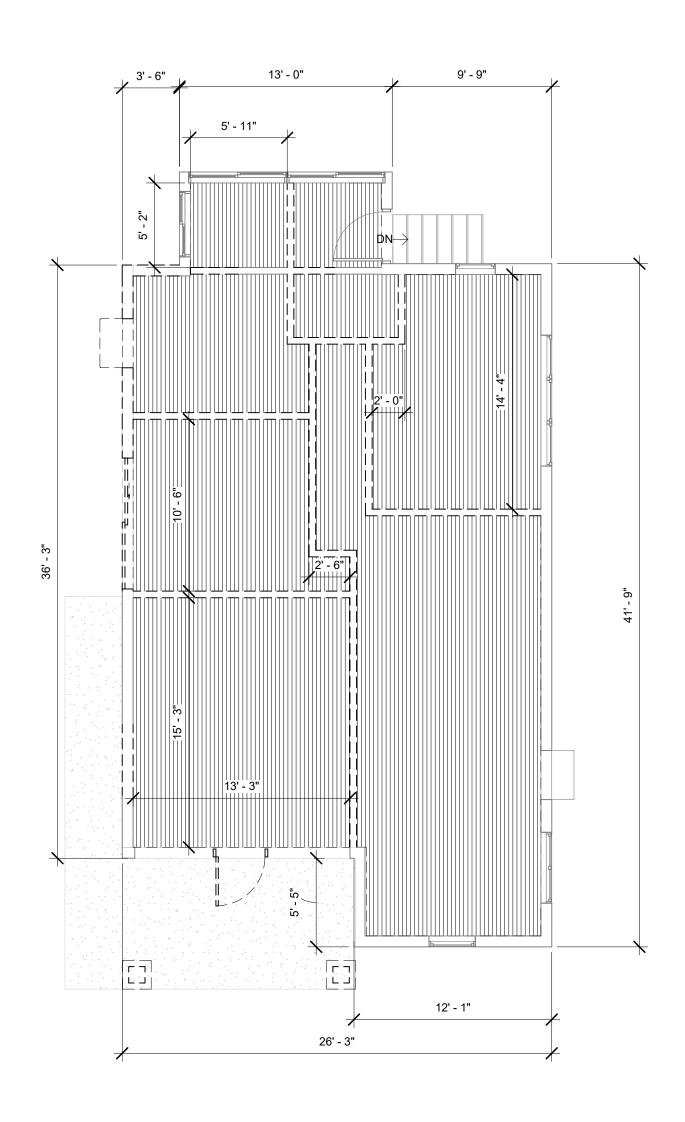
No.	Description	Date

2102 ALTA VISTA ADDITION

CURRENT ELEVATIONS

Project number	7850036
Date	08/17/2020
Drawn by	DHALSELL
Sheet Size	C-SIZE

A102



1 CURRENT FLOORPLAN
3/16" = 1'-0"

2 DEMO PLAN 3/16" = 1'-0" HALSELL DRAFTING & DESIGN

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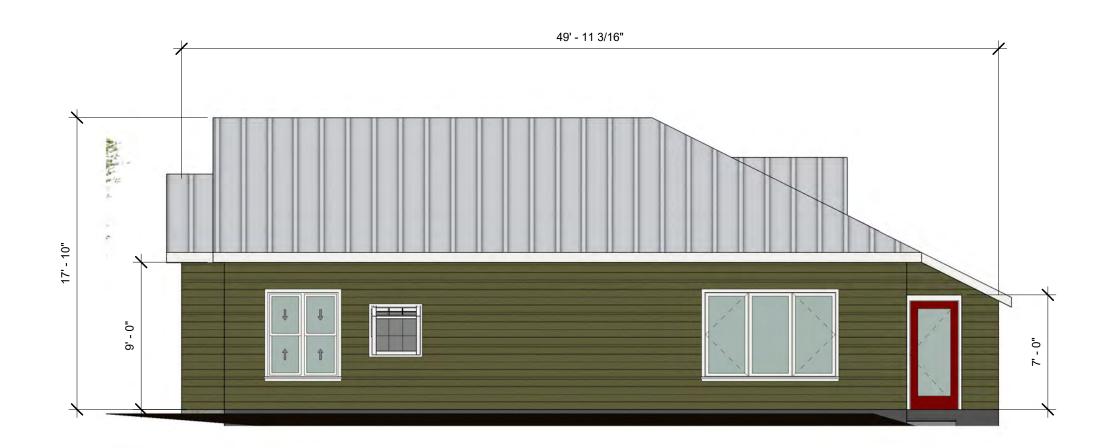
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2102 ALTA VISTA ADDITION

CURRENT FLOORPLAN

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A103



2 PROPOSED RIGHT SIDE ELEVATION 3/16" = 1'-0"

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A104

PROPOSED REAR ELEVATION
3/16" = 1'-0"



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PROPOSED ELEVATIONS

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A105

(1) CURRENT ROOF LINES



(2) PROPOSED ROOF LINES

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PROPOSED ROOF PLAN

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A111

Scale