
1510 Palma Plaza

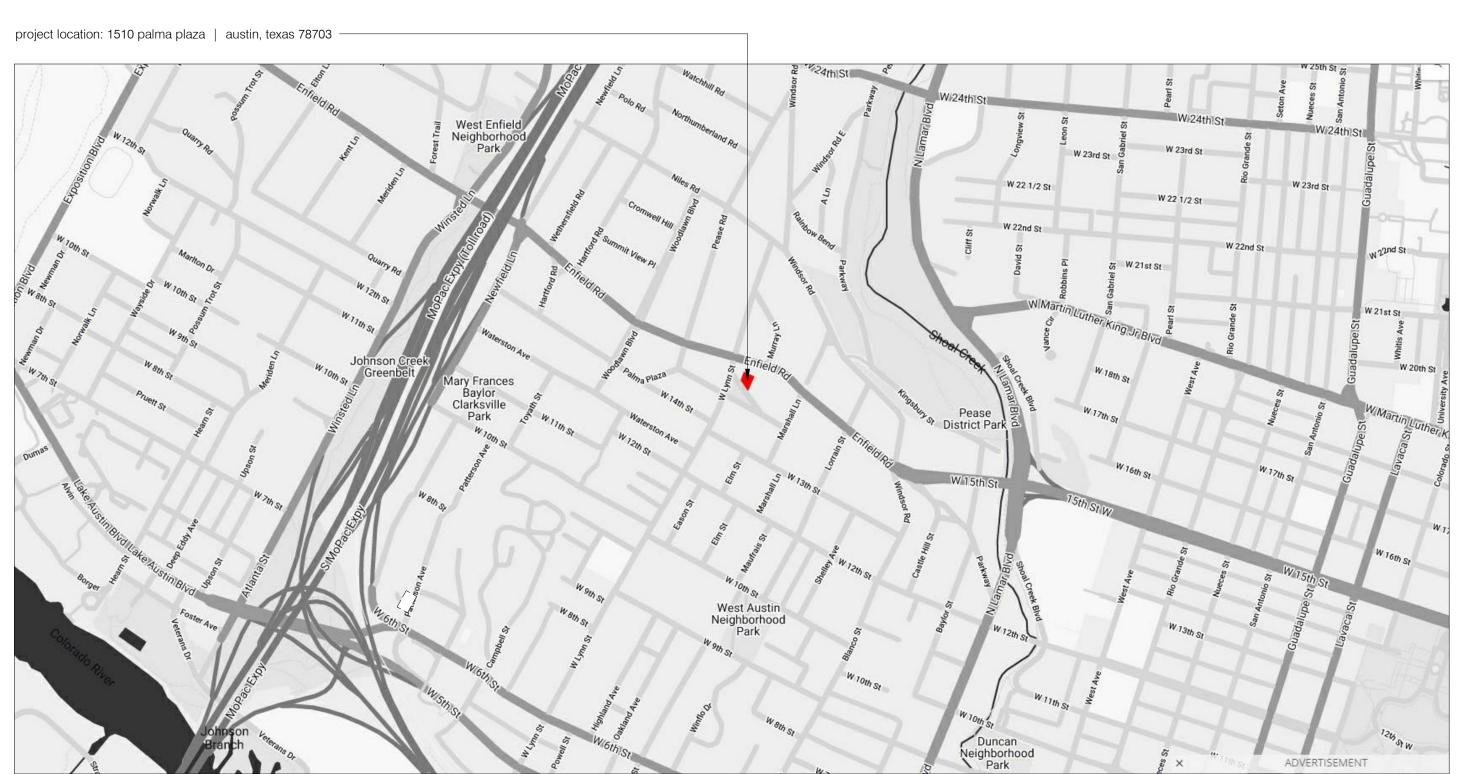



Historic Commision **Dec 2020**

Review Set - 21

GENERAL PROJECT NOTES

- FIELD VERIFY DIMENSIONS PRIOR TO START OF THE WORK.
- DO NOT SCALE DRAWINGS; WRITTEN DIMENSIONS SHALL GOVERN.
- NOTIFY ARCHITECT OR OWNER OF ANY DISCREPANCIES OR NONCOMPLIANCE FOUND IN THE DRAWINGS PRIOR TO PROCEDEEDING
- THESE DRAWINGS ARE INTENDED TO COMPLY W/ THE 2015 INTERNATIONAL RESIDENTIAL CODE, & ANY APPLICABLE LOCAL REGULATIONS AND/OR LOCAL DEED RESTRICTIONS. CONTRACTOR AND
- RESPONSIBILITY TO ENSURE THAT DRAWINGS ARE CODE COMPLIANT. CONTRACTOR SHALL ACCEPT FULL LIABILITY FOR ANY CHANGES MADE TO THE DRAWINGS W/ OUT VERIFYING W/ THE ARCHITECT.
- THESE DRAWINGS DO NOT SPECIFY ANY ACTUAL MATERIALS, FINISHES, PAINT COLORS, FIXTURES, APPLIANCES, OR EQUIPMENT. CONTRACTOR SHALL COORDINATE THE SELECTION OF THESE ITEMS W/ THE OWNER AND SHALL ACCEPT FULL RESPONSIBILITY FOR PROPER DETAILING &
- FIXTURES, APPLIANCES, & EQUIPMENT SHALL BE CONSTRUCTED AND/OR INSTALLED PER THE MANUFACTURER'S RECOMMENDATIONS & ANY
- ARCHITECT IS NOT RESPONSIBLE FOR MEANS & METHODS OF CONSTRUCTION DOCUMENTS. CONTRACTOR ACCEPTS FULL RESPONSIBILITY FOR ALL ASPECTS OF CONSTRUCTION.
- ALL ASSEMBLIES MATERIALS, FINISHES, FIXTURES, APPLIANCES, & PAYMENT, IN ADDITION TO ALL INDUSTRY STANDARD WARRANTIES.
- CONTRACTOR SHALL PROVIDE ALL LABOR SERVICES, EQUIPMENT, & MATERIALS REQUIRED FOR THE COMPLETE INSTALLATION OF THE ASSEMBLIES, MATERIALS, FINISHES, FIXTURES, APPLIANCES, & E QUIPMENT NOTED IN THESE DRAWINGS.
- THESE DRAWINGS DO NOT INCLUDE NECESSARY COMPONENTS FOR CONSTRUCTION SAFETY. CONTRACTOR ACCEPTS FULL RESPONSIBILITY FOR INITIATING, MAINTAINING, & SUPERVISING ALL SAFETY PRECAUTIONS PROGRAMS NECESSARY FOR THE COMPLETION OF THE WORK.
- CONTRACTOR SHALL GIVE NOTICE TO ALL AUTHORIZED INSPECTORS, SUPERINTENDENTS OR PERSONS IN CHARGE OF UTILITIES AFFECTED BY HIS/HER OPERATIONS PRIOR TO COMMENCING WORK.
- CONTRACTOR ACCEPTS FULL RESPONSIBILITY TO SUBMIT & SECURE ALL APPROVALS, PERMITS, TESTS, INSPECTIONS, & CERTIFICATES OF COMPLIANCE AS REQUIRED. CONTRACTOR ACCEPTS FULL RESPONSIBILITY TO ENSURE THAT ALL PERMITS NECESSARY TO LEGALLY PERFORM THE WORK HAVE BEEN APPROVED & OBTAINED PRIOR TO THE
- 15. DURING CONSTRUCTION OF THE WORK, CONTRACTOR SHALL MAINTAIN A CLEAN & ORDERLY WORK AREA AT ALL TIMES.
- 16. UPON COMPLETION OF THE WORK, CONTRACTOR SHALL CLEAR THE SITE OF ANY MATERIAL DEBRIS, & CLEAN UP ANY BUILDING OR SITE AREAS AFFECTED BY CONSTRUCTION.
- THESE DRAWING DO NOT SHOW TYPICAL DETAILING AND/OR WATERPROOFING.
- THE DESIGN & SIZING OF ALL STRUCTURAL MEMBERS (INCLUDING FOUNDATION) IS THE RESPONSIBILITY OF THE ENGINEER CHOSEN BY THE CONTRACTOR/OWNER.
- 19. VERIFY EXITING CONDITIONS AND DIMENSIONS PRIOR TO CONSTRUCTION

Sheet List

Sheet Number	Sheet Name
A000	cover sheet
A001	architectural site plan
A002	subchapter f elevations
A004	3D views
A101	first floor plan
A102	second floor plan
A103	third floor / attic plan
A104	roof plan
A201	building elevations
A202	building elevations



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review set

AND ORDINANCES.

BE RESPONSIBLE FOR ALL LABOR AND MATERIALS REQUIRED IN ACCORDANCE WITH THE DESIGN INTENT. REACH ARCHITECTS WILL NOT BE RESPONSIBLE FOR CONSTRUCTION MEANS, METHODS, TECHNIQUES, SEQUENCES OR PROCEDURES, OR FOR SAFETY PRECAUTIONS AND PROGRAMS IN CONNECTION WITH THIS PROJECT. ALL WORK SHALL BE PERFORMED IN ACCORDANCE WITH ALL APPLICABLE CODES

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by, or under the supervision of:

alan knox, aia # 21945

2020.12.21

No.	Description	Date

2020.12.21 1114 project number Drawn by

cover sheet

Checked by

ADEA DECODIDITION CO ET	Existing SF	to Remain	New/Ad	dded SF	Tota	al SF	SITE
AREA DESCRIPTION SQ. FT	UNIT A	UNIT B	UNIT A	UNIT B	UNIT A	UNIT B	TOTAL SF
1st floor conditioned area *	0	0	876	878	876	878	1,754
2nd floor conditioned area (@6')	0	0	878	905	878	905	1,783
3rd floor conditioned area (@6')	0	0	581	606	581	606	1,187
basement	0	0	0	0	0	0	0
covered parking - garage or carport *	0	0	199	200	199	200	399
covered patio, deck, porch &/or balcony area *	0	0	75	336	75	336	411
other covered or roofed area (overhang > 3') *	0	0	0	0	0	0	0
uncovered wood deck (counted @ 100%)	0	0	0	0	0	0	0
TOTAL BUILDING AREA	0	0	2,609	2,925	2,609	2,925	5,534
looc	0	0	0	0	0	0	0
spa	0	0	0	0	0	0	0
remodeled floor area, excluding addition/new	0	0	0	0	0	0	0
TOTAL BUILDING COVERAGE	* included	I in TOTAL BUILD	ING COVERAGE		1,150	1,414	2,564
driveway		0		268			268
sidewalks		0		166			166
uncovered patio		0		812			812
uncovered wood decks (counted @ 50%)		0		0			0
AC pads and other flatwork		0		18			18
other (pool coping, retaining walls)		0		0			0
TOTAL IMPERVIOUS COVER	Site Area:	8,842 sf x 0.45 =	3 979 sf allowed			43.29%	3,828



	Keynote Legend - Visitability
Key Value	Keynote Text

Visitable exterior route per (R320.7): maintain slope less than 1:20 and cross slope of less than 1:50. Any ramp included in an exterior Visitable route must comply with the Residential Code.

SITE PLAN NOTES

- 1. PRIOR TO START OF DEMOLITION & CONSTRUCTION, CONTRACTOR SHALL PROVIDE & INSTAL EROSION CONTROL BARRIERS AS REQUIRED.
- 2. UPON COMPLETION OF THE WORK, CONTRACTOR SHALL CLEAR THE SITE OF ANY MATERIAL DEBRIS, & CLEAN UP ANY BUILDING OR SITE AREAS AFFECTED BY CONSTRUCTION.
- EXTERIOR HVAC EQUIPMENT SHALL BE SCREENED IN COMPLIANCE W/ ANY CITY OF AUSTIN REGULATIONS AND/OR LOCAL DEED RESTRICTIONS.
- 4. EXISTING TREES SHALL BE MAINTAINED, UNLESS NOTED OTHERWISE.
- BUILDER TO PROVIDE PROPER DRAINAGE OF SURFACE WATER AWAY FROM BUILDING AS
- 6. VERIFY METER & UTILITY SERVICE LOCATIONS PRIOR TO INSTALLATION.
- 7. STABILIZED TEMPORARY CONSTRUCTION DRIVEWAY TO BE IN PACE PRIOR TO
- COMMENCEMENT OF CONSTRUCTION.

 CONFIRM ALL DRIVEWAY, WALKWAY & PVC LAYOUTS/LOCATIONS PRIOR TO COMMENCING
- WORK.
- PROVIDE CONTROL AND EXPANSION JOINTS AS REQUIRED ON CONCRETE DRIVES, WALKS & PATIOS.

GARBAGE RECEPTACLES TO BE STORED IN GARAGE OR SCREENED FROM VIEW AND ANIMAL

- 11. CONTRACTOR TO PROVIDE LOCATION OF MAILBOX AND EXTERIOR DRIVEWAY LIGHTS.
- 12. ALL CONSTRUCTION MATERIALS AND WASTE TO BE STORED ON SITE DURING CONSTRUCTIO
- 13. TREES TO BE REMOVED SHALL BE REMOVED FROM THE SOIL TO A DEPTH OF 12" BELOW THE SURFACE OF THE GROUND IN THE AREA OF THE BUILDING.
- 14. 1ST FLOOR POWDER BATH MUST QUALIFY AS A VISITABLE BATHROOM
 A. CLEAR DOOR OPENING MUST BE 30"
 B. LATERAL 2X6 BLOCKING MUST BE INSTALLED ALONG WALLS WITH CENTERLINE 34" ABOVE FINISHED FLOOR
 C. PROVIDE 30" X 30" CLEAR FLOOR SPACE
- 15. VISITABLE NO STEP ENTRANCE TO HAVE BEVELED THRESHOLD OF 1/2" OR LESS AND CLEAR
- DOOR WIDTH OF AT LEAST 32"

 16. SPOT GRADE ELEVATIONS REFERENCE THE LOWER ELEVATION BETWEEN EXISTING AND NEW

TREE PROTECTION NOTES:

- 1. MULCH TRAFFIC AREA AND SET PROTECTIVE FENCING AROUND TREES IN CRITICAL ROOT ZONE
- 2. NO CONSTRUCTION STAGING WITHIN CRITICAL ROOT ZONES.
- FOOTINGS WITHIN CRITICAL ROOT ZONES TO BE EXCAVATED USING AN AIR SPADE BY A CERTIFIED ARBORIST ON SITE AND USING PRESCRIBED SOIL TREATMENT. IF ANY ROOTS 1.5" O GREATER ARE ENCOUNTERED DURING EXCAVATION, FOOTING MUST BE MOVED TO AVOID ROCCONTACT ENGINEER FOR DIRECTION OF SHIFT.
- MATERIAL STAGING, DUMPSTER AND SPOILS PLACEMENT CANNOT BE WITHIN THE ½ CRZ OF A PROTECTED TREES. PORTABLE TOILET AND CONCRETE WASHOUT CANNOT BE WITHIN THE FULCRZ OF ANY PROTECTED TREES. COORDINATE EXACT LOCATIONS WITH TREE INSPECTOR DURING PRECONSTRUCTION MEETING.
- WRAP CONNECTIONS OF CONCRETE LINE PUMP WITH PLASTIC TO PREVENT CONCRETE SLURF FROM LEACHING INTO GROUND AND NEAR ROOTS OF TREES.
- IF HEAVY EQUIPMENT WILL BE ROLLING OVER ANY AREA OF THE FULL CRZ OF PROTECTED TREES, PROVIDE 3/4" PLYWOOD OVER 2X4 LUMBER OVER 12" LAYER OF MULCH TO BRIDGE OVI THE ROOTS AND PREVENT SOIL/ROOT COMPACTION. AFTER CONSTRUCTION IS COMPLETED, SPREAD MULCH AROUND SITE TO LEAVE A MAX LAYER OF 3" WITHIN ROOT ZONES.

TREE LIST

1 20" Pecan
2 7" Hackberry
3 22" Live Oak
4 6" Crepe Myrtle
5 11.5" Crepe Myrtle
6 16" Crepe Myrtle
7 5" Crepe Myrtle
8 4" Live Oak
9 3" Live Oak
10 15.5" Hackberry
11 6" Cedar Elm
12 8" Hackberrry
13 20" Pecan
14 5" Red Bud
286 30" Cedar Elm

an north


AREA DESC	CRIPTION	Existing SF to remain	UNIT A	UNIT B	Proposed Exemption	Applied Exemption	Total SF
1st floor con-	ditioned area		876	878			1,754
2nd floor cor	nditioned area - 5' aff		878	905			1,783
3rd floor con	ditioned area - 5' aff						
area w/ ceilir	ngs > 15'						
Ground Floo	r Porch		75	249	full porch	324	0
Basement							
Attic			824	874	attic	1,698	0
Garage	attached		199	XXX	garage	199	0
Garage	detached		XXX	XXX			XXX
Carport	attached		XXX	XXX			XXX
Carport	detached		XXX	200	carport	200	0
Accessory b	uilding(s)						
Totals			2,858	3,106	TOTAL GR	OSS FLOOR AREA	3,537

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LOT Area - 8,842sf x 0.4 = 3,537sf

NOTE: ALL AREAS MEASURED TO THE OUTSIDE FACE OF THE EXTERIOR FINISH MATERIAL.



max height

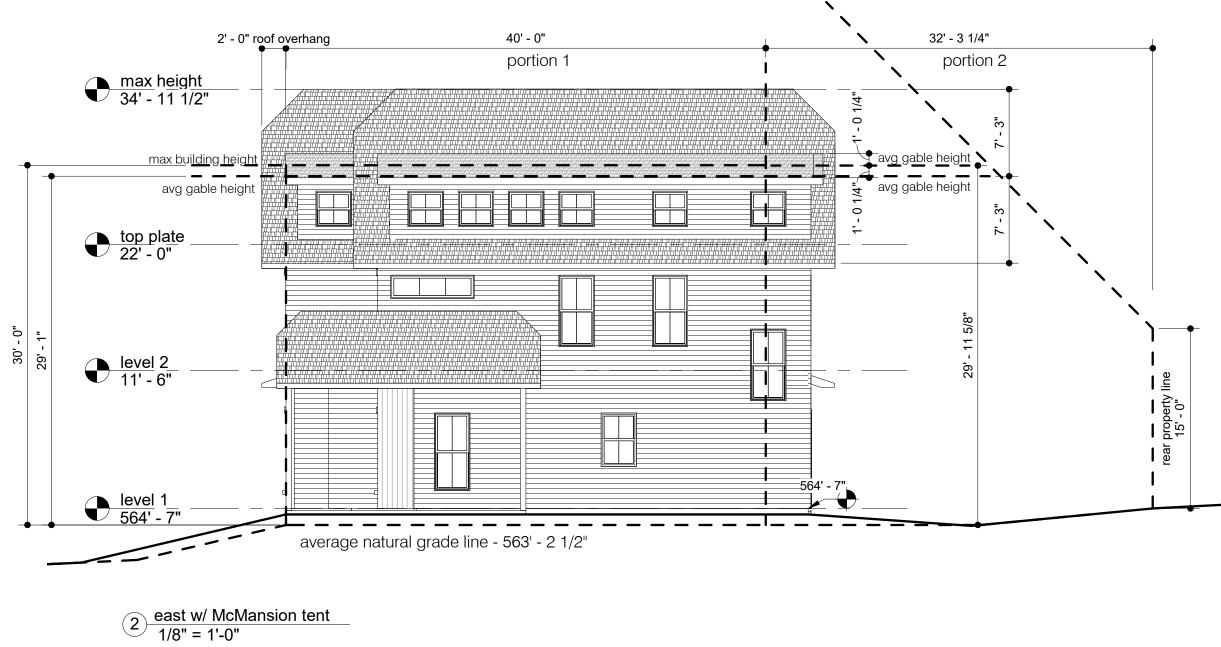34'-11 1/2'

50 plate


22'-0'

level 2

11'-6'

average natural grade line - 563 - 2 1/2"

north w/ McMansion tent 1/8" = 1'-0"

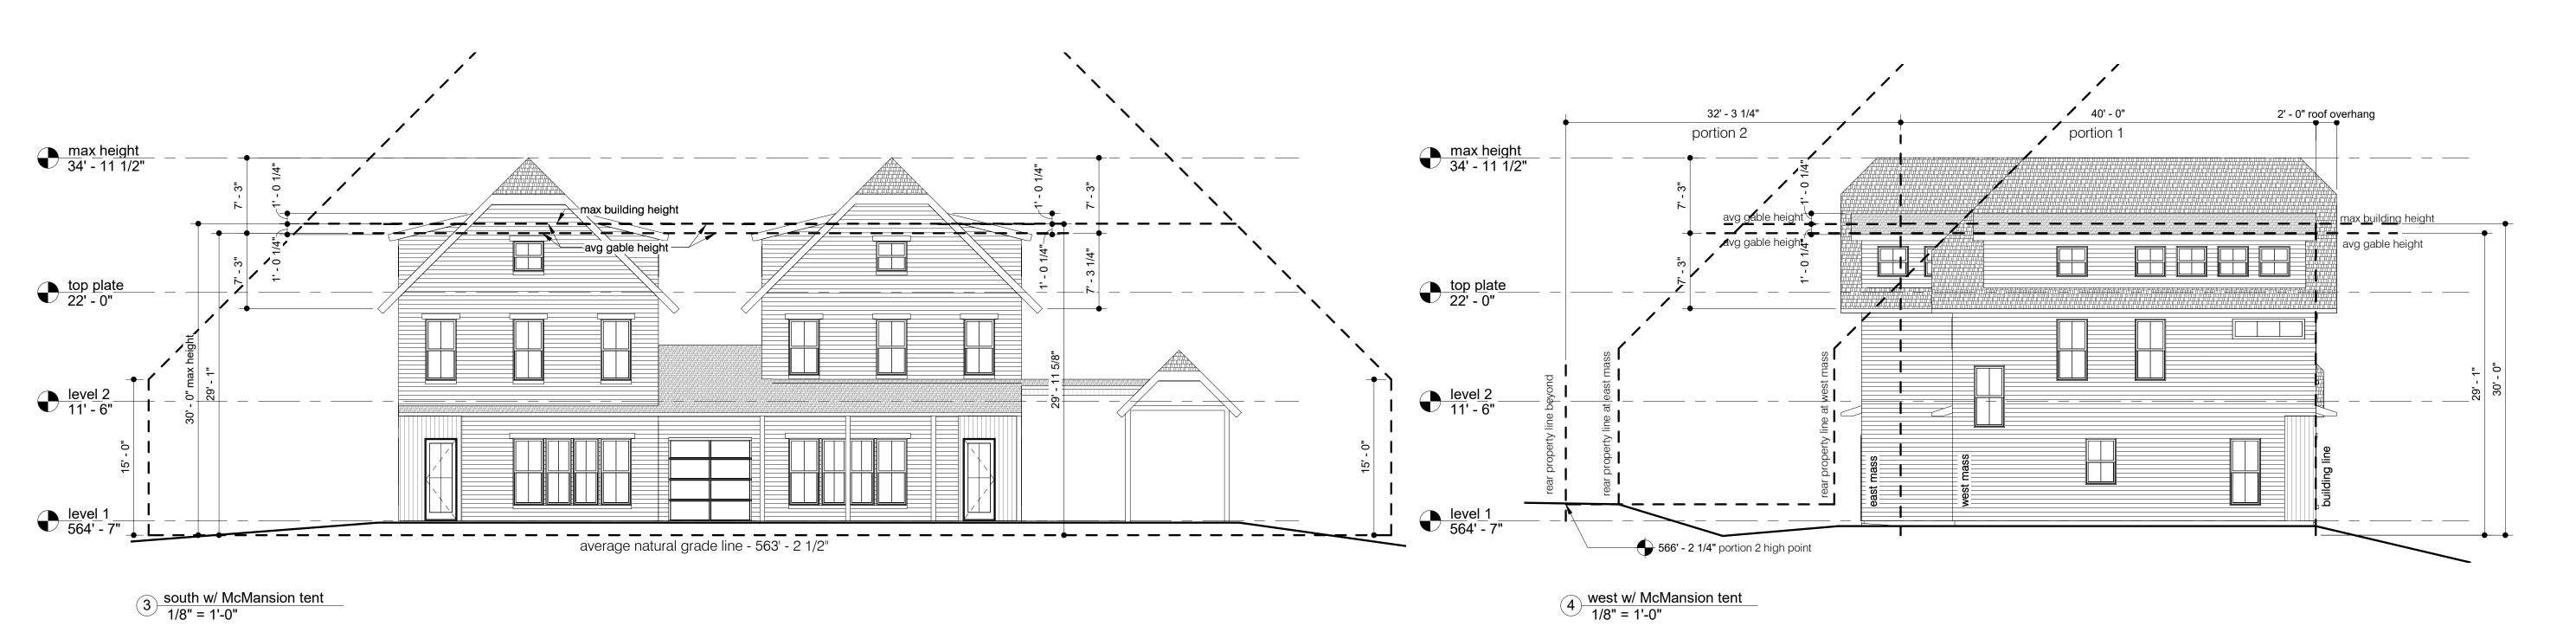

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2020.12.21

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Date
project number

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subchapter f elevations

A002

3D VIEW NOTES

THIS SHEET FOR REFERENCE ONLY, NOT FOR CONSTRUCTION. GRADE NOT SHOWN.



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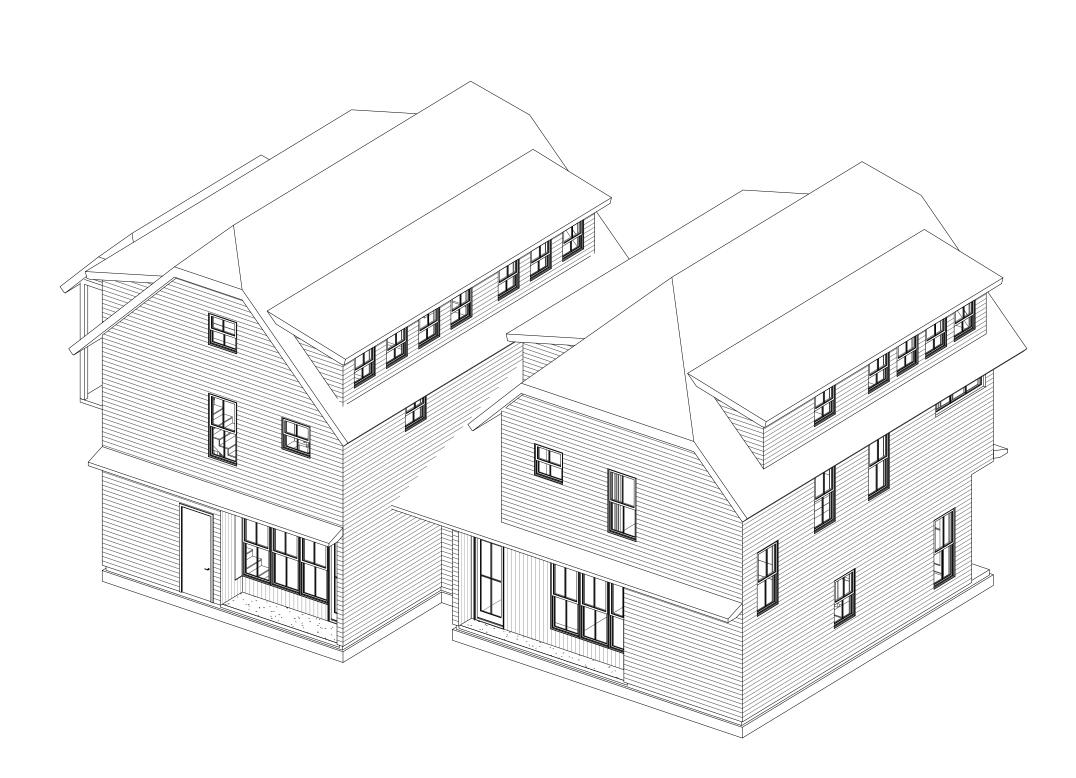
project number


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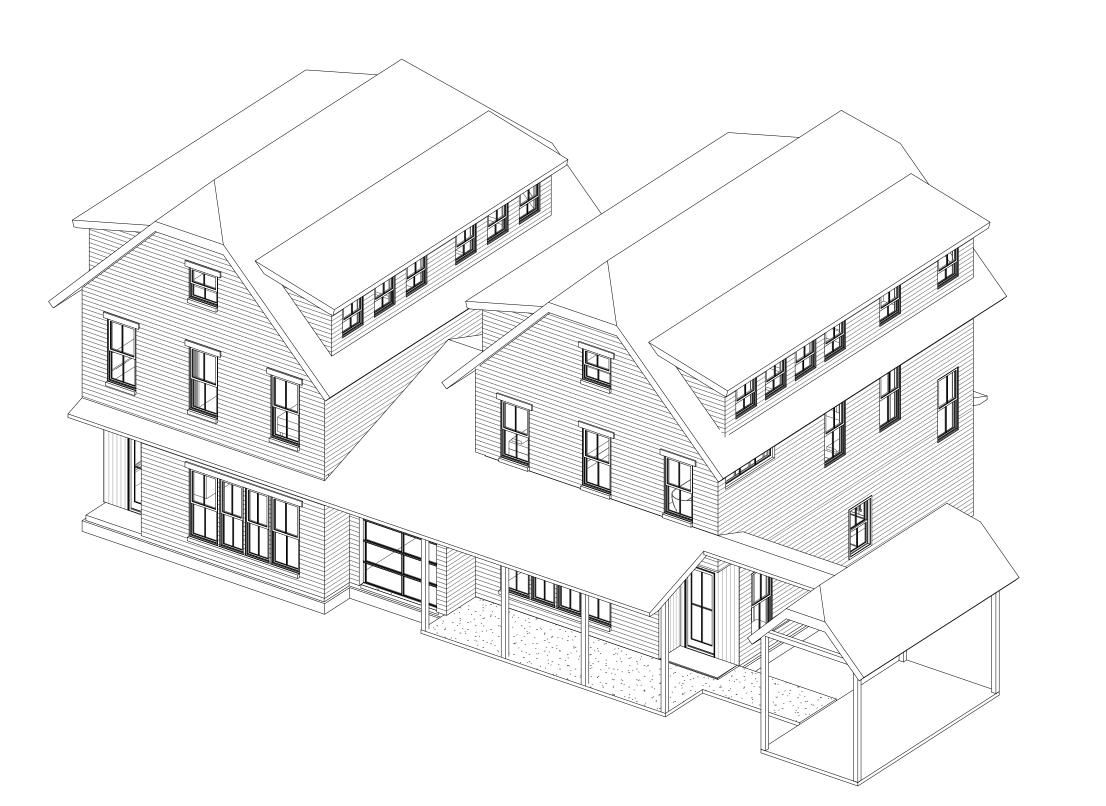
3D views

A004








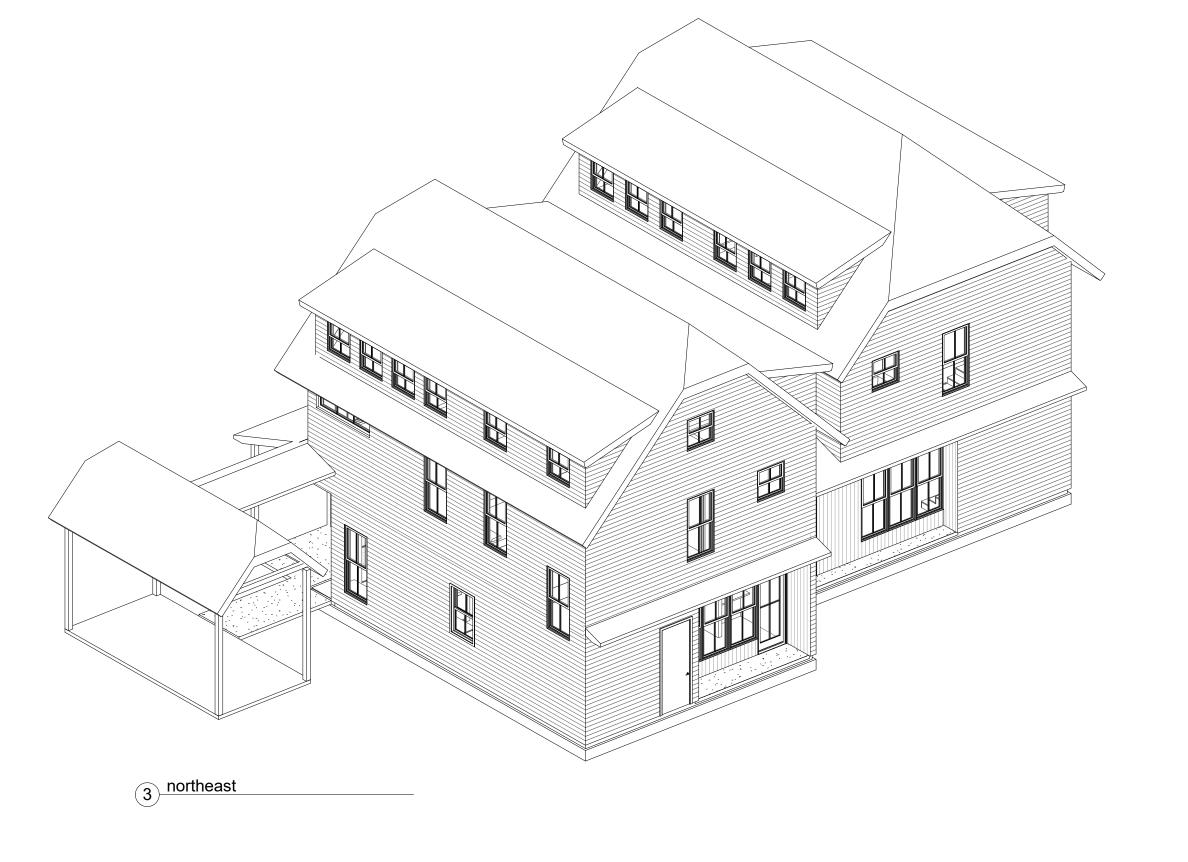

1 southeast

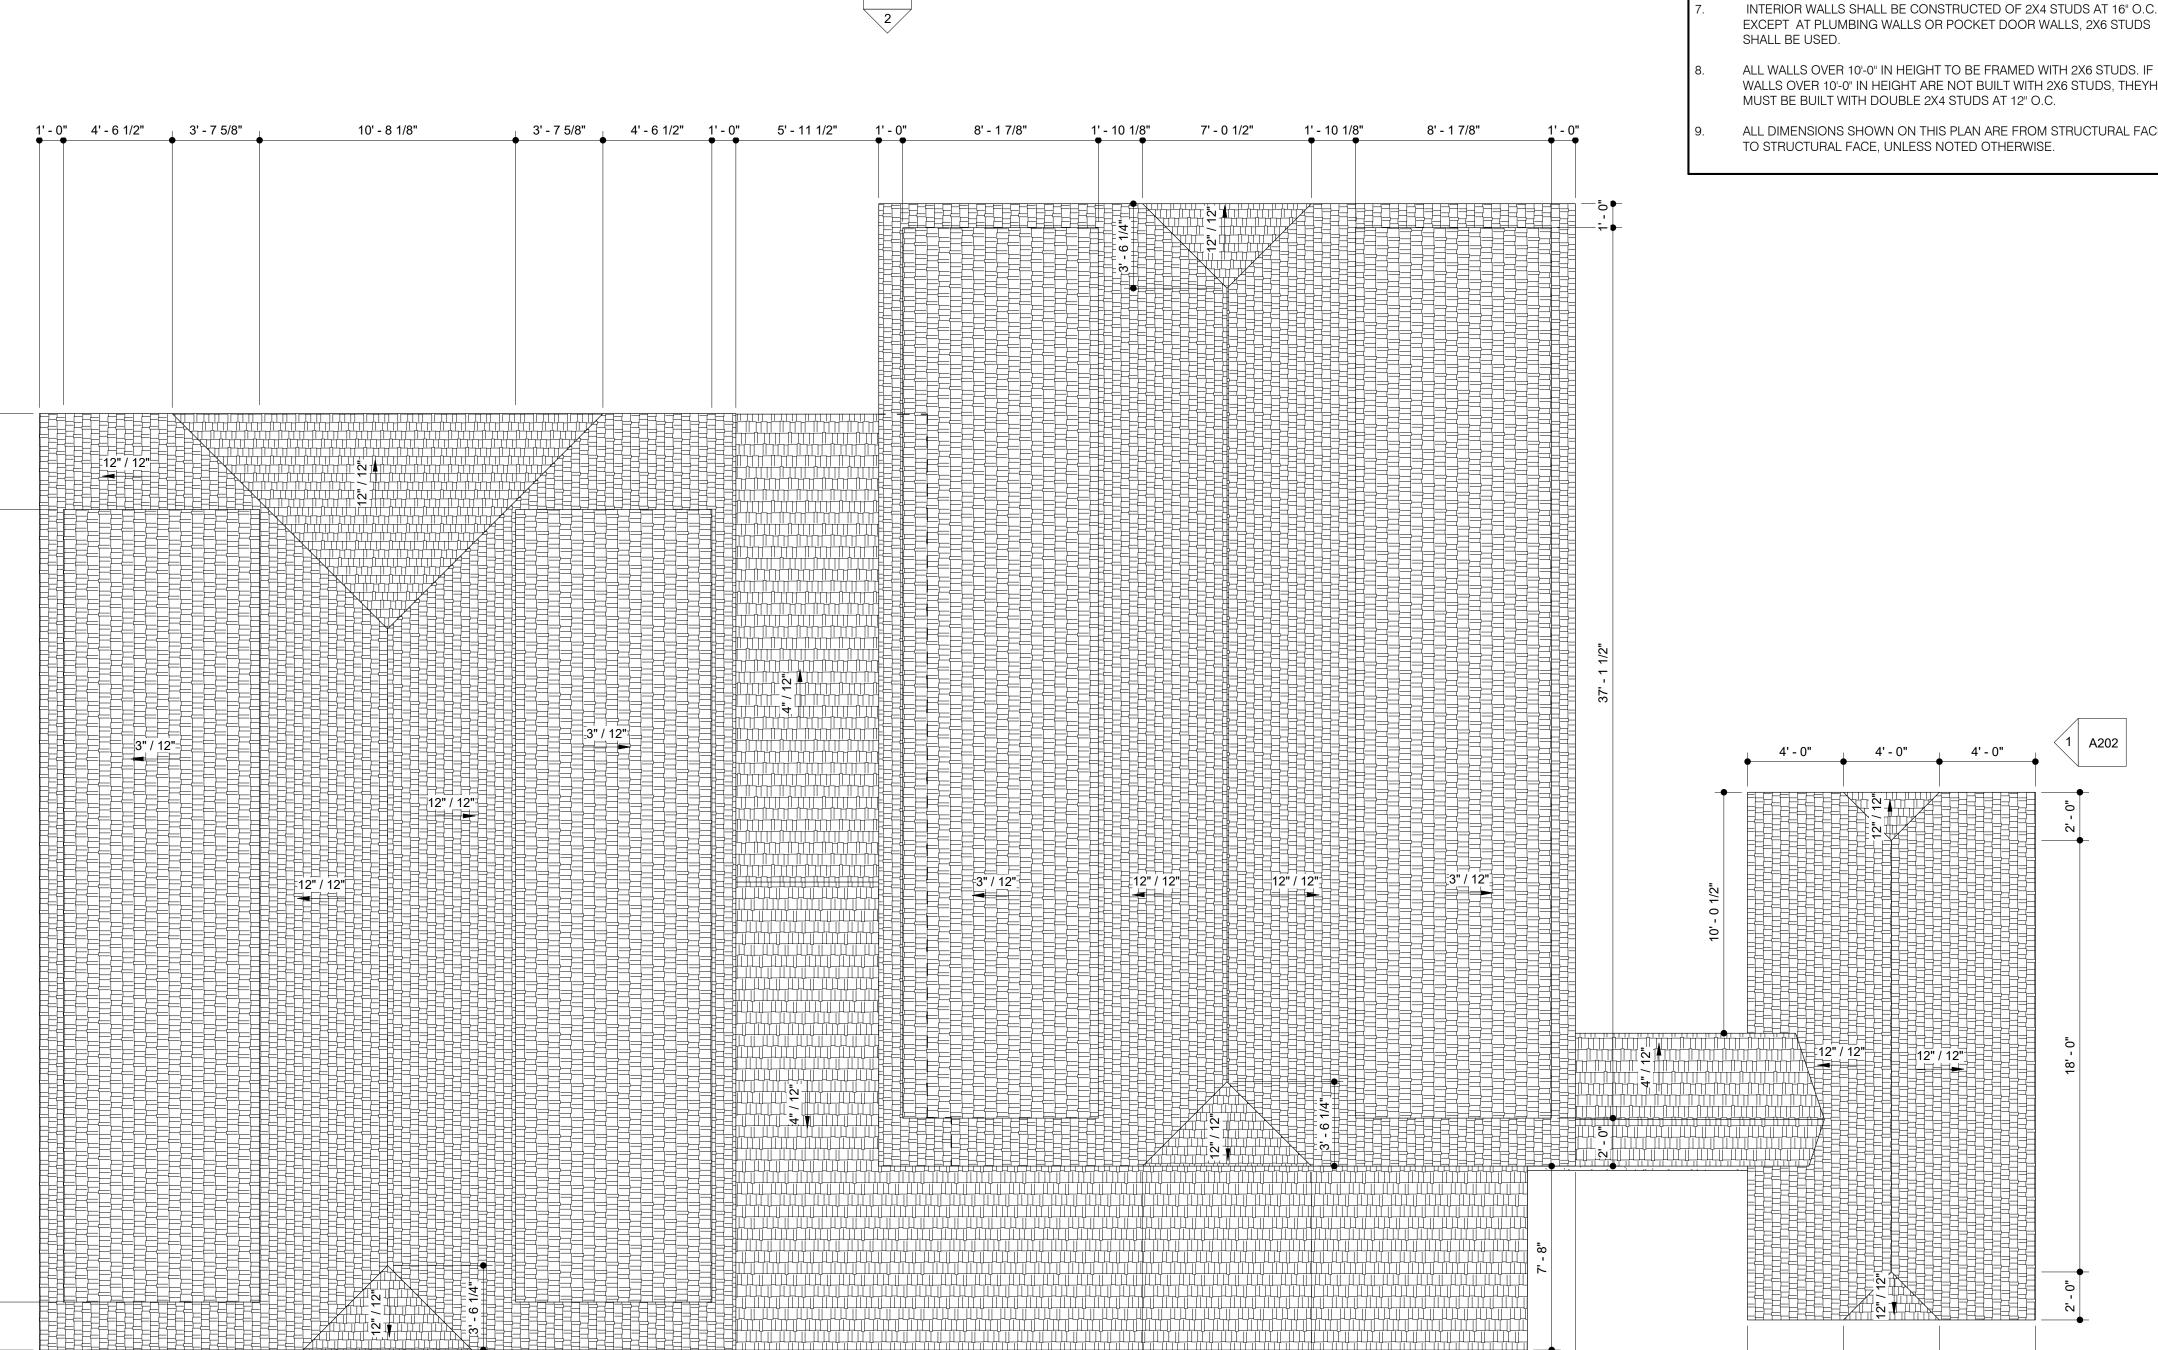

7' - 0 1/2"

11' - 0"

DIMENSION PLAN NOTES

- FIELD VERIFY DIMENSIONS PRIOR TO START OF THE WORK.
- DO NOT SCALE DRAWINGS; WRITTEN DIMENSIONS SHALL GOVERN.
- ALL WINDOWS & DOORS ARE DIMENSIONED TO CENTER LINE UNLESS OTHERWISE NOTED. GLASS SIZE PER MFR SPECS.
- ALL PLUMING EQUIPMENT IS DIMENSIONED TO CENTER LINE UNLESS OTHERWISE NOTED.
- FROM INTERIOR FINISH FLOOR TO ANY EXTERIOR FINISH FLOOR, THE DROP SHALL BE A MINIMUM OF 1/2", UNLESS NOTED OTHERWISE. CONTRACTOR TO VERIFY MATERIALS USED FOR DECK CONSTRUCTION AND FINISH FLOORING TO MAINTAIN MINIMUM DROP.
- SHOWER HEADS SHAL BE MOUNTED 7'-0" A.F.F. UNLESS NOTED OTHERWISE.
- INTERIOR WALLS SHALL BE CONSTRUCTED OF 2X4 STUDS AT 16" O.C., EXCEPT AT PLUMBING WALLS OR POCKET DOOR WALLS, 2X6 STUDS
- WALLS OVER 10'-0" IN HEIGHT ARE NOT BUILT WITH 2X6 STUDS, THEYH
- ALL DIMENSIONS SHOWN ON THIS PLAN ARE FROM STRUCTURAL FACE

4' - 0"

4' - 0"

ANNOTATION PLAN NOTES

- FIELD VERIFY DIMENSIONS PRIOR TO START OF THE WORK.
- DO NOT SCALE DRAWINGS; WRITTEN DIMENSIONS SHALL GOVERN.
- WINDOWS & DOORS SHALL HAVE TEMPERED GLASS OR LAMINATED SAFETY GLASS AS PER APPLICABLE CODES. CONTRACTOR TO COORDINATE W/ MANUFACTURERS.
- CONTRACTOR SHALL COORDINATE W/ WINDOW MANUFACTURER TO VERIFY EGRESSABLE WINDOWS ARE INSTALLED WHERE REQUIRED BY
 - ALL PLUMBING, APPLIANCE & GAS VENTS SHALL VENT TO REAR OF ROOF RIDGE WHEREVER POSSIBLE. ALL VENTS SHALL BE GROUPED TO MINIMIZE ROOF PENETRATIONS.
 - GENERIC SINKS & APPLIANCES SHOWN. COORDINATE ACTUAL SIZE, STYLE & LOCATION W/ OWNER.
- GENERIC MILLWORK SHOWN. COORDINATE FINAL MILLWORK DESIGN & ACCOMPANYING HARDWARE W/ OWNER
- PROVIDE CONTROL & EXPANSION JOINTS AS REQUIRED IN CONCRETE FLOORS, DRIVES, WALKS & PATIOS.
- PROVIDE WEATHERSEALS & SILLS AT ALL EXTERIOR DOOR THRESHOLDS.
- FROM INTERIOR FINISH FLOOR TO ANY EXTERIOR FINISH FLOOR, THE DROP SHALL BE A MINIMUM OF 1/2", UNLESS NOTED OTHERWISE. CONTRACTOR TO VERIFY MATERIALS USED FOR DECK CONSTRUCTION AND FINISH FLOORING TO MAINTAIN MINIMUM DROP.
- SHOWER HEADS SHALL BE MOUNTED 7'-0" A.F.F. UNLESS NOTED OTHERWISE.
- ALL INTERIOR WALLS SHALL BE CONSTRUCTED OF 2X4 STUDS AT 16" O.C., EXCEPT AT PLUMBING WALLS OR POCKET DOOR WALLS.
- 12. ALL WINDOWS WITHIN 24" OF AN EXTERIOR OR INTERIOR DOOR TO BE TEMPERED GLASS. WINDOW MANUFACTURER TO VERIFY FOR ALL TEMPERED GLASS LOCATIONS AS PER APPLICABLE CODE.
- 13. ALL HINGED SHOWER DOORS SHALL SWING OUTWARD. GLAZING USED IN DOORS AND PANELS OF SHOWER ENCLOSURES SHALL BE FULLY TEMPERED OR LAMINATED SAFETY GLASS.
- 14. THESE DOCUMENTS REFLECT NOMINAL WINDOW SIZES, UNLESS NOTED OTHERWISE.
- 15. PROVIDE BLOCKING FOR CEILING FANS AS REQUIRED.
- 16. BUILDER TO VERIFY SIZING AND LOCATION OF ALL APPLANCES & RELATED COMPONENTS
- 17. WEATHERSTRIP ATTIC ACCESS DOORS.
- 8. ALL WALLS OVER 10'-0" IN HEIGHT TO BE FRAMED WITH 2X6 STUDS. IF WALLS OVER 10'-0" IN HEIGHT ARE NOT BUILT WITH 2X6 STUDS, THEYH MUST BE BUILT WITH DOUBLE 2X4 STUDS AT 12" O.C.
- PROVIDE BLOCKING FOR HANDRAIL MOUNTING AT STAIRS AS NECCESARY.
- PROVIDE BLOCKING AND/OR PROPER SUPPORT FOR SHOWER
- GC TO PROVIDE CODE COMPLIANT MANUFACTURED SPIRAL STAIR;
- COORDINATE LOCATIONS & CONFIGURATION WITH OWNER.

ROOF PLAN NOTES

- ROOF PITCHES AS NOTED ON DRAWINGS.
- ALL PLUMBING, APPLIANCE & GAS VENTS SHALL VENT TO REAR OF ROOF RIDGE WHEREVER POSSIBLE. ALL VENTS SHALL BE GROUPED TO MINIMIZE ROOF PENETRATIONS.
- ALL EXTERIOR OPENINGS SHALL BE LOAD BEARING.
- CONTRACTOR AND HIS/HER SUBCONTRACTORS ACCEPT FULL RESPONSIBILITY TO ENSURE THAT BUILDING IS CODE COMPLIANT.
- CONTRACTOR SHALL ACCEPT FULL LIABILITY FOR ANY CHANGES MADE TO THE DRAWINGS W/ OUT VERIFYING W/ THE ARCHITECT.
- THE DESIGN & SIZING OF ALL STRUCTURAL MEMBERS IS THE RESPONSIBILITY OF THE ENGINEER CHOSEN BY THE CONTRACTOR/OWNER.
- RIDGES & VALLEYS TO BE FRAMED ONE SIZE LARGER THAN RAFTERS.
- ALL OVERHANGS TO BE 3" FROM THE FRAME WALL UNLESS NOTED OTHERWISE.
- WHEN ENGINEERED TRUSSES ARE USED, TRUSS DESIGN & SPACING SHALL BE PER ENGINEERI'S SPECIFICATIONS.
- WALLS OVER 10'-0" IN HEIGHTS ARE NOT BUILT WITH 2X6 STUDS, THEY MUST BE BUILTWITH DOUBLE 2X4 STUDS AT 12" O.C.

ALL WALLS OVER 10'-0" IN HEIGHT TO BE FRAMED WITH 2X6 STDUS. IF

- 11. IN VENTED ROOF ASSEMBLIES PROVIDE 1 S.F. NET FREE AREA OF ATTIC VENTILATION PER 150 S.F. OR TOTAL COVERED ROOF AREA AS PER CODE.
- 12. U.N.O. ALL INTERIOR WALLS OF ONE STORY PLAN TO BE LOAD BEARING.
- REFERENCE ALSO BUILDING ELEVATIONS, BUILDING SECTIONS, WALL SECTIONS, AND DETAILS.

Keynote Legend - Visitability

Key Value Keynote Text



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alan knox, aia

by, or under the supervision of:

21945

2020.12.21

No.	Description	Date

2020.12.21 Date

project number 1114

Drawn by Checked by

roof plan





11' - 0"

7' - 0 1/2"

11' - 0"

62' - 0 1/2"

A201





BLDG ELEVATION NOTES

DO NOT SCALE DRAWINGS; WRITTEN DIMENSIONS SHALL GOVERN.

2. REF A101 FLOOR PLAN.

CONTRACTOR TO PROVIDE RAINSCREEN & FLASHING FOR ALL WINDOWS & DOORS FOR PROPER DRAINAGE.

CONTRACTOR TO PROVIDE RAINSCREEN & FLASHING FOR ALL BRICK/MASONRY WALLS FOR PROPER DRAINAGE.

GRADE LINES SHOWN ON DRAWINGS ARE FOR REPRESENTATIONAL PURPOSES ONLY. REFER TO CIVIL DRAWINGS FOR ACTUAL GRADE ELEVATIONS.

ALL PLUMBING, APPLIANCE & GAS VENTS SHALL VENT TO REAR OF ROOF RIDGE WHEREVER POSSIBLE. ALL VENTS SHALL BE GROUPED TO MINIMIZE ROOF PENETRATIONS.

PAINT ALL GUTTERS & DOWNSPOUTS TO MATCH FIBER CEMENT SIDING.

Keynote Legend - Elevations

Key
Value

Keynote Text



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alan knox, aia # 21945

by, or under the supervision of:

2020.12.21

1114

No.	Description	Date
Date	2020	0.12.21

Date

project number

Drawn by
Checked by

building elevations

A201





east elevation

<u>west elevation</u>
1/4" = 1'-0"

BLDG ELEVATION NOTES

DO NOT SCALE DRAWINGS; WRITTEN DIMENSIONS SHALL GOVERN.

REF A101 FLOOR PLAN.


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PAINT ALL GUTTERS & DOWNSPOUTS TO MATCH FIBER CEMENT SIDING.



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1510 palma plaza

review set

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by, or under the supervision of:

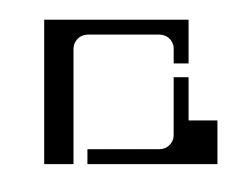alan knox, aia

2020.12.21

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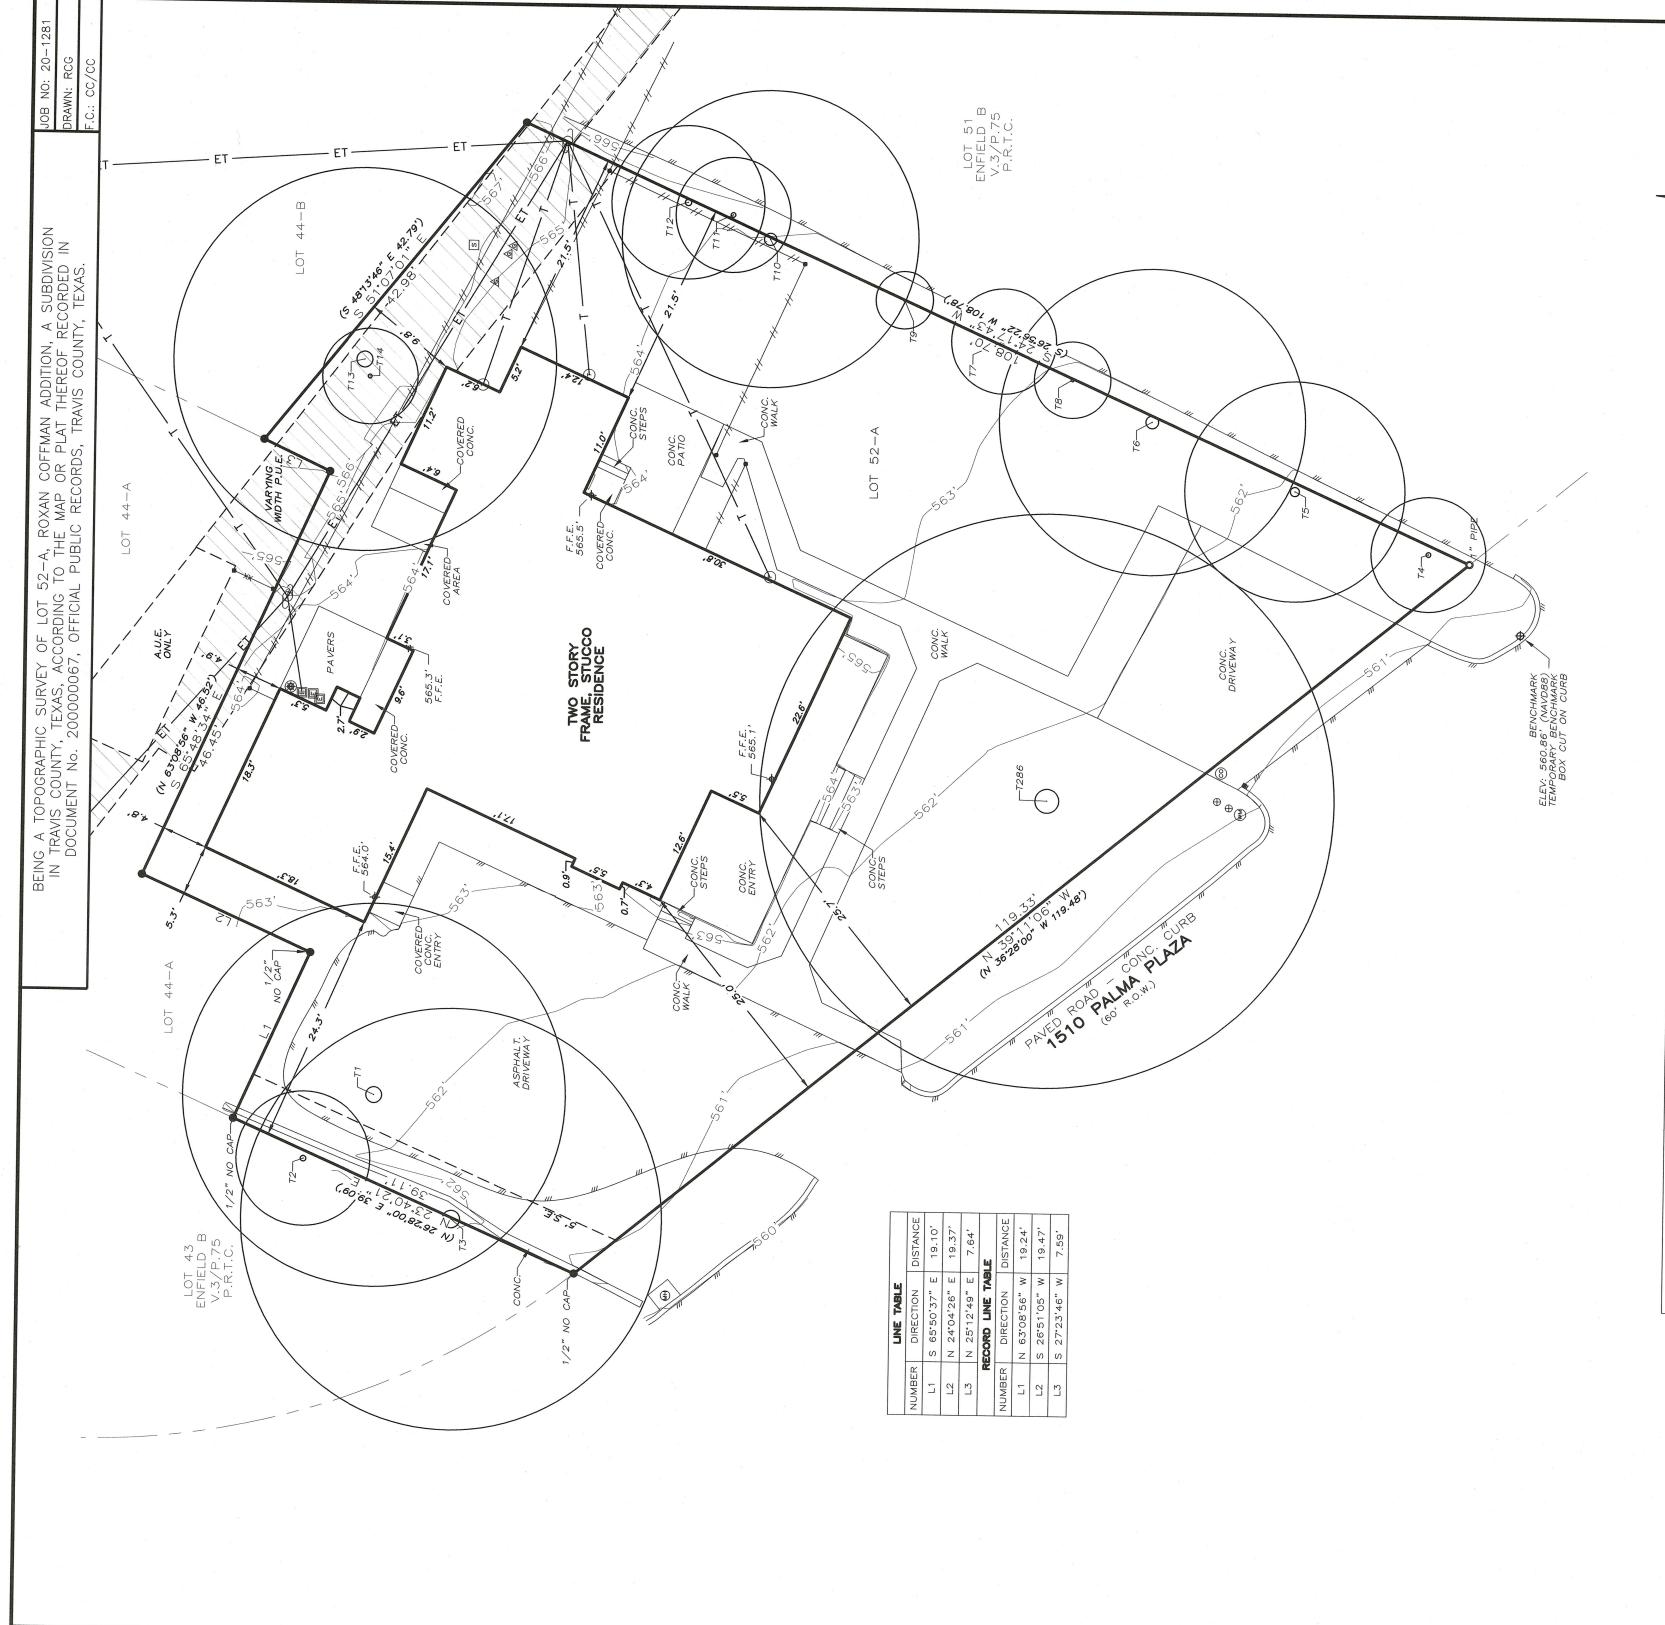
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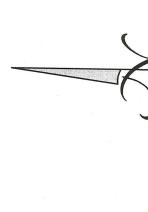
project number

Drawn by Checked by

building elevations



		TREE LIST	
TAG#	TYPE	CHARACTERISTICS	DIAMETER (INCHES)
. —	PECAN	SINGLE	20,,
7	HACKBERRY	3×	4" 3" 3"
М	LIVE OAK	SINGLE	22"
4	CREPE MYRTLE	3×	3" 3" 3"
Ŋ	CREPE MYRTLE	XX	6" 6" 5"
9	CREPE MYRTLE	7×	5" 4" 4" 4" 3" 3"
7	CREPE MYRTLE	**************************************	2" 2" 2" 2"
∞	LIVE OAK	SINGLE	.*4
თ	LIVE OAK	SINGLE	23.
10	HACKBERRY	3×	9" 7" 6"
<u></u>	CEDAR ELM	SINGLE	9
12	HACKBERRY	SINGLE	~ ~
 13	PECAN	SINGLE	20,,
 4	RED BUD	SINGLE	"n
286	CEDAR ELM	SINGLE	30,,



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SURVEY PERFORMED WITHOUT THE HEREON MAY AFFECT.
STATE OF TEXAS

EAR TO BE IN AREAS PER E RATE MAP N. 22, 2020, AADE IN LIEU

THIS AREA SPECIAL FEMA'S FI #48453CO4 THIS STATE

\$ K
COUNTY OF WILLIAMSON \$
THAT SURVEYOR FOR TEXAS L
SURVEY UNDER MY SUPERVISIN
THERE ARE NO DISCREPANCIES
PLACE, AND THAT SAIN FOR

ING, INC., HAVE THIS DATE CAUSED TO BE PERFORMED AN ON—THE—GROUND FOREGOING TRACT OF LAND AND TO THE BEST OF MY KNOWLEDGE AND BELIEF, SHORTAGES IN AREA, ENCROACHMENTS, VISIBLE UTILITY LINES OR ROADS IN A DEDIICATED ROADWAY. EXCEPT AS SHOWN HEREON.

Curveying, Land Texas o

Inc.

3613 Williams (512) 930– ELS LAND SURVE EINT DOES NOT CONTAIN SYAS LAND SURVEYING, IN

Photos of Existing Structure



Rotted cedar stump post



CMU blocks used as posts



Cracks from shifting foundation



Compromised wall system



Front Facade





East Facade

