

LIST OF DRAWINGS	
1910	SITE PLAN: DEMOLITION SITE PLAN: NEW GENERAL NOTES
BUILDINGS 1: NEW CONSTRUCTION	
A1-1	FLOOR PLANS: LEVEL-1 FLOOR PLANS: LEVEL-2
A1-2	FLOOR PLAN: HABITABLE ATTIC HIGH ROOF PLAN
A1-3	EXTERIOR ELEVATIONS: PLAN EAST PLAN SOUTH
A1-4	EXTERIOR ELEVATIONS: PLAN WEST PLAN NORTH
A1-5	BUILDING SECTIONS OUTLINE SPECIFICATIONS MISC SCHEDULES
A1-6	ELECTRICAL PLANS LEVEL-1 LEVEL-2 LEVEL-3
BUILDING 2: EXISTING-REMODEL	
A2-1	FLOOR PLANS: LEVEL-1 FLOOR PLANS: LEVEL-2
A2-2	EXTERIOR ELEVATIONS
A2-3	ELECTRICAL PLANS ROOF PLAN

JOINT USE ACCESS AGREEMENT NOTE


PER RESEARCH BY ARTHUR WALSTON OF THE CITY OF AUSTIN OFFICE OF REAL ESTATE SERVICES, AS DESCRIBED IN EMAILS ON OR AROUND 01.13.20, THE ACCESS EASEMENT REFERENCED IN THE PROPERTY DEEDS WERE NOT FORMALLY RECORDED WITH THE CITY OF AUSTIN, SO IT IS NOT NECESSARY TO SUBMIT OR OBTAIN AN EASEMENT RELEASE APPLICATION TO THE OFFICE OF REAL ESTATE SERVICES

DATE: _____

REVISION DESCRIPTION

04 NOVEMBER 2020
PERMIT REVISION

The Texas Board of Architectural
Examiners, P.O. Box 12337, Austin, Texas
78711-2337 or 333 Guadalupe, Suite
2-350, Austin, Texas 78701-3942, (512)
305-9000, has jurisdiction over
individuals licensed under the Architects'
Registration Law, Texas Civil Statutes,
Article 249a.
This file is an instrument of service and
is to be used solely for the purposes
stipulated under separate executed
contracts with the Architect. This
document is copyrighted and is not to be
used, duplicated or otherwise modified
except with express permission of the
Architect.

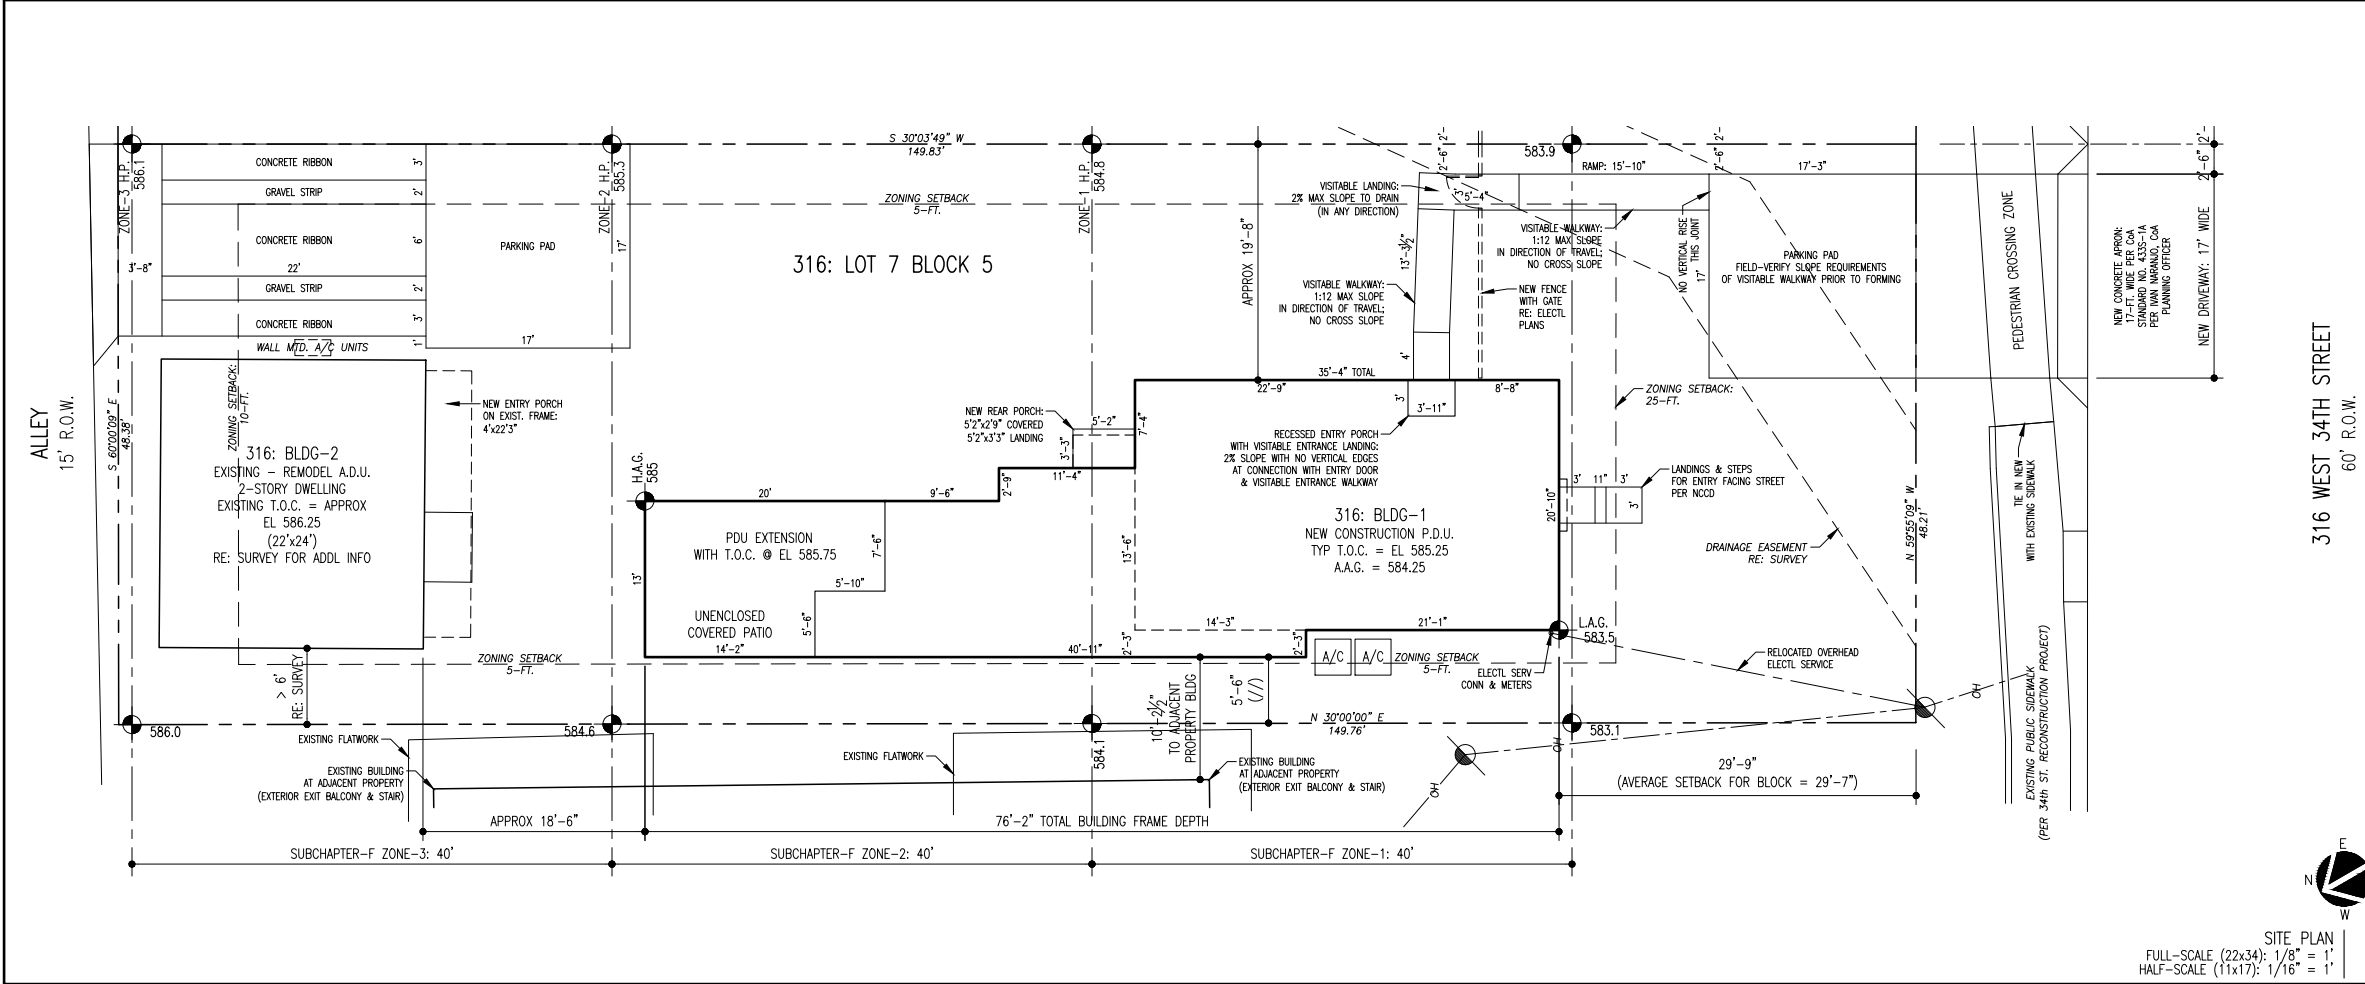

GENERAL NOTES

ALL WORK DESCRIBED BY THESE DOCUMENTS SHALL BE PERFORMED IN FULL COMPLIANCE WITH ALL APPLICABLE CODES AS MANDATED BY ALL GOVERNING JURISDICTIONS

DRAWINGS AND DOCUMENTS ARE GENERAL IN NATURE AND DO NOT INCLUDE OR ANTICIPATE EVERY CONDITION POSSIBLE

CONTRACTOR AND SUBCONTRACTORS SHALL REVIEW THESE DRAWINGS AND MAKE A DETAILED SITE VISIT TO REVIEW FIELD CONDITIONS: REPORT DISCREPANCIES.

WRITTEN DIMENSIONS GOVERN: DO NOT SCALE DRAWINGS

MATERIALS AND EQUIPMENT SHALL BE INSTALLED IN FULL ACCORDANCE WITH THE MANUFACTURER PUBLISHED INSTRUCTIONS AND/OR RECOMMENDATIONS

THESE DRAWINGS AND SPECIFICATIONS WHEN ISSUED ARE THE PROPERTY OF THE DESIGN COMPANY AND/OR ARCHITECT FOR THIS SPECIFIC ADDRESS

SITE PLAN IS BASED ON SURVEY INFORMATION PROVIDED BY OWNER AND SHALL BE VERIFIED PRIOR TO CONSTRUCTION BY GENERAL CONTRACTOR

PROJECT MAY BE SUBJECT TO EASEMENTS, COVENANTS, CONDITIONS, OR OTHER LIMITATIONS, OF WHICH THE DESIGN COMPANY AND/OR ARCHITECT HAS NOT BEEN INFORMED: OWNER TO VERIFY

TREES SHALL BE PROTECTED IN ACCORDANCE WITH REGULATING AUTHORITY'S RULES AND REGULATIONS

FAILURE TO ABIDE BY THE ABOVE INFORMATION, AND/OR FAILURE TO ABIDE BY COMMONLY ACCEPTED PRACTICES, SHALL ALLEVIATE THE DESIGN COMPANY AND/OR ARCHITECT FROM LIABILITY

REFER TO SITE DEVELOPMENT INFORMATION (SEPARATE DOCUMENT) FOR PROJECT DATA

ABBREVIATIONS:
AVERAGE ADJACENT GRADE A.A.G.
HIGH ADJACENT GRADE H.A.G.
LOW ADJACENT GRADE L.A.G.
TOP OF CONCRETE T.O.C.

DRAWING TITLE:	
DATE:	AS NOTED
PROJECT:	1910: 316
SCALE:	AS NOTED
DRAWN:	DPB
SHEET:	516

316 WEST 34th STREET
AUSTIN TX 78705

TWO-FAMILY PROJECT:
PDU: NEW CONSTRUCTION
ADU: ADDITION-REMODEL

ZONING: SF-3--NCCD--NP

BOREN
ARCHITECTS
512.554.5474

DRAWING TITLE:

DATE: AS NOTED

PROJECT: 1910: 316


SCALE: AS NOTED

DRAWN: DPB

SHEET: 516



410	28' SETBACK PER FIELD-MEASURE	01
408	27.5' SETBACK PER FIELD-MEASURE	02
406	26' SETBACK PER FIELD-MEASURE	03
404	27' SETBACK PER FIELD-MEASURE	04
402	27' SETBACK PER FIELD-MEASURE	05
400	MULTI-FAMILY USE APARTMENT BUILDING EXEMPT FROM SETBACK AVERAGING	06
316	24'-9" SETBACK PER SURVEY (NOT INCLUDED IN DATA FOR 316)	07
314	34'-3" SETBACK PER SURVEY (NOT INCLUDED IN DATA FOR 314)	08
312	29' SETBACK PER FIELD-MEASURE	09
310	39' SETBACK PER FIELD-MEASURE	10
308	25' PER PERMIT HISTORY DOCUMENTS	11
306	36'-2" PER PERMIT HISTORY DOCUMENTS	12
304	30' SETBACK PER FIELD-MEASURE	13
302	29' SETBACK PER FIELD-MEASURE	14
300	31' SETBACK PER FIELD-MEASURE	15



04 NOVEMBER 2020
PERMIT REVISION


The Texas Board of Architectural Examiners, P.O. Box 12337, Austin, Texas 78711-2337 or 333 Guadalupe, Suite 2-350, Austin, Texas 78701-3942, (512) 305-9000, has jurisdiction over individuals licensed under the Architects' Registration Law, Texas Civil Statutes, Article 249a.

This file is an instrument of service and is to be used solely for the purposes stipulated under separate executed contracts with the Architect. This document is copyrighted and is not to be used, duplicated or otherwise modified except with express permission of the Architect.

316 WEST 34th STREET
AUSTIN TX 78705

TWO-FAMILY PROJECT:
PDU: NEW CONSTRUCTION
ADU: ADDITION-REMODEL

ZONING: SF-3-NCCD-NP



512.554.5474

DRAWING TITLE:

DATE: AS NOTED

PROJECT: 1910: 316

SCALE: AS NOTED

DRAWN: DPB

SHEET: 316

DATA FOR 316 WEST 34th STREET

DATA THIS SHEET TAKEN FROM FIELD-MEASUREMENTS

LISTED DATA BELOW ORGANIZED FROM PROPERTIES WEST TO EAST

1.	28'-0"	
2.	27'-6"	
3.	21'-0"	
4.	27'-0"	
5.	27'-0"	
6.	APT BLDG	NOT APPLICABLE
7.	24'-9"	SUBJECT TRACT - NOT INCLUDED IN DATA
8.	34'-3"	
9.	29'-0"	
10.	39'-0"	
11.	26'-0"	
12.	36'-2"	
13.	30'-0"	
14.	29'-0"	
15.	31'-0"	

TOTALS:
384'-11" DIVIDED BY 13 APPLICABLE LOTS

AVERAGE SETBACK FOR BLOCK:
29'-7"

DATA FOR 314 WEST 34th STREET

DATA THIS SHEET TAKEN FROM FIELD-MEASUREMENTS


LISTED DATA BELOW ORGANIZED FROM PROPERTIES WEST TO EAST

1.	28'-0"	
2.	27'-6"	
3.	21'-0"	
4.	27'-0"	
5.	27'-0"	
6.	APT BLDG	NOT APPLICABLE
7.	24'-9"	SUBJECT TRACT - NOT INCLUDED IN DATA
8.	34'-3"	
9.	29'-0"	
10.	39'-0"	
11.	26'-0"	
12.	36'-2"	
13.	30'-0"	
14.	29'-0"	
15.	31'-0"	

TOTALS:
375'-0" DIVIDED BY 13 APPLICABLE LOTS

AVERAGE SETBACK FOR BLOCK:
28'-7"

City of Austin
REVIEWED FOR CODE COMPLIANCE
A0-1

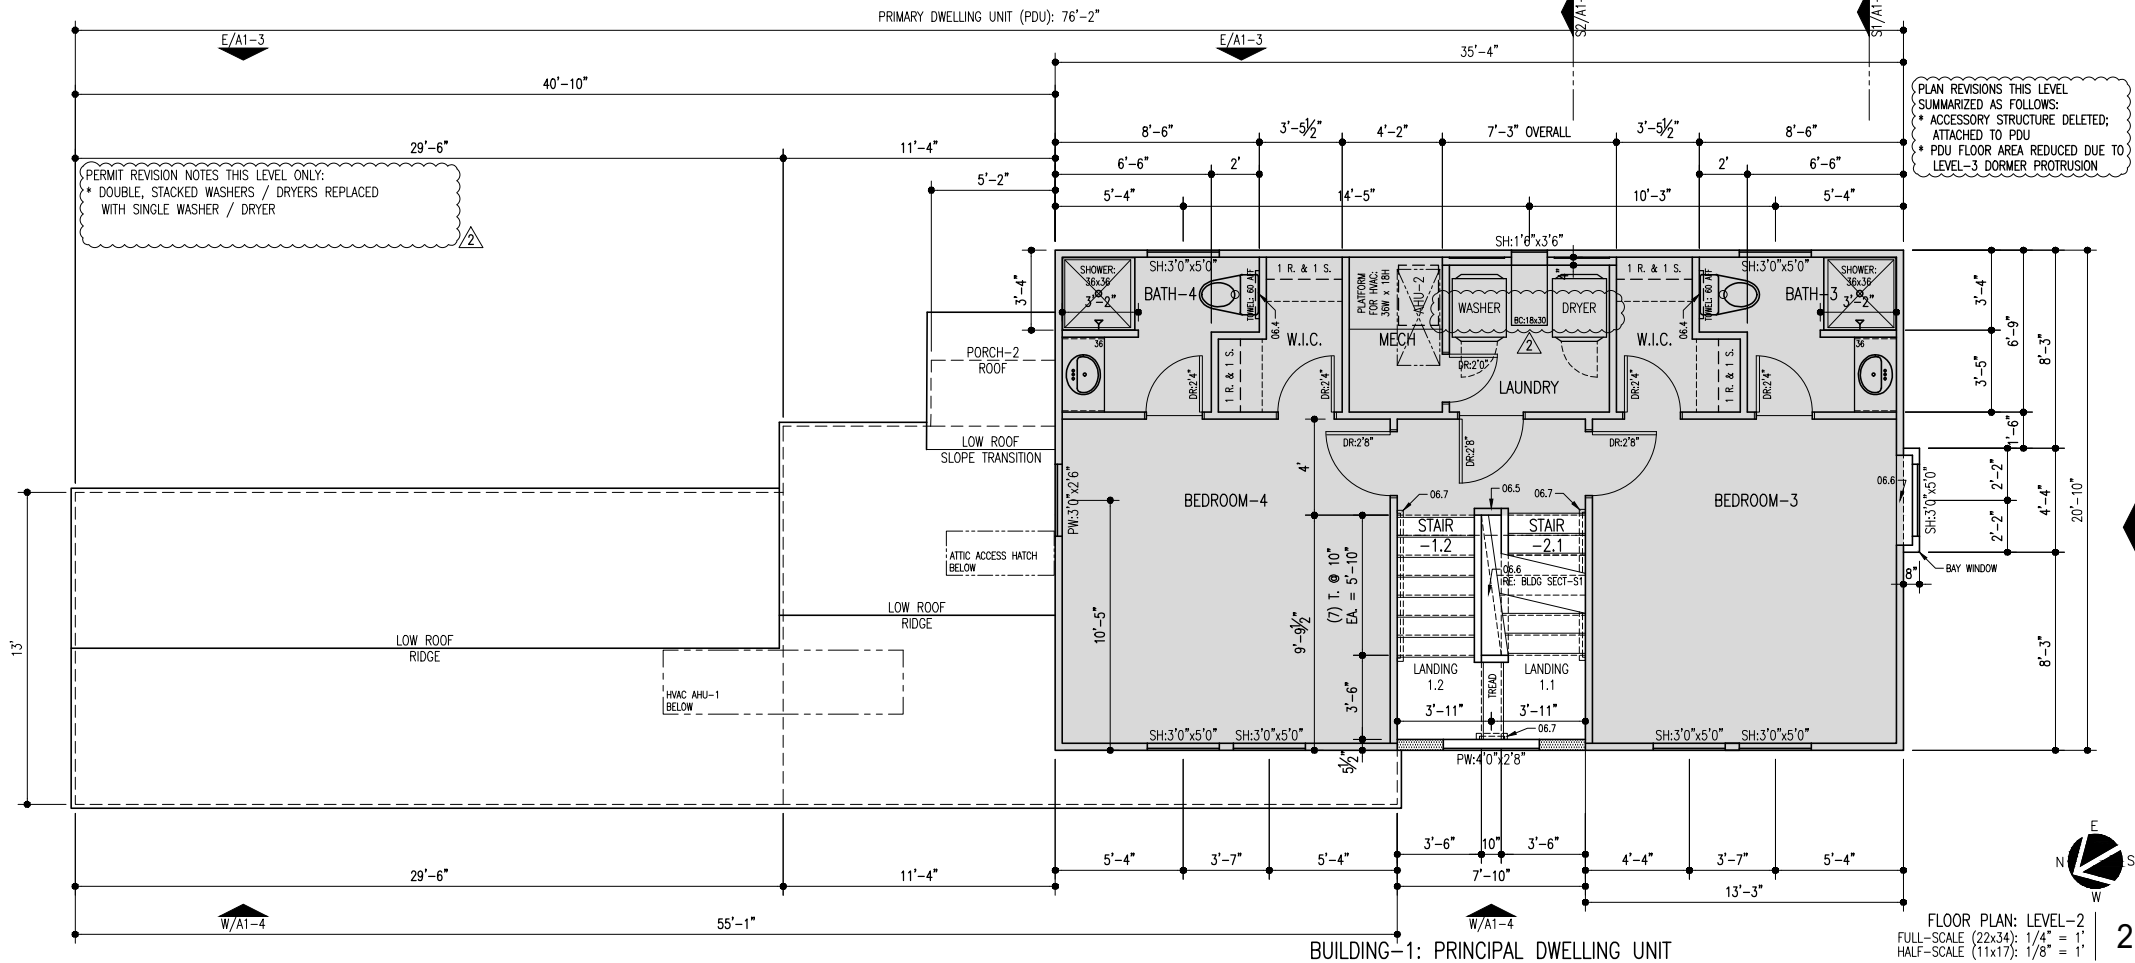

- KEYNOTES LEGEND**
- KEYNOTES ARE ORGANIZED IN GENERAL CSI SPECIFICATION FORMAT:
SEE OUTLINE SPECIFICATIONS THIS PACKAGE FOR ADDL INFO
- 01.1 VISIBILITY: INTERIOR ROUTE OF TRAVEL
01.2 VISIBILITY: 30 x 30 REQD CLEAR FLOOR AREA
* SEE VISIBILITY NOTES FOR ADDL INFO THIS ROOM
- 02.0 EXISTING GRADE TO REMAIN OR BE MODIFIED WHERE NOTED
02.1 NEW PAVEMENT: SLOPE TO DRAIN @ 2% MIN. OR AS NOTED
02.2 NEW FINISH GRADING: SLOPE TO DRAIN @ 2% MIN.
- 03.1 CONC FOUNDATION PER STRUCTL
03.2 CONC FOUNDATION PER STRUCTL: SLOPE TO DRAIN AS NOTED
03.3 CONC FOUNDATION PER STRUCTL: SPECIAL FEATURE AS NOTED
03.4 CONC FOUNDATION SLOPE TRANSITION: NO VERTICAL EDGE
03.5 CONC FOUNDATION STEPMALL: 4-IN. W. x 6-IN. H.
- 04.0 EXISTING CONCRETE MASONRY UNIT WALL
- 05.1 STEEL LINTEL AT NEW WALL OPENING AT EXISTING CMU WALL
- 06.0 EXISTING WOOD FRAMING ELEMENT
06.1 WOOD FLOOR OR ROOF FRAMING PER STRUCTL
06.2 EDGE OF FRAMING
06.3 LOWER CEILING OR FURR DOWN: DEPTH PER PLAN OR SECTION
06.4 2x6 MIN. BLOCKING IN STUD WALL CENTERED AS NOTED
06.5 PARTIAL-HEIGHT FRAMING: 40-IN. H. NOM. WITH DIVISION-09 CAP TRIM
06.6 INTERIOR PLATFORM: AS NOTED WITH DIVISION-09 CAP TRIM
06.7 STAINED WOOD HANDRAIL
- 07.0 EXISTING SIDING TO REMAIN: REFURBISH AS REQUIRED
07.1 SIDING TYPE-1: PLANKS WITH 10.75-IN. EXPOSURE TYP U.N.O.
07.2 SIDING TYPE-2: PLANKS WITH 4-IN. EXPOSURE
07.3 ROOF EDGE: 2x8 NOM @ TYPE-1 & 1x6 NOM @ TYPE-2
07.4 EXTERIOR TRIM AS SCHEDULED
07.5 EXTERIOR CEILING AS SCHEDULED
07.6 NEW SIDING TO MATCH EXISTING AT WINDOW OR DOOR INFILL
- 08.0 EXISTING DOOR OR WINDOW PER REMODEL PLAN NOTES
08.1 SCHEDULED DOOR
08.2 SCHEDULED WINDOW
- 12.1 MILLWORK: ISLAND WITH BASE CABINETS EA SIDE & TABLE FUNCTION
- 15.1 HVAC EQUIPMENT OR ACCESSORY
15.2 PLUMBING EQUIPMENT OR ACCESSORY
- 16.1 ELECTRICAL APPURTENANCE OR ACCESSORY

DATE: 11.04.20
11.20.20


REVISION DESCRIPTION

ADDENDA-2: PERMIT REVISION
ADDENDA-3: PERMIT REVISION CLARIFICATION

04 NOVEMBER 2020
PERMIT REVISION


The Texas Board of Architectural
Examiners, P.O. Box 12337, Austin, Texas
78711-2337 or 333 Guadalupe, Suite
2-350, Austin, Texas 78701-3942, (512)
305-9000, has jurisdiction over
individuals licensed under the Architects'
Registration Law, Texas Civil Statutes,
Article 249a.

This file is an instrument of service and
is to be used solely for the purposes
stipulated under separate executed
contracts with the Architect. This
document is copyrighted and is not to be
used, duplicated or otherwise modified
except with express permission of the
Architect.

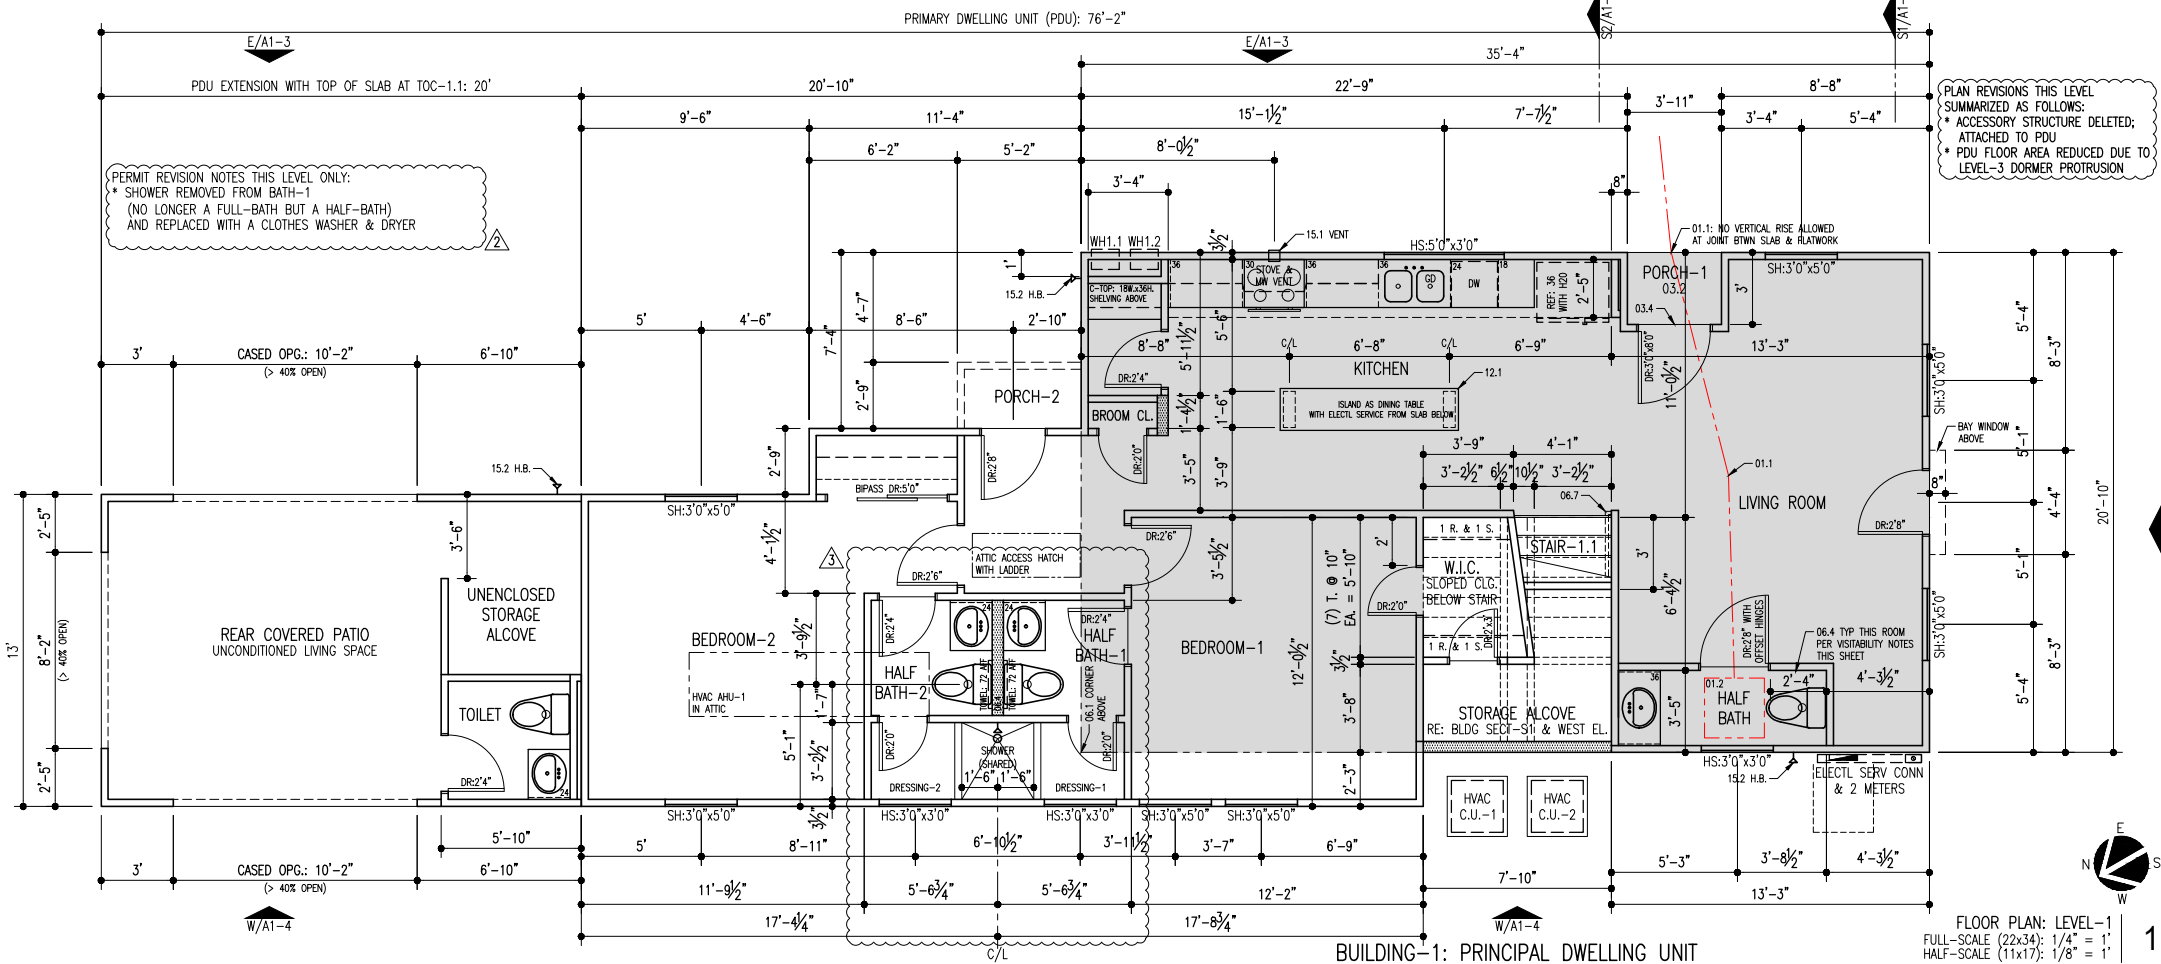

- FLOOR PLAN NOTES: NEW CONSTRUCTION**
1. NEW 2x6 STUD WALLS HATCHED FOR CLARITY: ALL OTHERS 2x4
2. ALL DIMENSIONS FROM EDGE OF WALL OR FLOOR FRAMING
OR FROM CENTERLINE OF SCHEDULED OPENINGS TYP
3. WINDOWS ARE SIZED ON PLANS IN WIDTH x HEIGHT FORMAT:
SEE EXTERIOR ELEVATIONS FOR ADDL INFO
4. DOORS SHALL BE 6'-FT. 8-IN. HIGH U.N.O. ON PLAN
5. COORDINATE ALL ROUGH OPENINGS OF WINDOWS & DOORS WITH MNFR REQD
6. SMOKE & CARBON MONOXIDE ALARMS TO BE INSTALLED IN FULL COMPLIANCE
WITH THE 2015 EDITION OF THE INTERNATIONAL RESIDENTIAL CODE R314

- VISIBILITY NOTES**
- R320.3: VISITABLE BATHROOM (HALF BATH LEVEL-1) (KEYNOTE-01.2)
* DOOR SHALL HAVE A MINIMUM CLEAR OPENING OF 32"
* LATERAL 2x6 BLOCKING SHALL BE INSTALLED CENTERED @ 34" A.F.F. FLUSH WITH STUD EDGES OF WALL
ALL 3-SIDES OF TOILET AT LEVEL-1 HALF BATH
- R320.4: MISC ELECTRICAL APPURTENANCES
* ALL LIGHT SWITCHES AND ENVIRONMENTAL CONTROLS AT UPPER LEVEL MUST BE NO HIGHER THAN 48" A.F.F.
* ALL OUTLETS AND RECEPTACLES AT UPPER LEVEL MUST BE 15" A.F.F.
- R320.5: VISIBILITY ROUTE
* SEE PLAN FOR GRAPHIC INFO THIS ELEMENT (KEYNOTE-01.1)
- R320.6: VISITABLE DWELLING ENTRANCE
* DOOR THRESHOLD AT ENTRANCE ALONG VISITABLE ROUTE PER R320.5
SHALL HAVE A 0.5" MAX HIGH THRESHOLD AS SHOWN BELOW
* CONC ALONG VISITABLE ROUTE SHALL HAVE A MAX CROSS-SLOPE OF 2% MAX & 5% MAX
IN DIRECTION OF TRAVEL
* CONC EDGES ALONG VISITABLE ROUTE SHALL NOT HAVE VERTICAL EDGES:
VERIFY WITH FOUNDATION DRAWINGS & CONCRETE SUBCONTRACTOR
- R320.7: EXTERIOR VISITABLE ROUTE
* BUILDING-1: THE PDU WILL HAVE A VISITABLE ENTRANCE THROUGH THE MAIN ENTRY
REF: SITE PLAN
* BUILDING-2: THE ADU IS AN EXISTING STRUCTURE TO BE REMODELLED
VISITABILITY NOT APPLICABLE

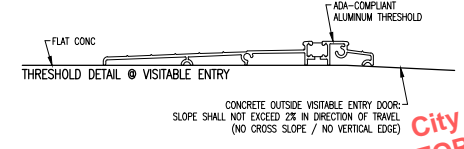

316 WEST 34th STREET
AUSTIN TX 78705

TWO-FAMILY PROJECT:
PDU: NEW CONSTRUCTION
ADU: ADDITION-REMODEL

ZONING: SF-3-NCCD-NP

BOREN
ARCHITECTS
512.554.5474

DRAWING TITLE:
BUILDINGS-1 & -3
FLOOR PLAN-1
FLOOR PLAN-2


DATE:
AS NOTED


PROJECT:
1910: 316



SCALE:
AS NOTED

DRAWN:
DPB

SHEET:
316

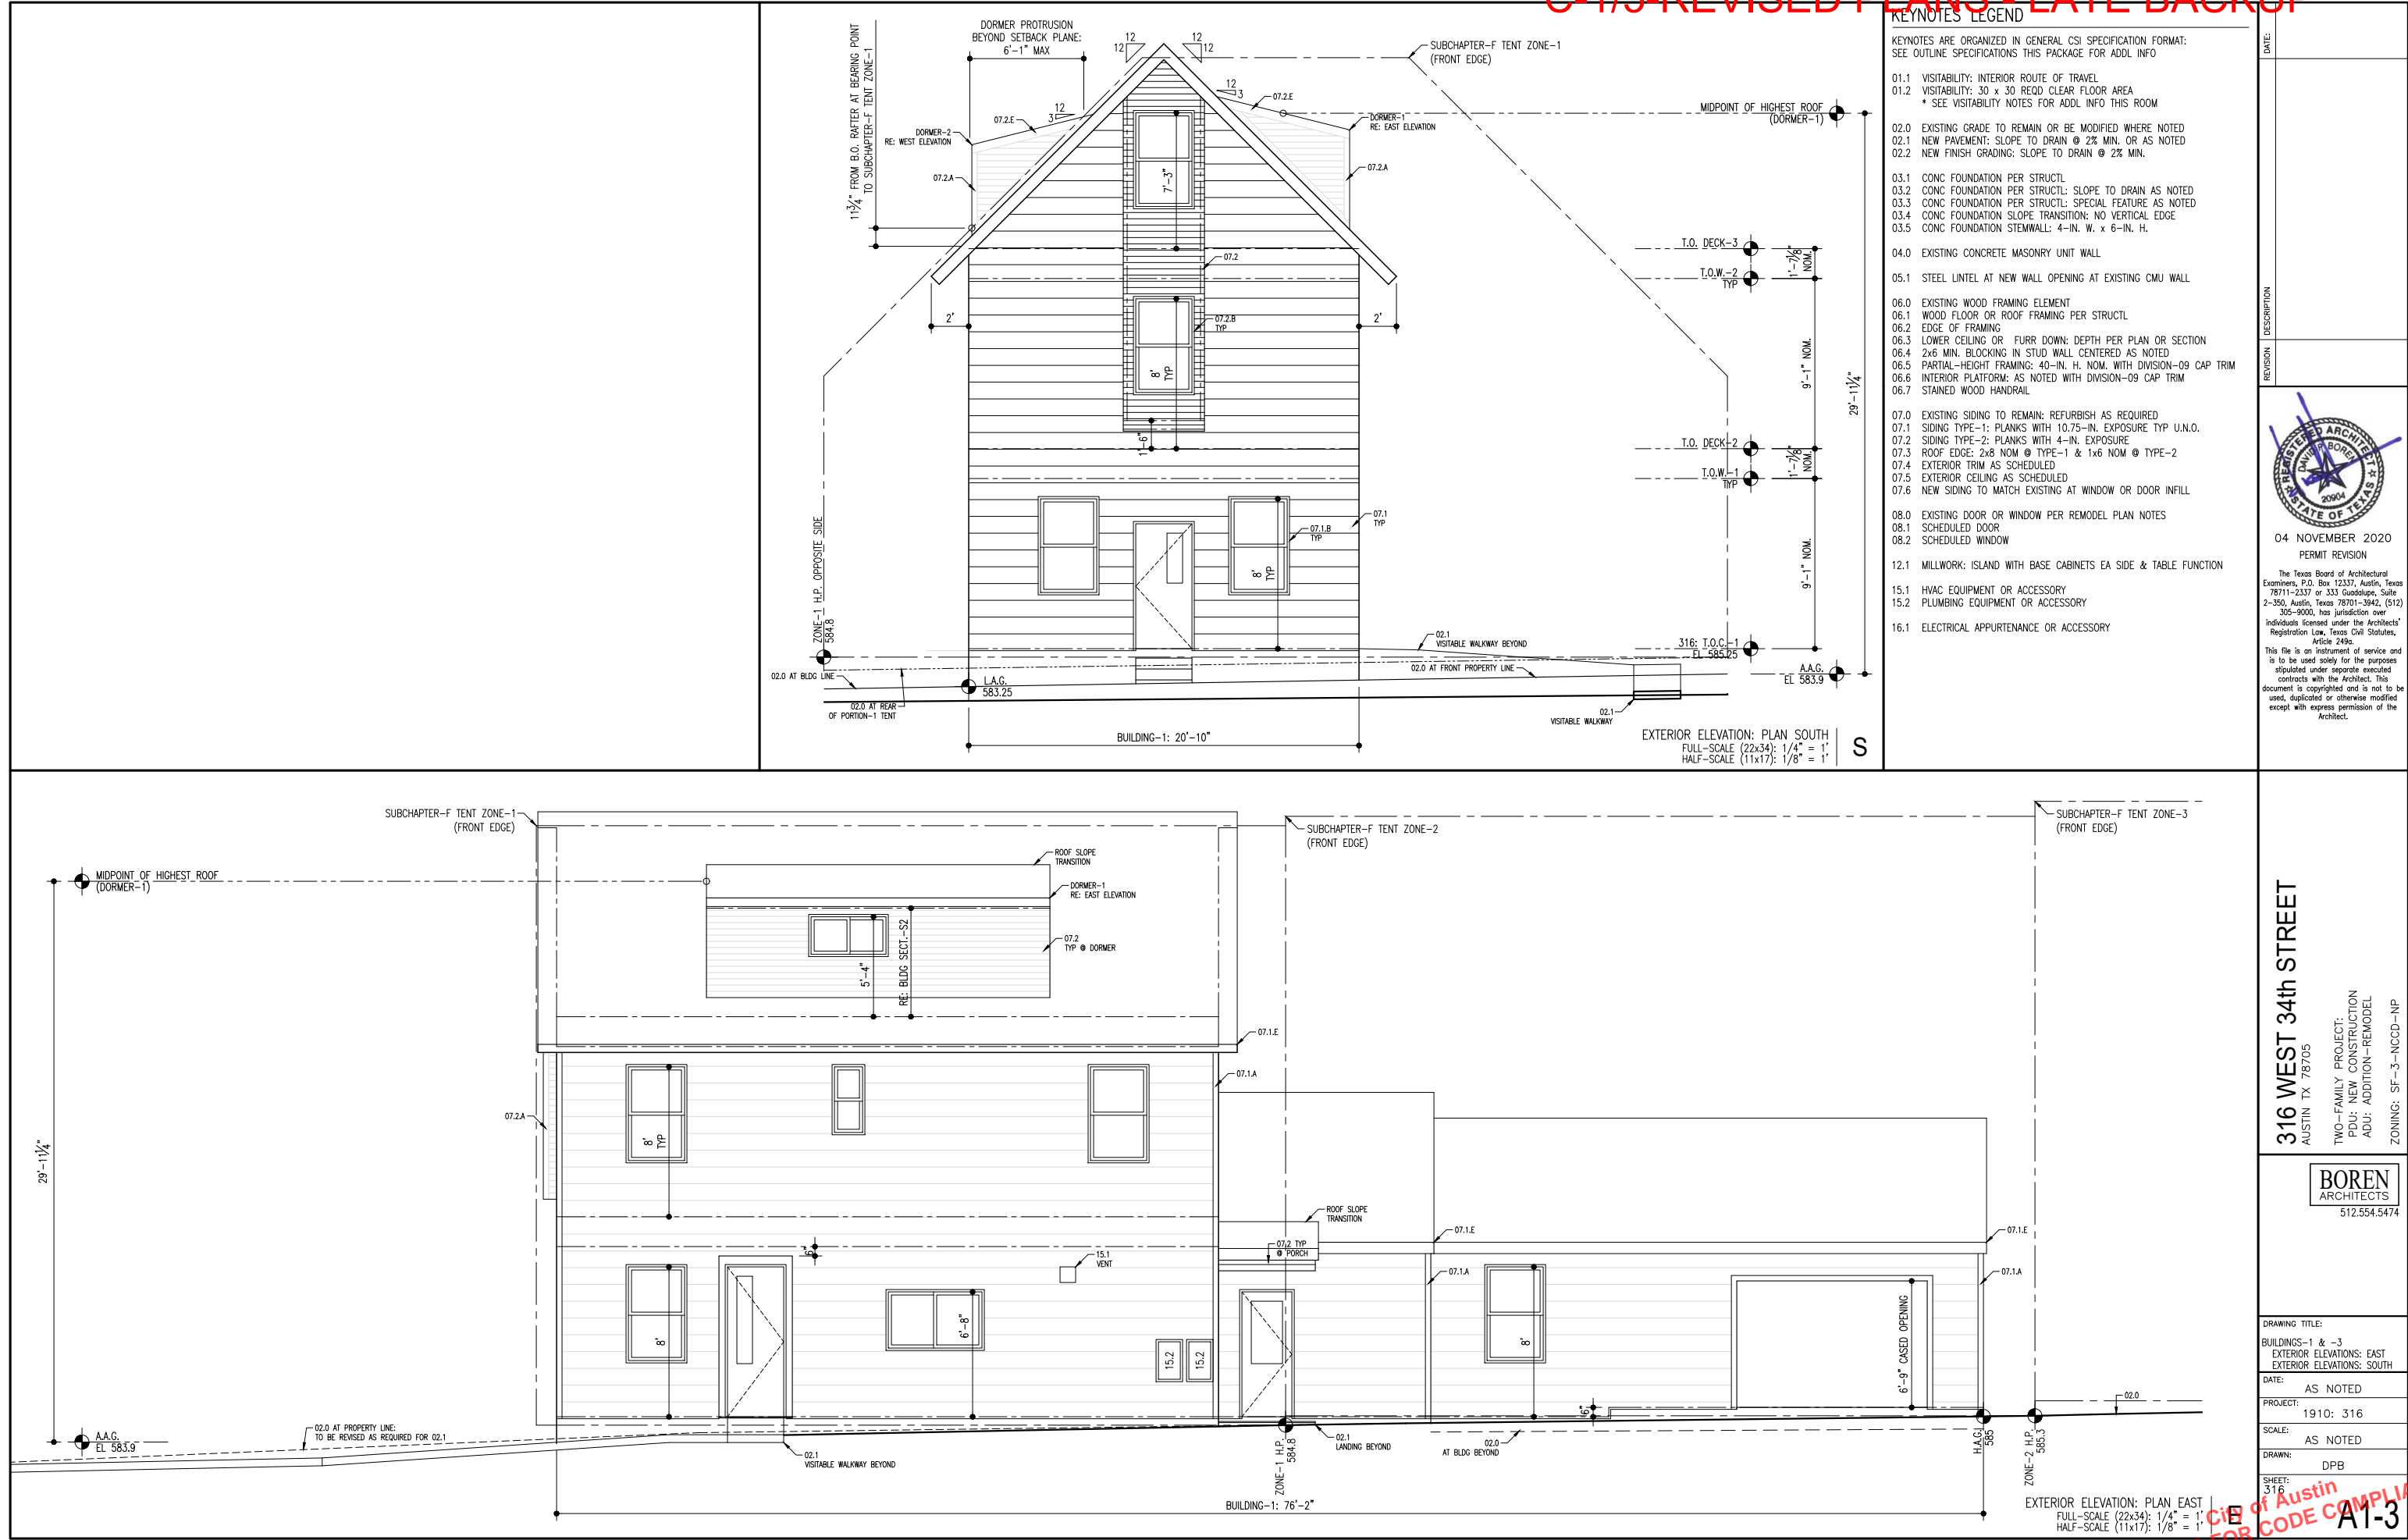

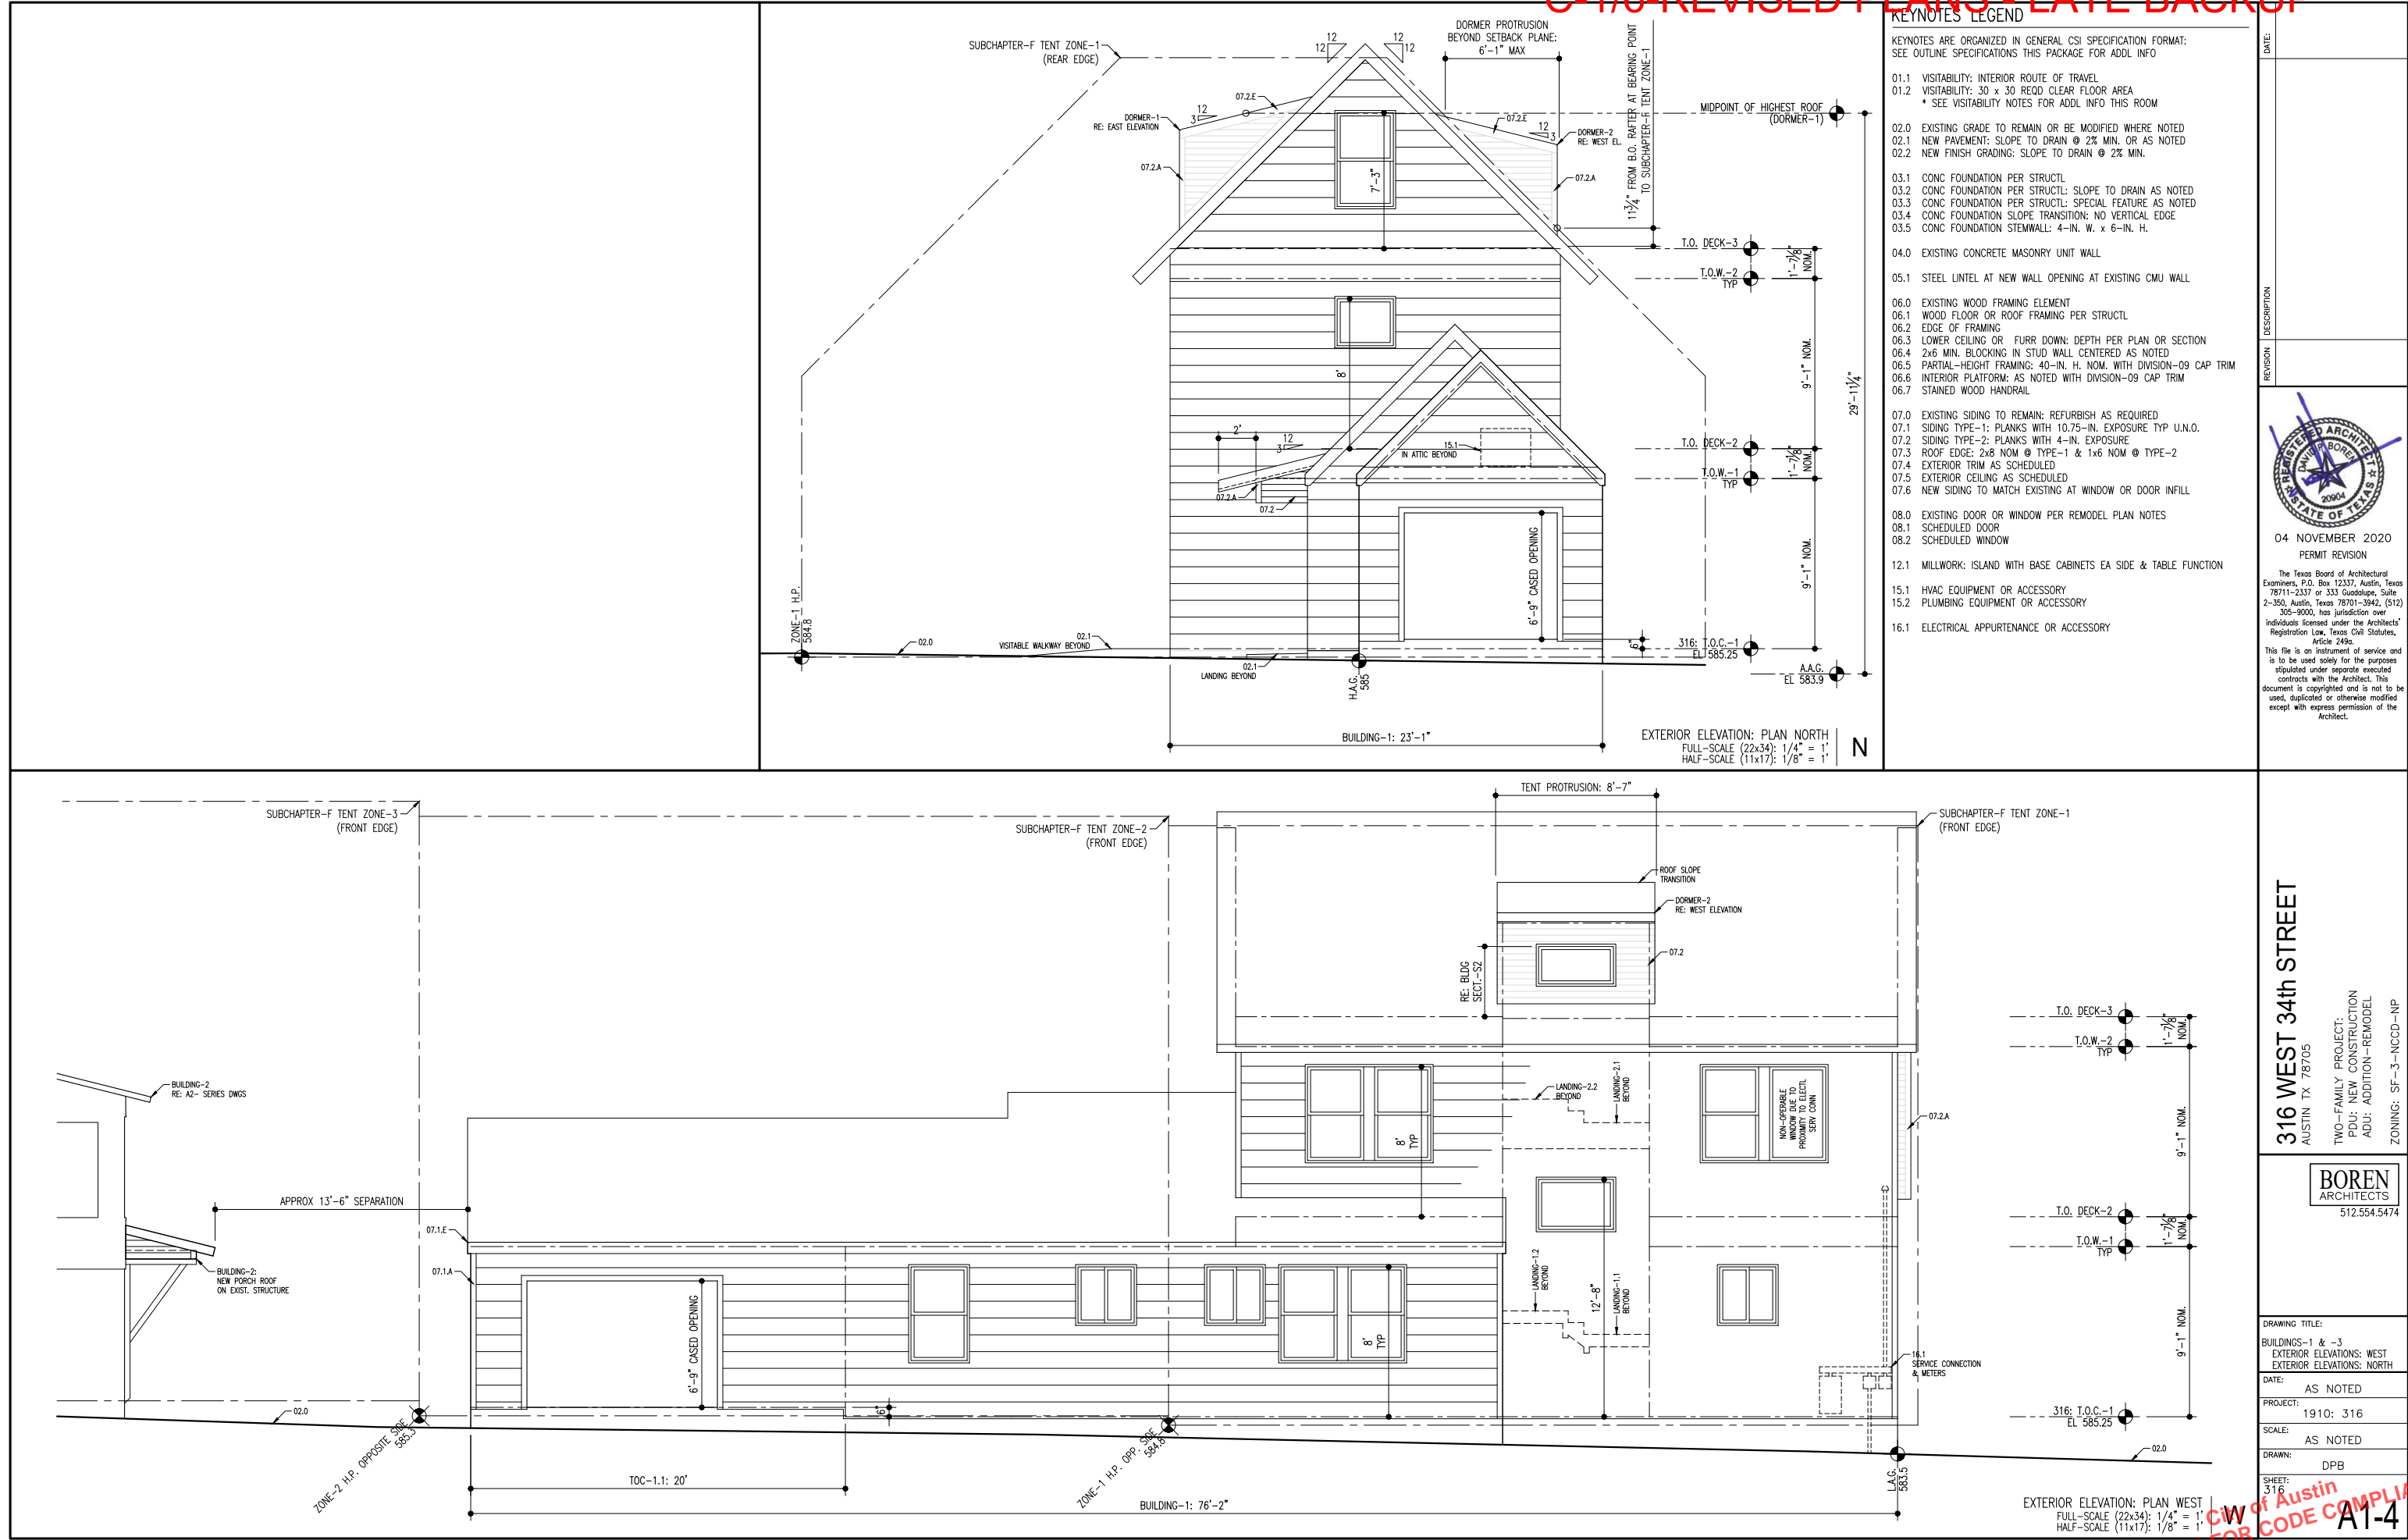

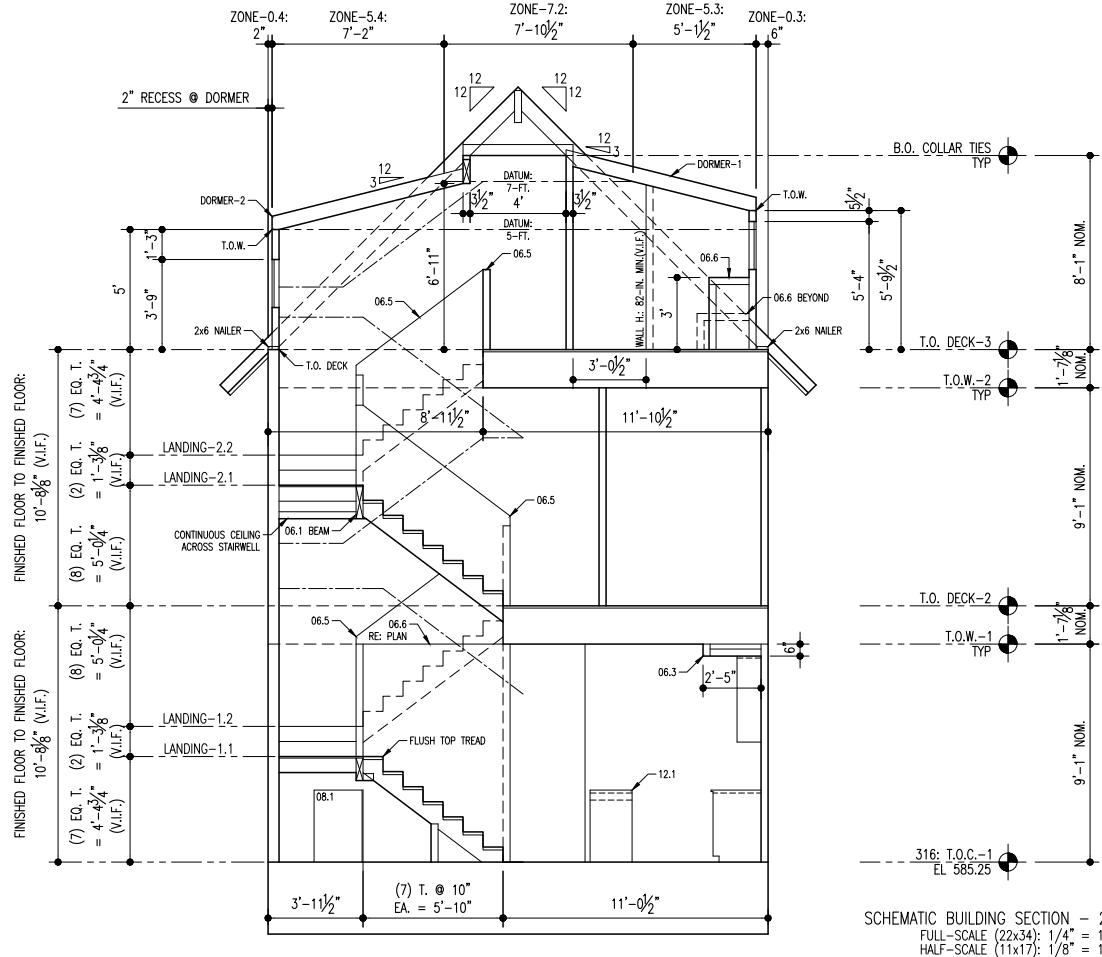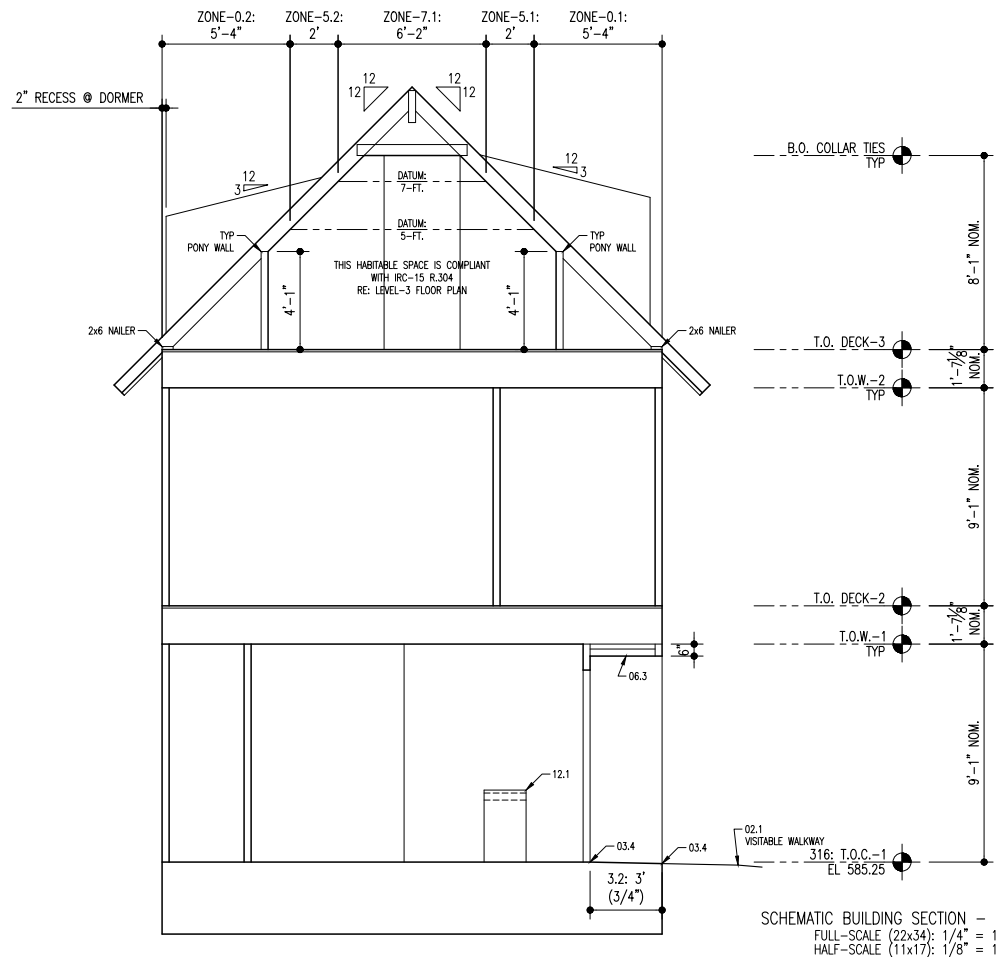

LEVEL: ROOM		FINISHES
LEVEL-1:		CEILING:
LIVING	KITCHEN	PAINTED GWB
BEDRMS	CLOSETS	WALLS:
STAIRS	HALLS	PAINTED GWB
LEVEL-2:		FLOORS:
BEDRMS	CLOSETS	PLANK FLOORING - VINYL OR ENGINEERED WOOD
LEVEL-3:		(T.B.O.) TYPICAL UNLESS NOTED OTHERWISE
MEDIA	DEN	* 314: FLOORING SHALL BE CARPET AT LEVEL-2
STO. RMS.	HALL	& LEVEL-3 & STAIRS
STAIRS		
BATHROOMS (ALL AS APPLICABLE)		CEILING:
		PAINTED GWB - MILDEW RESISTANT PAINT
		WALLS:
		PAINTED GWB - MILDEW RESISTANT PAINT
		FLOORS:
		CERAMIC TILE PER INTERIORS PACKAGE
		SHOWERS:
		PREFAB SHOWER BASE SIZED PER PLAN
		& WALLS TO MATCH BY SAME MNFR.
UTILITY SPACES:		CEILING:
LAUNDRY		PAINTED GWB - MILDEW RESISTANT PAINT
MECH		WALLS:
		PAINTED GWB - MILDEW RESISTANT PAINT
		FLOORS:
		SHEET VINYL PER INTERIORS PACKAGE
MISC EXTERIOR:		CEILING:
* PORCH-1		STAINED WOOD PER OUTLINE SPECS
* PORCH-2		WALLS:
* REAR COVERED PATIO		* PORCHES: PAINTED EXTERIOR SIDING
		* RE: OUTLINE SPECIFICATIONS FOR ADDL INFO
		FLOORS:
		* BROOM-FINISHED CONC
UTILITY SPACES:		CEILING:
L1: STO. ALCOVE		PAINTED GWB - MILDEW RESISTANT PAINT
		WALLS:
		PAINTED GWB - MILDEW RESISTANT PAINT
		FLOORS:
		CONCRETE - UNFINISHED

INSULATION SCHEDULE

ROOF INSULATION AT ALL ROOFS:

- * SPRAY FOAM INSULATION BETWEEN RAFTERS
- * R-38 EQUIVALENT; ASSUMED THICKNESS 6-IN.; CONFIRM
- * ROOF SHALL BE THERMAL ENVELOPE CONSTRUCTION

EXTERIOR WALLS:

- * OPTION-1: SPRAY FOAM INSULATION
- ~~* OPTION-2: BLOWN-IN CELLULOSE INSULATION~~
- ~~* OPTION-3: FIBERGLASS BATTS FULL-HEIGHT TYPICAL
IN A THICKNESS FULL DEPTH OF WALL CAVITY
(R-13 TYP WITH R-19 @ 2x6 WALLS)~~

FLOORS (TRUSSED AREA ONLY):

- * R-13 FIBERGLASS BATTS BETWEEN TRUSSES
(SOUND CONTROL)

INTERIOR WALLS FOR ACoustic PRIVACY:

- * R-13 FIBERGLASS BATTS SEPARATING BATHROOMS,
PLUMBING FIXTURES & LINES, FROM ALL ADJACENT
SPACES, & AROUND BEDROOMS

NOTE:

SPRAY FOAM INSULATION REFERS TO ICYNENE OR EQUAL
FIELD-APPLIED BY A CERTIFIED INSTALLER

GENERAL NOTES

THE CONTRACTOR & SUBCONTRACTORS SHALL NOTE IN THEIR BID
ALL DEVIATIONS FROM THESE DRAWINGS & SCHEDULES

THE CONTRACTOR & SUBCONTRACTORS SHALL VERIFY ALL DIMENSIONS AT THE
SITE AND PROMPTLY NOTIFY THE ARCHITECT OF ANY DISCREPANCIES PRIOR TO
BEGINNING WORK

THE CONTRACTOR & SUBCONTRACTORS SHALL VERIFY SIZES AND LOCATIONS OF
ALL APPLIANCES, FIXTURES AND RELATED COMPONENTS PRIOR TO INSTALLATION

THESE PLANS ARE ISSUED AS A "BUILDER'S SET"; SUBCONTRACTORS SHALL
COORDINATE ALL SCOPE OF WORK WITH GENERAL CONTRACTOR PRIOR TO BID

PROVIDE CONTROL AND EXPANSION JOINTS AS REQUIRED ON CONCRETE DRIVES,
WALKS AND PATIOS

ALL WATER LINES TO BE PEX

ALL WASTE PIPING TO BE SCHEDULE 40 PVC

PROVIDE THRESHOLDS @ ALL EXTERIOR DOORS

DIVISION-2: SITE CONSTRUCTION

LANDSCAPING:

- * BY OWNER
- * FINISHED GRADING SHALL SLOPE AWAY FROM BUILDING @ 2% MINIMUM

DIVISION-3: CONCRETE

- * CONCRETE FOUNDATION PER STRUCTURAL
- * EXPOSED CONCRETE SIDEWALLS > 8" H. SHALL BE PARGED
- * NEW CONCRETE FOUNDATIONS SHALL BE PER STRUCTURAL
- * PROVIDE CONTROL & EXPANSION JOINTS AS REQUIRED ON CONC DRIVES, WALKWAYS & PATIOS
- * COORDINATE CONCRETE WITH CITY OF AUSTIN VISIBILITY REQUIREMENTS, INCLUDING WIDTH & TEXTURE, SLOPE & CROSS-SLOPE

DIVISION-4: MASONRY

- * NOT APPLICABLE

DIVISION-6: WOOD & PLASTICS

FLOOR FRAMING (WHERE APPLICABLE):

- * FLOOR TRUSSES PER ENGINEERED SHOP DRAWINGS: 18" MINIMUM DEPTH
- * RE: STRUCTL FOR ADDL INFO

SUB FLOORING (WHERE APPLICABLE):

- * 1.125" TONGUE & GROOVE (T&G) PLYWOOD, NAIL & GLUE
- * RE: STRUCTL FOR ADDL INFO

WALL FRAMING:

- * 2x4 NOM. @ 16" MAX. O.C. TYPICAL; 2x6 NOM. WHERE NOTED ON PLAN
- * WALL SHEATHING:
- * OPTION-1: ZIP WALL SHEATHING RATED FOR SPAN - VERIFY W/ STRUCTL
- * OPTION-2: PER STRUCTL
- * ALL EDGES SHALL BE FULLY BLOCKED
- * RE: STRUCTL FOR ADDL INFO

ROOF FRAMING:

- * PER STRUCTL

ROOF SHEATHING:

- * SHEATHING PER STRUCTL RATED FOR SPAN
- * PROVIDE CLIPS AT MID-SPAN OF ALL JOINTS

EXTERIOR WOOD FRAMING:

- * ALL EXTERIOR WOOD FRAMING MATERIALS SHALL BE TREATED
- * ALL CONNECTORS SHALL BE RATED FOR APPLICATION

MISC WOOD FRAMING:

- * FRAMER TO INSTALL BLOCKING AS REQUIRED FOR ALL INTERIOR APPURTENANCES & ACCESSORIES NOTED OR SHOWN ON PLAN

DIVISION-7: THERMAL & MOISTURE PROTECTION

MOISTURE PROTECTION:

- * N/A IF ZIP WALL SHEATHING SYSTEM IS SELECTED: SEE ABOVE
- * TYVEK OR EQUAL HOUSEWRAP IF OSB OR PLYWOOD SHEATHING

EXTERIOR SIDING & TRIM:

- * EXTERIOR CEMENT FIBER BOARD "PLANK" SYSTEM BY JAMES HARDIE COMPANY OR EQUAL:
 - TYPE-1: 10.75-IN. EXPOSURE, SMOOTH
 - TYPE-2: 4-IN. EXPOSURE, SMOOTH
- * A CORNER TRIM: 1x HARDIE-TRIM, ONE SIDE ONLY AS SHOWN TP
- * B OPENING TRIM: 2x2 "REAL TRIM" ALL FOUR SIDES AS SHOWN
- * C OPENING TRIM - WINDOW INFILL: HARDIE-PANEL OVER FURR-STRIPS

OUTLINE SPECIFICATIONS

- * .D CASER OPENING TRIM: 1x HARDIE-TRIM FULL DEPTH
- * .E ROOF EDGE TRIM:
 - AT TYPE-1 SIDING: 2x8 AS SHOWN
 - AT TYPE-2 SIDING: 1x6 AS SHOWN

EXTERIOR CEILINGS OR SOFFIT:

- * NON-VENTED HARDIE-SOFFT TYPICAL WITH VINYL JOINTS, TYP U.N.O.
- * STAINED PINE T. & G. BEAD BOARD AT ALL GROUND FLOOR PORCH AND PATIO CEILINGS

ROOFING FOR 314 WEST 34th STREET:

- * ASPHALT COMPOSITION SHINGLES OVER TITANIUM ROOF UNDERLAYMENT

ROOFING FOR 316 WEST 34th STREET:

- * CONCEALED FASTENER GALVALUME METAL ROOF SYSTEM OVER TITANIUM ROOF UNDERLAYMENT
- * SYSTEM SHALL BE COMPATIBLE WITH S-5 PRODUCT CLAIMS
- * ASSUMED CTMRS SHURLOC OR SPANLOC SYSTEM: VERIFY WITH CTMRS OR APPROVED EVAL

△

BUILDING INSULATION:

- * SEE INSULATION SCHEDULE, THIS SHEET

DIVISION-8: DOORS & WINDOWS

SCHEDULED EXTERIOR DOORS:

- * RECOMMENDED: THERMATRU FIBERGLASS OR EQUAL

DOOR HARDWARE:

- * AS RECOMMENDED BY MNFR WITH OWNER REVIEW

INTERIOR DOORS:

- * RECOMMENDED: SOLID CORE WOOD VENEER - FLUSH

SCHEDULED WINDOWS:

- * STYLE & MATERIAL BY OWNER
- * ALL WINDOWS SHALL HAVE INSULATED, LOW-E, DOUBLE-PANE GLAZING
- * SUPPLIER SHALL VERIFY CODE REQUIREMENTS & OPERATIONS PRIOR TO ORDER
- * SUPPLIER SHALL REVIEW PLANS WITH ELEVATIONS & NOTIFY ARCHITECT OF POSSIBLE DISCREPANCIES PRIOR TO ORDER

DIVISION-9: FINISHES

GYPSUM WALLBOARD (GWB):

- * GWB, 0.5-IN. AT WALLS & 0.625-IN. AT CEILINGS
- * TAPE & FLOAT; TEXTURE & PAINT
- * COORDINATE TEXTURE WITH OWNER
- * CORNERS SHALL BE SQUARE
- * USE MOISTURE-RESISTANT GWB AT ALL "WET" AREAS
- * ALL JOINT CEMENTITIOUS BACKING BEHIND ALL TILE

316 REAR COVERED PATIO & 314 LAUNDRY ROOM ONLY:

- * USE EXTERIOR-RATED GWB AT CEILING, WITH JOINT COMPOUND & TEXTURE FOR INTERIOR SPACES

INTERIOR TRIM RECOMMENDATIONS FOR OWNER VERIFICATION:

- * BASE BOARDS: PAINTED MDF 1x6 WITH EASED TOP EDGE TYP
- * DOOR TRIM: PAINTED MDF 1x4 WITH EASED EDGES
- * WINDOW SILL: PAINTED MDF 1x WITH EASED EDGES; DOUBLE-THICK AT PROJECTING SILL
- * WINDOW TRIM: PAINTED GWB RETURNS @ JAMBS & HEAD
- * 06.5 CAP: SAME AS WINDOW SILL
- * 06.6 CAP: SAME AS WINDOW SILL BUT HDWD TO RESIST CUPPING: INSTALL OVER 0.75-IN. THICK PLYWOOD

NOTES:
FORMAT

THESE SPECIFICATIONS ARE IN 1995 CSI

DIVISION-10: SPECIALTIES
TOILET & BATH ACCESSORIES:
* TBD WITH INTERIOR DESIGNER (PER SEPARATE AGREEMENT)
* TOWEL BARS: 24-IN. W. AT HEIGHTS NOTED
CLOSET SYSTEMS:
* TBD WITH INTERIOR DESIGNER (PER SEPARATE AGREEMENT)

DIVISION-11: EQUIPMENT
APPLIANCES:
* AS NOTED ON PLANS WITH SELECTIONS PER OWNER

DIVISION-12: FURNISHINGS
CASEWORK & COUNTERTOPS:
* TBD WITH INTERIOR DESIGNER (PER SEPARATE AGREEMENT)

DIVISION-13: SPECIAL CONSTRUCTION
NOT APPLICABLE

DIVISION-15: MECHANICAL
HVAC WORK SHALL BE DESIGN-BUILD BY LICENSED SUBCONTRACTOR
BUILDING-1:
* LEVEL-1: AHU-1 WITH GAS FURNACE IN ATTIC BELOW LOW ROOF
* LEVEL-2: AHU-2 UPFLOW TYPE AT LEVEL-2
* LEVEL-3: SAME AS LEVEL-2
* REFER TO UTILITY NOTES THIS SHEET FOR ADDITIONAL INFORMATION

BUILDING-2:
* EXISTING / MODIFIED IN CONJUNCTION WITH LICENSED SUBCONTRACTOR

PLUMBING WORK SHALL BE DESIGN-BUILD BY LICENSED SUBCONTRACTOR
* PLUMBING FIXTURES AS INDICATED ON PLAN & SELECTED BY OWNER
* WASTEWATER LINES: ASSUMED SCHEDULE 40 PVC
* WATER LINES - INTERIOR: ASSUMED PEX
BUILDING-1:
* TWO GAS-FIRED TANKLESS-TYPE WATER HEATERS CONCEALED IN WALLS
WITH EXTERIOR WALL ACCESS: SEE LEVEL-1 PLAN FOR LOCATION
BUILDING-2:
* EXISTING / MODIFIED IN CONJUNCTION WITH LICENSED SUBCONTRACTOR

DIVISION-16: ELECTRICAL
ELECTRICAL WORK SHALL BE DESIGN-BUILD BY LICENSED SUBCONTRACTOR
* FIXTURES: PER ELECTRICAL DRAWINGS & OWNER
* SWITCHES: ROCKER TYPE PER ELECTRICAL DRAWINGS & OWNER
* TELECOMMUNICATIONS AND ENTERTAINMENT SYSTEMS: BY OTHERS
* ELECTRICAL SUBCONTRACTOR SHALL VERIFY ELECTR. PLAN IS COMPLIANT
WITH ALL PERTINENT CODES: NOTIFY G.C. OF ANY DISCREPANCIES

PHOTOVOLTAIC COLLECTORS (SOLAR PANELS):
* 314: NOT APPLICABLE
* 316: IN COORDINATION WITH SPECIALTY SUBCONTRACTOR

City of

316 WEST 34th STREET

AUSTIN TX 78705

TWO-FAMILY PROJECT:
PDU: NEW CONSTRUCTION
ADU: ADDITION-REMODEL

ZONING: SF-3--NCCD-NP

BOREN
ARCHITECTS

512.554.5474

DRAWING TITLE:	
BUILDINGS-1 & -3 BUILDING SECTIONS SPECS & SCHEDULES	
DATE:	AS NOTED
PROJECT:	1910: 316
SCALE:	AS NOTED
DRAWN:	DPB
SHEET: 316	


Austin
 CODE COMPLIANT
 A1-5


NOTICE TO BID



LEGEND

KEYNOTES ARE ORGANIZED IN GENERAL CSI SPECIFICATION FORMAT:
SEE OUTLINE SPECIFICATIONS THIS PACKAGE FOR ADDL INFO

- 01.1 VISIBILITY: INTERIOR ROUTE OF TRAVEL
- 01.2 VISIBILITY: 30 x 30 REDD CLEAR FLOOR AREA
 - * SEE VISIBILITY NOTES FOR ADDL INFO THIS ROOM
- 02.0 EXISTING GRADE TO REMAIN OR BE MODIFIED WHERE NOTED
- 02.1 NEW PAVEMENT: SLOPE TO DRAIN @ 2% MIN. OR AS NOTED
- 02.2 NEW FINISH GRADING: SLOPE TO DRAIN @ 2% MIN.
- 03.1 CONC FOUNDATION PER STRUCTL
- 03.2 CONC FOUNDATION PER STRUCTL: SLOPE TO DRAIN AS NOTED
- 03.3 CONC FOUNDATION PER STRUCTL: SPECIAL FEATURE AS NOTED
- 03.4 CONC FOUNDATION SLOPE TRANSITION: NO VERTICAL EDGE
- 03.5 CONC FOUNDATION STEMWALL: 4-IN. W. x 6-IN. H.
- 04.0 EXISTING CONCRETE MASONRY UNIT WALL
- 05.1 STEEL LINTEL AT NEW WALL OPENING AT EXISTING CMU WALL
- 06.0 EXISTING WOOD FRAMING ELEMENT
- 06.1 WOOD FLOOR OR ROOF ELEMENT PER STRUCTL
- 06.2 EDGE OF FRAMING
- 06.3 LOWER CEILING OR FURR DOWN: DEPTH PER PLAN OR SECTION
- 06.4 2x6 MIN. BLOCKING IN STUD WALL CENTERED AS NOTED
- 06.5 PARTIAL-HIGHT FRAMING: 40-IN. H. NOM. WITH DIVISION-09 CAP TRIM
- 06.6 INTERIOR PLATFORM: AS NOTED WITH DIVISION-09 CAP TRIM
- 06.7 STAINED WOOD HANDRAIL
- 07.0 EXISTING SIDING TO REMAIN: REFURBISH AS REQUIRED
- 07.1 SIDING TYPE-1: PLANKS WITH 10.75-IN. EXPOSURE TYP U.N.O.
- 07.2 SIDING TYPE-2: PLANKS WITH 4-IN. EXPOSURE
- 07.3 ROOF EDGE: 2x8 NOM @ TYPE-1 & 1x6 NOM @ TYPE-2
- 07.4 EXTERIOR TRIM AS SCHEDULED
- 07.5 EXTERIOR CEILING AS SCHEDULED
- 07.6 NEW SIDING TO MATCH EXISTING AT WINDOW OR DOOR INFILL
- 08.0 EXISTING DOOR OR WINDOW PER REMODEL PLAN NOTES
- 08.1 SCHEDULED DOOR
- 08.2 SCHEDULED WINDOW
- 12.1 MILLWORK: ISLAND WITH BASE CABINETS EA SIDE & TABLE FUNCTION
- 15.1 HVAC EQUIPMENT OR ACCESSORY
- 15.2 PLUMBING EQUIPMENT OR ACCESSORY
- 16.1 ELECTRICAL APPURTENANCE OR ACCESSORY

DATE:	09.11.2020
DESCRIPTION	ADDENDUM-1: REVISION FOR CONSTRUCTION SET
REVISION	
<p>04 NOVEMBER 2020</p> <p>PERMIT REVISION</p> <p>The Texas Board of Architectural Examiners, P.O. Box 12337, Austin, Texas 78711-2337 or 333 Guadalupe, Suite 2-350, Austin, Texas 78701-3942, (512) 325-2900, has jurisdiction over individuals licensed under the Architects' Registration Law, Texas Civil Statutes, Article 2496.</p> <p>This file is on instrument of service and is to be used solely for the purposes stipulated under separate executed contracts with the Architect. This document is copyrighted and is not to be used, duplicated or otherwise modified except with express permission of the Architect.</p>	

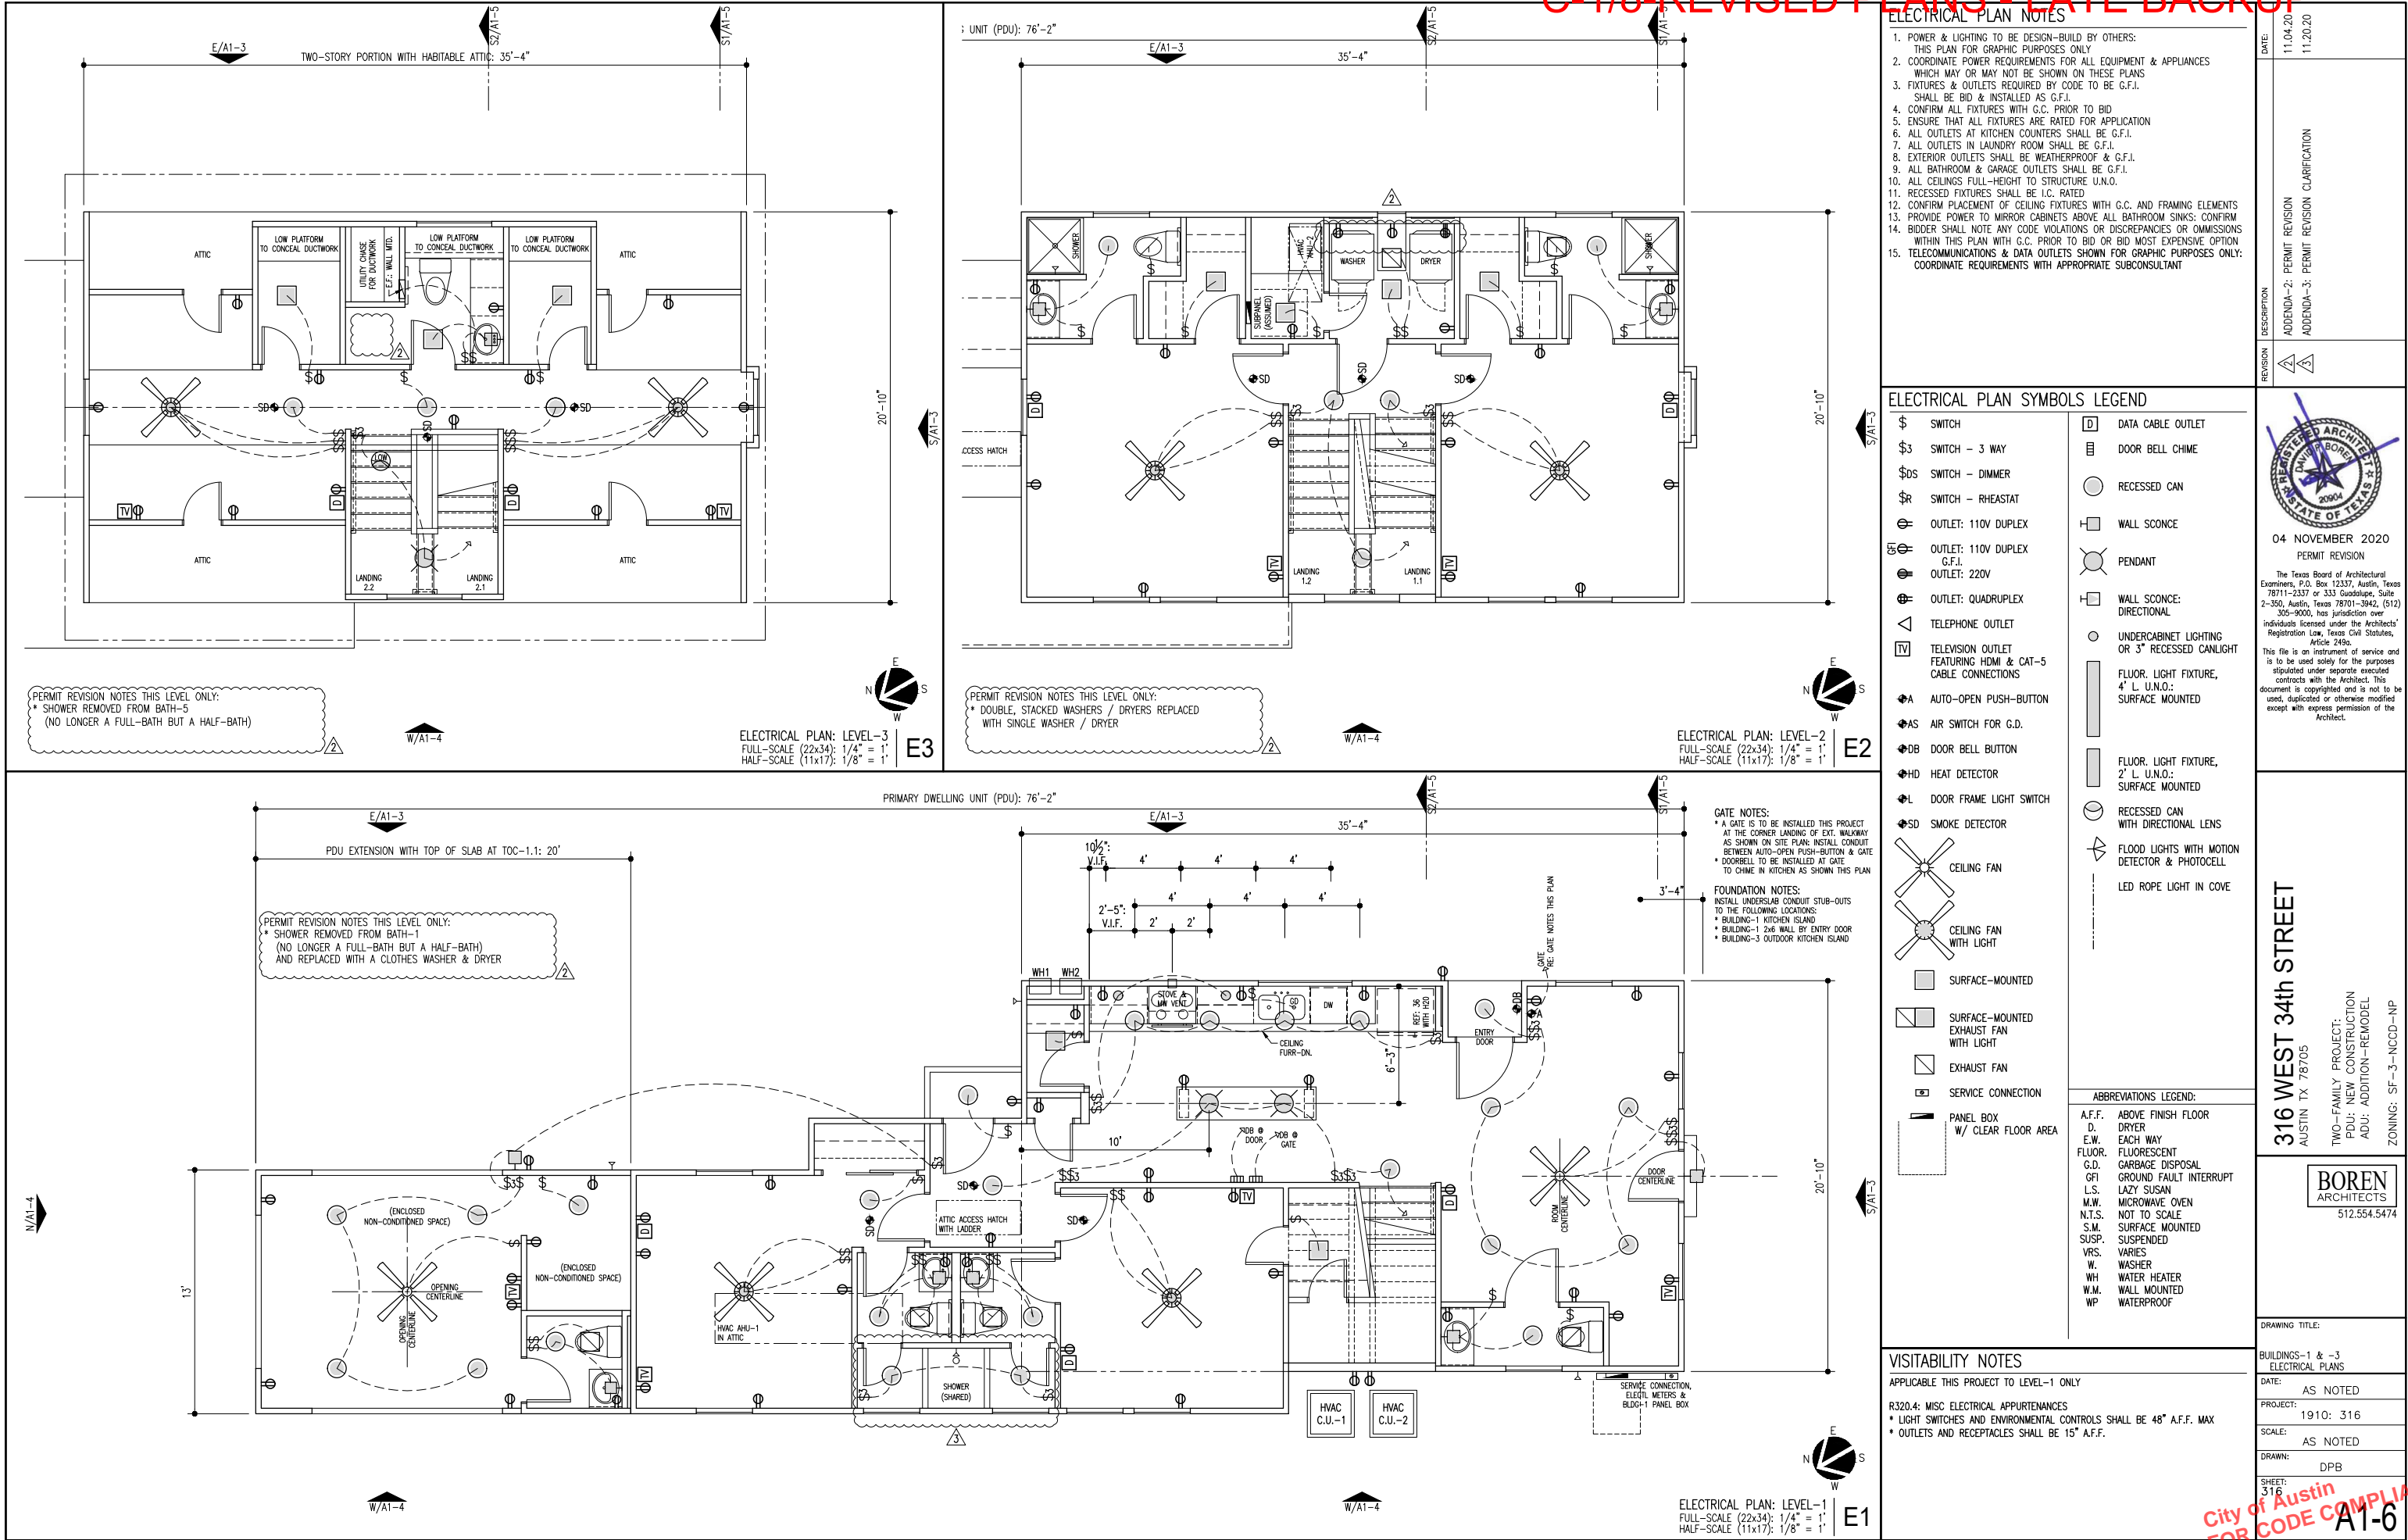

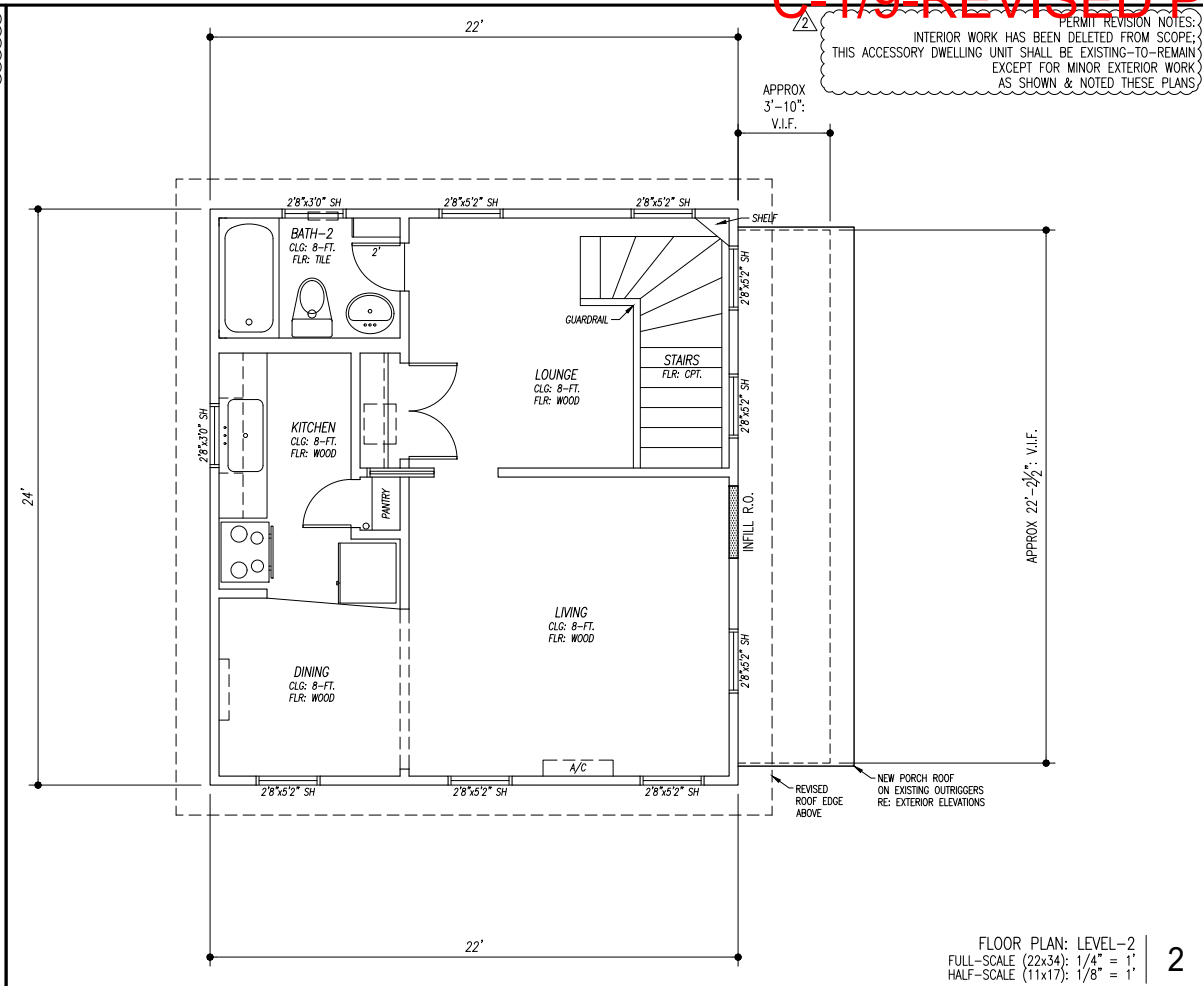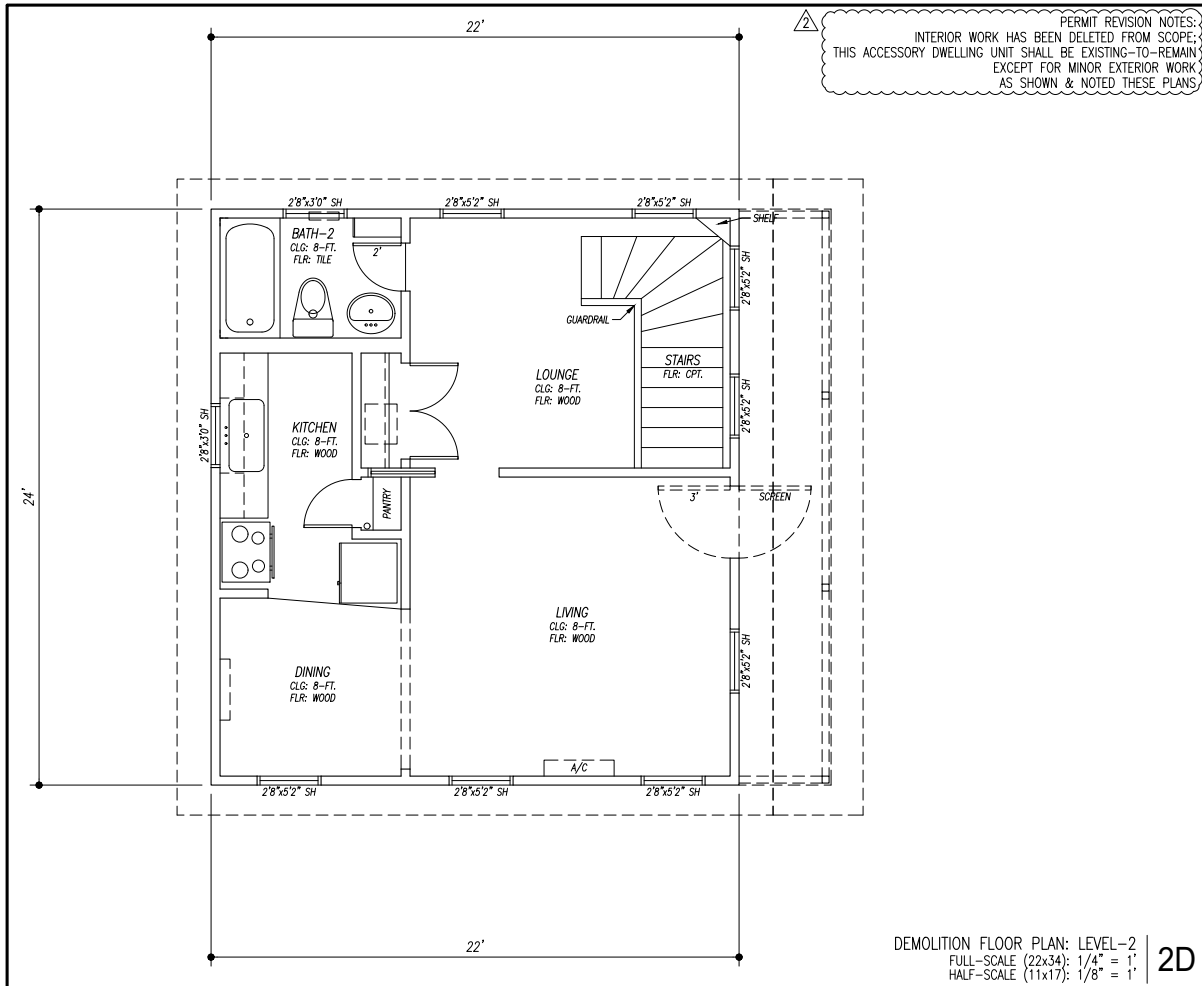

KEYNOTES LEGEND	
KEYNOTES ARE ORGANIZED IN GENERAL CSI SPECIFICATION FORMAT: SEE OUTLINE SPECIFICATIONS THIS PACKAGE FOR ADDL INFO	
01.1 VISIBILITY: INTERIOR ROUTE OF TRAVEL	01.2 VISIBILITY: 30 x 30 REQD CLEAR FLOOR AREA * SEE VISIBILITY NOTES FOR ADDL INFO THIS ROOM
02.0 EXISTING GRADE TO REMAIN OR BE MODIFIED WHERE NOTED	
02.1 NEW PAVEMENT: SLOPE TO DRAIN @ 2% MIN. OR AS NOTED	02.2 NEW FINISH GRADING: SLOPE TO DRAIN @ 2% MIN.
03.1 CONC FOUNDATION PER STRUCTL	
03.2 CONC FOUNDATION PER STRUCTL: SLOPE TO DRAIN AS NOTED	03.3 CONC FOUNDATION PER STRUCTL: SPECIAL FEATURE AS NOTED
03.4 CONC FOUNDATION SLOPE TRANSITION: NO VERTICAL EDGE	
03.5 CONC FOUNDATION STEMMALL: 4-IN. W. x 6-IN. H.	04.0 EXISTING CONCRETE MASONRY UNIT WALL
05.1 STEEL LINTEL AT NEW WALL OPENING AT EXISTING CMU WALL	
06.0 EXISTING WOOD FRAMING ELEMENT	06.1 WOOD FLOOR OR ROOF FRAMING PER STRUCTL
06.2 EDGE OF FRAMING	
06.3 LOWER CEILING OR FURR DOWN: DEPTH PER PLAN OR SECTION	06.4 2x6 MIN. BLOCKING IN STUD WALL CENTERED AS NOTED
06.5 PARTIAL-HEIGHT FRAMING: 40-IN. H. NOM. WITH DIVISION-09 CAP TRIM	
06.6 INTERIOR PLATFORM: AS NOTED WITH DIVISION-09 CAP TRIM	06.7 STAINED WOOD HANDRAIL
07.0 EXISTING SIDING TO REMAIN: REFURBISH AS REQUIRED	
07.1 SIDING TYPE-1: PLANKS WITH 10.75-IN. EXPOSURE TYP U.N.O.	07.2 SIDING TYPE-2: PLANKS WITH 4-IN. EXPOSURE
07.3 ROOF EDGE: 2x8 NOM @ TYPE-1 & 1x6 NOM @ TYPE-2	
07.4 EXTERIOR TRIM AS SCHEDULED	07.5 EXTERIOR CEILING AS SCHEDULED
07.6 NEW SIDING TO MATCH EXISTING AT WINDOW OR DOOR INFILL	
08.0 EXISTING DOOR OR WINDOW PER REMODEL PLAN NOTES	08.1 SCHEDULED DOOR
08.2 SCHEDULED WINDOW	
12.1 MILLWORK: ISLAND WITH BASE CABINETS EA SIDE & TABLE FUNCTION	15.1 HVAC EQUIPMENT OR ACCESSORY
15.2 PLUMBING EQUIPMENT OR ACCESSORY	
16.1 ELECTRICAL APPURTENANCE OR ACCESSORY	



DATE: 09.11.20
11.04.20

REVISION DESCRIPTION
ADDENDA-1: REVISION FOR CONSTRUCTION SET
ADDENDA-2: PERMIT REVISION

04 NOVEMBER 2020
PERMIT REVISION

The Texas Board of Architectural
Examiners, P.O. Box 12337, Austin, Texas
78711-2337 or 333 Guadalupe, Suite
2-350, Austin, Texas 78701-3942, (512)
305-9000, has jurisdiction over
Individuals licensed under the Architects'
Registration Law, Texas Civil Statutes,
Article 249a.

This file is an instrument of service and
is to be used solely for the purposes
stipulated under separate executed
contracts with the Architect. This
document is copyrighted and is not to be
used, duplicated or otherwise modified
except with express permission of the
Architect.

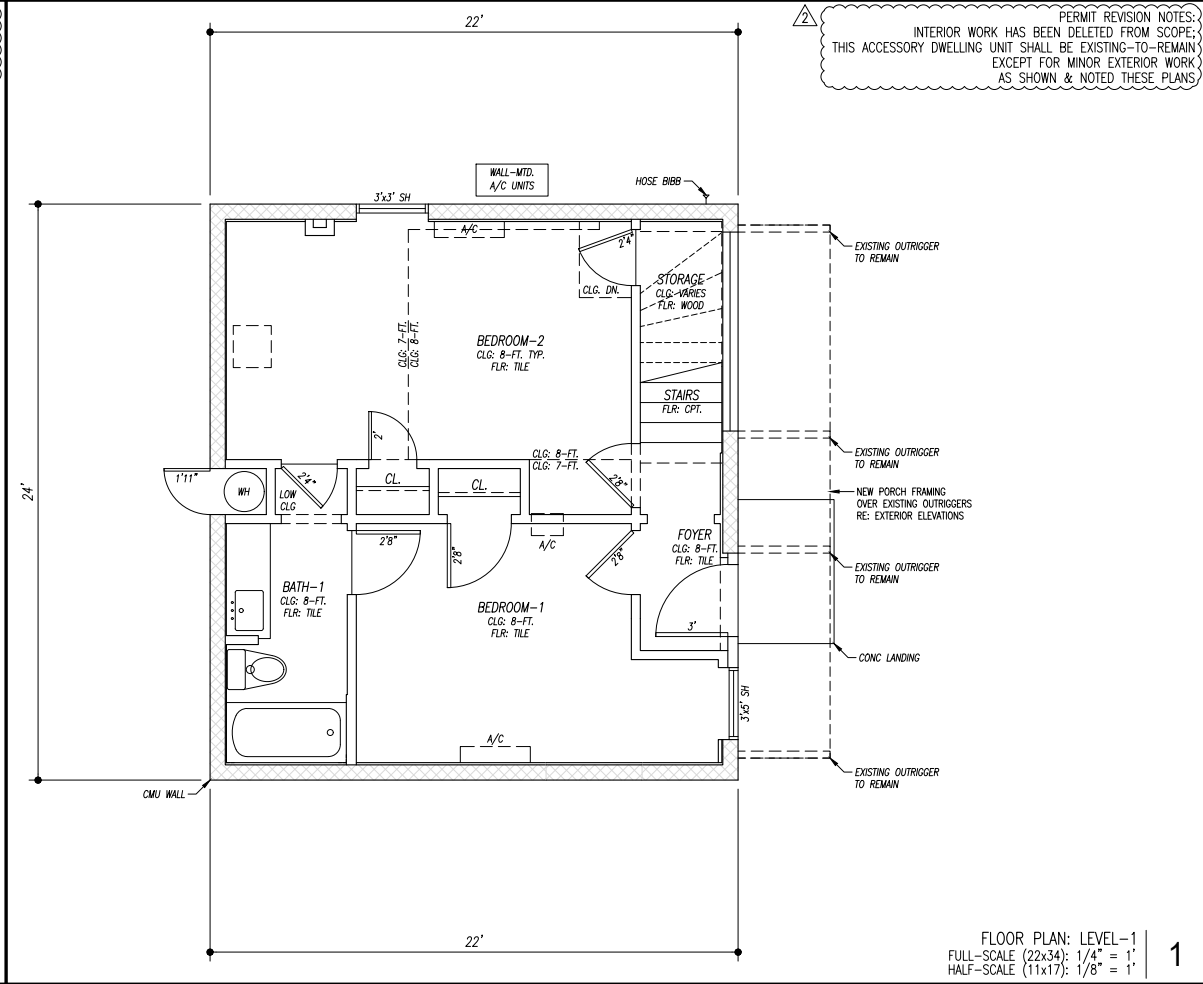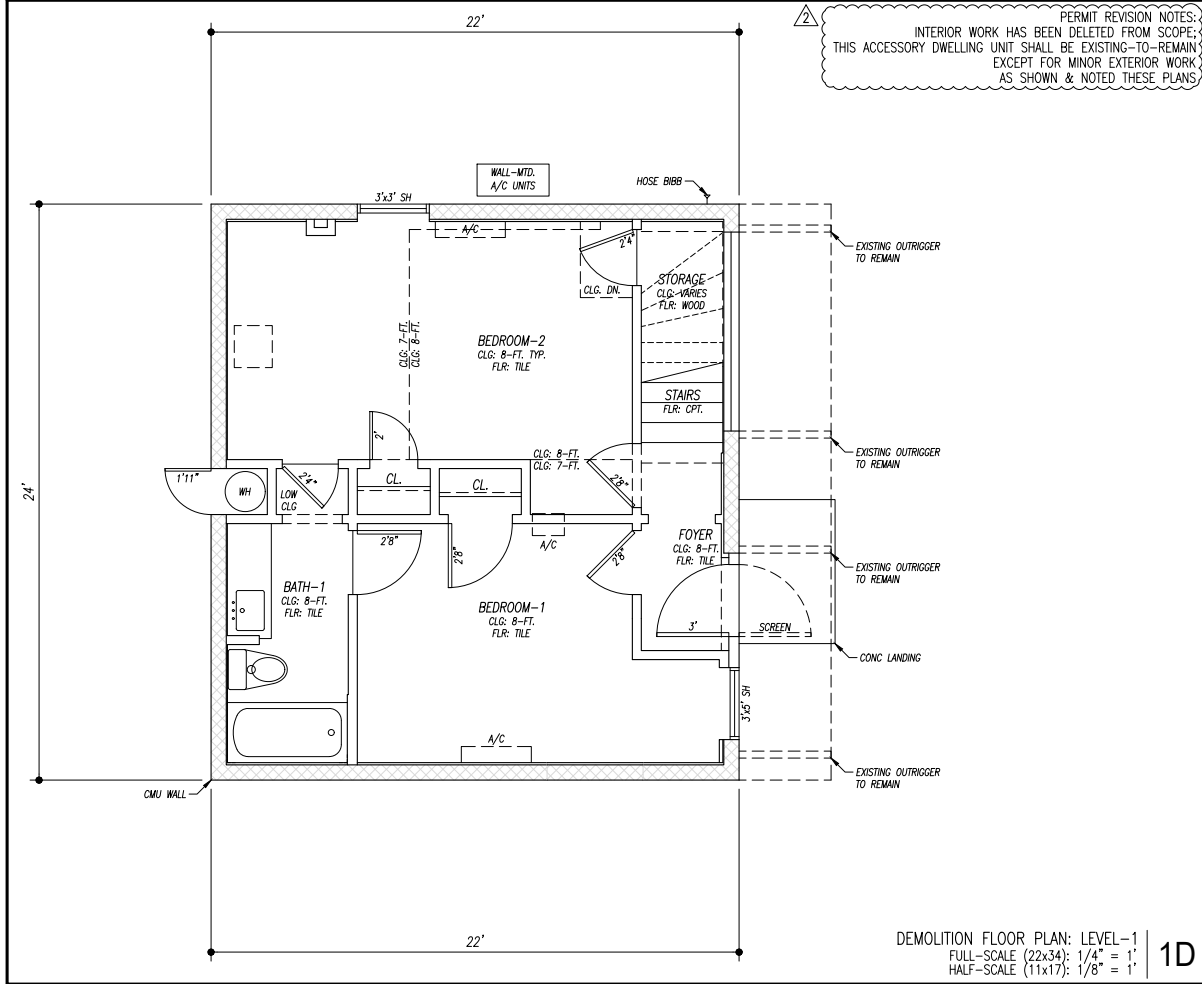

FLOOR PLAN NOTES: REMODEL	
1. ITALICIZED TEXT DENOTES AN EXISTING ELEMENT: CONFIRM EXISTING SIZES	
2. NEW WALLS HATCHED FOR CLARITY: ALL OTHERS EXISTING U.N.O.	
3. ALL DIMENSIONS FROM EDGE OF EXISTING FINISHED EDGE OR EDGE OF NEW WALL OR FLOOR FRAMING OR FROM CENTERLINE OF SCHEDULED OPENINGS TYP	
4. WINDOWS ARE SIZED ON PLANS IN WIDTH x HEIGHT FORMAT: * BASE BID: REPLACE ALL EXISTING WINDOWS IN-KIND THIS CONTRACT * ALT. BID: REFURBISH ALL EXISTING WINDOWS	
5. DOORS SHALL BE 6'-FT. 8'-IN. HIGH U.N.O. ON PLAN: * BASE BID: REPLACE ALL EXISTING DOORS IN-KIND THIS CONTRACT * ALT. BID: REFURBISH ALL EXISTING DOORS	
6. COORDINATE ALL ROUGH OPENINGS OF WINDOWS & DOORS WITH MNFR REQ	
7. REFER TO OUTLINE SPECIFICATIONS INCLUDED WITH BLDG-1 & BLDG-3 DWGS FOR ADDITIONAL INFORMATION	
8. INTERIOR FLOOR FINISHES TO BE DETERMINED DURING CONSTRUCTION: INCLUDE BID ALLOWANCE	
9. SMOKE & CARBON MONOXIDE ALARMS TO BE INSTALLED IN FULL COMPLIANCE WITH THE 2015 EDITION OF THE INTERNATIONAL RESIDENTIAL CODE R314	
MEP NOTES: REMODEL	
1. IT IS ASSUMED THAT ALL ELECTRICAL & PLUMBING ACCESSORIES & APPURTENANCES WILL BE REPLACED THIS CONTRACT	
2. EXISTING HVAC SYSTEMS TO BE RE-UTILIZED: SUBCONTRACTOR TO CONFIRM UPGRADES TO EXISTING SYSTEMS TO MEET NEW PLAN REQUIREMENTS	

316 WEST 34th STREET
AUSTIN TX 78705

TWO-FAMILY PROJECT:
PDU: NEW CONSTRUCTION
ADU: ADDITION-REMODEL

ZONING: SF-3--NCCD-NP

BOREN
ARCHITECTS
512.554.5474

DRAWING TITLE:
BUILDING-2 (ADU)
(EXISTING / REMODEL)
FLOOR PLANS



DATE: AS NOTED

PROJECT: 1910: 316

SCALE: AS NOTED

DRAWN: DPB

SHEET: 516

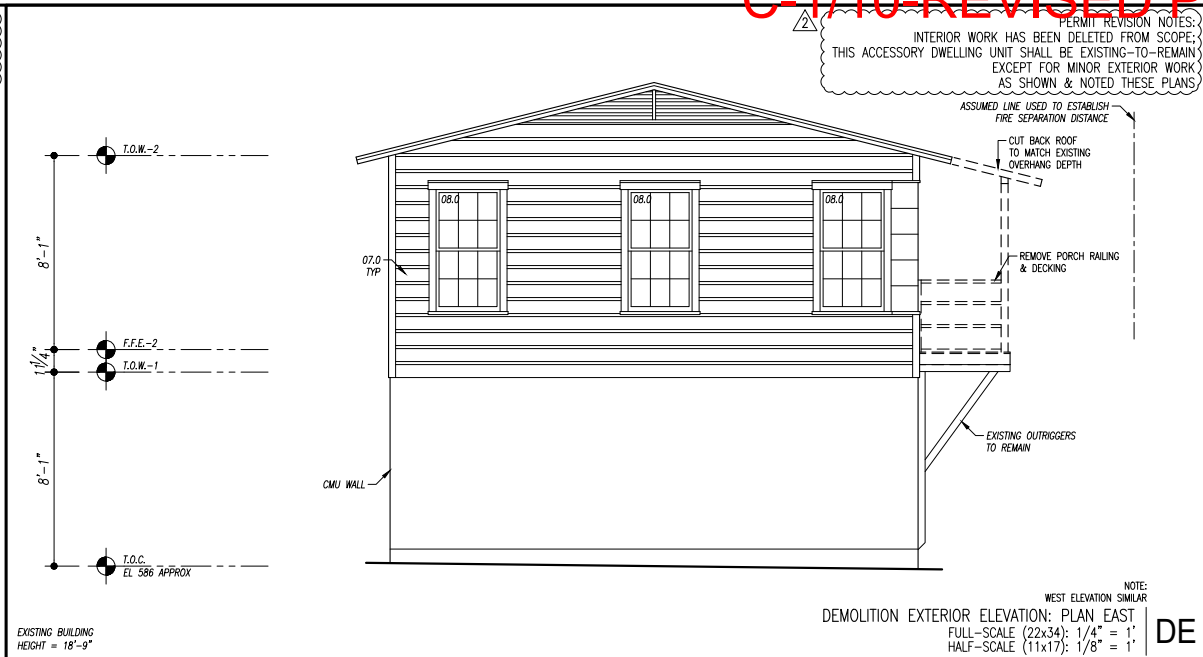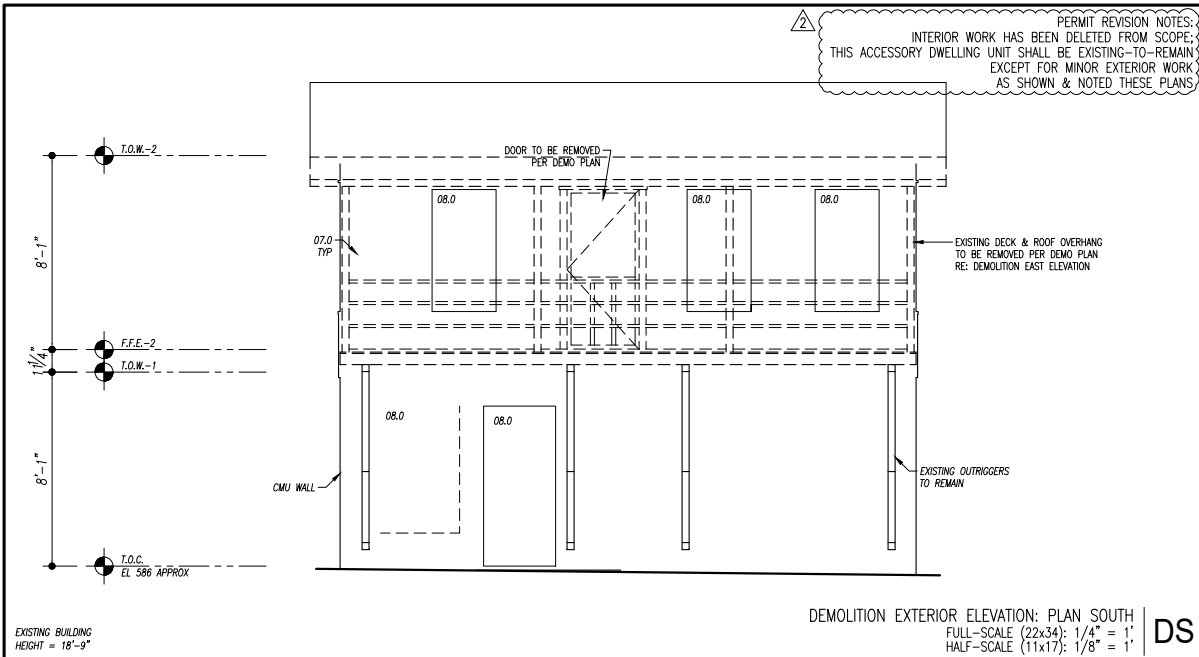

- KEYNOTES LEGEND
- KEYNOTES ARE ORGANIZED IN GENERAL CSI SPECIFICATION FORMAT:
SEE OUTLINE SPECIFICATIONS THIS PACKAGE FOR ADDL INFO
- 01.1 VISIBILITY: INTERIOR ROUTE OF TRAVEL
 - 01.2 VISIBILITY: 30 x 30 REQD CLEAR FLOOR AREA
* SEE VISIBILITY NOTES FOR ADDL INFO THIS ROOM
 - 02.0 EXISTING GRADE TO REMAIN OR BE MODIFIED WHERE NOTED
 - 02.1 NEW PAVEMENT: SLOPE TO DRAIN @ 2% MIN. OR AS NOTED
 - 02.2 NEW FINISH GRADING: SLOPE TO DRAIN @ 2% MIN.
 - 03.1 CONC FOUNDATION PER STRUCTL
 - 03.2 CONC FOUNDATION PER STRUCTL: SLOPE TO DRAIN AS NOTED
 - 03.3 CONC FOUNDATION PER STRUCTL: SPECIAL FEATURE AS NOTED
 - 03.4 CONC FOUNDATION SLOPE TRANSITION: NO VERTICAL EDGE
 - 03.5 CONC FOUNDATION STEMMALL: 4-IN. W. x 6-IN. H.
 - 04.0 EXISTING CONCRETE MASONRY UNIT WALL
 - 05.1 STEEL LINTEL AT NEW WALL OPENING AT EXISTING CMU WALL
 - 06.0 EXISTING WOOD FRAMING ELEMENT
 - 06.1 WOOD FLOOR OR ROOF FRAMING PER STRUCTL
 - 06.2 EDGE OF FRAMING
 - 06.3 LOWER CEILING OR FURR DOWN: DEPTH PER PLAN OR SECTION
 - 06.4 2x6 MIN. BLOCKING IN STUD WALL CENTERED AS NOTED
 - 06.5 PARTIAL-HEIGHT FRAMING: 40-IN. H. NOM. WITH DIVISION-09 CAP TRIM
 - 06.6 INTERIOR PLATFORM: AS NOTED WITH DIVISION-09 CAP TRIM
 - 06.7 STAINED WOOD HANDRAIL
 - 07.0 EXISTING SIDING TO REMAIN: REFURBISH AS REQUIRED
 - 07.1 SIDING TYPE-1: PLANKS WITH 10.75-IN. EXPOSURE TYP U.N.O.
 - 07.2 SIDING TYPE-2: PLANKS WITH 4-IN. EXPOSURE
 - 07.3 ROOF EDGE: 2x8 NOM @ TYPE-1 & 1x6 NOM @ TYPE-2
 - 07.4 EXTERIOR TRIM AS SCHEDULED
 - 07.5 EXTERIOR CEILING AS SCHEDULED
 - 07.6 NEW SIDING TO MATCH EXISTING AT WINDOW OR DOOR INFILL
 - 08.0 EXISTING DOOR OR WINDOW PER REMODEL PLAN NOTES
 - 08.1 SCHEDULED DOOR
 - 08.2 SCHEDULED WINDOW
 - 12.1 MILLWORK: ISLAND WITH BASE CABINETS EA SIDE & TABLE FUNCTION
 - 15.1 HVAC EQUIPMENT OR ACCESSORY
 - 15.2 PLUMBING EQUIPMENT OR ACCESSORY
 - 16.1 ELECTRICAL APPURTENANCE OR ACCESSORY

DATE: 09.11.20
11.04.20



REVISION DESCRIPTION

ADDENDA-1: REVISION FOR CONSTRUCTION SET
ADDENDA-2: PERMIT REVISION

04 NOVEMBER 2020
PERMIT REVISION

The Texas Board of Architectural
Examiners, P.O. Box 12337, Austin, Texas
78711-2337 or 333 Guadalupe, Suite
2-350, Austin, Texas 78701-3942, (512)
305-0800, has jurisdiction over
individuals licensed under the Architects'
Registration Law, Texas Civil Statutes,
Article 249a.

This file is an instrument of service and
is to be used solely for the purposes
stipulated under separate executed
contracts with the Architect. This
document is copyrighted and is not to be
used, duplicated or otherwise modified
except with express permission of the
Architect.

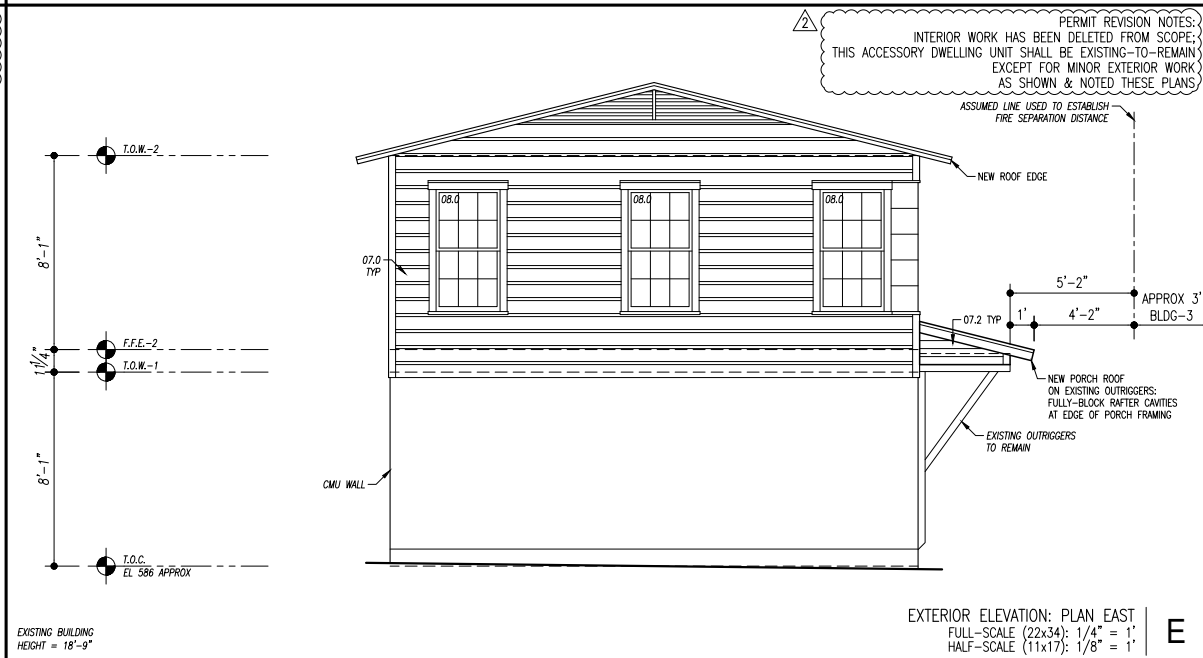
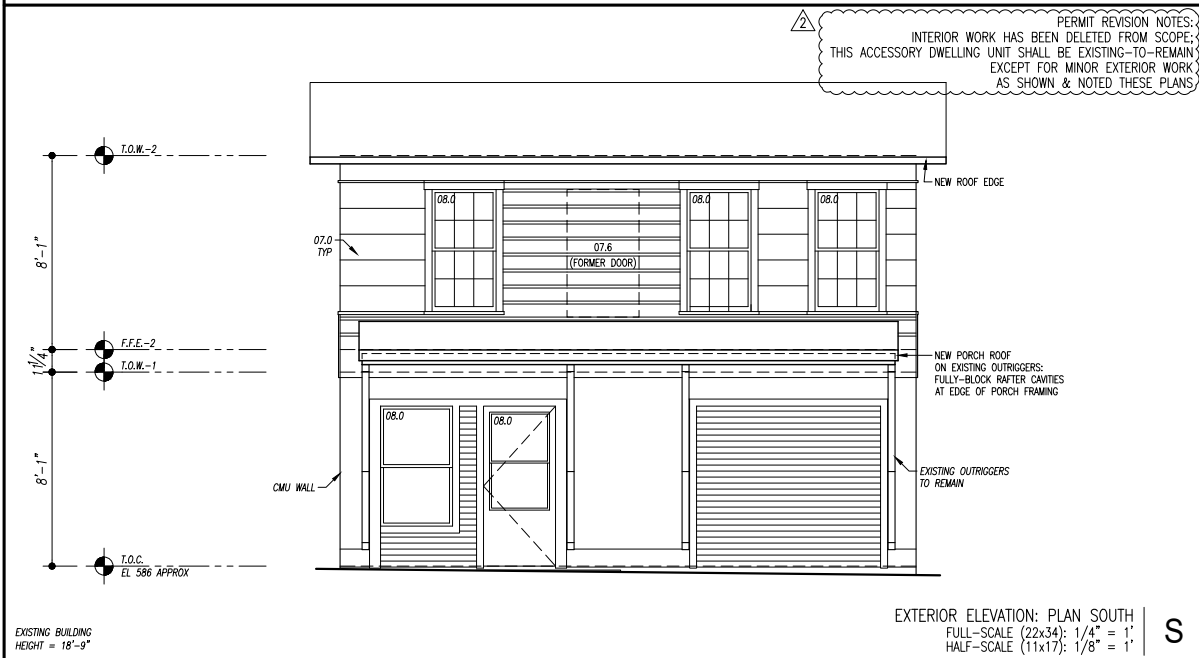


- FLOOR PLAN NOTES: REMODEL
- 1. ITALICIZED TEXT DENOTES AN EXISTING ELEMENT: CONFIRM EXISTING SIZES
 - 2. NEW WALLS HATCHED FOR CLARITY: ALL OTHERS EXISTING U.N.O.
 - 3. ALL DIMENSIONS FROM EDGE OF EXISTING FINISHED EDGE
OR EDGE OF NEW WALL OR FLOOR FRAMING
OR FROM CENTERLINE OF SCHEDULED OPENINGS TYP
 - 4. WINDOWS ARE SIZED ON PLANS IN WIDTH x HEIGHT FORMAT:
* BASE BID: REPLACE ALL EXISTING WINDOWS IN-KIND THIS CONTRACT
* ALT. BID: REFURBISH ALL EXISTING WINDOWS
 - 5. DOORS SHALL BE 6'-0" x 8'-0" HIGH U.N.O. ON PLAN:
* BASE BID: REPLACE ALL EXISTING DOORS IN-KIND THIS CONTRACT
* ALT. BID: REFURBISH ALL EXISTING DOORS
 - 6. COORDINATE ALL ROUGH OPENINGS OF WINDOWS & DOORS WITH MNFR REQ
 - 7. REFER TO OUTLINE SPECIFICATIONS INCLUDED WITH BLDG-1 & BLDG-3 DWGS
FOR ADDITIONAL INFORMATION
 - 8. INTERIOR FLOOR FINISHES TO BE DETERMINED DURING CONSTRUCTION:
INCLUDE BID ALLOWANCE
 - 9. SMOKE & CARBON MONOXIDE ALARMS TO BE INSTALLED IN FULL COMPLIANCE
WITH THE 2015 EDITION OF THE INTERNATIONAL RESIDENTIAL CODE R314

316 WEST 34th STREET
AUSTIN TX 78705

TWO-FAMILY PROJECT:
PDU: NEW CONSTRUCTION
ADU: ADDITION-REMODEL

ZONING: SF-3--NCCD--NP

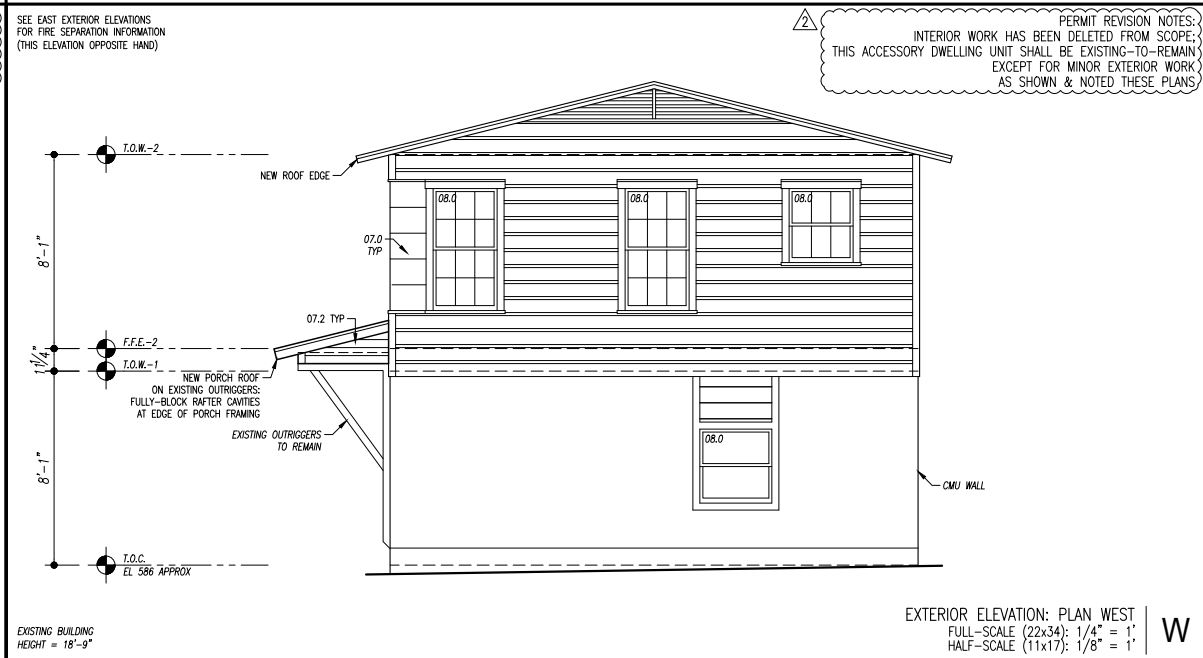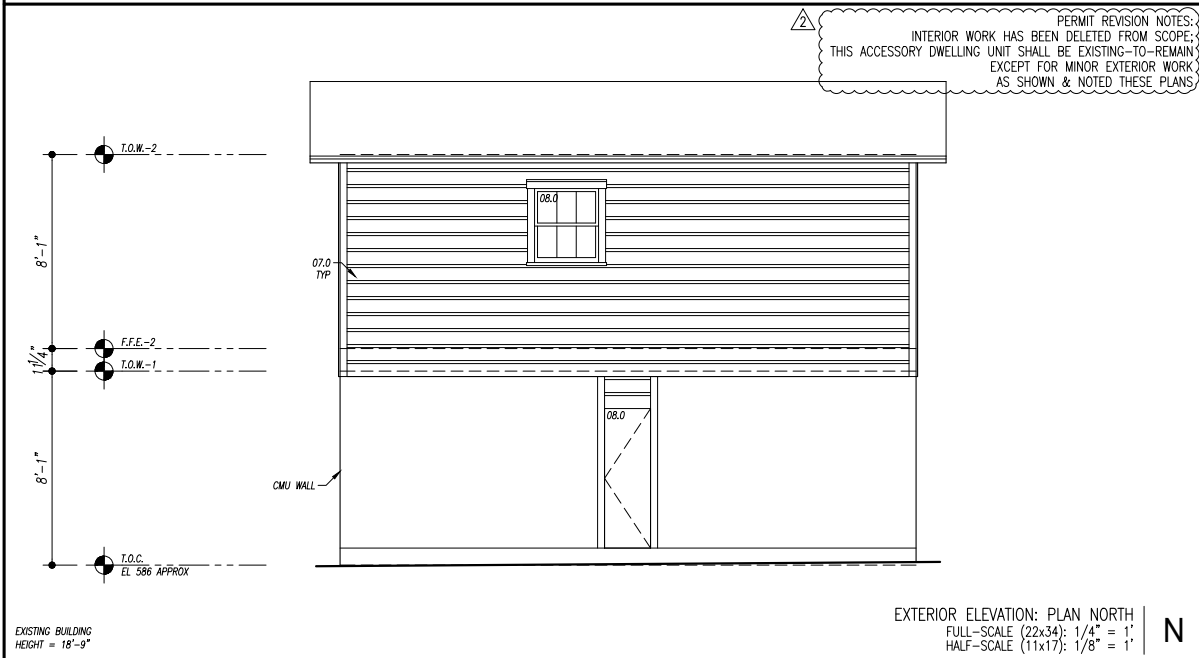

- MEP NOTES: REMODEL
- 1. IT IS ASSUMED THAT ALL ELECTRICAL & PLUMBING ACCESSORIES
& APPURTENANCES WILL BE REPLACED THIS CONTRACT
 - 2. EXISTING HVAC SYSTEMS TO BE RE-UTILIZED: SUBCONTRACTOR TO CONFIRM
UPGRADES TO EXISTING SYSTEMS TO MEET NEW PLAN REQUIREMENTS

BOREN
ARCHITECTS
512.554.5474

DRAWING TITLE:
BUILDING-2 (ADU)
(EXISTING / REMODEL)
EXTERIOR ELEVATIONS


DATE: AS NOTED

PROJECT: 1910: 316

SCALE: AS NOTED

DRAWN: DPB

SHEET: 316

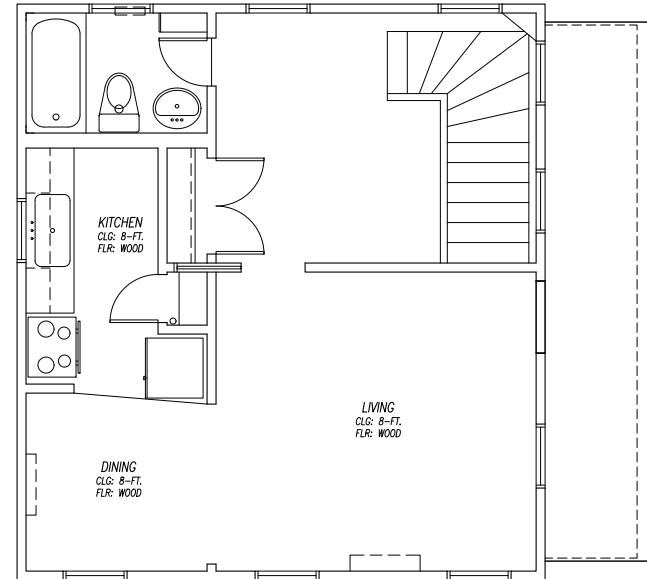









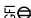


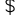














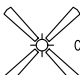


ELECTRICAL PLAN: LEVEL-2
FULL-SCALE (22x34): 1/4" = 1'
HALF-SCALE (11x17): 1/8" = 1'

ELECTRICAL PLAN NOTES

1. POWER & LIGHTING TO BE DESIGN-BUILD BY OTHERS:
THIS PLAN FOR GRAPHIC PURPOSES ONLY
2. COORDINATE POWER REQUIREMENTS FOR ALL EQUIPMENT & APPLIANCES
WHICH MAY OR MAY NOT BE SHOWN ON THESE PLANS
3. FIXTURES & OUTLETS REQUIRED BY CODE TO BE G.F.I.
SHALL BE BID & INSTALLED AS G.F.I.
4. CONFIRM ALL FIXTURES WITH G.C. PRIOR TO BID
5. ENSURE THAT ALL FIXTURES ARE RATED FOR APPLICATION
6. ALL OUTLETS AT KITCHEN COUNTERS SHALL BE G.F.I.
7. ALL OUTLETS IN LAUNDRY ROOM SHALL BE G.F.I.
8. EXTERIOR OUTLETS SHALL BE WEATHERPROOF & G.F.I.
9. ALL BATHROOM & GARAGE OUTLETS SHALL BE G.F.I.
10. ALL CEILINGS FULL-HEIGHT TO STRUCTURE U.N.O.
11. RECESSED FIXTURES SHALL BE I.C. RATED
12. CONFIRM PLACEMENT OF CEILING FIXTURES WITH G.C. AND FRAMING ELEMENTS
13. PROVIDE POWER TO MIRROR CABINETS ABOVE ALL BATHROOM SINKS: CONFIRM
14. BIDDER SHALL NOTE ANY CODE VIOLATIONS OR DISCREPANCIES OR OMISSIONS
WITHIN THIS PLAN WITH G.C. PRIOR TO BID OR BID MOST EXPENSIVE OPTION
15. TELECOMMUNICATIONS & DATA OUTLETS SHOWN FOR GRAPHIC PURPOSES ONLY:
COORDINATE REQUIREMENTS WITH APPROPRIATE SUBCONSULTANT

ELECTRICAL PLAN SYMBOLS LEGEND

- | | | | |
|---|--|---|---|
|  | SWITCH |  | DATA CABLE OUTLET |
|  | SWITCH - 3 WAY |  | DOOR BELL CHIME |
|  | SWITCH - DIMMER |  | RECESSED CAN |
|  | SWITCH - RHEOSTAT |  | WALL SCONCE |
|  | OUTLET: 110V DUPLEX |  | PENDANT |
|  | OUTLET: 110V DUPLEX
G.F.I. |  | WALL SCONCE:
DIRECTIONAL |
|  | OUTLET: 220V |  | UNDERCABINET LIGHTING
OR 3" RECESSED CANLIGHT |
|  | OUTLET: QUADRUPLEX |  | FLUOR. LIGHT FIXTURE,
4' L. U.N.O.:
SURFACE MOUNTED |
|  | TELEPHONE OUTLET |  | FLUOR. LIGHT FIXTURE,
2' L. U.N.O.:
SURFACE MOUNTED |
|  | TELEVISION OUTLET
FEATURING HDMI & CAT-5
CABLE CONNECTIONS |  | RECESSED CAN
WITH DIRECTIONAL LENS |
|  | AUTO-OPEN PUSH-BUTTON |  | FLOOD LIGHTS WITH MOTION
DETECTOR & PHOTOCELL |
|  | AIR SWITCH FOR G.D. |  | LED ROPE LIGHT IN COVE |
|  | DOOR BELL BUTTON | | |
|  | HEAT DETECTOR | | |
|  | DOOR FRAME LIGHT SWITCH | | |
|  | SMOKE DETECTOR | | |
|  | CEILING FAN | | |

ABBREVIATIONS LEGEND:


- | | |
|--------|------------------------|
| A.F.F. | ABOVE FINISH FLOOR |
| D. | DRYER |
| E.W. | EACH WAY |
| FLOOR. | FLUORESCENT |
| G.D. | GARBAGE DISPOSAL |
| GFI | GROUND FAULT INTERRUPT |
| L.S. | LAZY SUSAN |
| M.W. | MICROWAVE OVEN |
| N.T.S. | NOT TO SCALE |
| S.M. | SURFACE MOUNTED |
| SUSP. | SUSPENDED |
| VRS. | VARIES |
| W. | WASHER |
| WH | WATER HEATER |
| W.M. | WALL MOUNTED |
| WP | WATERPROOF |

REMODEL NOTES


ELECTRICIAN SHALL FIELD-VERIFY EXISTING CONDITIONS PRIOR TO BID
TO ESTABLISH SCOPE-OF-WORK

SOME RECESSED CANS MAY REQUIRE LOW-PROFILE KITS DUE TO EXISTING FRAMING CONDITIONS: V.I.F.

COORDINATE WITH HVAC & PLUMBING SUBCONTRACTORS FOR ADDL WORK
NOT NECESSARILY SHOWN THIS PLAN

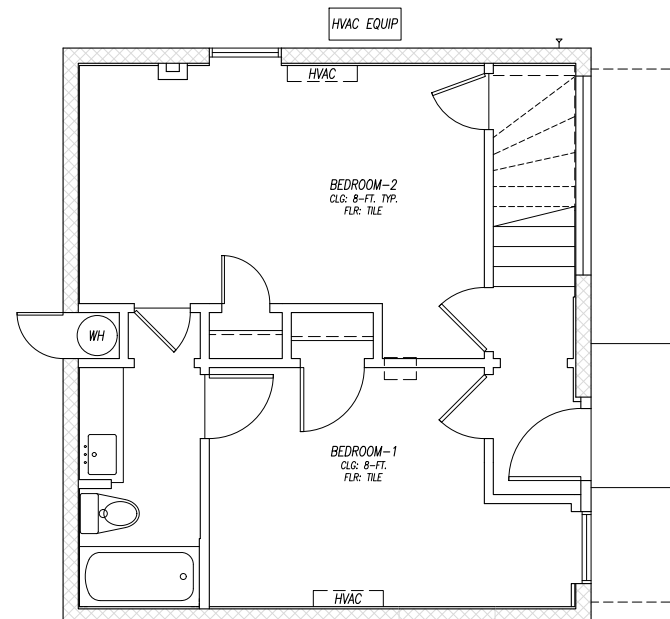

ELECTRICAL PLAN: LEVEL-1
FULL-SCALE (22x34): 1/4" = 1'
HALF-SCALE (11x17): 1/8" = 1'

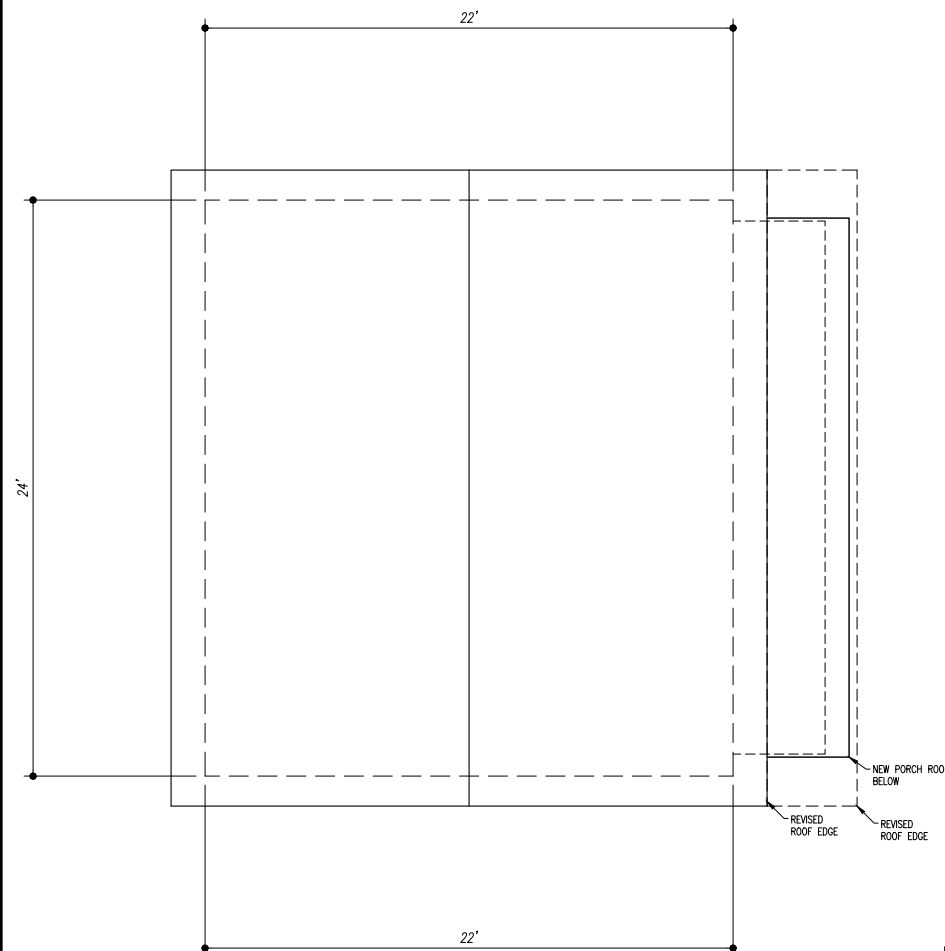

ROOF PLAN
FULL-SCALE (22x34): 1/4" = 1'
HALF-SCALE (11x17): 1/8" = 1'

09.11.20	11.04.20
----------	----------

ADDENDA-1: REVISION FOR CONSTRUCTION SET
ADDENDA-2: PERMIT REVISION



04 NOVEMBER 2020
PERMIT REVISION

The Texas Board of Architectural Examiners, P.O. Box 12337, Austin, Texas 78711-2337 or 333 Guadalupe, Suite 350, Austin, Texas 78701-3942, (512) 305-9000, has jurisdiction over all individuals licensed under the Architects' Registration Law, Texas Civil Statutes, Article 249a.

This file is an instrument of service and is to be used solely for the purposes stipulated under separate executed contracts with the Architect. This document is copyrighted and is not to be used, duplicated or otherwise modified except with express permission of the Architect.

316 WEST 34th STREET
AUSTIN TX 78705

TWO-FAMILY PROJECT;
PDU: NEW CONSTRUCTION
ADU: ADDITION-REMODEL
ZONING: SF-3-NCCD-NP

OREN
ARCHITECTS
512.554.5474

DRAWING TITLE:

BUILDING-2 (ADU)
EXISTING / REMODEL)
ELECTRICAL & ROOF PLANS

DATE: AS NOTED

PROJECT: 1910: 316

SCALE: AS NOTED

RAWN: DPB

HEET:
16

A2-

A2-3