

HIGHLAND AVENUE

SITE PLAN
(22X34 SHEET) SCALE= 1"=10'-0" (11X17 SHEET) SCALE= 1"=20'-0"

612 Highland Avenue

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A2.1: NORTH & WEST EXTERIOR ELEVATIONS A3.0: BUILDING SECTIONS

ZONING	SF-3
TOTAL LOT SIZE	7,111 S.
BUILDING COVERAGE	
	1,274 S.
CONDITIONED MAIN FLOOR AREA COVERED FRONT PORCH	1,274 S. 222 S.F.
CONDITIONED MAIN FLOOR AREA	


411 S.F.
2.844 S.F.
2,418 S.F.

TOTAL BUILDING COVERAGE	2.418 S.F
STEPS @ GARAGE	2,410 S.F. 24 S.F.
CONCRETE PARKING RUNNERS	102 S.F.
WOOD TRASH DECK (1 / 2 S.F.)	40 S.F.
CONCRETE STEPS AND PADS	80 S.F.
CONCRETE FRONT STEPS	11S.F.
SITE WALLS	146 S.F.
A/C/ PAD	18 S.F.
IMPERVIOUS COVERAGE TOTAL ALLOWED @ 45% OF 7,111 S.F. =	3,200 S.I
IMPERVIOUS COVERAGE TOTAL @ 40%	2,839 S.
FLOOR AREA RATIO CALCS.	
	1,274 G
(FAR) MAIN FLOOR GROSS AREA	1.274 G
(FAR) MAIN FLOOR GROSS AREA (FAR) BASEMENT GROSS AREA	
	261 G.F.

FLOOR AREA RATIO (FAR) TOTAL (ALLOWED) @ 40% OF 7,111 S. FLOOR AREA RATIO (FAR) TOTAL (NEW) =

SITE NOTES

- STLE NOTES
 1.STEPTAN BASED ON SURVEY PLAT OF 612 HIGHLAND AVENUE, AUSTIN TX 78703. LOT 12, BLOCK B,
 TERNACE PARK, A SUBDIVISION RECORDED X VOLUME 2, PAGE 242, PLAT RECORDS OF TRAVIS COUNTY.
 STE INFORMATION BASED OFF OF SURVEY PREFORMED BY STUART W. WASTON, REGISTRED
 PROFESSIONAL LAND SURVYOR TEXES LICTINS INMURE \$150 ON HEBRINARY 18, 2016.
 2. PROVIDE UNDERCROLIND ELECTRICAL SERVICE FROM NEW ELECTRICAL UTILITY PLICE. COORDINATE
 DESIGN & DETLISM UTILITY LINES ALTONE MANDEL LOCATION OF UTILITY LINES & PAREL
 LOCATIONS WITH ARCHITECT
 3. PROTFECT TREES, ROCK OUT CROPPINGS, AND NATURAL SITE FEATURES DURING CONSTRUCTION.
 MINIMUES SEID EDSTURBANCE TO PROJECT LINT LINE.
 4. LIMIT AREAS OF STOCKPILED MATERIAL TO AREAS APPROVED BY ARCHITECT.

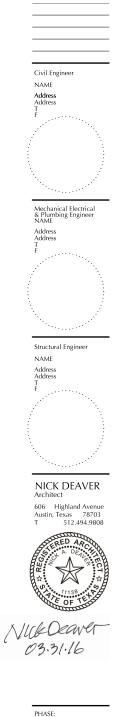

PERMIT DOCUMENTS


GOLOD Residence

612 HIGHLAND DR. Austin, TX 78703

DRAWING NAME:

SITE PLAN

DRAWN BY:	AM		
CHECKED BY:	ND		
JOB #:	248		
FILE:			
C 2016 NICKDEAVERARCHITECT			
DATE: 03.31.2016			
SCALE:			
SHEET:	1		

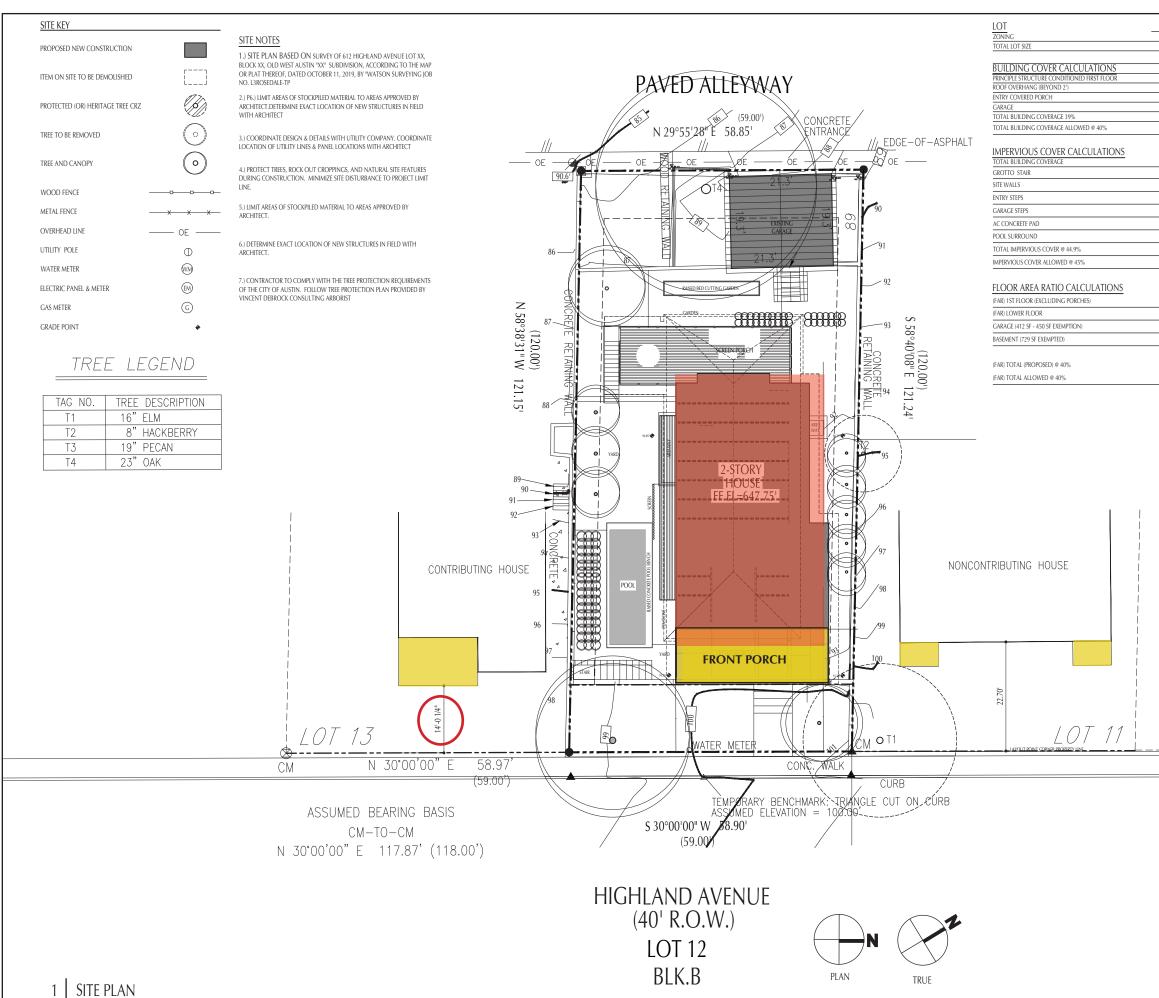

SCALE = 1:10 (22X34) SCALE = 1:20 (11X17)

612 Highland Avenue

SF-3-NP		REVISIONS
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1513 SF	A1.0: FLOOR PLAN	
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412 SF	A1.2: GENERAL NOTES, SYMBOLS, DOOR & WINDOW SCHEDULES	
2756 SF	A1.3: GENERAL NOTES, SYMBOLS, DOOR & WINDOW SCHEDULES	
2826 SF	A2.0: EXTERIOR ELEVATIONS	
	A3.0: BUILDING SECTIONS	
2756 SF	A4.0: WALL SECTIONS & SECTION DETAILS	
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3180 SF	S0.0: STRUCTURAL GENERAL NOTES	
	S1.0: FOUNDATION PLAN	
1513 SF	S1.1: FRAMING PLAN	
1312 SF	S1.2: ROOF FRAMING PLAN	
0 SF	S1.3: MAIN LEVEL BRACING PLAN	
0 SF	S1.4: SECOND LEVEL BRACING PLAN	
	S2.0: FOUNDATION DETAILS	
2825 SF	S3.0: FRAMING DETAILS	
2826 SF	S3.1: FRAMING DETAILS	
	55.1. HAMING DEI/AE5	
		NICK DEAVER Architect
		606 Highland Avenue Austin, Texas 78703 www.nickdeaver.com



phase: DESIGN DEVELOPMENT

NICH Deave

project: COOK

Residence

612 HIGHLAND AVE. AUSTIN, TX 78703

PROJECT MANAGER:

DRAWING NAME:

SITE PLAN

SHEET:

SP1

1. NO MATERIAL OR DUMPSTER STORAGE OVER THE $\frac{1}{2}$ CRZ. 2. PEDESTRIAN TRAFFIC AND STORAGE ONLY IN THE $\frac{1}{2}$ CRZ WITH 2 LAYERS OF 1° PLYWOOD SEPARATED BY 2X4 WILL BE USED IN ALL PEDESTRIAN TRAFFIC AND STORAGE AREAS INSIDE THE CRZ.

3. LIMITED SIZE EQUIPMENT AND TRAFFIC INSIDE THE $\frac{1}{2}$ CRZ.

CONTRACTOR TO PROPOSE DUMPSTER LOCATION, MATERIAL DROP OFF AND STORAGE AREAS, FENCING, AND GATE LOCATIONS TO ARCHITECT PRIOR TO BEGINNING OF CONSTRUCTION

CONTRACTOR TO SEE TREE PLAN FOR PROTECTION OF CRITICAL ROOT ZONE DURING CONSTRUCTION AND TRAFFIC. ALL TREES ON SITE TO BE GIVEN MEASURES TO AVOID DAMAGE BEFORE, DURING CONSTRUCTION

From: Nick Deaver nick@nickdeaver.com Subject: Re: 612 Highland Ave. Austin. Tx 78703 Date: August 24, 2020 at 1:46 PM To: Cara Bertron Cara.Bertron@austintexas.gov Cc: Jessica Deaver jessica@nickdeaver.com

Hello Cara,

We are still in the process of designing a new house for the 612 Highland Ave property. We are hoping to meet with the Historic Subcommittee as soon as we have satisfied our clients.

I have been trying to identify the appropriate front yard setback for our New Construction on the site where the original house burned.

Article 2.3.B Average Front Yard Setback (of Subchapter F: Residential Design and Compatibility Standards) allows us to average the 4 structures that are closest to our property on the same side of the road, (some of which are not contributing structures to the Smoot/Terrace Park Local Historic District): while the Design Guidelines for New Construction in the Smoot/Terrace Park HD Design Standards/Preservation Plan allows: 2. Setbacks for new construction of a new principal building shall be consistent with setbacks the district's contributing houses by taking the average of the existing setbacks of contributing houses on the same block face, or by aligning with the setback of one adjacent contributing house. This may allow setbacks that are shallower than the base zoning.

Would you please advise me as to which Front Yard setback would take precedent?

Thanks for your help, Nick

Nick Deaver

Nick Deaver Architect nickdeaver.com

512.494.9808 о.

512.801.1764

On Aug 5, 2020, at 11:42 AM, Bertron, Cara <Cara.Bertron@austintexas.gov> wrote:

Got it, thanks. I'll wait to hear from you. As I wrote last month, I'd strongly recommend that you get early feedback on the project—but the timing for that is your call.

Cara Bertron

Senior Planner / Deputy Historic Preservation Officer City of Austin Planning and Zoning Department (512) 974-1446 | cara.bertron@austintexas.gov

From: Jessica Deaver <jessica@nickdeaver.com> Date: Tuesday, August 4, 2020 at 5:11 PM To: "Bertron, Cara" <<u>Cara.Bertron@austintexas.gov</u>> Cc: Nick Deaver <<u>nick@nickdeaver.com</u>> Subject: Re: 612 Highland Ave. Austin. Tx 78703



From: Bertron, Cara Cara.Bertron@austintexas.gov Subject: Re: 612 Highland Ave. Austin, Tx 78703 Date: September 15, 2020 at 1:25 PM To: Nick Deaver nick@nickdeaver.com Cc: Jessica Deaver jessica@nickdeaver.com

> Hi y'all, sorry again for the delay. The Smoot/Terrace Park Design Standards control when they conflict with other code provisions. This doesn't come up very often; I'm happy to talk to a coordinating reviewer to avert any confusion, if you're already working with someone in the **Development Services Department.**

Cara

From: "Bertron, Cara" <Cara.Bertron@austintexas.gov> Date: Thursday, August 27, 2020 at 9:11 AM To: Nick Deaver <nick@nickdeaver.com> Cc: Jessica Deaver <jessica@nickdeaver.com> Subject: Re: 612 Highland Ave. Austin, Tx 78703

Hi Nick,

I wanted to let you know that I'm checking on this with the Law Department to be sure. Apologies for the delay—I hope to get back with you soon.

Cara

Cara Bertron

Senior Planner / Deputy Historic Preservation Officer City of Austin Planning and Zoning Department (512) 974-1446 | cara.bertron@austintexas.gov

612 Highland Avenue







February 2021



Before November 2019

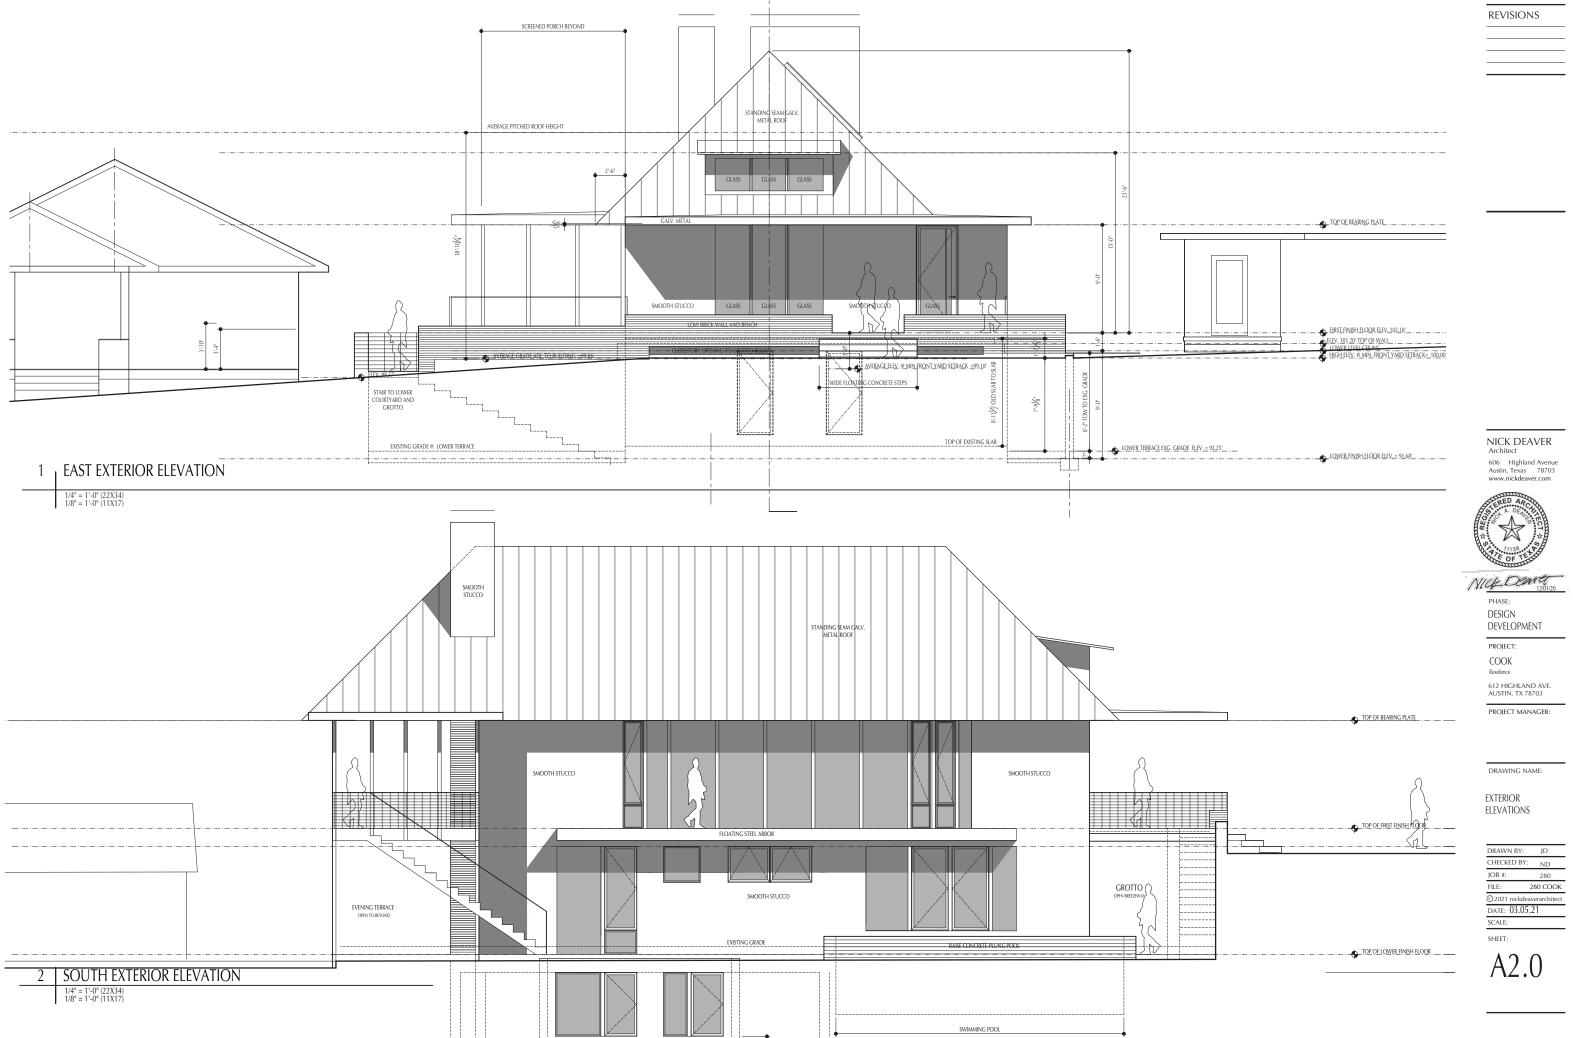

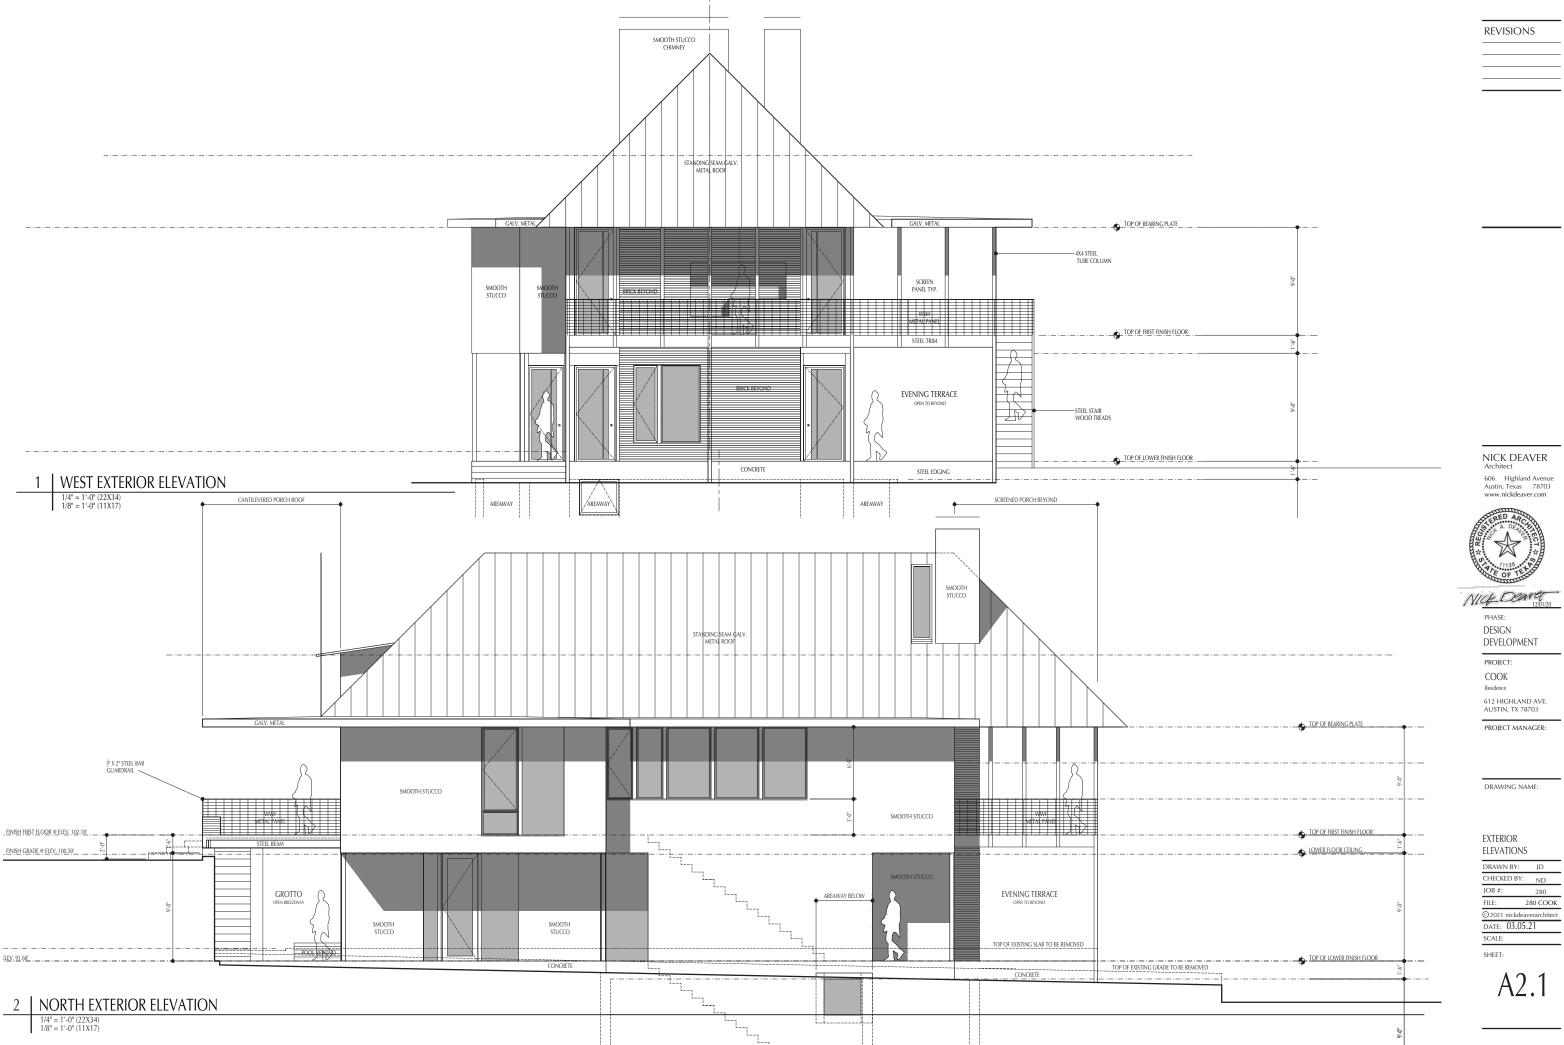





Smoot/Terrace Park Historic District Design Guidelines for New Construction

- 1.) Same street orienation and distance from adjacent buildings.
- 2.) Front yard setback aligns with setback of adjacent contributing house to the south.
- 3.) Compatible but differentiated from historic bungalows. Deliberatly departing from Craftsman Style with modern architecture that reflects its time.
- 4.) Reflects materials in the neighborhood. (Brick and Stucco, Standing Seam Metal Roof, Wood Porch Ceiling and Soffits.)
- 5.) Matches original footprint and eave heights of *original structure, maintaining scale, massing, and spacing between houses. (Street pattern is 5' setback, open space for drive, house repeat)
- 6.) A modern house "not a historic style" with front proportions and fenestration patterns similar to neighbors.
- 7.) Simple hipped roof with front facing dormer and projected front porch.
- 8.) Deep building-wide front porch matching width, floor height, and ceiling height of the original structure. Maintains relationship to the ground.
- 9.) Single story with lower floor and outdoor garden at level below street grade.

612 Highland Avenue

* Original Structure destroyed by fire in 2019