PROJECT LOCATION | PROXIMITY MAP



GENERAL NOTES

- 1. THE CONTRACTOR SHALL THOROUGLY REVIEW ALL CONSTRUCTION DOCUMENTS INCLUDING, BUT NOT LIMITED TO, DRAWINGS, NOTES, DIMENSIONS AND SCHEDULES. THE CONTRACTOR SHALL MAKE A DETAILED SITE VISIT, AND SHALL IMMEDIATELY BRING ANY INCONSISTENCY, SITE LAYOUT PROBLEM, OR ANY OTHER REQUEST FOR CLARIFICATION TO THE ARCHITECT FOR RESOLUTION PRIOR TO THE DELIVERY OF ANY BID OR INITIATION OF WORK. FAILURE TO DO SO SHALL CAUSE THE CONTRACTOR TO BE INELIGIBLE FOR EXTRAS RELATING TO SUCH MATTERS.
- THESE DRAWINGS ARE, IN GENERAL, DIAGRAMMATIC. EXACT LOCATIONS SHALL BE DETERMINED BY THE CONTRACTOR FROM FIELD MEASUREMENTS taken by contractor's personnel. Actual arrangement of the work shall follow locations shown on the drawings within the CONSTRAINTS OF EXISTING EQUIPMENT AND CONSTRUCTION. DRAWING AND NOTES TO DRAWINGS ARE CORRELATIVE AND HAVE EQUAL AUTHORITY AND PRIORITY. SHOULD THERE BE DISCREPANCIES IN THEMSELVES OR BETWEEN THEM, CONTRACTOR SHALL BASE BID PRICING ON THE MOST EXPENSIVE
- 3. DO NOT SCALE THESE DRAWINGS. IMMEDIATELY NOTIFY THE ARCHITECT OF ANY DISCREPANCIES OR ANY OTHER REQUEST FOR CLARIFICATION.
 4. VERIFY ALL DIMENSIONS BEFORE ORDERING MATERIAL AND PROCEEDING WITH THE WORK.
- MINIMUM CLEARANCE DIMENSIONS INDICATED SHALL BE MAINTAINED PARTICULARLY AT STAIRS, CORRIDORS AND RESTROOMS.
 CONTRACTOR TO ACQUIRE ALL NECESSARY PERMITS PRIOR TO WORK.
 CONTRACTOR IS RESPONSIBLE FOR THE SAFETY, ACTIONS AND CONDUCT OF HIS EMPLOYEES AND HIS SUBCONTRACTORS' EMPLOYEES WHILE IN THE
- 10. EVERY EFFORT HAS BEEN MADE ON THE PART OF THE ARCHITECT TO ENSURE LOCAL CODE COMPLIANCE. IT IS THE CONTRACTOR'S RESPONSIBILITY TO VERIFY THAT THE WORK CONFORMS WITH ALL APPLICABLE CODES, AND IF DISCREPANCIES ARE NOTED, TO NOTIFY THE ARCHITECT PRIOR TO WORK.
- 12. PROVIDE BLOCKING AS REQUIRED FOR PROPER SUPPORT OF WALL AND CEILING MOUNTED EQUIPMENT.
- 13. INSTALL PEX PIPE SYSTEM PLUMBING; INSULATE AS REQUIRED.

 14. FOR ALL "MATCH EXISTING" NOTES, ARCHITECT'S INTENT IS FOR CONTRACTOR TO MATCH EXISTING PROFILE AND FINISH AS CLOSE AS POSSIBLE USING AVAILABLE STOCK MATERIALS. IF UNABLE TO MATCH EXISTING, PROVIDE SAMPLES FOR ALTERNATE MATERIALS OR METHODS FOR ARCHITECT'S APPROVAL. 15. DISSIMILAR METALS TO REMAIN SEPARATED TO AVOID GALVANIC CORROSION. 16. ALL EXTERIOR WALLS AND ROOFS TO HAVE CLOSED CELL SPRAY FOAM INSULATION
- 17. ALL EXTERIOR WALLS TO BE STUD GRADE 2 X 6 NO. 2 SYP WITH STUDS AT 24" OC UNLESS OTHERWISE NOTED. 18. ALL INTERIOR WALLS TO BE STUD GRADE 2 X 4 OR NO. 2 SYP WITH STUDS AT 16" OC WITH 1/2" GYPSUM BOARD SHEATHING ON BOTH SIDES UNLESS OTHERWISE NOTED. ALL CAVITIES IN WALL ASSEMBLY TO BE FILLED WITH R-1 1 SOUND BATT INSULATION.
- 19. ALL CEILINGS TO BE SHEATHED WITH 5/8" GYPSUM BOARD UNLESS OTHERWISE NOTED. 20. ALL INTERIOR PAINTS, STAINS AND SEALANTS TO BE NON-TOXIC. 1. FIRE SUPPRESSION SYSTEM MUST BE INSTALLED BY A CONTRACTOR LICENSED PER STATE FIRE MARSHAL'S REQUIREMENTS. SHOP DRAWINGS OF SYSTEM
- MUST BE SUBMITTED TO FIRE MARSHAL FOR REVIEW AND APPROVAL.

 22. ALL WORK MUST BE IN COMPLIANCE WITH THE APPLICABLE NFPA STANDARDS AND THE INTERNATIONAL FIRE CODE AS AMENDED BY THE CITY OF
- 23. MINIMUM OF 15 DAYS MUST BE ALLOWED FOR NEW SYSTEM PLAN REVIEWS

PROJECT CODE ANALYSIS

ZONING: MF-4 NP PARCEL ID: 106602 CONSTRUCTION TYPE: V-B

LOT SIZE: 10,130 SQFT (.233 ACRES)

FLOOR AREA RATIO: PROVIDED: 39% (3,934 SQFT) ALLOWED: MAX 40% (4,052 SQFT)

IMPERVIOUS COVERAGE: PROVIDED: 43% (4345.5)

ALLOWED: 45% (4558.5) AIR CONDITIONED AREA: 4,854 SQFT


MAIN HOUSE

1,187 SQFT BASEMENT FLOOR: LEVEL 01: 1,868 SQFT LEVEL 02: 701 SQFT TOTAL: 3,756 SQFT

LEVEL 01: 549 SQFT 549 SQFT LEVEL 02: TOTAL: 1,098 SQFT

CARPORT: 267 SQFT GARAGE: 445 SQFT

ARCHITECTURAL SYMBOLS

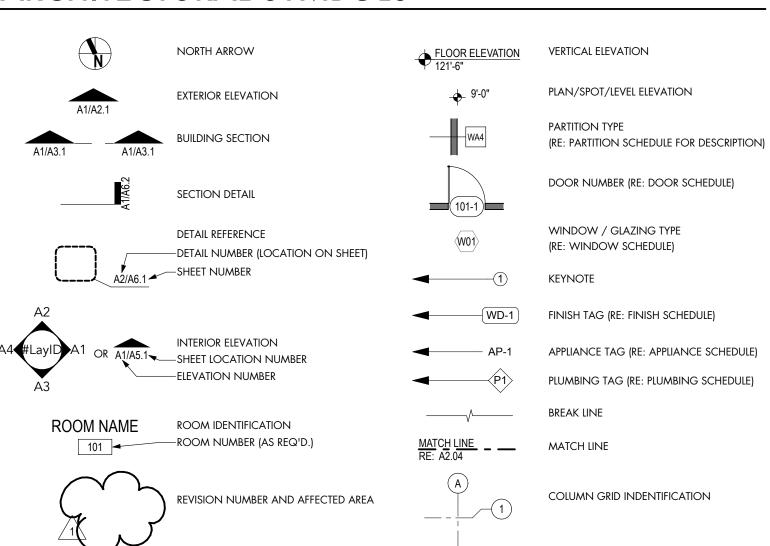

613 West Lynn Spec

613 West Lynn Austin, TX 78703

PROJECT DESCRIPTION

REMODEL OF EXISTING HOME WITH AN ADDITION OF AN ADU.

PROJECT TEAM

CLIENT

CONTACT: MICHAEL LAHR 10808 PELICAN POINT, AUSTIN, TX 78778730 e: LAHRHOME91@GMAIL.COM

ARCHITECT

DESIGNTRAIT ARCHITECTS CONTACT: BECKY JEANES 2525 SOUTH LAMAR #6 AUSTIN, TX 78704 PH: 512-542-0073 EMAIL: BECKY@DESIGNTRAIT.COM

SHEET INDEX

ARCHITECTURAL

COVER SHEET A0.1 SURVEY

SITE PLAN

BUILDING TENT EXHIBIT BASEMENT EXEMPTION EXHIBIT

D1.1

MAIN HOUSE - FLOOR PLAN BASEMENT LEVEL

MAIN HOUSE - FLOOR PLAN LEVEL 1

MAIN HOUSE - FLOOR PLAN LEVEL 2 MAIN HOUSE - ROOF PLAN

A1.5 ADU - FLOOR PLANS LEVEL 1 & 2 BUILDING ELEVATIONS

BUILDING ELEVATIONS


A2.3 BUILDING ELEVATIONS

BUILDING ELEVATIONS A3.1 BUILDING SECTIONS

DESIGNTRAIT ARCHITECTS

9

SHEET TITLE **COVER SHEET**

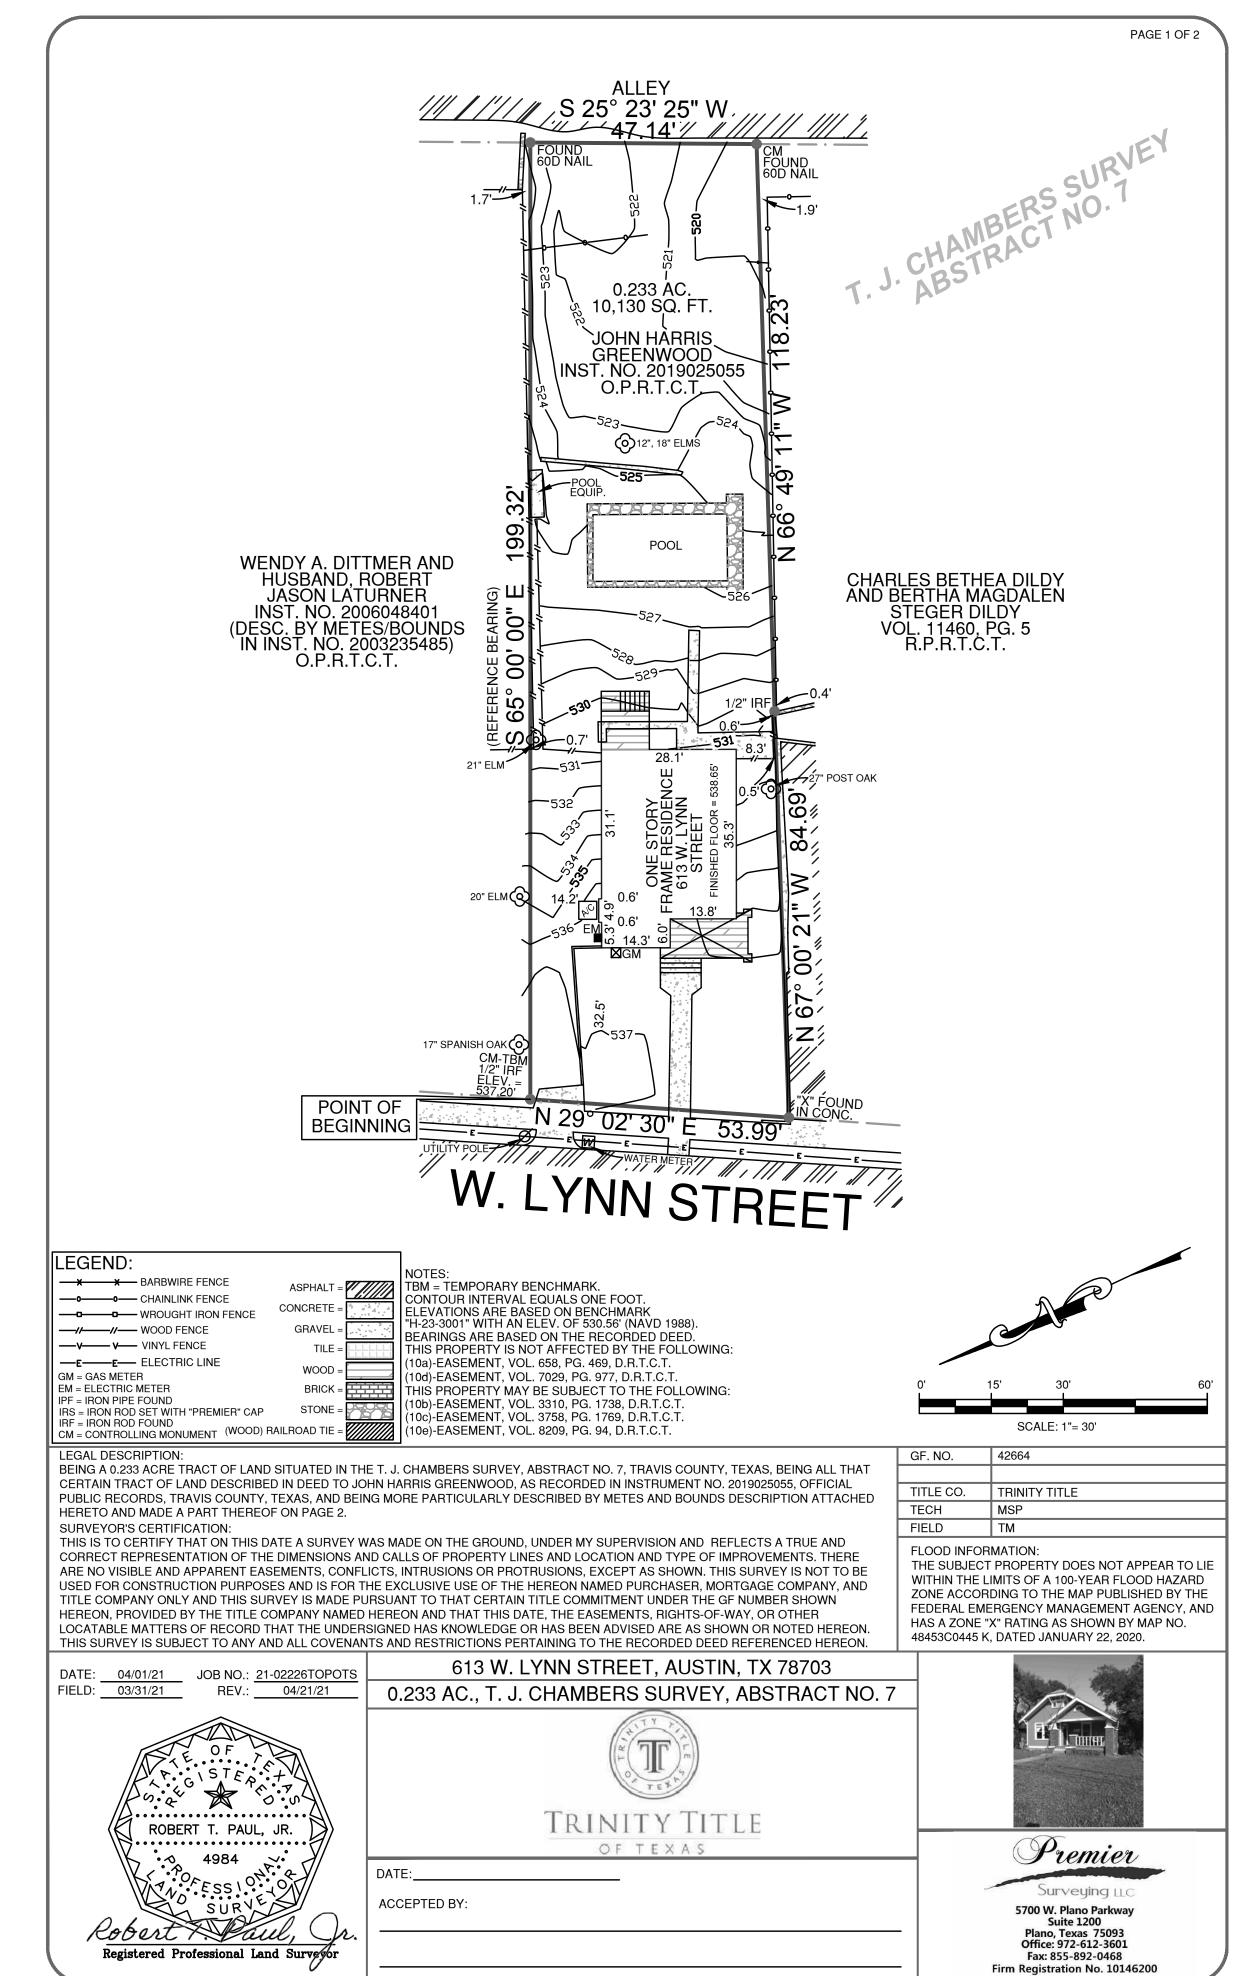


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SHEET TITLE

CAUTION: DO NOT SCALE DRAWINGS

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SURVEY



CONSTRUCTION NOT FOR

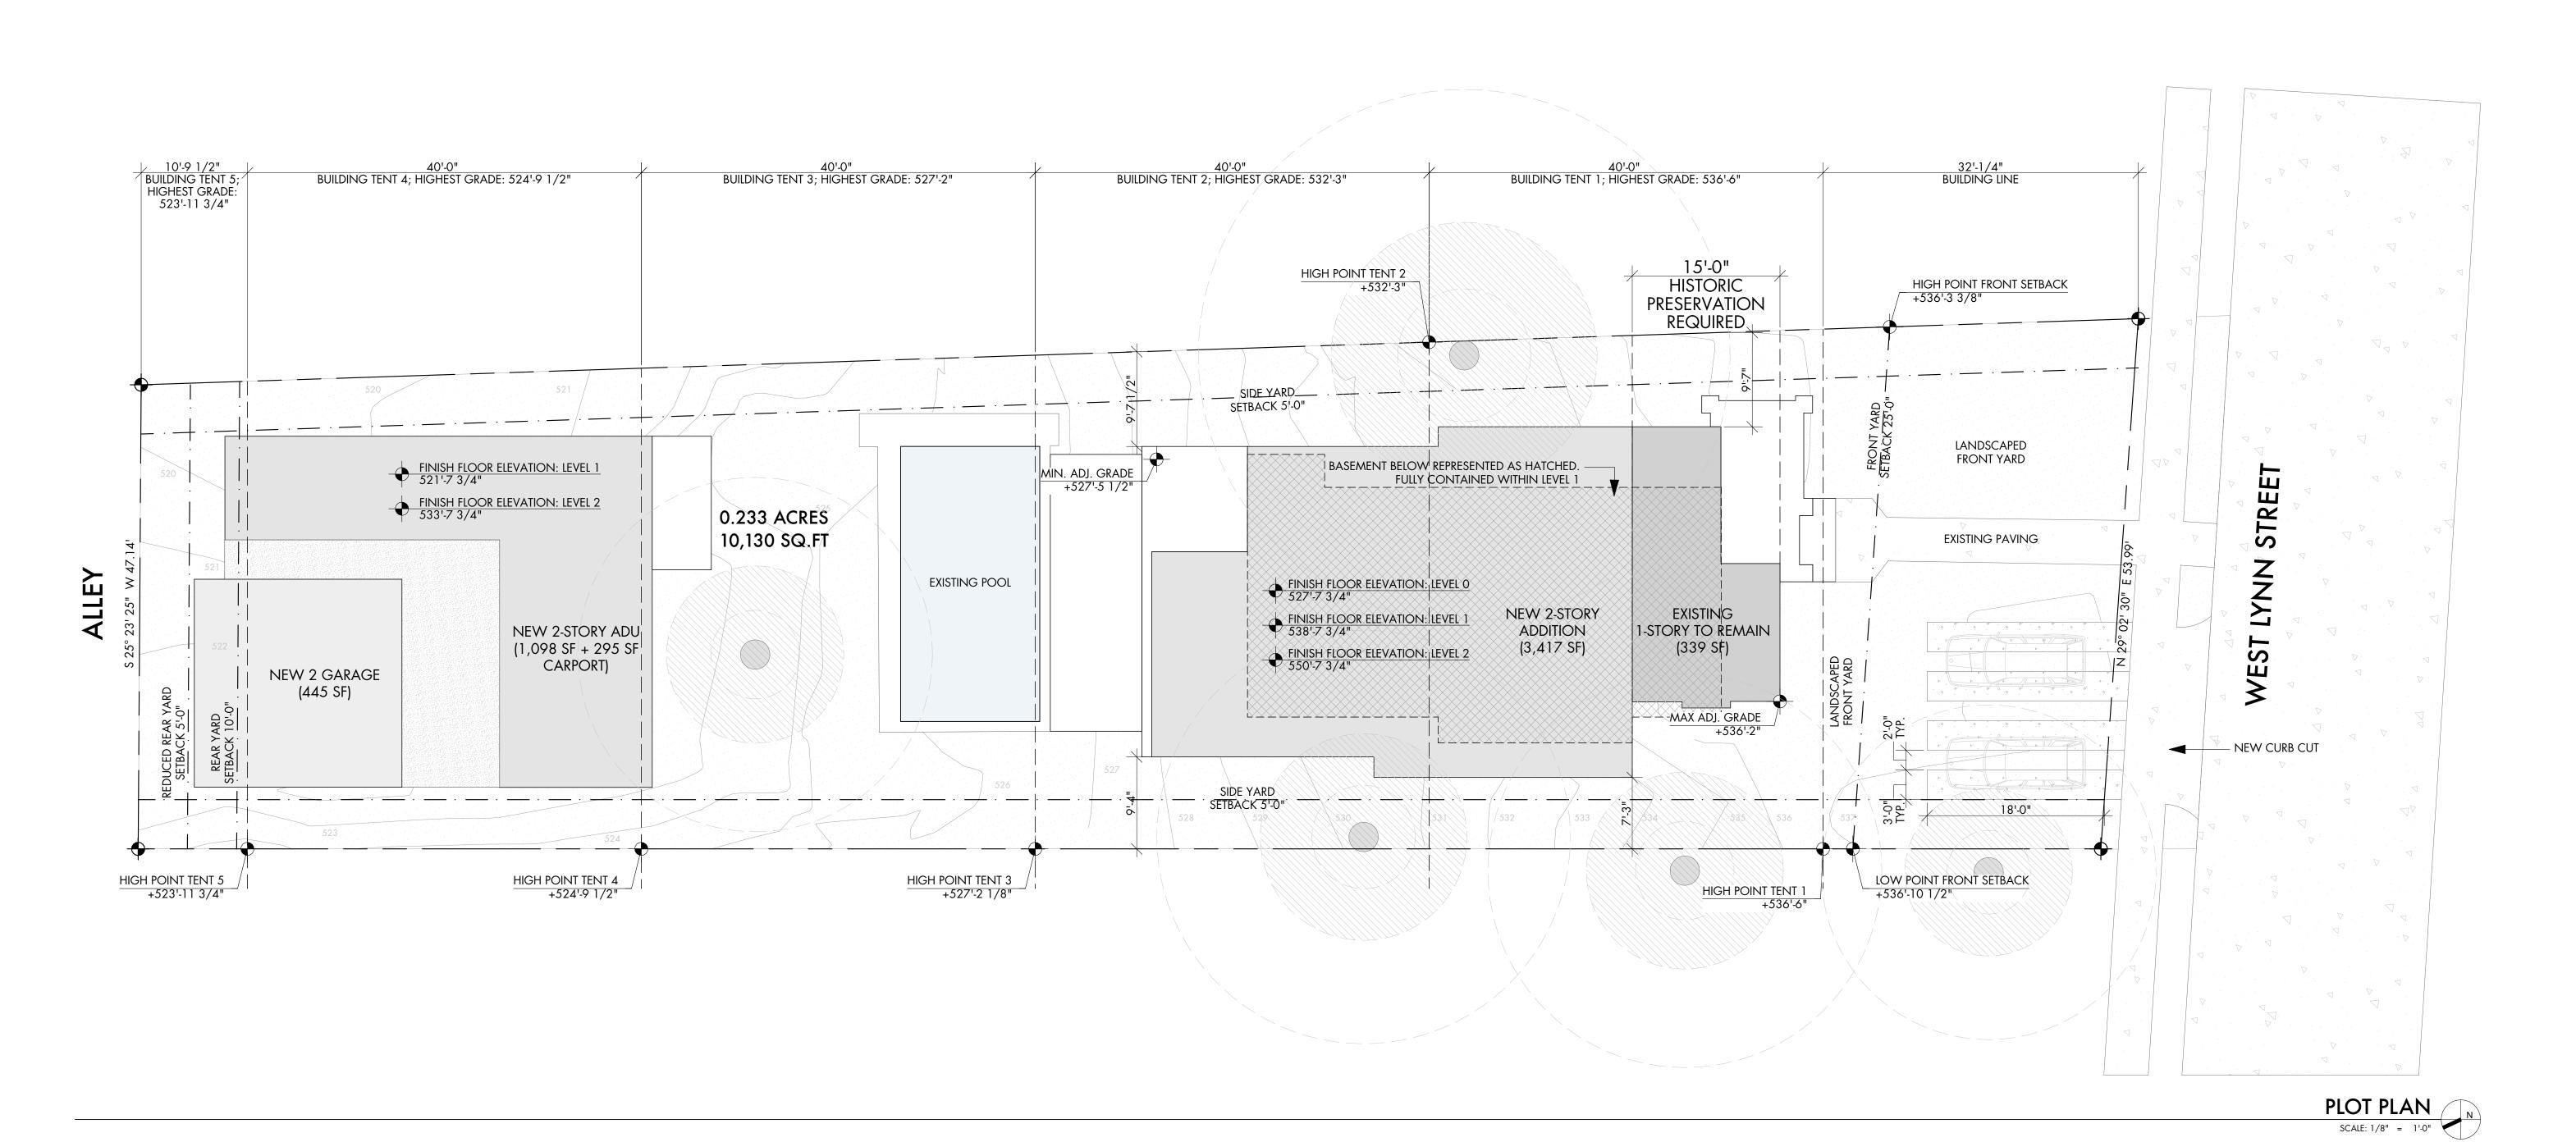Kegistration #2129/
6/9/21

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permitting or construction.

Tray Toungate - Texas Architect
Registration #21509


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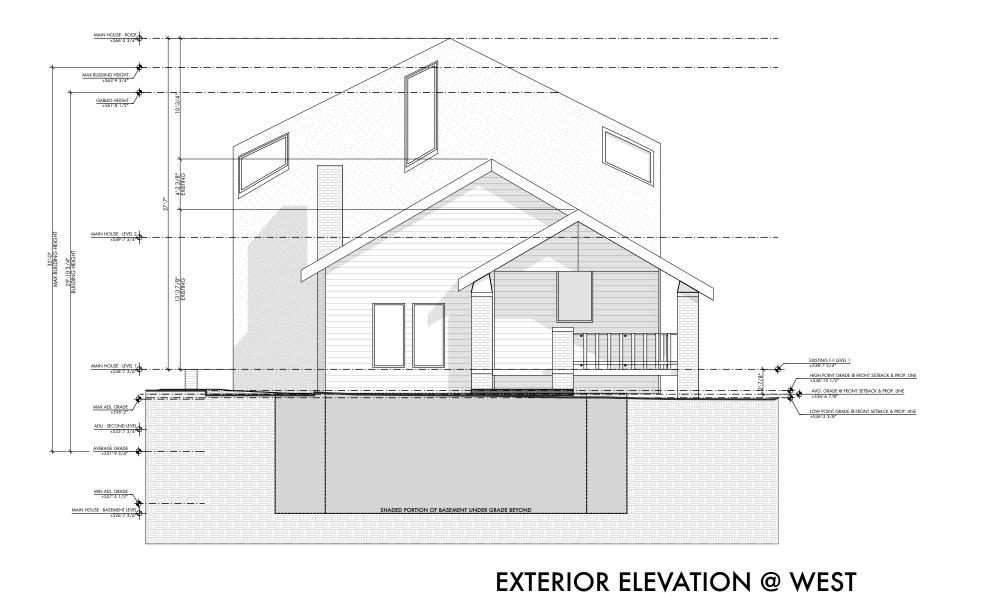
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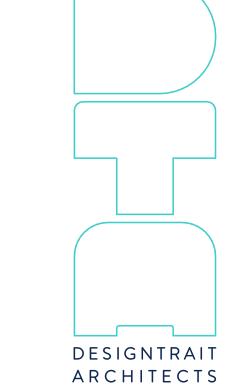






BASEMEN	T EXEMPTION LEGEND
	WALL AREA BELOW GRADE
	PERIMETER OF BASEMENT WALL

WALL AREA CALCULATIONS				
	TOTAL WALL AREA	WALL AREA BELOW GRADE	% BELOW GRADE	
TOTAL	1,566 SF	869 SF	55.49 %	
NORTH	490 SF	296 SF	60.4%	
SOUTH	490 SF	272 SF	55.5%	
EAST	293 SF	13 SF	4.4%	
WEST	293 SF	288 SF	98.3%	

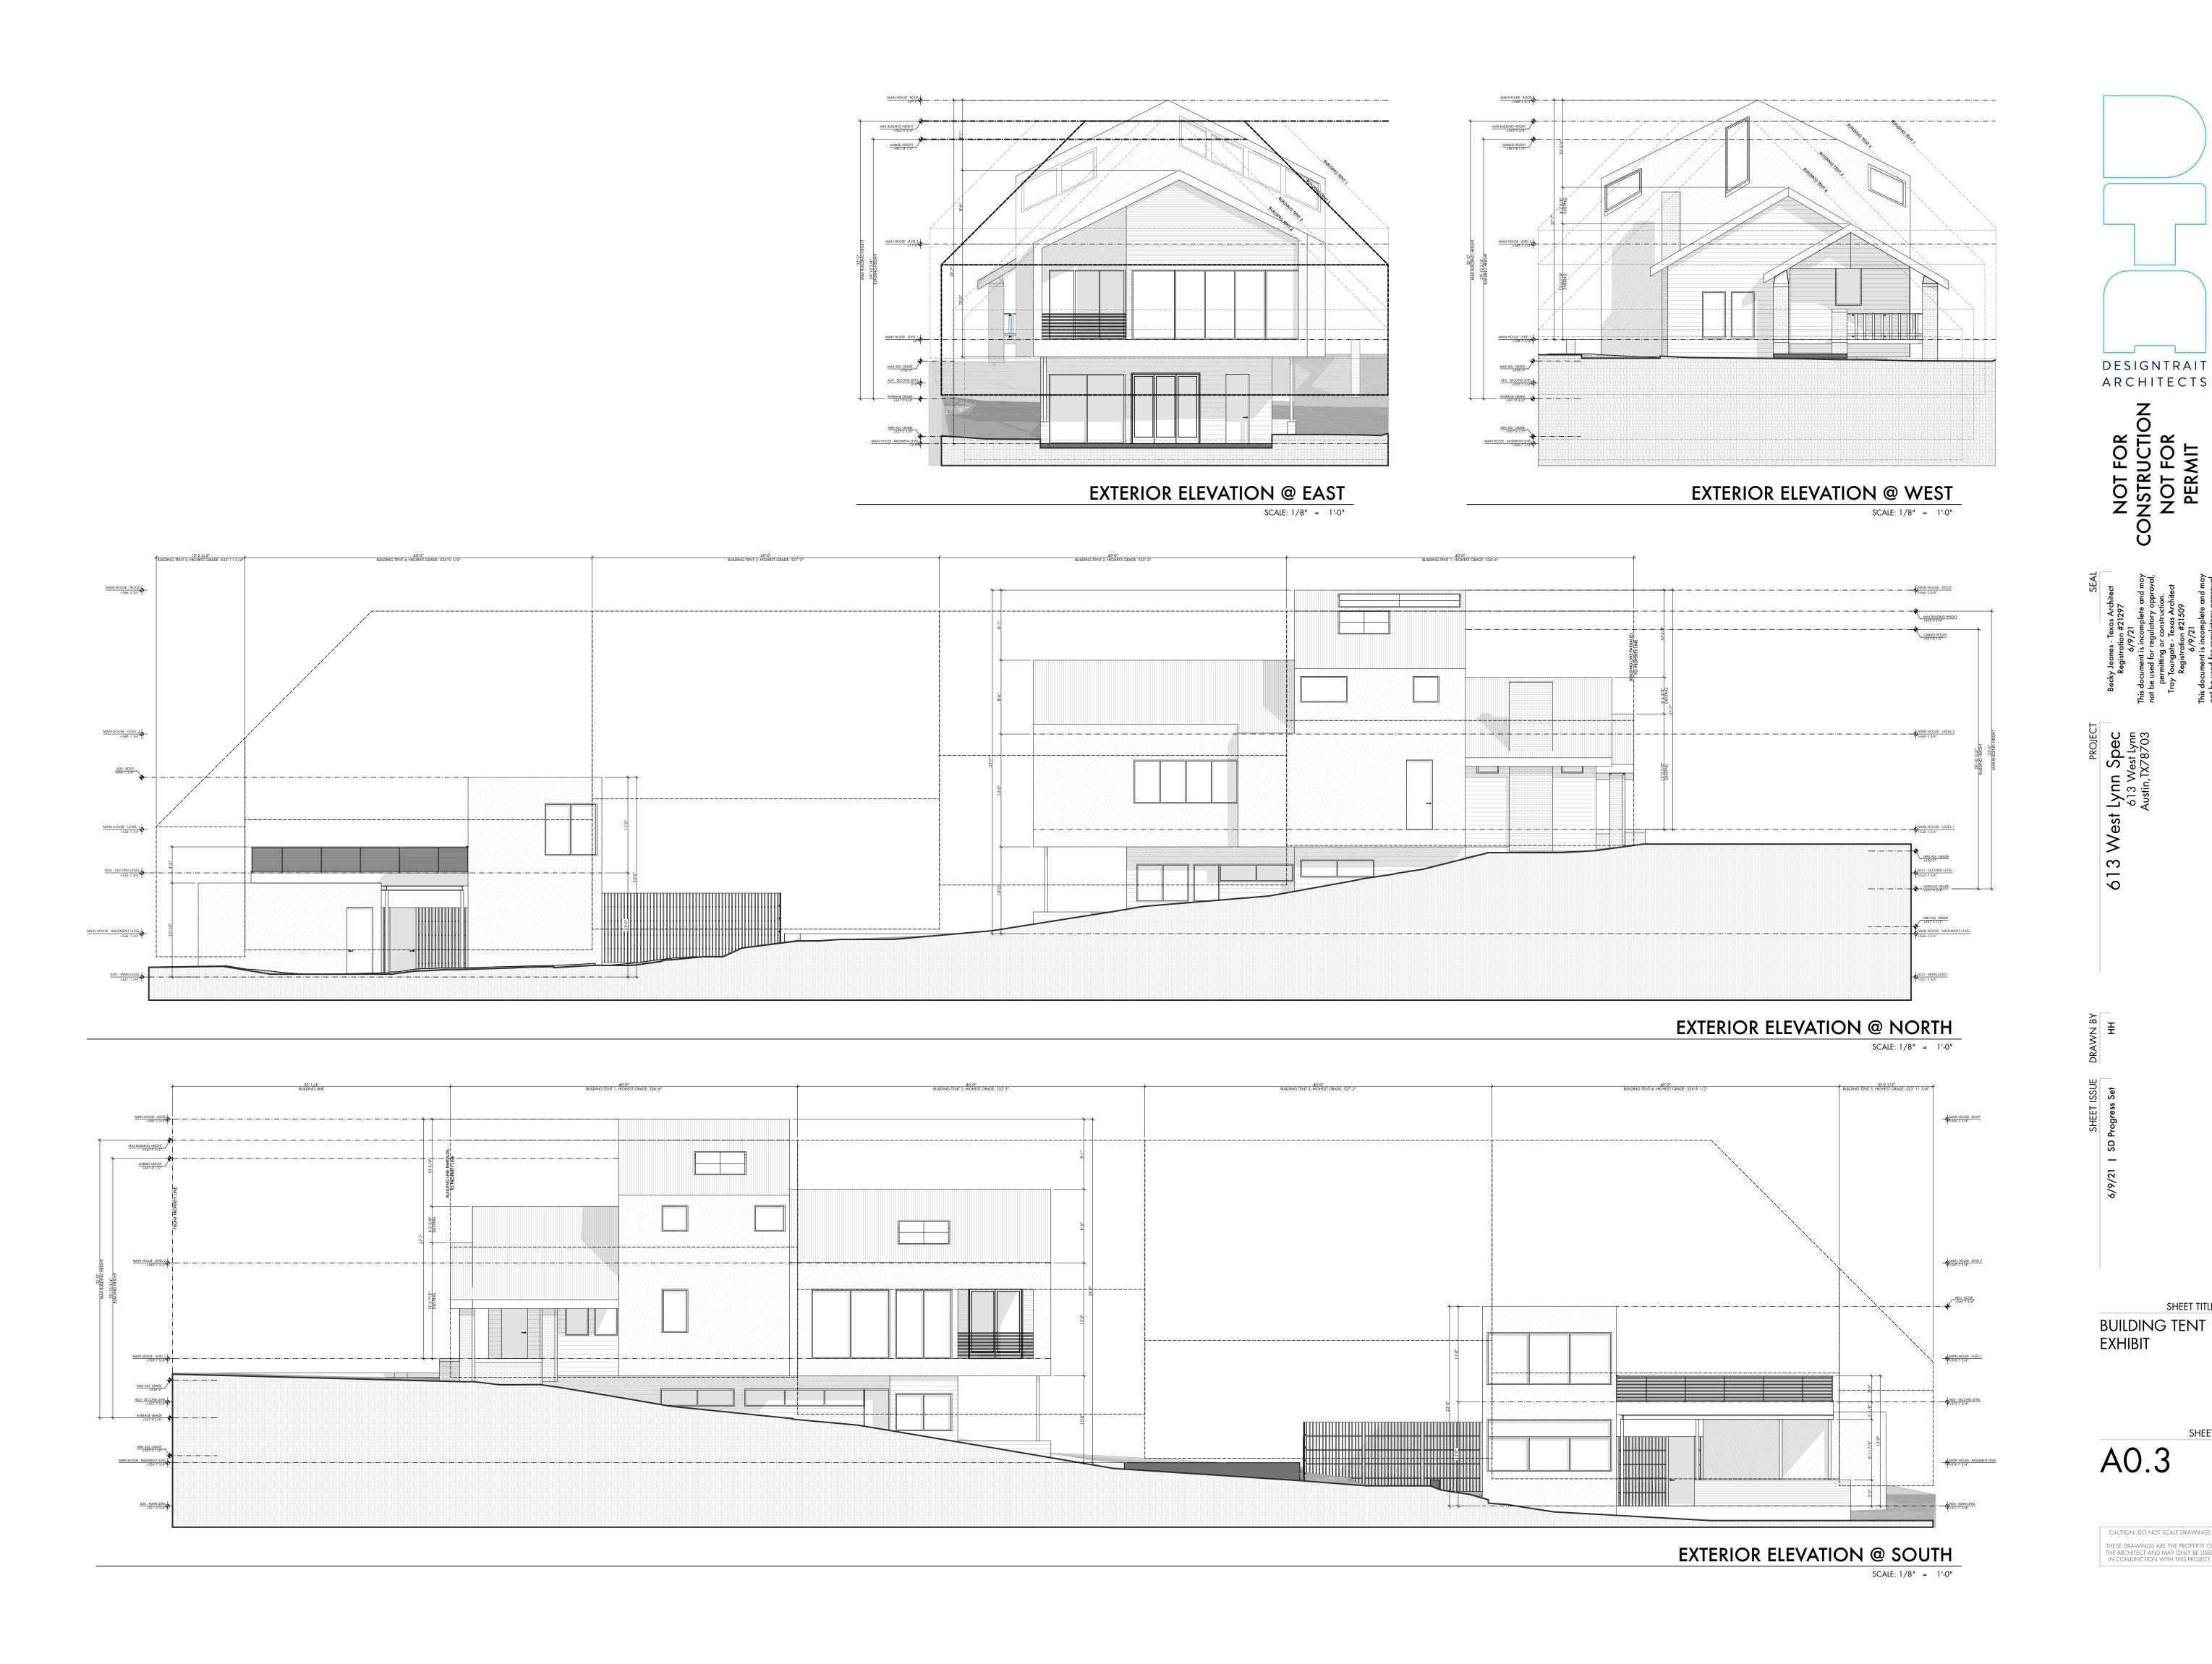

NOT FOR CONSTRUCTION NOT FOR PERMIT

Becky Jeanes - Texas Architect
Registration #21297

6/9/21

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Tray Toungate - Texas Architect Registration #21509

6/9/21

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613 West Lynn Spec 613 West Lynn Austin, TX78703


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BASEMENT EXEMPTION EXHIBIT


A0 4


CAUTION: DO NOT SCALE DRAWINGS


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IN CONJUNCTION WITH THIS PROJECT.

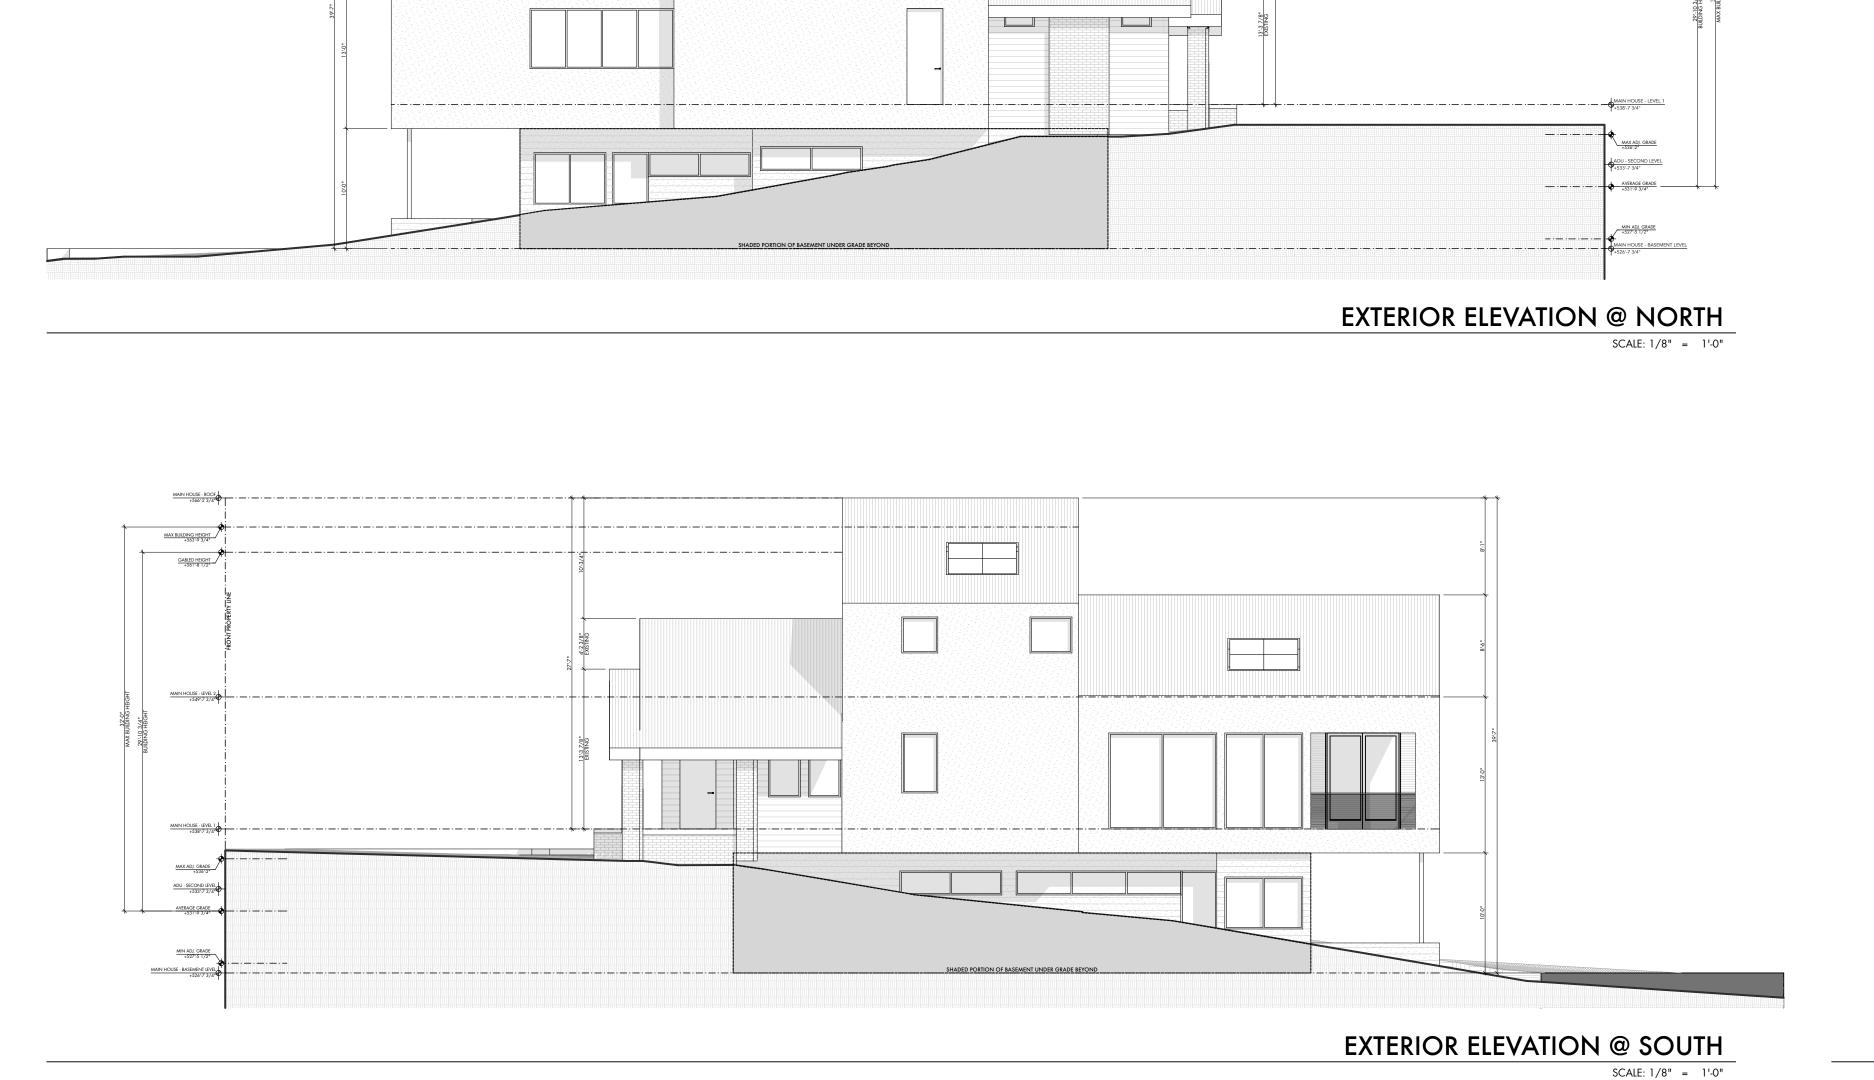

LOCAL STATE OF THE STATE OF THE

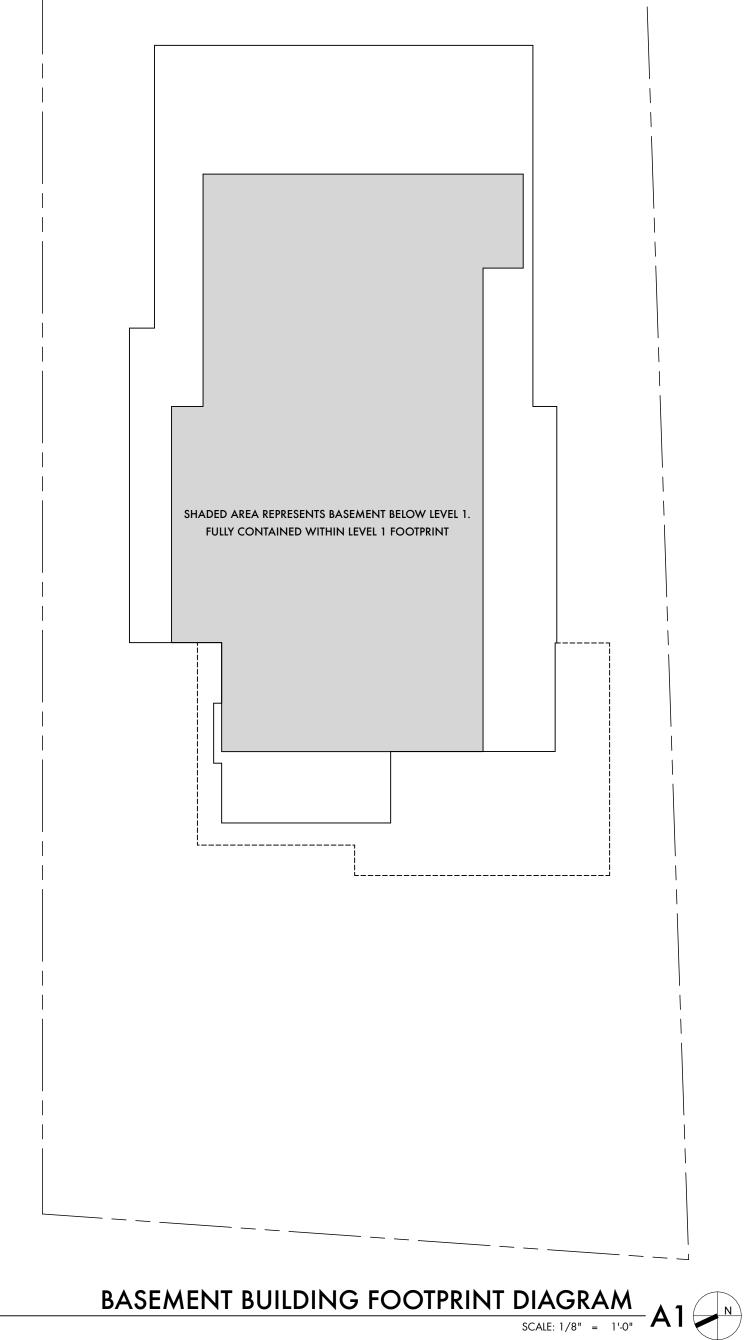

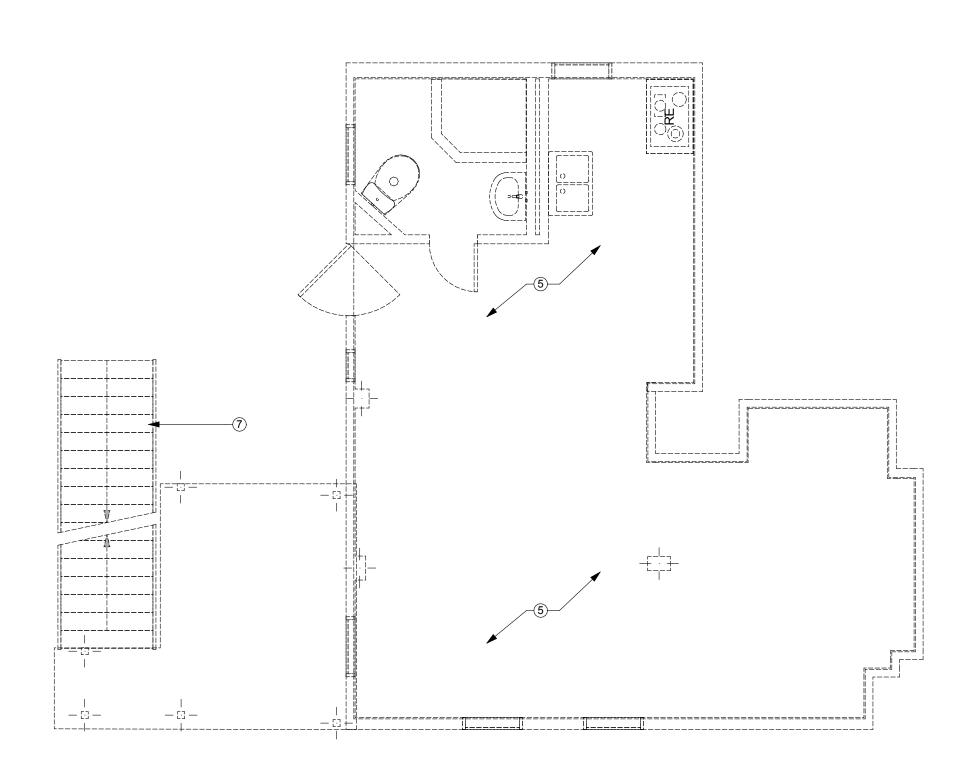

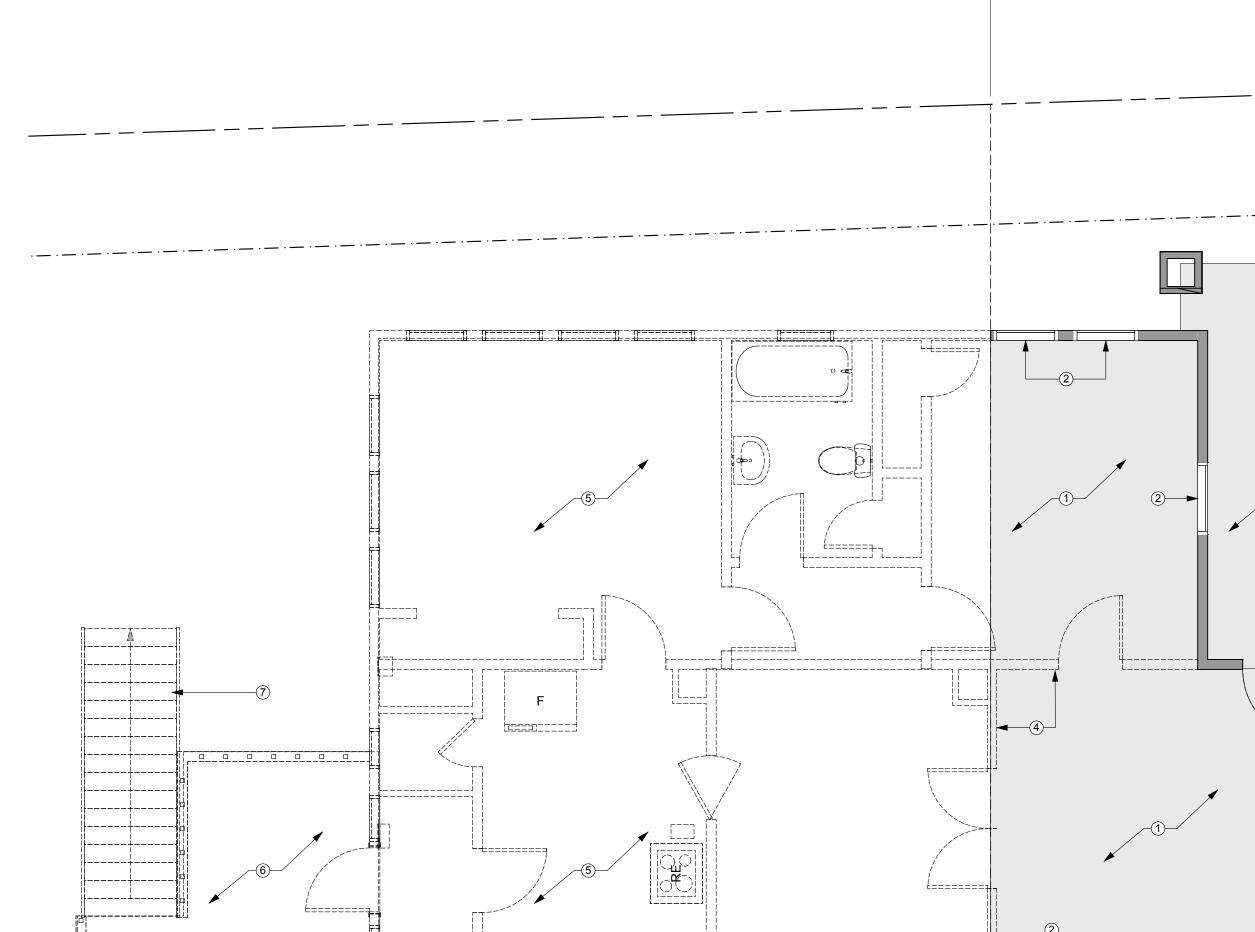

KEYNOTES - DEMO PLAN

Shaded area shown as extents of first 15'-0" of the structure to remain. Patch and reparir all exterior walls, roofs and slab to remain within area, U.N.O. Do not scale the drawings. If a specific dimension is not given, contract Designtrait for clarification.
Dimensions are to face of frame or centerline of frame as noted.
Keynotes located on this sheet are for this sheet only. 2 Existing glazing to remain. Repair/replace as needed. Contractor shall exercise reasonable precaution in the protection of all existing finishes to remain and/or all existing substrates to receive new finish; Contractor shall: provide protective coverings and impact protection for all floor, partition, ceiling, window, glass, and all other existing finishes in the project area and for all finishes which may be subject to traffic or construction activity in 3 Existing front porch to remain. 4 Interior partitions to be demo'd. rine project area and for all finishes which may be subject to traffic or construction activity in adjacent areas; extend protection from building entry(ies) to project area(s).

Patch and repair all finishes and materials that occur from the removal or demolition procedure.

The Contractor shall remove from demolished walls or portions of walls all power circuits and switch legs back to first junction box. Remove any millwork or wall-mounted fixtures from walls indicated to be demolished and not otherwise shown. Any building fixtures from the Project and not dispersed of shall be salarated by the Course Prospersed to the Contractor shall take Demo all exterior & interior walls, slabs, roof, plumbing fixtures & appliances outside of first 15'-0" of existing structure. 6 Demo existing wood rear patio. 7 Demo existing wood patio stairs. disposed of shall be salvaged as directed by the Owner Representative. The Contractor shall take care not to unreasonable cause damage to the building fixtures.

Contractor to remove at least one side of gyp at all existing walls for the installation new sound batt Contractor to remove at least one side of gyp at all existing walls for the installation new sound part insulation.
Contractor to remove ALL wall panelling from project. Replace with 5/8" Gyp Bd.
Existing walls might carry or transfer roof and/or ceiling loads. Consult with a qualified structural engineer to verify load bearing status for all existing walls prior to any demolition work. Provide transfer beams or alternate structure if necessary. Provide temporary shoring where required.
Contractor shall walk project site with Architect and Owner to review extent of demolition and identify any additional components that need to be removed in order to provide proposed new construction or that the Owner wishes to be removed as part of the scope of project. WALL LEGEND EXISTING WALL TO REMAIN

DEMO EXISTING WALL

DEMO PLAN - MAIN HOUSE - LEVEL 1


SCALE: 1/4" = 1'.0"

15'-0" HISTORIC PRESERVATION REQUIRED

GENERAL NOTES | DEMO PLAN

DEMO PLAN

DESIGNTRAIT ARCHITECTS

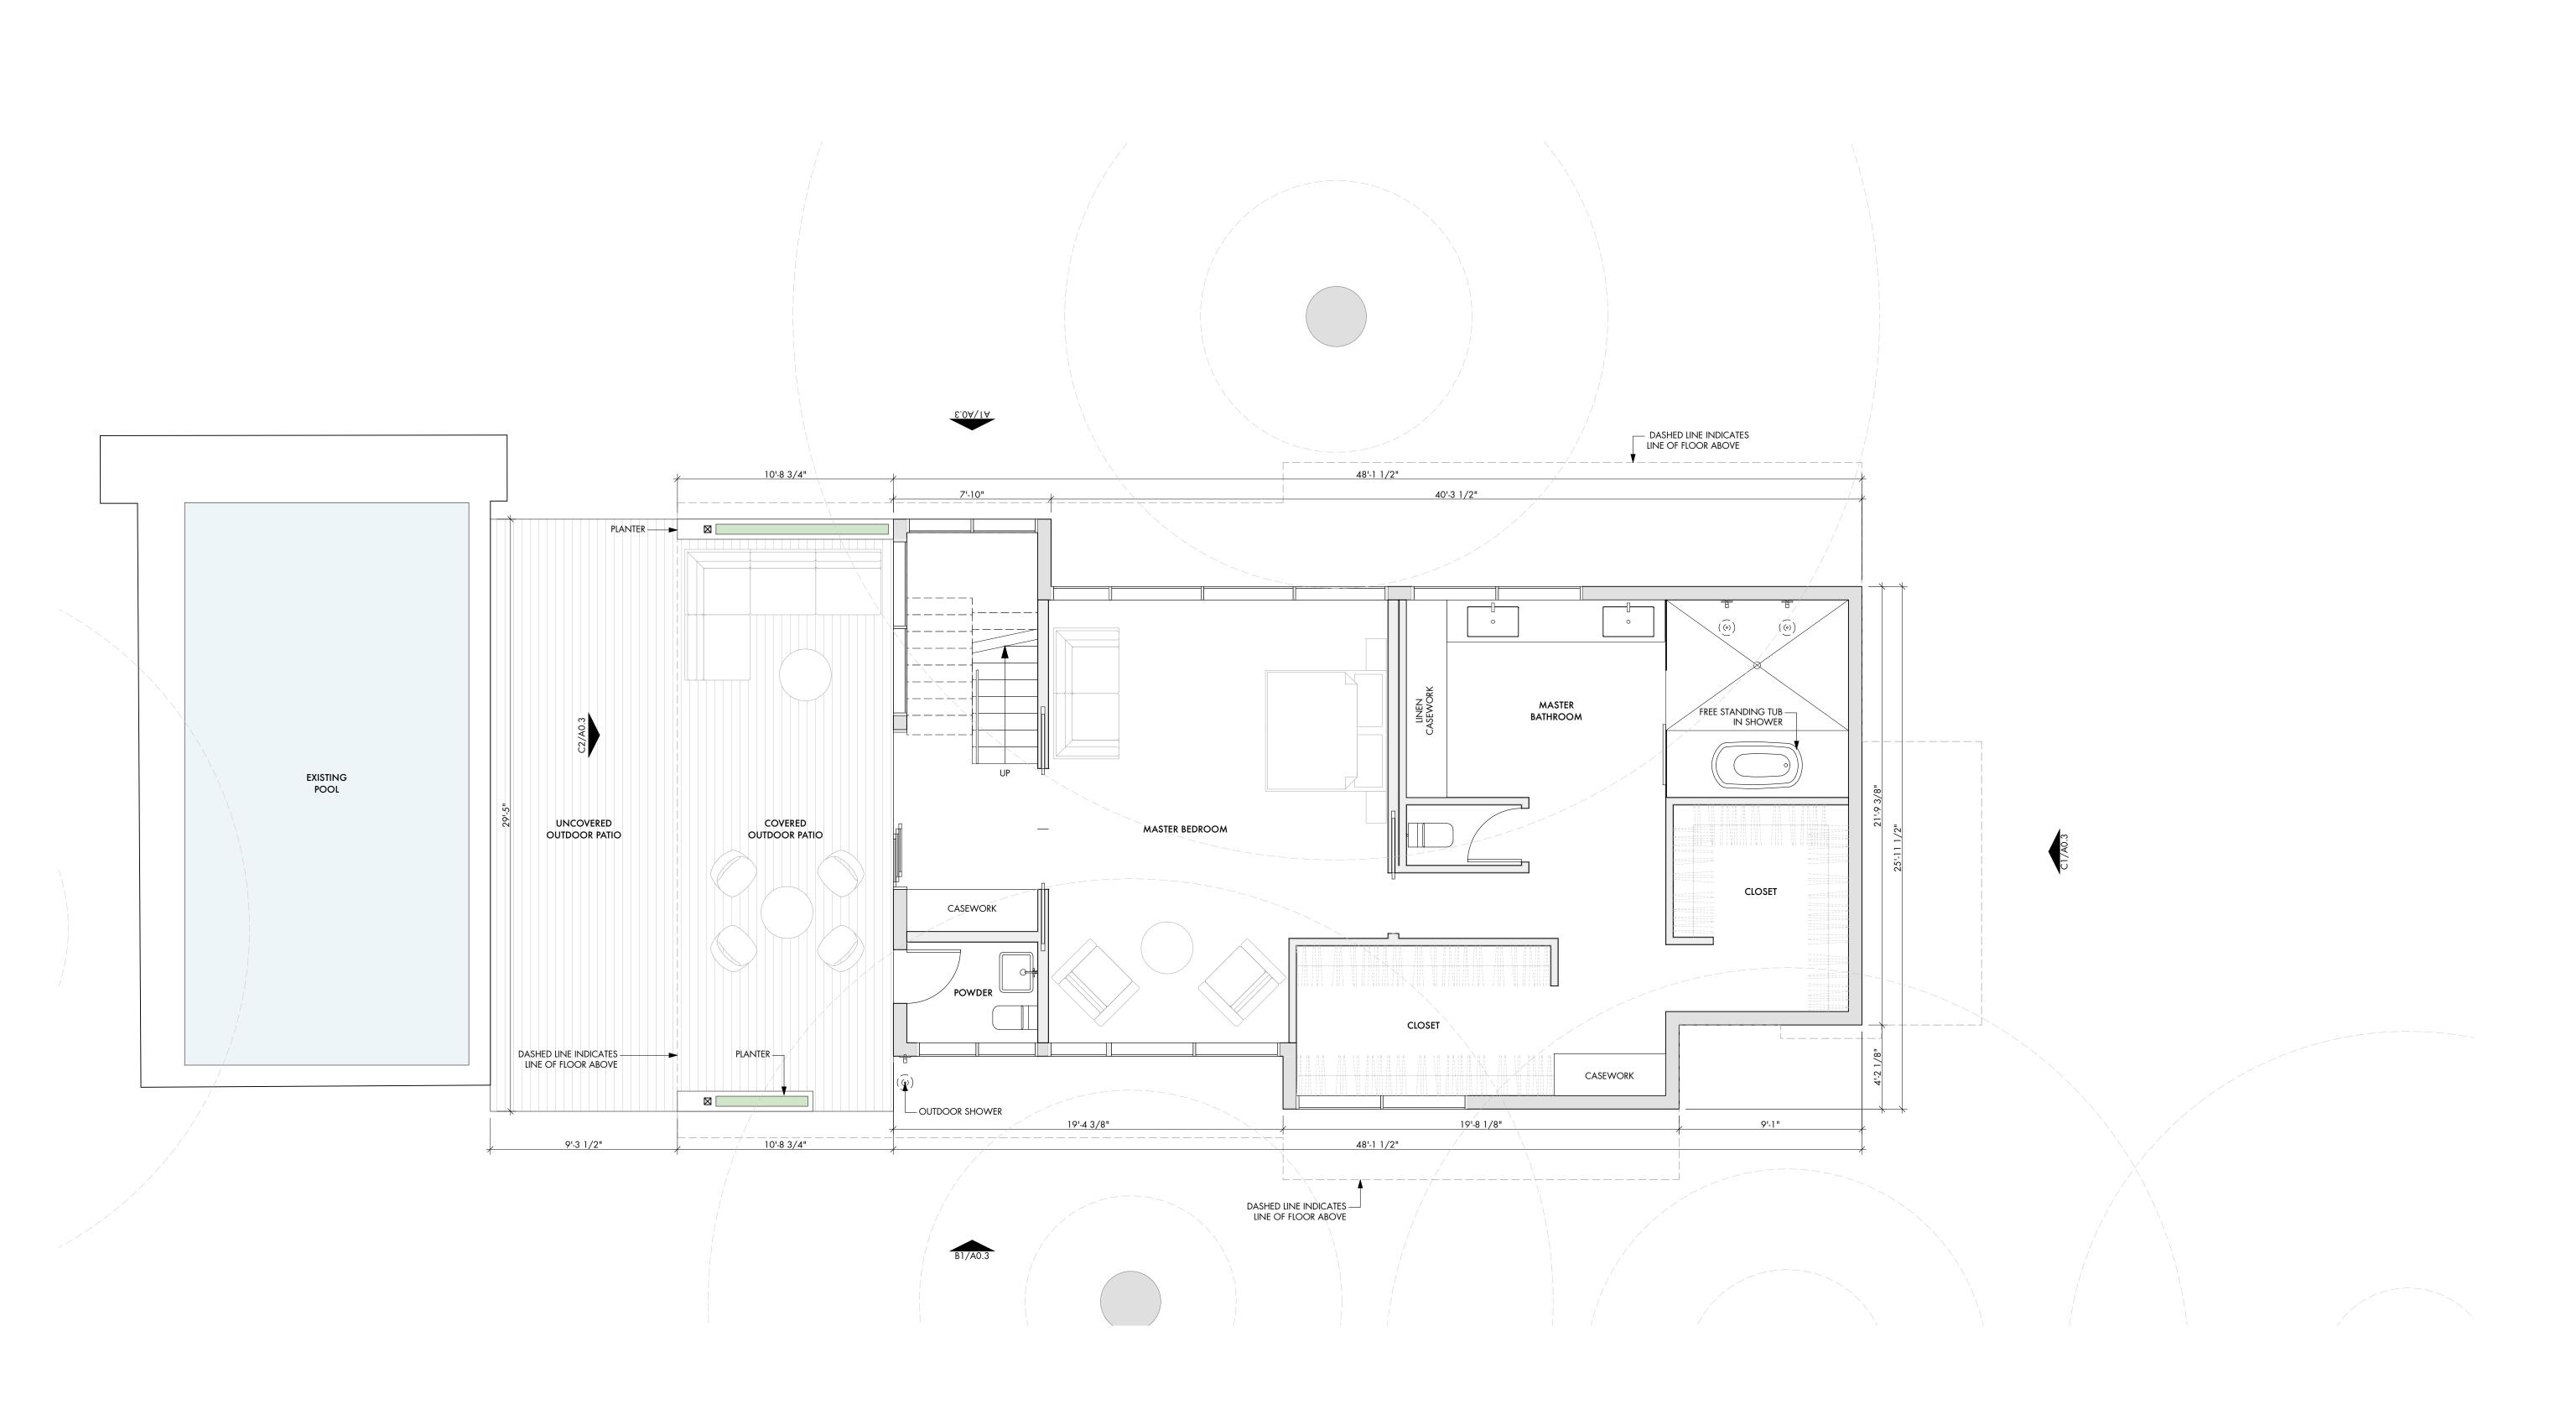

GENERAL NOTES | FLOOR PLAN


- Do not scale the drawings. If a specific dimension is not given, contract Designtrait for clarification.
 Dimensions are to face of frame or centerline of frame as noted.
 Keynotes located on this sheet are for this sheet only.
- Provide tempered glazing as required by local codes.
 Provide submittals and shop drawings showing number of windows, locations of tempered glazing,
- Window and door types indicate rough sizes only. GC shall field verify the appropriate glazing and leaf sizes in the field prior to ordering. For any questions, contact Designtrait for clarification.
 Patch and repair all finishes and materials that occur from the removal or demolition procedure.
 Contractor to remove at least one side of gyp at all existing walls for the installation new sound batt
- 10. Contractor to remove at least one state of gyp at all schooling transfer to remove at least one state of gyp at all schooling transfer to the structural engineer to verify load bearing status for all existing walls prior to any demolition work. Provide transfer beams or alternate structure if necessary. Provide temporary shoring where required.
 10. Contractor shall walk project site with Architect and Owner to review extent of demolition and identify any additional components that need to be removed in order to provide proposed new construction or that the Owner wishes to be removed as part of the scope of project.


FLOOR PLAN - BASEMENT LEVEL

SCALE: 1/4" = 1'-0"

DESIGNTRAIT ARCHITECTS

SHEET TITLE MAIN HOUSE -FLOOR PLAN BASEMENT LEVEL

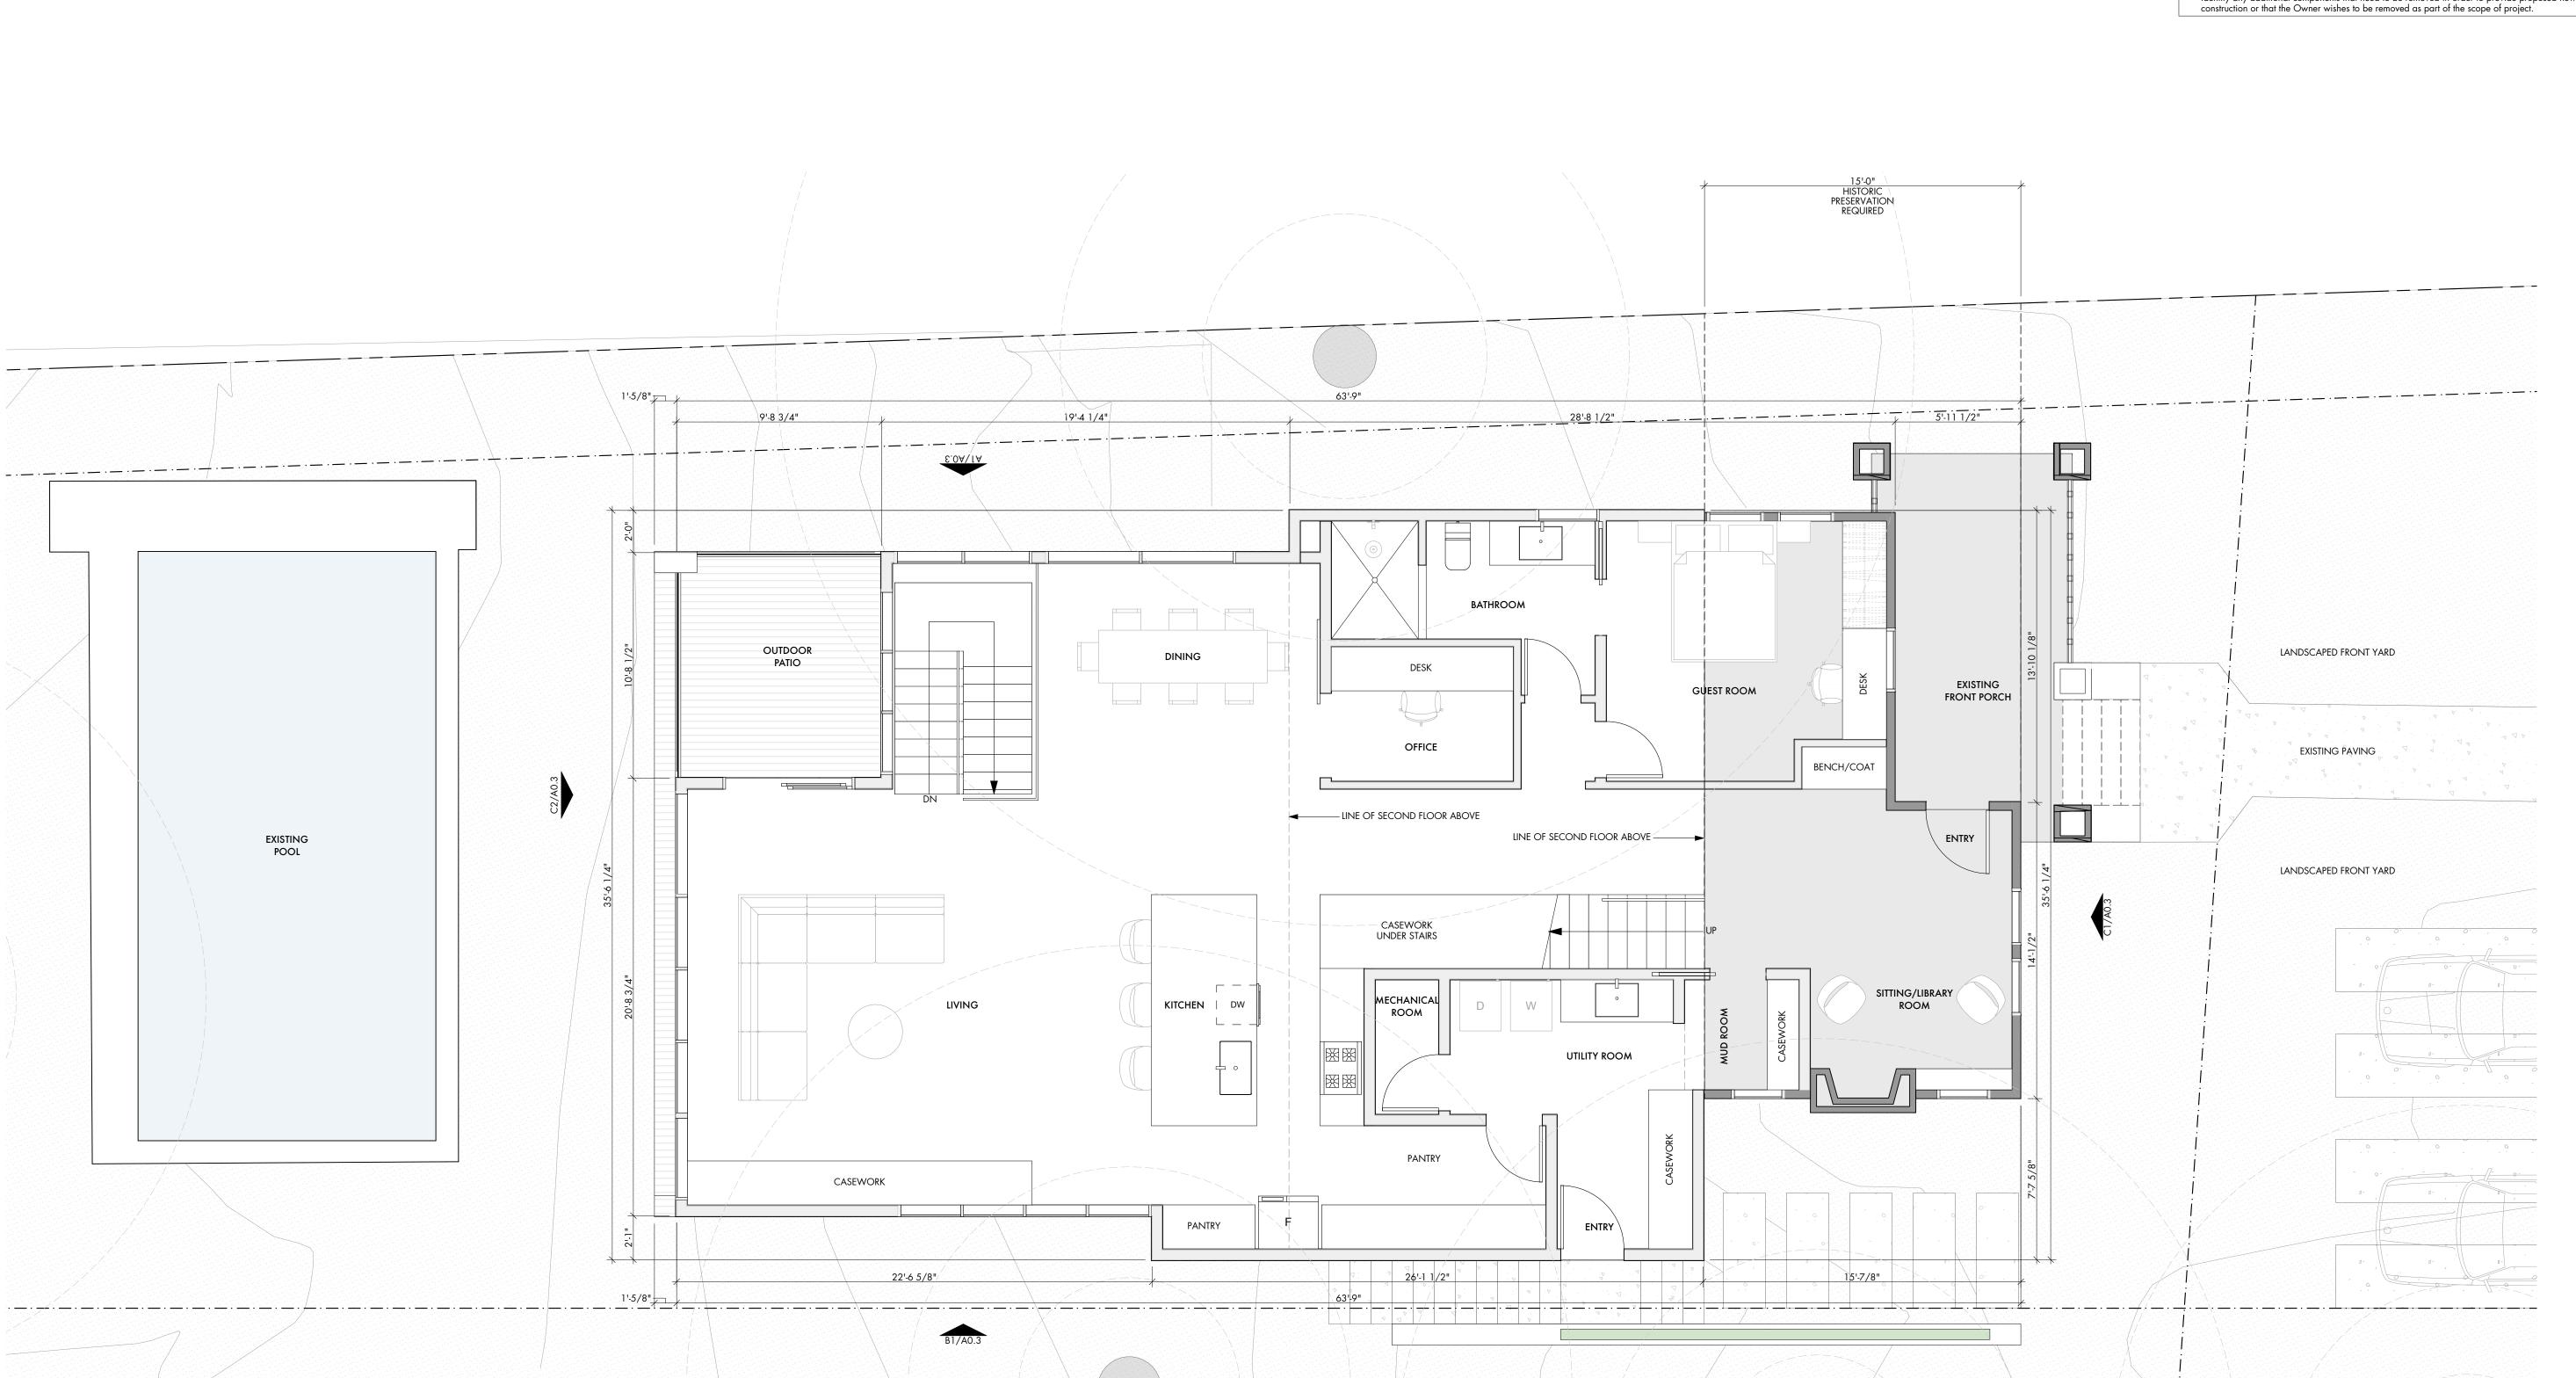

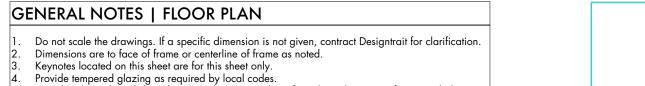

Provide tempered glazing as required by local codes.
Provide submittals and shop drawings showing number of windows, locations of tempered glazing,

Window and door types indicate rough sizes only. GC shall field verify the appropriate glazing and leaf sizes in the field prior to ordering. For any questions, contact Designtrait for clarification.
Patch and repair all finishes and materials that occur from the removal or demolition procedure.
Contractor to remove at least one side of gyp at all existing walls for the installation new sound batt

insulation.
Existing walls might carry or transfer roof and/or ceiling loads. Consult with a qualified structural engineer to verify load bearing status for all existing walls prior to any demolition work. Provide transfer beams or alternate structure if necessary. Provide temporary shoring where required.
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FLOOR PLAN - LEVEL 1

SCALE: 1/4" = 1'.0"

DESIGNTRAIT ARCHITECTS

SHEET TITLE MAIN HOUSE -FLOOR PLAN LEVEL 1



GENERAL NOTES | FLOOR PLAN

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- Provide tempered glazing as required by local codes.
 Provide submittals and shop drawings showing number of windows, locations of tempered glazing, finishes, etc.
- 6. Window and door types indicate rough sizes only. GC shall field verify the appropriate glazing and leaf sizes in the field prior to ordering. For any questions, contact Designtrait for clarification.
 7. Patch and repair all finishes and materials that occur from the removal or demolition procedure.
 8. Contractor to remove at least one side of gyp at all existing walls for the installation new sound batt
- insulation.
 Existing walls might carry or transfer roof and/or ceiling loads. Consult with a qualified structural engineer to verify load bearing status for all existing walls prior to any demolition work. Provide transfer beams or alternate structure if necessary. Provide temporary shoring where required.
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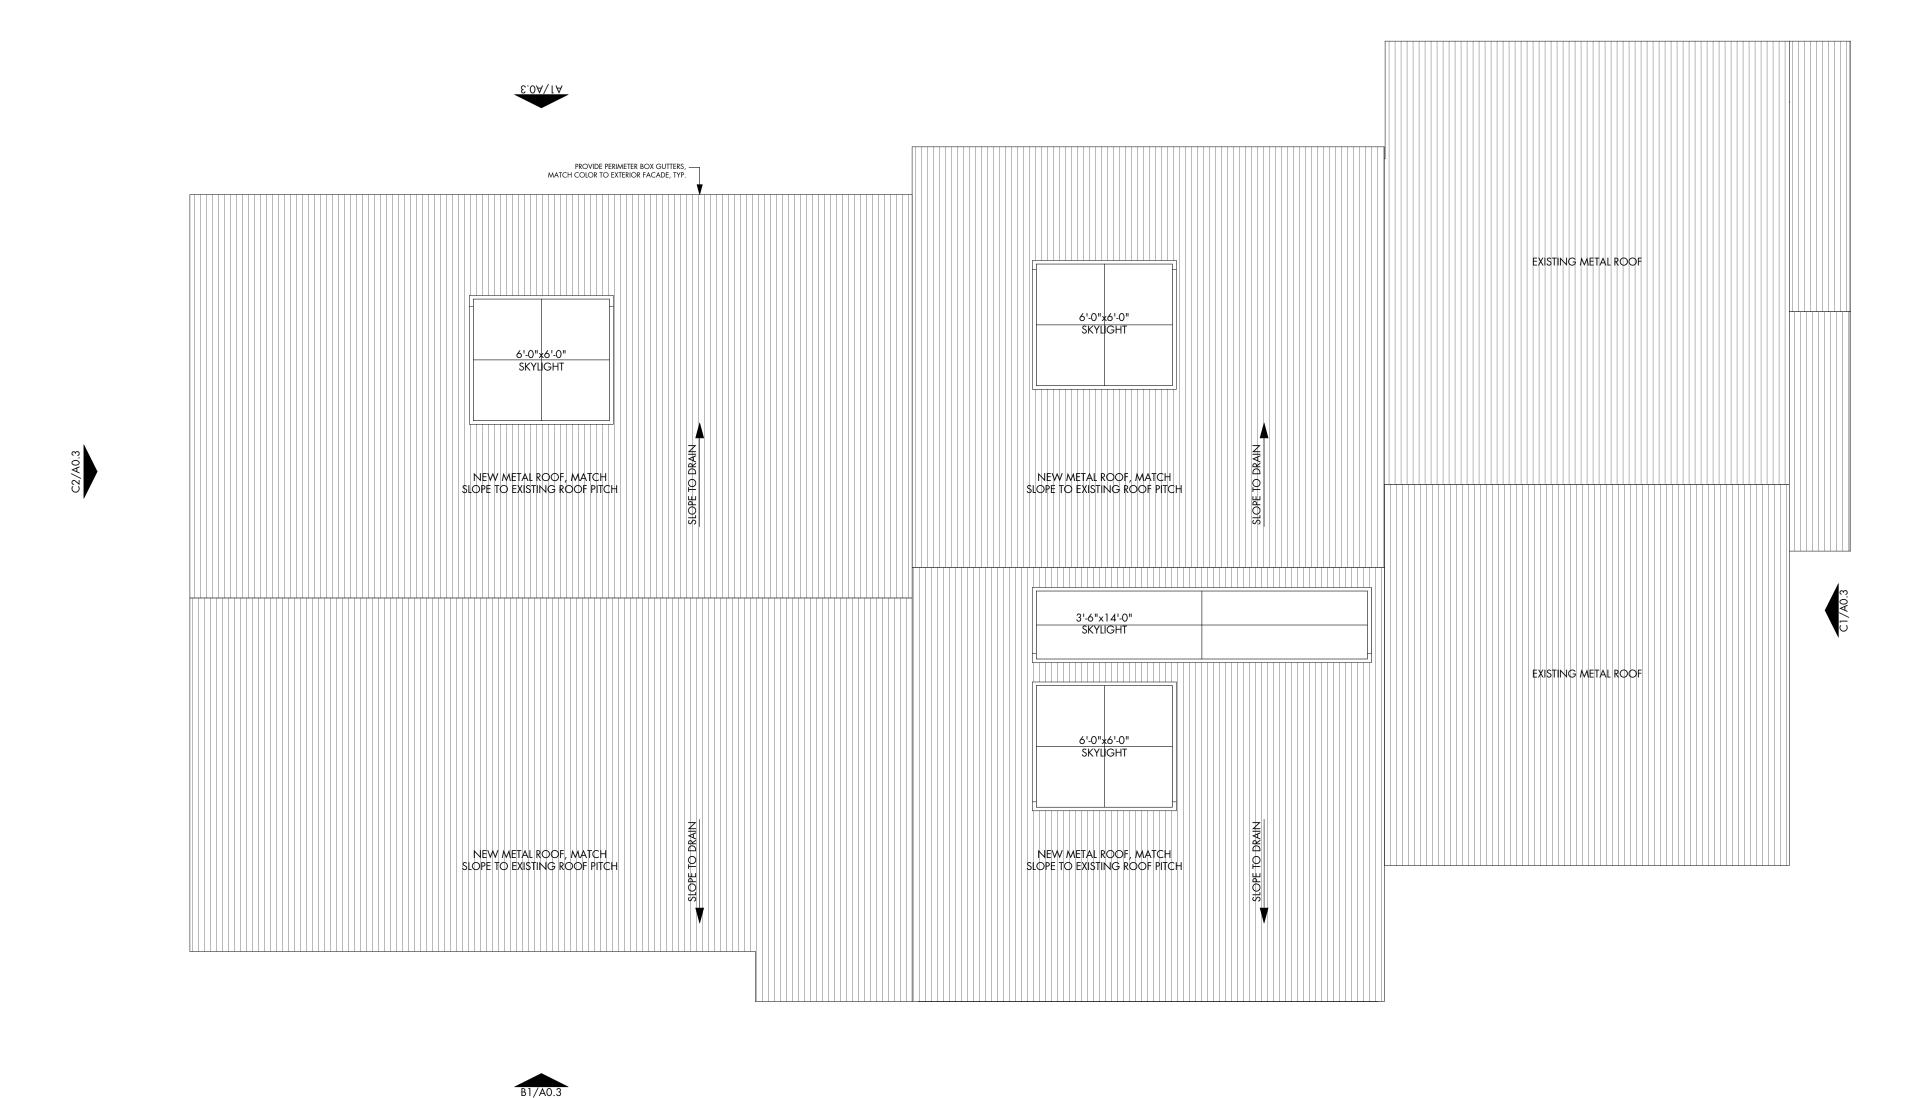
DESIGNTRAIT ARCHITECTS

MAIN HOUSE -FLOOR PLAN LEVEL 2

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FLOOR PLAN - LEVEL 2

SCALE: 1/4" = 1'-0"



GENERAL NOTES | ROOF PLAN

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 Dimensions are to face of frame or centerline of frame as noted.
 Keynotes located on this sheet are for this sheet only.
- Provide tempered glazing as required by local codes.
 Provide submittals and shop drawings showing number of windows, locations of tempered glazing,
- finishes, etc.
- finishes, etc.
 6. Window and door types indicate rough sizes only. GC shall field verify the appropriate glazing and leaf sizes in the field prior to ordering. For any questions, contact Designtrait for clarification.
 7. Patch and repair all finishes and materials that occur from the removal or demolition procedure.
 8. Existing walls might carry or transfer roof and/or ceiling loads. Consult with a qualified structural engineer to verify load bearing status for all existing walls prior to any demolition work. Provide transfer beams or alternate structure if necessary. Provide temporary shoring where required.
 9. Contractor shall walk project site with Architect and Owner to review extent of demolition and identify any additional components that need to be removed in order to provide proposed new construction or that the Owner wishes to be removed as part of the scope of project.


DESIGNTRAIT


ARCHITECTS

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SHEET TITLE MAIN HOUSE -ROOF PLAN





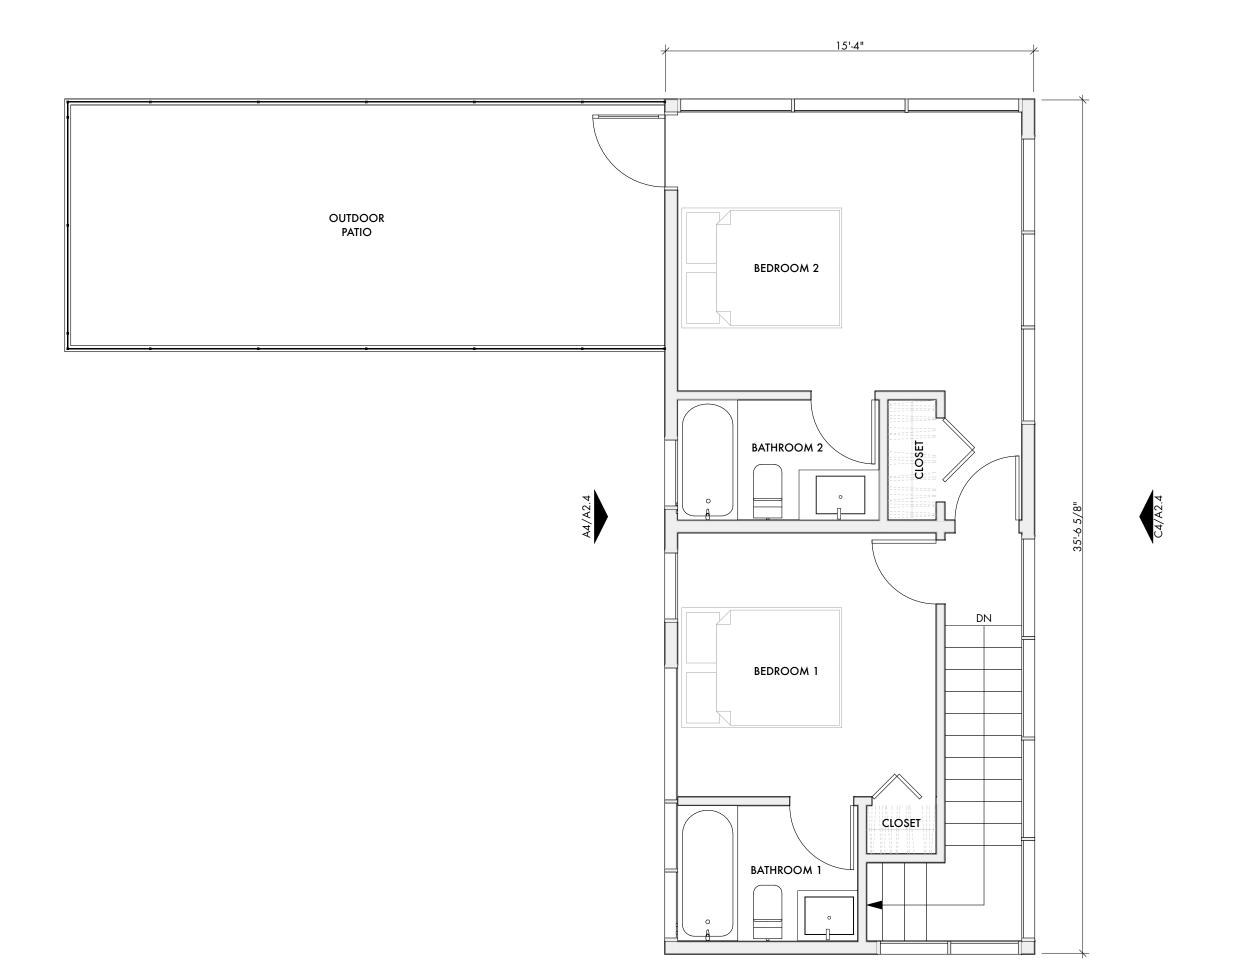

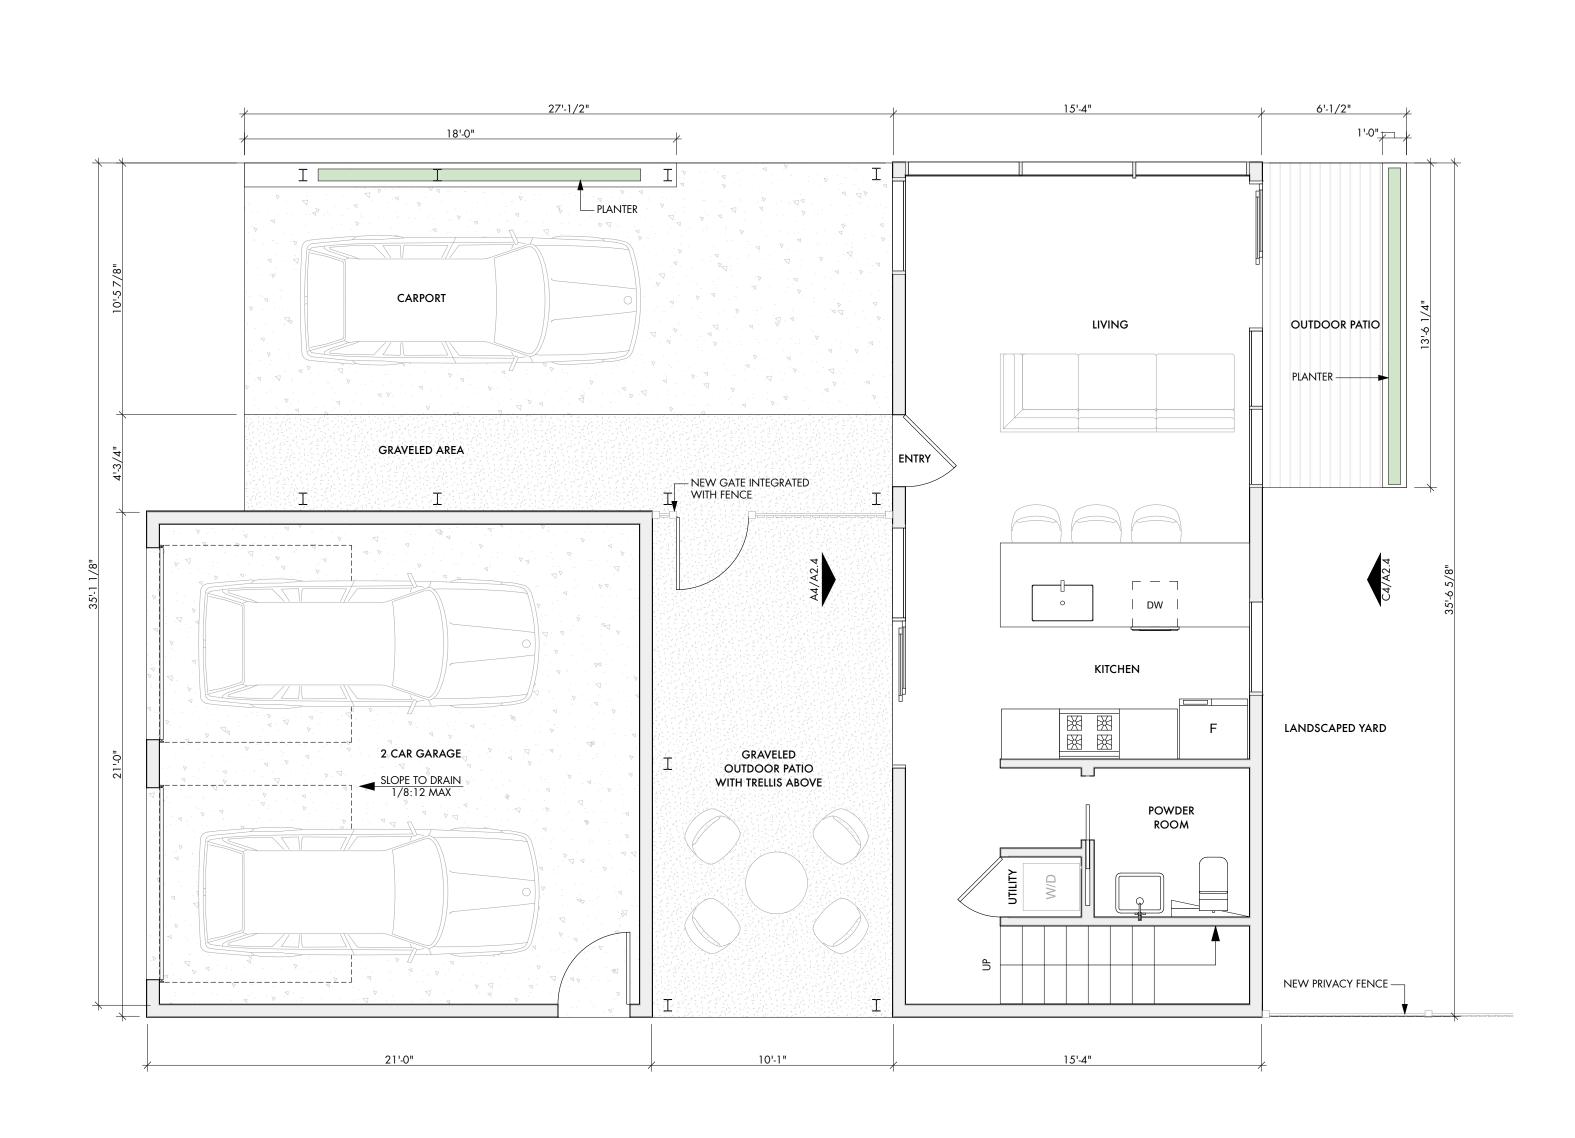GENERAL NOTES | FLOOR PLAN

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Provide tempered glazing as required by local codes.
Provide submittals and shop drawings showing number of windows, locations of tempered glazing,

Window and door types indicate rough sizes only. GC shall field verify the appropriate glazing and leaf sizes in the field prior to ordering. For any questions, contact Designtrait for clarification.
Patch and repair all finishes and materials that occur from the removal or demolition procedure.
Contractor to remove at least one side of gyp at all existing walls for the installation new sound batt

10. Contractor to remove at least one state of gyp at all existing walls for the installation.
11. Existing walls might carry or transfer roof and/or ceiling loads. Consult with a qualified structural engineer to verify load bearing status for all existing walls prior to any demolition work. Provide transfer beams or alternate structure if necessary. Provide temporary shoring where required.
12. Contractor shall walk project site with Architect and Owner to review extent of demolition and identify any additional components that need to be removed in order to provide proposed new construction or that the Owner wishes to be removed as part of the scope of project.


DESIGNTRAIT


ARCHITECTS

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SHEET TITLE ADU - FLOOR PLANS LEVEL 1 &





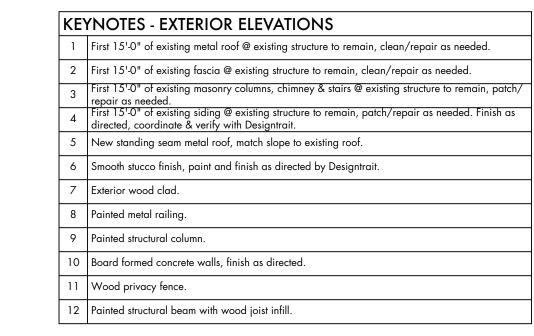

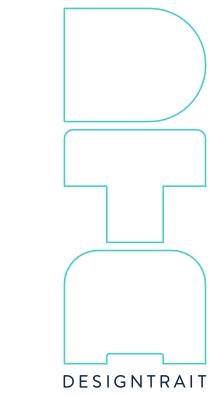ARCHITECTS Z


CONSTRUCTION NOT FOR PERMIT


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Frog Toungate - Texas
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Frog Toungate - Texas


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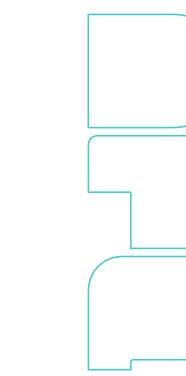
BUILDING ELEVATIONS

A2.1



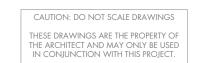

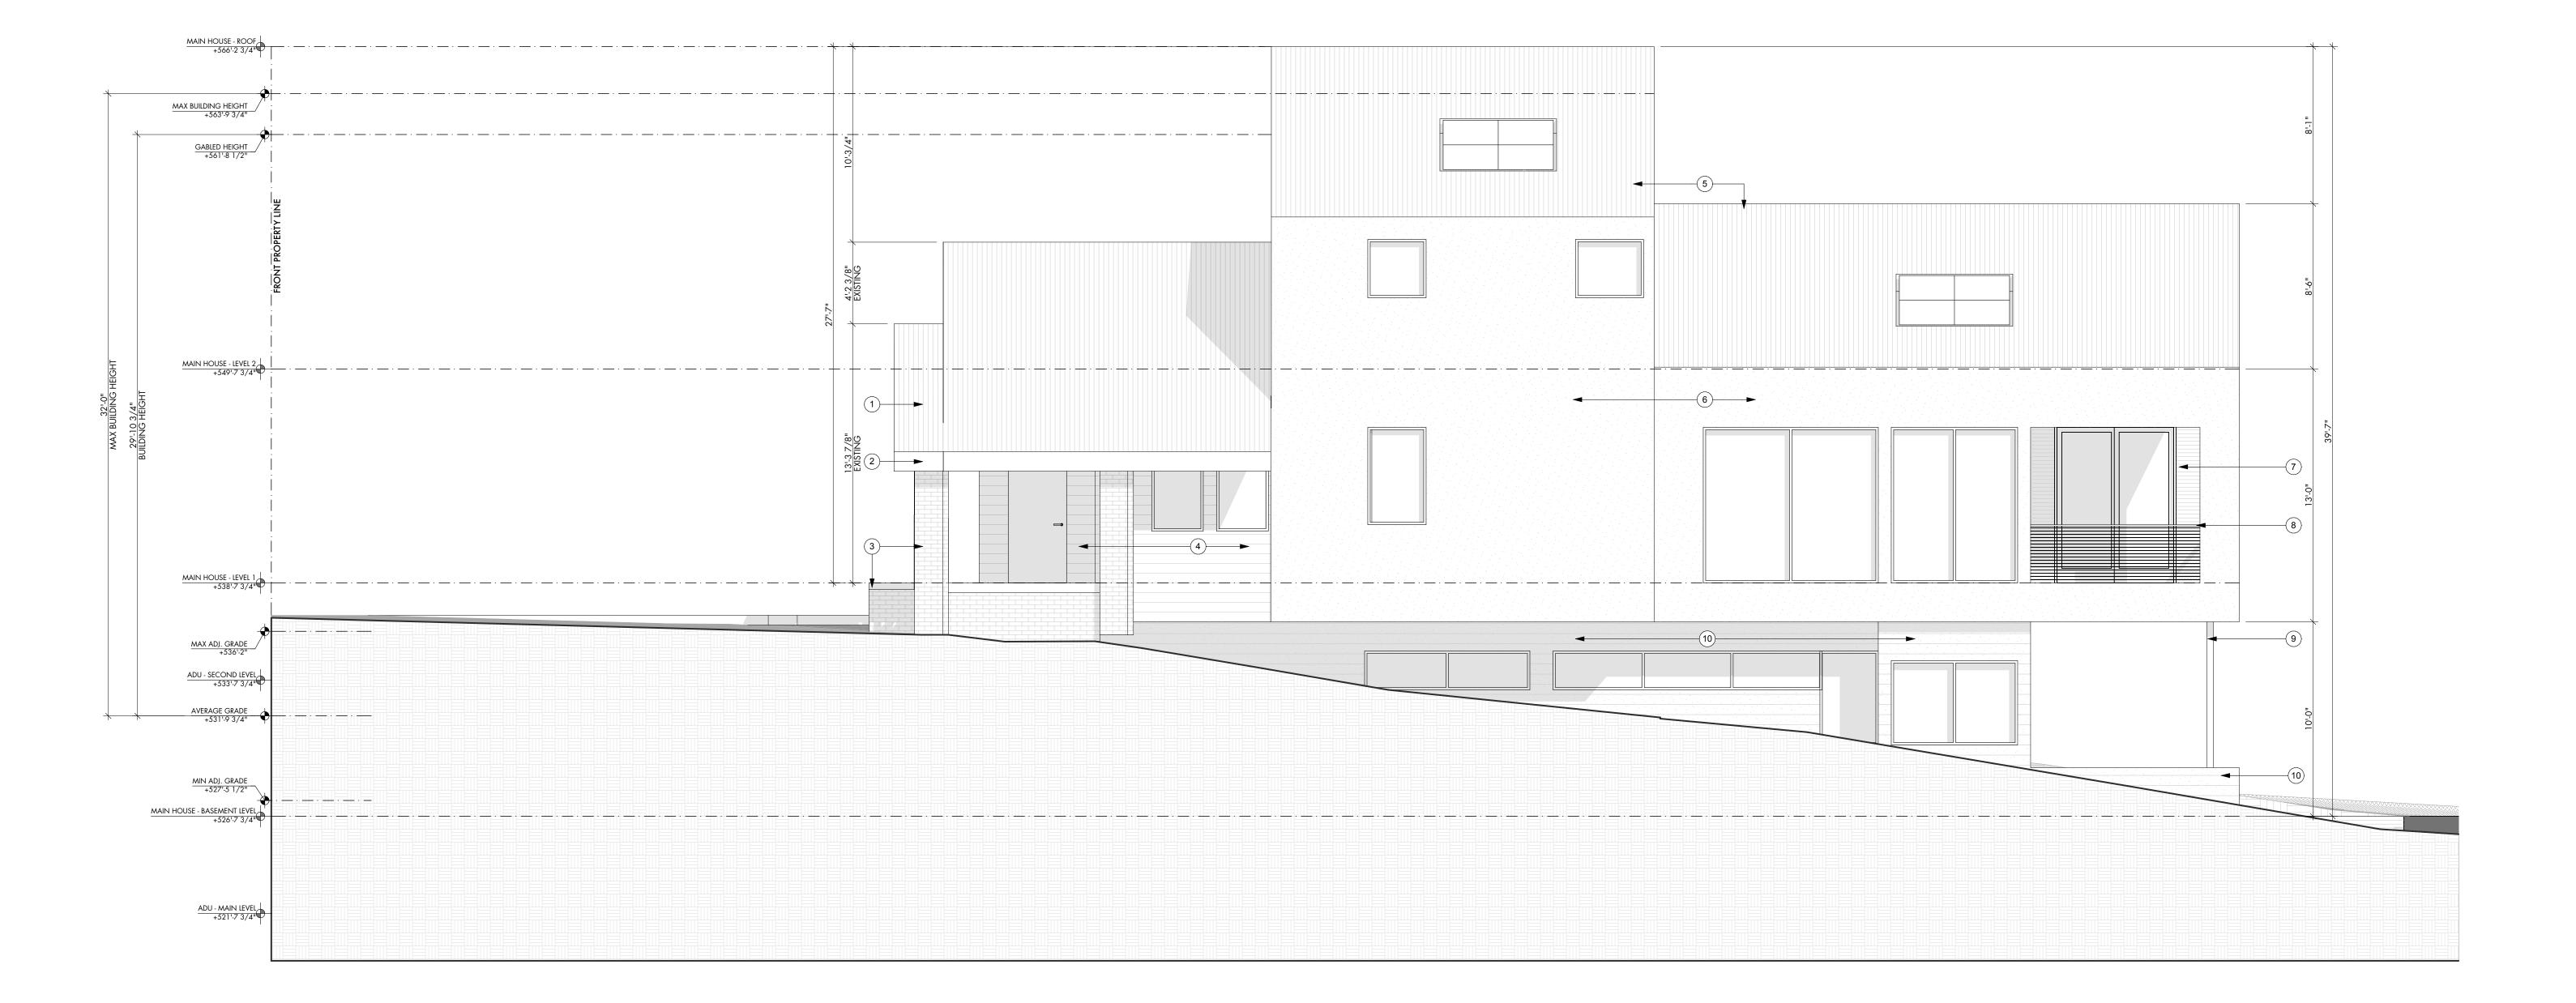


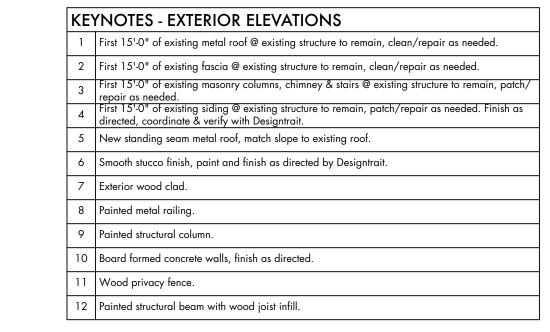



MAIN HOUSE - NORTH EXTERIOR ELEVATION

SCALE: 1/4" = 1'-0" A1

9—

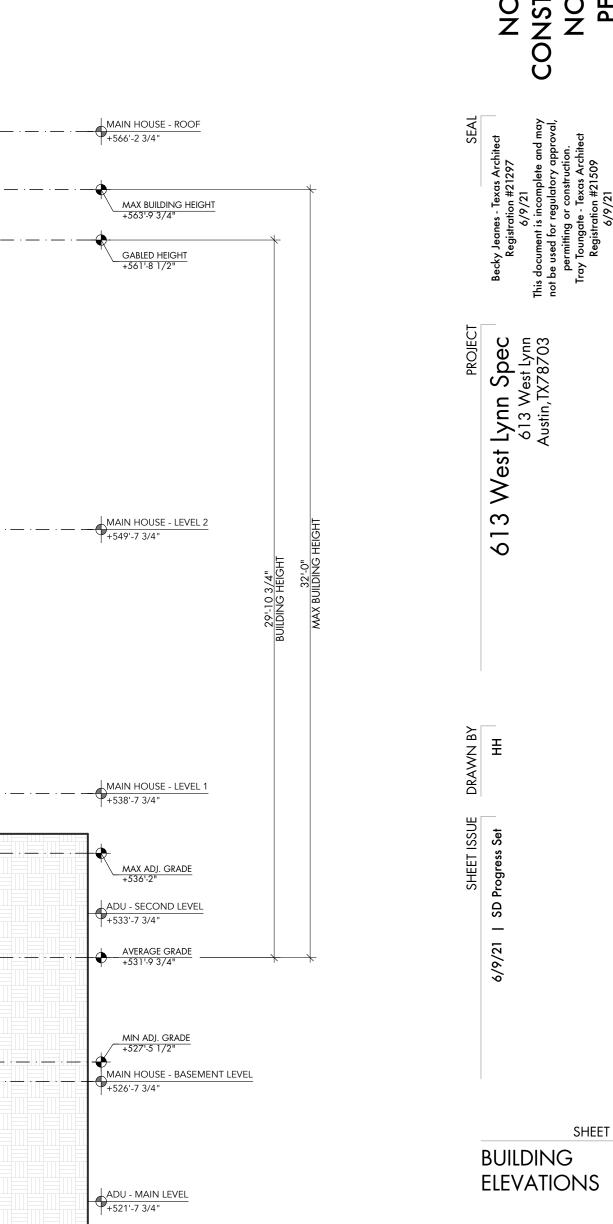

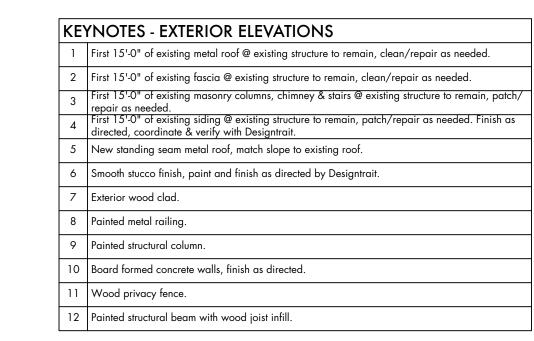


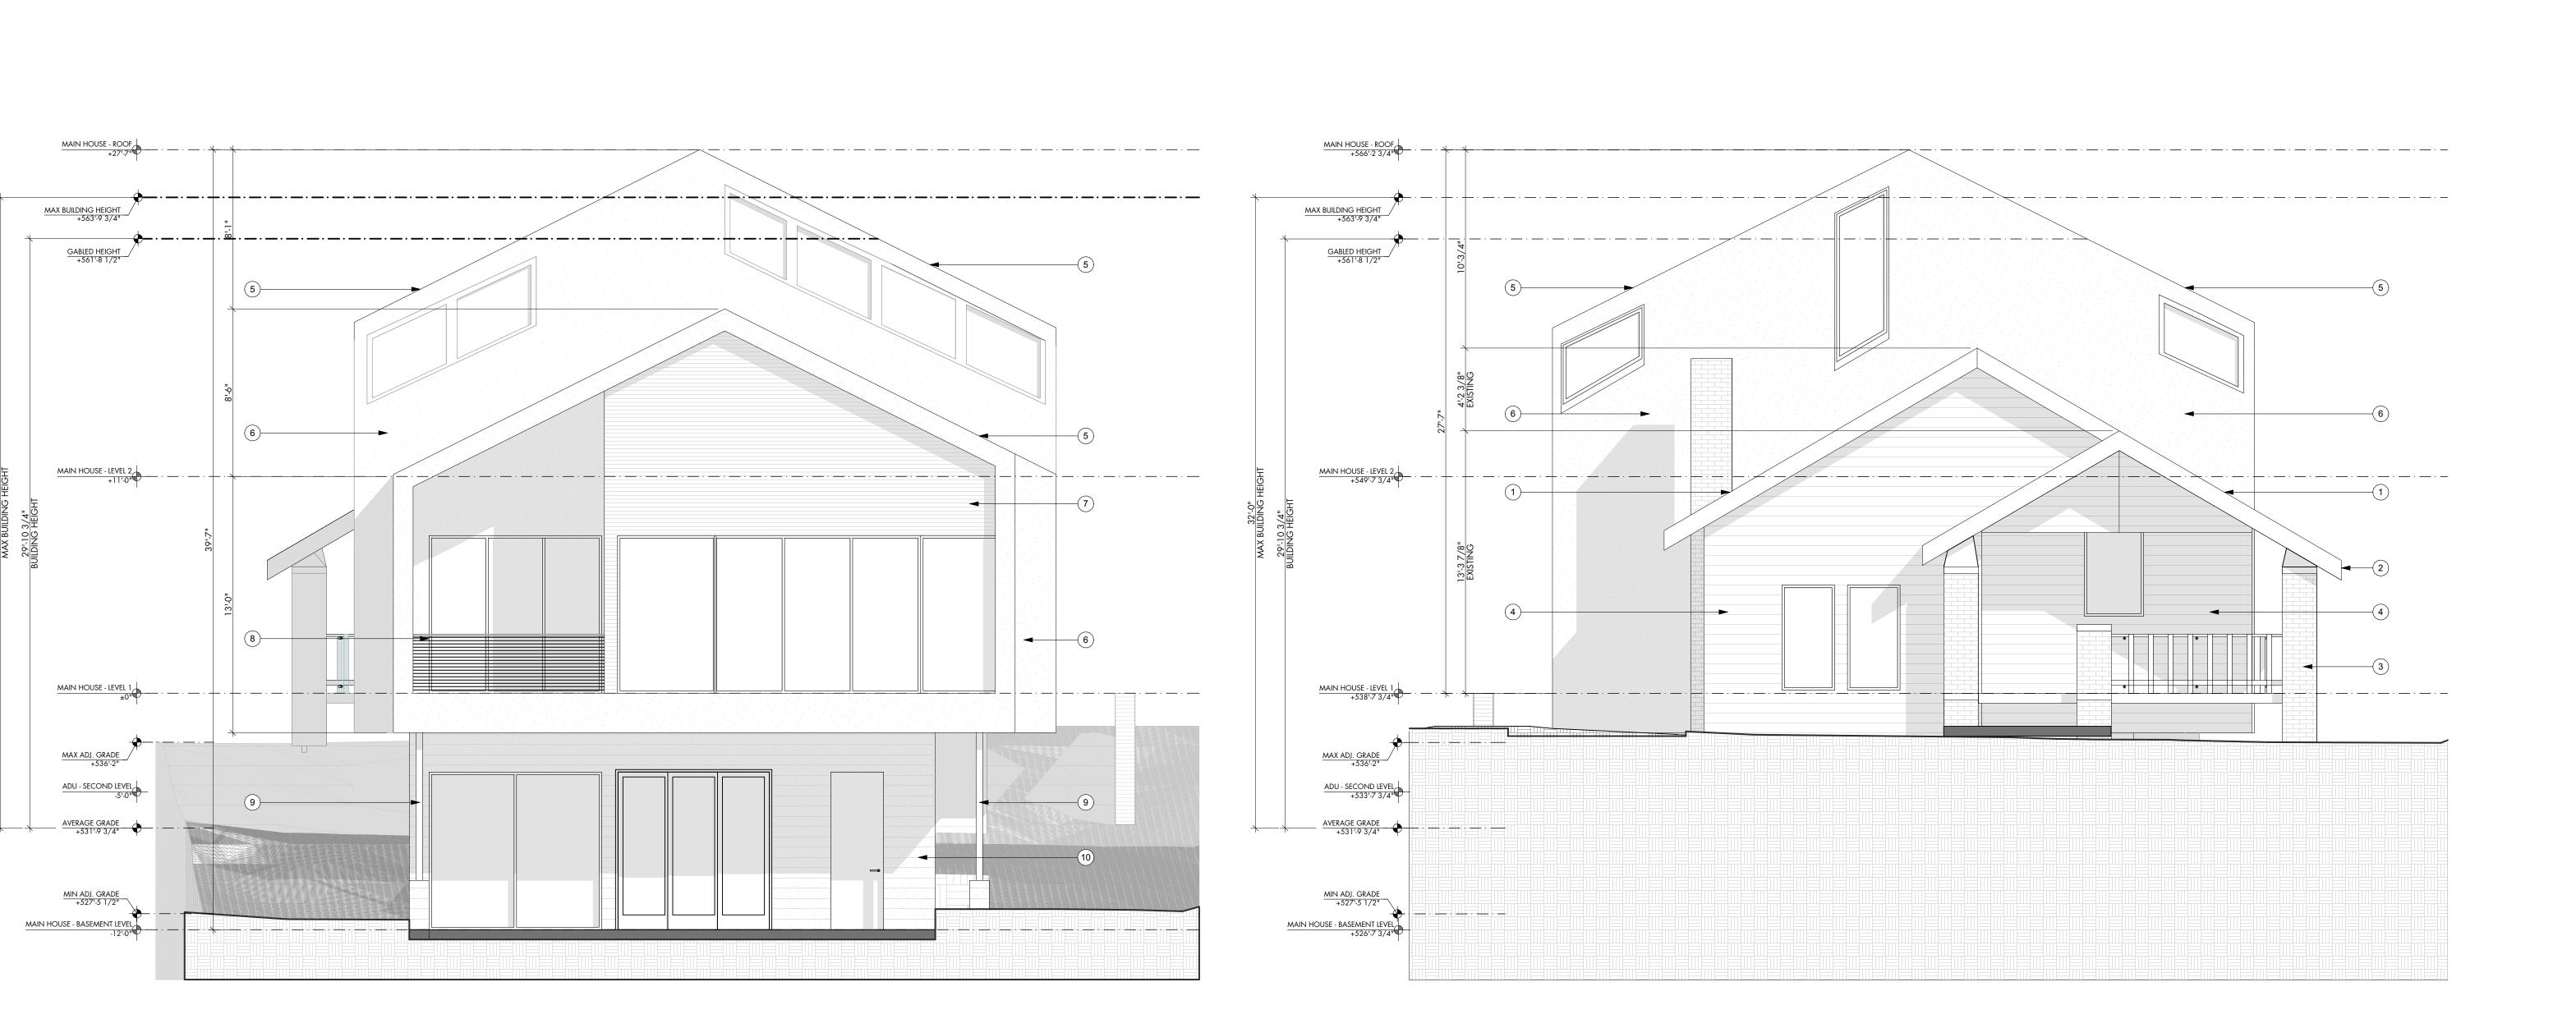

BUILDING ELEVATIONS


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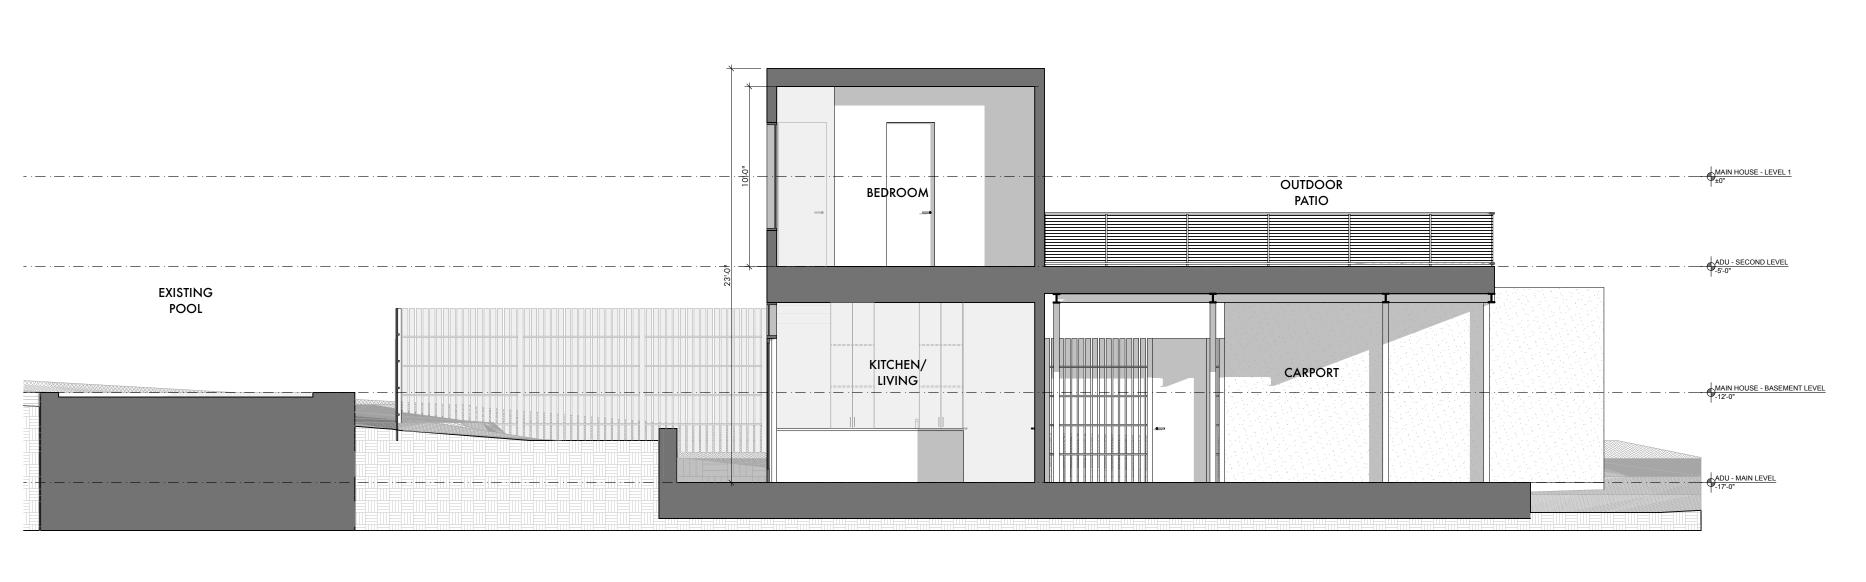
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SCALE: 1/4" = 1'-0"

ADU - SOUTH ELEVATION SCALE: 1/4" = 1'-0"

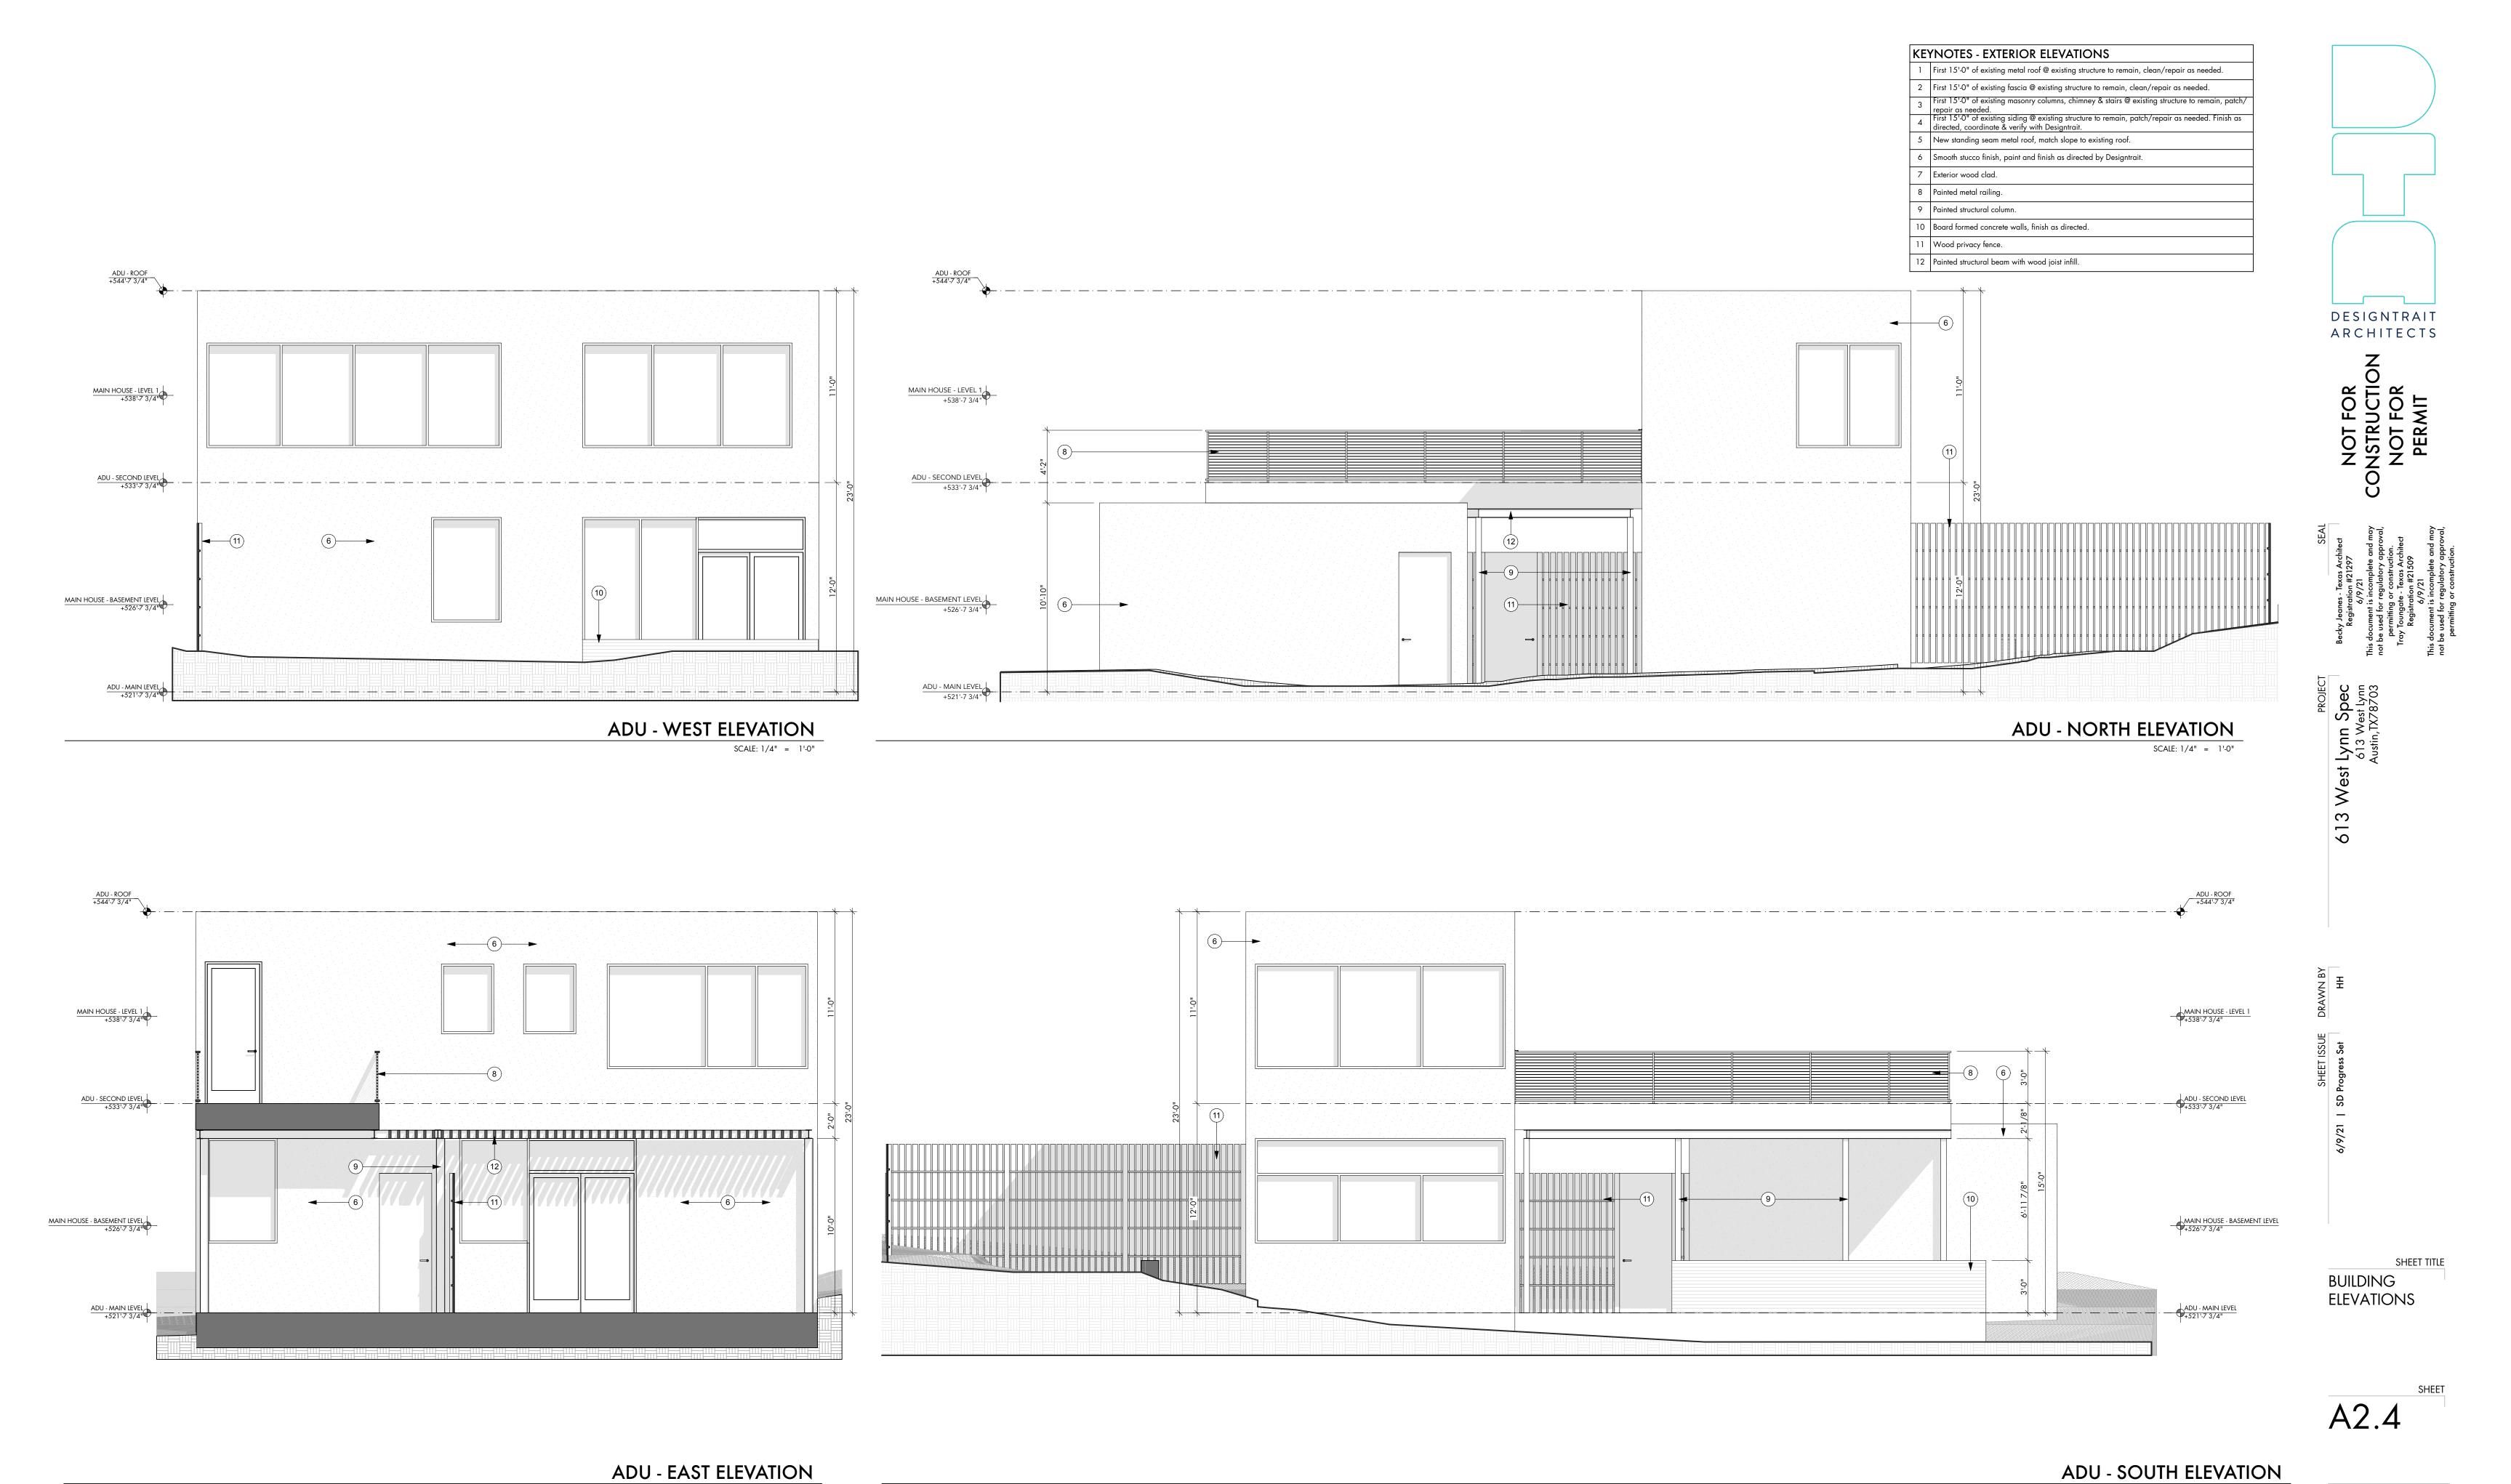



CROSS SECTION THROUGH ADU

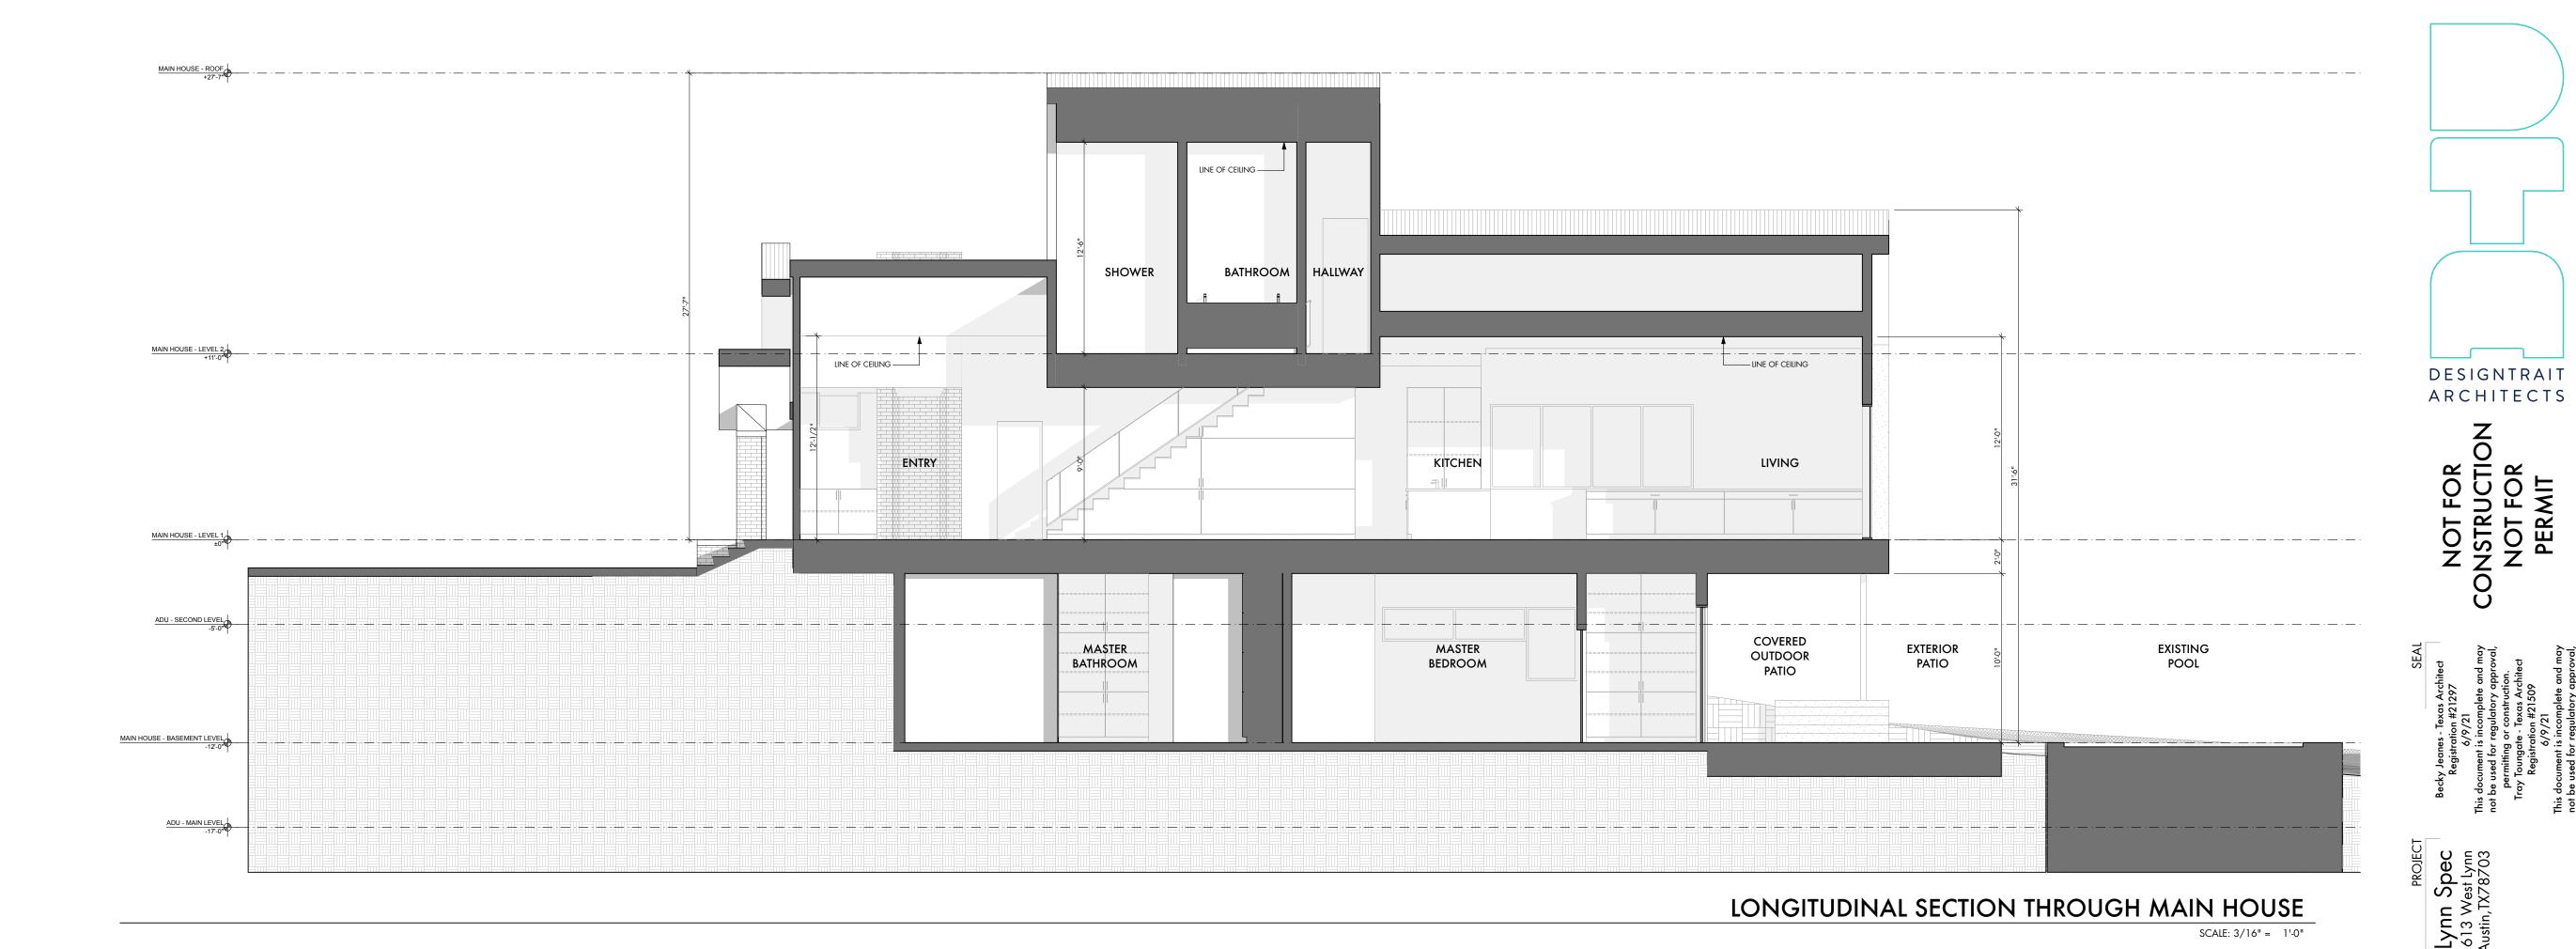SCALE: 3/16" = 1'-0"

CAUTION: DO NOT SCALE DRAWINGS

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BUILDING SECTIONS

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