
# Elisabet Ney Museum Building Restoration & Site Improvements - HVAC and Lighting

CIP: 7551.005


304 E 44th St, Austin, TX 78751

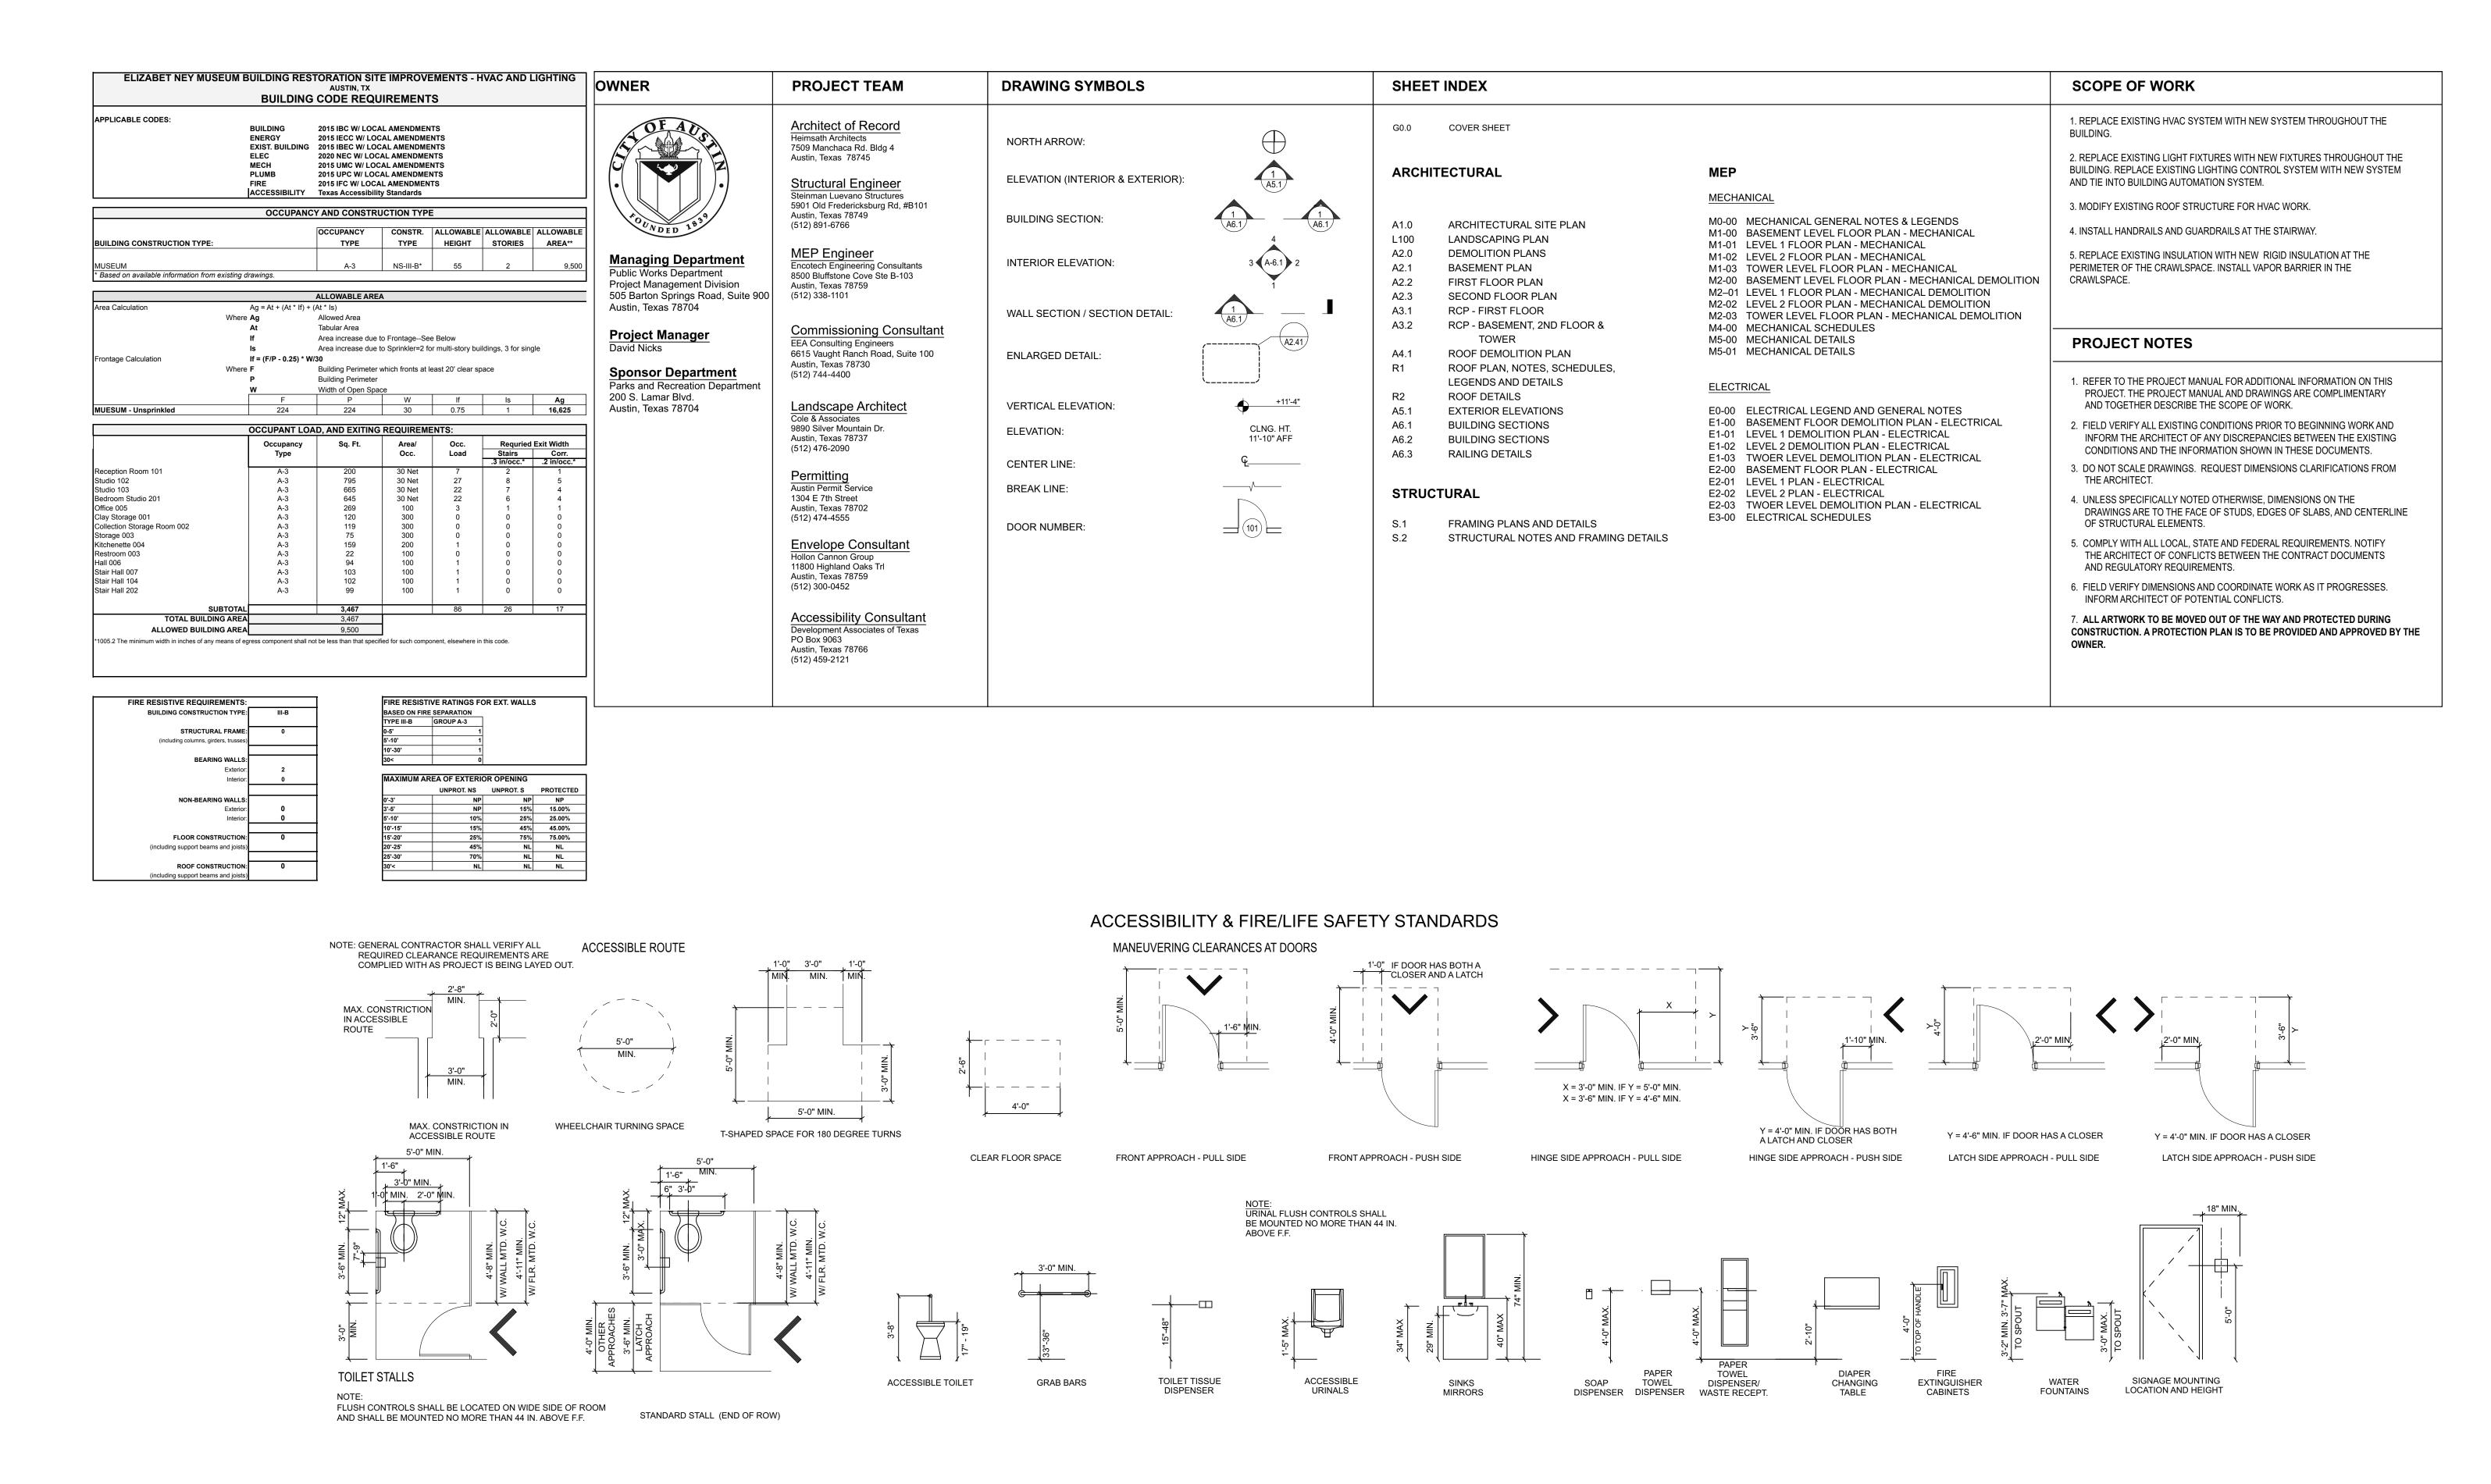


No./Date/Remarks

2019-930


Sheet Number

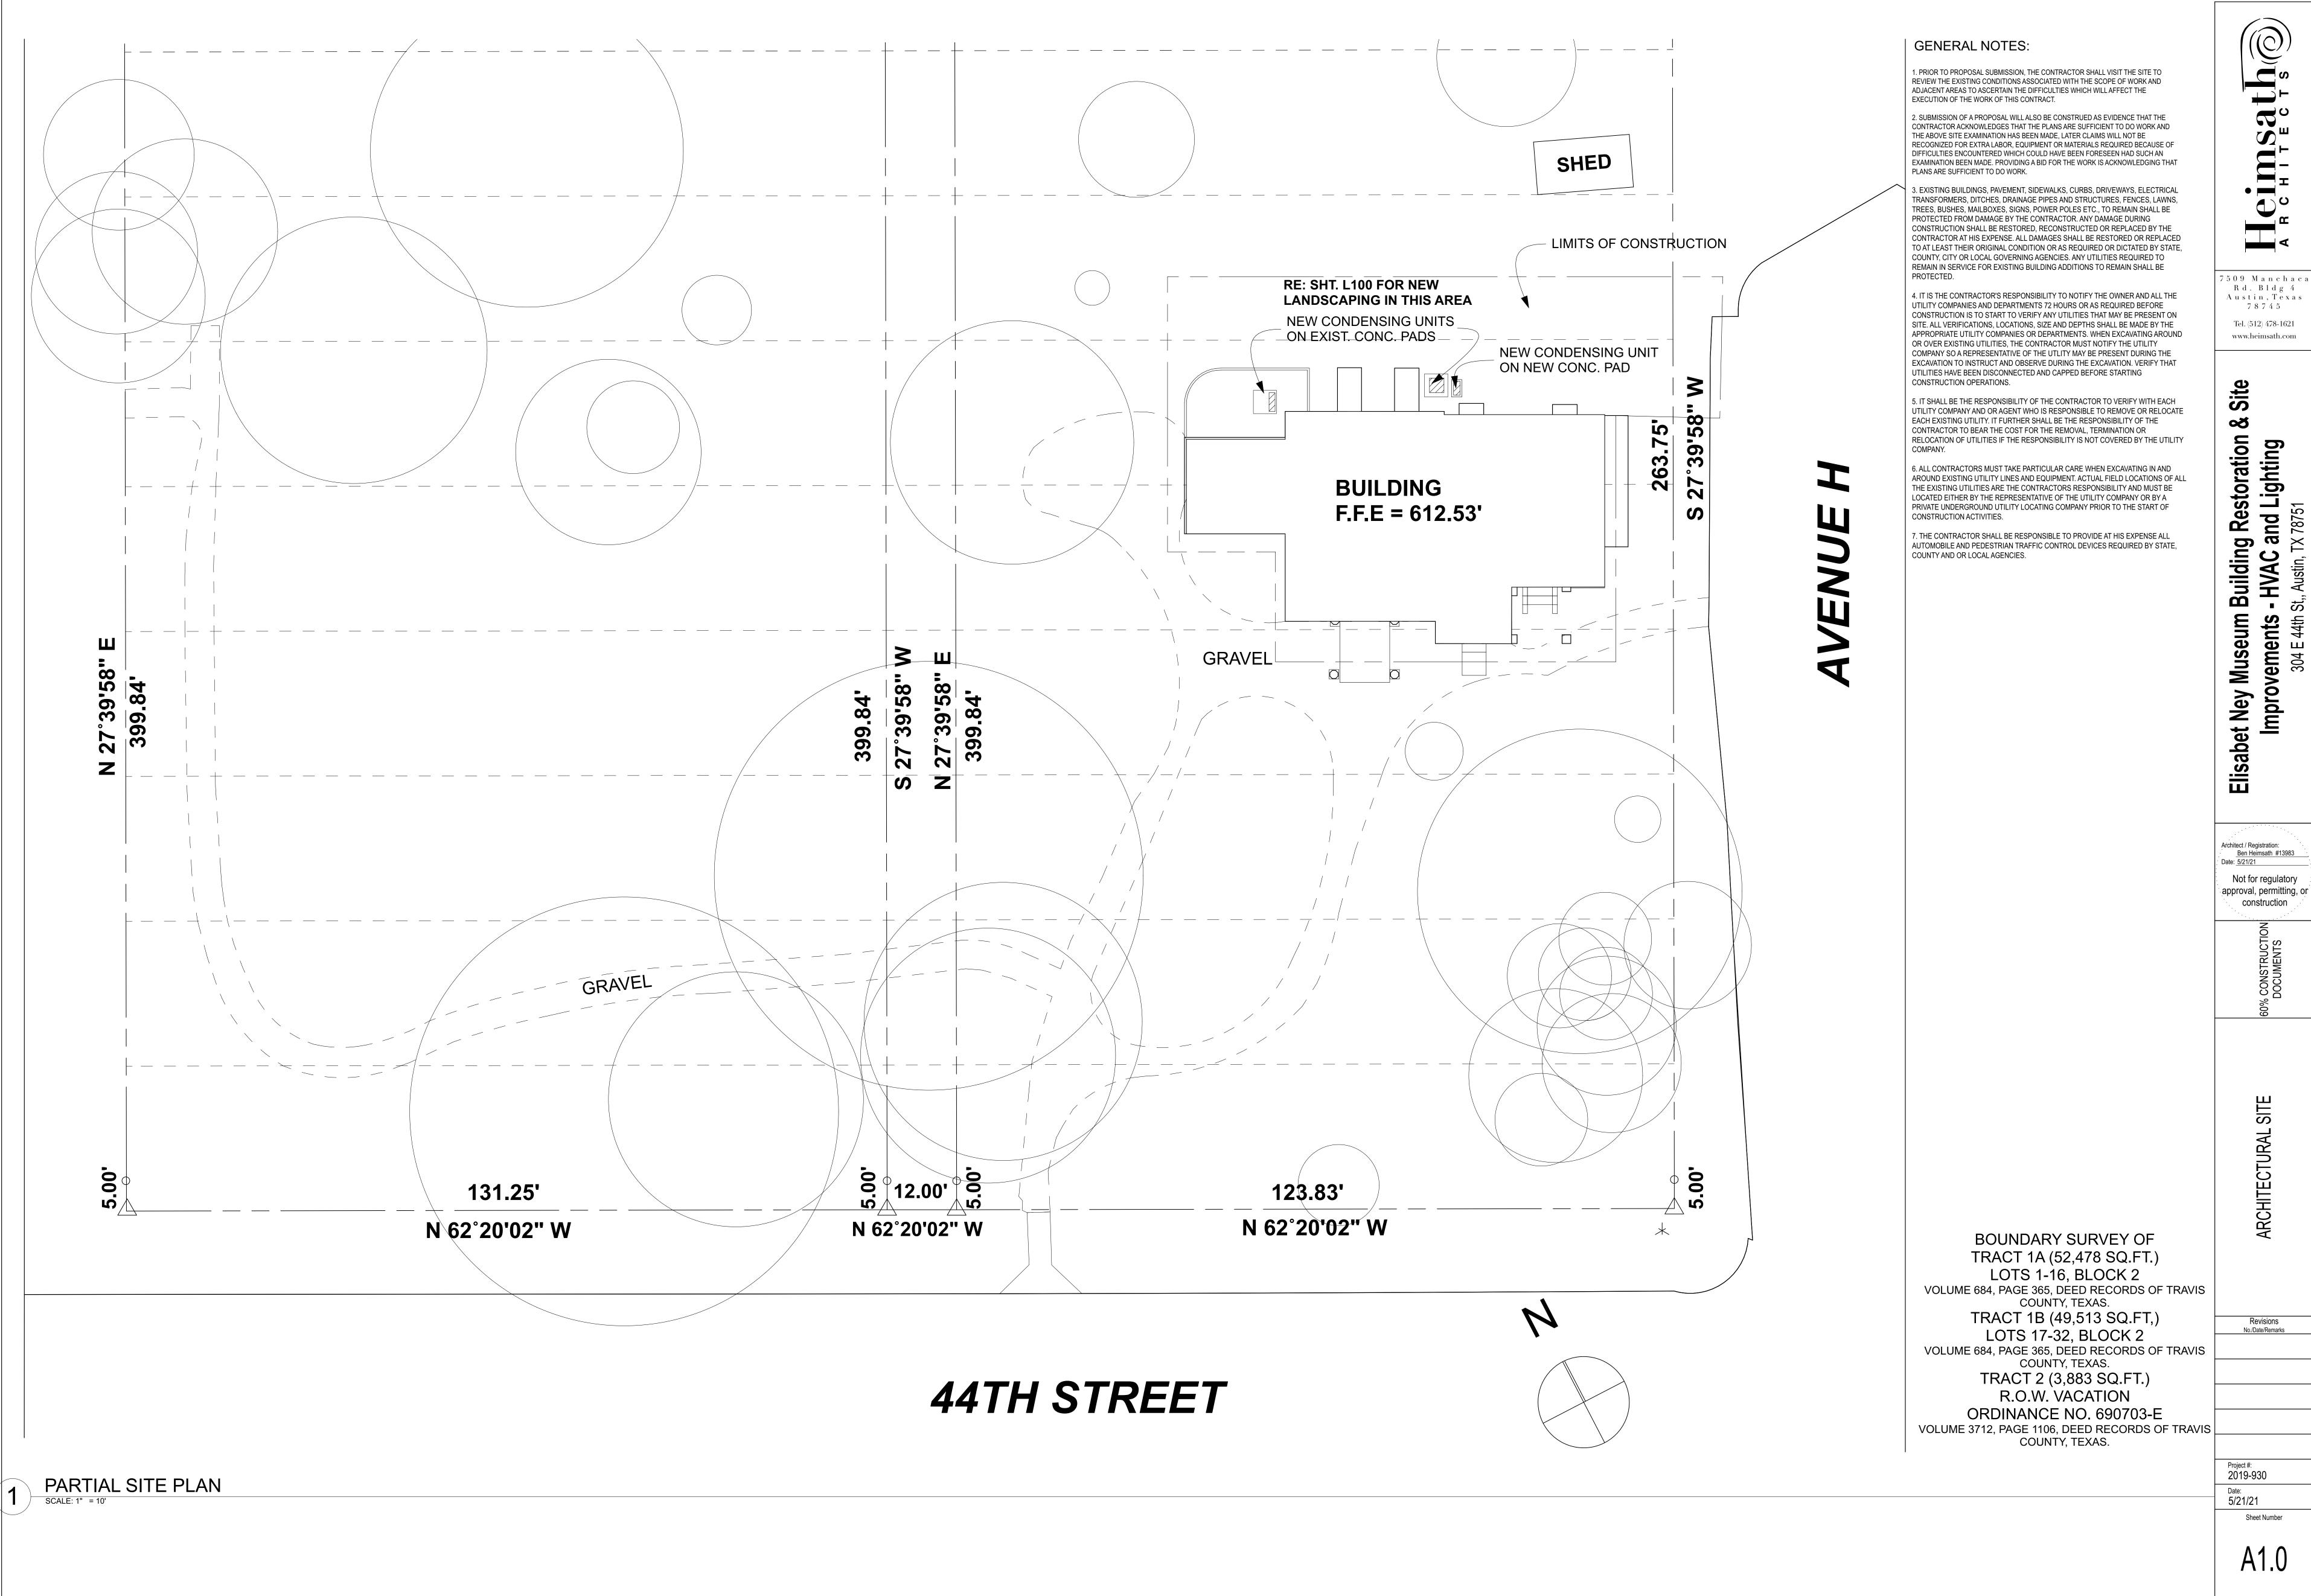

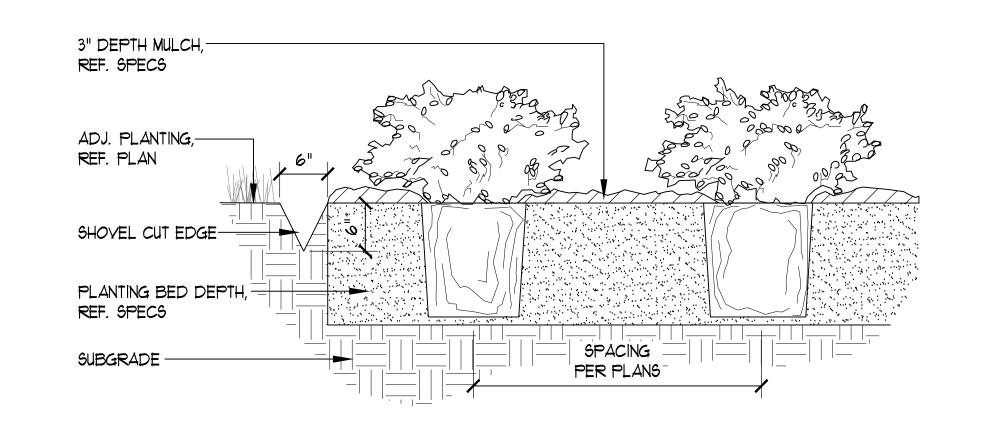

SHRUB PLANTING / SHOVEL CUT EDGE

SCALE: 1"=1'-Ø"

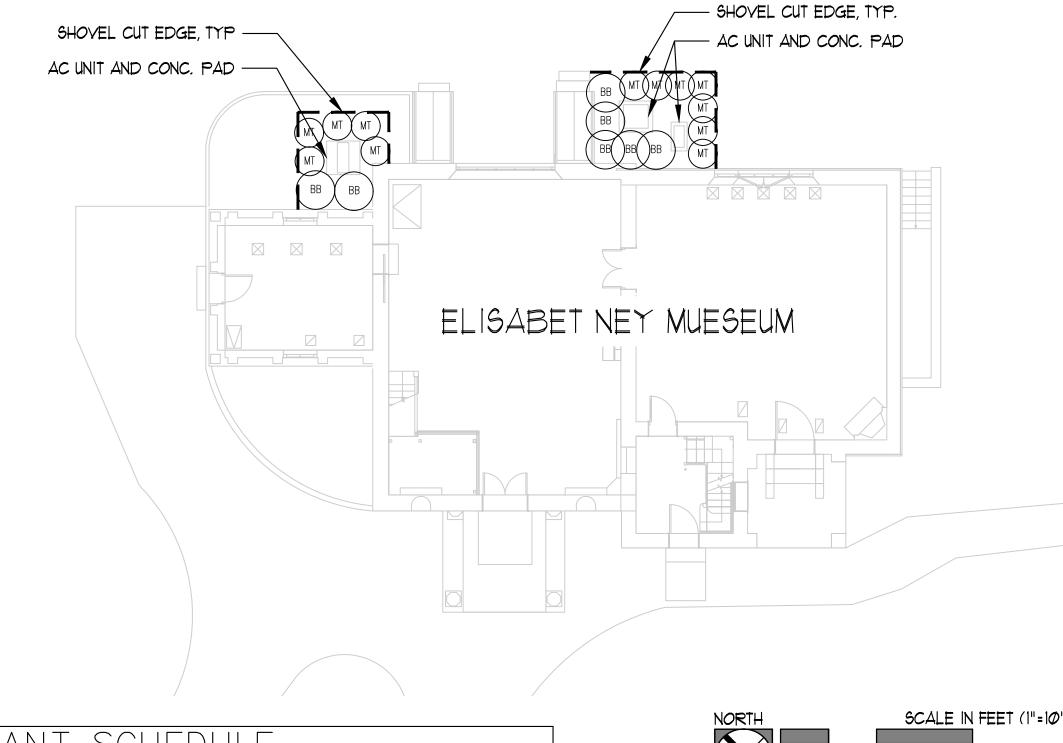

PLANT SCHEDULE						
SHRUBS	QTY	COMMON / BOTANICAL NAME	CONT	SPACING		
BB		AMERICAN BEAUTYBERRY CALLICARPA AMERICANA	5 GAL	48" o.c.		
MT	12	AGARITA MAHONIA TRIFOLIATA	5 GAL	36" o.c.		

- REFERENCE CITY OF AUSTIN 6086 PIANTING FOR SHRUB PLANTING
- REFERENCE CITY OF AUSTIN 6095 NATIVE SEEDING AND PLANTING FOR RESTORATION TO REVEGETATE ALL AREAS DISTURBED NOT SHOWN ON THIS PLAN DURING CONSTRUCTION.
- 3. REFERENCE CITY OF AUSTIN 6065 -FERTILIZATION.

GENERAL NOTES.

4. NO PERMANENT IRRIGATION IS REQUIRED, ALL SHRUBS SHOULD BE HAND WATERED TO ESTABLISH.

## SITE DEVELOPMENT PERMIT LANDSCAPE NOTES.

- I. ALL LANDSCAPED AREAS TO BE PROTECTED BY 6 INCH CURBS, WHEEL-STOPS OR OTHER APPROVED BARRIERS AS PER ECM 2.4.7(A). 2. THE OWNER WILL CONTINUOUSLY MAINTAIN THE REQUIRED LANDSCAPING IN ACCORDANCE WITH LDC 25-2-984.
- 3. EXISTING TREES TO BE SAVED SHALL BE PROTECTED BY FENCING BEFORE CONSTRUCTION BEGINS. NO EQUIPMENT OR MATERIALS SHALL BE STORED OR OPERATED WITHIN THE FENCED-IN AREAS. FENCES SHALL BE AT THE DRIP LINE AND COMPLETELY SURROUND THE TREE OR CLUSTERS OF TREES. NO BURNING OF DEBRIS, CLEANING FLUIDS, CONCRETE SPILLS, ETC. WILL BE ALLOWED WITHIN THESE AREAS.
- 4. BUFFERING OF THE STREET YARD WILL BE ACCOMPLISHED THROUGH THE COMBINATION OF TREES, SHRUBS, GRADE CHANGES, AND FENCES. 5. GRADE CHANGES THAT DO NOT APPEAR ON THE
- SITE PLANS SHALL BE BROUGHT TO THE ATTENTION OF THE LANDSCAPE ARCHITECT BY THE GENERAL CONTRACTOR PRIOR TO CONSTRUCTION.
- 6. TRENCHING SHALL NOT OCCUR WITHIN THE FENCED DRIP LINE AREAS OF EXISTING TREES. 1. SHRUB MATERIAL NOT TO EXCEED 36" O.C. UNLESS OTHERWISE SPECIFIED. GROUNDCOVERS NOT TO EXCEED 18" O.C. DURING THE TIME OF MARCH
- 15-OCTOBER 15 INSTALLATION OF HYDROMULCH SHALL BE COMMON BERMUDA OR SAHARA BERMUDA FOR OCTOBER 16 -MARCH 14 INSTALLATION OF HYDROMULCH SHALL BE ANNUAL OR PERENNIAL RYE WITH A SPRING APPLICATION OF COMMON BERMUDA OR SAHARA BERMUDA.
- 8. ALL LAWN AREAS WITHIN THE LIMITS OF CONSTRUCTION SHALL BE RE-VEGETATED WITH BERMUDA SOD OR RYE UNLESS NATIVE RESTORATION MIX IS SPECIFIED.
- 9. NOT MORE THAN 50% OF THE TREES AND 50% OF SHRUBS PROPOSED WILL BE OF THE SAME 10. AN AUTOMATIC IRRIGATION SYSTEM SHALL BE
- INSTALLED. SEE IRRIGATION NOTES IN THESE DRAWINGS FOR REQUIREMENT. 11. IF ESTABLISHING VEGETATION DURING ANY STAGE OF DROUGHT, SECTION 6-4-30 MAY REQUIRE A YARIANCE. CONTACT AUSTIN WATER

CONSERVATION STAFF AT (512-974-2199 OR AT

WATERUSECOMPYAR@AUSTINTEXAS.GOV.

#### LANDSCAPE CERTIFICATION

I, AAN G. COLEMAN, DO HEREBY CERTIFY THAT THE PLANS FOR THE DEVELOPMENT PROJECT LOCATED AT 304 E 44TH STREET, SATISFY THE REQUIREMENTS OF THE LDC-25-2 OF THE CITY OF AUSTIN LAND DEVELOPMENT

MARISSA MCKINNEY

COLEMAN & ASSOCIATES ALL RESPONSIBILITY FOR THE ADEQUACY OF THESE PLANS REMAINS WITH THE LANDSCAPE ARCHITECT WHO PREPARED THEM. IN REVIEWING THESE PLANS, THE CITY OF AUSTIN MUST RELY ON THE ADEQUACY OF THE WORK OF THE LANDSCAPE ARCHITECT.

# IRRIGATION NOTES.

AUTOMATIC IRRIGATION SYSTEMS SHALL COMPLY WITH TCEQ CHAPTER 344, AS WELL AS THE FOLLOWING REQUIREMENTS.

- THESE REQUIREMENTS SHALL BE NOTED ON THE SITE DEVELOPMENT PERMIT AND SHALL BE IMPLEMENTED AS PART OF THE LANDSCAPE INSPECTION.
- A. THE SYSTEM MUST PROVIDE A MOISTURE LEVEL ADEQUATE TO SUSTAIN GROWTH OF THE PLANT MATERIALS.
- B. THE SYSTEM DOES NOT INCLUDE SPAY IRRIGATION ON AREAS LESS THAN (10) FEET WIDE (SUCH AS MEDIANS, BUFFER STRIPS, AND PARKING LOT ISLANDS).
- C. CIRCUIT REMOTE CONTROL YALVES HAVE ADJUSTABLE FLOW CONTROLS.
- D. SERVICEABLE IN-HEAD CHECK VALVES AREA ADJACENT TO PAYED AREAS WHERE ELEVATION DIFFERENCES MAY CAUSE LOW HEAD DRAINAGE
- E. A MASTER VALVE INSTALLED ON THE DISCHARGE SIDE OF THE BACKFLOW PREVENTER.
- F. ABOYE-GROUND IRRIGATION EMISSION DEVICES ARE SET BACK AT LEAST SIX (6) INCHES FROM IMPERVIOUS SURFACES.
- G. AN AUTOMATIC RAIN SHUT-OFF DEVICE SHUTS OFF THE IRRIGATION SYSTEM AUTOMATICALLY AFTER MORE THAN A ONE-HALF INCH (1/2") RAINFALL.
- H. NEWLY PLANTED TREES SHALL HAVE PERMANENT IRRIGATION CONSISTING OF DRIP OR BUBBLERS.
- THE IRRIGATION INSTALLER SHALL DEVELOP AND PROVIDE AN AS-BUILT DESIGN PLAN TO THE CITY AT THE TIME THE FINAL IRRIGATION INSPECTION IS PERFORMED.
- A. UNLESS FISCAL SECURITY IS PROVIDED TO THE CITY FOR THE INSTALLATION OF THE SYSTEM, IT MUST BE OPERATIONAL AT THE TIME OF THE FINAL LANDSCAPE INSPECTION,
- 3. THE IRRIGATION INSTALLER SHALL ALSO PROVIDE EXHIBITS TO BE PERMANENTLY INSTALLED INSIDE OR ATTACHED TO THE IRRIGATION CONTROLLER, INCLUDING.
- A. A LAMINATED COPY OF THE WATER BUDGET CONTAINING ZONE NUMBERS, PRECIPITATION RATE, GALLONS PER MINUTE AND THE LOCATION OF THE ISOLATION VALVE, AND AN AS BUILT PLAN.
- 4. THE IRRIGATION INSTALLER SHALL PROVIDE A REPORT TO THE CITY ON A FORM PROVIDED BY THE AUSTIN WATER UTILITY DEPARTMENT CERTIFYING COMPLIANCE WITH SUBSECTION I WHEN THE FINAL PLUMBING INSPECTION IS PERFORMED BY THE CITY

SITE PLAN RELEASE Sheet of	
FILE NUMBER:EXPIRATION DATE:	
CASE MANAGER:APPLICATION DATE:	
APPROVED ADMINISTRATIVELY ON:	Project #:
APPROVED BY PLANNING COMMISSION ON:	2019-930
APPROVED BY CITY COUNCIL ON:of the Austin City Code.	
or order sectionor orderor the Austin orty south.	Date:
Signing For Director, Development Services Department	5/10/21
DATE OF DELEACE 7001110	Sheet Nur
DATE OF RELEASE:ZONING:	
Rev. 1 Correction 1	
Rev. 2 Correction 2	
Rev. 3 Correction 3	1 1 1
RELEASE OF THIS APPLICATION DOES NOT CONSTITUTE A VERIFICATION	1 11
OF ALL DATA. INFORMATION AND CALCULATIONS SUPPLIED BY THE	
APPLICANT. THE ENGINEER OF RECORD IS SOLELY RESPONSIBLE FOR	
THE COMPLETENESS, ACCURACY AND ADEQUACY OF HIS/HER	
SUBMITTAL, WHETHER OR NOT THE APPLICATION IS REVIEWED FOR	©2021 Heimsati
CODE COMPLIANCE BY CITY ENGINEERS.	

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Elisab

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#### **GENERAL DEMO NOTES**

1. THE CONTRACTOR SHALL VISIT THE SITE TO REVIEW THE EXISTING CONDITIONS ASSOCIATED WITH THE SCOPE OF WORK AND ADJACENT AREAS TO ASCERTAIN THE DIFFICULTIES WHICH WILL AFFECT THE EXECUTION OF THE WORK OF THIS CONTRACT.

2. SUBMISSION OF A PROPOSAL WILL ALSO BE CONSTRUED AS EVIDENCE THAT THE CONTRACTOR ACKNOWLEDGES THAT THE PLANS ARE SUFFICIENT TO DO WORK AND THE ABOVE SITE EXAMINATION HAS BEEN MADE, LATER CLAIMS WILL NOT BE RECOGNIZED FOR EXTRA LABOR, EQUIPMENT OR MATERIALS REQUIRED BECAUSE OF DIFFICULTIES ENCOUNTERED WHICH COULD HAVE BEEN FORESEEN HAD SUCH AN EXAMINATION BEEN MADE. PROVIDING A BID FOR THE WORK IS ACKNOWLEDGING THAT PLANS ARE SUFFICIENT TO DO WORK.

3. THE OWNER HAS PROVIDED ASBESTOS SURVEY FOR THE CONTRACTOR'S USE. OTHER THAN THAN THIS REPORT THE ARCHITECT HAS NO KNOWLEDGE OF AND SHALL NOT BE HELD LIABLE FOR ANY ASBESTOS OR OTHER HAZARDOUS MATERIALS ON THE JOB SITE. THE CONTRACTOR SHALL TAKE THE APPROPRIATE MEASURES IN COORDINATING SITE EXAMINATION BY AN OFFICIAL IN IDENTIFYING THE PRESENCE OF THESE MATERIALS ON SITE AS OUTLINED IN THE TEXAS HEALTH PROTECTION RULES (TAHPR).

4. CONTRACTOR TO COORDINATE WORK OF VARIOUS DISCIPLINES AND REPORT ANY CONFLICTS OR DISCREPANCIES PRIOR TO BEGINNING WORK.

5. FULL EXTENT OF REQUIRED DEMOLITION MAY NOT BE INDICATED ON THIS PLAN. PROVIDE ALL DEMOLITION WORK EVEN WHERE NOT SPECIFICALLY INDICATED FOR A COMPLETELY FINISHED PROJECT.


6. MAINTAIN RECORD DRAWINGS OF ALL SITE WORK. NOTE ANY DISCREPANCY BETWEEN THESE DRAWINGS AND ACTUAL FIELD CONDITION ESPECIALLY WHERE HIDDEN.

7. CAUSE NO DAMAGE TO EXISTING CONSTRUCTION. TAKE CARE TO NOT ENCROACH INTO ADJACENT AREAS NOT WITHIN THE SCOPE OF WORK. PROTECT ALL EXISTING FINISHES, DOORS, FRAMES, CABINETRY, MILLWORK, ETC WHICH ARE TO REMAIN.

8. CONDUCT DEMOLITION OPERATIONS AND THE REMOVAL OF DEBRIS TO ENSURE MINIMUM INTERFERENCE WITH STREETS, SIDEWALKS, AND OTHER ADJACENT OCCUPIED SPACES. COMPLY WITH LOCAL JURISDICTION REQUIREMENTS FOR RECYCLING AND TREATMENT OF ITEMS TO BE RECYCLED.


9. REFER TO MECHANICAL AND ELECTRICAL DRAWINGS FOR MECHANICAL AND ELECTRICAL DEMOLITION SCOPE. REFER TO STRUCTURAL, MECHANICAL, ELECTRICAL & PLUMBING DRAWINGS FOR SPECIFIC NOTES & SPECIFICATIONS REGARDING THESE DISCIPLINES. ALL HVAC, ELECTRICAL AND PLUMBING ITEMS SHALL BE CAPPED AND IDENTIFIED.

10. COMPLY WITH LOCAL JURISDICTION REQUIREMENTS FOR RECYCLING AND TREATMENT OF ITEMS TO BE RECYCLED.

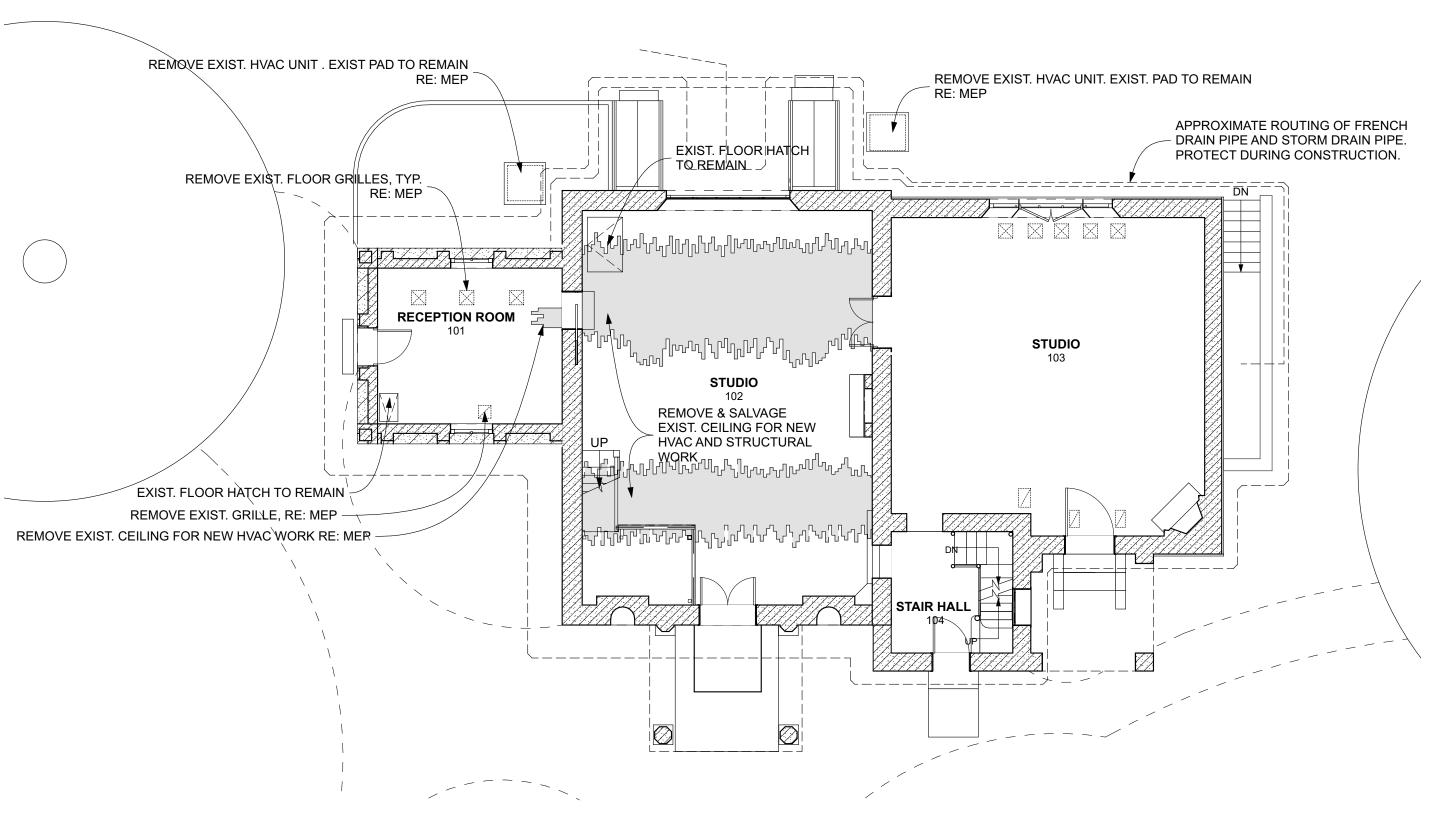

FIRST FLOOR DEMO

SCALE: 1/8" = 1'-0"

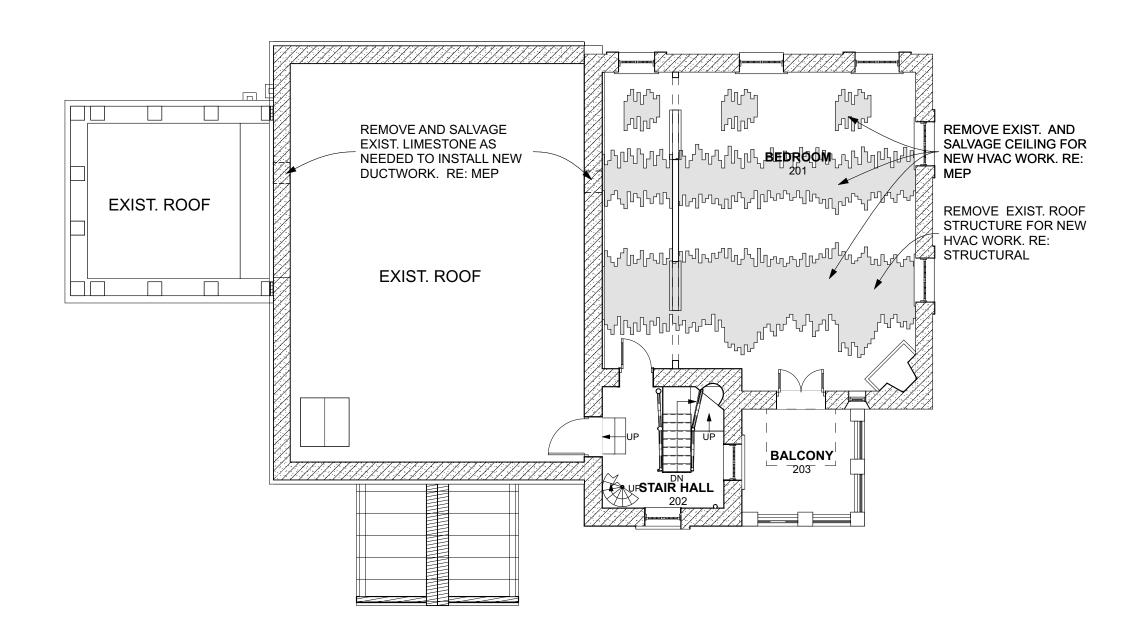

3 SECOND FLOOR DEMO
SCALE: 1/8" = 1'-0"

REFER TO SHEETS A4.2 AND M2-03 FOR ROOFING DEMOLITION

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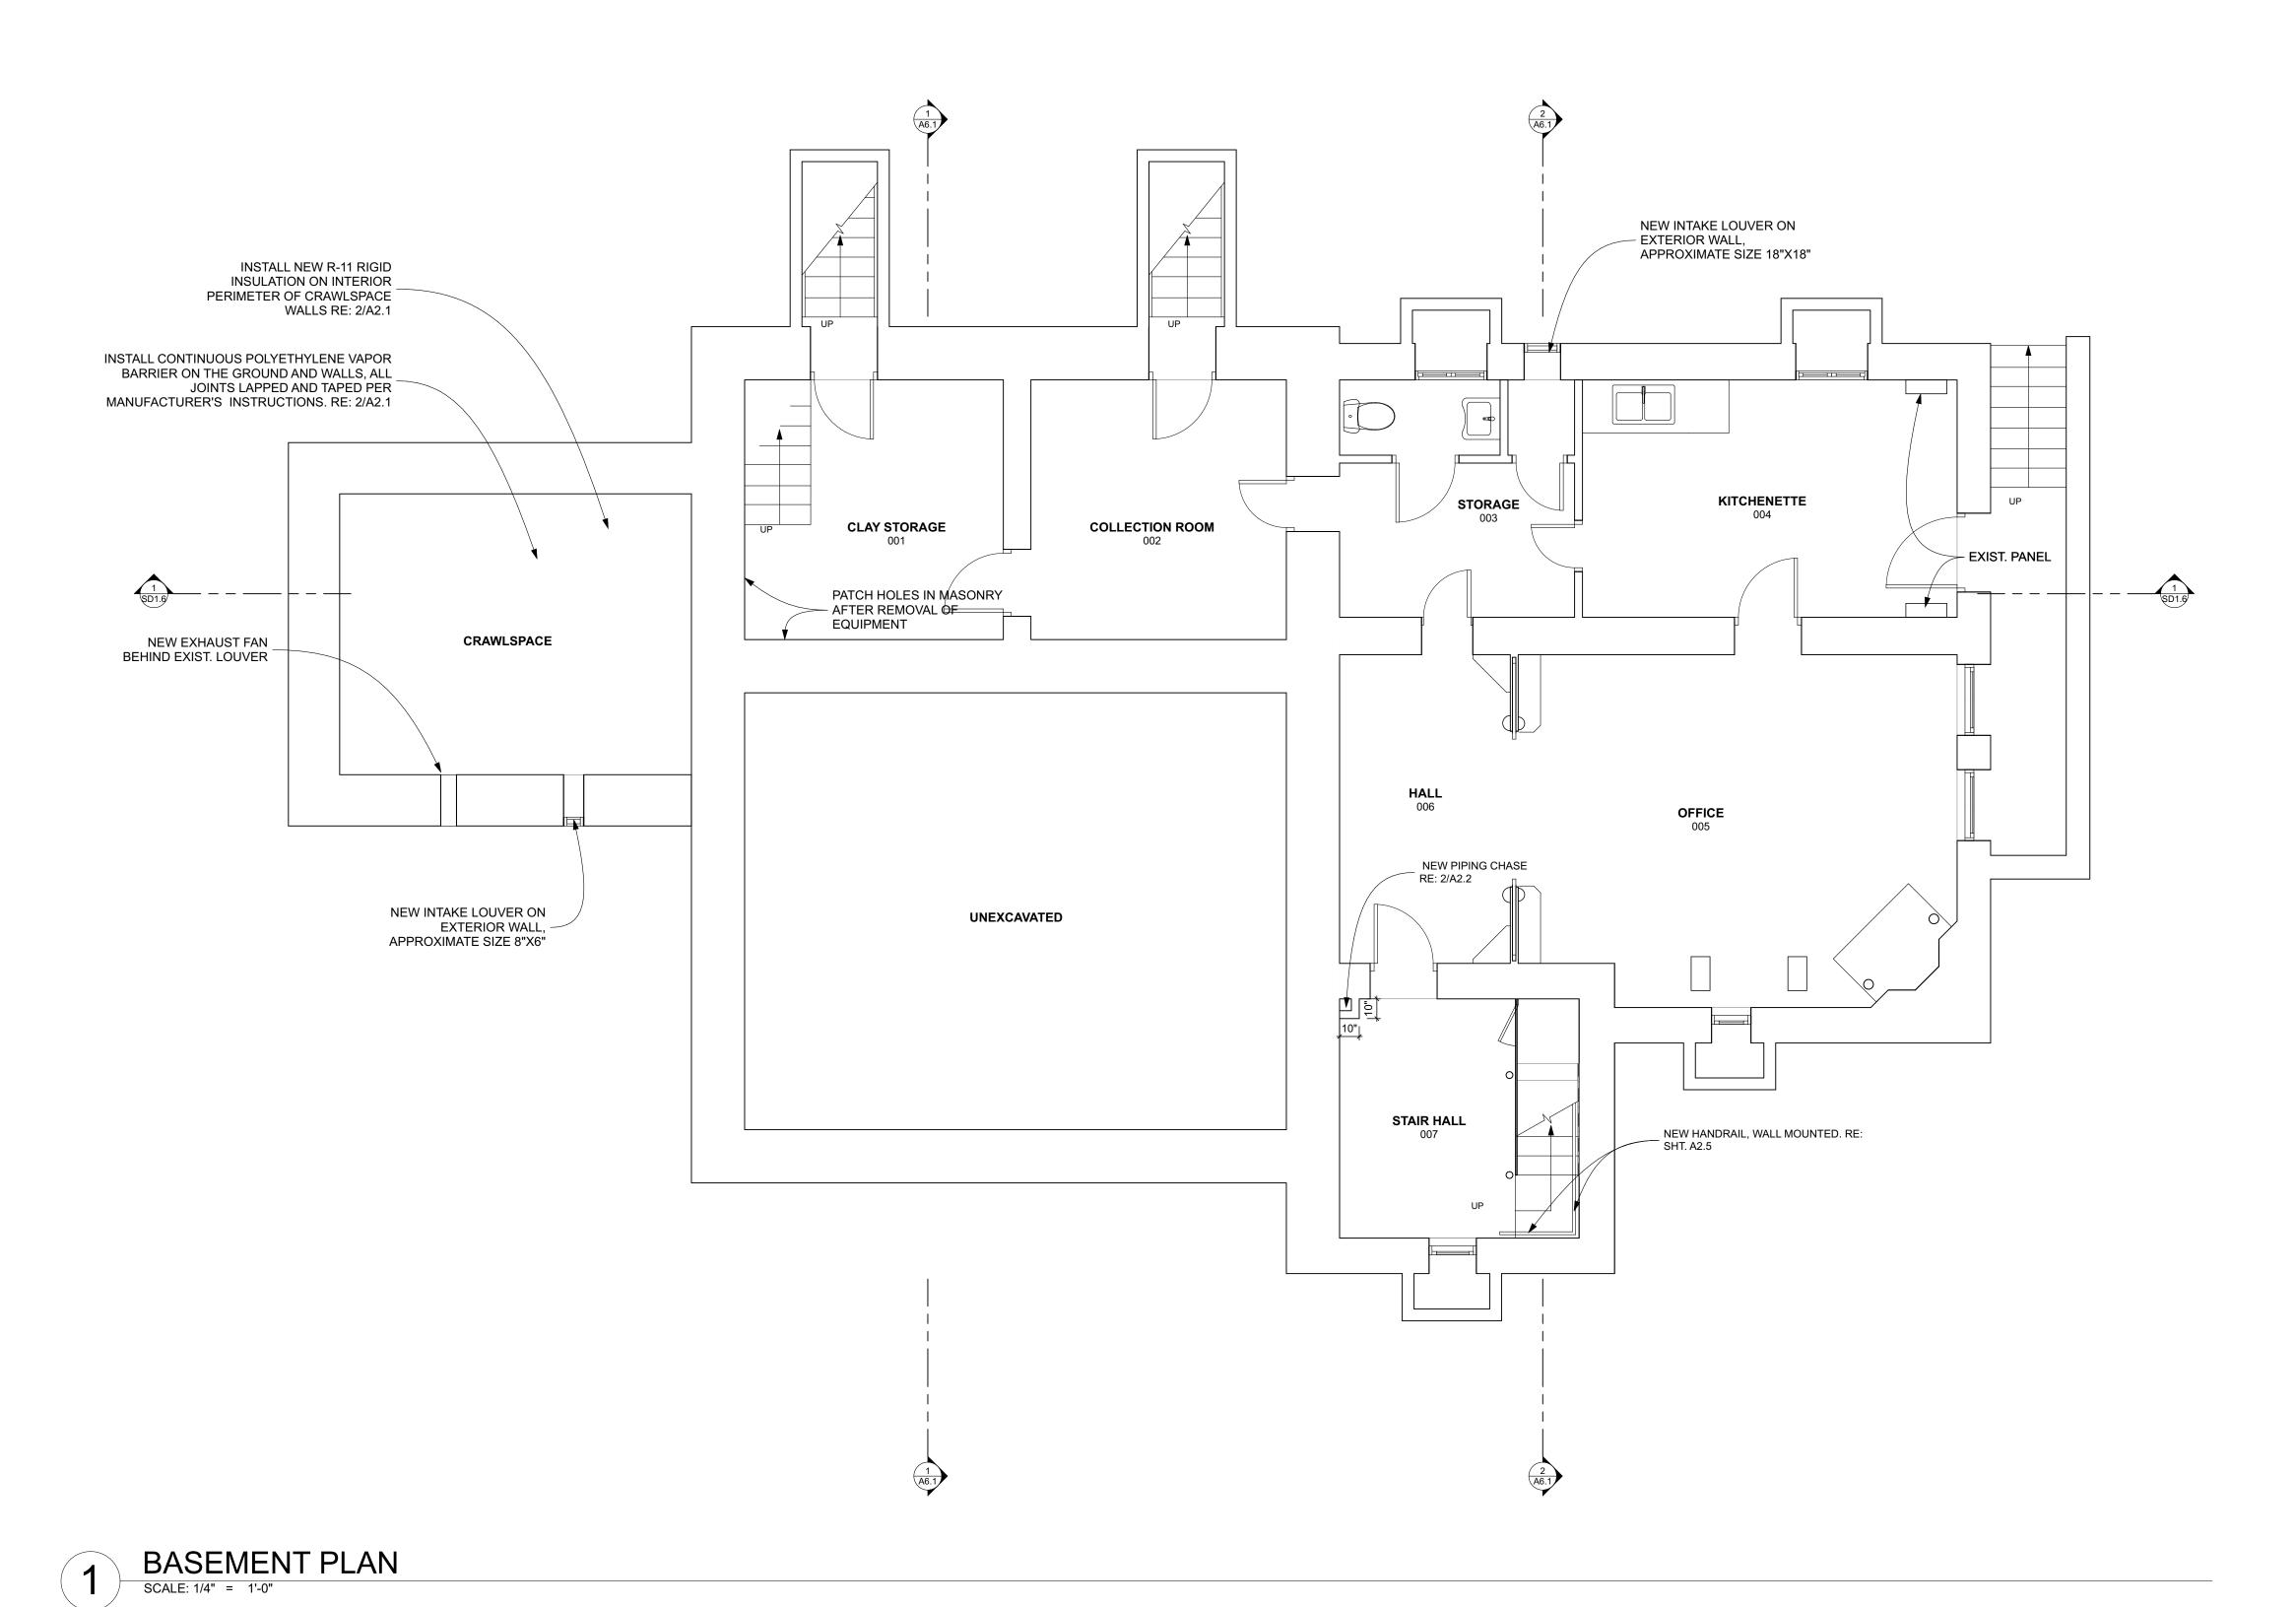
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2 DETAIL @ CRAWL SPACE

SCALE: 1" = 1'-0"



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Tel. (512) 478-1621

Architect / Registration:
Ben Heimsath #13983

Date: 5/21/21

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construction

CONSTRUCTION

DOCUMENTS


DOCUMENTS

**ASEMENT PLAN** 

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A2.1





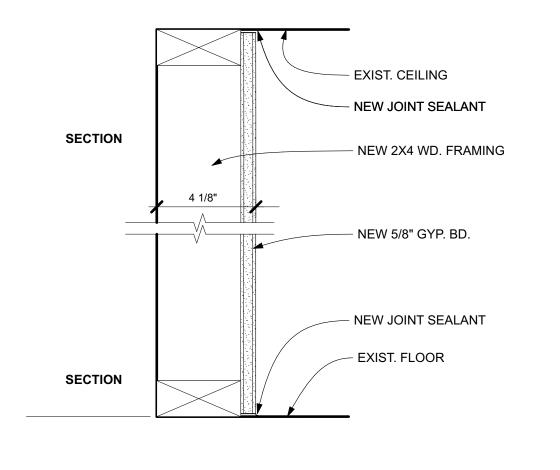

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SECOND FLOOR PLAN

SCALE: 1/4" = 1'-0"

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#### RCP LEGEND

EXIST. WOOD CEILING

REINSTALLED WOOD CEILING/NEW WOOD CEILING

CEILING MOUNTED/WALL MOUNTED FRESH AIR GRILLE RETURN AIR GRILLE

CEILING MOUNTED 1X4 LED FIXTURE


RECESSED CAN LED FIXTURE

TRACK LIGHT

### **GENERAL NOTES:**

1. COORDINATE LOCATION OF ALL EXPOSED CONDUIT, PIPING AND CONDENSATE LINES WITH OWNER AND ARCHITECT. ALL ARE TO BE INSTALLED IN ALIGNMENT WITH EXISTING STRUCTURE AND HIDDEN AS MUCH AS POSSIBLE.

2.PATCH ALL HOLES IN CEILINGS AFTER REMOVAL OF EXIST. FIXTURES. PANINT OR STAIN PATCHES TO MATCH EXIST. CEILING FINISH.

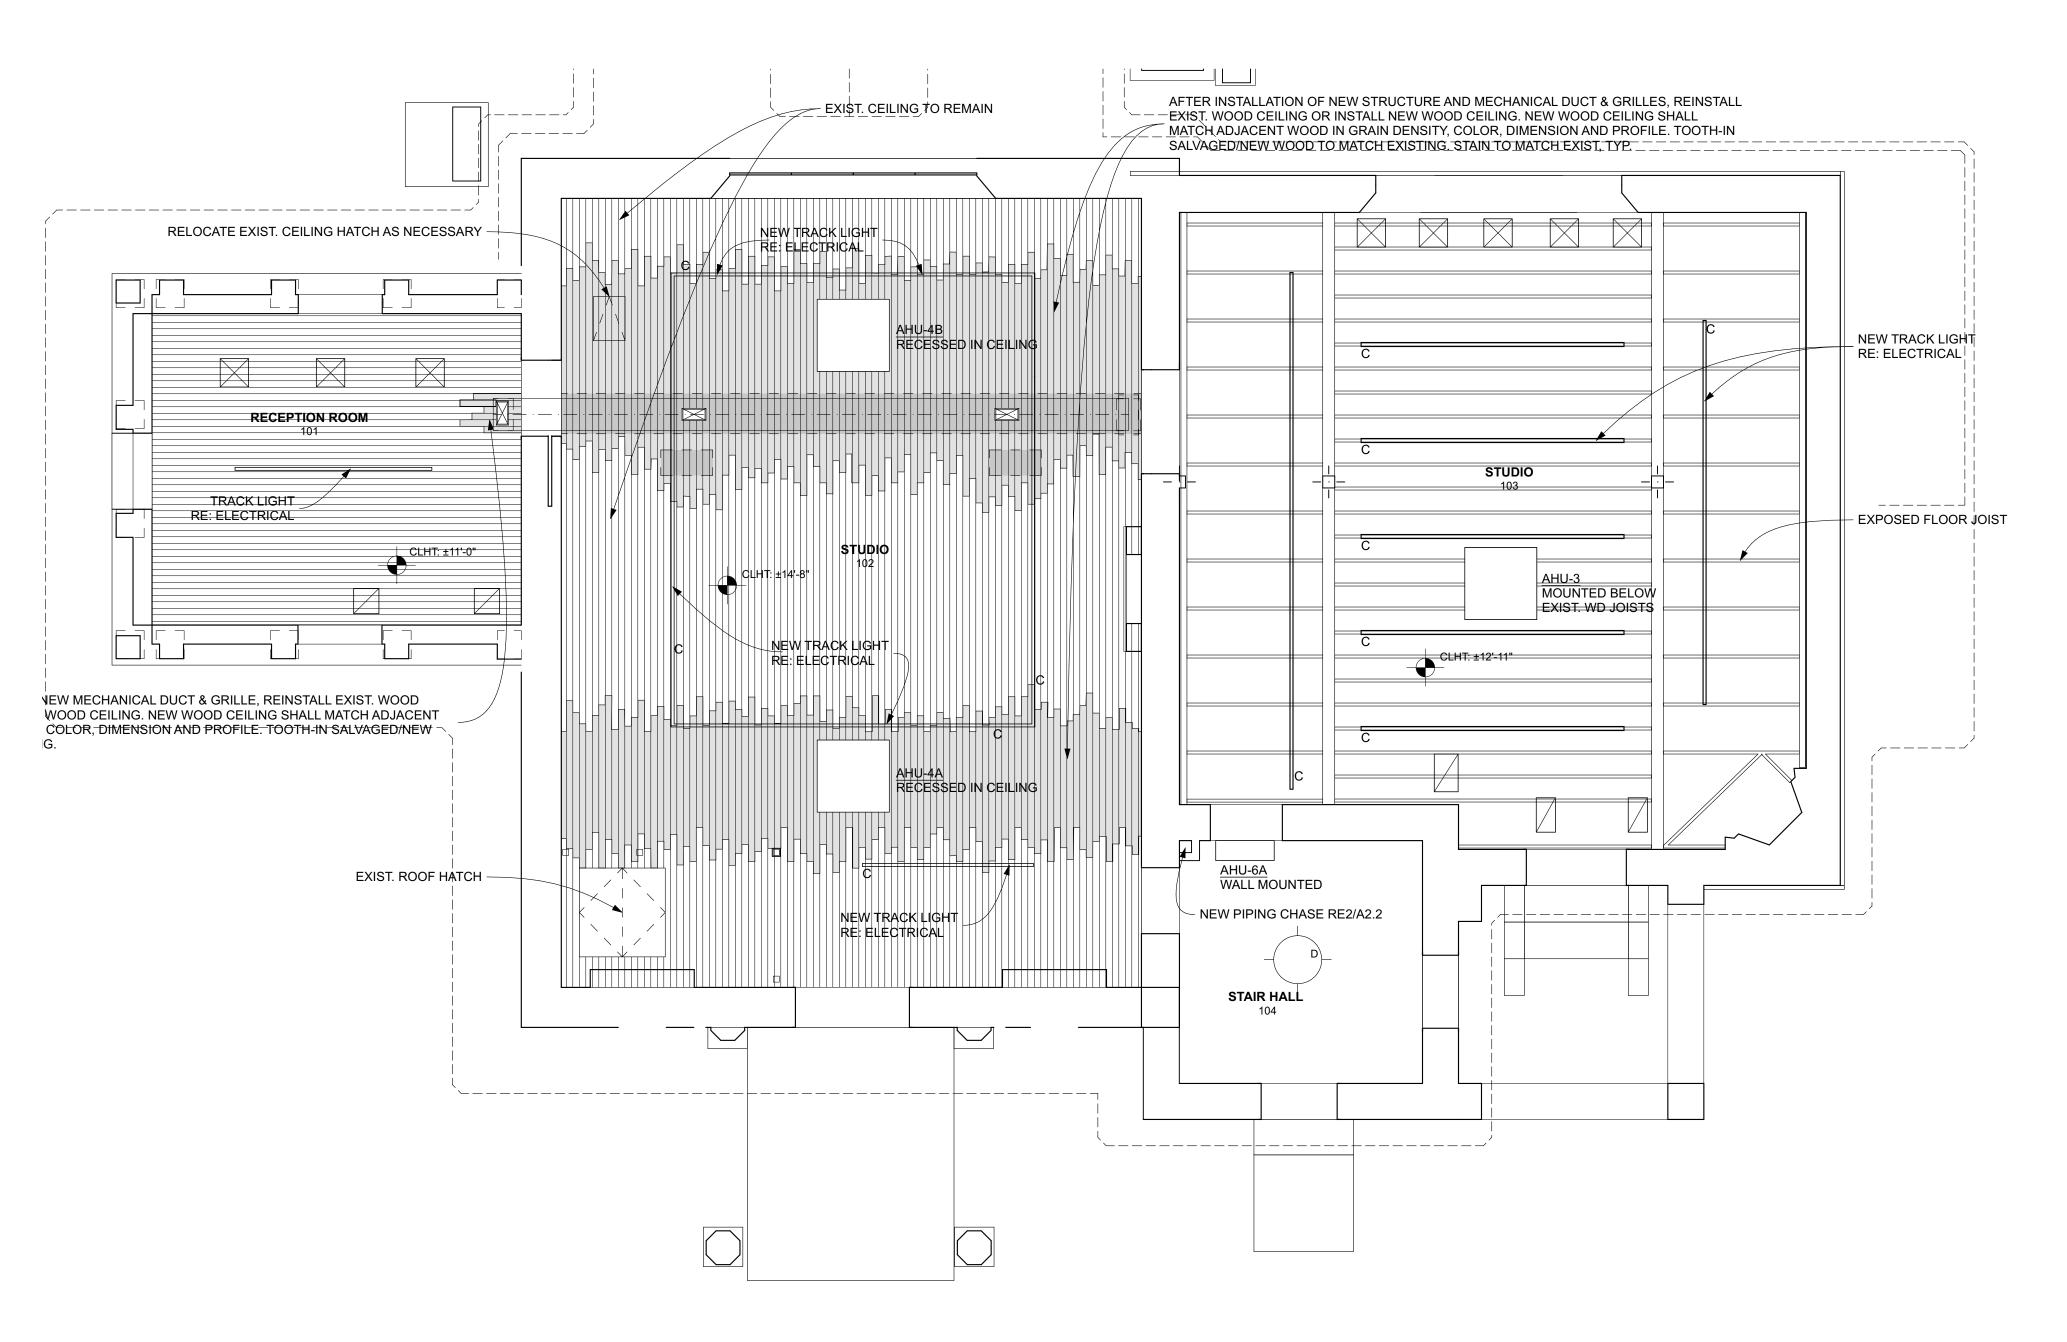

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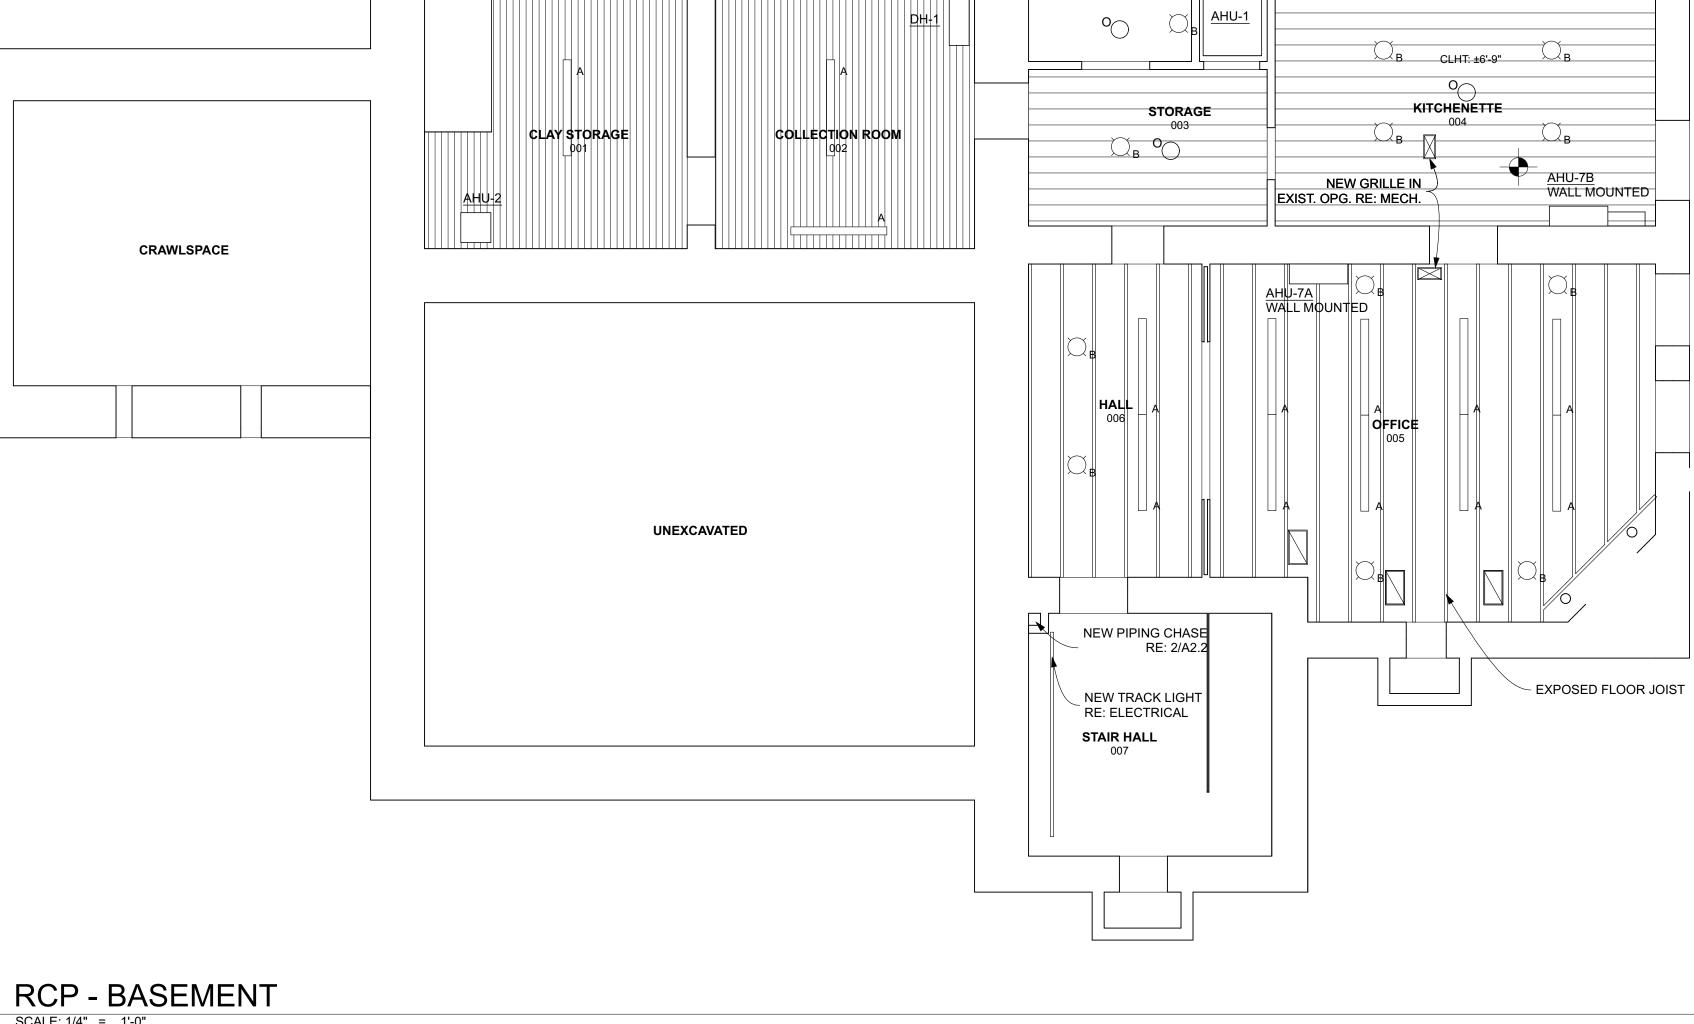
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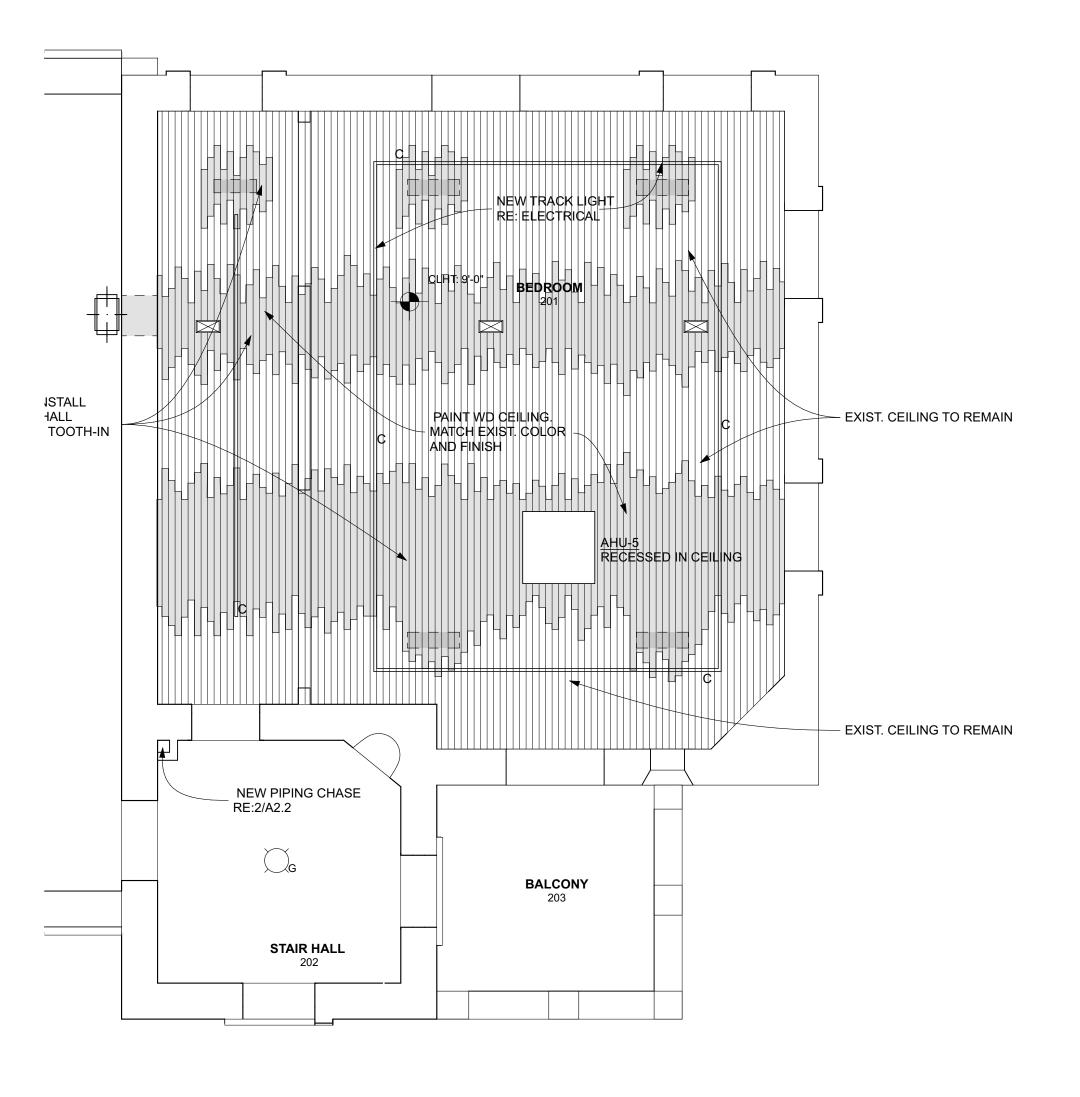
construction

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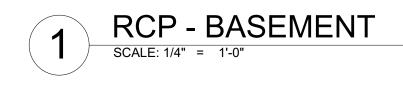
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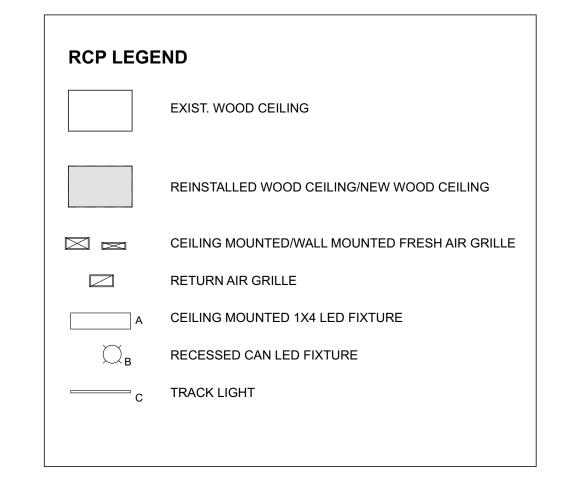





2 RCP - SECOND FLOOR

SCALE: 1/4" = 1'-0"





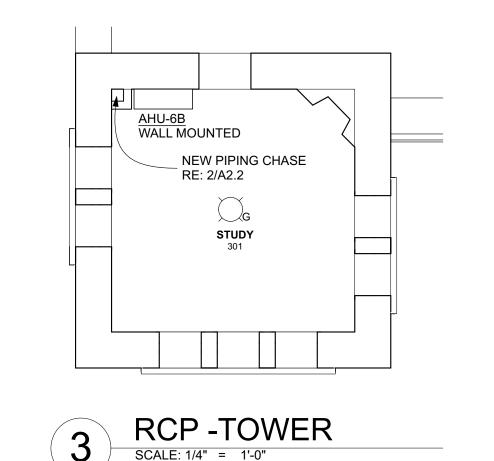

1 ROOF
SCALE: 1/4" = 1'-0"

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ROOF DEMOLITION PLAN

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Date: 5/21/21

A4.0

ROOF PLAN - ELISABET NEY MUSEUM

EXISTING ROOF MEMBRANE -

- INGULATION / COVER BD. TO MATCH EXIGT.

EXIST. INSULATION

EXIST. PLYWOOD DECK

ANCHOR TO DECK AT EA. CORNER

- MEMBRANE CAP SHEET

— 10 GA. GALV. STEEL PLATE

– MEMBRANE BASE PLY

#### GENERAL NOTES TO CONTRACTORS

- GENERAL NOTES:
- CONTRACTOR SHALL VERIFY FIELD DIMENSIONS.
- 2. FIELD MEAGUREMENTG ARE REQUIRED FOR BIDDING PURPOGES. 3. CONTRACTOR IS RESPONSIBLE FOR VERIFICATION OF EXISTING ROOFING SYSTEM.
- PROVIDE TAPERED CRICKETS ON HIGH SIDE OF CURBED PENETRATIONS AS REQ'D TO
- DIRECT DRAINAGE AROUND PENETRATION. P. CONTRACTOR SHALL FIELD VERIFY EXACT CRICKET SIZE AND PROFILE IN THE FIELD TO ENGURE POGITIVE DRAINAGE AROUND CURBED PENETRATIONG.
- CONTRACTOR SHALL VERIFY OPERATIONAL STATUS OF ROOF TOP EQUIPMENT W/OWNER PRIOR TO COMMENCING WITH THE WORK.
- ABANDONED EQUIPMENT AND CURBS SHALL BE REMOVED FROM THE BUILDING. AND DISPOSED OF. REPAIR DECKING AT ABANDONED PENETRATIONS (NOT SCHEDULED ON
- THE DRAWINGS FOR REMOVAL) PER UNIT PRICING, DETAILS AND SPECIFICATIONS. 8. LOCATION AND ROUTING OF PIPING / CONDUIT SHOWN ON ROOF PLAN IS
- SCHEMATIC. CONTRACTOR TO FIELD VERIFY LOCATION AND ROUNTING EQUIPMENT / PIPING SUPPORTS:

ROOF TOP EQUIPMENT / PENETRATIONS:

- APPROPRIATE PIPE SUPPORTS ARE DETERMINED BY OUTSIDE DIAMETER OF PIPING / CONDUIT. RE: SPECIFICATION SECTION 07 7200 FOR DESCRIPTIONS OF DESIGNED ROOF TOP PIPE SUPPORTS.
- a) TYPE "A" ADJUSTABLE HEIGHT PIPE SUPPORT RE: DETAIL 4/R2 6) TYPE "B" - ADJUSTABLE HEIGHT PIPE SUPPORT RE: DETAIL 5/R2 c) TYPE "C" - HANGING PIPE SUPPORT RE: DETAIL 6/R2
- P. PIPING OR CONDUIT INSTALLATION SHALL PROVIDE A MINIMUM CLEARANCE OF 12" ABOVE FINISHED ROOF SURFACE FOR SUPPORT TYPES "A", "B", "C".
- PAINTING: GCRAPE. PRIME AND PAINT GAS LINES PER SECTION 09 9100
- TRAFFIC PROTECTION:
- PROVIDE TRAFFIC PROTECTION PADS AT ROOF ACCESS POINTS AND ON ALL SIDES OF ROOF TOP UNITS.

#### KEYED NOTES TO CONTRACTOR

- (1) PROVIDE ELECTRICAL DISCONNECT RACK PER DETAIL 3/RI
- $\langle 2 \rangle$  PROVIDE ROOF TOP UNIT CURB PER DETAIL 1/R2
- (3) PROVIDE ENCLOGED CURB PER DETAIL 2/R2
- 4 PROVIDE DECK REPAIR PER DETAIL IA/RI OR IB/RI

5 PROVIDE WALL REPAIR PER DETAIL --/---

## SYMBOL LEGEND

SYMBOL	LABEL	DESCRIPTION	DETAIL	
	АВ	ABANDONED DUCT PENETRATION	1A/R1, 1B/R1	
	w	CONDENSING UNIT	2/R2	
	RTU	ROOF TOP UNIT	1/R2	
	C	CONDENSATE LINE		
	E	ELECTRICAL LINE	SECTION	
<b></b>	G	GAS LINE	07 7200	
<u>elope</u> →				
	NC	PT IN CONTRACT		
	TAPERED CRICKET		7/R2, &/R2	
		TRAFFIC PAD		

#### WARRANTY SCHEDULE

.,				
ROOF SECTION	MANUFACTURER	EXP. DATE	WARRANTY	
A01, A02, A03	SIPLAST	3/6/2033	<i>45186</i>	

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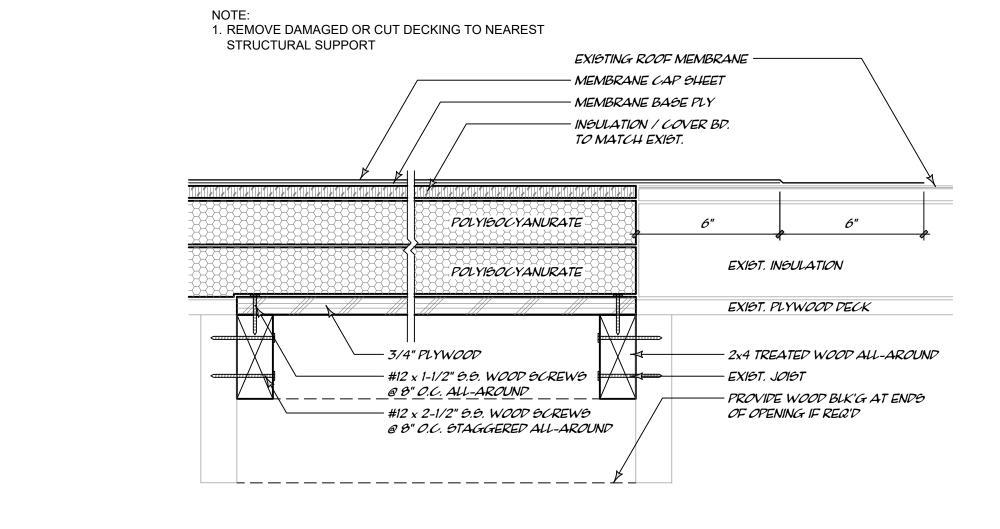
FPLAN, NOTES, EGENDS, AND I

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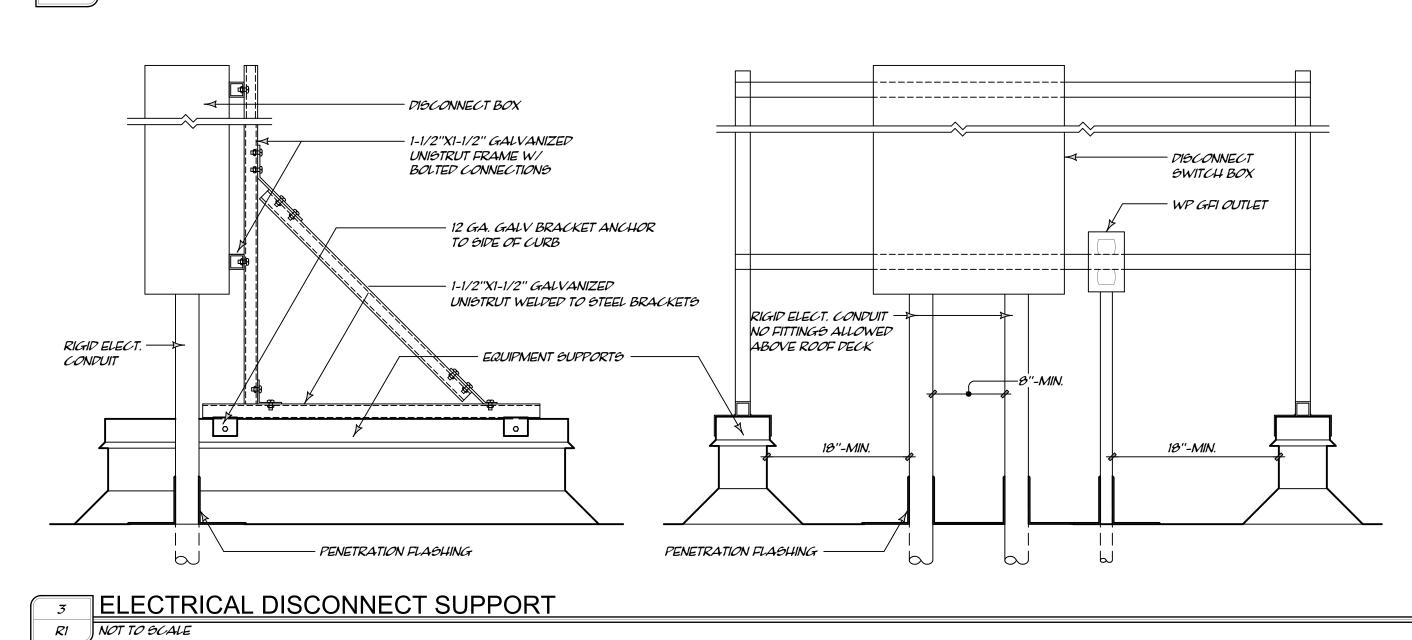
SMALL DECK REPAIR

LARGE DECK REPAIR

SMALL DECK REPAIR

12"-MAX.

PLAN NORTH



EXIST. PLYWOOD DECK

MULTIPLE CONDUIT W/ LESS THAN 8" CLEARANCE ALL SIDES

1. CONDUIT PENETRATING ROOFING ASSEMBLY SHALL BE RIGID CONDUIT. CONTRACTOR

2. CONDUIT SHALL BE ONE CONTINUOUS PIECE FROM UNDERSIDE OF DECK EXTENDING

3. MINIMUM 1" SPACE IS REQUIRED BETWEEN PENETRATIONS AND INTERIOR WALL OF

MIN. 6" ABOVE PENETRATION SEAL. ANCHOR TO DECK OR NEAREST STRUC. FRAMING AS

PENETRATION CURB AND BETWEEN MULTIPLE PENETRATIONS. REROUTE PENETRATIONS

- EXISTING RIGID PENETRATION REMOVE ASPHALTIC CONTAMINATES

INSTALLATION OF PENETRATION SEAL

PRIME PENETRATION W/ SEALANT

FROM PENETRATION PRIOR TO

- PRECAST PENETRATION CURB

OR SEALANT

- SEALANT BEADS

EXIST. INSULATION

SHALL REPLACE ALL FLEXIBLE OR DAMAGED PIPING W/ RIGID CONDUIT

AS REQUIRED TO PROVIDE MINIMUM 1" SPACING REQUIRED

REQ'D TO ELIMINATE MOVEMENT.

POURABLE -

SEALANT

PENETRATION FLASHING - REPAIR

3" = 1'-0"

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1. CONDUIT PENETRATING ROOFING ASSEMBLY SHALL BE RIGID CONDUIT. CONTRACTOR

2. CONDUIT SHALL BE ONE CONTINUOUS PIECE FROM UNDERSIDE OF DECK EXTENDING

MIN. 6" ABOVE PENETRATION SEAL. ANCHOR TO DECK OR NEAREST STRUC. FRAMING AS

- EXISTING OR NEW RIGID PENETRATION

REMOVE ASPHALTIC CONTAMINATES

- MONOLITHIC PMMA REGIN FLAGHING AG PRODUCED BY THE MEMBRANE

FROM PENETRATION PRIOR TO

MANUFACTURER

ROOF SYSTEM -

EXIST. INSULATION

CONDUIT W/ GREATER THAN 8" CLEARANCE ALL SIDES

EXIST. PLYWOOD DECK

INSTALLATION OF PENETRATION

SHALL REPLACE ALL FLEXIBLE OR DAMAGED PENETRATIONS W/ RIGID CONDUIT


REQ'D TO ELIMINATE MOVEMENT.

MIN.

3. MINIMUM 8" SPACE IS REQUIRED BETWEEN PENETRATIONS

Architect: Robert L. Raffle Texas License No. 24779

Date: 5/5/2021

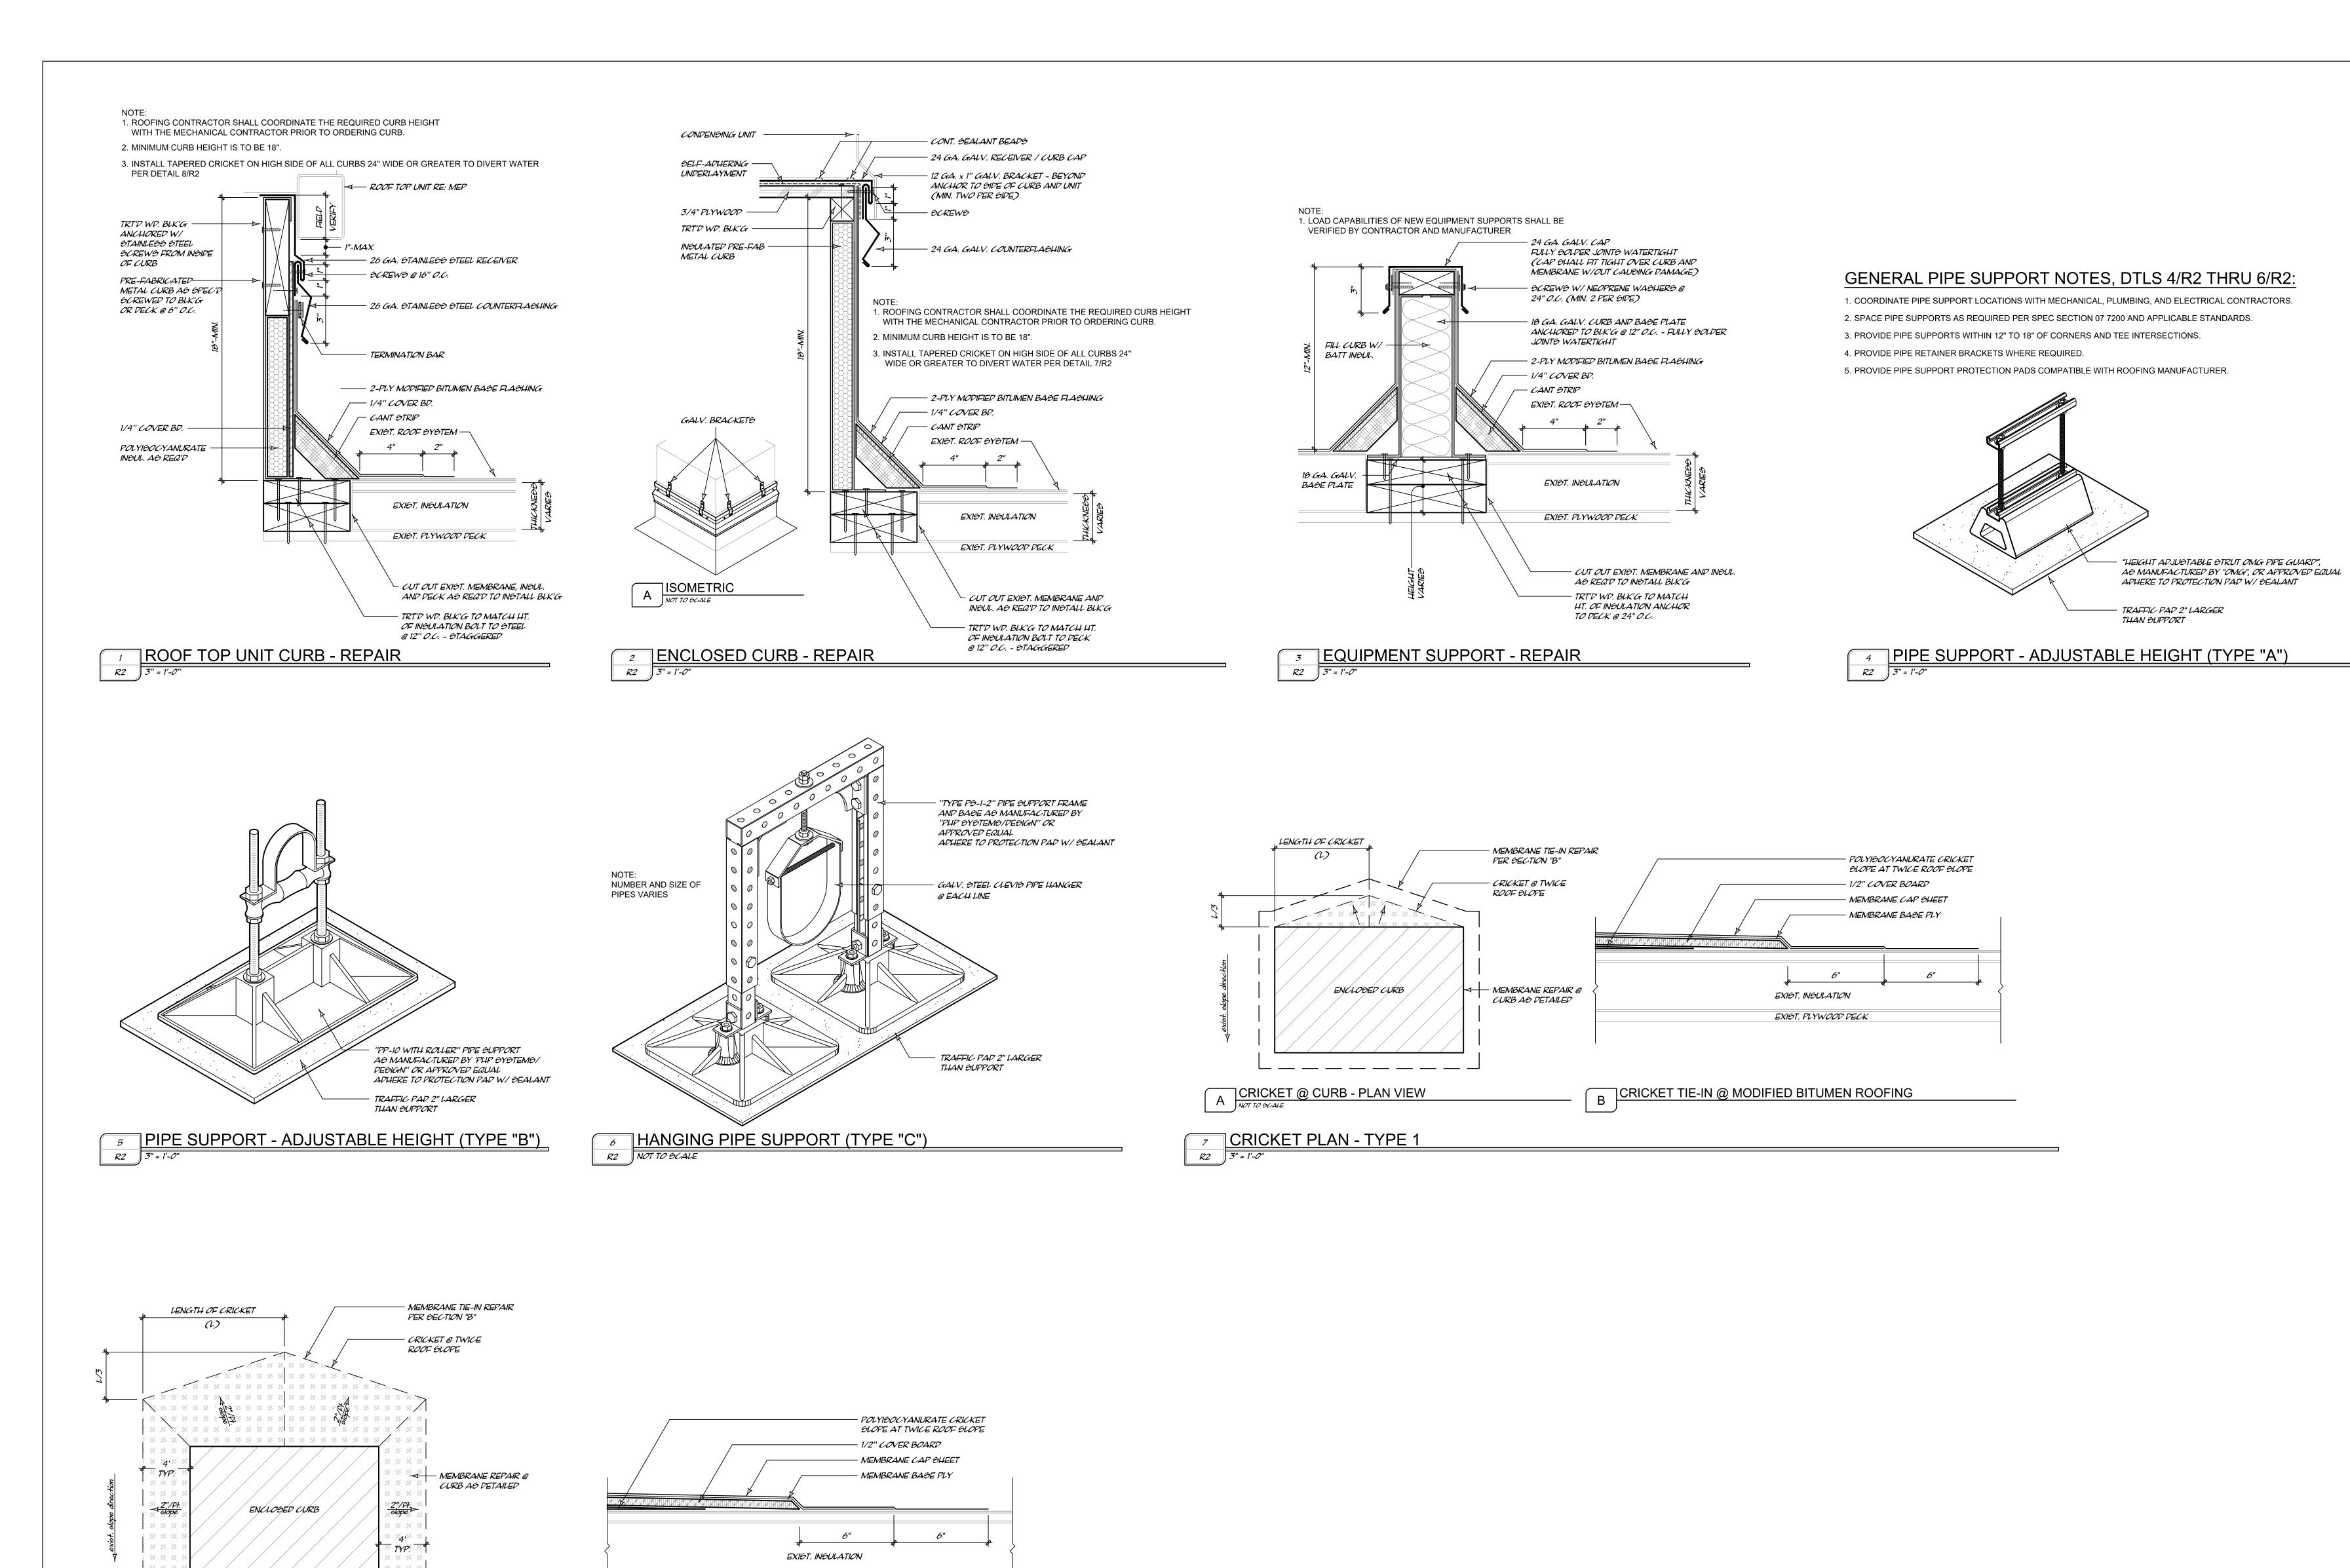

EXIST. PLYWOOD DECK

CRICKET TIE-IN @ MODIFIED BITUMEN ROOFING

A CRICKET @ CURB - PLAN VIEW

© CRICKET PLAN - TYPE 2

R2 3" = 1'-0"

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Building

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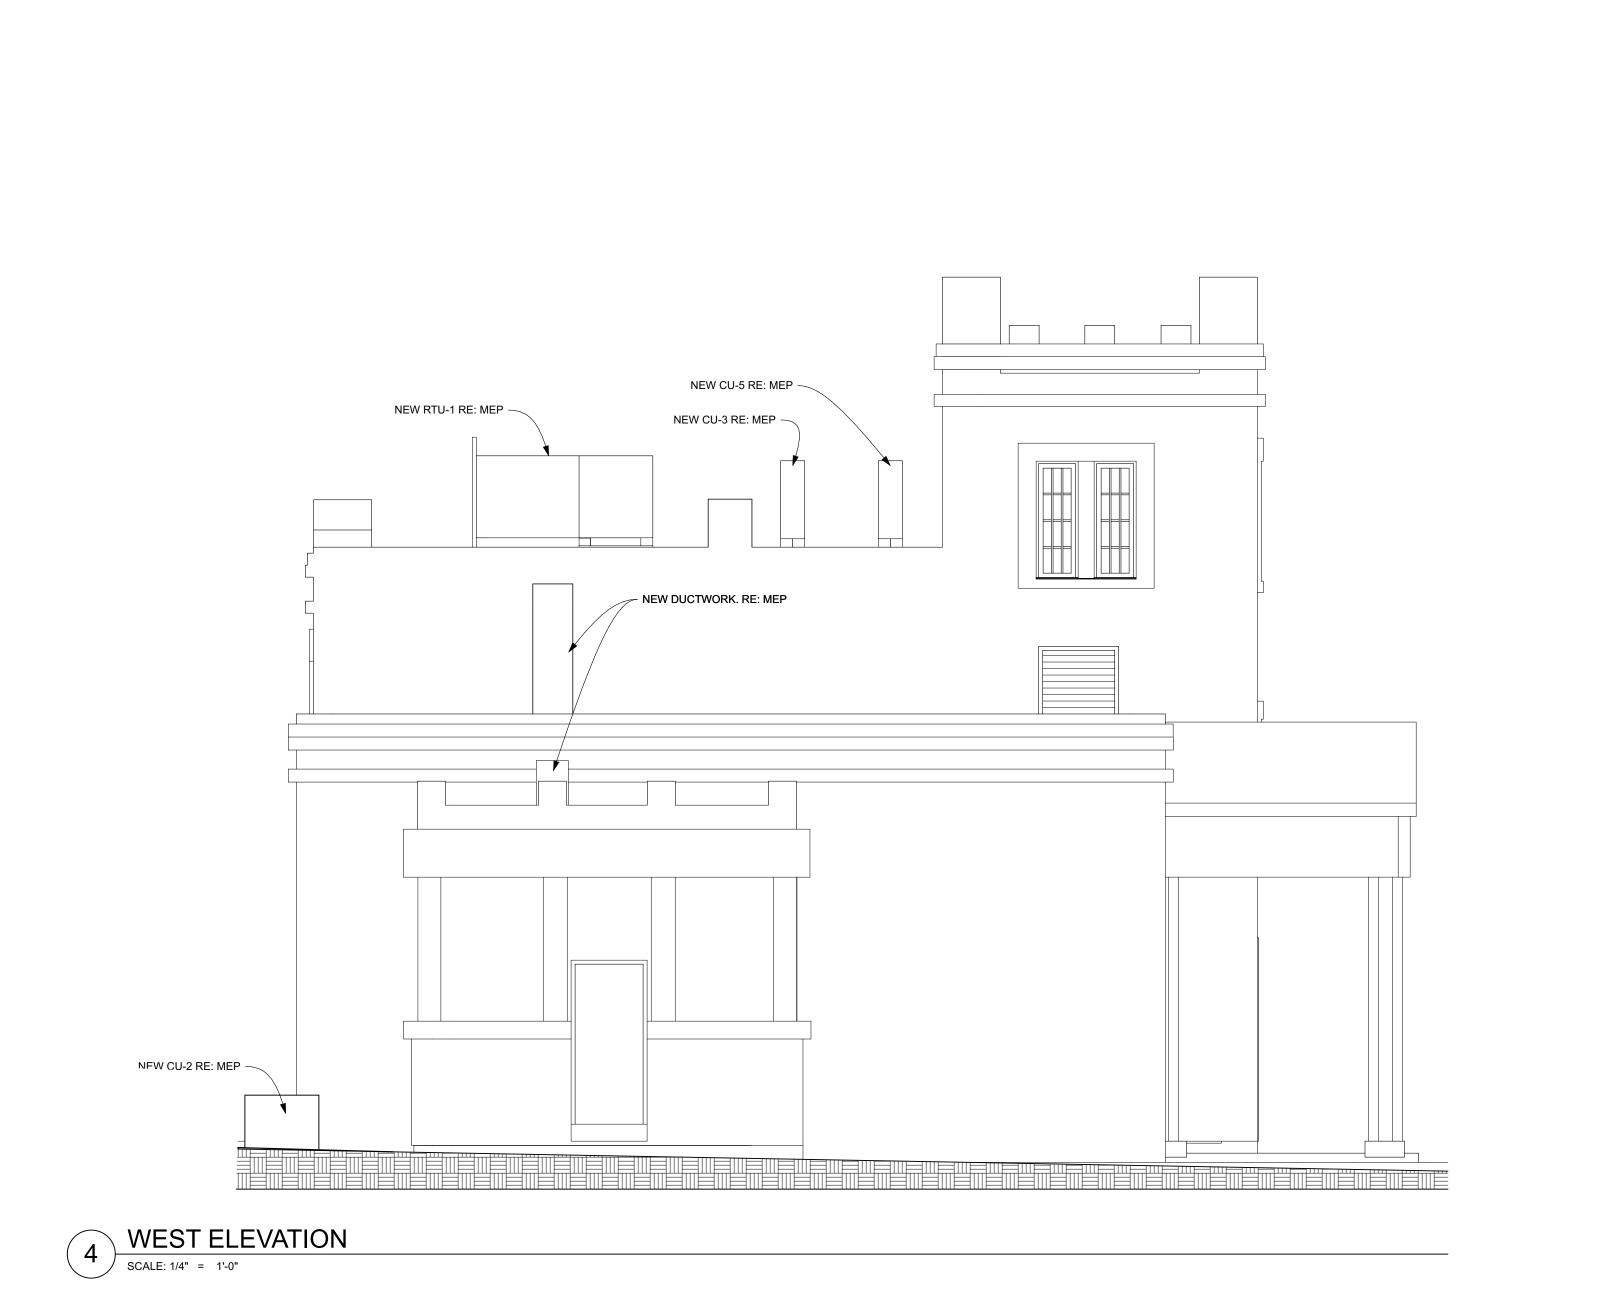
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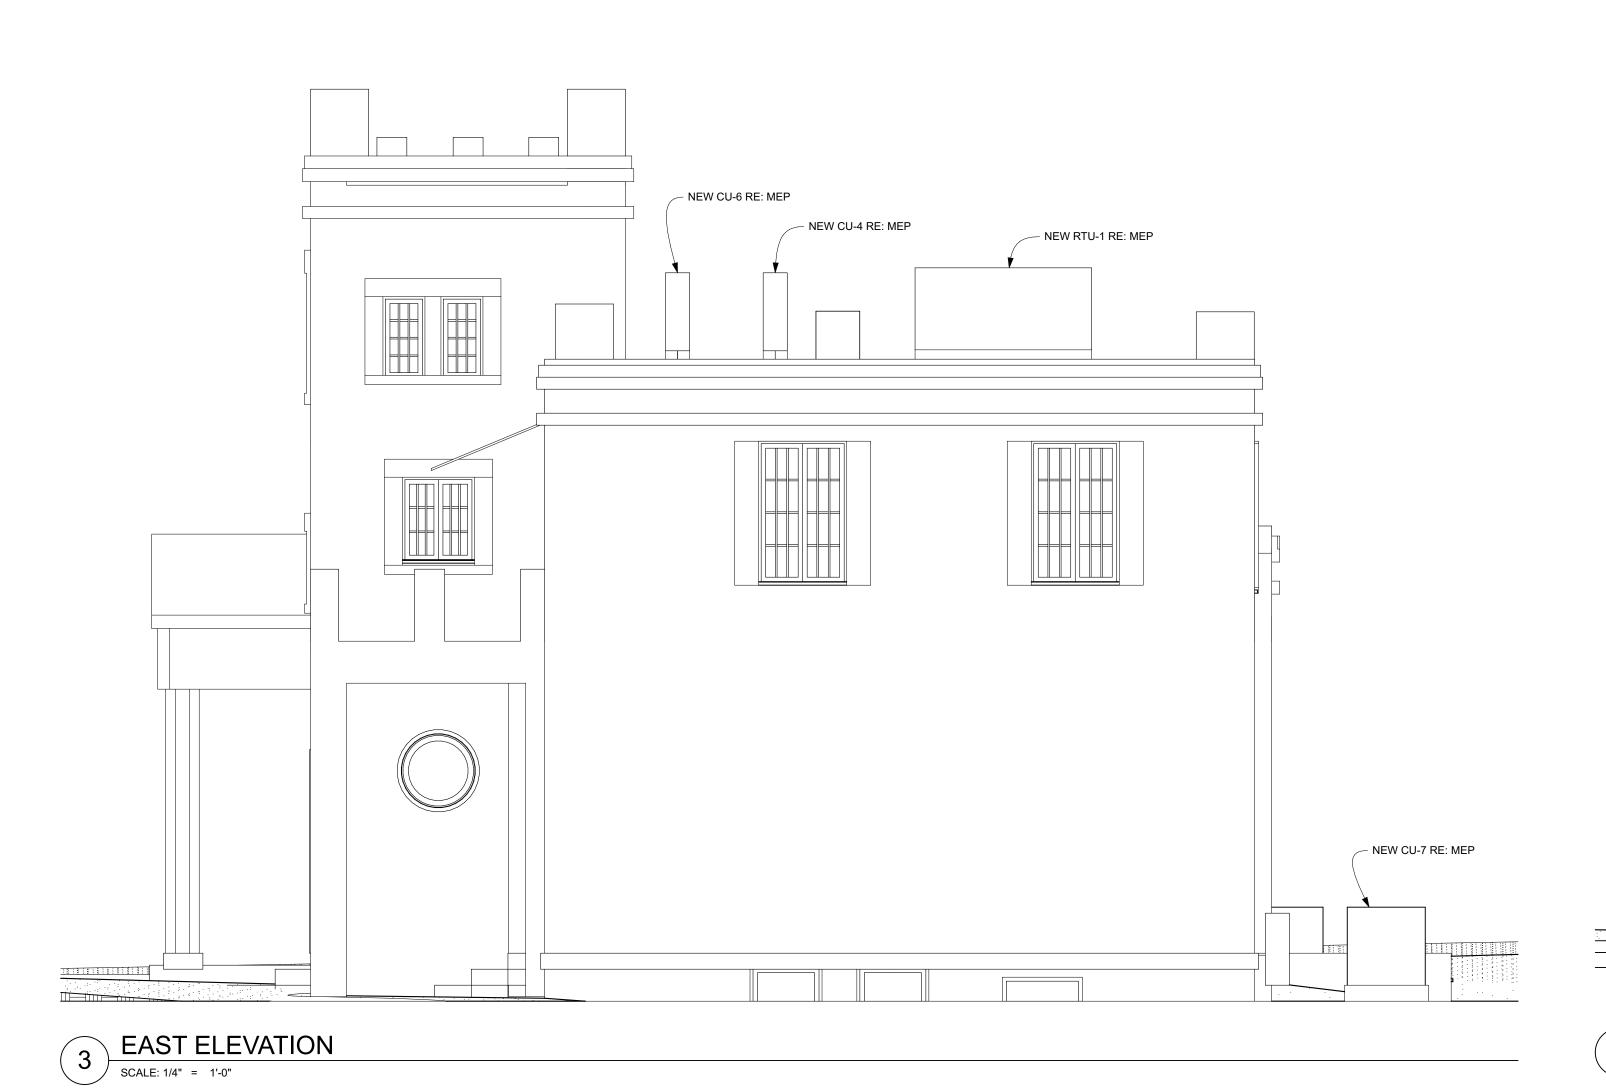
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Restoration and Lighting











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Ben Heimsath #13983
Date: 5/21/21

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Revisions No./Date/Remarks


Project #: 2019-930

Date: **5/21/21** 

Sheet Number

N-S BUILDING SECTION

SCALE: 1/4" = 1'-0"

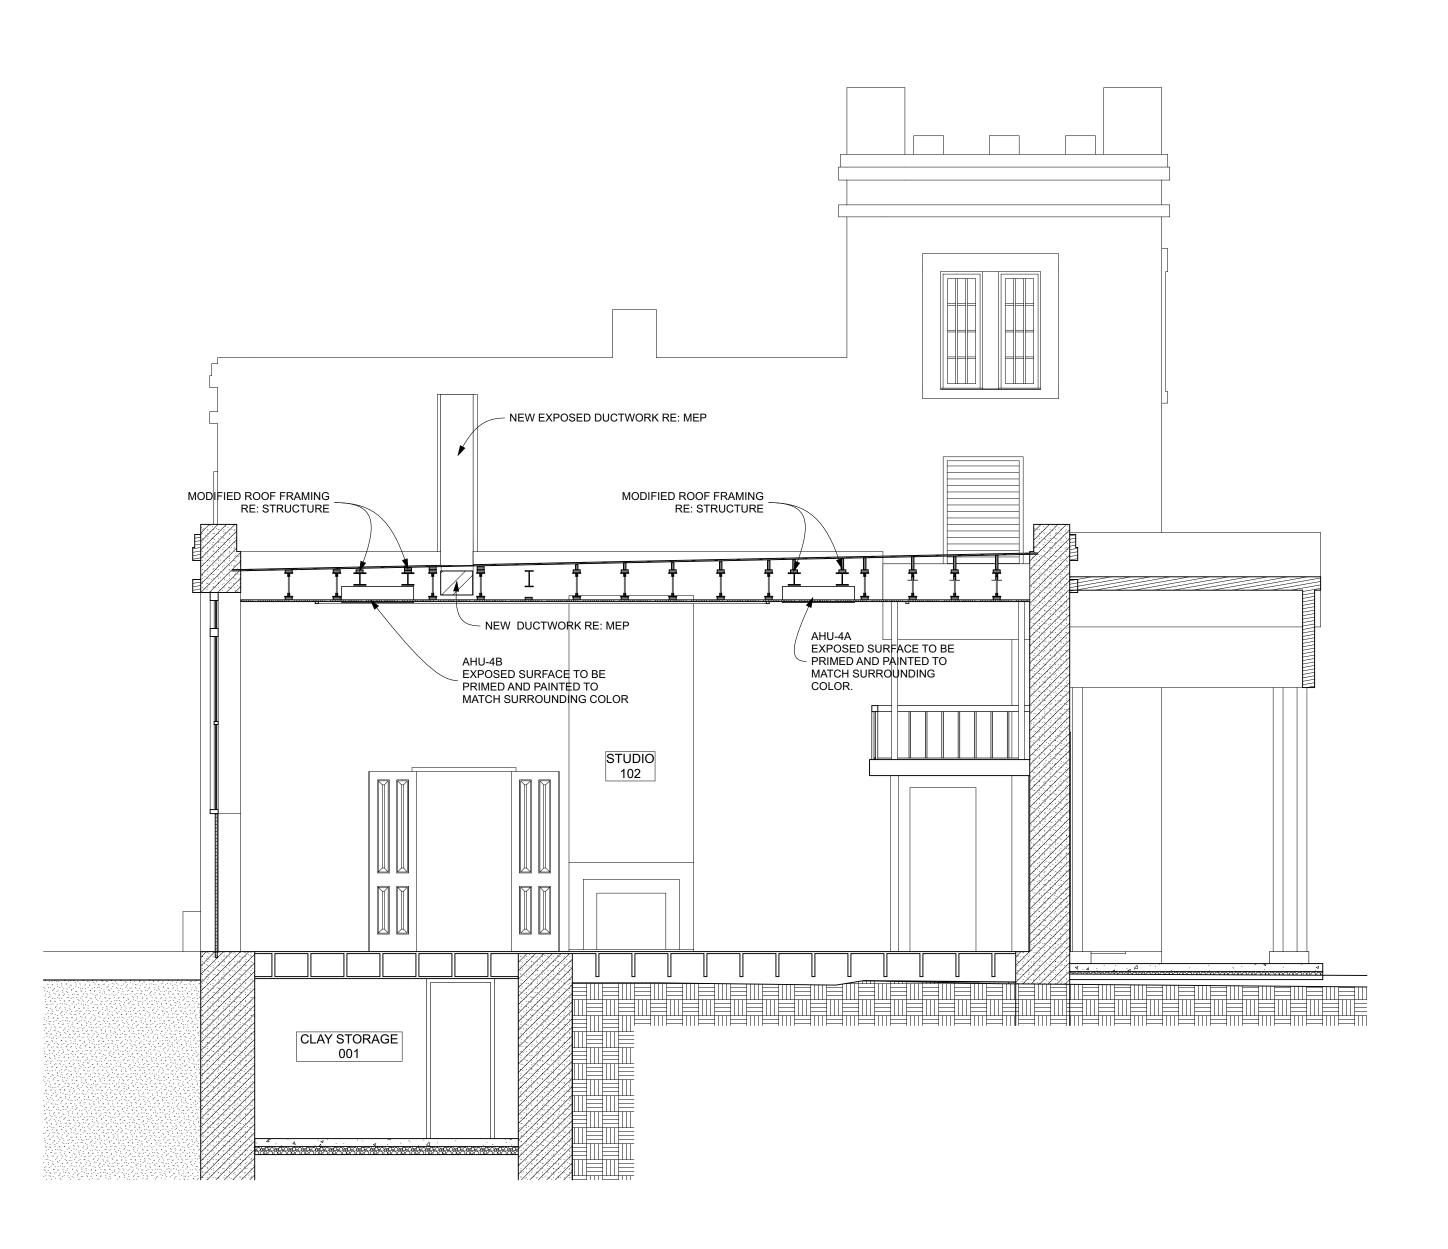

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SCALE: 1/4" = 1'-0"

Elisabet Ney Museum Building Restoration & Site Improvements - HVAC and Lighting 304 E 44th St., Austin, TX 78751

7509 Manchaca Rd. Bldg 4 Austin, Texas

78745

Tel. (512) 478-1621 www.heimsath.com

Architect / Registration:
Ben Heimsath #13983

Date: 5/21/21

Not for regulatory approval, permitting, or construction

60% CONSTRUCTION
DOCUMENTS

NG SECTIONS

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