


Elisabet Ney Museum Building Restoration and Site Improvements

Local Historic Districts



Hyde Park Local Historic District



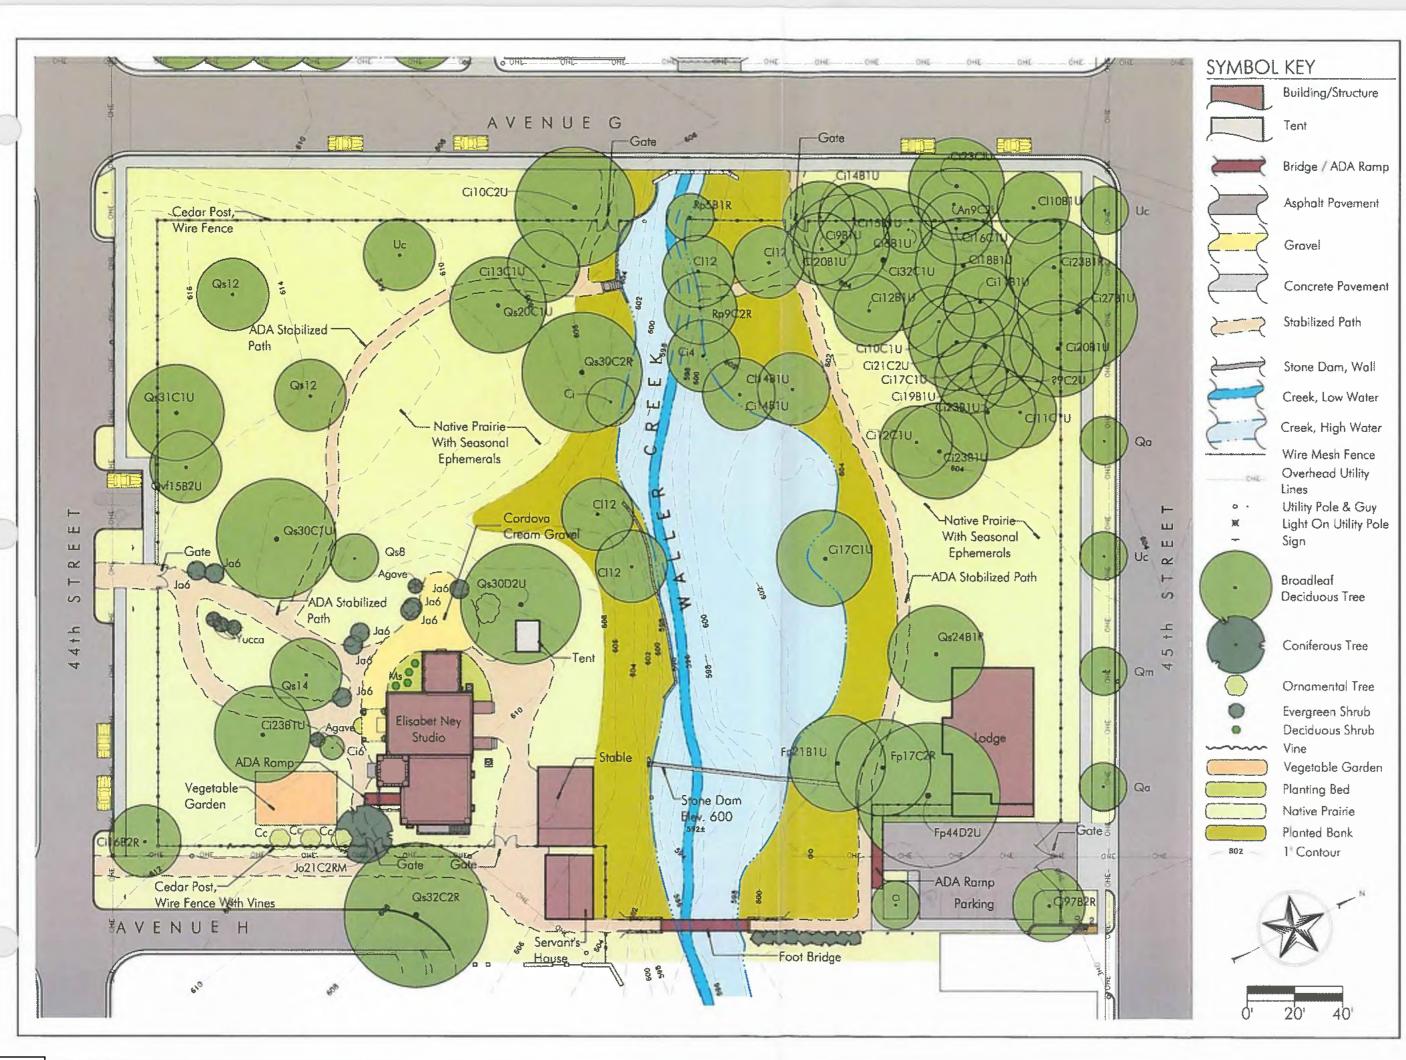



/ Museum Restoration Master Plan

Elisabet Ney Museum
Comprehensive Restoration Name Restoration Name Restoration Plan

Heritage Landscapes
Passivation Landscape Architects & Planner
Charlotte, VT 05445



Drawing Title

LANDSCAPE RESTORATION PLAN

Date: 2007

Drawing Number










Page 5

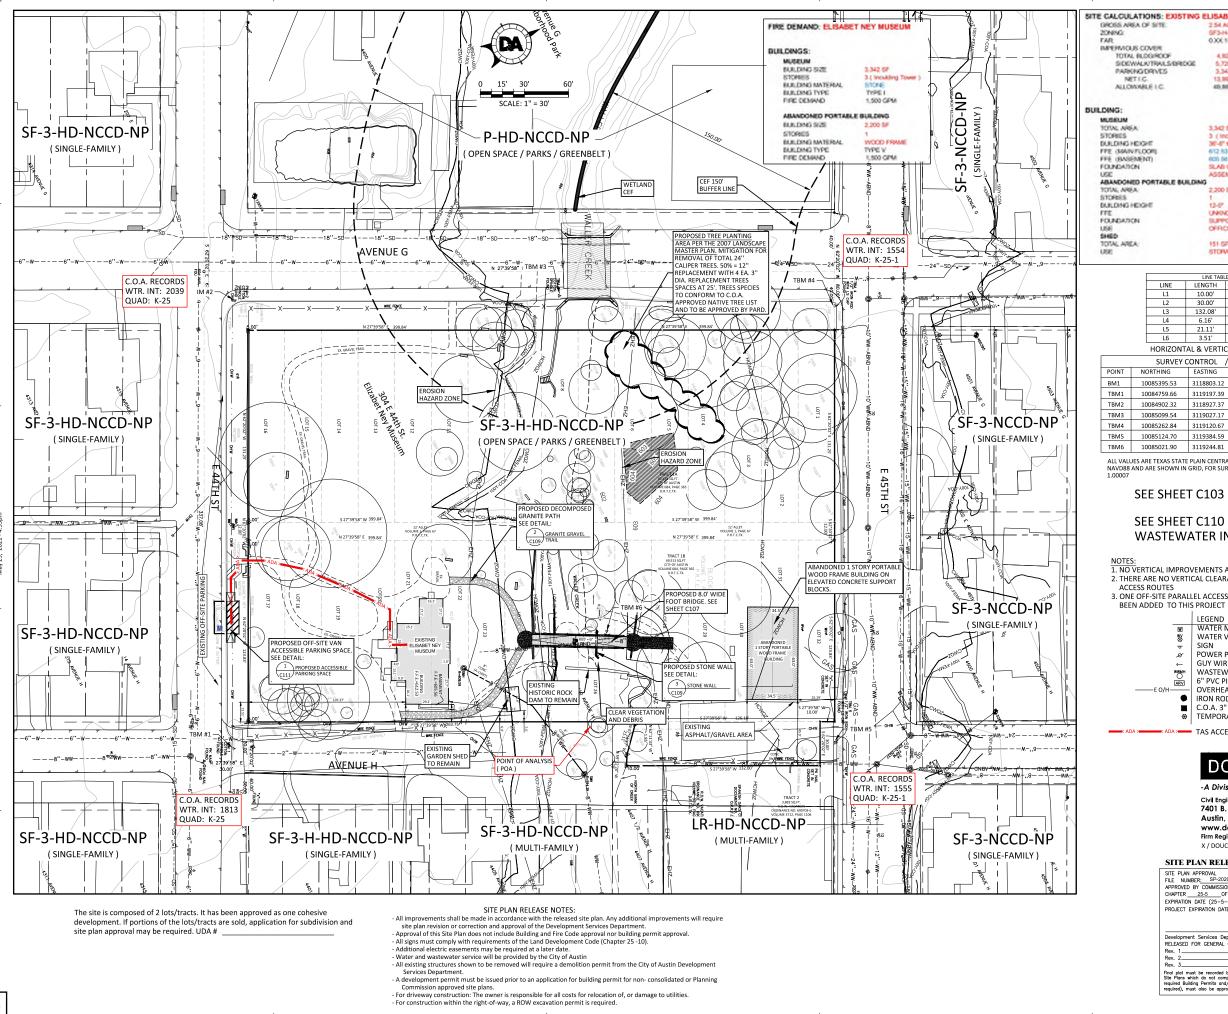

SITE CALCULATIONS: EXISTING ELISABET NEY MUSEUM GROSS AREA OF SITE: 2.54 AC 110.1 0.000.5 PROPOSED TOTAL BLOGROOF SIDEWALK/TRALS/BROGE PARKHG/DRVES 4,826 SF 0.11 AC 4.45% 5,726.00 0.13 AC 5.17% 3,343.00 0.09 AC 3.02% 13,907 SF 0.32 AC 12,63% ALLOWWIE I C. 49.860 SF 1.14 AC 3,342 SF 5 (Including Tower) 36'-6" to top of Tower Parapet 612.63 SLAB ON GRADE ASSEMBLY A3 (MUSEUM ABANDONED PORTABLE BUILDING MEP UNKNOWN SUPPORT BLOCKS OFFICE Structural

> 10.00' S 28°02'29" W 132.08' S 28°02'29" W 6.16' L5 21.11' N 47°14'37" W L6 3.51' N 62°08'22" W HORIZONTAL & VERTICAL CONTROL GRID

STORAGE

	SURVEY C	CONTROL /	BENCH MAI	RKS
POINT	NORTHING	EASTING	ELEVATION	DESCRIPTION
BM1	10085395.53	3118803.12	608.99	C.O.A. 3" BRASS DISK
TBM1	10084759.66	3119197.39	612.04	COTTON SPINDLE SET
TBM2	10084902.32	3118927.37	613.00	COTTON SPINDLE SET
ТВМЗ	10085099.54	3119027.17	606.05	COTTON SPINDLE SET
TBM4	10085262.84	3119120.67	606.17	1/2" IRON W/LS CAP
TBM5	10085124.70	3119384.59	603.05	1/2" IRON W/LS CAP
TBM6	10085021.90	3119244.81	601.52	80d NAIL SET

ALL VALUES ARE TEXAS STATE PLAIN CENTRAL ZONE NAD83, VERTICAL DATUM IS IN NAVD88 AND ARE SHOWN IN GRID, FOR SURFACE VALUES, USE SCALE FACTER: 1.00007

SEE SHEET C103 FOR TREE LIST

SEE SHEET C110 FOR WATER AND WASTEWATER INFORMATION

- NOTES: 1. NO VERTICAL IMPROVEMENTS ARE PLANNED WITHIN THE RIGHT OF WAY 2. THERE ARE NO VERTICAL CLEARANCE ISSUES WITHIN FIRE DEPARTMENT
- ACCESS ROUTES

 3. ONE OFF-SITE PARALLEL ACCESSIBLE PARKING SPACE ON 44TH. STREET HAS

LEGEND WATER METER WATER VALVE SIGN POWER POLE **GUY WIRE** WASTEWATER MANHOLE 6" PVC PIPE OVERHEAD ELECTRIC IRON ROD FOUND TEMPORARY BENCH MARKS FOR PROJECT

> TAS ACCESSIBLE ROUTE DOUCET+ CHAN

-A Division of Doucet & Associates, Inc.-

Civil Engineering - Planning - Geospatial 7401 B. Highway 71 W, Suite 160 Austin, Texas 78735, Phone: (512)-583-2600 www.doucetengineers.com Firm Registration Number: 3937 X / DOUCET / 1600-012

SITE PLAN RELEASE

FILE NUMBER: SP-2002-027FD APPLICATION DATE: JULY 2, 2022 APPROVED BY COMMISSION ON UNDER SECTION 112 CHAPTER 25-5 OF THE CITY OF AUSTIN CODE. EXPIRATION DATE (25-5-81, LDC) CASE MMAGGER AND DeSail PROJECT EXPIRATION DATE (ORD. ₱979005)DWP2DD2	SITE PLAN APPROVAL	SHEET 9 OF 1
CHAPTER 25-5 OF THE CITY OF AUSTIN CODE. EXPIRATION DATE (25-5-81, LDC)CASE MANAGER Ann DeSai	FILE NUMBER: SP-2020-0276D	APPLICATION DATE: JULY 2, 2020
EXPIRATION DATE (25-5-81, LDC)CASE MANAGER Ann DeSai	APPROVED BY COMMISSION ON	UNDER SECTION 112
	CHAPTER 25-5 OF THE CITY OF	AUSTIN CODE.
	EXPIRATION DATE (25-5-81, LDC)	CASE MANAGER Ann DeSar
, , , , , , , , , , , , , , , , , , , ,		
	, ,	
Development Services Department	Development Services Department	
Development Services Department RELEASED FOR GENERAL COMPLIANCE: ZONING ZONING	Development Services Department RELEASED FOR GENERAL COMPLIANCE:	ZONINGZONING
RELEASED FOR GENERAL COMPLIANCE:ZONINGZONING	RELEASED FOR GENERAL COMPLIANCE:	ZONING ZONING

Final plat must be recorded by the Project Expiration Date, if applicable. Subsequer Site Plans which do not comply with the Code current at the time of filing, and all required Building Permits and/or a notice of construction (if a building permit is not required), must also be approved prior to the Project Expiration Date. SP-2020-0276D

LAWRENCE GROUP

Austin New York St. Loui Office: 900 E. 6th St., Suite 105 Austin, TX 78702 p 512.391.1932 f 512.391.1920

O'Connell Architecture 1405 W. 10th Street Austin, TX 78703 p. 512.751.1374 Tere O'Connell

Jose I. Guerra, Inc. 2401 S. IH 35 Austin, TX 78741 p. 512.445.2090 Debra Sharpe

Debra Sharpe Structures 6926 N. Lamar Blvd. Austin, TX 78752 p. 512,499,0919 Dante Angelini Doucet & Associates 7401 TX-71 West, Ste 160 Austin, TX 78735 p. 512,583,2623 Tom Curran



5/25/2021

Project Title:

Museum

Ney Elisabet

St. Austin, TX 78751


BUILDING RESTORATION & SITE IMPROVMENTS 304

This drawing and details on it are the sole property


2 000 inplies.	

SITE PLAN

Page 6

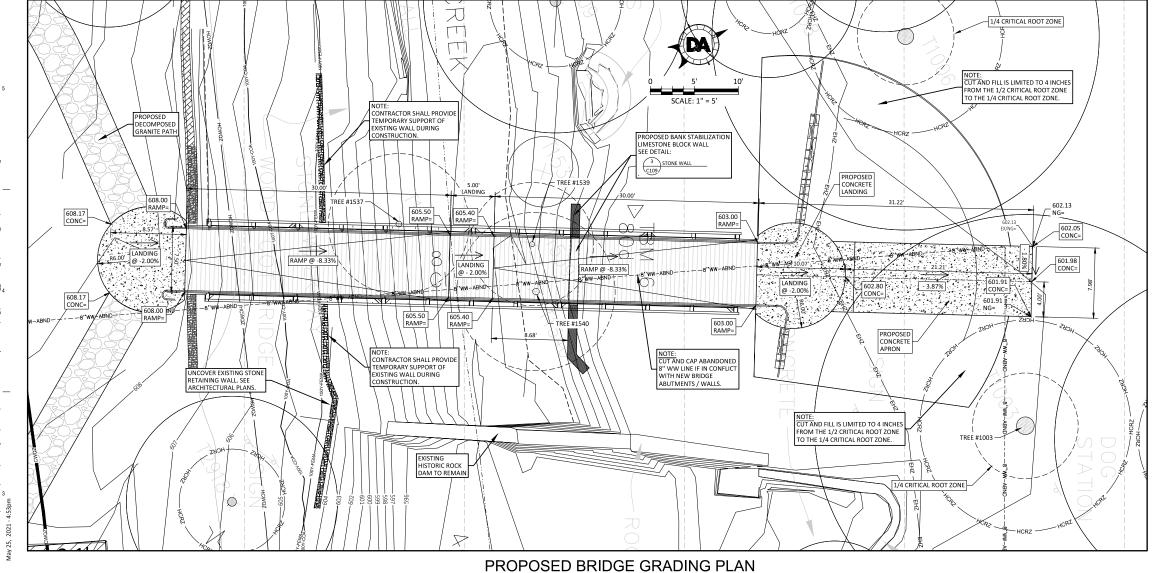

SCALE: 1" = 5'

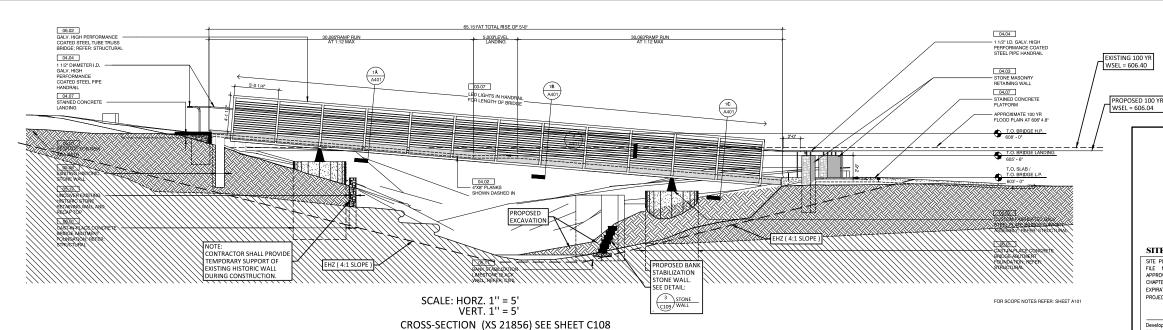

PROPOSED BRIDGE SECTION

SCALE: 1" = 5'

LAWRENCE GROUP PROPOSED CURB PROPOSED LAYDOWN CUF

GRADING LEGEND — EXISTING R.O.W./PROPERTY LINE EXISTING EASEMENT LINE EXISTING PAVEMENT

X DETAIL

EX. CONTOURS 493 PROP. CONTOURS EX. STORM DRAIN —— SD—— PROP. STORM DRAII

EX. STORM DRAIN INLET PROP. STORM DRAIN WITH LATERAL PROP. STORM DRAIN INLET WITH LATERAL

PROPOSED FINISH FLOOR ELEVATION SW= 493.00 PROPOSED TOP OF SIDEWALK

493.00 PROPOSED FINISH TOP 1.00% (SLOPE DOWN)

_ G.B._ OR _GRADE BREAK _ PROPOSED GRADE BREAK ON SURFACE (CNC., PVMT., GRASS, ETC.)

NOTE: FINISHED GROUND (FG=) SPOT ELEVATION CALLOUTS INDICATE THE ELEVATION OF FINAL GRADING INCLUDING THE INSTALLATION OF GRASS AND/OR REVEGETATION. IF THE CONTRACTOR INSTALLS GRASS SOD AND / OR TOP SOIL. THE THICKNESS OF THE MATERIAL SHOULD BE SUBTRACTED FROM THE FINISHED GROUND ELEVATIONS CALLOUTS.

NOTE: CONTRACTOR SHALL CONSTRUCT ALL TAS ACCESSIBLE ROUTES SIDEWALK, RAMP AND DRIVEWAY CROSSING GRADES AND DIMENSIONS IN ACCORDANCE WITH THE TEXAS ACCESSIBLITY STANDARDS, ARCHITECTURAL BARRIERS GOVERNMENT CODE, ARCHITECTURAL BARRIERS AGNINISTRATURY RULES AND TECHNICAL MEMOGRANDUM,

BARRIERS ADMINISTRATIVE RULES AND TECHNICAL MEMORANDUM, LATEST EDITION. THE GRADES SHOWN ON THESE DRAWINGS WERE ESTABLISHED USING THE BEST AVAILABLE EXISTING GROUND INFORMATION AND ARE FOR GENERAL CONSTRUCTION AND BIDDING PURPOSES ONLY, CONTRACTOR SHALL ADJUST GRADES AND DIMENSIONS TO FIELD CONDITIONS AND TO COMPLY WITH TEXAS ACCESSIBILITY STANDARDS.

---SPILL ----SPILL -- DENOTES THE CURB & GUTTER SHALL BE A SPILL CURB.

EXISTING GROUND X= 493.00 PAV=

DETAIL CALLOUT REFERENCE

×100) EXISTING TREE (TO BE REMOVED)

HOPOSED TOP TC= OF CURB

Y=−−493.00 PROPOSED TOP TW= OF WALL

→ 493.00 PROPOSED FLOW LINE

ELEVATION

SHEET NUMBER XX NAME

DETAIL NUMBER -X / XX

493.00 PROPOSED FINISH RAMP= RAMP GRADE

SHEET NUMBER ----

Austin New York St. Louis Office: 900 E. 6th St., Suite 105 Austin, TX 78702 p 512.391.1932 f 512.391.1920

O'Connell Architecture 1405 W. 10th Street Austin, TX 78703 p. 512.751.1374 Tere O'Connell

Jose I. Guerra, Inc. 2401 S. IH 35 Austin, TX 78741 p. 512.445.2090 Debra Sharpe Structural

Debra Sharpe Structures 6926 N. Lamar Blvd. Austin, TX 78752 p. 512,499,0919 Dante Angelini Doucet & Associates 7401 TX-71 West, Ste 160 Austin, TX 78735 p. 512,583,2623 Tom Curran Civil

MEP



5/25/2021

Project Title:

BUILDING RESTORATION & SITE IMPROVMENTS Elisabet Ney

304

44th St.,

This drawing and details on it are the sole property of the architect and may be used for this specific project only. It shall not be loaned, copied or reproduced, in whole or part, or for any other purpose or project without the written consent of the architect.

No.	Description	Date

BRIDGE GRADING PLAN

Final plat must be recorded by the Project Expiration Date, if applicable. Subsequent Site Plans which do not comply with the Code current at the time of filing, and all required Bullding Permits and/or a notice of construction (if a building permit is not required), must also be approved prior to the Project Expiration Date.

Page 7

SP-2020-0276D

Civil Engineering - Planning - Geospatial 7401 B. Highway 71 W, Suite 160 Austin, Texas 78735, Phone: (512)-583-2600 www.doucetengineers.com

Firm Registration Number: 3937


DOUCET+CHAN


-A Division of Doucet & Associates, Inc.-

X / DOUCET / 1600-012


FILE NUMBER: SP-2020-0276D APPLICATION DATA APPROVED BY COMMISSION ON UNDER SECTION.	
	TION 112
CHAPTER 25-5 OF THE CITY OF AUSTIN CODE.	A D-0
EXPIRATION DATE (25-5-81, LDC)CASE MAN	
PROJECT EXPIRATION DATE (ORD.#970905)DWPZ	DDZ



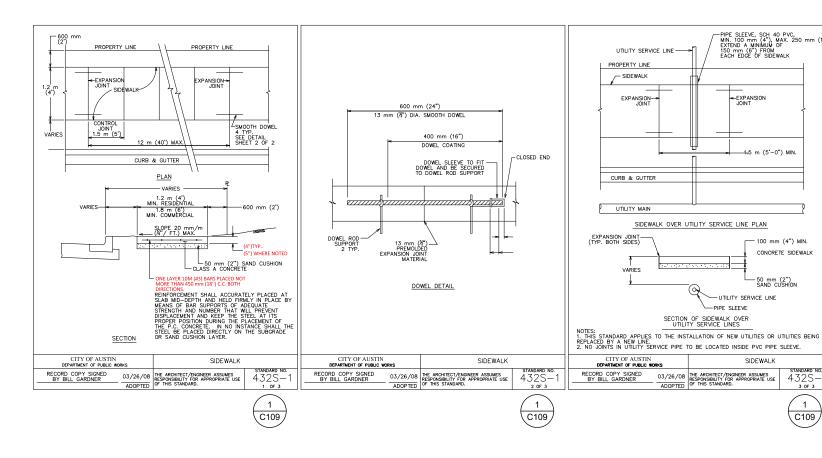

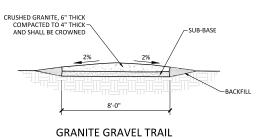

Not To Scale

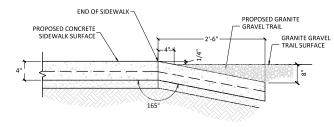

GRANITE GRAVEL AT CONCRETE TRANSITION

Not To Scale



PART 1 - GENERAL

A. FURNISH AND INSTALL GRANITE GRAVEL PAVING AS SHOWN

B. RELATED WORK SPECIFIED ELSEWHERE

- 1. SERIES 400 CONCRETE STRUCTURES AND MISC. CONCRETE 2. SERIES 100 - EARTHWORK
 3. SERIES 210 - FLEXIBLE BASE
 4. SECTION 02760 - SITE FURNISHING
 5. SECTION 13122 - RUBBERIZED SAFETY SURFACE
 6. SECTION 13121 - PEA GRAVEL

PART 2 - PRODUCTS

2.01 MATERIALS

DECOMPOSED UNWASHED GRANITE AGGREGATE AND RED CLAY FINES. A. THE WEARING MATERIALS SHALL BE COMPRISED OF 6" STABILIZER

B. THE GRANITE SHALL MEET THE FOLLOWING GRADATION:

RETAINED ON 5/8" SIEVE - 0% RETAINED ON 3/8" SIEVE - 15% TO 25% RETAINED ON #4 SIEVE - 40% TO 55% RETAINED ON #10 SIEVE - 20% TO 35%

C. THE SUBBASE MATERIAL SHALL BE 6" RED ROAD BASE

D. SUBMIT SAMPLE TO OWNER'S REPRESENTATIVE FOR APPROVAL PRIOR TO ACCEPTANCE.

PART 3 - EXECUTION 3.01 INSTALLATION


1. PERFORM ALL WORK IN ACCORDANCE WITH DRAWINGS.
2. PROTECT EXISTING TREES, PROPERTY AND PUBLIC RIGHT-OF-WAYS FROM DAMAGE BY TRUCKS AND EQUIPMENT.

B. THE GRANITE GRAVEL WEARING COURSE SHALL BE 6". COMPACTED TO 4", AND SHALL BE CROWNED.

C. RED ROAD BASE SUBBASE COURSE SHALL BE 6" COMPACTED TO 4".

D. UPON COMPLETION OF INSTALLATION, ALL GRANITE GRAVEL SHALL BE REMOVED FROM ADJOINING HARD SURFACES (I.E. RETAINING CURB/WALL, SIDEWALKS, RUBBER SAFETY SURFACE, PLAYSCAPE DECKS OR RAMPS.)

E INSTALL ANY ADIACENT HARD SURFACES SUCH AS CURBS OR WALKS, PRIOR TO INSTALLATION OF GRANITE GRAVEL.

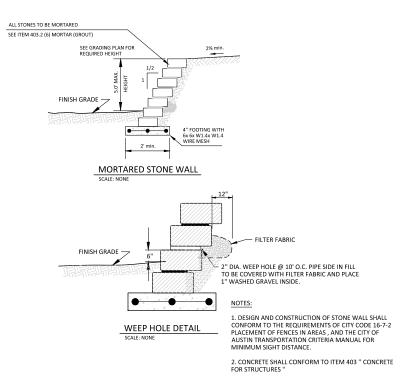

432S-

C109





Austin New York St. Louis Office: 900 E. 6th St., Suite 105 Austin, TX 78702 p 512.391.1932 f 512.391.1920

O'Connell Architecture

1405 W. 10th Street Austin, TX 78703 p. 512.751.1374 Tere O'Connell Jose I. Guerra, Inc. 2401 S. IH 35 Austin, TX 78741 p. 512.445.2090 Debra Sharpe

Structural

Jebra Sharpe Structures 6926 N. Lamar Blvd Austin, TX 78752 p. 512,499,0919 Dante Angelini Doucet & Associates 7401 TX-71 West, Ste 160 Austin, TX 78735 p. 512,583,2623 Tom Curran



5/25/2021

Project Title:

BUILDING RESTORATION & SITE IMPROVMENTS Museum Elisabet Ney

St

ш

304

DOUCET+ CHAN

-A Division of Doucet & Associates, Inc.-

Civil Engineering - Planning - Geospatial 7401 B. Highway 71 W, Suite 160

Development Services Department
RELEASED FOR GENERAL COMPLIANCE: __

This drawing and details on it are the sole property o

Austin, Texas 78735, Phone: (512)-583-2600

www.doucetenglneers.com Firm Registration Number: 3937 X/DOUCET/1600-012	
SITE PLAN RELEASE	
SITE PLAN APPROVAL SHEET 12 OF 14 FILE NUMBER: SP-2020-0276D APPLICATION DATE: JULY 2, 2020 APPROVED BY COMMISSION ON UNDER SECTION 112 OF	
CHAPTER <u>25-5</u> OF THE CITY OF AUSTIN CODE. EXPIRATION DATE (25-5-81, LDC)CASE MANAGER Ann DeSanctis PROJECT EXPIRATION DATE (ORD, #970905)DDZDDZ	
,	


STANDARD DETAILS

Final plat must be recorded by the Project Expiration Date, if applicable. Subsequent Site Plans which do not comply with the Code current at the time of filing, and all required Building Permits and/or a notice of construction (if a building permit is not required), must also be approved prior to the Project Expiration Date.

Page 8


SP-2020-0276D

ZONING ZONING

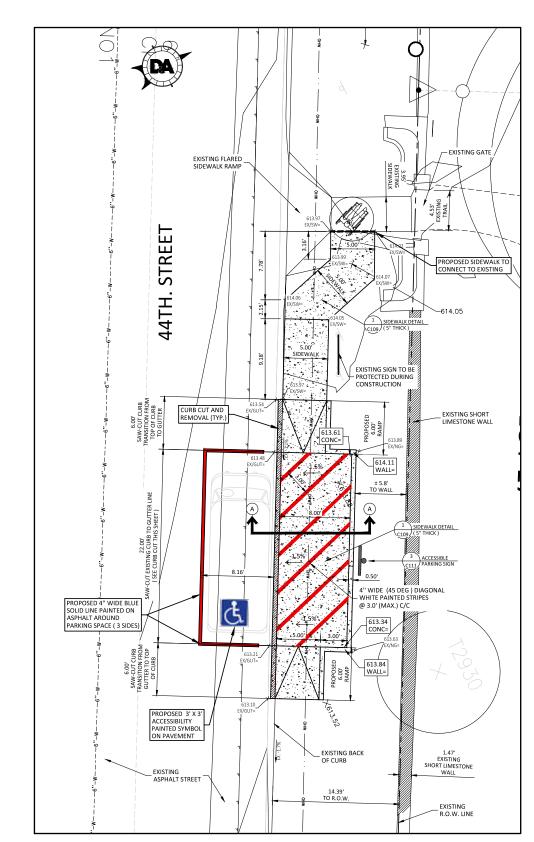



PROPOSED VAN ACCESSIBLE PARKING SPACE

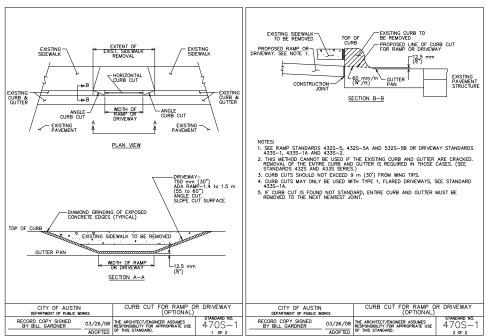




- VAN ACCESSIBLE SIGN

VAN ACCESSIBLE PARKING SIGN

C111


SCALE: NONE

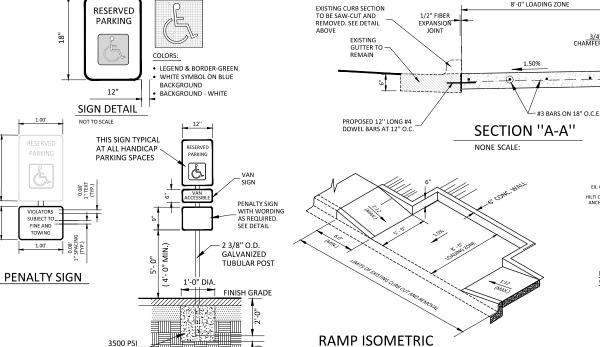

SCALE: NONE



SIDEWALK ENTRANCE

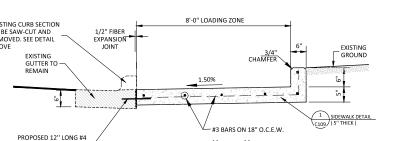



Civil Engineering - Planning - Geospatial 7401 B. Highway 71 W, Suite 160 Austin, Texas 78735, Phone: (512)-583-2600 www.doucetengineers.com Firm Registration Number: 3937 X / DOUCET / 1600-012

SITE PLAN RELEASE

	SITE PLAN APPROVAL SHEET 14 OF 14
	FILE NUMBER: SP-2020-0276D APPLICATION DATE: JULY 2, 2020
	APPROVED BY COMMISSION ON UNDER SECTION 112 OF
8	CHAPTER 25-5 OF THE CITY OF AUSTIN CODE.
8	EXPIRATION DATE (25-5-81, LDC)CASE MANAGER Ann DeSanctis
9	PROJECT EXPIRATION DATE (ORD.#970905)DWPZDDZ
ž.	
8	Development Services Department
N.	RELEASED FOR GENERAL COMPLIANCE:ZONINGZONING
	Rev. 1 Correction 1
	Rev. 2 Correction 2

PROPOSED ACCESSIBLE PARKING SPACE

Page 9


C111

SCALE: 1" = 5'

Office: 900 E. 6th St., Suite 105 Austin, TX 78702 p 512.391.1932 f 512.391.1920 1405 W. 10th Street Austin, TX 78703 p. 512.751.1374 Tere O'Connell Jose I. Guerra, Inc. 2401 S. IH 35 Austin, TX 78741 p. 512.445.2090 Debra Sharpe

LAWRENCE GROUP


Austin New York St. Louis

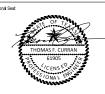

5/25/2021

BUILDING RESTORATION & SITE IMPROVMENTS Elisabet Ney Museum

SP-2020-0276D

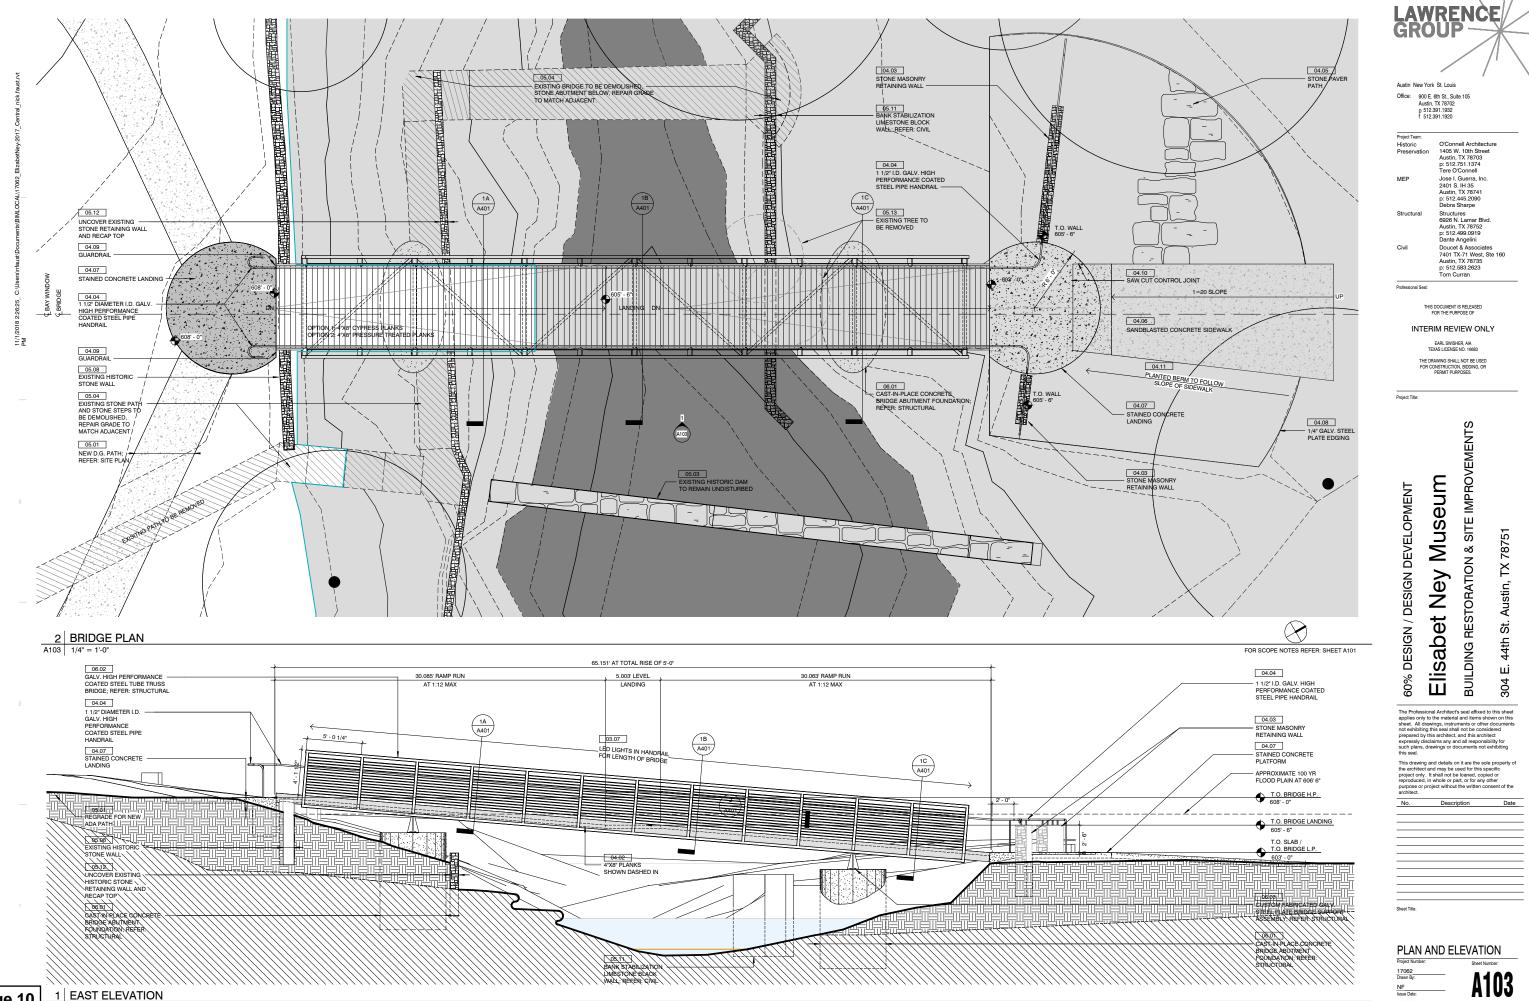

Page 10

A103 1/4" = 1'-0"

FOR SCOPE NOTES REFER: SHEET A101

A103

10/26/18

LAWRENCE Austin New York St. Louis Office: 900 E. 6th St., Suite 105 Austin, TX 78702 p 512.391.1932 f 512.391.1920 Project Team:
Historic
Preservation
1405 W. 10th Street
Austin, TX 78703
p. 512.751.1374
Tere O'Connell
1-so 1 Guerra, Inc.

Tere O'Connell
Jose I, Guerra, Inc.
2401 S. IH 95
Austin, TX 78741
p: 512.445.2090
Debra Sharpe
Structures
6926 N. Lamar Blvd.
Austin, TX 78752
p: 512.499.0919
Dounte Angelini
Doucet & Associates
7401 TX-71 West, Ste 160
Austin, TX 78735
p: 512.883.2623
Tom Curran

THIS DOCUMENT IS RELEASED FOR THE PURPOSE OF

INTERIM REVIEW ONLY

Project Title:

MEP

Structural

BUILDING RESTORATION & SITE IMPROVEMENTS Museum Ney

Austin, TX 78751


DESIGN / DESIGN DEVELOPMENT Elisabet I 44th St. ш 809 304

The Professional Architect's seal affixed to this sheet applies only to the material and items shown on this sheet. All drawings, instruments or other documents not exhibiting this seal shall not be considered prepared by this architect, and his architect, and his architect expressly disclaims any and all responsibility for such plans, drawings or documents not exhibiting this seal.


This drawing and details on it are the sole property of the architect and may be used for this specific project only. It shall not be loaned, copied or reproduced, in whole or part, or for any other purpose or project without the written consent of the architect.

Sheet Title:

DETAIL SECTION 10/26/18

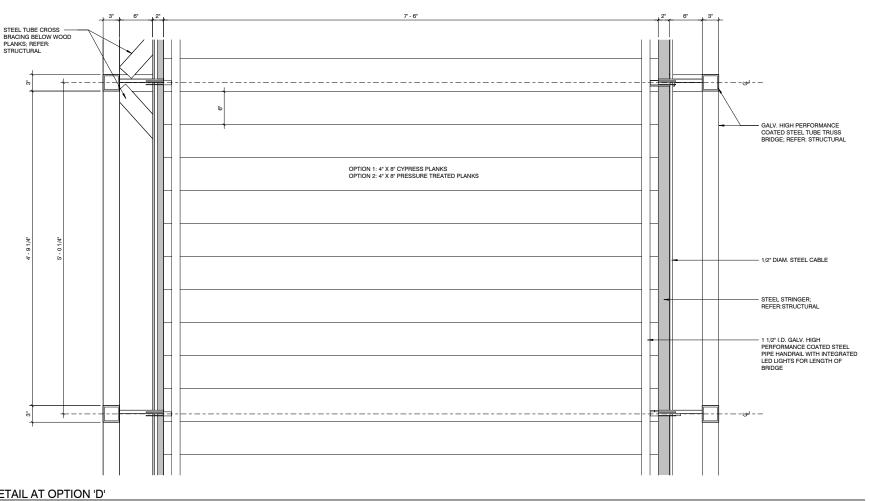

2 PLAN DETAIL AT OPTION 'D' A401 1 1/2" = 1'-0"

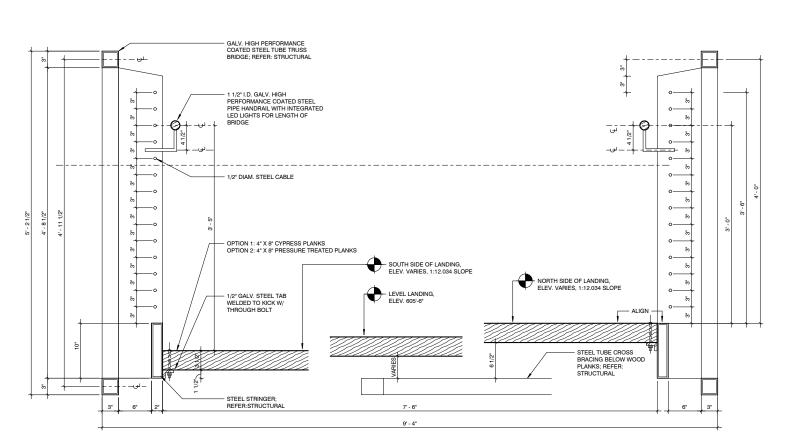

1 DETAIL SECTION AT OPTION 'D' A401 | 1 1/2" = 1'-0"

Page 11





