1712 WEST 11TH

REMODEL & ADDITION

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PROJECT

江王

DRAWN BY

SET ISSUE


CP, MB, LK

12.10.2021: HISTORIC REVIEW

SHEET TITLE

COVER SHEET

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GENERAL NOTES

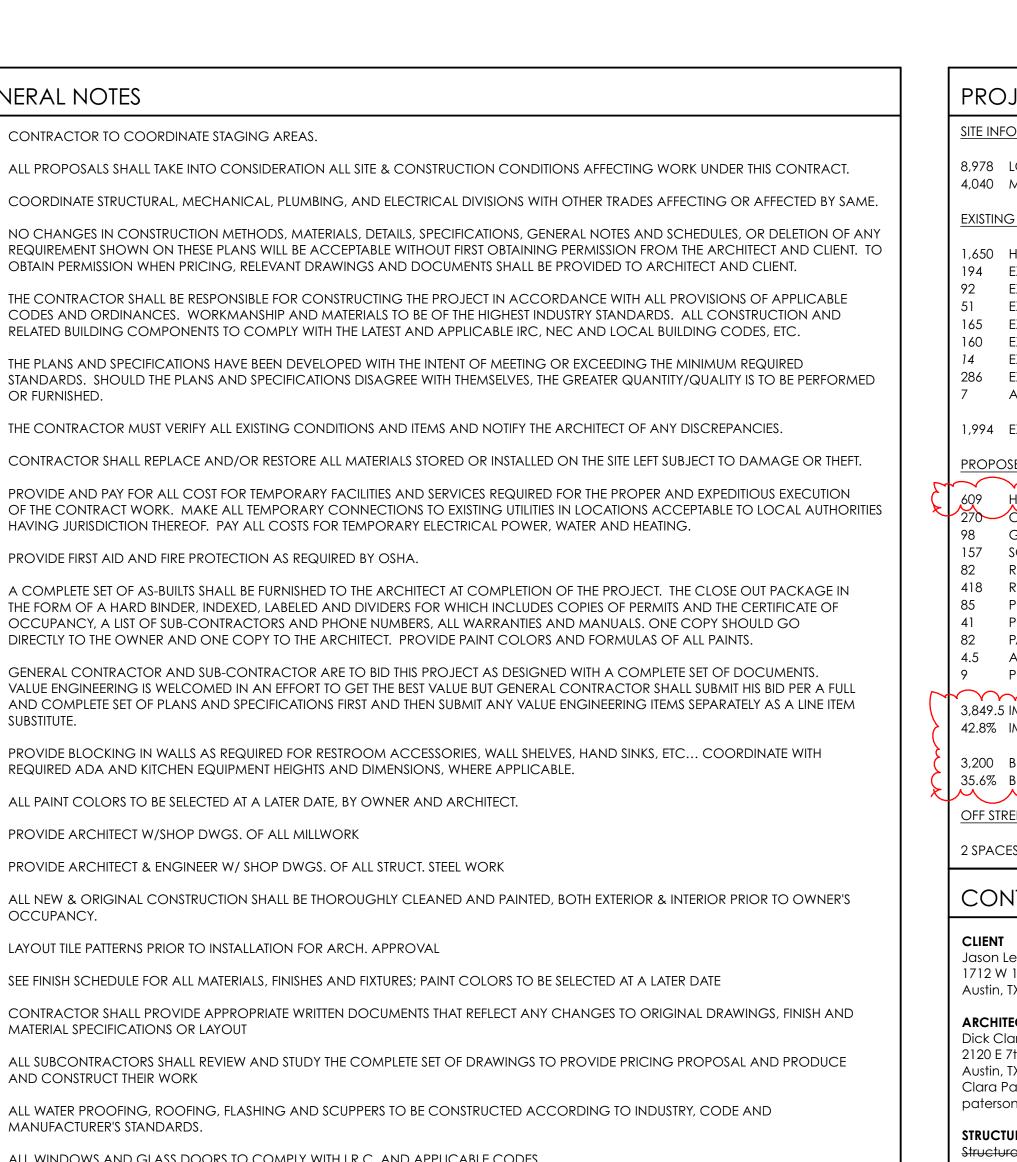OR FURNISHED.

SUBSTITUTE.

OCCUPANCY.

CONTRACTOR TO COORDINATE STAGING AREAS.

10. PROVIDE FIRST AID AND FIRE PROTECTION AS REQUIRED BY OSHA.

HAVING JURISDICTION THEREOF. PAY ALL COSTS FOR TEMPORARY ELECTRICAL POWER, WATER AND HEATING.

19. SEE FINISH SCHEDULE FOR ALL MATERIALS, FINISHES AND FIXTURES; PAINT COLORS TO BE SELECTED AT A LATER DATE

INFORM OWNER IN INVITIAL CONSTRUCTION SCHEDULE OR MEETING OF ANY MILESTONE DATES OR CRITICAL POINTS.

REQUIRED ADA AND KITCHEN EQUIPMENT HEIGHTS AND DIMENSIONS, WHERE APPLICABLE.

ALL PAINT COLORS TO BE SELECTED AT A LATER DATE, BY OWNER AND ARCHITECT.

16. PROVIDE ARCHITECT & ENGINEER W/ SHOP DWGS. OF ALL STRUCT. STEEL WORK

ALL WINDOWS AND GLASS DOORS TO COMPLY WITH I.R.C. AND APPLICABLE CODES.


18. LAYOUT TILE PATTERNS PRIOR TO INSTALLATION FOR ARCH. APPROVAL


15. PROVIDE ARCHITECT W/SHOP DWGS. OF ALL MILLWORK


MATERIAL SPECIFICATIONS OR LAYOUT

MANUFACTURER'S STANDARDS.


DIRECTLY TO THE OWNER AND ONE COPY TO THE ARCHITECT. PROVIDE PAINT COLORS AND FORMULAS OF ALL PAINTS.

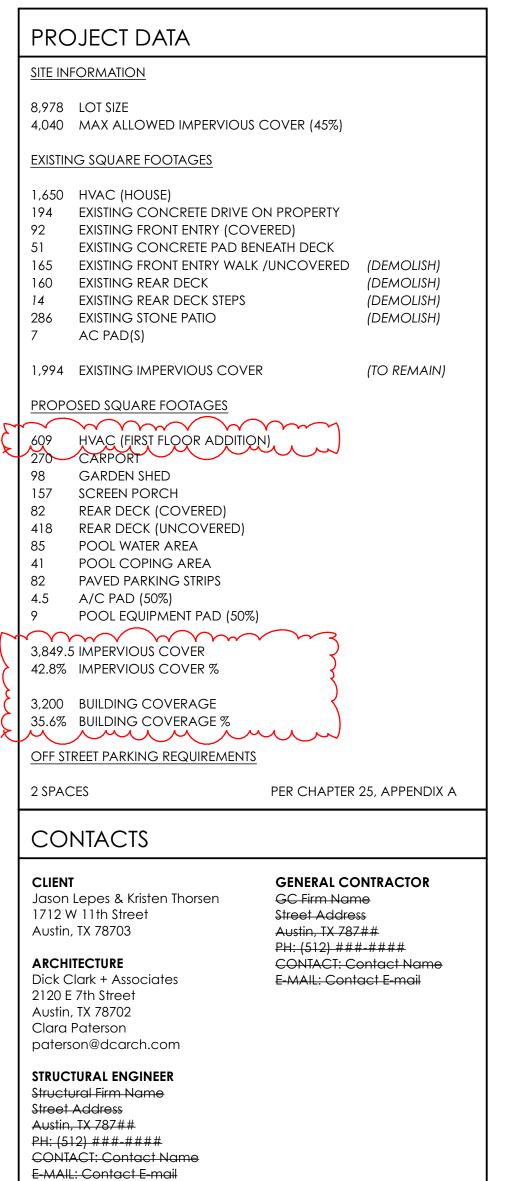


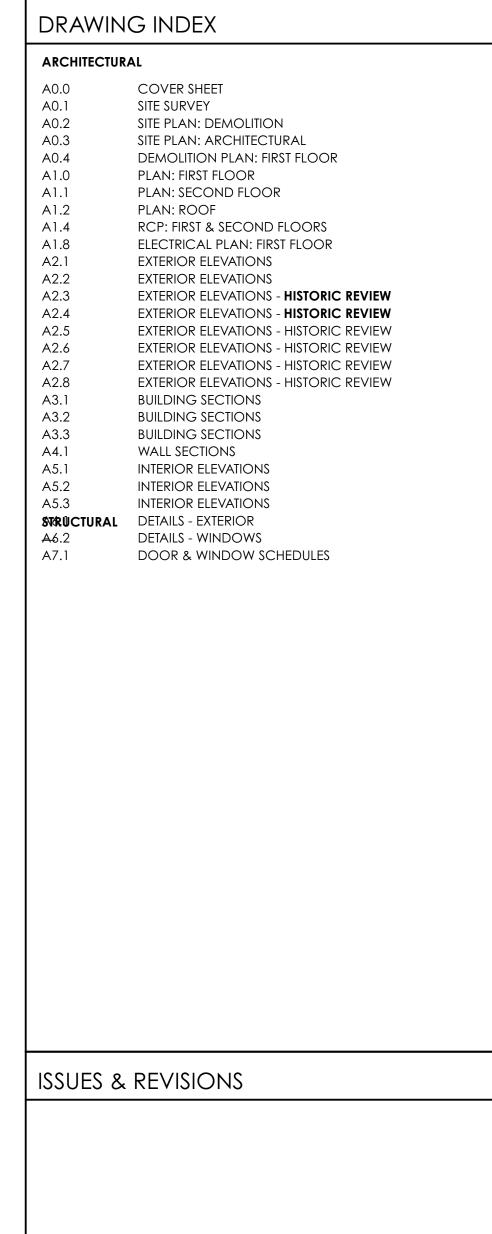


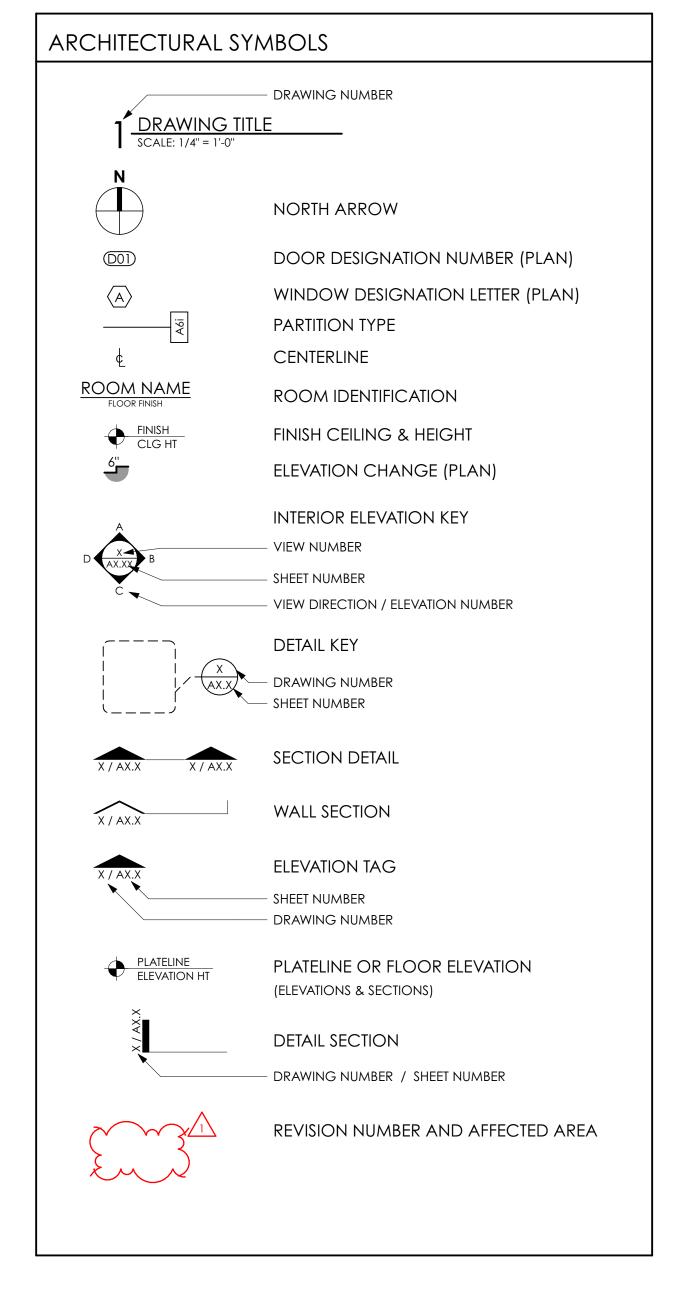



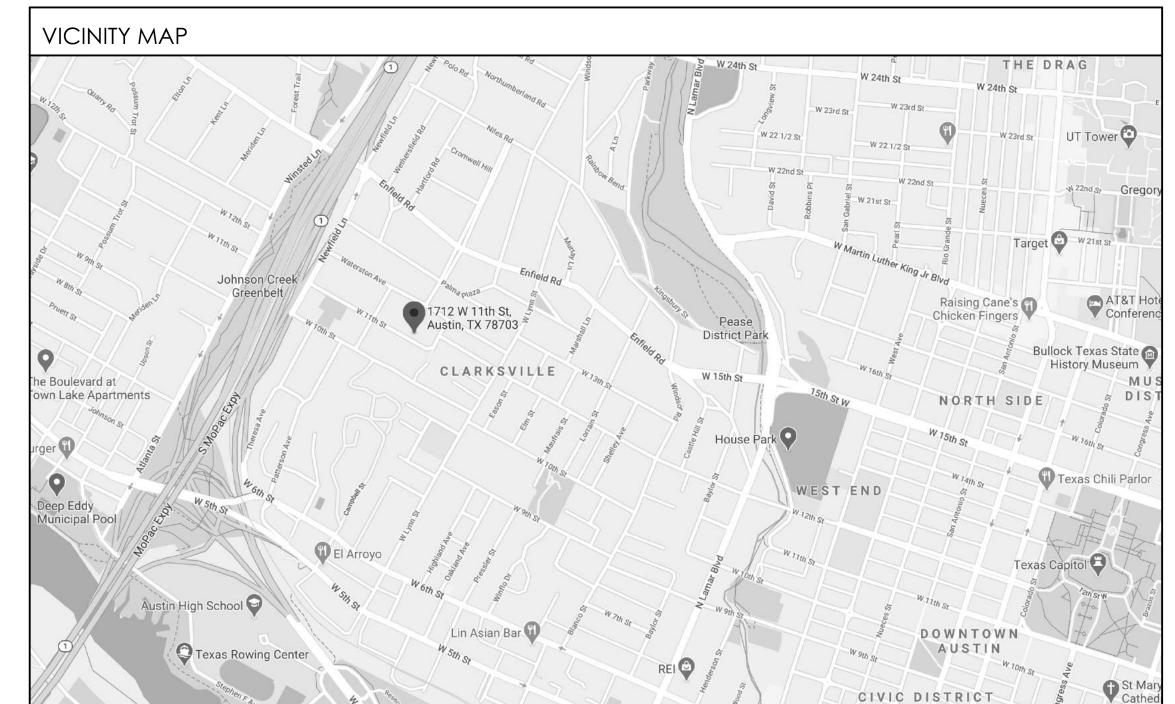

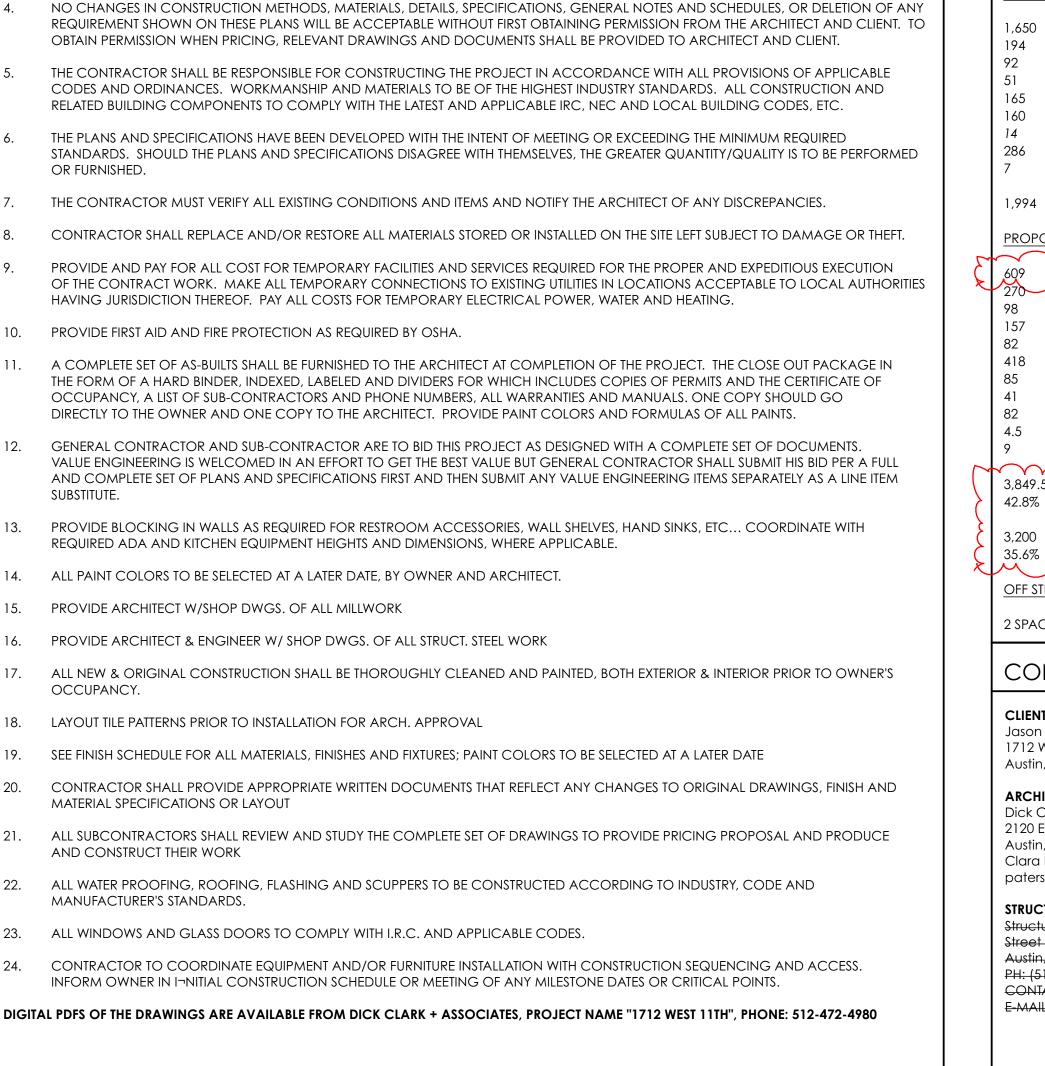

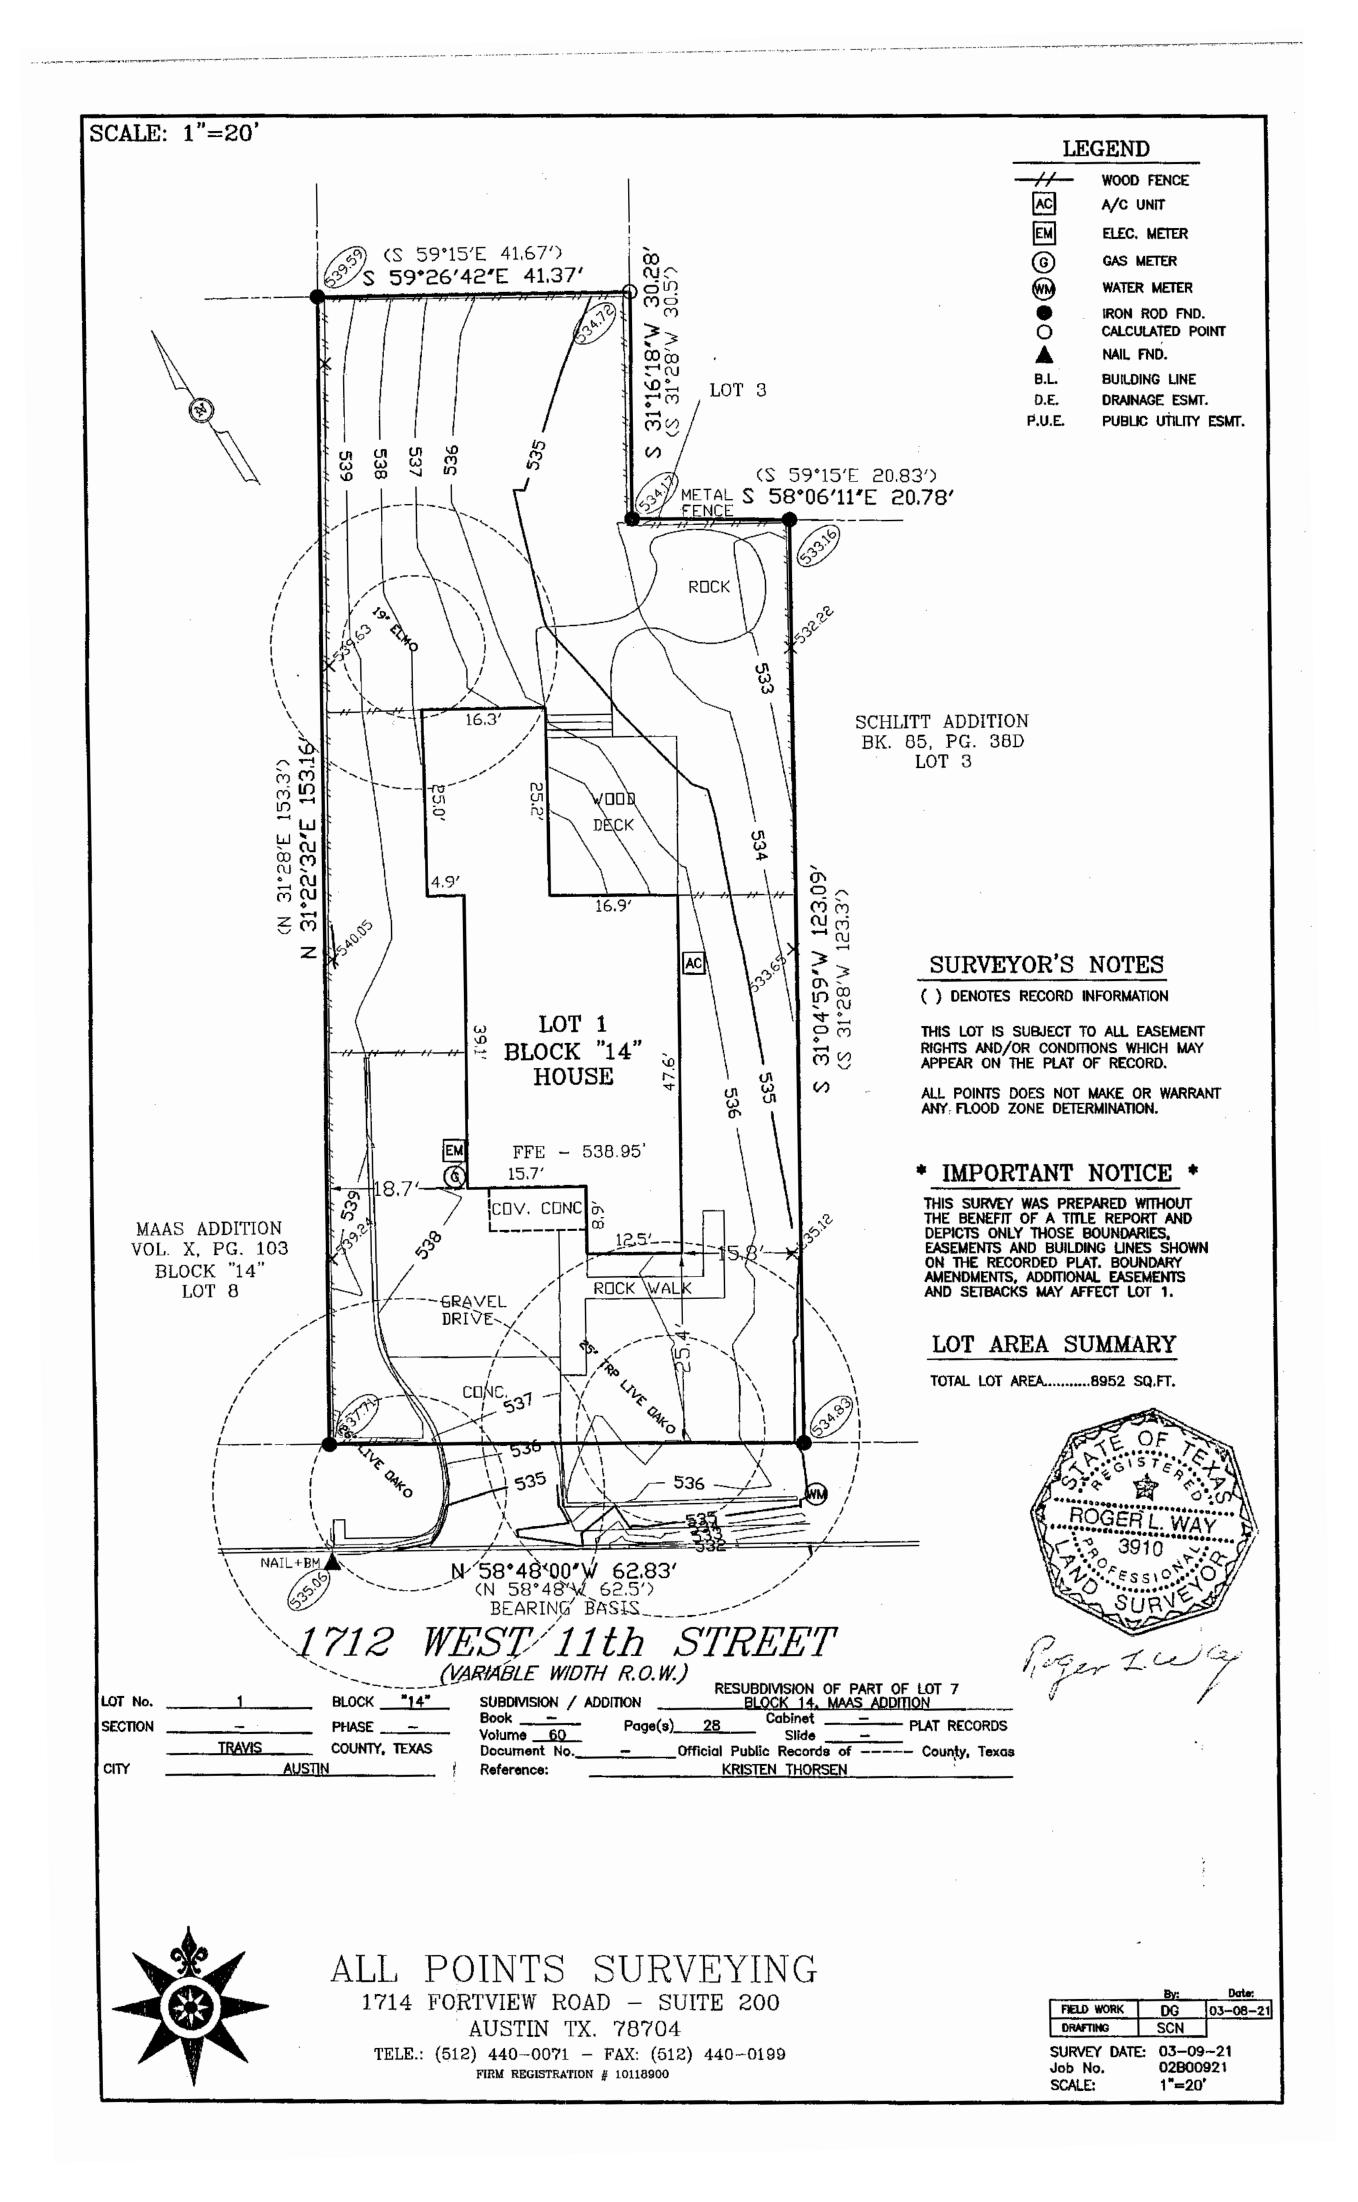



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SHEET TITLE

SITE SURVEY

SITE SURVEY

NOT IN SCOPE:

POINTS SURVEYING

ORIGINAL SURVEY DONE BY ALL



TREE MITIGATION NOTE:

EXISTING CALIPER INCHES TO BE MITIGATED EXISTING CALIPER INCHES TO BE REMOVED

* ALL EXISTING TREES TO BE MITIGATED ARE TO BE PROTECTED WITH FENCING THROUGHOUT CONSTRUCTION

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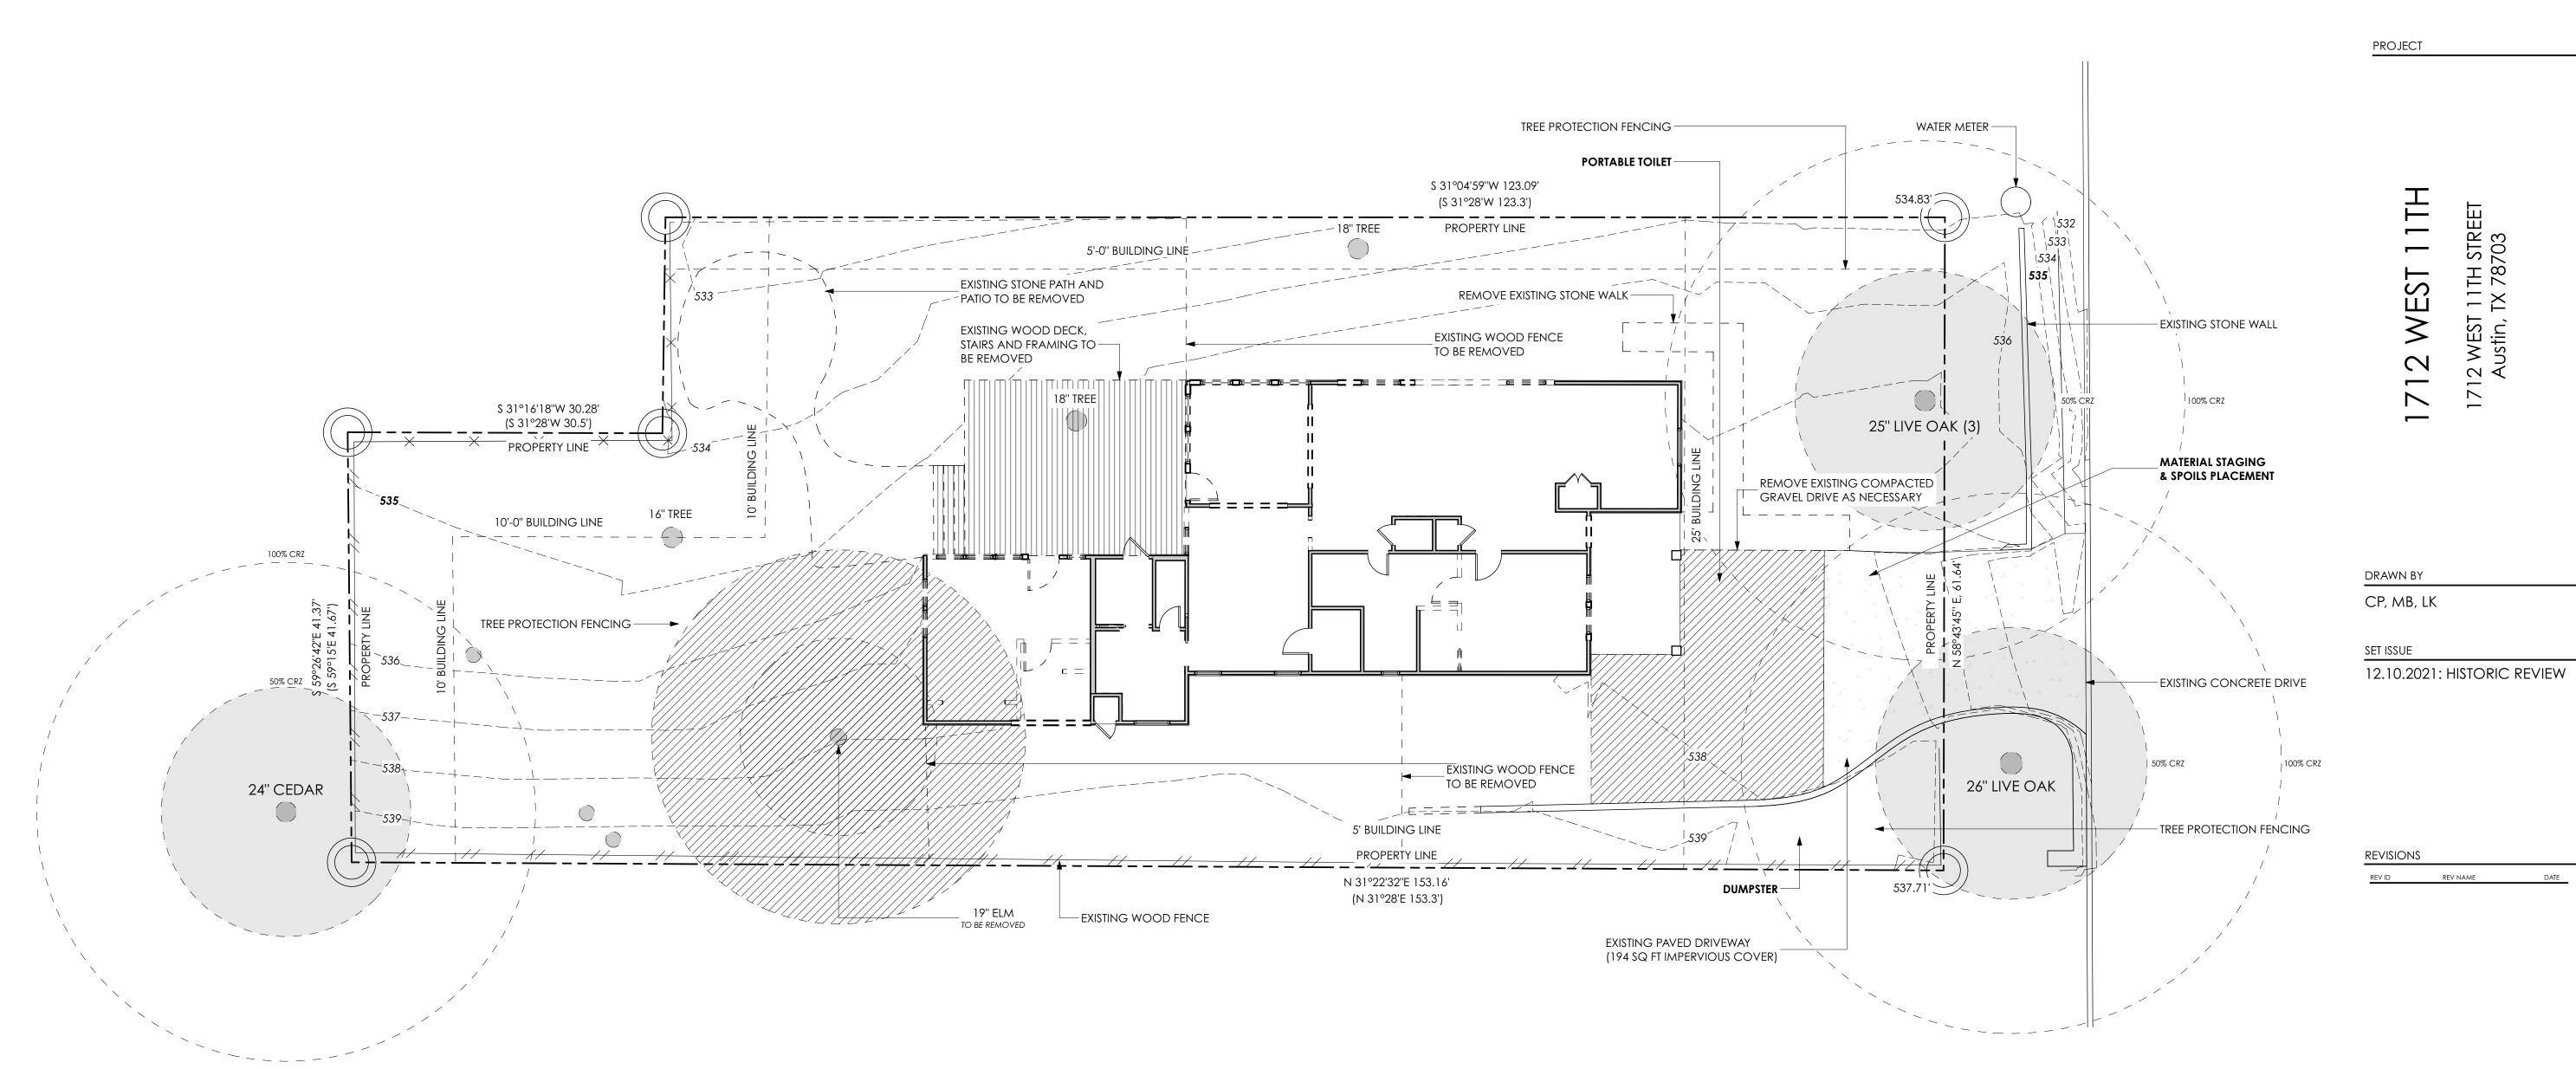
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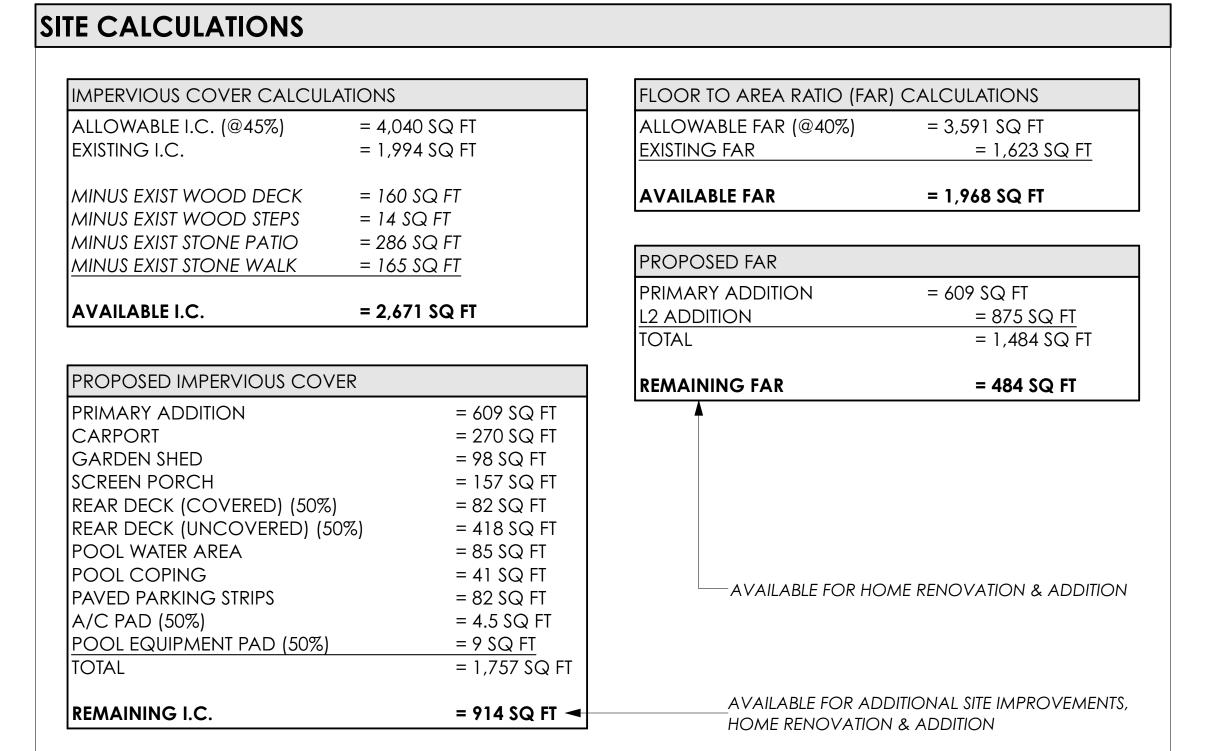
SHEET TITLE


SITE PLAN: DEMOLITION
SCALE: 1/8" = 1'-0"

TRUE NORTH

SITE PLAN: DEMOLITION





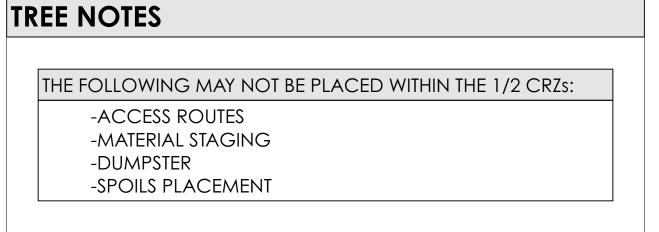

THE FOLLOWING MAY NOT BE PLACED WITHIN THE FULL CRZs:

-PORTABLE TOILET

-PAINT WASHOUT

REQUIRED PARKING STRIP

CARPORT

539.24' **DUMPSTER** –

EXISTING PAVED DRIVEWAY (194 SQ FT IMPERVIOUS COVER)

● PARKING SPOT #1

5' BUILDING LINE

N 31°22'32"E 153.16'

(N 31°28'E 153.3')

-CONCRETE WASHOUT

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PROJECT

WEST 11TH WEST 11TH STREET VUSTIN, TX 78703 12 A

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100% CRZ

- EXISTING CONCRETE DRIVE

TREE PROTECTION FENCING

50% CRZ

SITE PLAN: ARCHITECTURAL SCALE: 1/8" = 1'-0"

26" LIVE OAK


TRUE NORTH

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SITE PLAN: ARCHITECTURAL

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— EXISTING WOOD FENCE TENT A & B

L1 ADDITION
A: 608.69 sf

539.50'

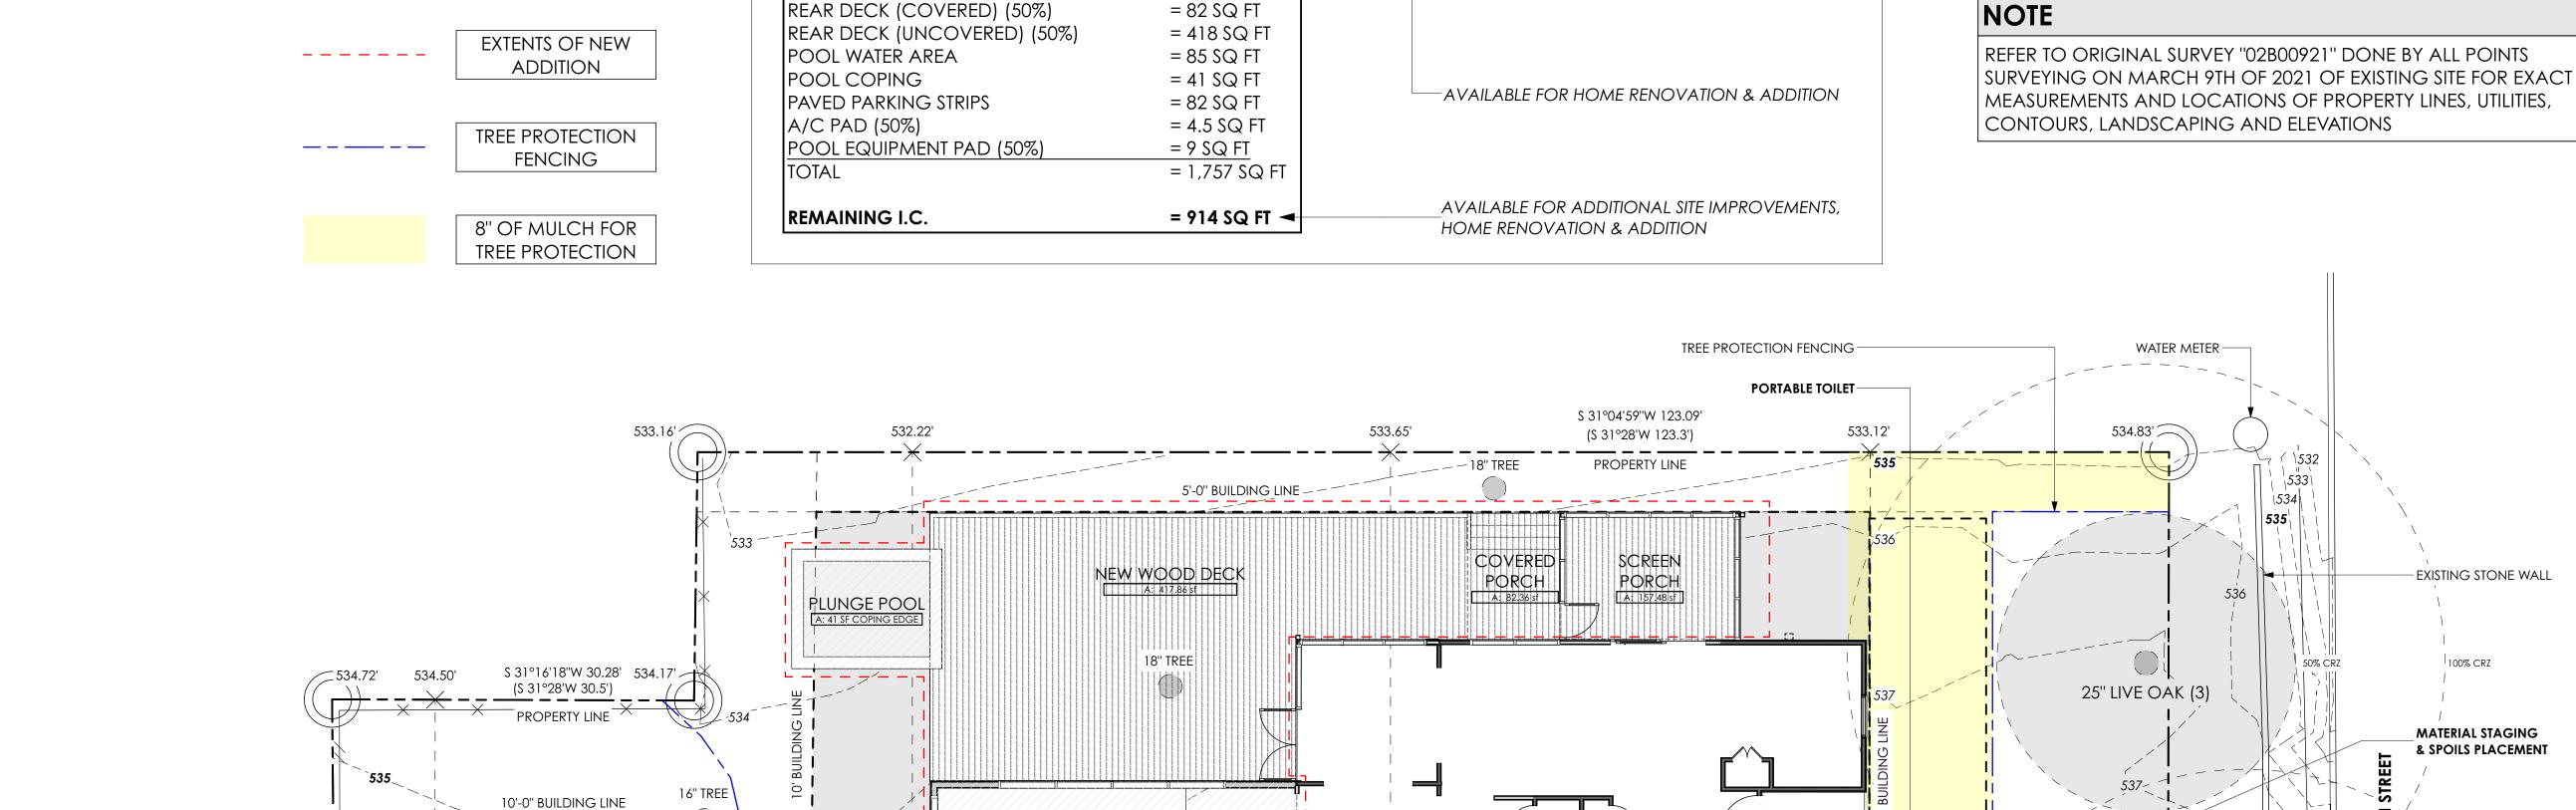UNIDENTIFIED EXISTING TREES <19" PROTECT AND PRESERVE ALL


EXISTING TREES ON SITE U.N.O.

TREE PROTECTION FENCING —

24" CEDAR


539.59' 539.20'


CAUTION: DO NOT SCALE DRAWINGS

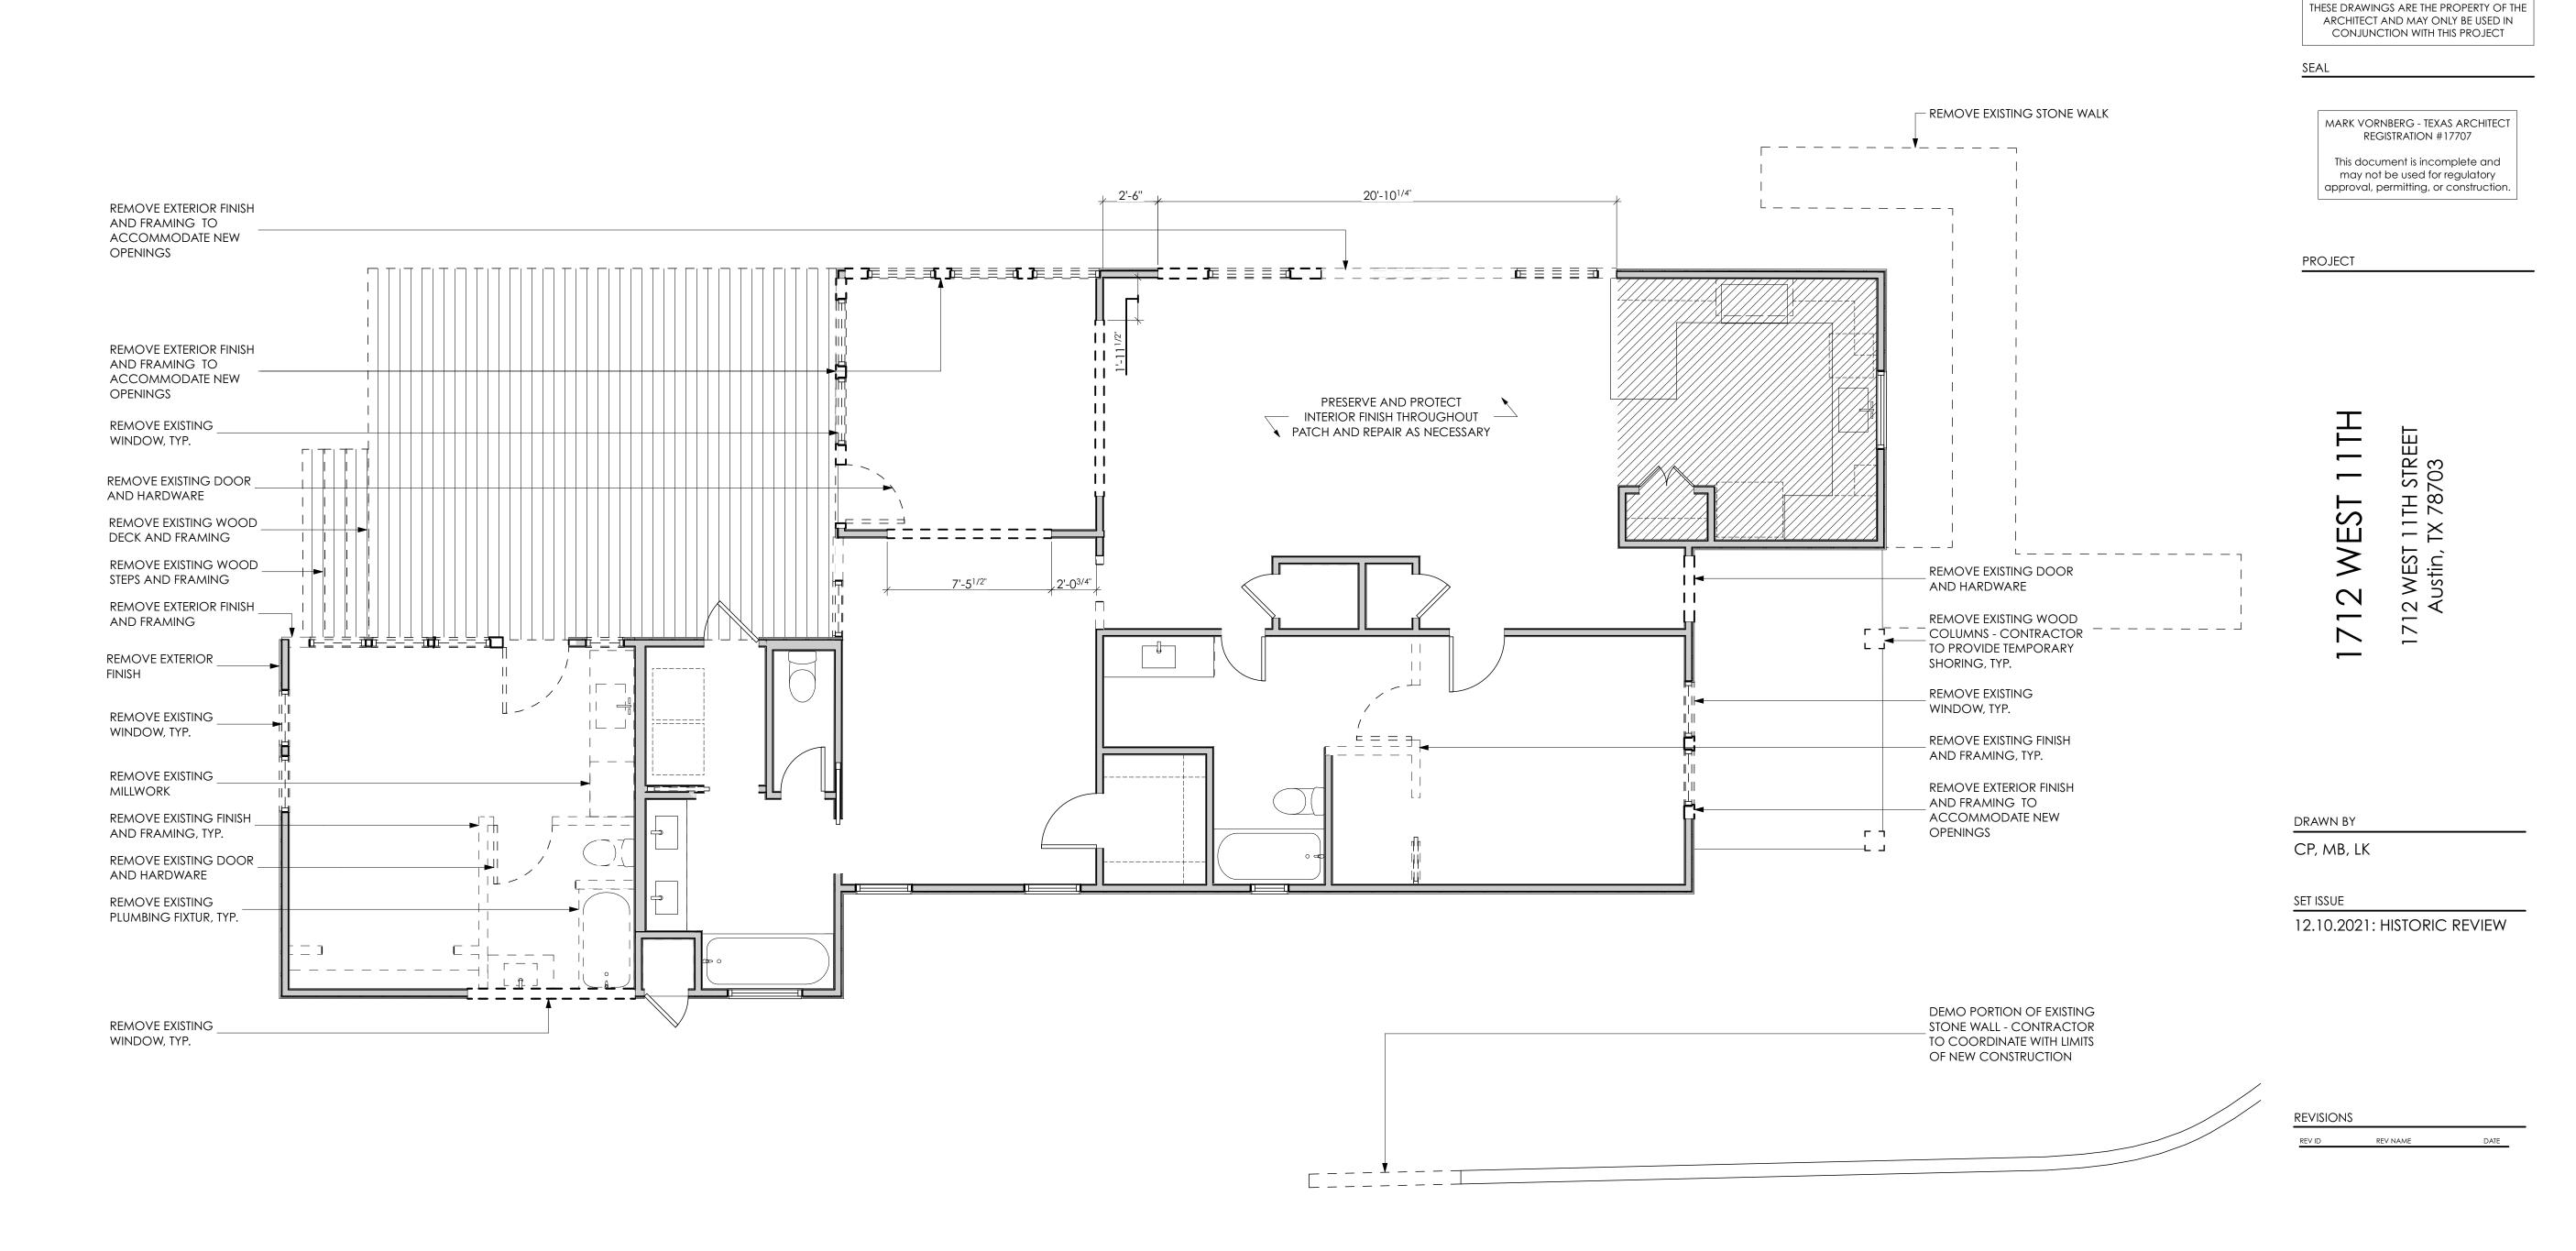

SHEET TITLE

DEMOLITION PLAN: FIRST FLOOR

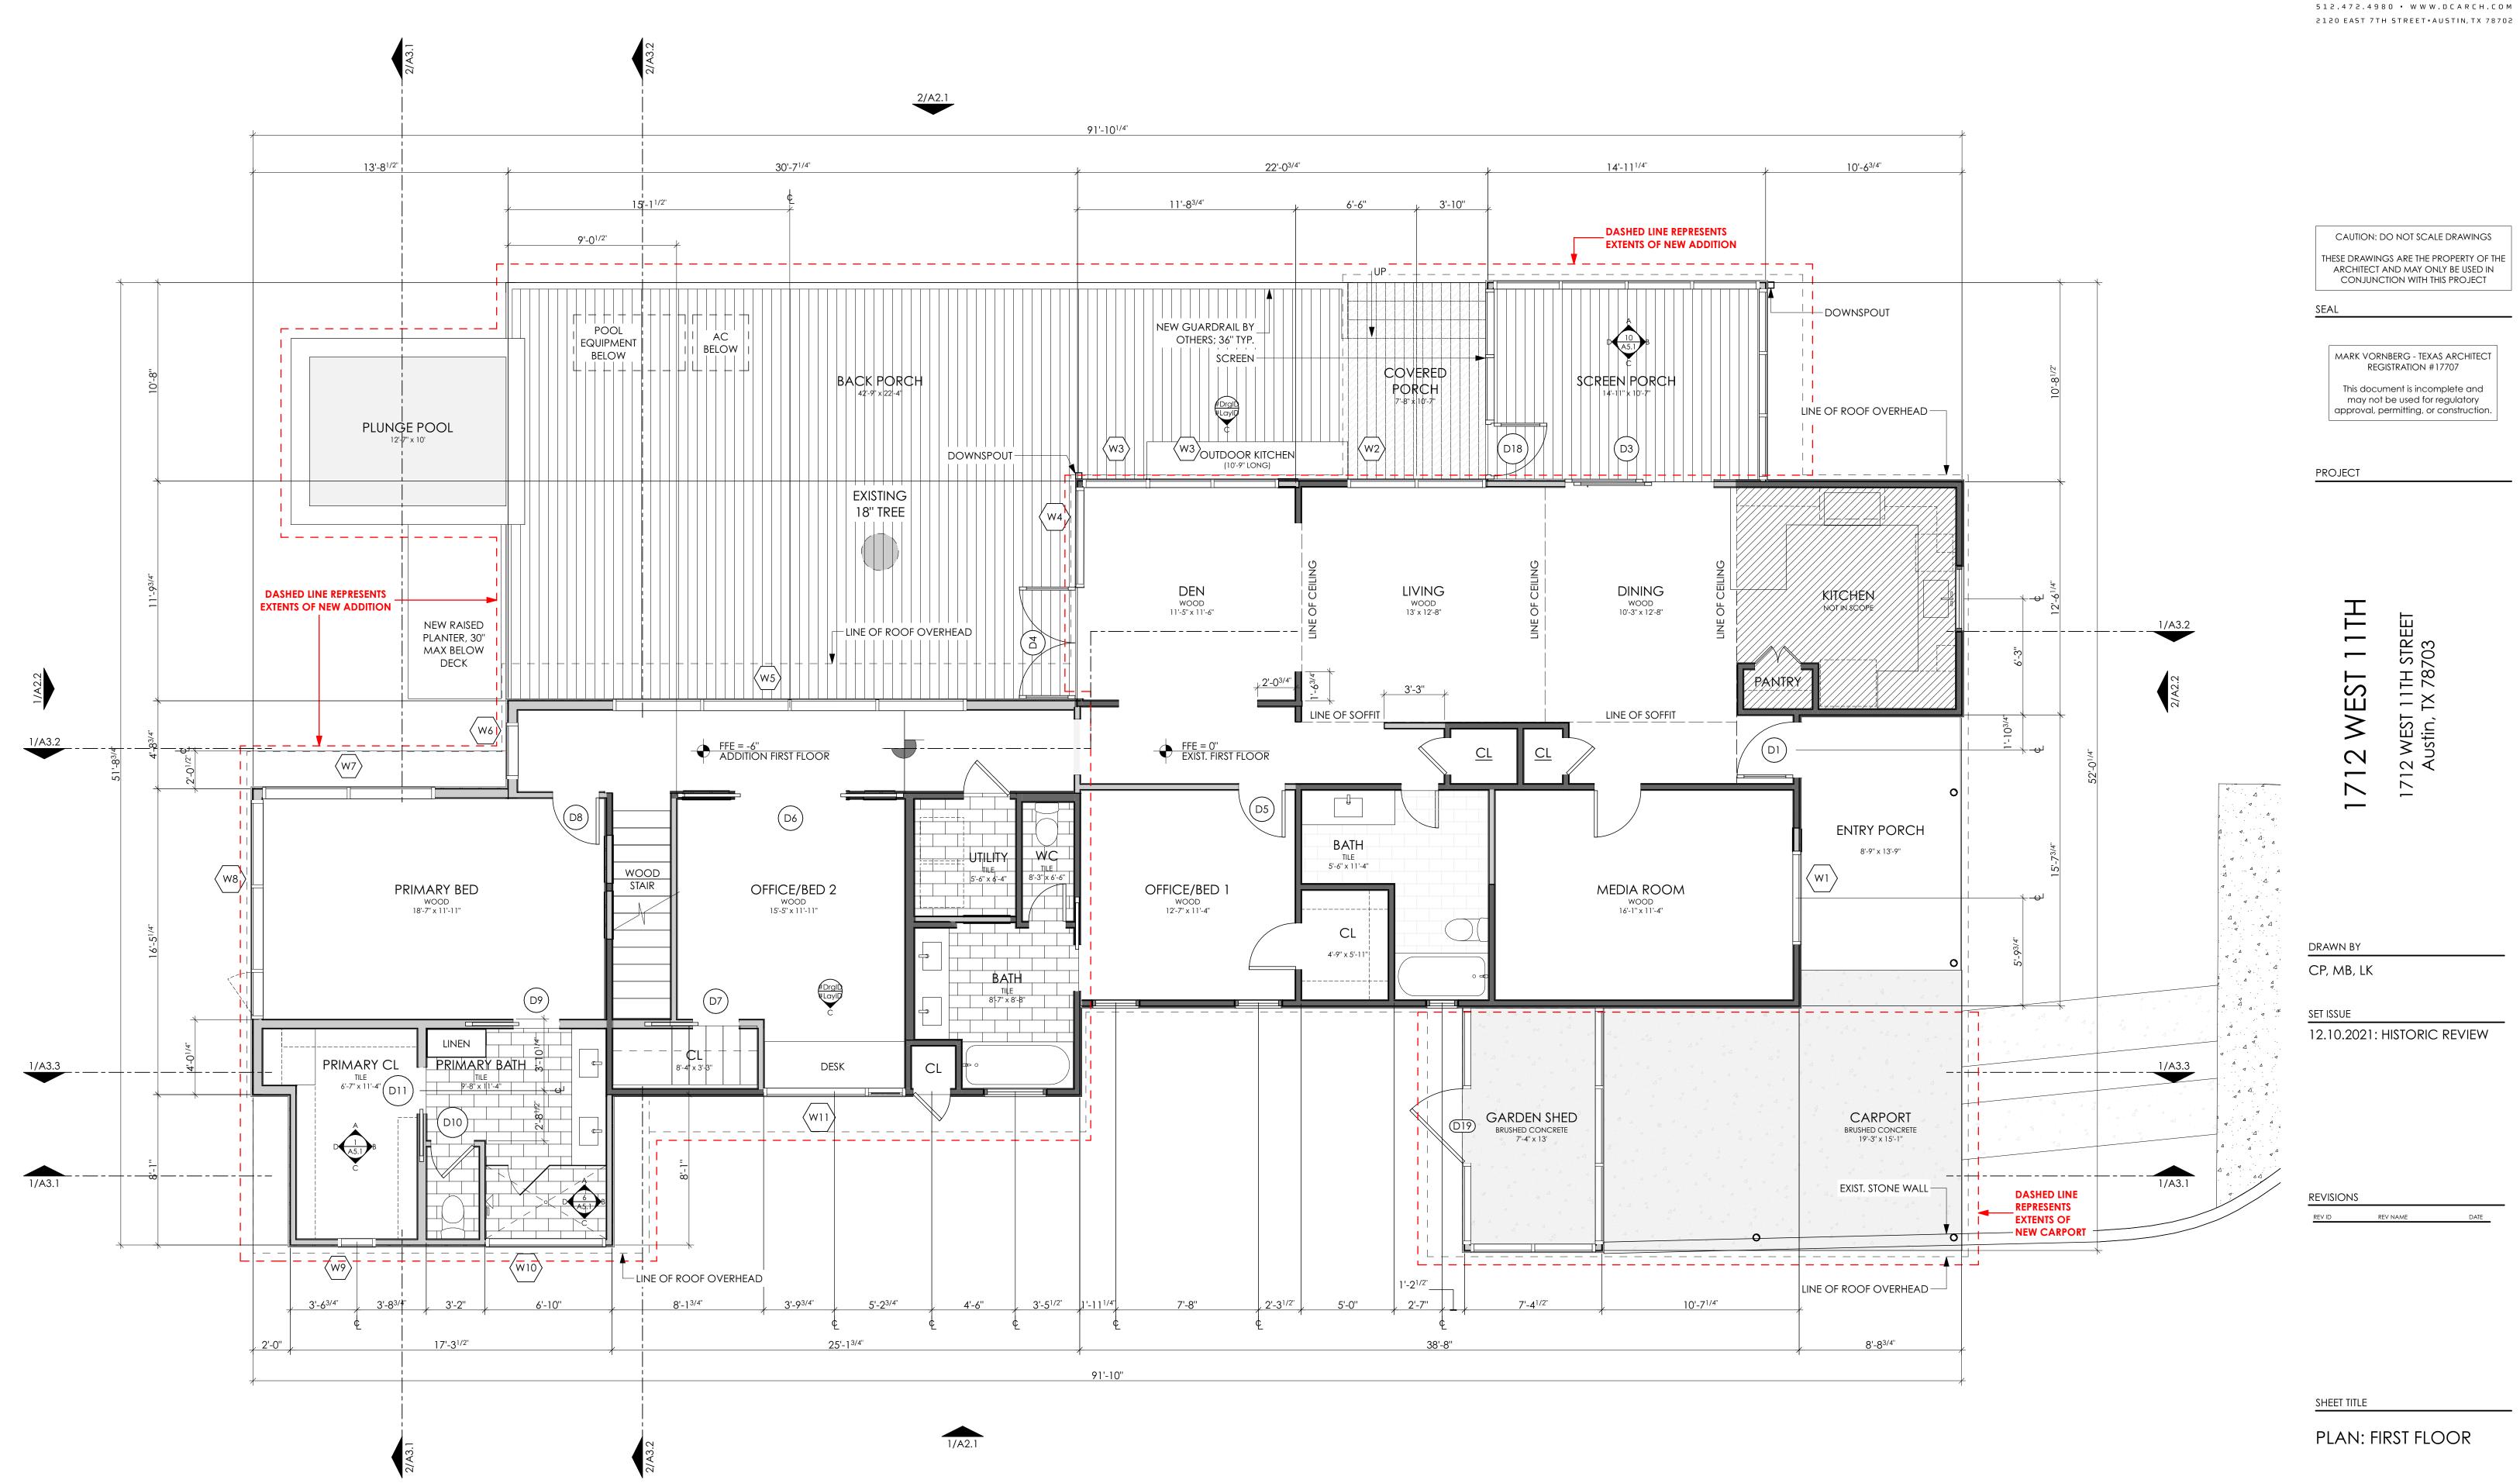

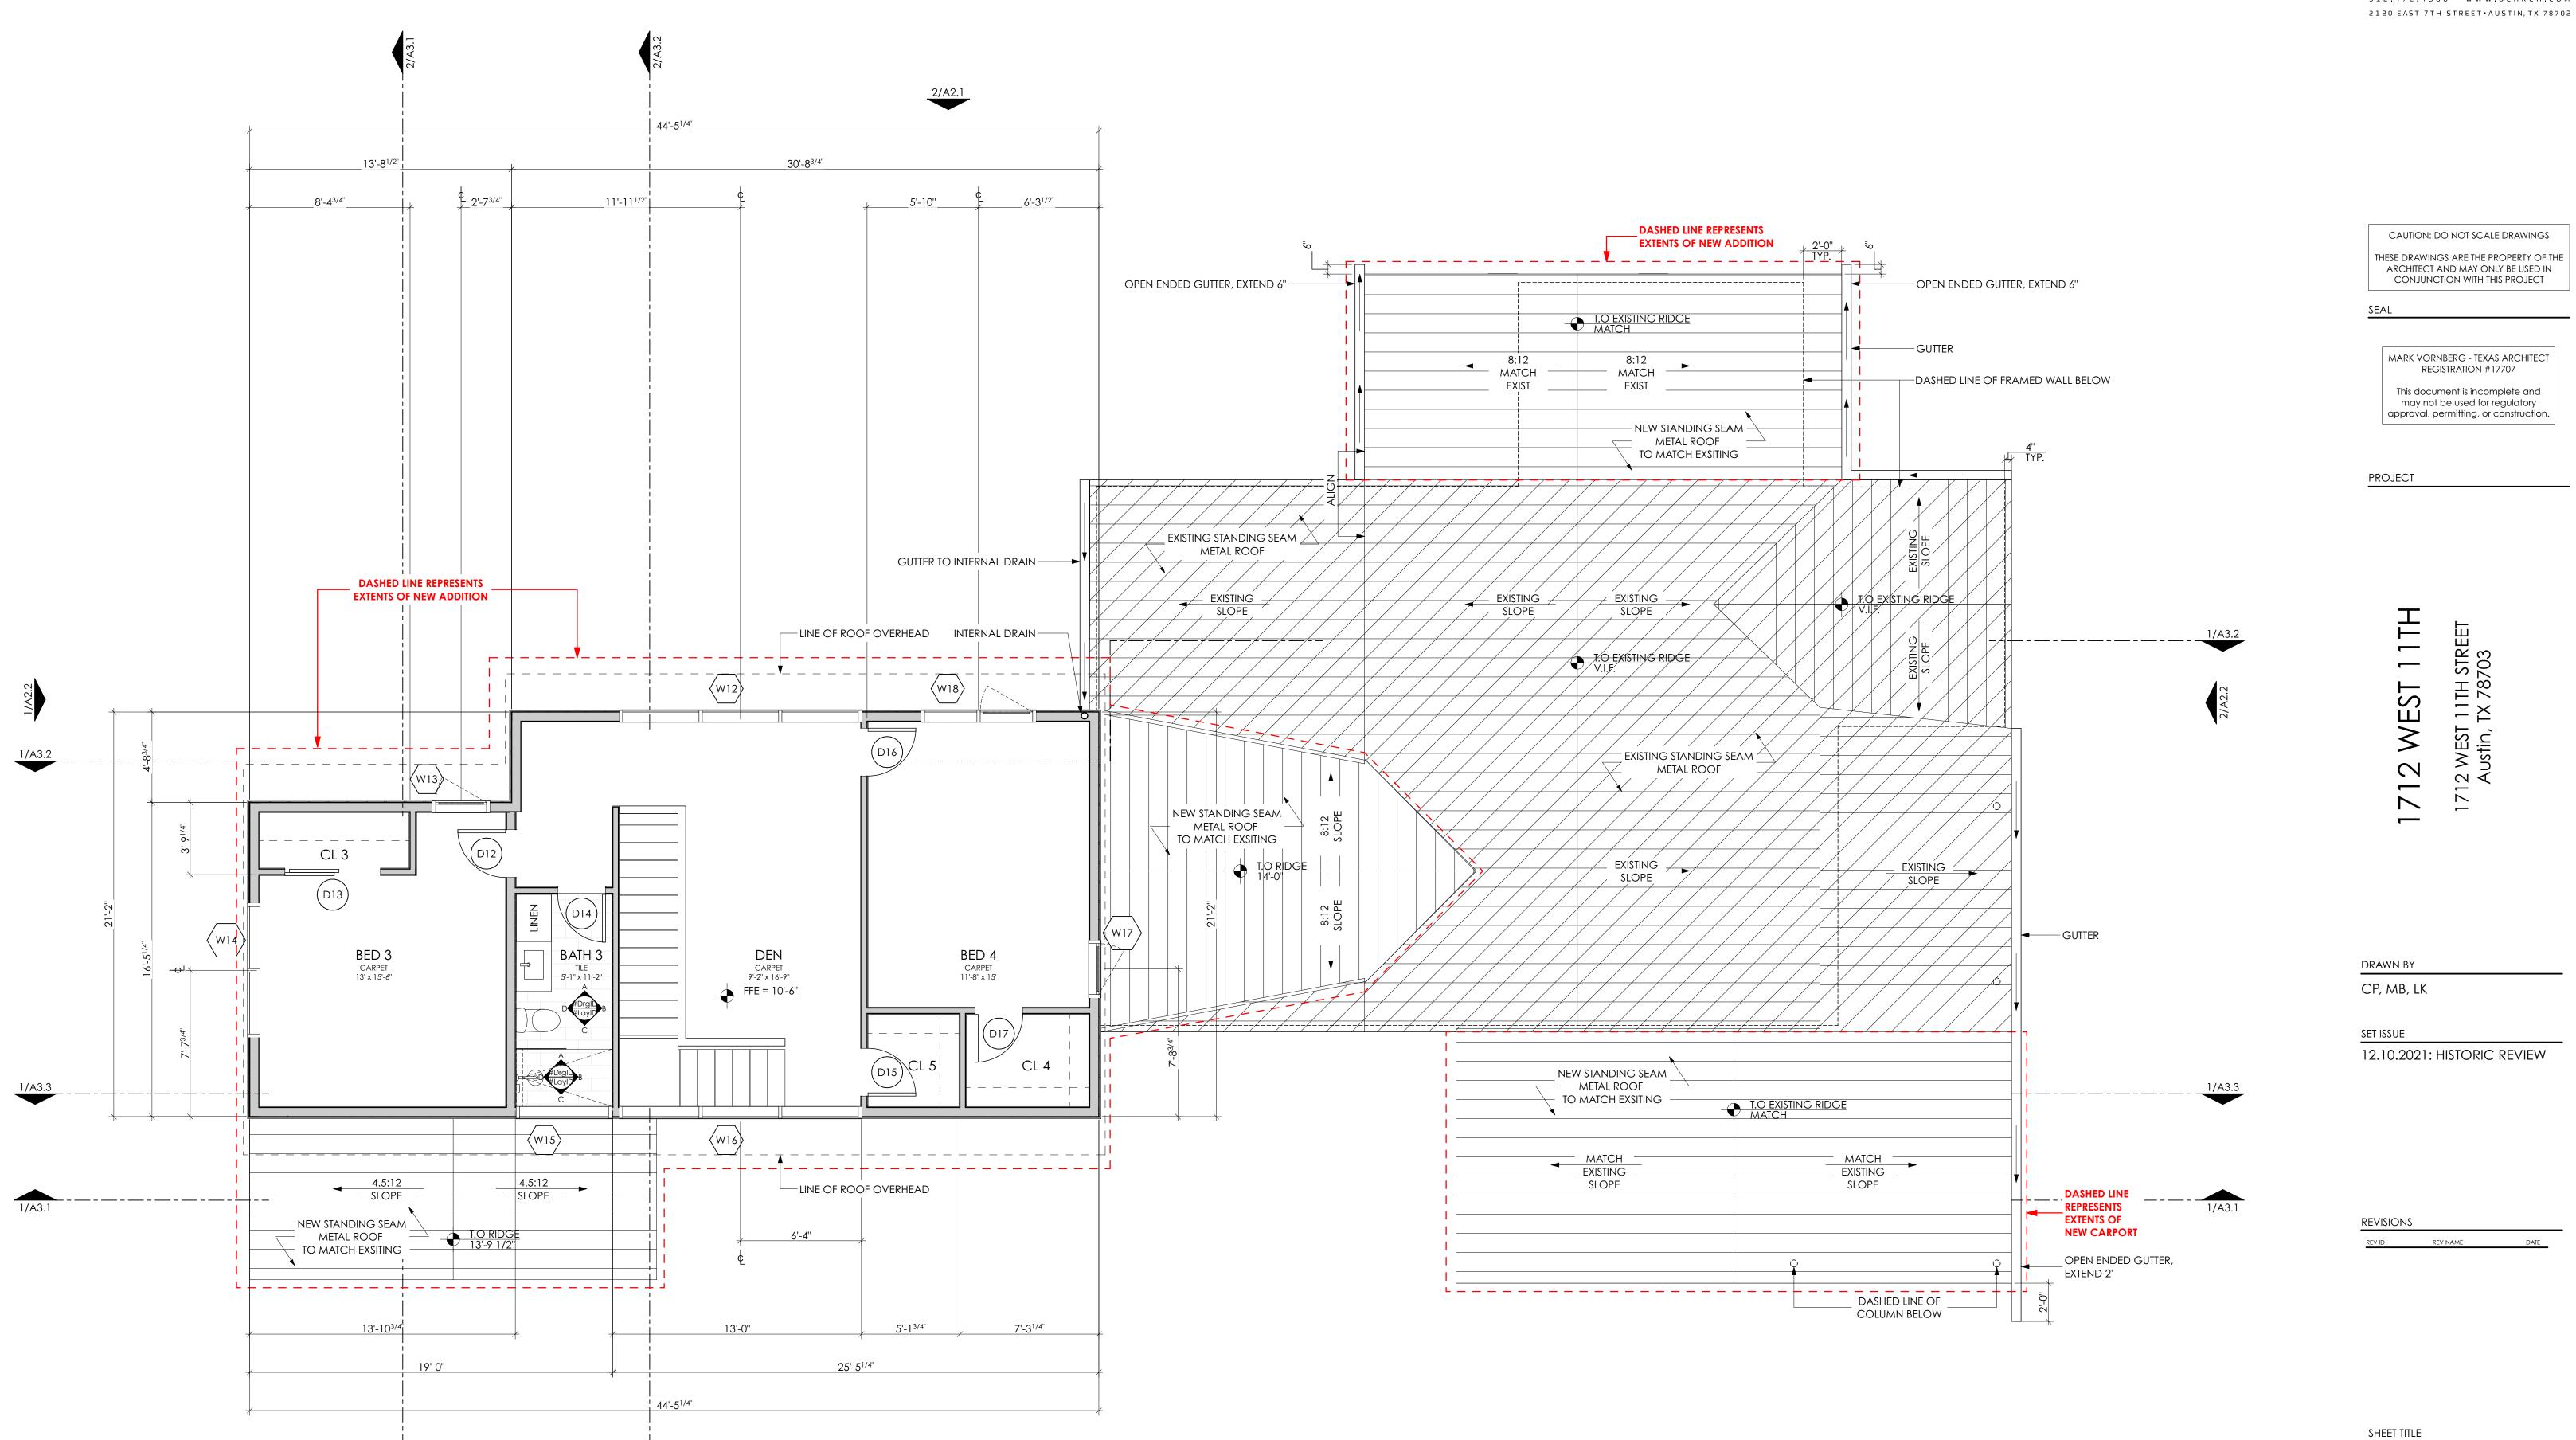


1/A2.1

A1.

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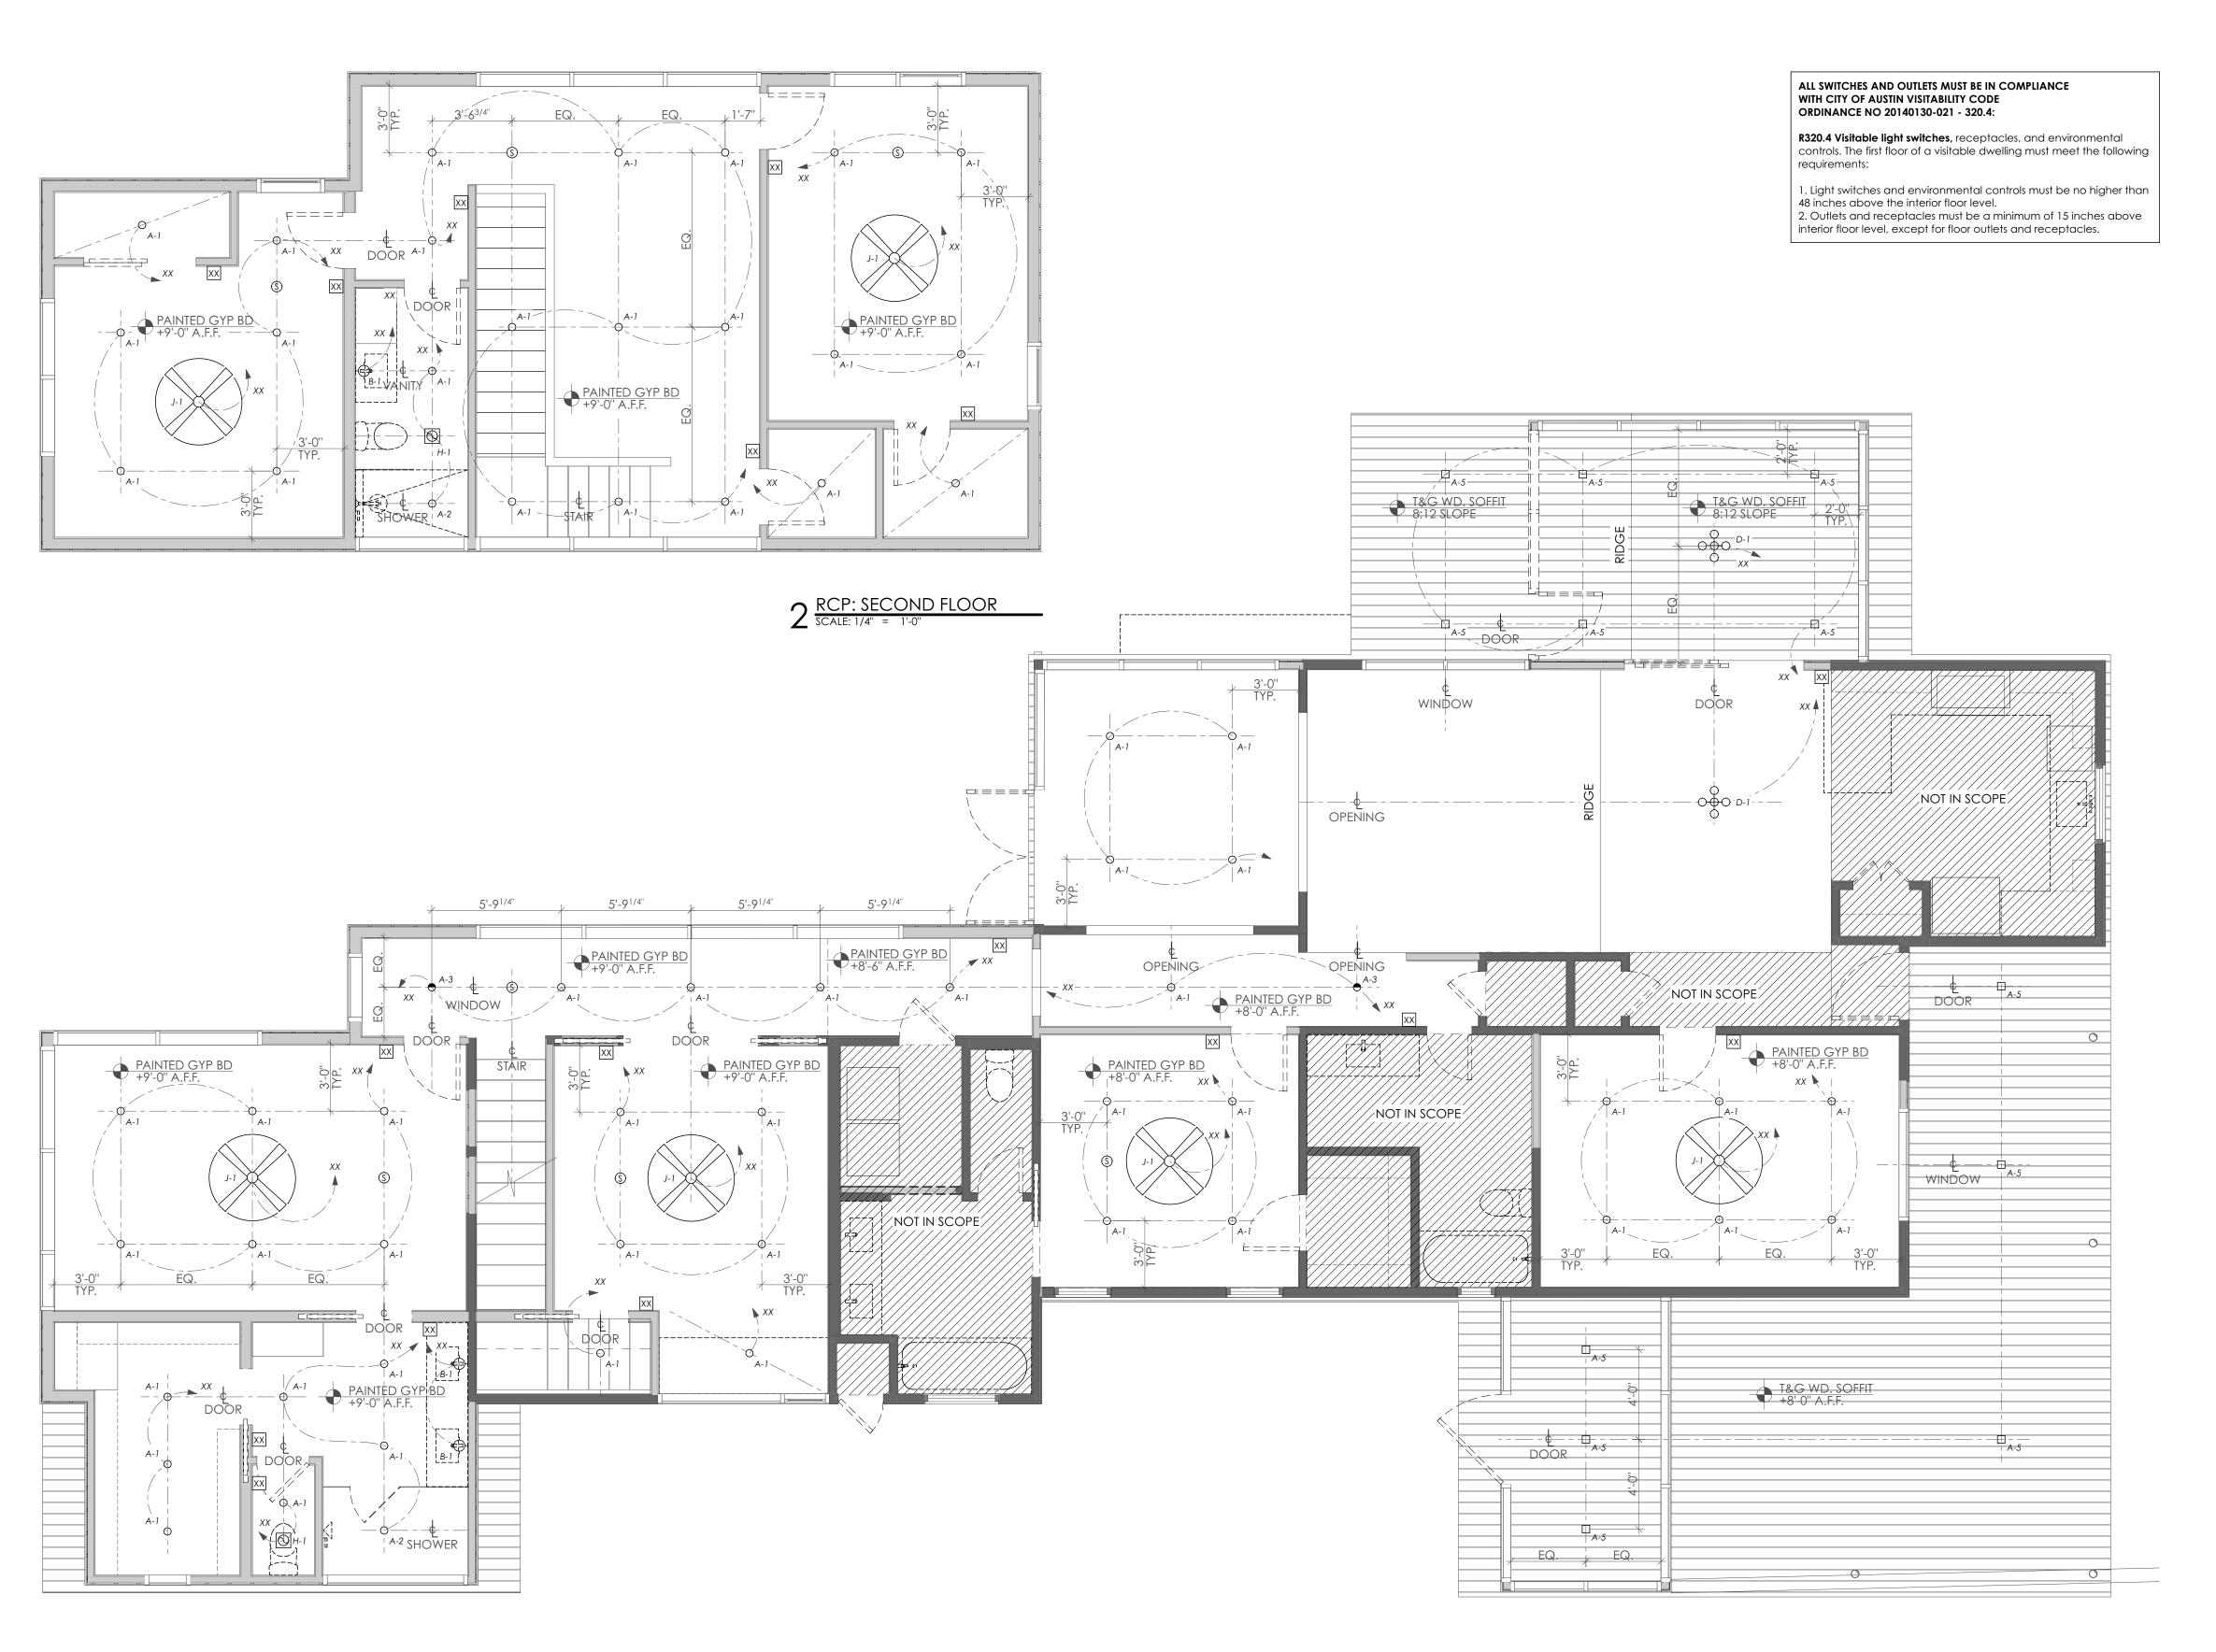
PLAN: SECOND FLOOR

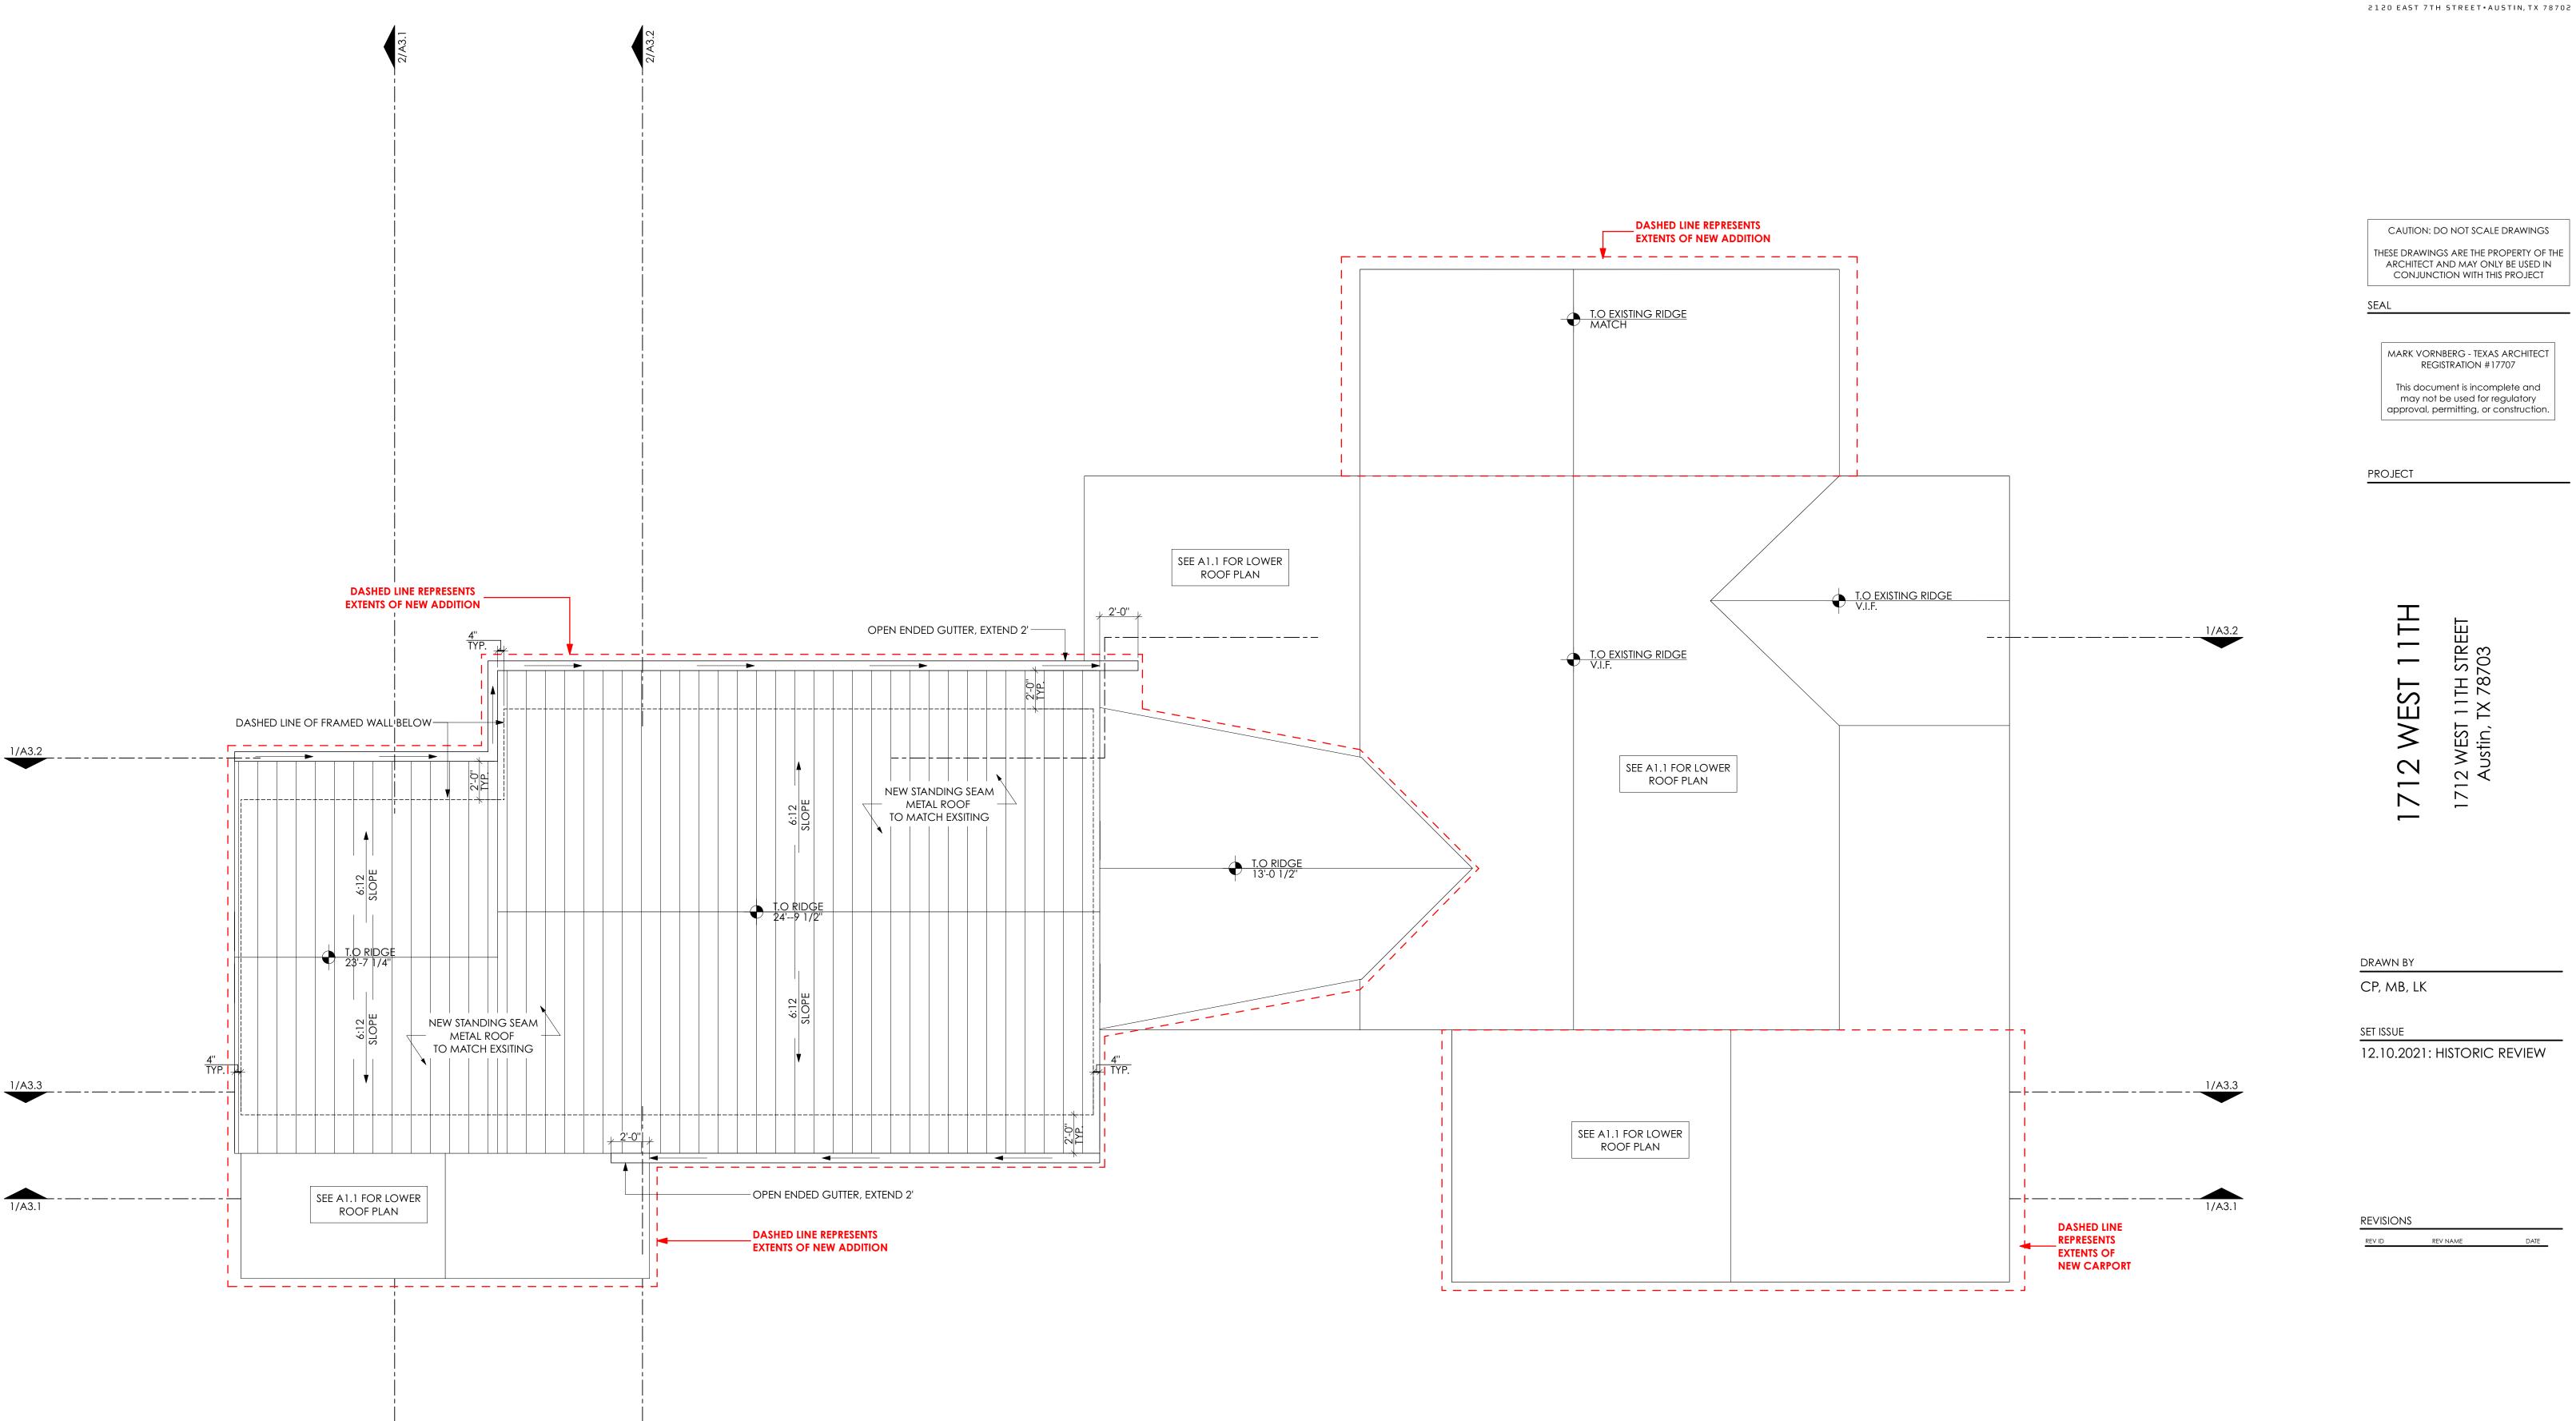

PLAN: ROOF

SHEET TITLE

A1.2



LIGHTING SCHEDULE										
KEY	TYPE	LOCATION	DESCRIPTION	SIZE	MANUFACTURER	MODEL / MODEL #	TRIM / FINISH	NOTES / REMARKS		
A-1	RECESSED CAN	GENERAL DOWNLIGHT, THROUGHOUT	3000K, 800LM, ROUND REFLECTOR W/ ROUND APERTURE	4" (ROUND)	NORA LIGHTING	IOLITE/NIO-4RNDC-30X-WW	WHITE			
A-2	RECESSED CAN: WET RATED	GENERAL DOWNLIGHT, THROUGHOUT	3000K, 800LM, ROUND REFLECTOR W/ ROUND APERTURE	4" (ROUND)	NORA LIGHTING	IOLITE/NIO-4RNDC-30X-WW	WHITE			
A-3	RECESSED CAN: DIRECTIONAL	GENERAL DOWNLIGHT, DIRECTIONAL	3000K, 800LM, ROUND ADJUSTABLE CONE	2" (ROUND)	NORA LIGHTING	IOLITE/NIOB-2RC-30X-WW	WHITE			
A-5	RECESSED CAN: SQUARE	WOOD CEILING - EXTERIOR	3000K, 800LM, SQUARE REFLECTOR W/ SQUARE APERTURE	4" (SQUARE)	NORA LIGHTING	iolite/nio-4sndsq-30x-bz	BRONZE			
B-1	WALL SCONCE: INTERIOR RATED	WALL MOUNTED - BATHS	LED BULB NOT INCLUDED, 60 WATT	22.5"H X 5"W	WORLEY'S LIGHTING	PEBBLE DOUBLE SCONCE 18"	CORNSILK OAK/MATTE BLACK/FROSTED BULB	VERIFY HEIGHT W/ ARCHITECT IN FIELD		
D-1	DECORATIVE PENDANT FIXTURE	CEILING MOUNTED - DINING	3000K, 95+ CRI, REMOTE, DIRECT CEILING MOUNT	75" L	JUNIPER	THIN MULTIPLES DYAD HORIZONTAL BLACK OXIDE		SEGMENT LENGTH: 36"; 2 CONNECTED SECTIONS		
H-1	EXHAUST FAN	WC EXHAUST FANS			PANASONIC	WHISPER GREEN FAN ONLY	WHITE			
J-1	CEILING FAN	CEILING FAN - INTERIOR		52"	THE MODERN FAN CO	CIRRUS DC/#CIR-BA-50-AL-355	BRUSHED ALUMINUM			

LIGHTING SCHEDULE

LIGHTING LEGEND SWITCH # WALL WASHER SQUARE WALL WASHER SURFACE MOUNTED FIXTURE PENDANT WALL SCONCE IN-GROUND UPLIGHT RECESSED CAN LIGHT RECESSED SQUARE CAN LIGHT (LINE UP W/ T&G CEILING) PIN HOLE RECESSED LIGHT FIXTURE STEP LIGHT FAN/LIGHT COMBO CHANDELIER PENDANT TRACK LIGHTING SYSTEM CEILING MOUNTED FLUORESCENT EXTERIOR SPOT LIGHT — - — CONTINUOUS LINEAR LIGHTING LANDSCAPE LIGHT CIRCUIT RECESSED CEILING EXHAUST FAN CEILING FAN OPENER GARAGE DOOR RECESSED WALL MOUNTED SPEAKERS CEILING MOUNTED SPEAKERS DOOR BELL SMOKE, HEAT OR IONIZATION DETECTOR

RCP NOTES

1. CEILING DEVICES AND LIGHTS SHOWN FOR LOCATION AND COORDINATION. REFER TO MECHANICAL AND ELECTRICAL DRAWINGS FOR INFORMATION ON ACTUAL CEILING DEVICES AND

AND ELECTRICAL DRAWINGS AS REQUIRED.

3. DIMENSIONS INDICATED ON THE REFLECTED CEILING PLAN ARE TO THE FACE OF STUD AND TO THE GRIDLINE OR CENTERLINE OF THE GRID TEE OR LIGHT FIXTURE, ETC.

4. VERIFY & COORDINATE ALL OUTLETS & SWITCHES WITH CASEWORK.

5. DO NOT SCALE DRAWINGS. IF DIMENSIONS ARE IN QUESTION, THE CONTRACTOR SHALL BE RESPONSIBLE FOR CLARIFICATION WITH ARCHITECT BEFORE CONTINUING WITH CONSTRUCTION.

7. REFER TO ELECTRICAL DRAWINGS FOR FIXTURE SCHEDULE AND ADDITIONAL

8. SCHEDULE WALK THRU & VERIFY LOCATIONS OF ALL ELECT. FIXTURE, OUTLET, PANEL, CABLE DATA, SMOKE DETECTOR SWITCH, ETC. W/ OWNER & ARCH. IN

9. ALL FIXTURES TO BE ALIGNED & SPACED AS SHOWN, PLAN FRAMING AS

12. ALL SWITCH PLATES TO BE MOUNTED AT 42" A.F.F. U.N.O. VERIFY WITH

BY CODE.

15. SWITCHES TO BE GANGED.

17. CONTRACTOR TO COORDINATE SECURITY/MEDIA/SOUND & COMPUTER SYSTEMS W/OWNER. CONTRACTOR TO PROVIDE NECESSARY ELECTRICAL

ACCORDING TO MANUF.

22. ALL FLUORESCENT LIGHTS TO BE WARM WHITE UNLESS OTHERWISE NOTED.

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REVISIONS

CARBON MONOXIDE DETECTOR

THERMOSTAT

CEILING HEIGHT AND MATERIAL CALL OUT

SOFFIT-MOUNTED CAMERA

2. COORDINATE ALL WORK WITH OTHER TRADES. REFER TO THE MECHANICAL

6. LIGHT FIXTURES TO BE CENTERED IN SOFFITS AND CEILING TILES UNLESS NOTED OTHERWISE.

INFORMATION.

FIELD FOR FINAL APPROVAL.

10. ALL SWITCH PLATES & WALL PLATES TO BE SELECTED BY OWNER & ARCH. 11. ALL SWITCHES, EXCEPT IN MECH. AREAS TO BE DIMMABLE.

CONTRACTOR & OWNER.

13. PROVIDE OWNER WITH ALL MANUF. INSTRUCTIONS. 14. CONTRACTOR TO PROVIDE GFI OUTLETS AT ALL WET AREAS AS REQUIRED

16. FOR EACH FIXTURE PROVIDE ALL NECESSARY PARTS (I.E. TRANSFORMERS, TRIM, LEADS, LAMPS, FITTINGS).

CONNECTIONS PER OWNER'S CONSULTANT.

18. EACH FIXTURE TO BE SUITABLE FOR INTENDED LOC. & INSTALLATION CONDITION, I.E. INSULATED CEILING, ADJUSTABLE CAN IN SLOPED CEILING, SAME TRIM SIZE/STYLE IN EACH SPACE OR CIRCUIT ETC.

19. ELECTRICIAN TO USE I.C. OR NON I.C. FIXTURE KITS AS REQUIRED.

20. ALL LIGHT FIXTURES LOCATED IN WET LOC. & CLOSETS SHALL HAVE WET-RATED LENS COVER & COMPLY W/ CODE REQUIREMENTS.


21. PROVIDE CORRECT HOUSING/PLATFORM FOR EACH RECESSED FIXTURE

RCP: FIRST & SECOND **FLOORS**

SHEET TITLE


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RCP: FIRST FLOOR

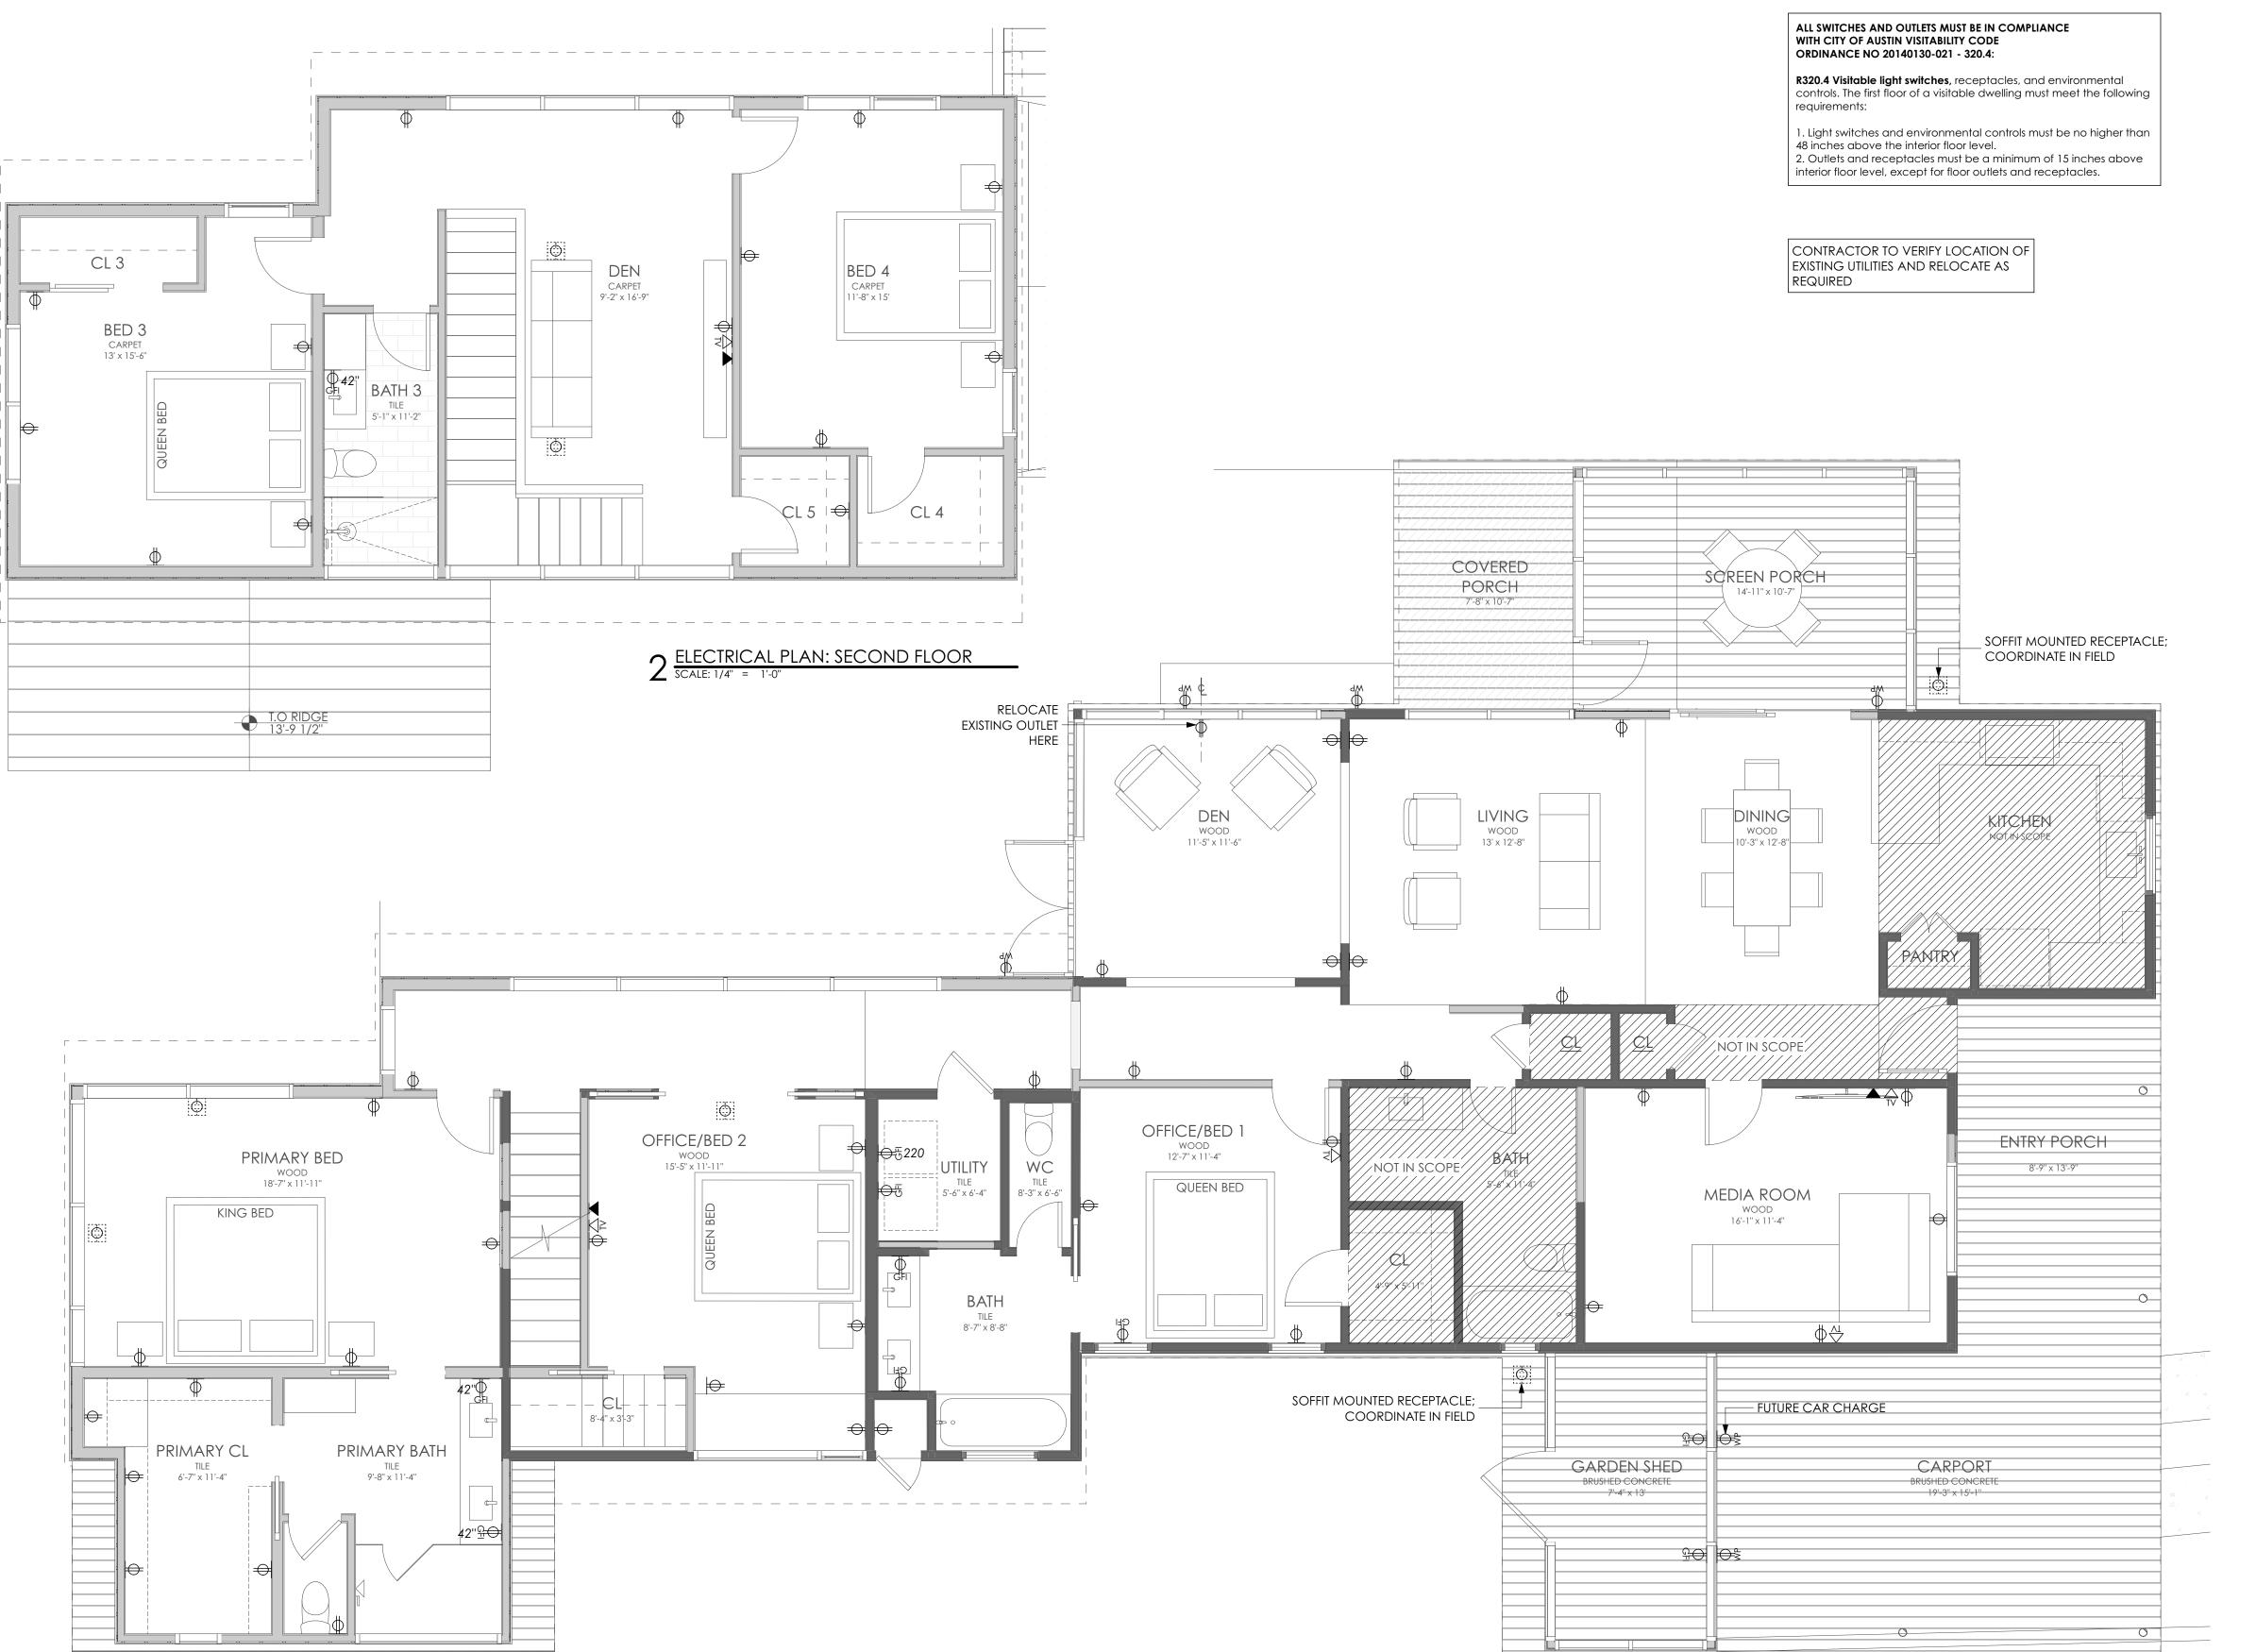

ELECTRICAL PLAN: FIRST FLOOR

SCALE: 1/4" = 1'-0"



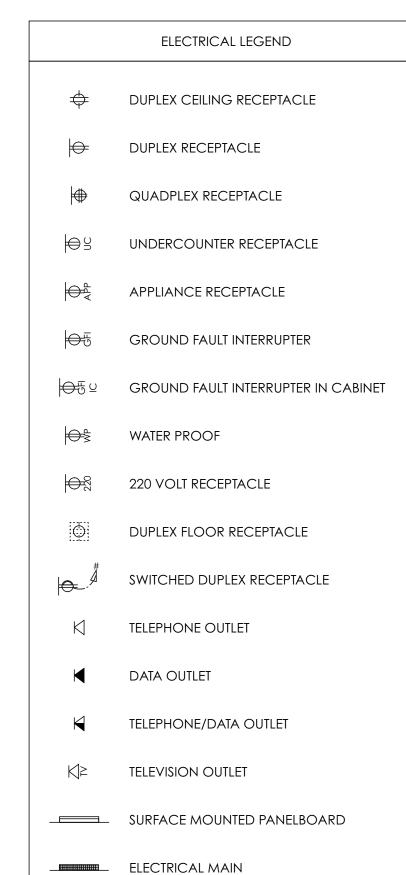

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712 WEST 11TH

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SHEET TITLE

ELECTRICAL PLAN: FIRST FLOOR

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NOTE MATERIALS LEGEND GRAY FILL INDICATES EXISTING TO REMAIN 12" WIDE VERTICAL METAL PANEL, FLAT PANEL; REF. SPEC (A0.01) DICK CLARK + ASSOCIATES HORIZONTAL HARDIE PANEL; REF. SPEC (A0.01) ARCHITECTURE • INTERIORS 512.472.4980 • WWW DCARCH COM 2120 EAST 7TH STREET · AUSTIN, TX 78702 VE OPTION: S-2 VERTICAL HARDIE PANEL; REF. SPEC (A0.01) COORDINATE PAINT COLORS W/ OWNER AND ARCHITECT ______ NEW STANDING SEAM METAL ROOF TO MATCH EXISTING NEW STANDING SEAM METAL HARDIE FASCIA TO ROOF TO MATCH EXISTING MATCH ROOFING EXISTING WOOD HARDIE FASCIA TO CONJUNCTION WITH THIS PROJECT SIDING TO REMAIN MATCH ROOFING METAL PANEL, M-1 — HARDIE PANEL, S-1 METAL FASICA TO MATCH MARK VORNBERG - TEXAS ARCHITECT STANDING SEAM METAL ROOF BRAKE METAL WRAP IN ALL COLUMN/CORNER This document is incomplete and WINDOW LOCATIONS, PTD — HARDIE PANEL, S-1 may not be used for regulatory TO MATCH WINDOWS approval, permitting, or construction. EXISTING METAL **ROOF TO REMAIN** PROJECT EXISTING FASCIA TO REMAIN EXISTING WOOD NEW GUARDRAIL BY SIDING TO REMAIN OTHERS, 36" TYP. BRAKE METAL WRAP IN ALL WEST 11TH COLUMN/CORNER WINDOW LOCATIONS, PTD TO MATCH TENT C STARTING POINT = 539.5' 0'-0" L1 ADDITION FIN. FLOOR A.A.G = 536.9' A.A.G = 536.9' NEW POOL -I A/C II POOL - STEEL COLUMN - NEW WOOD DECK | BELOW | | EQUIPMENT | | DECK || BELOW DECK WOOD DECK STRUCTURE; REF. STRUCTURAL BRAKE METAL WRAP IN ALL COLUMN/ BRAKE METAL WRAP IN ALL COLUMN/ CORNER WINDOW LOCATIONS, PTD -- CORNER WINDOW LOCATIONS, PTD TO MATCH WINDOWS TO MATCH WINDOWS METAL PANEL, M-1 INFILL IN METAL FRAME _____ DRAWN BY NEW STANDING SEAM METAL NEW STANDING SEAM METAL ROOF TO MATCH EXISTING CP, MB, LK ROOF TO MATCH EXISTING SET ISSUE 12.10.2021: HISTORIC REVIEW - EXISTING WOOD SIDING TO REMAIN +19'-6" T.O. L2 PLATE HARDIE FASCIA TO HARDIE FASCIA TO MATCH ROOFING MATCH ROOFING - EXISTING FASCIA TO REMAIN ─ HARDIE PANEL, S-1 EXISTING METAL ROOF TO REMAIN -NEW STANDING SEAM METAL ROOF TO MATCH EXISTING HARDIE PANEL, S-1 -METAL FASICA TO MATCH ROOFING REVISIONS +10'-6" L2 FIN. FLOOR HARDIE FASCIA TO MATCH ROOFING +9'-0" T.O. L1 PLATE HARDIE PANEL, S-1 -SHEET TITLE NEW STEEL COLUMNS EXTERIOR ELEVATIONS TENT C STARTING POINT = 539.5 BRAKE METAL WRAP IN ALL COLUMN/CORNER - EXISTING WOOD SIDING TO REMAIN -A.A.G = 536.9' WINDOW LOCATIONS, PTD TO MATCH WINDOWS _ Dashed line of Foundation for New Addition beyond BRAKE METAL WRAP IN ALL COLUMN/CORNER METAL PANEL, M-1 -WINDOW LOCATIONS, PTD TO MATCH WINDOWS

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NOTE

GRAY FILL INDICATES EXISTING TO REMAIN

MATERIALS LEGEND

M-1 12" WIDE VERTICAL METAL PANEL, FLAT PANEL; REF. SPEC (A0.01)


S-1 HORIZONTAL HARDIE PANEL; REF. SPEC (A0.01)


VE OPTION: S-2 VERTICAL HARDIE PANEL; REF. SPEC (A0.01)

COORDINATE DAINT COLORS W/ OWNER AND ARCHITECT

COORDINATE PAINT COLORS W/ OWNER AND ARCHITECT



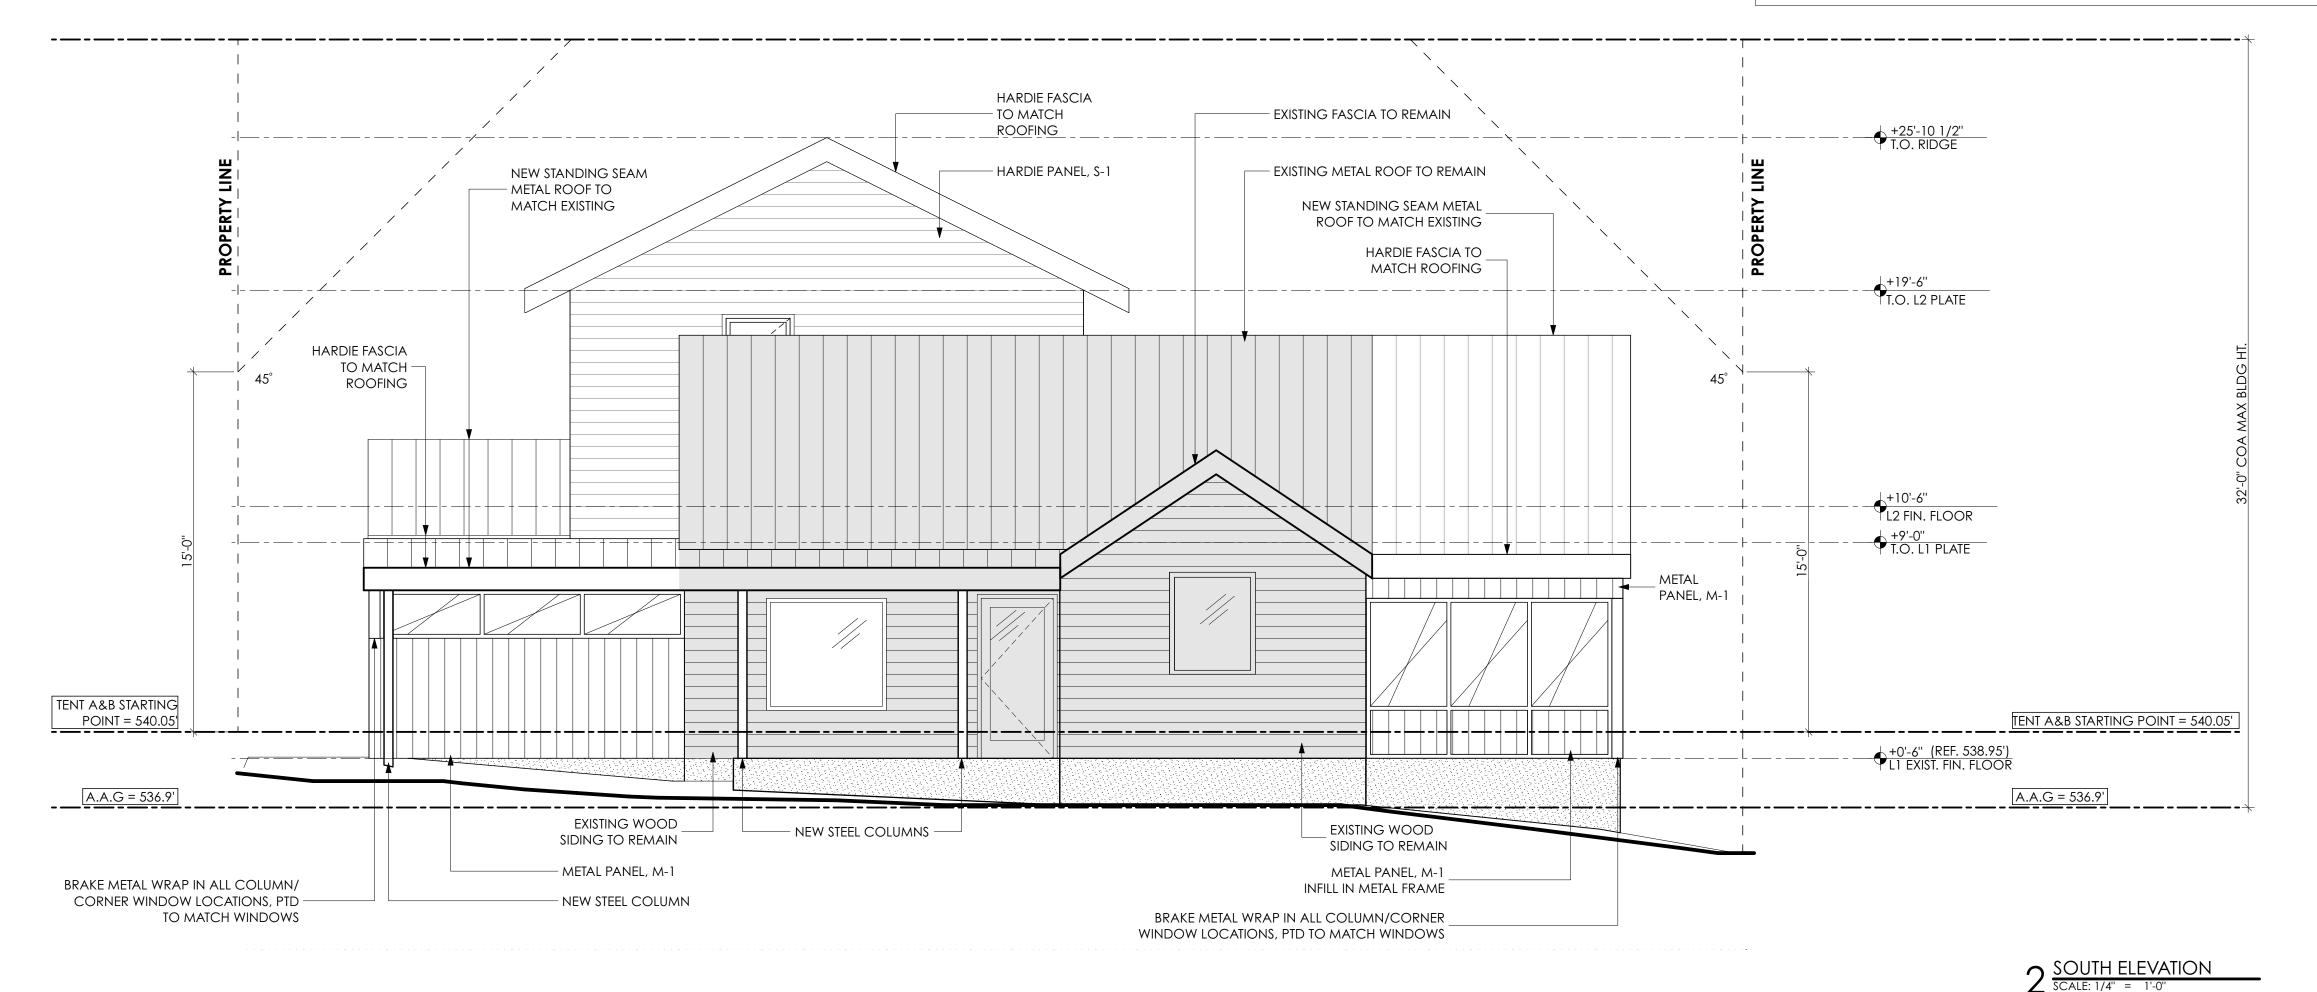

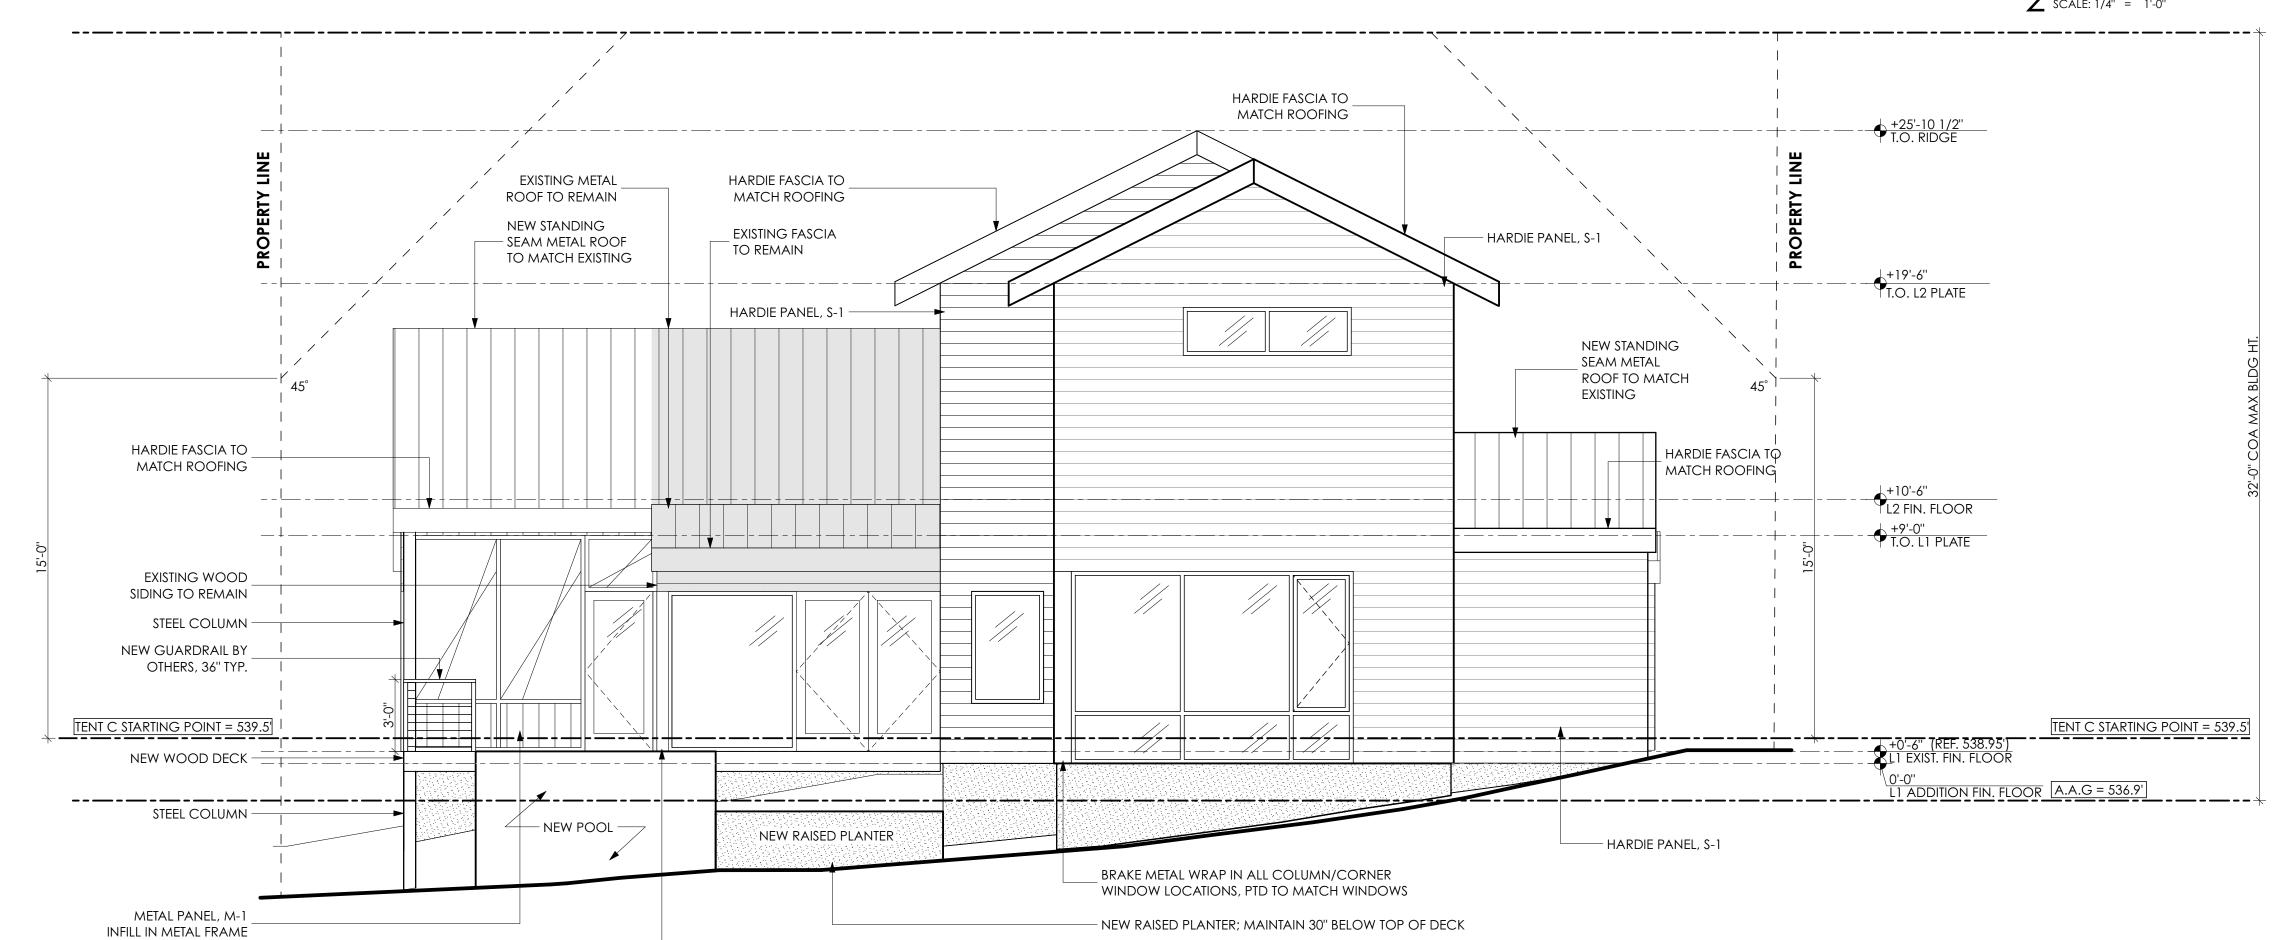

BRAKE METAL WRAP IN ALL COLUMN/

CORNER WINDOW LOCATIONS, PTD

TO MATCH WINDOWS

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/ ID REV NAME DAT

SHEET TITLE

NORTH ELEVATION
SCALE: 1/4" = 1'-0"

EXTERIOR ELEVATIONS


A2.2



STAINED WOOD SOFFIT



S-1: HARDIE PLANK LAP SIDING - GRAY SLATE

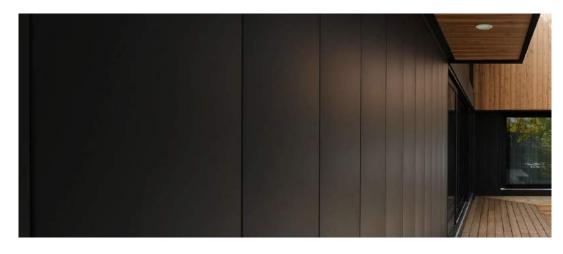

M-1: MAC METAL VERSA SIDING - TITANIUM BLACK

12" WIDE VERTICAL METAL PANEL, FLAT PANEL; REF. SPEC (A0.01)

HORIZONTAL HARDIE PANEL; REF. SPEC (A0.01)

VE OPTION: S-2 VERTICAL HARDIE PANEL; REF. SPEC (A0.01)

COORDINATE PAINT COLORS W/ OWNER AND ARCHITECT



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EXTERIOR ELEVATIONS -HISTORIC REVIEW

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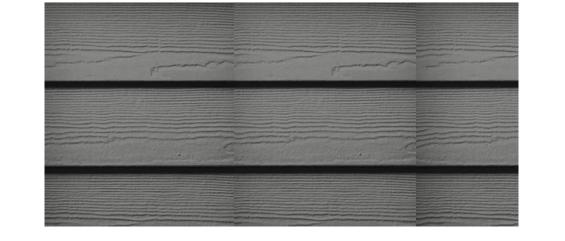
EXISTING SIDING: PTD WOOD SHIPLAP METAL ROOF TO MATCH EXISTING



WEST ELEVATION - RENDERED SCALE: 1:2.50



STAINED WOOD SOFFIT



S-1: HARDIE PLANK LAP SIDING - GRAY SLATE

EXISTING METAL ROOF TO REMAIN

M-1: MAC METAL VERSA SIDING _ COLOR: TITANIUM BLACK



M-1: MAC METAL VERSA SIDING - TITANIUM BLACK

MATERIALS LEGEND

12" WIDE VERTICAL METAL PANEL, FLAT PANEL; REF. SPEC (A0.01)

HORIZONTAL HARDIE PANEL; REF. SPEC (A0.01)

VE OPTION: S-2 VERTICAL HARDIE PANEL; REF. SPEC (A0.01)

COORDINATE PAINT COLORS W/ OWNER AND ARCHITECT



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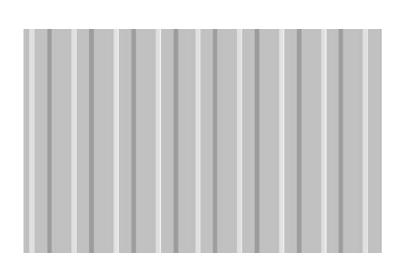
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EXISTING SIDING: PTD WOOD SHIPLAP



METAL ROOF TO MATCH EXISTING



METAL ROOF TO MATCH EXISTING :

S-1: HARDIE PLANK LAP SIDING COLOR: GRAY SLATE

EXISTING SIDING: PTD WOOD SHIPLAP

M-1: MAC METAL VERSA SIDING ______ COLOR: TITANIUM BLACK

2 EAST ELEVATION - RENDERED SCALE: 1:2.50

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EXTERIOR ELEVATIONS -HISTORIC REVIEW


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STAINED WOOD SOFFIT



S-1: HARDIE PLANK LAP SIDING - GRAY SLATE



M-1: MAC METAL VERSA SIDING - TITANIUM BLACK

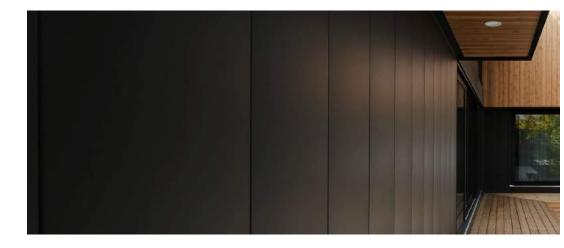12" WIDE VERTICAL METAL PANEL, FLAT PANEL; REF. SPEC (A0.01)

HORIZONTAL HARDIE PANEL; REF. SPEC (A0.01)

VE OPTION: S-2 VERTICAL HARDIE PANEL; REF. SPEC (A0.01)

COORDINATE PAINT COLORS W/ OWNER AND ARCHITECT



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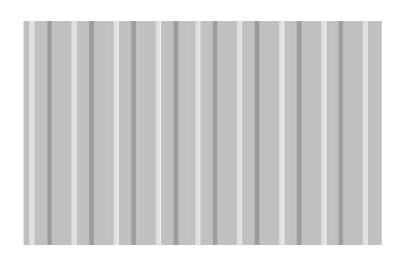
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PROJECT



EXISTING SIDING: PTD WOOD SHIPLAP



METAL ROOF TO MATCH EXISTING



2 SOUTH ELEVATION - RENDERED NOT TO SCALE



DRAWN BY CP, MB, LK

12.10.2021: HISTORIC REVIEW

EXTERIOR ELEVATIONS -HISTORIC REVIEW

12" WIDE VERTICAL METAL PANEL, FLAT PANEL; REF. SPEC (A0.01)

HORIZONTAL HARDIE PANEL; REF. SPEC (A0.01)

VE OPTION: S-2 VERTICAL HARDIE PANEL; REF. SPEC (A0.01)

COORDINATE PAINT COLORS W/ OWNER AND ARCHITECT



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12.10.2021: HISTORIC REVIEW

EXTERIOR ELEVATIONS -HISTORIC REVIEW







PROPOSED

A2.6

12" WIDE VERTICAL METAL PANEL, FLAT PANEL; REF. SPEC (A0.01)

HORIZONTAL HARDIE PANEL; REF. SPEC (A0.01)

VE OPTION: S-2 VERTICAL HARDIE PANEL; REF. SPEC (A0.01)

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12.10.2021: HISTORIC REVIEW

EXTERIOR ELEVATIONS -HISTORIC REVIEW







<u>PROPOSED</u>

M-1 12" WIDE VERTICAL METAL PANEL, FLAT PANEL; REF. SPEC (A0.01)

S-1 HORIZONTAL HARDIE PANEL; REF. SPEC (A0.01)

VE OPTION: S-2 VERTICAL HARDIE PANEL; REF. SPEC (A0.01)

COORDINATE PAINT COLORS W/ OWNER AND ARCHITECT



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PROJECT

12 WEST 11TH STREET

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SET ISSUE

12.10.2021: HISTORIC REVIEW

REVISIONS

REV ID REV NAME DATE

SHEET TITLE

EXTERIOR ELEVATIONS -HISTORIC REVIEW

Friday, December 10, 2021 | 9:47 AM








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712 WEST 11TH



BUILDING SECTION A

SCALE: 1/4" = 1'-0"

Friday, December 10, 2021 | 9:47 AM

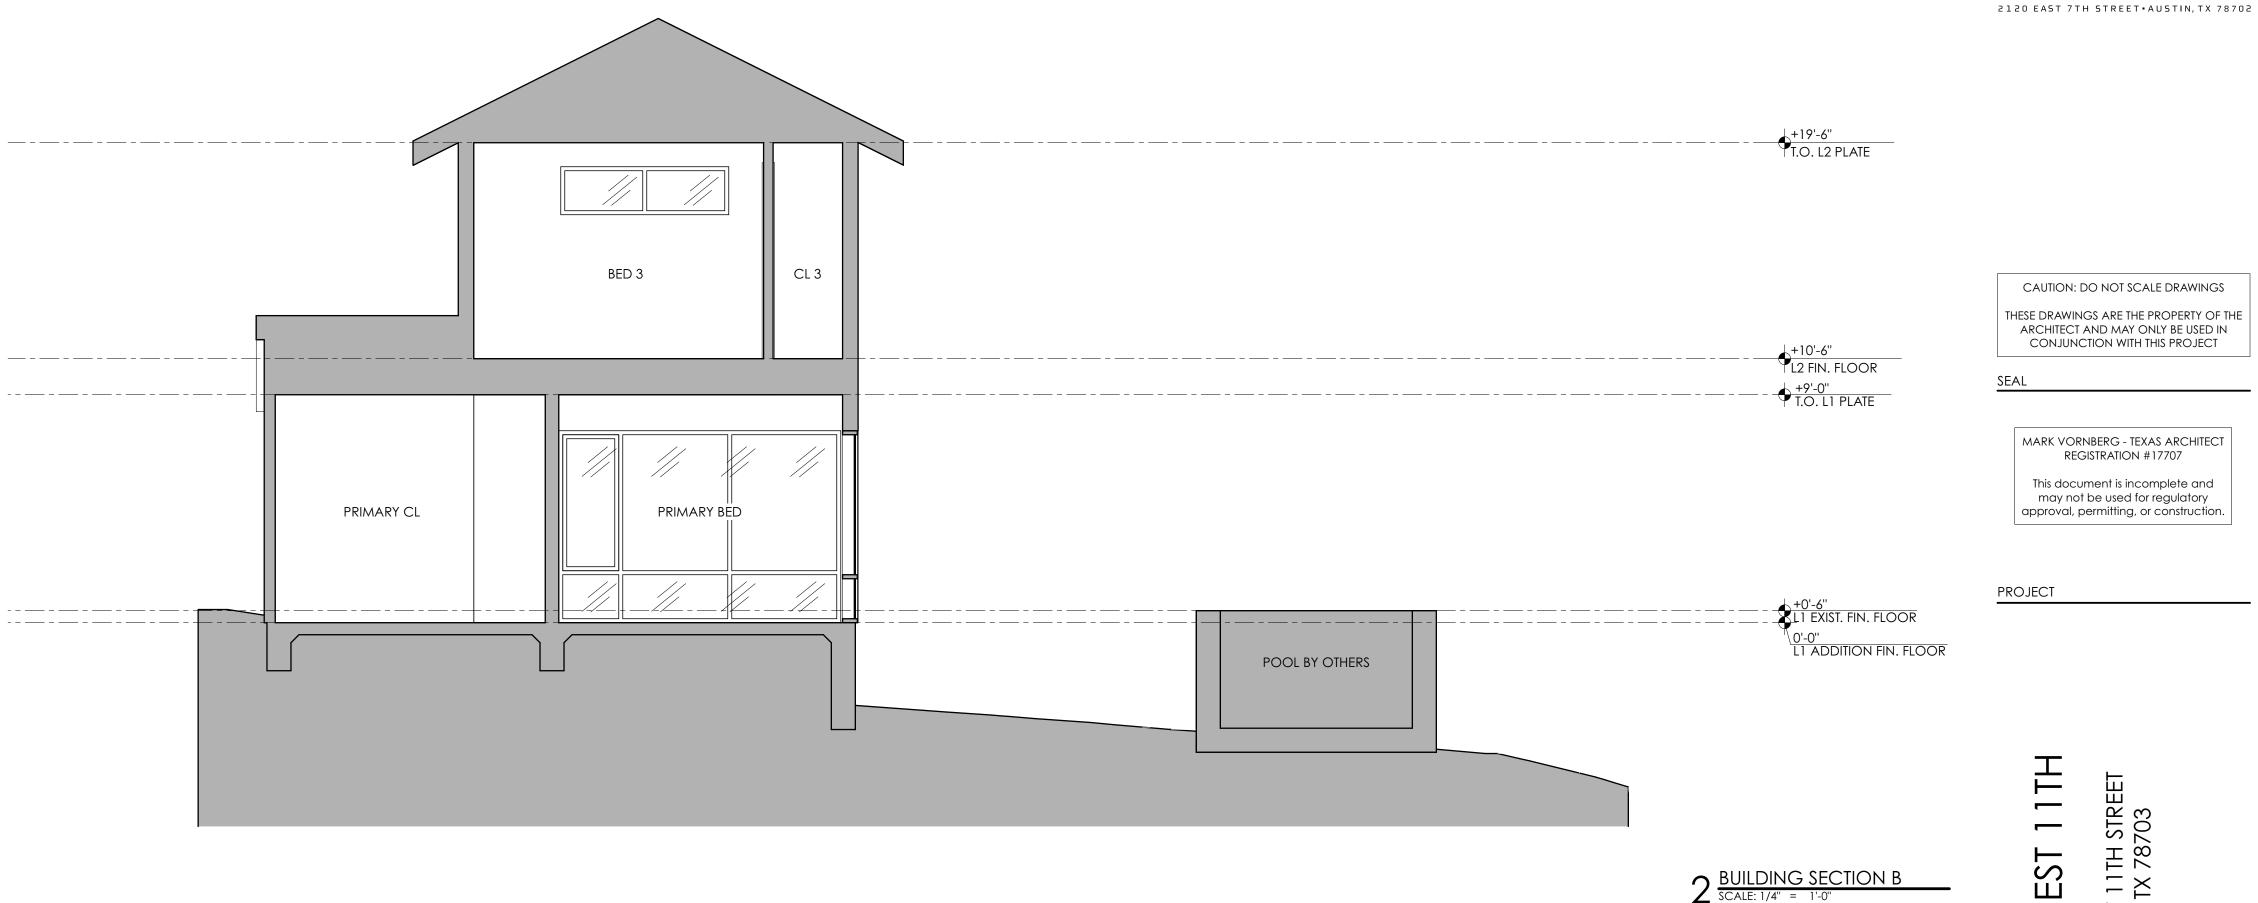

 KITCHEN (NOT IN SCOPE) DINING

OPEN TO ENTRY \
BEYOND

DICK CLARK + ASSOCIATES

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A3 2




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PROJECT

712 WEST 11TH



BUILDING SECTION E

SCALE: 1/4" = 1'-0"

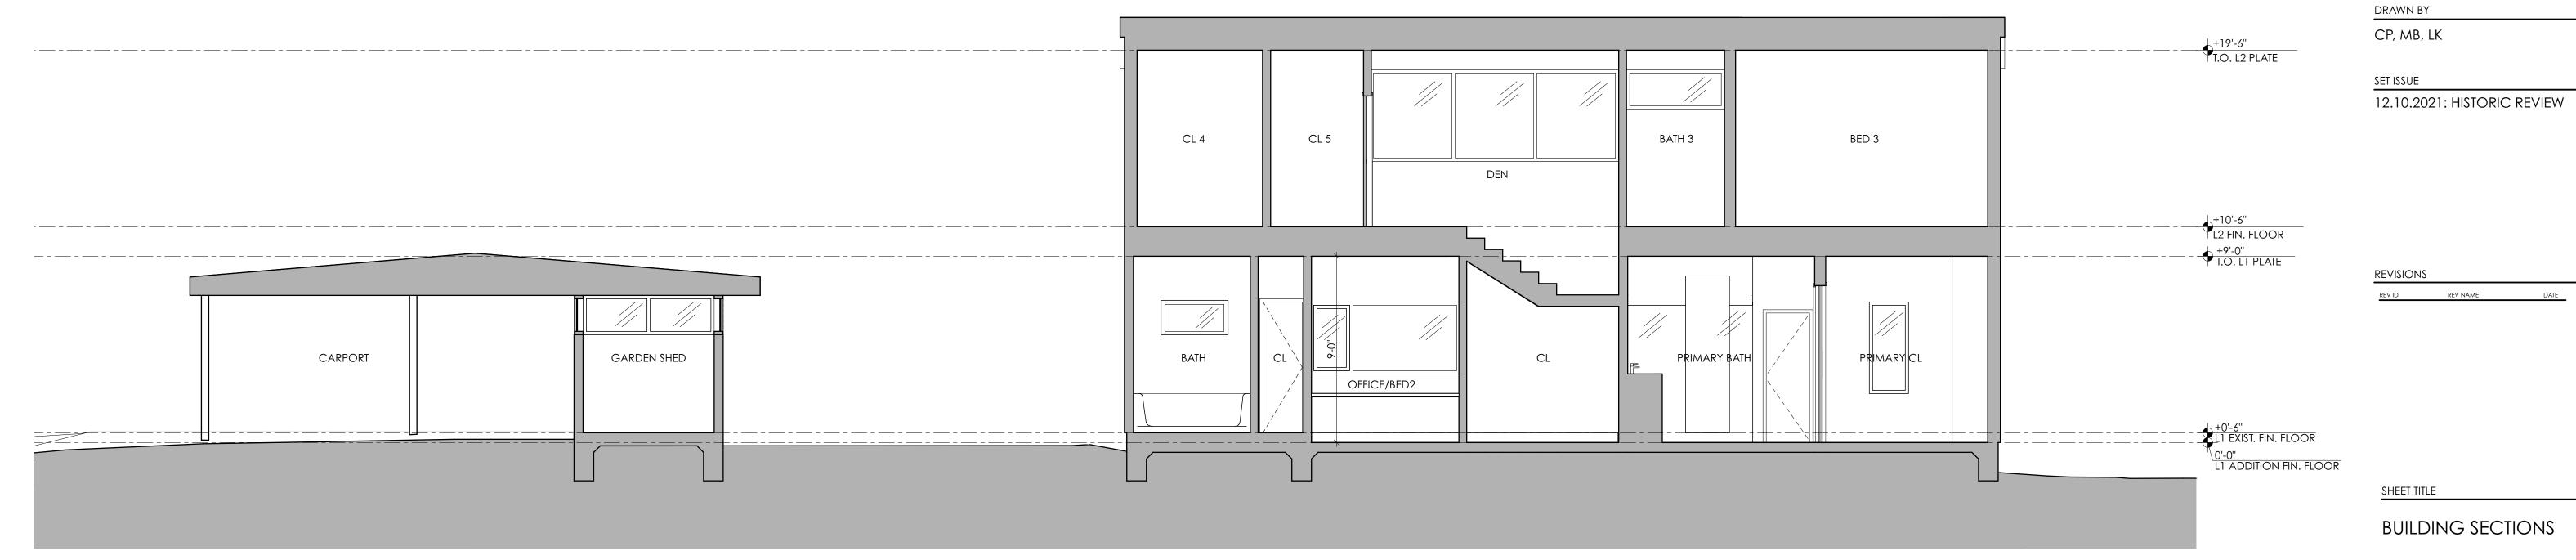A3.3



DOOR TYPES

GENERAL NOTES:

GLAZING NOTES:

SECTION R308.4.

1. CONTRACTOR TO VERIFY ALL REQUIRED EGRESS

2. CONTRACTOR TO VERIFY QUANTITY OF DOORS.

1. GLAZING IN HAZARDOUS LOCATIONS TO BE TEMPERED SAFETY GLASS AS REQUIRED BY IRC 2015

PRIOR TO ORDERING & FABRICATION WITH PARTICULAR ATTENTION TO FLOOR-TO-CEILING &

3. PROVIDE EMERGENCY ESCAPE & RESCUE

WALL-TO-WALL CONFIGURATIONS.

R310.1 WHERE REQUIRED.

2. VERIFY ALL WINDOW & DOOR DIMENSIONS IN FIELD

OPENINGS IN COMPLIANCE WITH IRC 2015 SECTION

DOOR SCHEDULE											
ID	SIZE (WxH)	LOCATION	MATERIAL	FINISH	OPERATION	DOOR TYPE	HARDWARE		*NO DOORS REQUIRE FIRE RATINGS, PROVIDE SAFETY GLAZING IN ALL DOORS A PER IRC R308.4		
							LOCK	HANDLE	DETAILS	NOTES	
D1	3'-0"×6'-8"	ENTRY PORCH	ALUMINUM + GLASS	FLUSH, PTD.	SWING	-	DEADBOLT	LEVER	-		
D3	8'-0"×6'-8"	SCREEN PORCH	ALUMINUM + GLASS	PREFINISHED	SLIDER	2 PANEL, OX	PER MANUFACTURER	-	-		
D4	6'-0"×6'-8"		-	FLUSH, PTD.	DBL SWING	-	-	-	-		
D5	2'-6"×6'-8"	OFFICE/BED 1	SC WOOD INTERIOR	FLUSH, PTD.	SWING	-	PRIVACY	LEVER	-		
D6	6'-0"×6'-8"	OFFICE/BED 2	SC WOOD INTERIOR	FLUSH, PTD.	POCKET, BI-PART	-	PRIVACY	LEVER	-		
D7	2'-6"×6'-8"	CL 2	SC WOOD INTERIOR	FLUSH, PTD.	POCKET	-	-	-	-		
D8	2'-6"×6'-8"	PRIMARY BED	SC WOOD INTERIOR	FLUSH, PTD.	SWING	-	PRIVACY	LEVER	-		
D9	2'-6"×6'-8"	PRIMARY BATH	SC WOOD INTERIOR	FLUSH, PTD.	POCKET	-	PRIVACY	FACE+JAMB PULL	-		
D10	2'-4''×6'-8''	PRIMARY WC	SC WOOD INTERIOR	FLUSH, PTD.	SWING	-	PRIVACY	LEVER	-		
D11	2'-6''×8'-0''	PRIMARY CLOSET	SC WOOD INTERIOR	FLUSH, PTD.	POCKET	-	-	FACE+JAMB PULL	-		
D12	2'-6''×6'-8''	BED 3	SC WOOD INTERIOR	FLUSH, PTD.	SWING	-	PRIVACY	LEVER	-		
D13	5'-0''×8'-0''	CL 3	SC WOOD INTERIOR	FLUSH, PTD.	POCKET, BI-PART	-	-	FACE+JAMB PULL	-		
D14	2'-6"×6'-8"	BATH 3	SC WOOD INTERIOR	FLUSH, PTD.	SWING	-	PRIVACY	LEVER	-		
D15	2'-6"×6'-8"	CL 5	SC WOOD INTERIOR	FLUSH, PTD.	SWING	-	-	LEVER	-		
D16	2'-6"×6'-8"	BED 4	SC WOOD INTERIOR	FLUSH, PTD.	SWING	-	PRIVACY	LEVER	-		
D17	2'-6"×6'-8"	CL 4	SC WOOD INTERIOR	FLUSH, PTD.	SWING	-	-	LEVER	-		
D18	9'-10 ^{1/2} "×6'-8"	SCREEN PORCH	-	PREFINISHED	SWING	-	-	FACE PULL	-	SCREEN DOOR INTEGRAL WITH ADJACENT FRAMED SCREENS	
D19	4'-0''×7'-0''	GARDEN SHED	HOLLOW METAL	PREFINISHED	SWING	_	DEADBOLT	LEVER	-		

REVISIONS

SHEET TITLE

DOOR & WINDOW SCHEDULES

A/.I