

For Office Use Only Date of Submission:		
Case #:		
 Historic Preservation	Office approval	
Date of Approval:		

Historic Review Applicat	tion
NOUNDED 1839	Historic Preservation Office approval
	Date of Approval:
Property Address: 804 Rutherford Pl	
Historic Landmark Historic District (Local)	National Register Historic District
Historic Landmark or Historic District Name: Travis Heights	
Applicant Name: Ryan Rodenberg Phone #: 5	512-796-5995 Email: ryan@rodenbergdesign.con
	State: TX Zip: 78704
Please describe all proposed exterior work with location and m	naterials. If you need more space, attach an additional sheet.
PROPOSED WORK	LOCATION OF PROPOSED PROPOSED MATERIAL(S) WORK
1) New construction of single family house and ADU	Entire lot ———————————————————————————————————
2)	
3)	
existing and proposed conditions for alterations and add	a) specify materials and finishes to be used, and b) show ditions. Plan Roof Plan
Elevation(s) proposed to be modified Any changes to these plans must b Historic Preservation Office and/or	
Applicant Signature:	Date: 12/30/21
Outside a soulist and the soulist and the state of a soulist	on retion @ quetinto you gove Call (E42) 074 2202 with a continue

Submit complete application, drawings, and photos to preservation@austintexas.gov. Call (512) 974-3393 with questions.



Design Standards and Guidelines for Historic Properties

Adopted December 2012

Design Standards and Guidelines for Historic Properties

Landmarks and National Register historic district properties

If you are making changes to a historic landmark, the project *must* comply with these standards to receive a Certificate of Appropriateness. If you are making changes to a contributing property or constructing a new building within a National Register historic district, consider the standards below as advisory guidelines:

- 1. Use a property for its historic purpose or place it in a new use that requires minimal change to the defining characteristics of the building and its site and environment.
- 2. Retain and preserve the historic character or a property shall be retained and preserved. Avoid the removal of historic materials or alteration of features and spaces that characterize a property.
- 3. Recognize each property as a physical record of its time, place, and use. Changes that create a false sense of historical development, such as adding conjectural features or architectural elements from other buildings, shall not be undertaken.
- 4. Most properties change over time; those changes that have acquired historic significance in their own right shall be retained and preserved.
- 5. Distinctive features, finishes, and construction techniques or examples of craftsmanship that characterize a historic property shall be preserved.
- 6. Deteriorated historic features shall be repaired rather than replaced. Where the severity of deterioration requires visual qualities and, where possible, materials. Replacement of missing features shall be substantiated by documentary, physical, or pictorial evidence.
- 7. Chemical or physical treatments, such as sandblasting, that cause damage to historic materials shall not be used. The surface cleaning of structures, if appropriate, shall be undertaken using the gentlest means possible.
- 8. Significant archaeological resources affected by a project shall be protected and preserved. If such resources must be disturbed, mitigation measures shall be undertaken.
- 9. New additions, exterior alterations, or related new construction shall not destroy historic materials that characterize the property. The new work shall be differentiated from the old and shall be compatible with the massing, size, scale, and architectural features to protect the historic integrity of the property and its environment.
- 10. New additions and adjacent or related new construction shall be undertaken in such a manner that if removed in the future, the essential form and integrity of the historic property and its environment would be unimpaired.

Local historic district properties

If you are making changes to a contributing property or constructing a new building in a local historic district, the project *must* comply with the design standards established for that district to receive a Certificate of Appropriateness. Visit the Historic Preservation Office website to view your district's design standards: http://www.austintexas.gov/department/historic-preservation.

What Type of Work Requires a Certificate of Appropriateness?

Certificates of Appropriateness (COAs) are required for exterior changes or additions to historic landmarks, any property pending designation as a landmark, and contributing buildings in local historic districts; or if you are constructing a new building in a local historic district. Work requiring a COA includes:

- 1. Additions
- 2. Construction of new buildings, including outbuildings
- 3. Window and door replacement
- 4. Exterior siding replacement
- 5. Replacement of roof materials with a different material
- 6. Site changes such as a pool, deck, fence, or back porch enclosure

Ordinary repair and maintenance projects do *not* require a Certificate of Appropriateness. For more information, see the historic review process charts on the <u>Historic Preservation Office website</u>.







Rear





VERIFY SIZES AND HEAD HEIGHT W/ PLANS AND ELEVATIONS; CONTACT DESIGNER W/ ANY DISCREPANCIES: TEMPER NOT SPECIFIED

WINDOW WINDOW	# SIZE	HEAD HEIGHT	TYPE	COMMENTS	
A	6'0"X5'0"	9'0"	FIXED		
<u></u> В	2'0"X3'0"	9'0"	FIXED		
C	4'0"X8'0"	9'0"	FIXED		
D	4'0"X8'0"	9'0"	FIXED		
E	10 %00		TIXED		
 F	4'0"X8'0"	9'0"	FIXED		
G	3'0"X8'0"	9'0"	FIXED		
Н	3'0"X8'0"	9'0"	FIXED		
I	4'0"X8'0"	9'0"	FIXED		
J	4'0"X8'0"	9'0"	FIXED		
K	4'0"X8'0"	9'0"	FIXED		
L	5'0"X6'0"	7'6"	FIXED		
М	3'0"X6'0"	7'6"	CASEMENT	EGRESS	
N	2'0"X3'0"	7'6"	FIXED		
0	3'0"X6'0"	8'0"	CASEMENT	EGRESS	
Р	5'0"X6'0"	8'0"	FIXED		
Q	4'0"X6'0"	8'0"	FIXED		
R	2'6"X6'0"	8'0"	FIXED		
S	2'6"X6'0"	8'0"	FIXED		
Т	5'0"X6'0"	8'0"	FIXED		
U	4'0"X3'0"	HEADER	FIXED		
V	4'0"X3'0"	HEADER	FIXED		
W	4'0"X3'0"	HEADER	FIXED		
X	3'0"X7'0"	8'0"	FIXED		
Υ	2'0"X3'0"	8'0"	FIXED		
Z	2'0"X3'0"	7'0"	FIXED		
AA	8'0"X7'0"	7'0"	FIXED		
BB	3'0"X6'0"	7'0"	CASEMENT	EGRESS	
CC					
DD					
EE					

DOOR #	HEDULE SIZE	INT / EX	COMMENTS	
1	8'X8'0"	EX	GARAGE	
2	3'0"X8'0"	EX	ACCESSIBLE ROUTE DOOR - ADA THRESHOLD	
3	2'8"X8'0"	INT	ACCESSIBLE ROUTE DOOR	
4	3'0"X9'0"	EX	FULL LITE FRONT DOOR	
5	2'6"X8'0"	INT		
6	8'0"X9'0"	EX	2 PANEL SLIDER	
7	4'0"X8'0"	INT	DOUBLE DOORS	
8	2'6"X8'0"	INT		
9	2'6"X8'0"	INT		
10	4'0"X8'0"	INT	DOUBLE DOORS	
11	2'6"X8'0"	INT		
12	5'0"X8'0"	INT	DOUBLE DOORS	
13	2'6"X8'0"	INT		
14	8'0"X8'0"	EX	2 PANEL SLIDER	
15	2'6"X8'0"	INT		
16	2'6"X8'0"	INT	POCKET DOOR	
17	2'4"X8'0"	INT		
18	3'0"X9'0"	EX	FULL LITE FRONT DOOR	
19	8'0"X8'0"	EX	2 PANEL SLIDER	
20	2'6"X8'0"	INT		
21	2'6"X8'0"	INT		
22	4'0"X8'0"	INT	DOUBLE DOORS	
23				
24				
25				
26				
OR NO	TES		•	

PROJECT

804 RUTHERFORD PL

OWNER


NASH GARRISON

REVISIONS

NO ISSUE DATE 1 PERMIT 11/26/20

NOTES

SEAL & SIGNATURE

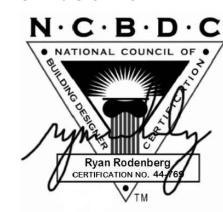

DESIGNER

—0

RODENBERG DESIGN

1702 EVERGREEN DR AUSTIN, TX 78704 512-796-5995 RYAN@RODENBERGDESIGN.COM

STRUCTURAL ENGINEER

SEC SOLUTIONS LLC MARCOS DEQUEIROGA, PE 407 FOREST STREET LIBERTY HILL, TX 78642 512-215-4364

SHEET TITLE

SCHEDULES

SHEET NUMBER


A0.2


COVERED 67 SF - COVERED PORCH 77 SF GARAGE 200 SF TST FLOOR D 284 SF WD DECK 84 SF 1ST FLOOR 940 SF WATER 288 SF


1/16" = 1'-0" @ 22x34 1/32" = 1'-0" @ 11x17

COPING 76 SF

02 Area Calculations

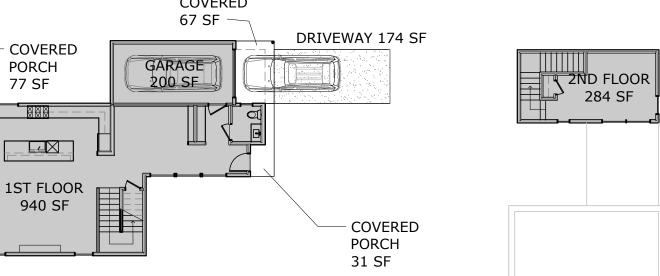

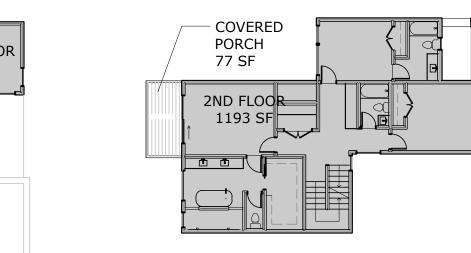

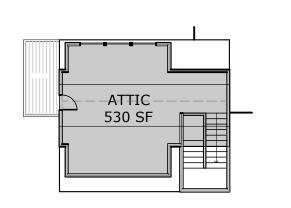

Visitability Notes


- 1. Light switches and environmental controls to be installed maximum 48" above the interior floor level.
- 2. Outlets and receptacles to be installed minimum 15" above interior floor level (except for floor outlets).

Visitability Entrance

- 1. Door to be 3'-0" x 8'-0"minimum.
- 2. Landing to be 3'-0" x 3'-0" minimum with maximum slope of $\frac{1}{4}$ "/ft.
- 3. If foundation plan shows more than 1 ½" drop, design professional must provide threshold detail.


Visitability Bathroom

- 1. Door to be 3'-0" x 8'-0"
- above finish floor (except behind lavatory).

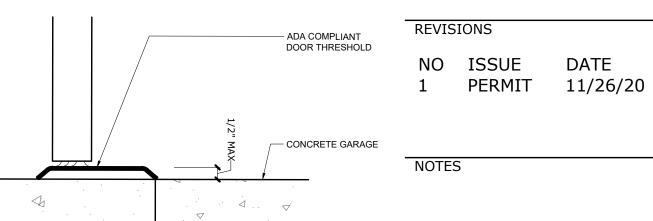

3" = 1'-0" @ 22x34 1 1/2" = 1'-0" @ 11x17

- minimum.
- 2. 2x6 blocking, centerline at 34"

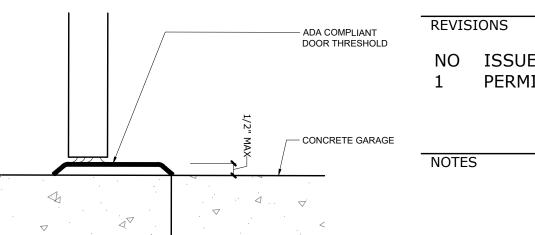

03 Threshold Detail at Entrance

SEAL & SIGNATURE $N \cdot C \cdot B \cdot D \cdot C$


PROJECT

OWNER

NASH GARRISON

804 RUTHERFORD PL

DATE

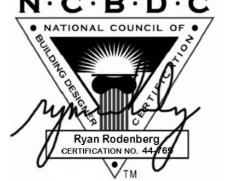

RODENBERG DESIGN

1702 EVERGREEN DR AUSTIN, TX 78704 512-796-5995 RYAN@RODENBERGDESIGN.COM

STRUCTURAL ENGINEER


SEC SOLUTIONS LLC MARCOS DEQUEIROGA, PE 407 FOREST STREET LIBERTY HILL, TX 78642 512-215-4364

SHEET TITLE

SITE PLAN


SHEET NUMBER

A1.0

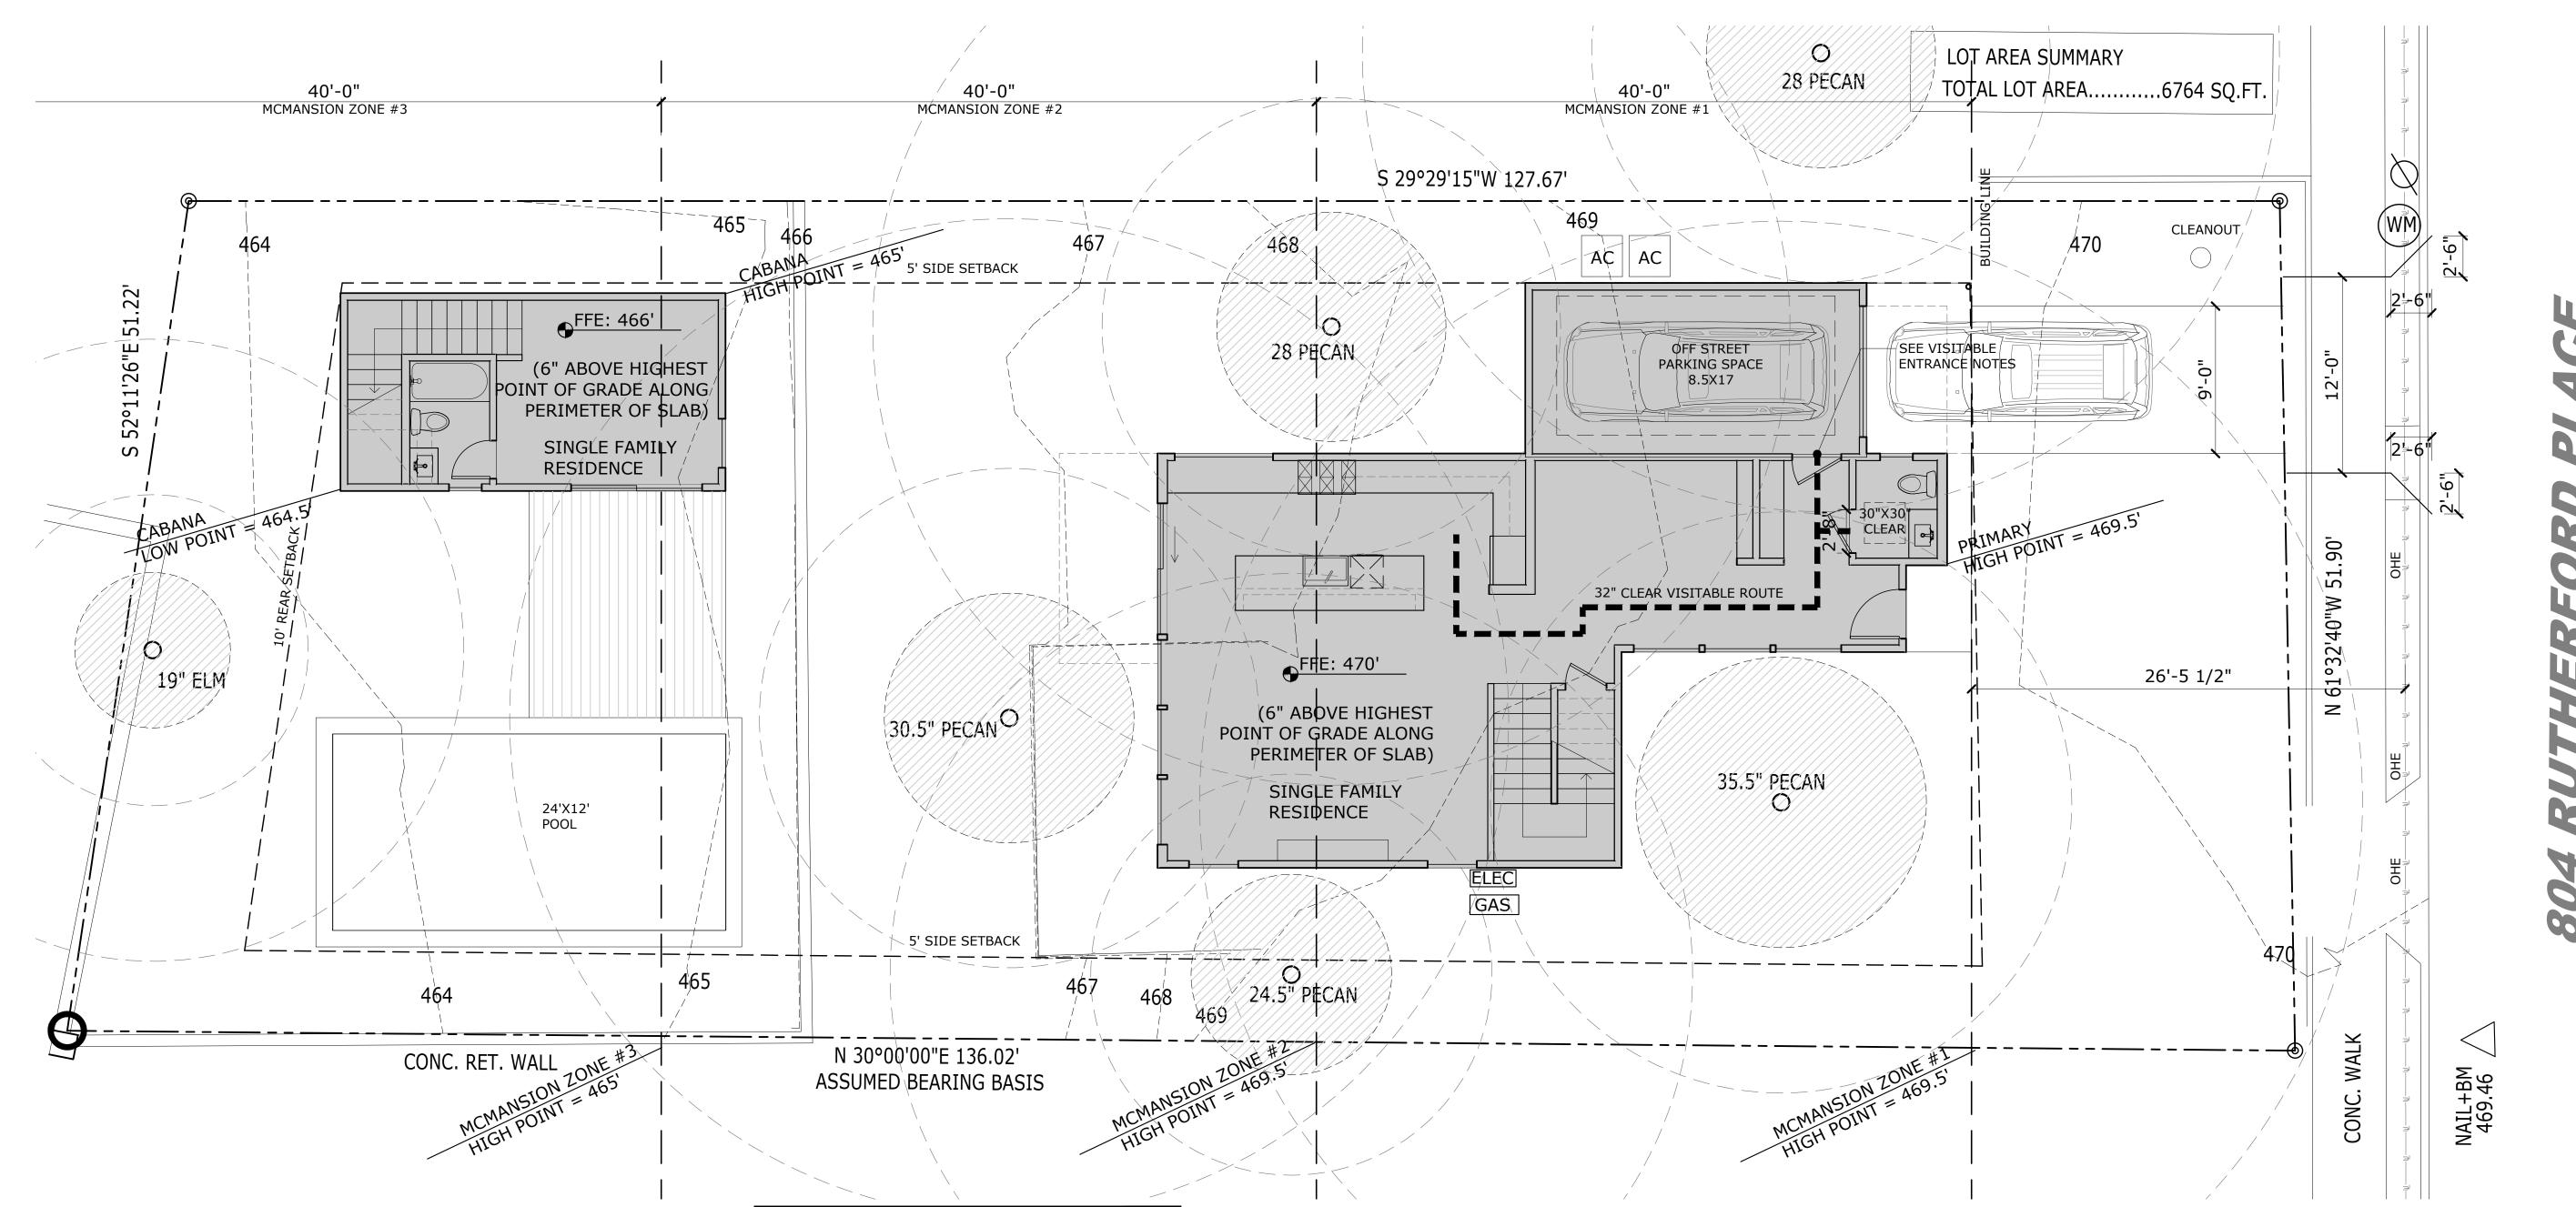

01 Site Plan

1/8" = 1'-0" @ 22x34 1/16" = 1'-0" @ 11x17

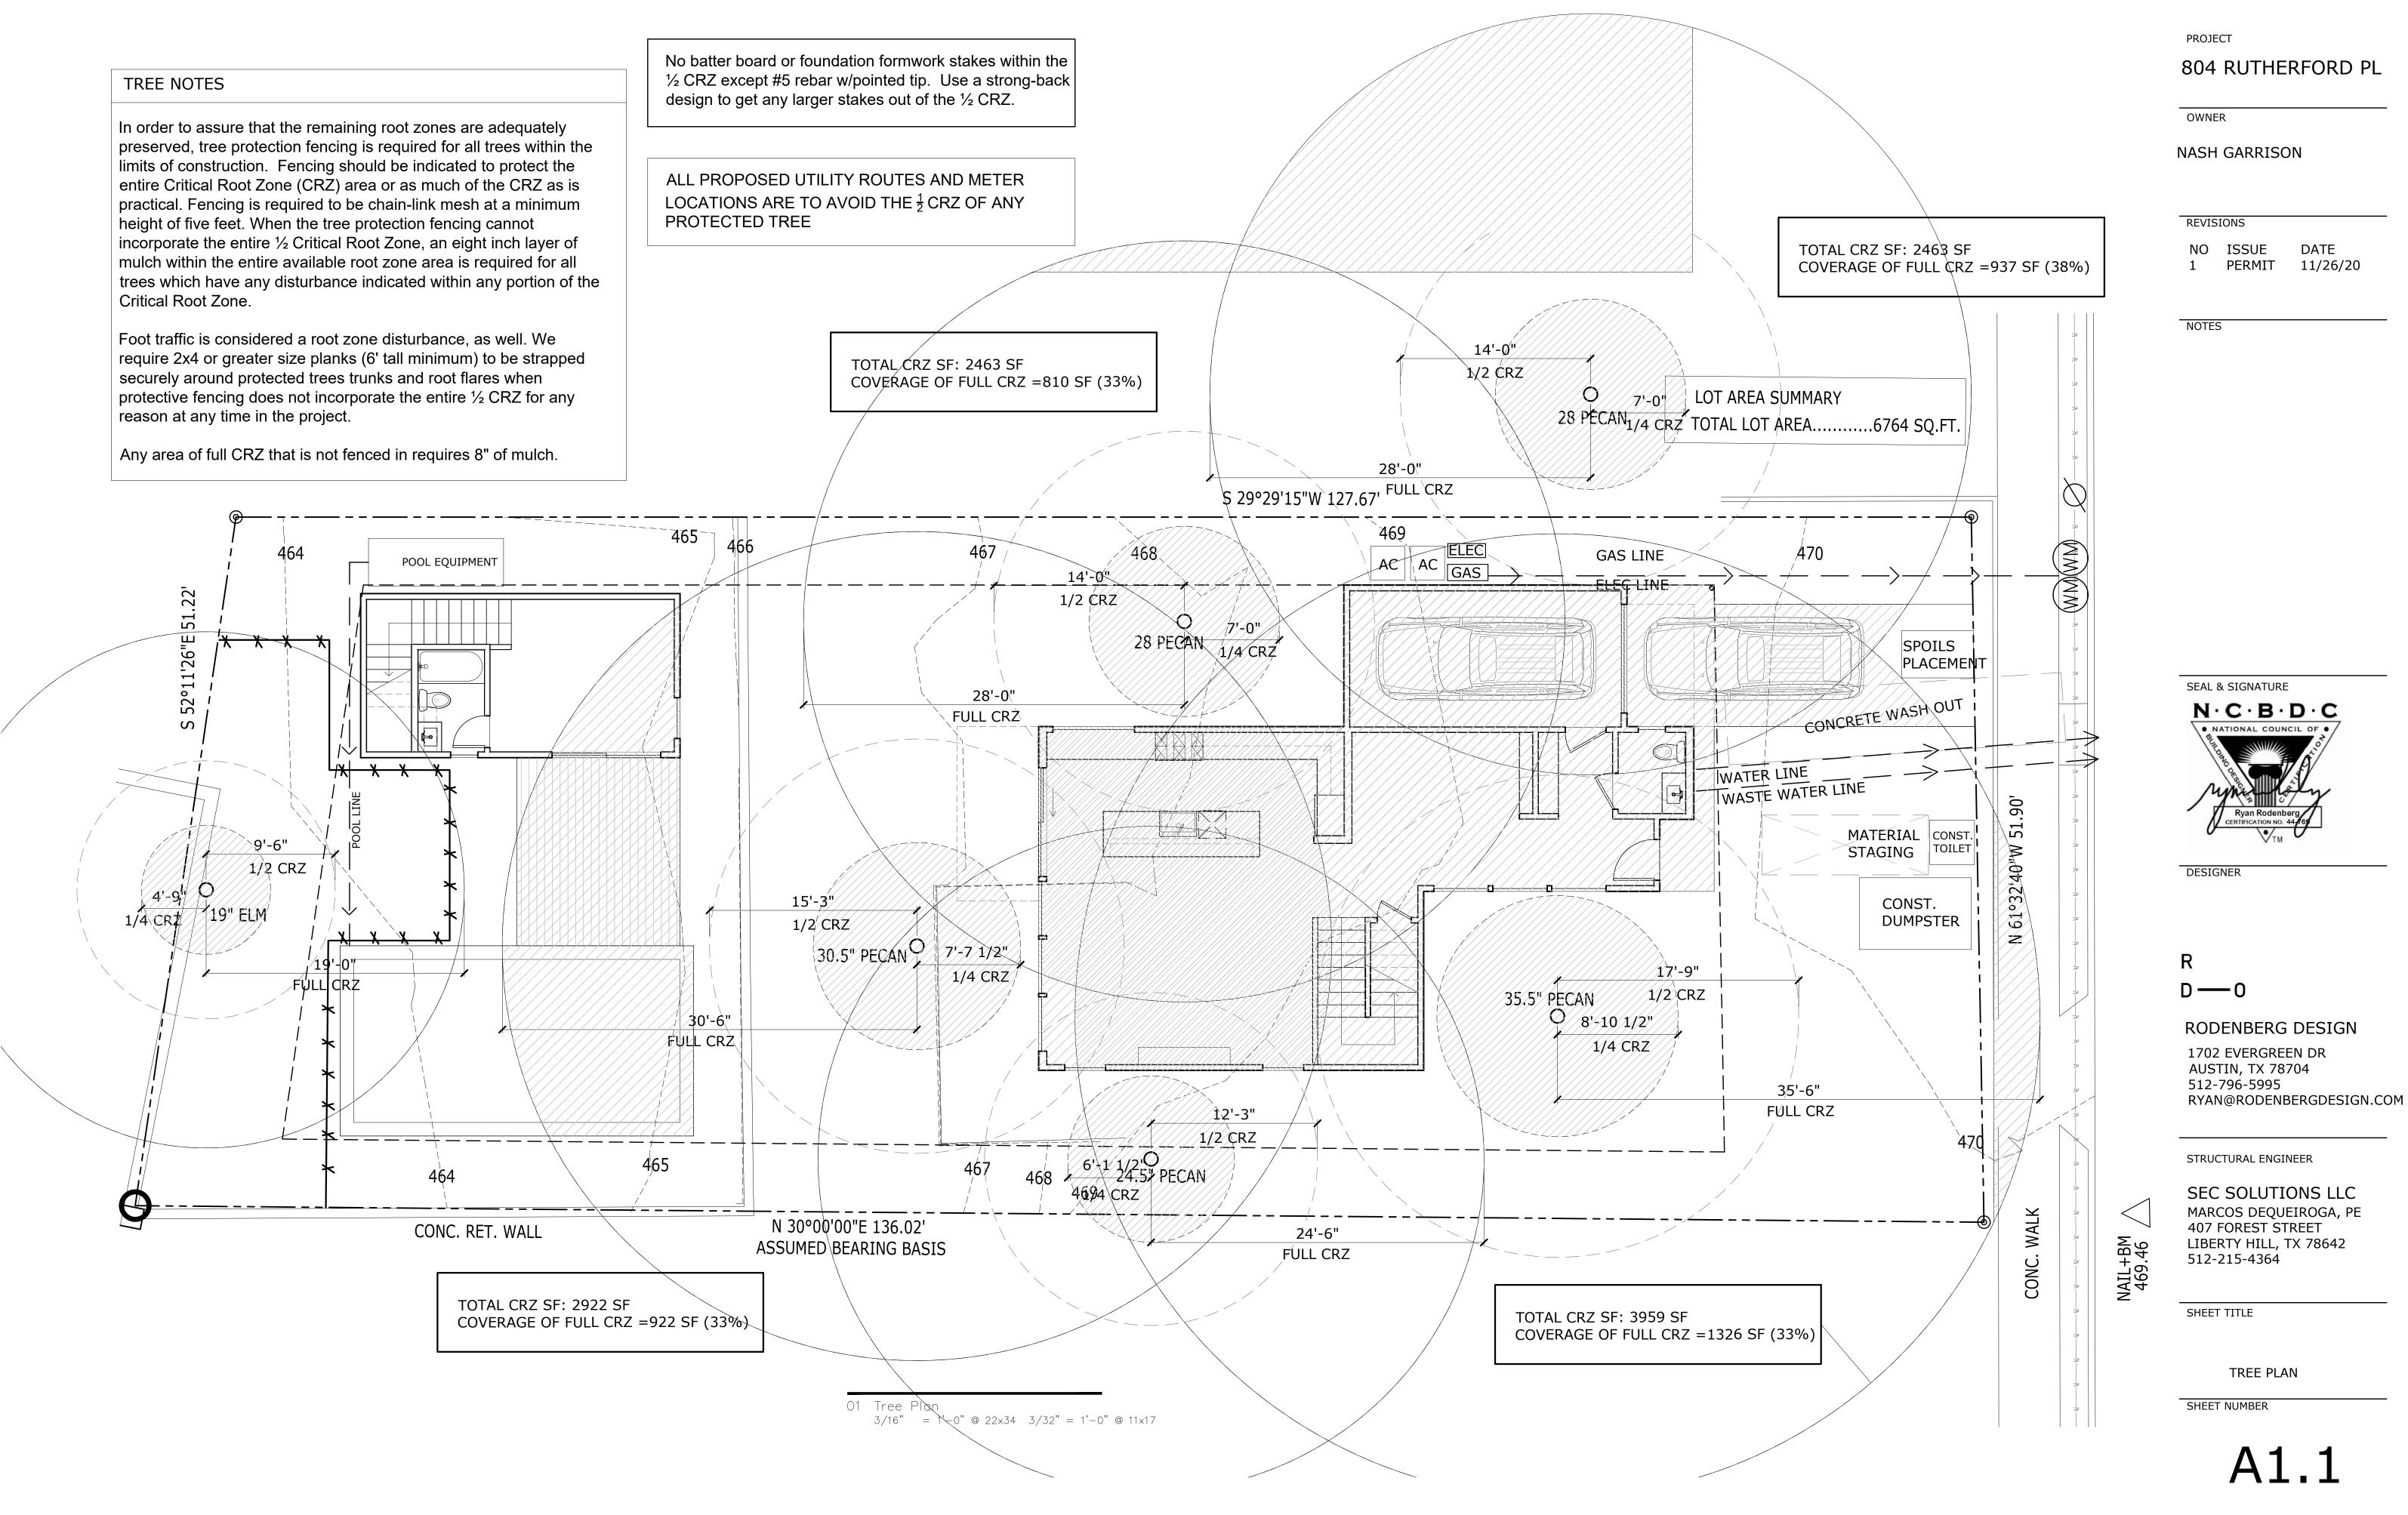

All rights reserved. All designs, drawings, plans & specifications are the property of RODENBEG D/D LLC. Purchaser's rights are conditional & limited to a one-time use to construct a single project on the site & use is limited to a one-time use to construct a single project on the site & use is limited to a one-time use to construct a single project on the site & use is limited specifically to such property. The use or reproduction of these plans concerning any other construction is strictly prohibited without the written permission of RODENBERG D/D LLC.

- All walls to be 2x4; plumbing walls to be 2x6; insulate exterior walls, R-19 min.
- 2. All doors to be 96" height
- 3. 5" gypsum board throughout 4. Green board in showers and
- wet areas
 5. Shoot all plates w/ 2x
 Ramset w/in 6" of cut

Plan Notes


- All egress windows and doors to comply with 2015 IRC R310.1, R311.2, R312.2
 Stairs, handrails, and
- 2. Stairs, handrails, and guardrails to comply with 2015 IRC R311.5.1, R311.7, R312.1
- 3. First floor of new construction with any living space to comply with all visitability standards under city code section 25-12-243, R320. Visitability items are referenced on floor plans


Legend

CM Smok

Smoke detector installed in accordance with IRC 2015 R314

Carbon monoxide detector installed in accordance with IRC 2015 R315

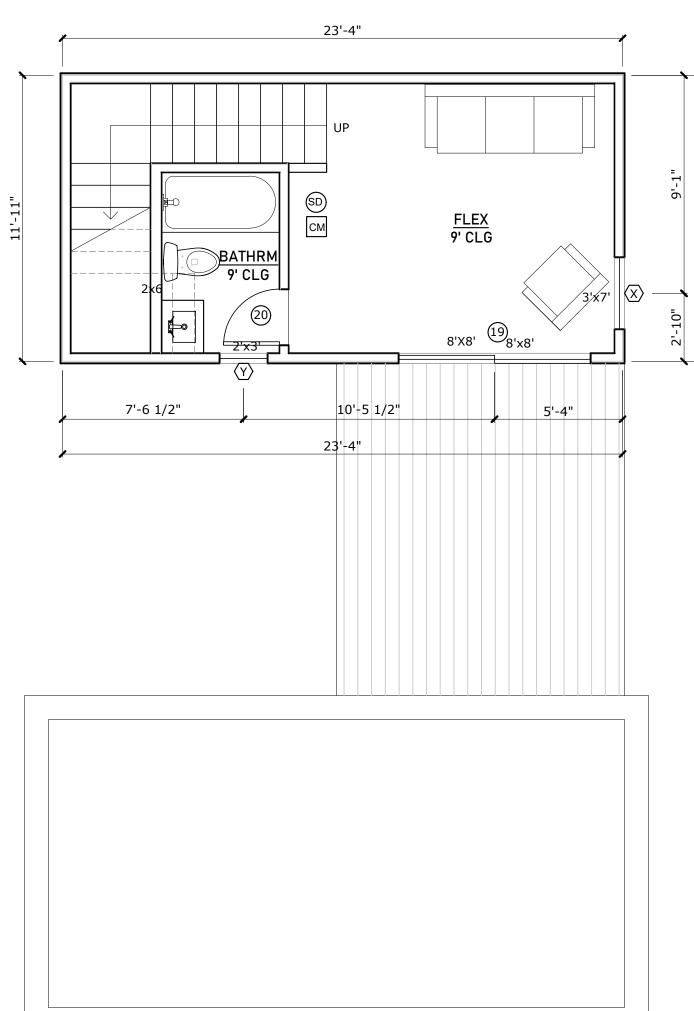

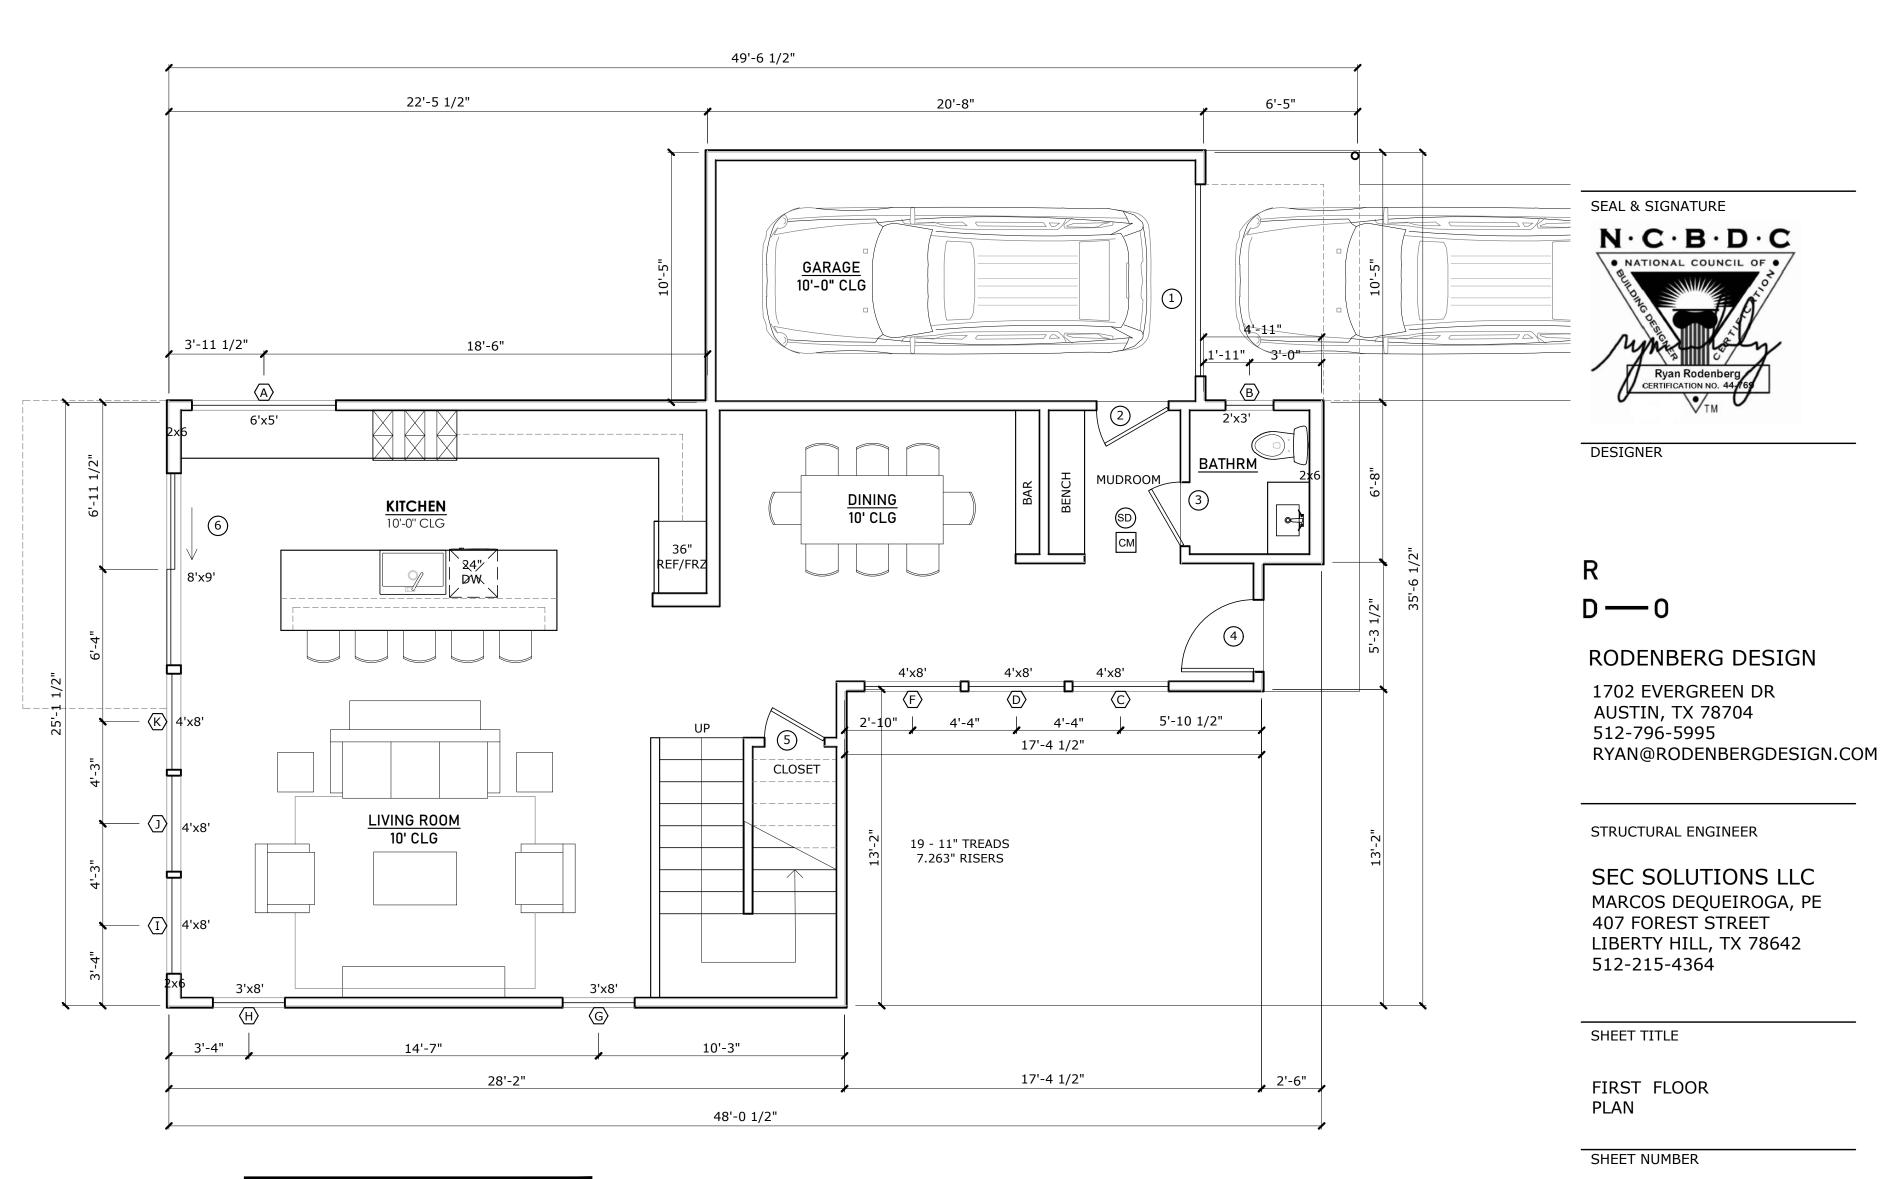

PROJECT

804 RUTHERFORD PL

OWNER

NASH GARRISON

REVISIONS

NO ISSUE DATE 1 PERMIT 11/26/20

NOTES

01 First Floor Plan 1/4" = 1'-0" @ 22x34 1/8" = 1'-0" @ 11x17

- 1. All walls to be 2x4; plumbing walls to be 2x6; insulate exterior walls, R-19 min.
- 2. All doors to be 96" height
- 3. § gypsum board throughout 4. Green board in showers and wet areas
- 5. Shoot all plates w/ 2x Ramset w/in 6" of cut

Plan Notes


- 1. All egress windows and doors to comply with 2015 IRC R310.1, R311.2, R312.2
- 2. Stairs, handrails, and guardrails to comply with 2015 IRC R311.5.1, R311.7, R312.1
- 3. First floor of new construction with any living space to comply with all visitability standards under city code section 25-12-243, R320. Visitability items are referenced on floor plans


Legend

Smoke detector installed in accordance with IRC 2015

R314

Carbon monoxide detector installed in accordance with

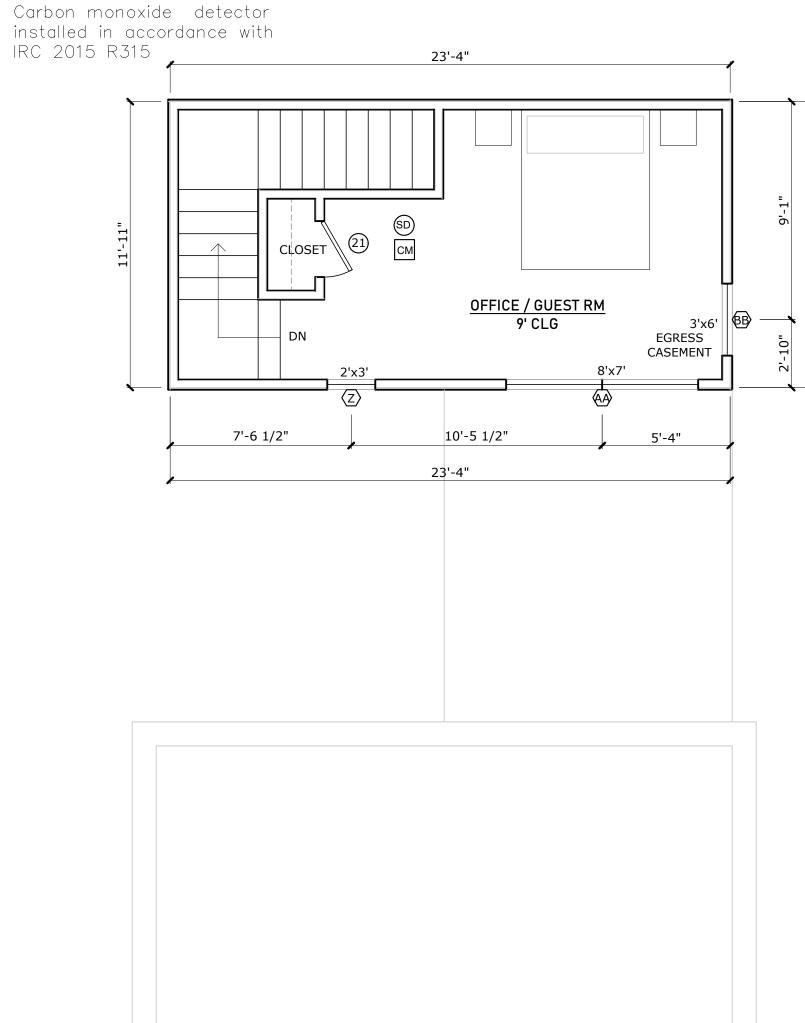

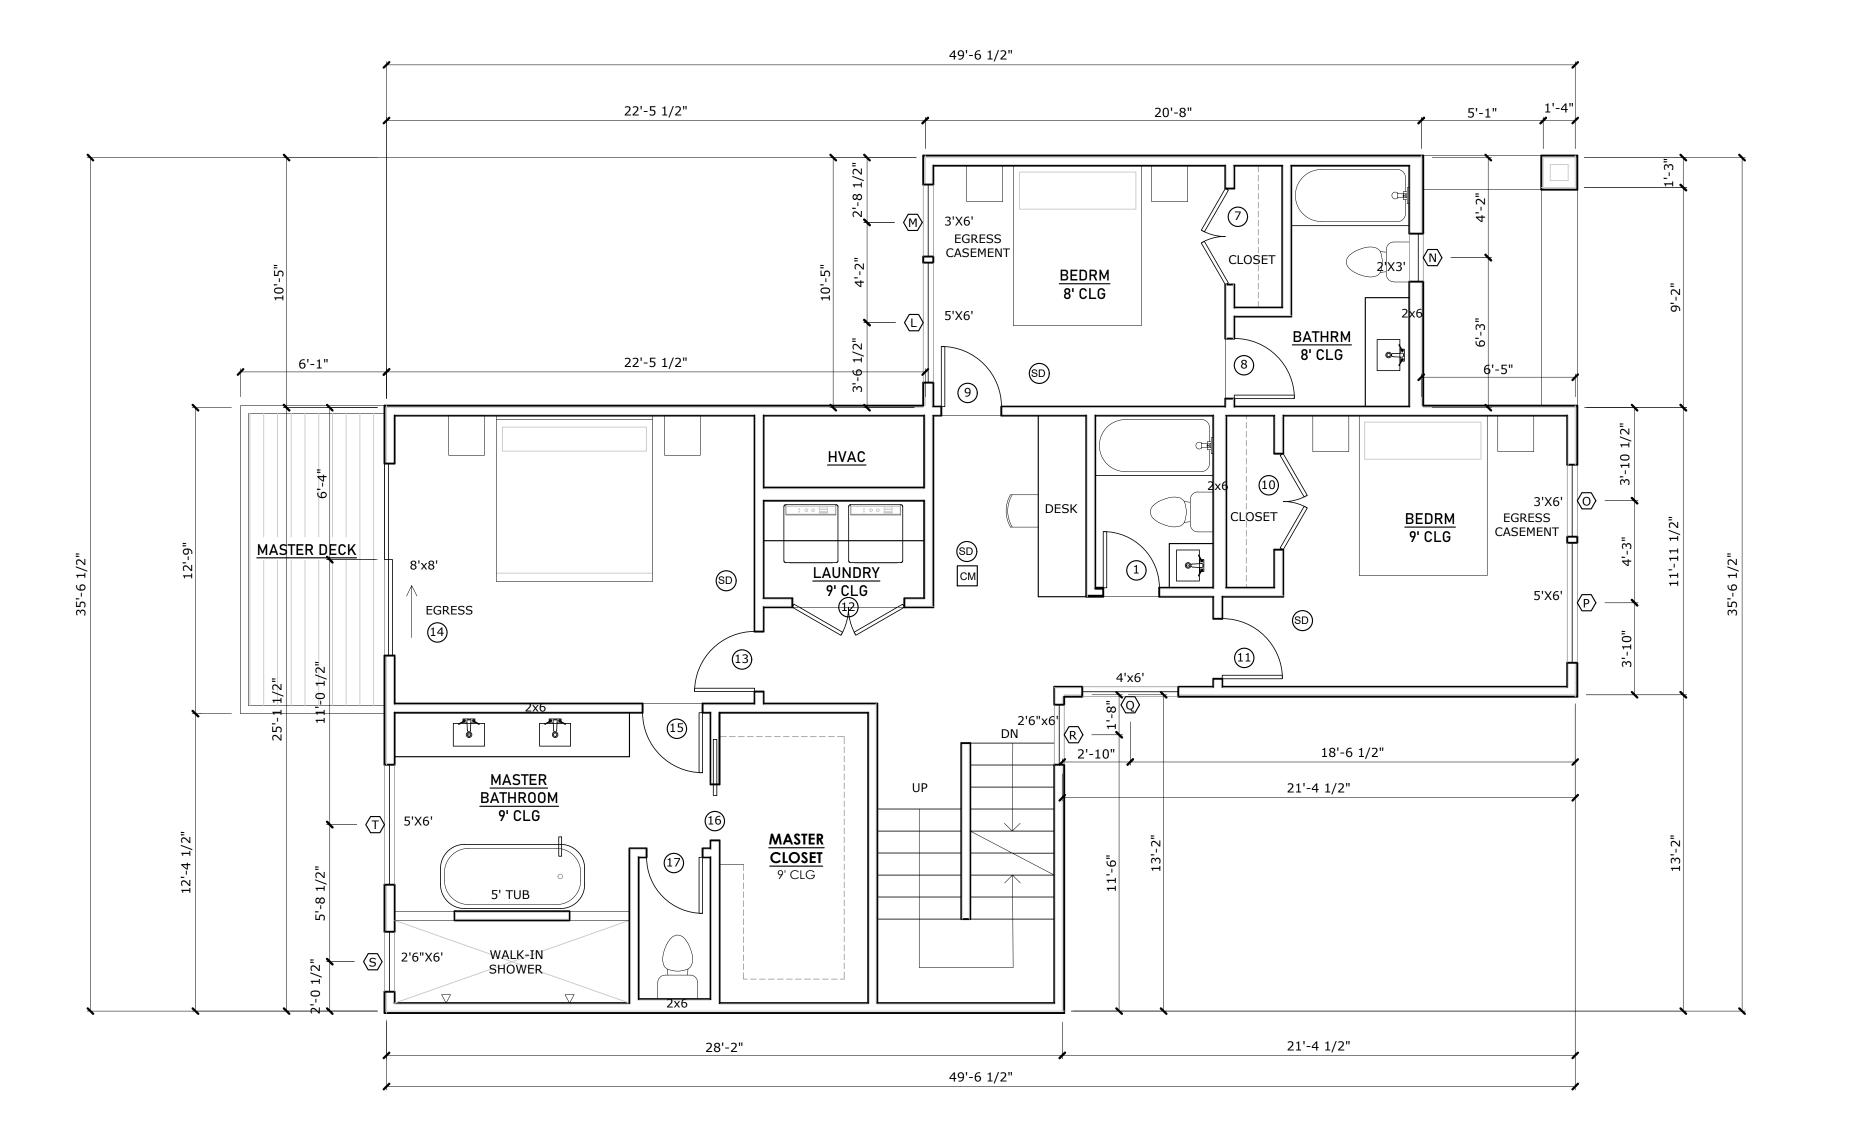

01 Second Floor Plan 1/4" = 1'-0" @ 22x34 1/8" = 1'-0" @ 11x17

PROJECT

804 RUTHERFORD PL

OWNER


NASH GARRISON

REVISIONS

NO ISSUE DATE 1 PERMIT 11/26/20

NOTES

SEAL & SIGNATURE

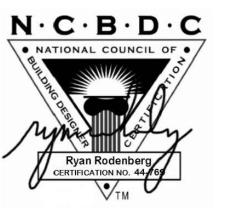

 $D \longrightarrow 0$

RODENBERG DESIGN

1702 EVERGREEN DR AUSTIN, TX 78704 512-796-5995 RYAN@RODENBERGDESIGN.COM

STRUCTURAL ENGINEER

SEC SOLUTIONS LLC MARCOS DEQUEIROGA, PE 407 FOREST STREET LIBERTY HILL, TX 78642 512-215-4364

SHEET TITLE

2ND FLOOR PLAN

- 1. All walls to be 2x4; plumbing walls to be 2x6; insulate
- exterior walls, R-19 min. 2. All doors to be 96" height
- 3. § gypsum board throughout 4. Green board in showers and wet areas
- 5. Shoot all plates w/ 2x Ramset w/in 6" of cut


Plan Notes

- All egress windows and doors to comply with 2015 IRC R310.1, R311.2, R312.2
 Stairs, handrails, and
- guardrails to comply with 2015 IRC R311.5.1, R311.7, R312.1
- 3. First floor of new construction with any living space to comply with all visitability standards under city code section 25—12—243, R320. Visitability items are referenced on floor plans


Legend

Smoke detector installed in accordance with IRC 2015 R314

> Carbon monoxide detector installed in accordance with IRC 2015 R315

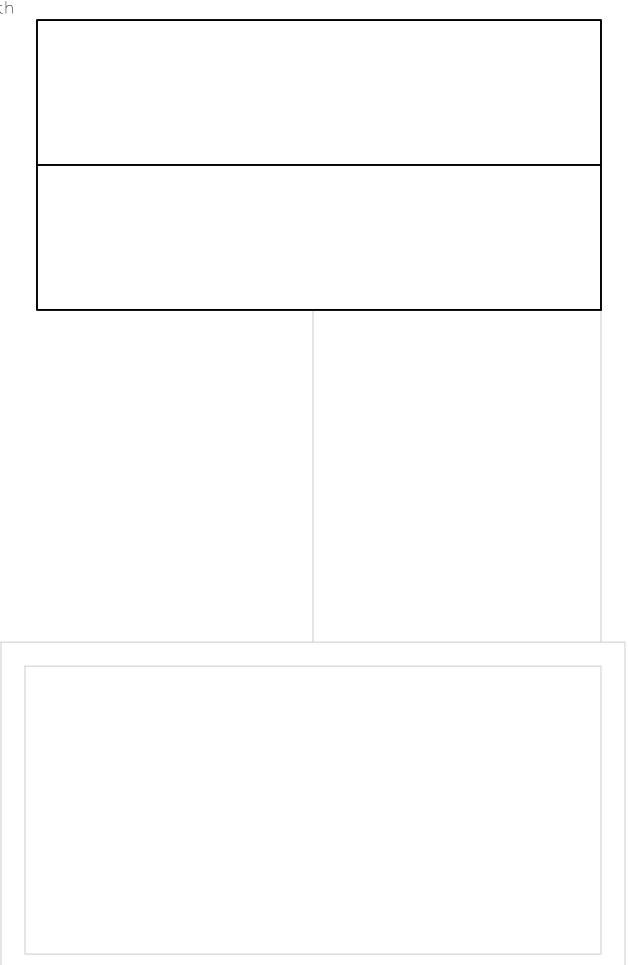

⁰¹ ATTIC Plan 1/4" = 1'-0" @ 22x34 1/8" = 1'-0" @ 11x17

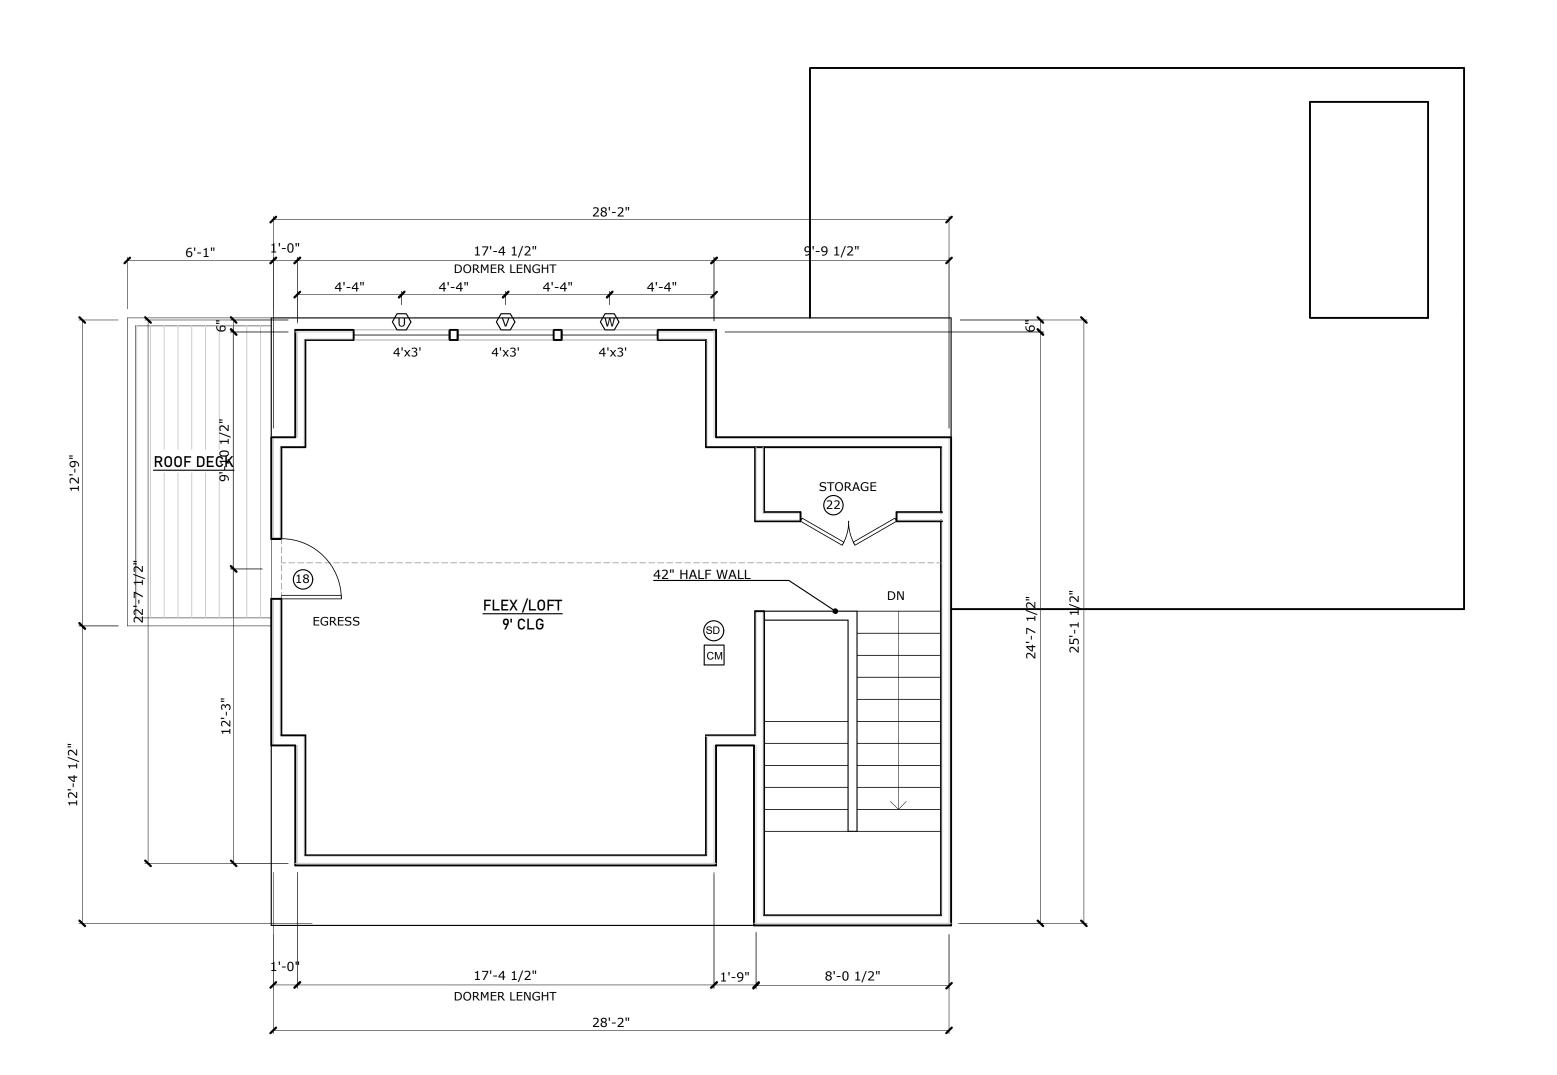

PROJECT

804 RUTHERFORD PL

OWNER


NASH GARRISON


REVISIONS

NO ISSUE DATE 1 PERMIT 11/26/20

NOTES

SEAL & SIGNATURE

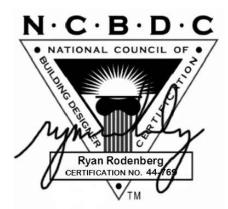

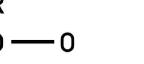

RODENBERG DESIGN

1702 EVERGREEN DR AUSTIN, TX 78704 512-796-5995 RYAN@RODENBERGDESIGN.COM

STRUCTURAL ENGINEER

SEC SOLUTIONS LLC MARCOS DEQUEIROGA, PE 407 FOREST STREET LIBERTY HILL, TX 78642 512-215-4364

SHEET TITLE

ATTIC PLAN

- 1. All walls to be 2x4; plumbing walls to be 2x6; insulate
- exterior walls, R-19 min. 2. All doors to be 96" height
- 3. § gypsum board throughout 4. Green board in showers and wet areas
- 5. Shoot all plates w/ 2x Ramset w/in 6" of cut


Plan Notes

- All egress windows and doors to comply with 2015 IRC R310.1, R311.2, R312.2
 Stairs, handrails, and
- guardrails to comply with 2015 IRC R311.5.1, R311.7, R312.1
- 3. First floor of new construction with any living space to comply with all visitability standards under city code section 25—12—243, R320. Visitability items are referenced on floor plans


Legend

Smoke detector installed in accordance with IRC 2015 R314

> Carbon monoxide detector installed in accordance with IRC 2015 R315

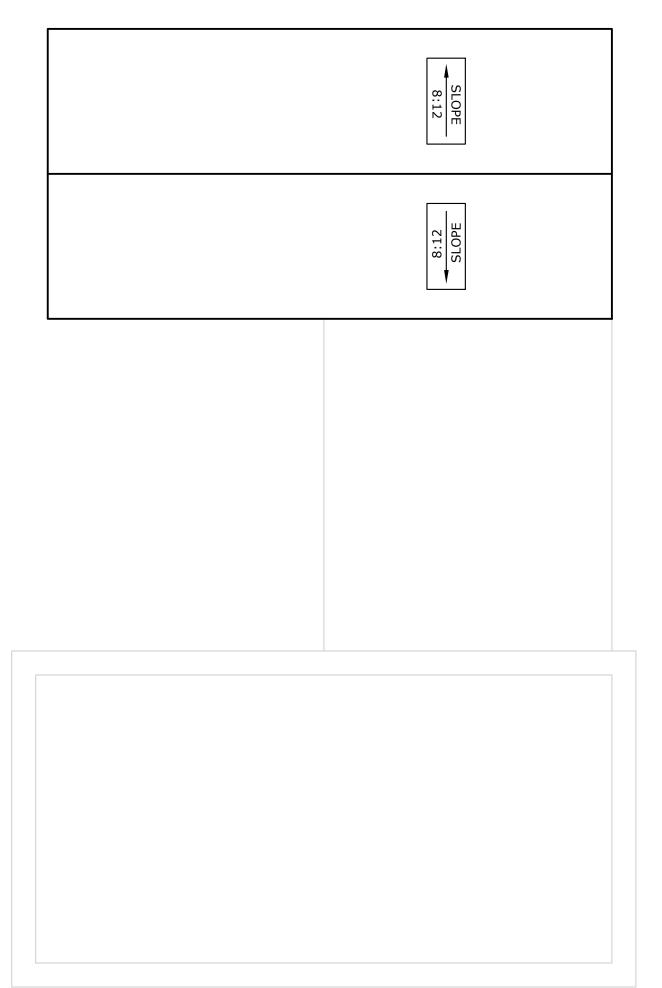

01 Roof Plan 1/4" = 1'-0" @ 22x34 1/8" = 1'-0" @ 11x17

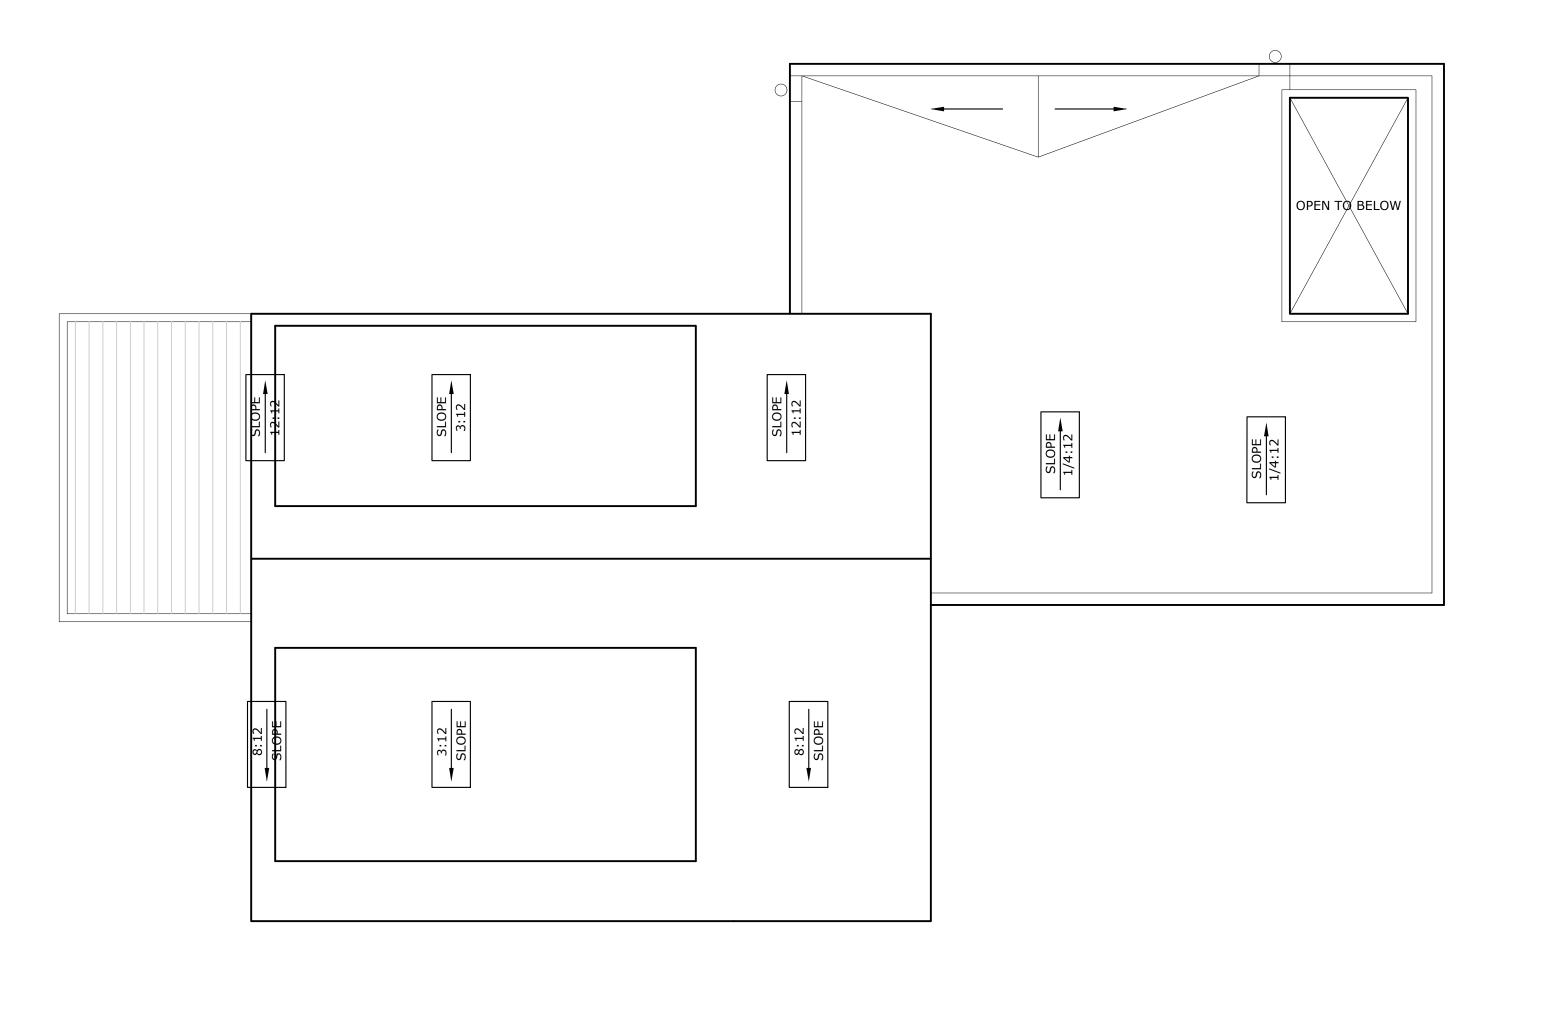

PROJECT

804 RUTHERFORD PL

OWNER


NASH GARRISON

REVISIONS

NO ISSUE DATE 1 PERMIT 11/26/20

NOTES

SEAL & SIGNATURE

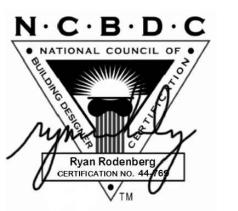

 $D \longrightarrow 0$

RODENBERG DESIGN

1702 EVERGREEN DR AUSTIN, TX 78704 512-796-5995 RYAN@RODENBERGDESIGN.COM


STRUCTURAL ENGINEER

SEC SOLUTIONS LLC MARCOS DEQUEIROGA, PE 407 FOREST STREET LIBERTY HILL, TX 78642 512-215-4364

SHEET TITLE

ROOF PLAN

PLEASE COORDINATE ALL WINDOWS AND DOORS WITH SCHEDULES ON A0.2

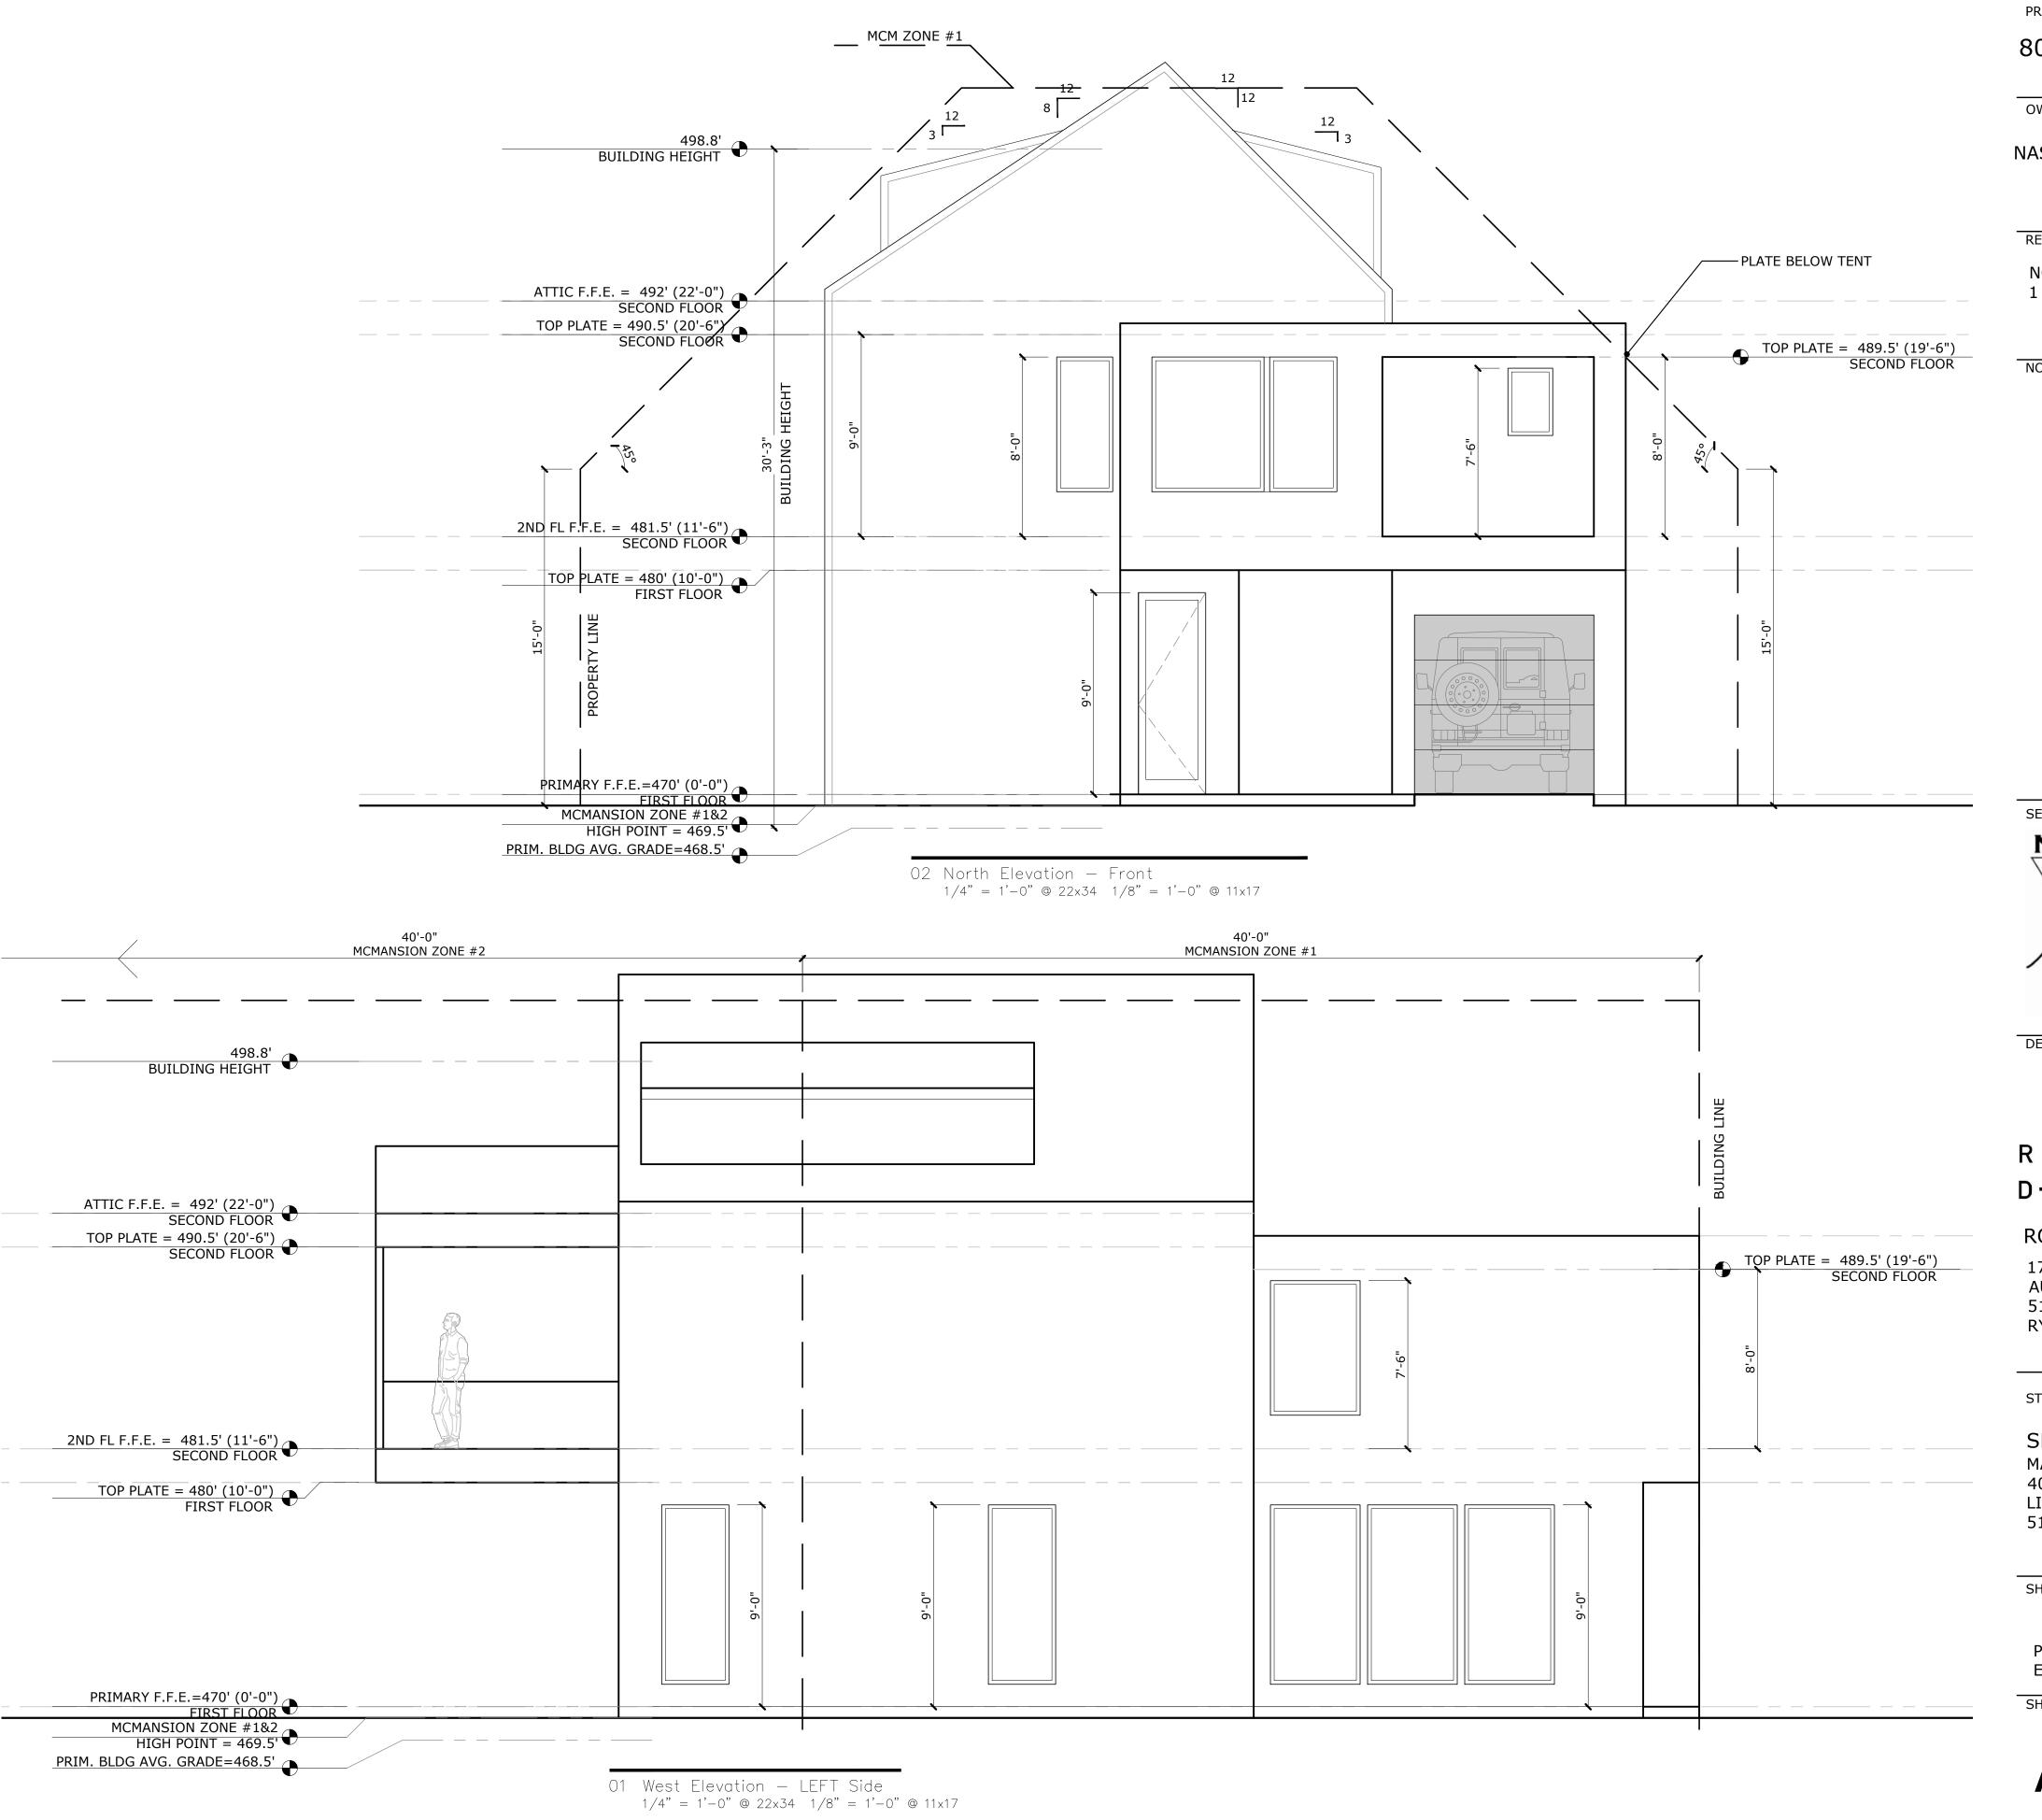

PROJECT

804 RUTHERFORD PL

OWNER

NASH GARRISON

REVISIONS

NO ISSUE DATE 1 PERMIT 11/26/20

NOTES

SEAL & SIGNATURE



DECICNED

D — 0

RODENBERG DESIGN

1702 EVERGREEN DR AUSTIN, TX 78704 512-796-5995 RYAN@RODENBERGDESIGN.COM

STRUCTURAL ENGINEER

SEC SOLUTIONS LLC MARCOS DEQUEIROGA, PE 407 FOREST STREET LIBERTY HILL, TX 78642 512-215-4364


SHEET TITLE


PRIMARY RESIDENCE ELEVATIONS

SHEET NUMBER

A3.0

PLEASE COORDINATE ALL WINDOWS AND DOORS WITH SCHEDULES ON A0.2

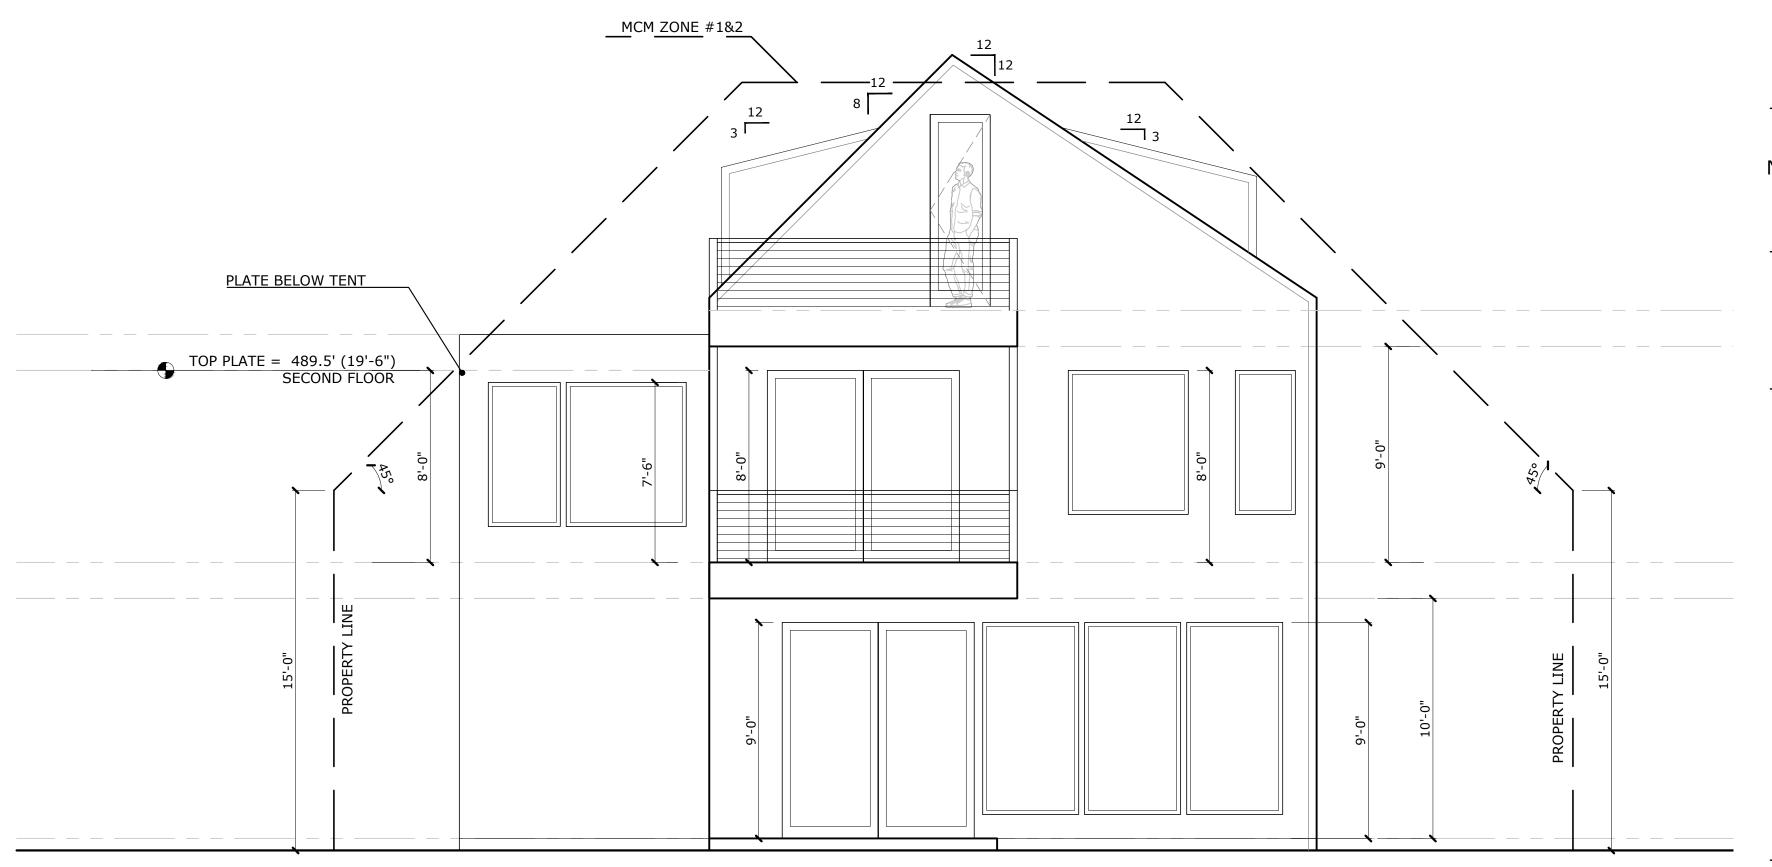

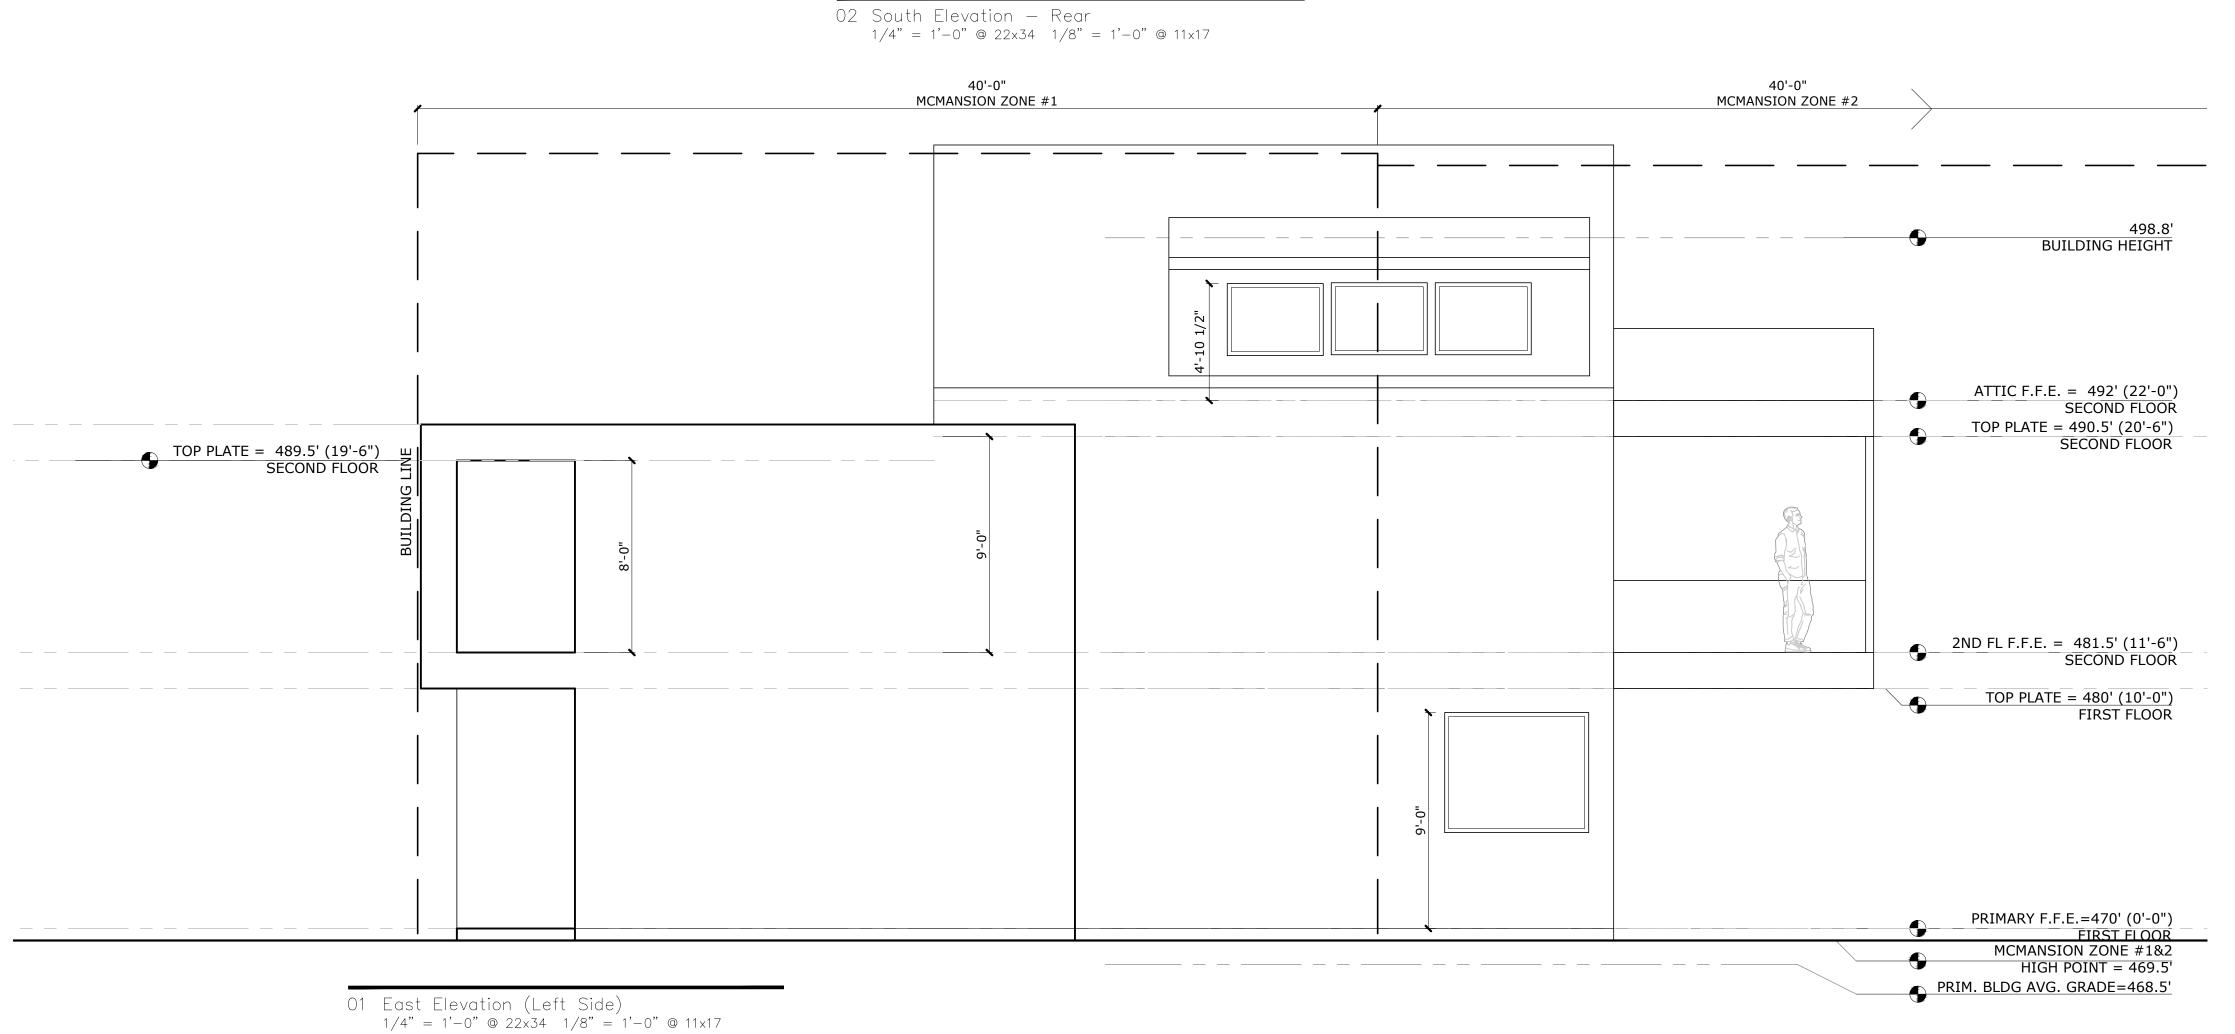

PROJECT

804 RUTHERFORD PL

OWNER


NASH GARRISON

REVISIONS

NO ISSUE DATE 1 PERMIT 11/26/20

NOTES

SEAL & SIGNATURE

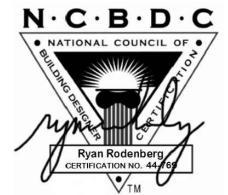

DESIGNED

D — 0

RODENBERG DESIGN

1702 EVERGREEN DR AUSTIN, TX 78704 512-796-5995 RYAN@RODENBERGDESIGN.COM


STRUCTURAL ENGINEER


SEC SOLUTIONS LLC MARCOS DEQUEIROGA, PE 407 FOREST STREET LIBERTY HILL, TX 78642 512-215-4364

SHEET TITLE


PRIMARY RESIDENCE ELEVATIONS


PLEASE COORDINATE ALL WINDOWS AND DOORS WITH SCHEDULES ON A0.2

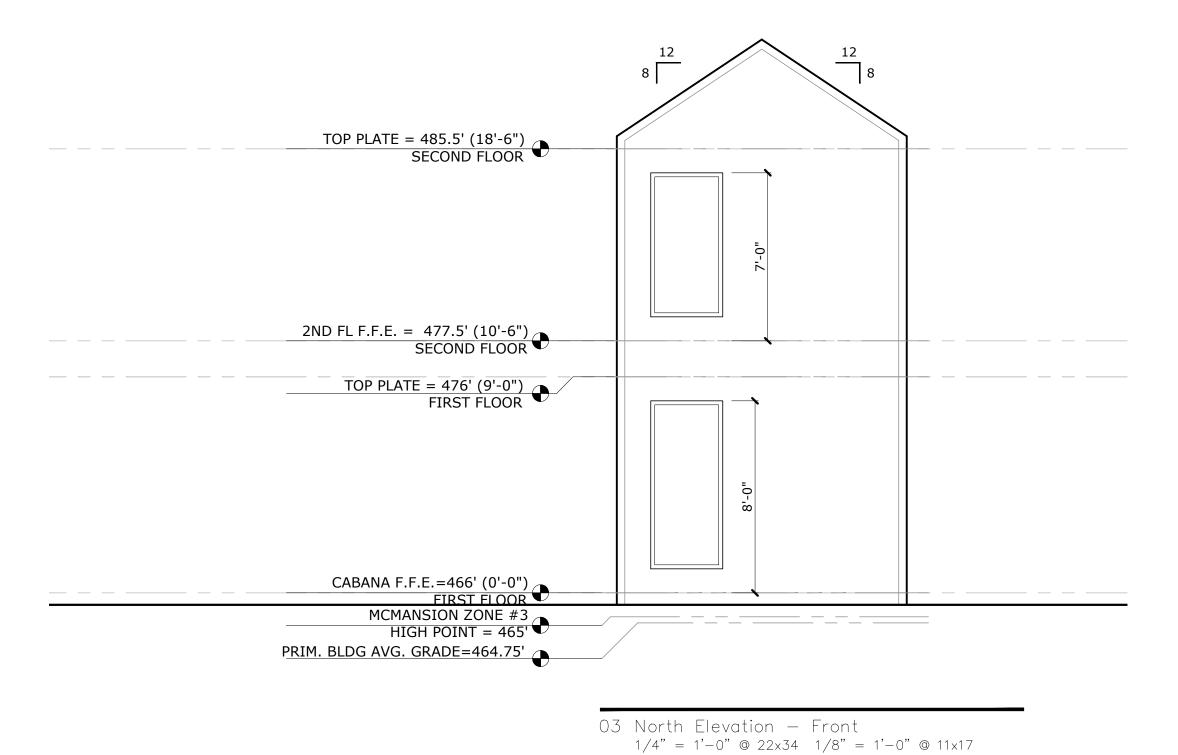

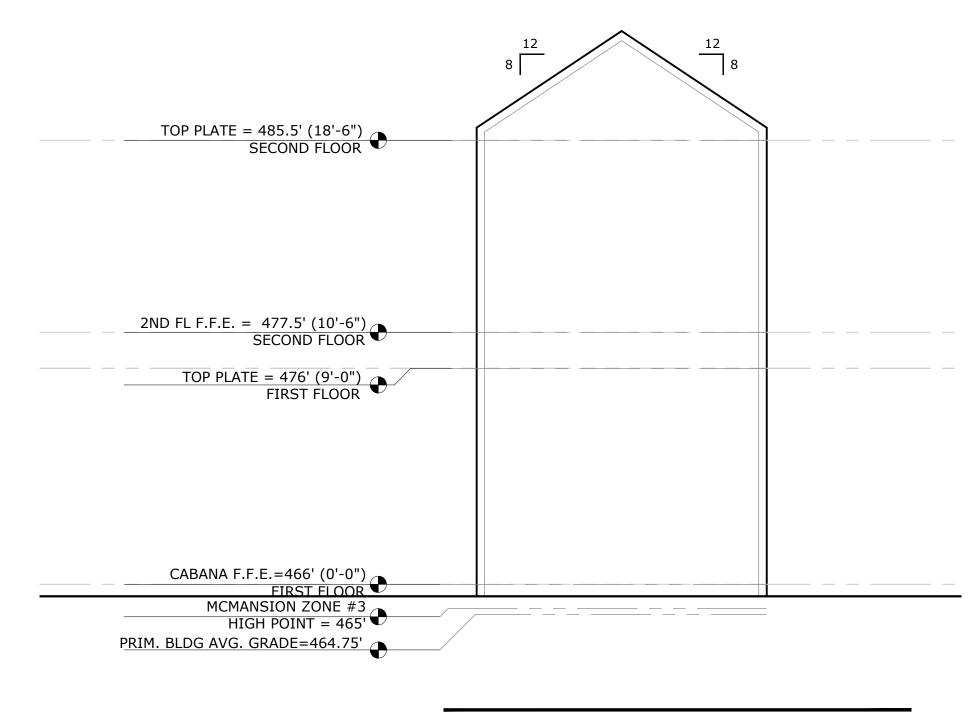

02 South Elevation — Rear 1/4" = 1'-0" @ 22x34 1/8" = 1'-0" @ 11x17

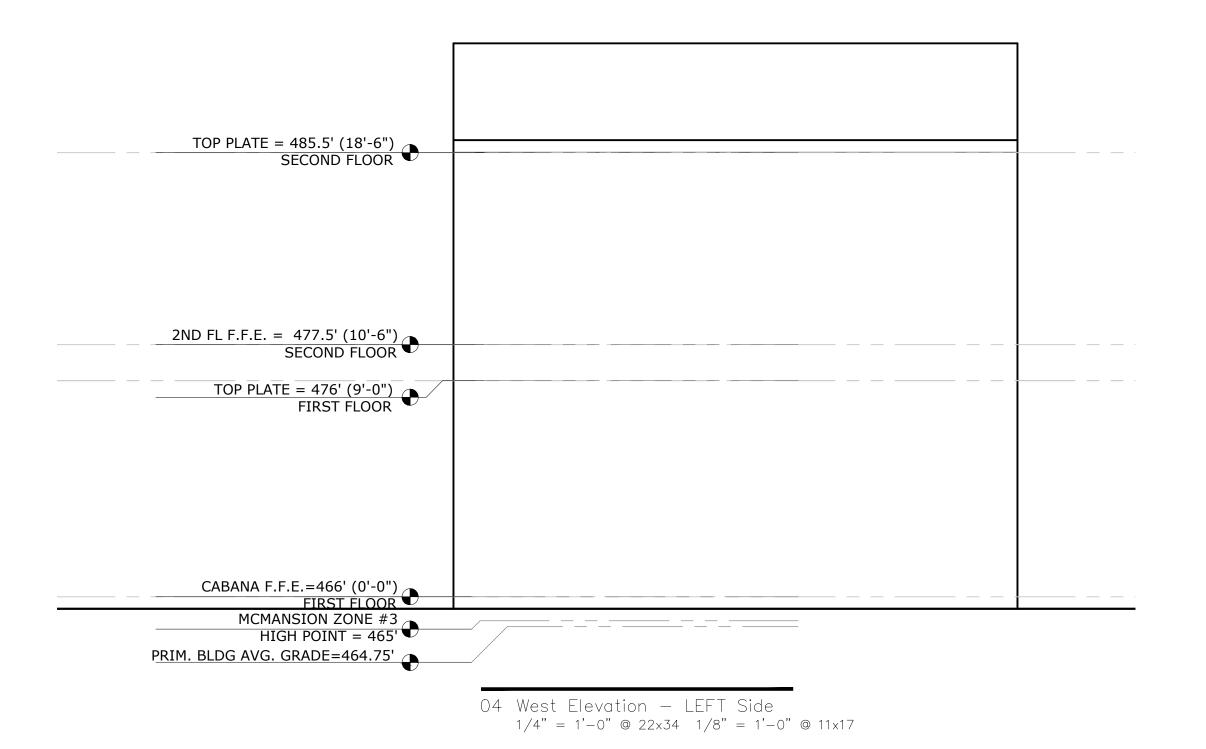

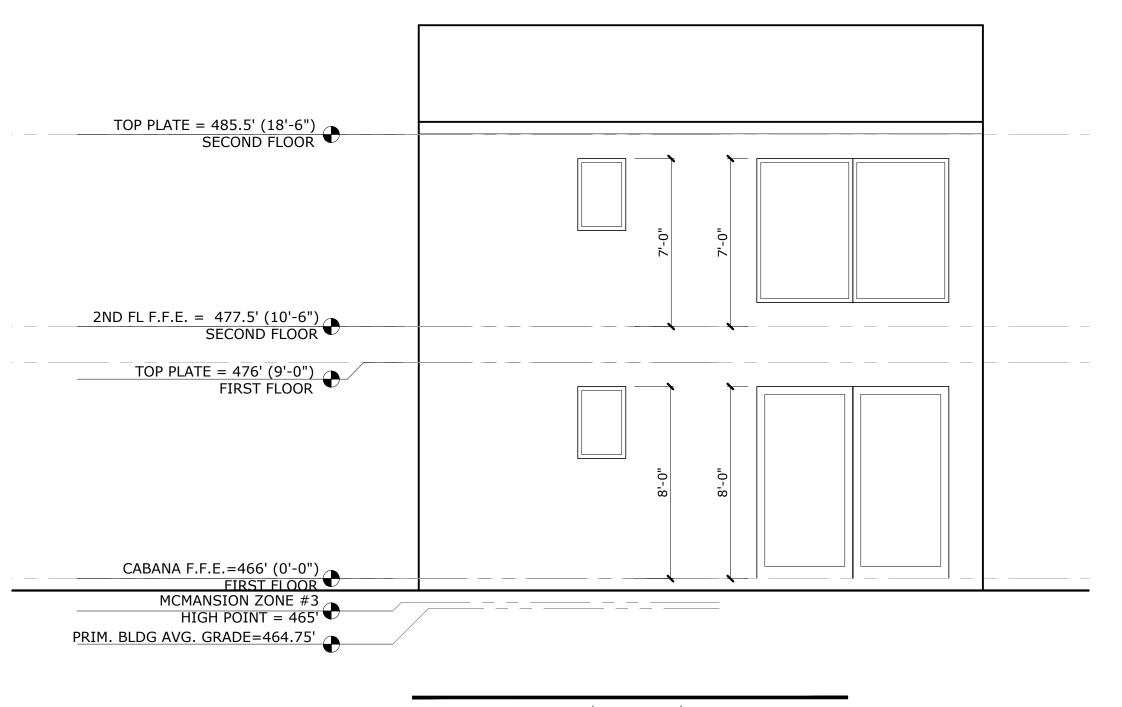

01 East Elevation (Left Side) 1/4" = 1'-0" @ 22x34 1/8" = 1'-0" @ 11x17 PROJECT

804 RUTHERFORD PL

OWNER


NASH GARRISON

REVISIONS

NO ISSUE DATE 1 PERMIT 11/26/20

NOTES

SEAL & SIGNATURE

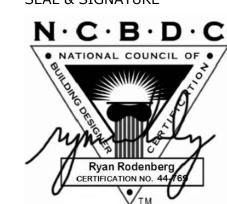

DESIGNED

R D — 0

RODENBERG DESIGN

1702 EVERGREEN DR AUSTIN, TX 78704 512-796-5995 RYAN@RODENBERGDESIGN.COM

STRUCTURAL ENGINEER

SEC SOLUTIONS LLC MARCOS DEQUEIROGA, PE 407 FOREST STREET LIBERTY HILL, TX 78642 512-215-4364

SHEET TITLE

CABANA RESIDENCE ELEVATIONS

PROJECT

804 RUTHERFORD PL


OWNER

NASH GARRISON


REVISIONS

NO ISSUE DATE 1 PERMIT 11/26/20

NOTES

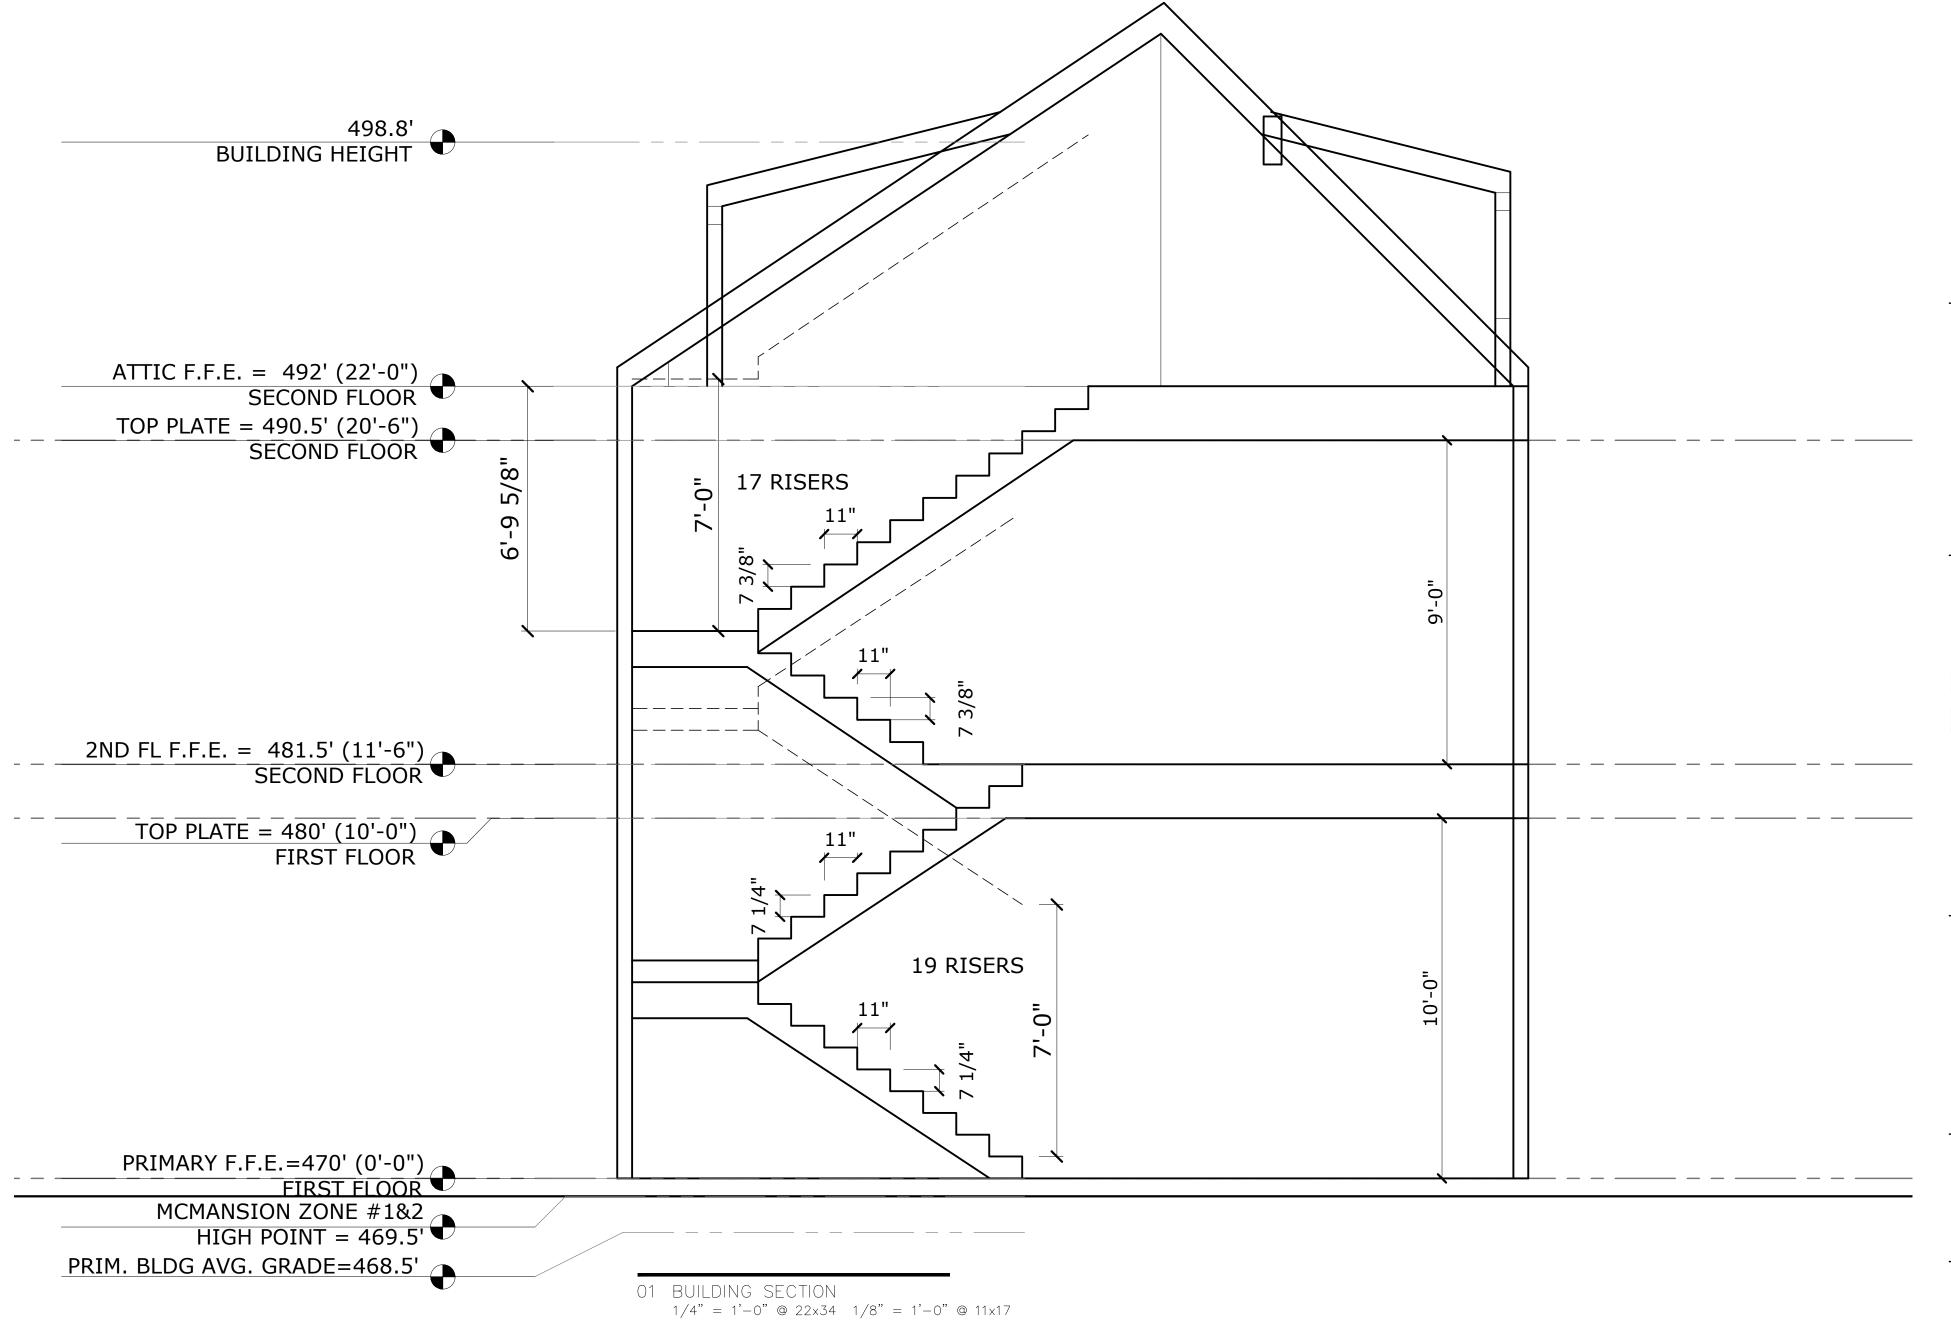

SEAL & SIGNATURE

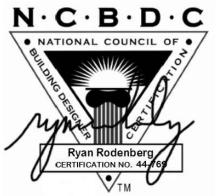

DESIGNER

D — 0

RODENBERG DESIGN

1702 EVERGREEN DR AUSTIN, TX 78704 512-796-5995 RYAN@RODENBERGDESIGN.COM

STRUCTURAL ENGINEER


SEC SOLUTIONS LLC MARCOS DEQUEIROGA, PE 407 FOREST STREET LIBERTY HILL, TX 78642 512-215-4364


SHEET TITLE

SECTION

SHEET NUMBER

A3.3

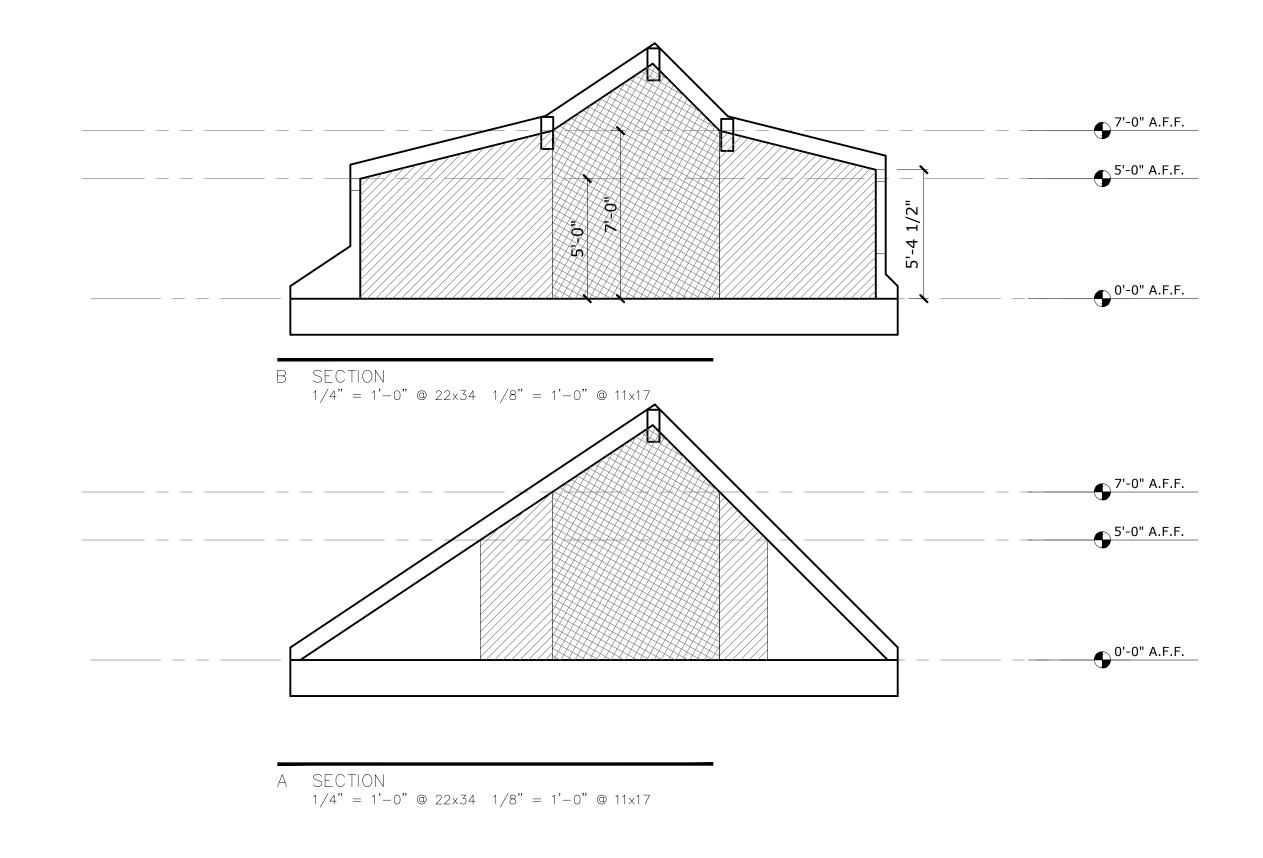

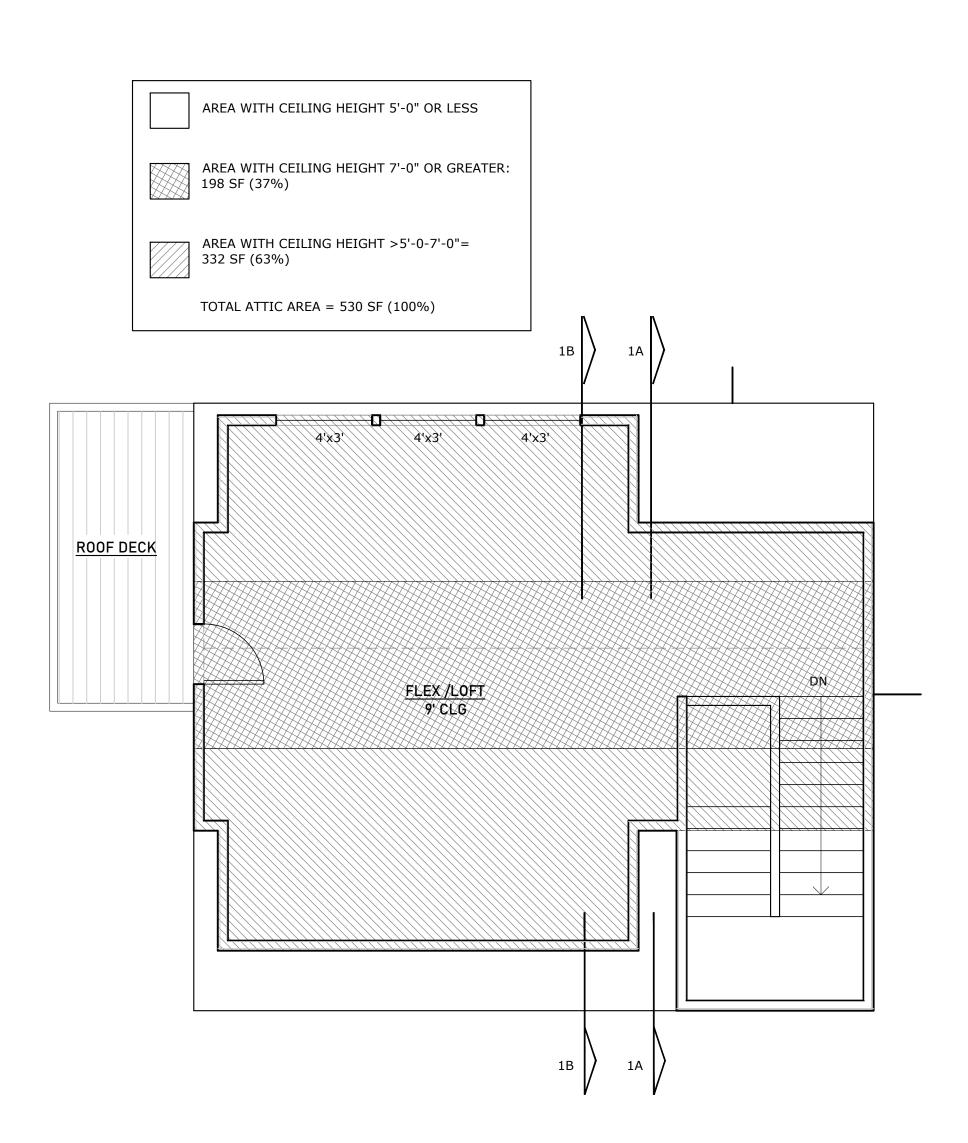

PROJECT

804 RUTHERFORD PL

OWNER

NASH GARRISON

REVISIONS

NO ISSUE DATE 1 PERMIT 11/26/20

NOTES

SEAL & SIGNATURE



DESIGNER

D — 0

RODENBERG DESIGN

1702 EVERGREEN DR AUSTIN, TX 78704 512-796-5995 RYAN@RODENBERGDESIGN.COM

STRUCTURAL ENGINEER

SEC SOLUTIONS LLC MARCOS DEQUEIROGA, PE 407 FOREST STREET LIBERTY HILL, TX 78642 512-215-4364

SHEET TITLE

ATTIC EXEMPTION

SHEET NUMBER

All rights reserved. All designs, drawings, plans & specifications are the property of RODENBEG D/D LLC. Purchaser's rights are conditional & limited to a one-time use to construct on the site & use is limited to a one-time use to construct a single project on the site & use is limited specifications are the property. The use or reproduction of these plans concerning any other construction is strictly prohibited without the written permission of RODENBERG D/D LLC.