

SITE PLAN NOTES

- REFER TO G1.0 FOR CODE COMPLIANCE.
- 2. REFER TO G2.0 FOR ADDITIONAL GENERAL NOTES.
- 3. SITE INFORMATION SHOWN IS BASED FROM SURVEY DATED JUNE 17, 2020 PREPARED BY WATERLOO SURVEYORS.
- CONTRACTOR SHALL FIELD VERIFY JOB CONDITIONS AND IMMEDIATELY NOTIFY ARCHITECT OF ANY DISCREPANCIES FROM CONSTRUCTION DOCUMENTS.
- THE CONTRACTOR SHALL NOTIFY THE ARCHITECT IMMEDIATELY IF ANY DEFECTS IN THE EXISTING CONSTRUCTION ARE UNCOVERED DURING DEMOLITION WORK SO NECESSARY REPAIRS CAN BE MADE. REPORT ANY CONDITIONS THAT MAY DICTATE UNFORESEEN CHANGES IN THE WORK TO BE PROVIDED.
- DEMOLITION SITE PLAN IS FOR GUIDANCE ONLY. ANY ADDITIONAL DEMOLITION WORK REQUIRED TO FULLY COMPLETE WORK, BUT NOT OTHERWISE SHOWN OR DESCRIBED IN THE DEMOLITION DRAWINGS SHALL BE CONSIDERED PART OF THE CONTRACT.
- THE INFORMATION SHOWN ON THESE DRAWINGS INDICATING SIZE, TYPE AND LOCATION OF ANY UNDERGROUND, SURFACE AND AERIAL UTILITIES OR OTHER EXISTING FEATURES IS NOT GUARANTEED TO BE EXACT OF COMPLETE. THE CONTRACTOR SHALL CONTACT THE AUSTIN AREA "ONE CALL" SYSTEM (1-800-344-8377) FOR EXISTING UTILITY LOCATIONS AT LEAST 48 HOURS PRIOR TO BEGINNING ANY
- THE CONTRACTOR SHALL BE FULLY RESPONSIBLE FOR FIELD VERIFYING LOCATIONS AND ELEVATIONS OF ALL EXISTING UTILITIES AFFECTED BY THIS PROJECT'S CONSTRUCTION, IN ORDER TO AVOID DAMAGING THOSE UTILITIES, AND SHALL IMMEDIATELY ARRANGE FOR REPAIR AND RESTORATION OF CONTRACTOR-DAMAGED UTILITIES, TO THE SATISFACTION OF THE UTILITY COMPANY, AT THE EXPENSE OF THE
- WHERE A SEAMLESS PATCH BETWEEN EXISTING AND NEW SURFACES AND/OR ITEMS IS NOT POSSIBLE OR PRACTICAL, REMOVE EXISTING SURFACE AND/OR ITEM BACK TO NEAREST JOINT AND REPLACE WITH NEW TO MATCH.
- 10. ALL HAULING AND DISPOSAL OF DEMOLISHED ITEMS SHALL BE PROVIDED BY CONTRACTOR.

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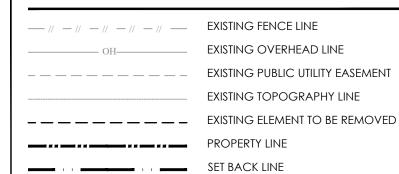
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LEGEND AND SCALE




ADJACENT PROPERTY LINE

SHEET NAME **DEMO** SITE PLAN

SHEET NUMBER

R2203 JOB NO. DRAWN BY

TRUE NORTH FULL SIZE SCALE : 1" = 10'-0" OR 1:120 (HALF SIZE SCALE: 1" = 20'-0" OR 1:240)

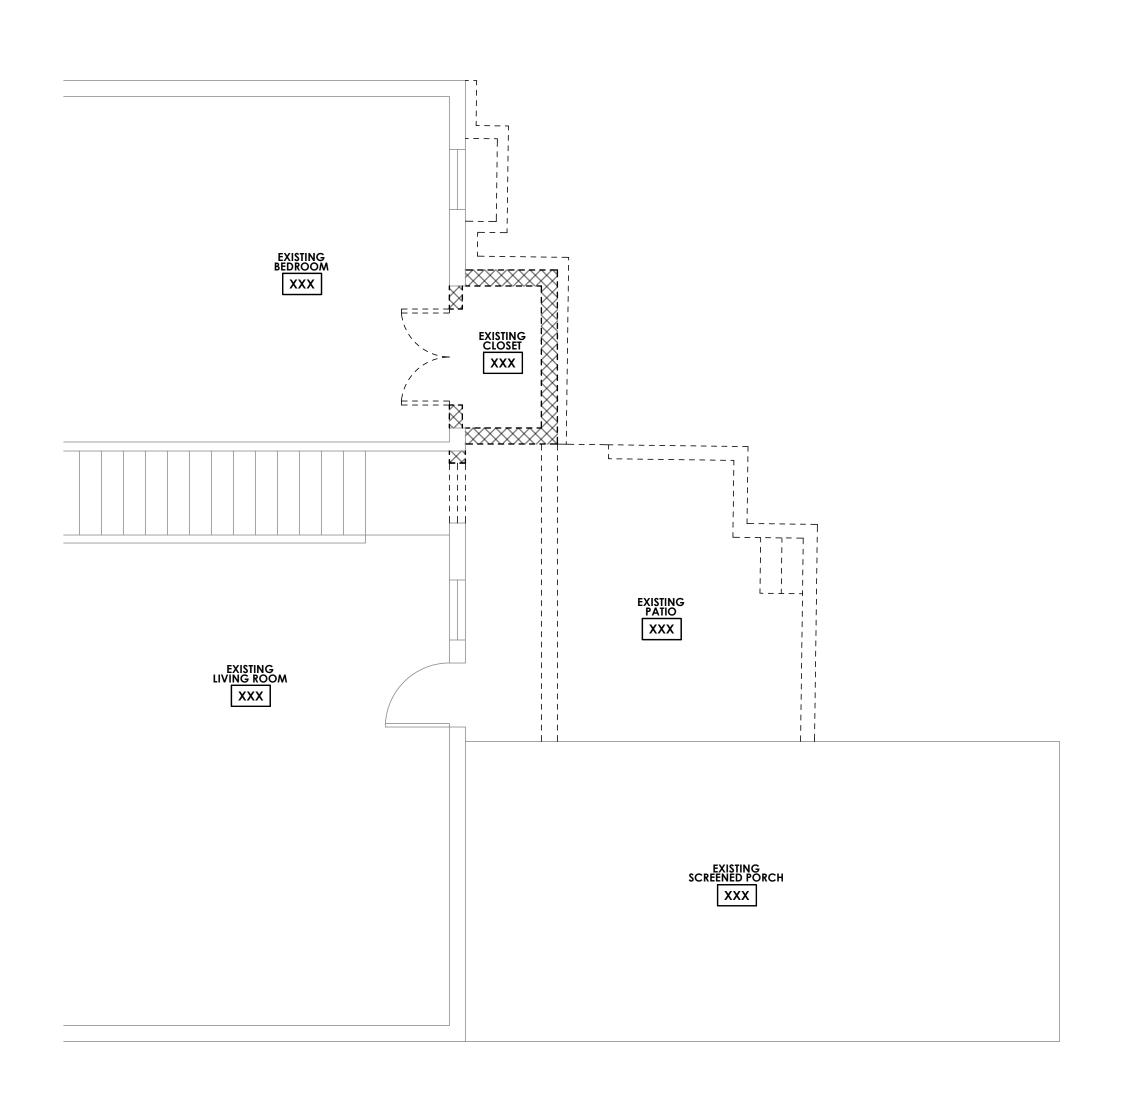

SHEET NOTES

- REFER TO SHEET G1.0 FOR CODE COMPLIANCE.
- 2. REFER TO SHEET G2.0 FOR GENERAL NOTES.
- 3. REFER TO SHEET AS 1.0 FOR VISITABILITY REQUIREMENTS.
- 4. REFER TO A3.0 SERIES FOR EXTERIOR ELEVATIONS AND ADDITIONAL WINDOW TAGS.
- 5. DO NOT SCALE DRAWINGS.
- 6. VERIFY ALL DIMENSIONS IN FIELD AND REPORT ALL DISCREPANCIES TO THE ARCHITECT FOR RESOLUTION PRIOR TO COMMENCEMENT OF WORK.
- ALL DIMENSIONS TO FACE OF STUD, FACE OF CONCRETE, CENTERLINE OF STRUCTURE, CENTER OF OPENING OR FIXTURE, UNLESS NOTED OTHERWISE.
- 8. ALL DOOR FRAMES SHALL BE LOCATED 4" FROM NEAREST PERPENDICULAR WALL OR CENTER ON WALL SEGMENT AS ILLUSTRATED, UNLESS DIMENSIONED OTHERWISE.
- WALL FRAMING SHALL BE AS NOTED BELOW UNLESS NOTED OTHERWISE BY STRUCTURAL ENGINEER. CONSULT ARCHITECT ON ANY DISCREPANCIES.
 - A. ALL EXTERIOR & LOADING BEARING WALLS SHALL BE CONSTRUCTED WITH 2X6 OR 2X4 WOOD FRAMING AT 18" ON CENTER, U.N.O. REFER TO WALL LEGEND BELOW.
- B. ALL SIMPLE (NON-LOAD BEARING) INTERIOR PARTITIONS SHALL BE CONSTRUCTED WITH 2X4 WOOD FRAMING AT 24" ON CENTER, U.N.O.
- CONSTRUCTED WITH 2X6 FRAMING, U.N.O. D. ALL INTERIOR PARTITIONS SUPPORTING POCKET

C. ALL INTERIOR AND EXTERIOR PLUMBING WALLS TO BE

- DOORS TO BE CONSTRUCTED WITH 2X6 FRAMING, 10. ROOF AND FLOOR FRAMING SHALL BE PER STRUCTURAL
- DRAWINGS. TRUSS MANUFACTURER SHALL SUPPLY SHOP DRAWINGS SEALED BY AN ENGINEER TO DESIGN TEAM AND CONTRACTOR FOR APPROVAL PRIOR TO FABRICATION. 10. EXTERIOR WALL INSULATION - ALL EXTERIOR WALLS SHALL
- OPTIONAL SPRAY FOAM LAYER ADJACENT TO EXTERIOR 11. ROOF INSULATION - ALL ROOF SHALL RECEIVE MIN. R-36

RECEIVE MIN. R-19 CELLULOSE BLOWN-IN INSULATION WITH

12. FLOOR INSULATION - ALL SPACES BETWEEN FLOORS SHALL RECEIVE MIN. R-30 BATT INSULATION BETWEEN FLOORS.

OPEN CELL SPRAY FOAM INSULATION.

- 13. INTERIOR WALL INSULATION ALL BEDROOMS, BATHROOM AND LAUNDRY ROOM WALLS SHALL RECEIVE SOUND BATT INSULATION.
- 14. CONTRACTOR SHALL PROVIDE BLOCKING IN WALLS AND CEILINGS AS REQUIRED FOR ALL ACCESSORIES, WALL MOUNTED ITEMS, CEILING FANS, ETC.
- 15. USE ½" WATER RESISTANT GYP BD IN BATHROOM AND KITCHEN ON ALL WALLS EXCEPT BEHIND CERAMIC TILE AND BATH TUB WHERE TILE BACKER BOARD (DENSHIELD) IS
- 16. ALL DIMENSIONS ARE TAKEN FROM EDGE OF SLAB TO FACE OF WOOD, UNLESS NOTED "CLEAR".
- 17. ALL DOOR OPENINGS TO BE 4" FROM ADJACENT WALL,
- 18. CONTRACTOR TO INSTALL BLOCKING IN WALLS AND CEILINGS AS REQUIRED FOR ALL ACCESSORIES, WALL MOUNTED ITEMS, CEILING FANS, ETC.
- 19. TRUSS MANUFACTURER SHALL SUPPLY SHOP DRAWINGS SEALED BY AN ENGINEER TO ARCHITECT AND CONTRACTOR FOR APPROVAL PRIOR TO FABRICATION.
- 20. CONTACT ARCHITECT/OWNER WITH ANY FRAMING QUESTIONS/DISCREPANCIES.

LEGEND AND SCALE

EXISTING WALL/ELEMENT TO REMAIN REMOVE EXISTING WALL

REMOVE EXISTING ELEMENT



LEVEL 1 - DEMOLITION PLAN

SCALE: 3/16" = 1'-0"

FULL SIZE SCALE : 1/4" = 1'-0" (HALF SIZE SCALE: $\frac{1}{8}$ " = 1'-0")

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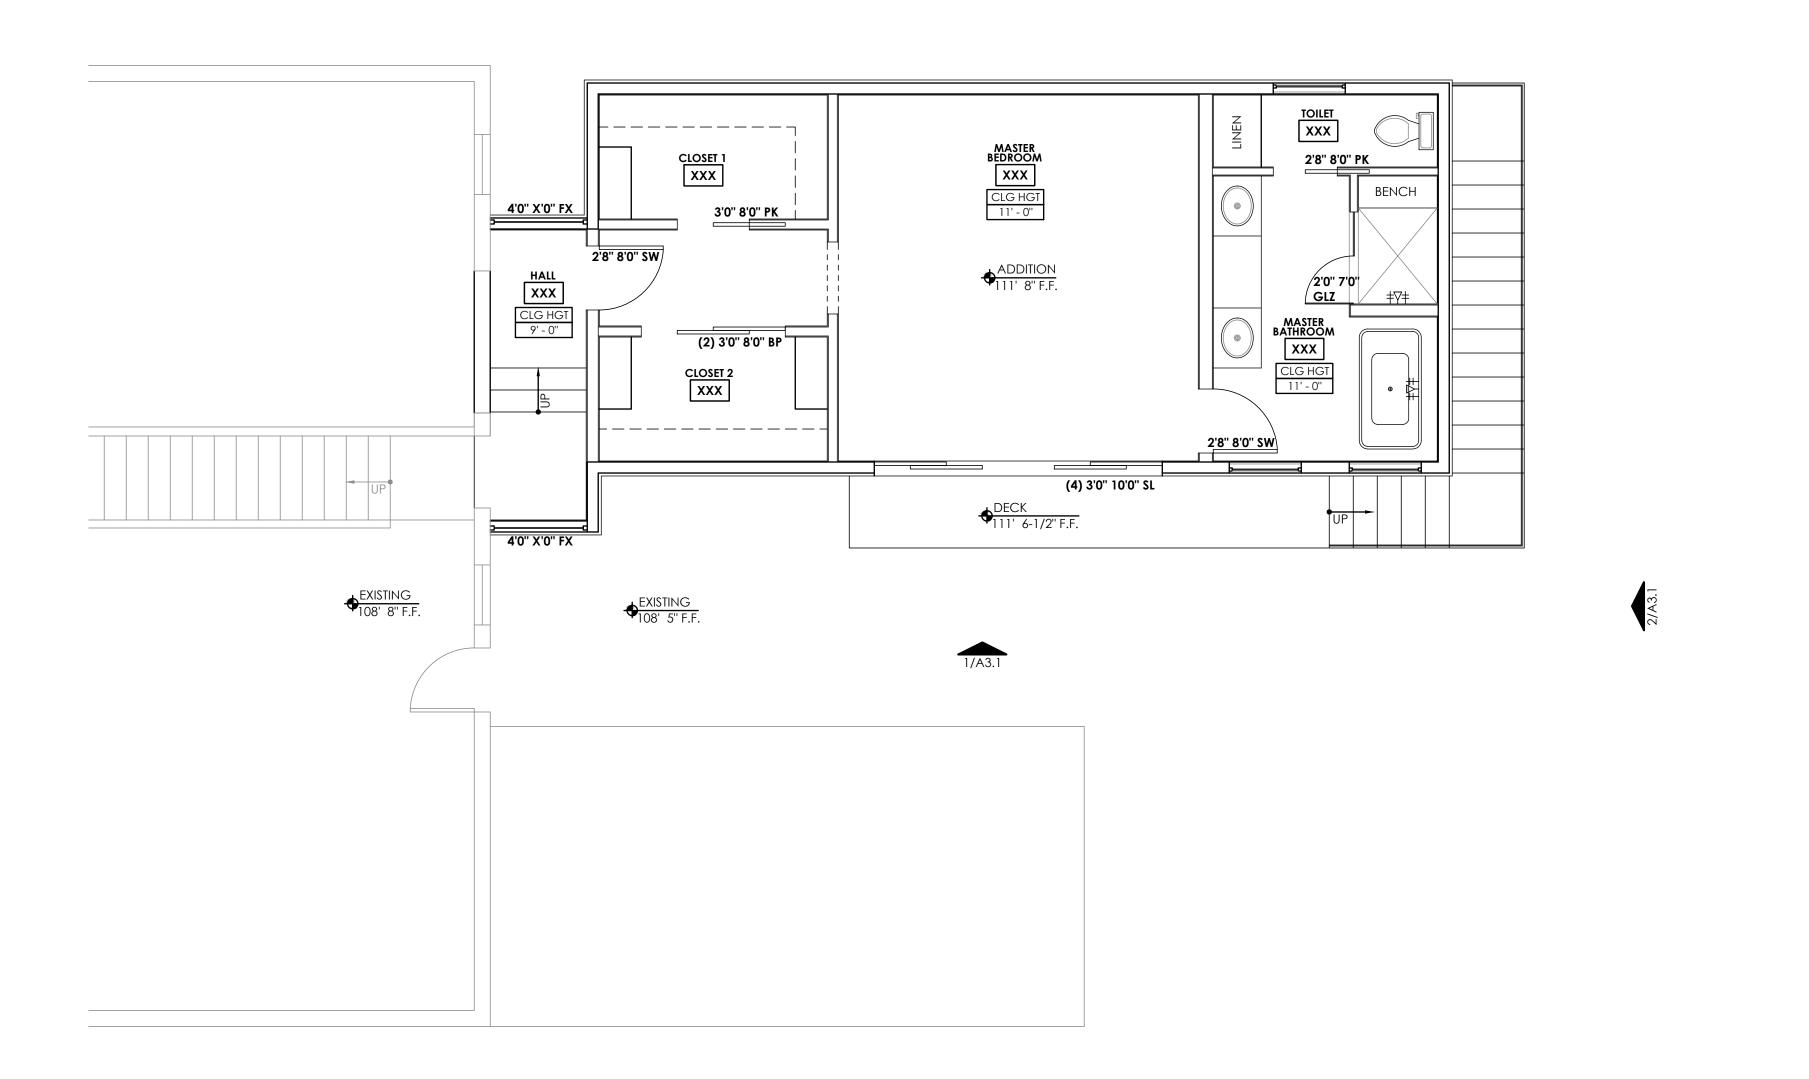
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JOB NO. R2203 DRAWN BY

SHEET NAME LEVEL 1 **DEMOLITION FLOOR PLAN** SHEET NUMBER



SHEET NOTES


- 3. REFER TO SHEET AS 1.0 FOR VISITABILITY REQUIREMENTS.
- 5. DO NOT SCALE DRAWINGS.
- 6. VERIFY ALL DIMENSIONS IN FIELD AND REPORT ALL DISCREPANCIES TO THE ARCHITECT FOR RESOLUTION PRIOR TO COMMENCEMENT OF WORK.
- CENTERLINE OF STRUCTURE, CENTER OF OPENING OR FIXTURE, UNLESS NOTED OTHERWISE.
- 8. ALL DOOR FRAMES SHALL BE LOCATED 4" FROM NEAREST PERPENDICULAR WALL OR CENTER ON WALL SEGMENT AS
- WALL FRAMING SHALL BE AS NOTED BELOW UNLESS NOTED OTHERWISE BY STRUCTURAL ENGINEER. CONSULT ARCHITECT ON ANY DISCREPANCIES.
 - CONSTRUCTED WITH 2X6 OR 2X4 WOOD FRAMING AT 18" ON CENTER, U.N.O. REFER TO WALL LEGEND BELOW.
- B. ALL SIMPLE (NON-LOAD BEARING) INTERIOR
- C. ALL INTERIOR AND EXTERIOR PLUMBING WALLS TO BE CONSTRUCTED WITH 2X6 FRAMING, U.N.O.
- DOORS TO BE CONSTRUCTED WITH 2X6 FRAMING,
- DRAWINGS SEALED BY AN ENGINEER TO DESIGN TEAM AND CONTRACTOR FOR APPROVAL PRIOR TO FABRICATION.
- OPTIONAL SPRAY FOAM LAYER ADJACENT TO EXTERIOR
- OPEN CELL SPRAY FOAM INSULATION.
- RECEIVE MIN. R-30 BATT INSULATION BETWEEN FLOORS.
- 13. INTERIOR WALL INSULATION ALL BEDROOMS, BATHROOM AND LAUNDRY ROOM WALLS SHALL RECEIVE SOUND BATT INSULATION.
- CEILINGS AS REQUIRED FOR ALL ACCESSORIES, WALL MOUNTED ITEMS, CEILING FANS, ETC.
- KITCHEN ON ALL WALLS EXCEPT BEHIND CERAMIC TILE AND BATH TUB WHERE TILE BACKER BOARD (DENSHIELD) IS
- 16. ALL DIMENSIONS ARE TAKEN FROM EDGE OF SLAB TO FACE OF WOOD, UNLESS NOTED "CLEAR".
- 18. CONTRACTOR TO INSTALL BLOCKING IN WALLS AND CEILINGS AS REQUIRED FOR ALL ACCESSORIES, WALL MOUNTED ITEMS, CEILING FANS, ETC.
- 19. TRUSS MANUFACTURER SHALL SUPPLY SHOP DRAWINGS SEALED BY AN ENGINEER TO ARCHITECT AND CONTRACTOR FOR APPROVAL PRIOR TO FABRICATION.
- 20. CONTACT ARCHITECT/OWNER WITH ANY FRAMING QUESTIONS/DISCREPANCIES.

- REFER TO SHEET G1.0 FOR CODE COMPLIANCE.
- 2. REFER TO SHEET G2.0 FOR GENERAL NOTES.
- 4. REFER TO A3.0 SERIES FOR EXTERIOR ELEVATIONS AND ADDITIONAL WINDOW TAGS.

- ALL DIMENSIONS TO FACE OF STUD, FACE OF CONCRETE,
- ILLUSTRATED, UNLESS DIMENSIONED OTHERWISE.
- - A. ALL EXTERIOR & LOADING BEARING WALLS SHALL BE
 - PARTITIONS SHALL BE CONSTRUCTED WITH 2X4 WOOD FRAMING AT 24" ON CENTER, U.N.O.
 - D. ALL INTERIOR PARTITIONS SUPPORTING POCKET
- 10. ROOF AND FLOOR FRAMING SHALL BE PER STRUCTURAL DRAWINGS. TRUSS MANUFACTURER SHALL SUPPLY SHOP
- 10. EXTERIOR WALL INSULATION ALL EXTERIOR WALLS SHALL RECEIVE MIN. R-19 CELLULOSE BLOWN-IN INSULATION WITH
- 11. ROOF INSULATION ALL ROOF SHALL RECEIVE MIN. R-36
- 12. FLOOR INSULATION ALL SPACES BETWEEN FLOORS SHALL
- 14. CONTRACTOR SHALL PROVIDE BLOCKING IN WALLS AND
- 15. USE ½" WATER RESISTANT GYP BD IN BATHROOM AND
- 17. ALL DOOR OPENINGS TO BE 4" FROM ADJACENT WALL,

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NORTH

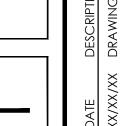

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SHEET NAME **FIRST FLOOR** PLAN

SHEET NUMBER

LEGEND AND SCALE

EXTERIOR 2X4 WALL WITH BRICK EXTERIOR 2X6 WALL WITH HARDIE SIDING

EXTERIOR 2X4 WALL WITH HARDIE SIDING


INTERIOR 2X4 WALL INTERIOR 2X6 WALL

2X4 PARTIAL HEIGHT WALL

2X6 WALL BELOW INTERIOR 2X4 FLAT STUD WALL

FULL SIZE SCALE : 1/4" = 1'-0" (HALF SIZE SCALE: $\frac{1}{8}$ " = 1'-0")

FLOOR PLAN: MASTER BEDROOM ADDITION
SCALE: 1/4" = 1'-0"

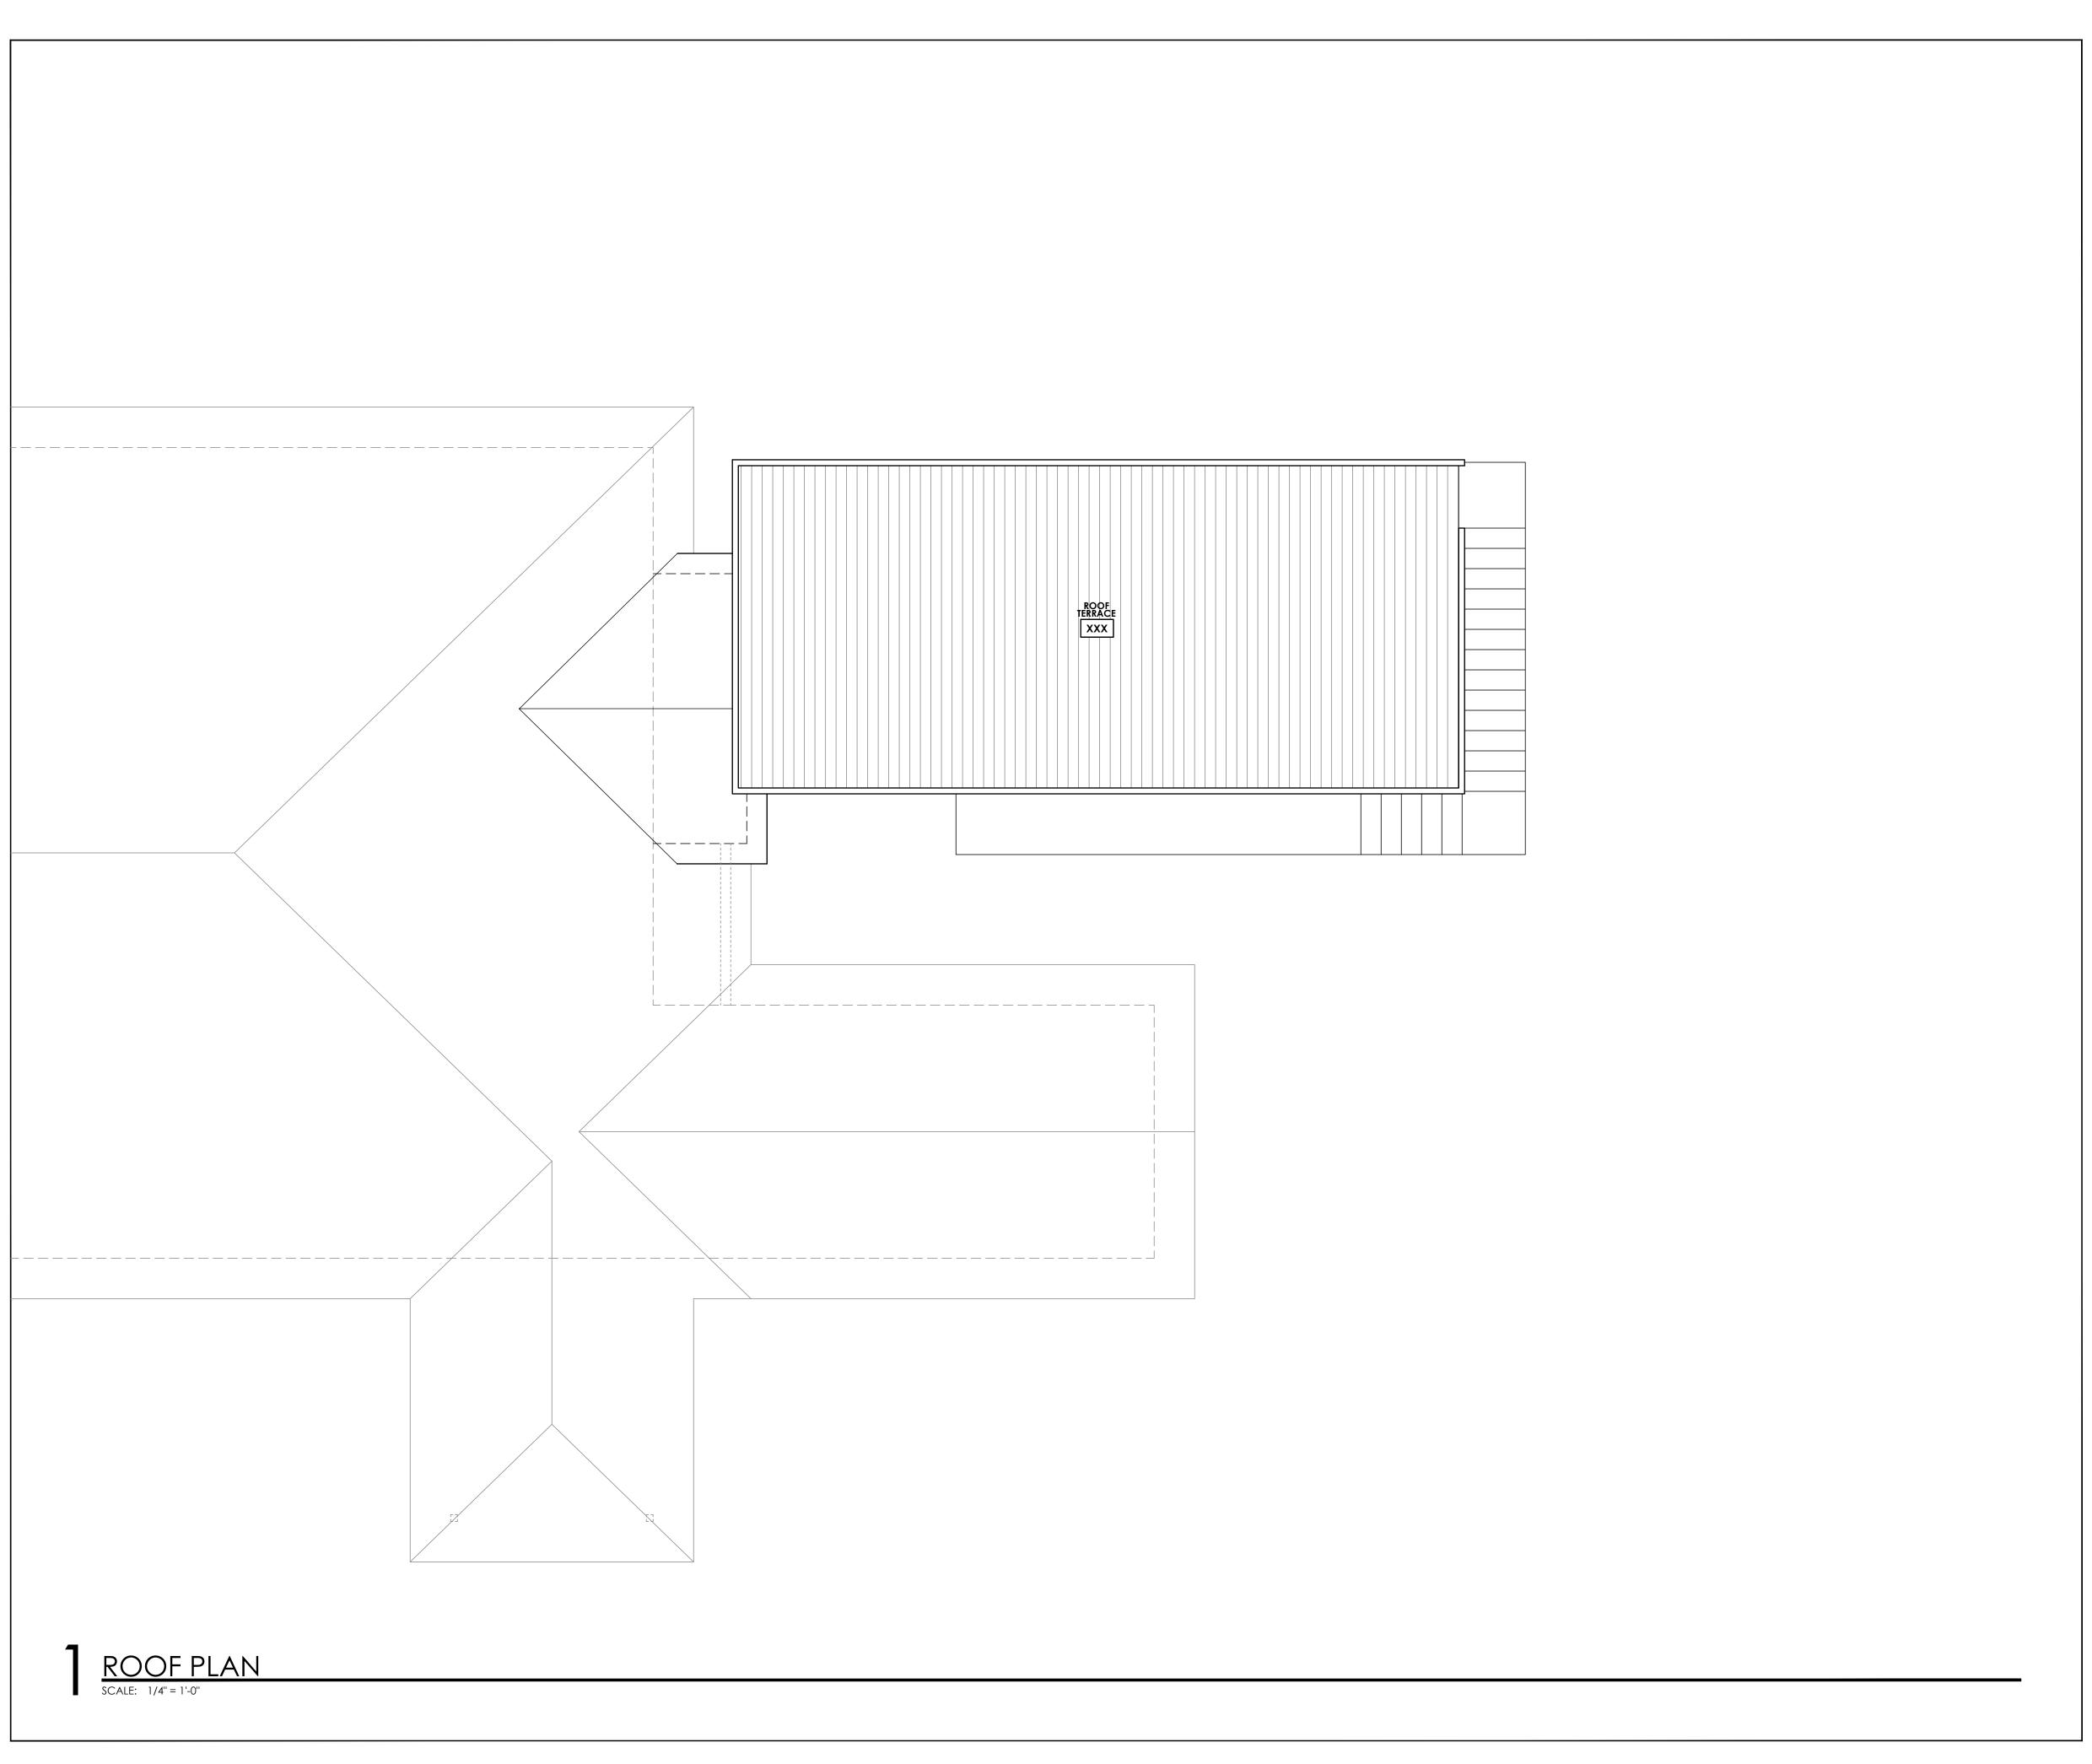

SHEET NOTES

- PROVIDE GUTTERS AND DOWNSPOUTS.
- 2. BASIS OF DESIGN IS STANDING SEAM METAL ROOF. TPO OVER GARAGE.
- 3. VENT FOR ALL MECH/PLUMBING FIXTURES.
- 4. FIELD VERIFY ALL DIMENSIONS PRIOR TO CONSTRUCTION.
- 5. PROVIDE R-30 INSULATION BETWEEN ROOF AND CEILING.
- 6. PROVIDE RADIANT BARRIER ROOF DECKING.
- 7. FLASHING, UNDERLAYMENT, AND FASTENING DETAILS PER ROOF MANUF. INSTALLER. VERIFY WITH ARCHITECT.
- 8. COMPLETELY SEAL ROOF. PROVIDE FRESH AIR INTAKES AS PART OF HVAC SYSTEM.
- 9. SPRAY-FOAM INSULATION AT TRUSS AND SECOND FLOOR CEILING. SHEET ROCK BARRIER AROUND ALL MECHANICAL UNITS.
- 10. PROVIDE DECKING FOR MECHANICAL EQUIPMENT AND STORAGE.

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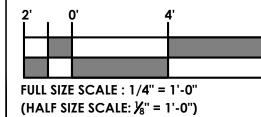
9TH STREET ADDITION 1502 W. 9TH STREET, AUSTIN, TEXAS 78703

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REV. # DATE DESCRIPTION
- XX/XX/XX DRAWING SET

JOB NO. R2203 DRAWN BY LL

SCALE



NORTH


SHEET NUMBER

A1.3


SHEET NAME

ROOF

PLAN

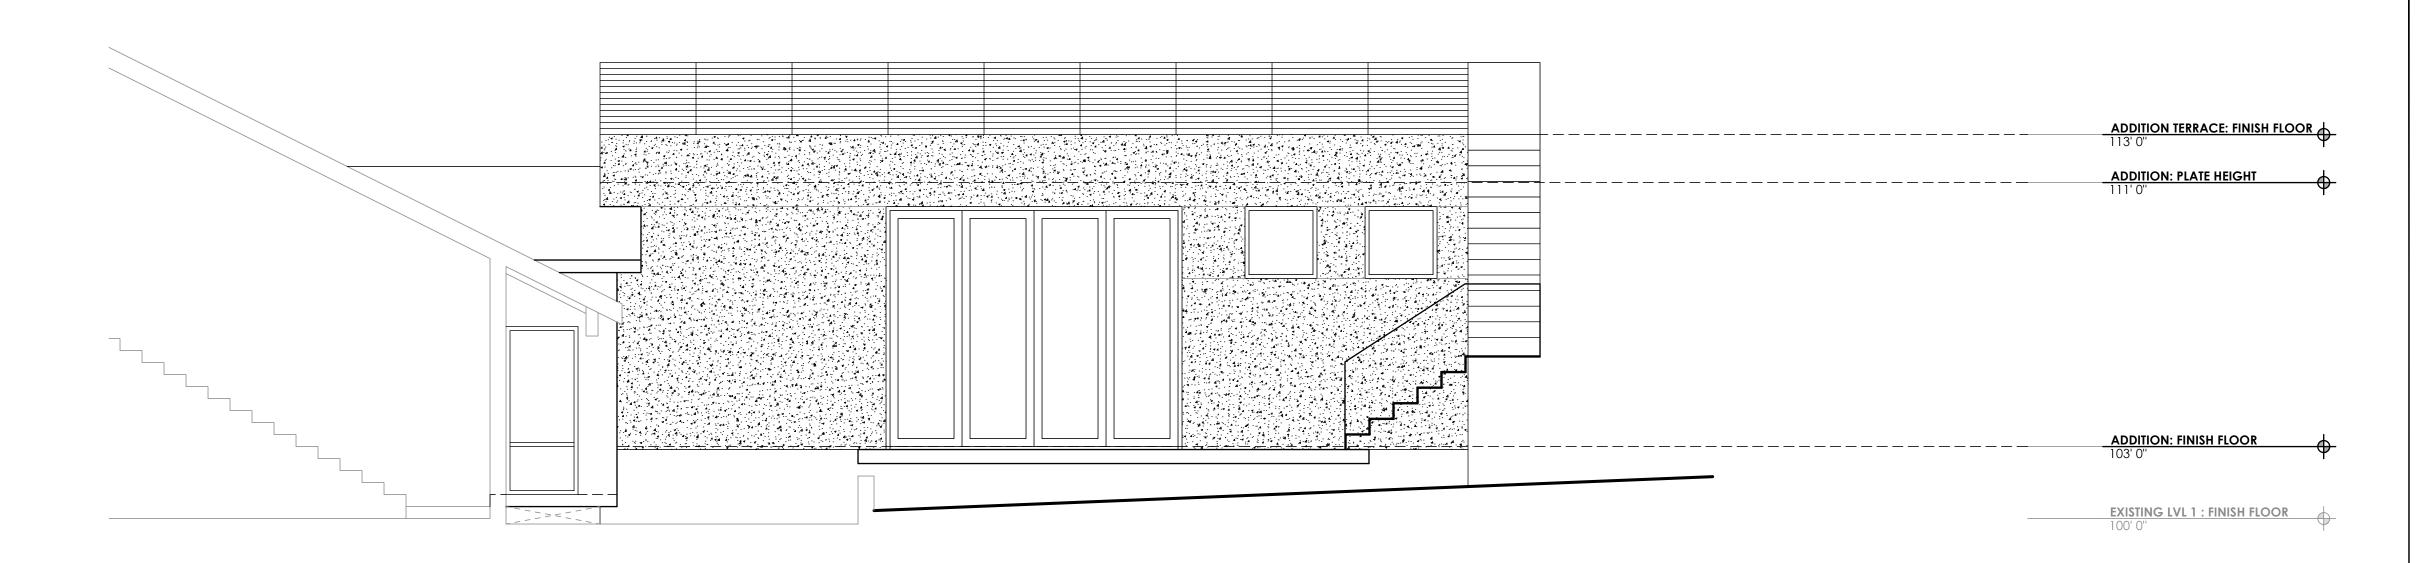

EAST EXTERIOR ELEVATION SCALE: 1/4" = 1'-0"

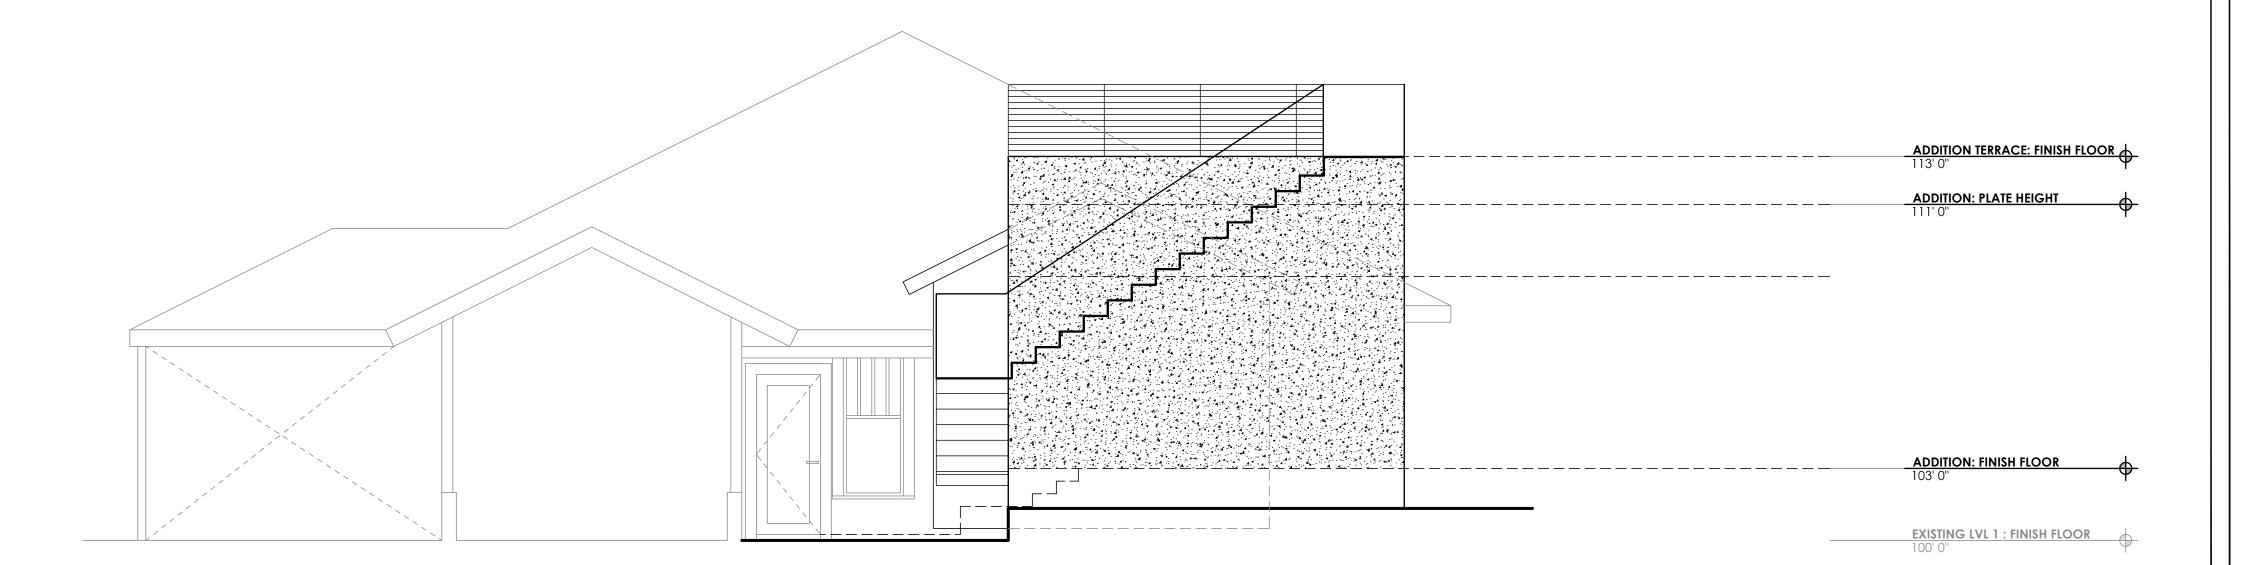

NORTH EXTERIOR ELEVATION

SCALE: 1/4" = 1'-0"

SHEET NOTES

- 1. REFER TO G1.0 FOR CODE COMPLIANCE.
- 2. REFER TO G2.0 FOR GENERAL NOTES.
- REFER TO XXX FOR EXTERIOR ASSEMBLY NOTES AND SPECIFICATIONS.
- 4. REFER TO XXX FOR DOOR AND WINDOW TYPES & SCHEDULE
- CONTRACTOR SHALL PROVIDE GUTTER AND DOWNSPOUT SYSTEM TO POSITIVELY DRAIN ROOF AWAY FROM BUILDING AND INTO LANDSCAPE BEDS.
- 4. ALL WINDOW HEADER HEIGHTS ON LOWER AND UPPER FLOOR SHALL BE 7'-8" AFF UNO.
- ALL WINDOWS LOCATED WITHIN 24" OF AN EXTERIOR OR INTERIOR DOOR SHALL RECEIVE TEMPERED SAFETY GLASS PER IRC 2015. WINDOW MANUFACTURER AND CONTRACTOR SHALL VERIFY ALL TEMPERED GLASS LOCATIONS PER APPLICABLE CODES.
- WINDOW MANUFACTURER AND CONTRACTOR SHALL VERIFY ALL EGRESS WINDOWS ARE INSTALLED PER APPLICABLE CODE REQUIREMENTS.
- 7. ALL WINDOWS SHALL HAVE U-FACTOR 0.40 OR LESS PER CITY OF AUSTIN CODE AMENDMENT.
- 8. ALL WINDOWS SHALL BE ALUMINUM CLAD AND FACTORY MULLED WHEN POSSIBLE.
- 9. PROVIDE MIN. 4" TRIM AT ALL SIDES OF ALUMINUM WINDOWS.
- 10. EXPOSED FOUNDATION SHALL BE MIN. 8" AND A MAXIMUM OF X INCHES ABOVE GRADE. UNDERPIN ALL EXPOSED FOUNDATIONS.
- 11. GRADE LINES SHOWN ON ELEVATION DRAWINGS SHALL NOT BE CONSTRUED TO REPRESENT ACTUAL FINISH GRADES. VERIFY FINISH GRADE ON JOB SITE AND NOTIFY ARCHITECT OF ANY SIGNIFICANT DISCREPANCIES PRIOR TO STARTING WORK.
- 12. ACTUAL ELEVATIONS TO VARY PER GRADE OF EXISTING
- 13. ALL PLUMBING, APPLIANCE, AND GAS VENTS TO BE GANGED TO THE LEAST POSSIBLE NUMBER OF ROOF PENETRATIONS AND KEPT TO REAR OF ROOF WHENEVER
- 14. CONTRACTOR SHALL INSTALL ALL PRODUCTS AND ASSEMBLIES PER MANUFACTURER'S RECOMMENDED INSTALLATION.
- 15. ALL EXTERIOR SYSTEMS SHALL BE INSTALLED TO ASSURE ADEQUATE DRAINAGE IS PROVIDED.
- 16. TEMP GLZ = PROVIDE TEMPERED SAFETY GLASS AT ALL REQUIRED LOCATIONS AS REQUIRED BY CODE.

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JOB NO. DRAWN BY

SHEET NAME **EXTERIOR**

SHEET NUMBER

ELEVATIONS

LEGEND AND SCALE

FULL SIZE SCALE : 1/4" = 1'-0" (HALF SIZE SCALE: $\frac{1}{8}$ " = 1'-0")



SCALE: 1/4" = 1'-0"

SHEET NOTES

- 1. REFER TO G1.0 FOR CODE COMPLIANCE.
- 2. REFER TO G2.0 FOR GENERAL NOTES.
- 3. REFER TO XXX FOR EXTERIOR ASSEMBLY NOTES AND SPECIFICATIONS.
- 4. REFER TO XXX FOR DOOR AND WINDOW TYPES & SCHEDULE
- CONTRACTOR SHALL PROVIDE GUTTER AND DOWNSPOUT SYSTEM TO POSITIVELY DRAIN ROOF AWAY FROM BUILDING AND INTO LANDSCAPE BEDS.
- 4. ALL WINDOW HEADER HEIGHTS ON LOWER AND UPPER FLOOR SHALL BE 7'-8" AFF UNO.
- 5. ALL WINDOWS LOCATED WITHIN 24" OF AN EXTERIOR OR INTERIOR DOOR SHALL RECEIVE TEMPERED SAFETY GLASS PER IRC 2015. WINDOW MANUFACTURER AND CONTRACTOR SHALL VERIFY ALL TEMPERED GLASS LOCATIONS PER APPLICABLE CODES.
- WINDOW MANUFACTURER AND CONTRACTOR SHALL VERIFY ALL EGRESS WINDOWS ARE INSTALLED PER APPLICABLE CODE REQUIREMENTS.
- 7. ALL WINDOWS SHALL HAVE U-FACTOR 0.40 OR LESS PER CITY OF AUSTIN CODE AMENDMENT.
- 8. ALL WINDOWS SHALL BE ALUMINUM CLAD AND FACTORY MULLED WHEN POSSIBLE.
- 9. PROVIDE MIN. 4" TRIM AT ALL SIDES OF ALUMINUM WINDOWS.
- 10. EXPOSED FOUNDATION SHALL BE MIN. 8" AND A MAXIMUM OF x INCHES ABOVE GRADE. UNDERPIN ALL EXPOSED FOUNDATIONS.
- 11. GRADE LINES SHOWN ON ELEVATION DRAWINGS SHALL NOT BE CONSTRUED TO REPRESENT ACTUAL FINISH GRADES. VERIFY FINISH GRADE ON JOB SITE AND NOTIFY ARCHITECT OF ANY SIGNIFICANT DISCREPANCIES PRIOR TO STARTING WORK.
- 12. ACTUAL ELEVATIONS TO VARY PER GRADE OF EXISTING LOT.
- 13. ALL PLUMBING, APPLIANCE, AND GAS VENTS TO BE GANGED TO THE LEAST POSSIBLE NUMBER OF ROOF PENETRATIONS AND KEPT TO REAR OF ROOF WHENEVER POSSIBLE.
- 14. CONTRACTOR SHALL INSTALL ALL PRODUCTS AND ASSEMBLIES PER MANUFACTURER'S RECOMMENDED INSTALLATION.
- 15. ALL EXTERIOR SYSTEMS SHALL BE INSTALLED TO ASSURE ADEQUATE DRAINAGE IS PROVIDED.
- 16. TEMP GLZ = PROVIDE TEMPERED SAFETY GLASS AT ALL REQUIRED LOCATIONS AS REQUIRED BY CODE.

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JOB NO. R2203 DRAWN BY

SHEET NAME **EXTERIOR ELEVATIONS**

SHEET NUMBER

LEGEND AND SCALE

FULL SIZE SCALE : 1/4" = 1'-0" (HALF SIZE SCALE: $\frac{1}{8}$ " = 1'-0")