

Ryan O'Connor and Sheer Nisman

2012 E 16th Street Austin, Texas 78702 Mobile +1 713 703 3141

Low Design Office

2601A S 2nd St Austin, TX 78704 Telephone +1 832 729 7962 www.lowdo.net

Fort Structures

2235 East 6th Street #105 Austin, TX 78702 Telephone +1 512 817 9264 sam@fortstructures.com

12/28/21 COA Permit Set



Any reproduction or translation of all or any part of this work without the written consent of Low Design Office, LLC is unlawful. For any information please contact Low Design Office, LLC

O'CONNOR/NISMAN RESIDENCE ADDITION 2012 E 16th Street

Austin, Texas 78702

Proposed Site Plan

12/28/21 12/28/21

A0.2

O'Connor Residence Addition

COA PERMIT SET 12/28/2021

DRAWING LIST

AO.O TITLE SHEET AO.1 EXISTING PLAN WITH DEMO AO.11 EXISTING ELEVATIONS WITH DEMO AO.2 PROPOSED SITE PLAN AO.4 SETBACK COMPLIANCE PLAN A0.5 TENT ENVELOPE COMPLIANCE DRAWINGS A1.0 GROUND FLOOR PLAN A1.1 SECOND FLOOR PLAN A1.2 ROOF PLAN A3.0 ELEVATIONS A3.1 ELEVATIONS A4.0 BUILDING SECTIONS A4.1 BUILDING SECTIONS A4.2 WALL AND BUILDING SECTIONS A9.0 WINDOW SCHEDULE A9.1 DOOR SCHEDULE P1.0 FIRST FLOOR PLUMBING PLAN P1.1 SECOND FLOOR PLUMBING PLAN TREE AND TOPOGRAPHIC SURVEY SO.O GENERAL NOTES SO.1 GENERAL NOTES S1.0 FOUNDATION PLAN S1.1 SECOND FLOOR & LOWER ROOF FRAMING PLAN

S1.2 UPPER ROOF FRAMING PLAN

S2.0 FOUNDATION DETAILS

S2.1 FOUNDATION DETAILS S3.0 FRAMING DETAILS

S3.2 TYPICAL FRAMING DETAILS

S3.3 TYPICAL FRAMING DETAILS

S3.1 FRAMING DETAILS


S1.3 FIRST FLOOR BRACED WALL PLAN

S1.4 SECOND FLOOR BRACED WALL PLAN

ABBREVIATIONS

CONC. CTR. DEMO. DIM. DWG. EL. ELEC. EXT. FFE. GA. GPDW	COLUMN CONCRETE CENTER DEMOLISH, DEMOLITION DIMENSION DRAWING ELEVATION ELECTRICAL EXTERIOR FINISH FLOOR ELEVATION GAUGE GYPSUM DRY WALL HARDWOOD METAL	N.T.S. O.C. O.D. O.F. OPP. PLYWD. REF. REQD. R.O. S.F. SIM. TYP. VAR. VIF W/ WD. W/O	OUTSIDE FACE OPPOSITE PLYWOOD REFERENCE REINFORCE REQUIRED ROUGH OPENING SQUARE FT. SIMILAR TYPICAL

DRAWING SYMBOLS

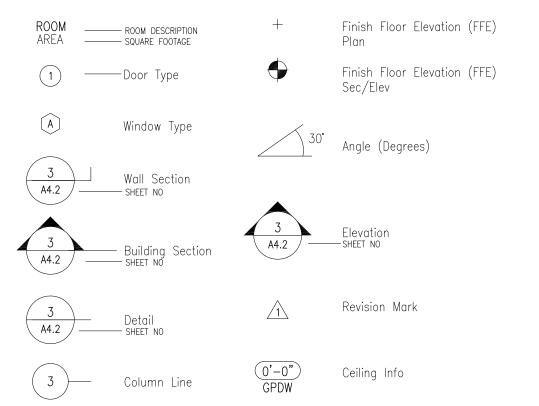

GENERAL PROJECT NOTES

- 1. CONSTRUCTION OF THIS PROJECT SHALL BE IN COMPLIANCE WITH ALL APPLICABLE CODES, ORDINANCES AND REGULATIONS OF THE GOVERNING JURISDICTION.
- THE DRAWINGS AND SPECIFICATIONS: THESE DETAILS COVER THE FURNISHING AND INSTALLATION OF ALL MATERIALS AND WORK AS CALLED FOR ON THE DRAWINGS AND/OR THE SPECIFICATIONS WHICH ARE BOUND SEPARATELY AND ARE PART OF THIS CONTRACT. IT SHALL BE THE RESPONSIBILITY OF EACH CONTRACTOR TO CHECK WITH THE ARCHITECTURAL AND ALL OTHER CONTRACT DRAWINGS BEFORE THE INSTALLATION OF THEIR WORK. ANY DISCREPANCY BETWEEN THE DRAWINGS SHALL BE BROUGHT TO THE DESIGNER'S ATTENTION BY NOTIFICATION FOR CLARIFICATION. ANY WORK INSTALLED IN CONFLICT WITH THE ARCHITECTURAL DRAWINGS SHALL BE CORRECTED BY THE CONTRACTOR AT HIS OWN EXPENSE AND AT NO EXPENSE TO THE OWNER, ENGINEER OR DESIGNER.
- ABBREVIATIONS: THROUGHOUT THE PLANS ARE ABBREVIATIONS WHICH ARE IN COMMON USE. THE LIST OF ABBREVIATIONS PROVIDED IS NOT INTENDED TO BE COMPLETE OR REPRESENTATIVE OF CONDITIONS OR MATERIALS ACTUALLY USED ON THE PROJECT. THE ARCHITECT WILL DEFINE THE INTENT OF ANY IN QUESTION.
- SCHEDULE AND RECEIVE APPROVAL FROM GOVERNING JURISDICTION FOR ALL UTILITY INTERUPTIONS A MINIMUM OF ONE WEEK (7 DAYS) IN ADVANCE OF NEEDED DATE.
- THE GENERAL CONTRACTOR SHALL BE RESPONSIBLE FOR VERIFICATION AND COORDINATION WITH OTHER INSTALLERS TO SECURE COMPLIANCE OF DRAWING AND SPECIFICATIONS CONCERNING THE ACCURATE LOCATION OF STRUCTURAL MEMBERS AND OPENINGS FOR MECHANICAL, ELECTRICAL AND MISCELLANEOUS EQUIPMENT.
- CONTRACTOR SHALL VERIFY SIZES AND LOCATIONS OF ALL OPENINGS FOR MECHANICAL EQUIPMENT AS WELL AS SHOP DRAWINGS AS APPROVED BY DESIGNER OR ENGINEER BEFORE PROCEEDING WITH THE WORK.
- CONTRACTOR SHALL VERIFY SIZES AND LOCATIONS OF ALL EQUIPMENT PADS AND BASES AS WELL AS POWER AND WATER OR DRAIN INSTALLATION WITH APPROVED SHOP DRAWING SUBMITTALS BEFORE PROCEEDING WITH THE WORK.
- PROVIDE BLOCKING BEHIND ALL WALL MOUNTED ACCESSORIES AND MILLWORK AS REQUIRED BY APPLICABLE MANUFACTURER RECOMMENDATIONS, AND AS APPROVED BY THE DESIGNER DURING SUBMITTAL PROCESS.
- ALL PENETRATIONS OF FIRE RESISTIVE FLOORS OR WALLS SHALL BE PROTECTED BY MATERIALS AND INSTALLATION DETAILS THAT CONFORM TO UNDERWRITERS LABORATORIES' LISTINGS FOR PENETRATION THROUGH FIRE STOP SYSTEM. THE CONTRACTOR SHALL SUBMIT SHOP DRAWING DETAILS OF EACH PENETRATION WHICH SHOW COMPLIANCE TO THE U.L. LISTING TO THE ARCHITECT AND SUCH DRAWINGS SHALL BE AVAILABLE TO THE SUPERVISING INSPECTOR.
- CONTRACTOR SHALL CONTACT DESIGNER PRIOR TO FINAL PLACEMENT OF LIGHT FIXTURES, DIFFUSERS, AND EXHAUST CEILING AND WALL FANS FOR APPROVAL.
- 11. CONTRACTOR TO VERIFY UTILITY REQUIREMENTS TO ALL NEW FIXTURES.
- ALL EXTERIOR WALL OPENINGS, FLASHING, COUNTER—FLASHING, EXPANSION JOINTS SHALL BE CONSTRUCTED IN SUCH A MANNER AS TO MAKE THEM WEATHERPROOF
- 13. PROVIDE GALVANIC INSULATION BETWEEN DISSIMILAR METALS.
- 14. INSTALL DOOR FRAMES PRIOR TO WALL FINISH MATERIAL.
- 15. ALL GYP. BOARD CONSTRUCTION TO HAVE APPROPRIATE METAL EDGE TRIM TO PROVIDE SQUARE CORNERS AND STRAIGHT EDGES.
- 16. VERIFY ALL DIMENSIONS IN FIELD TO ENSURE PROPER CLEARANCES REQUIRED BY CODE
- 17. INSTALL 2x6 BLOCKING 2'-10" AFF IN WALLS AROUND ALL TUBS AND SHOWERS.



Ryan O'Connor and Sheer Nisman

2012 E 16th Street Austin, Texas 78702 Mobile +1 713 703 3141

Low Design Office

2601A S 2nd St Austin, TX 78704 Telephone +1 832 729 7962 www.lowdo.net

Fort Structures

2235 East 6th Street #105 Austin, TX 78702 Telephone +1 512 817 9264 sam@fortstructures.com

12/28/21 COA Permit Set



Any reproduction or translation of all or any part of this work without the written consent of Low Design Office, LLC is unlawful. For any information please contact Low Design Office, LLC

O'CONNOR/NISMAN RESIDENCE ADDITION 2012 E 16th Street


Austin, Texas 78702

201202

Title Sheet

Drawing Number

12/28/21 12/28/21

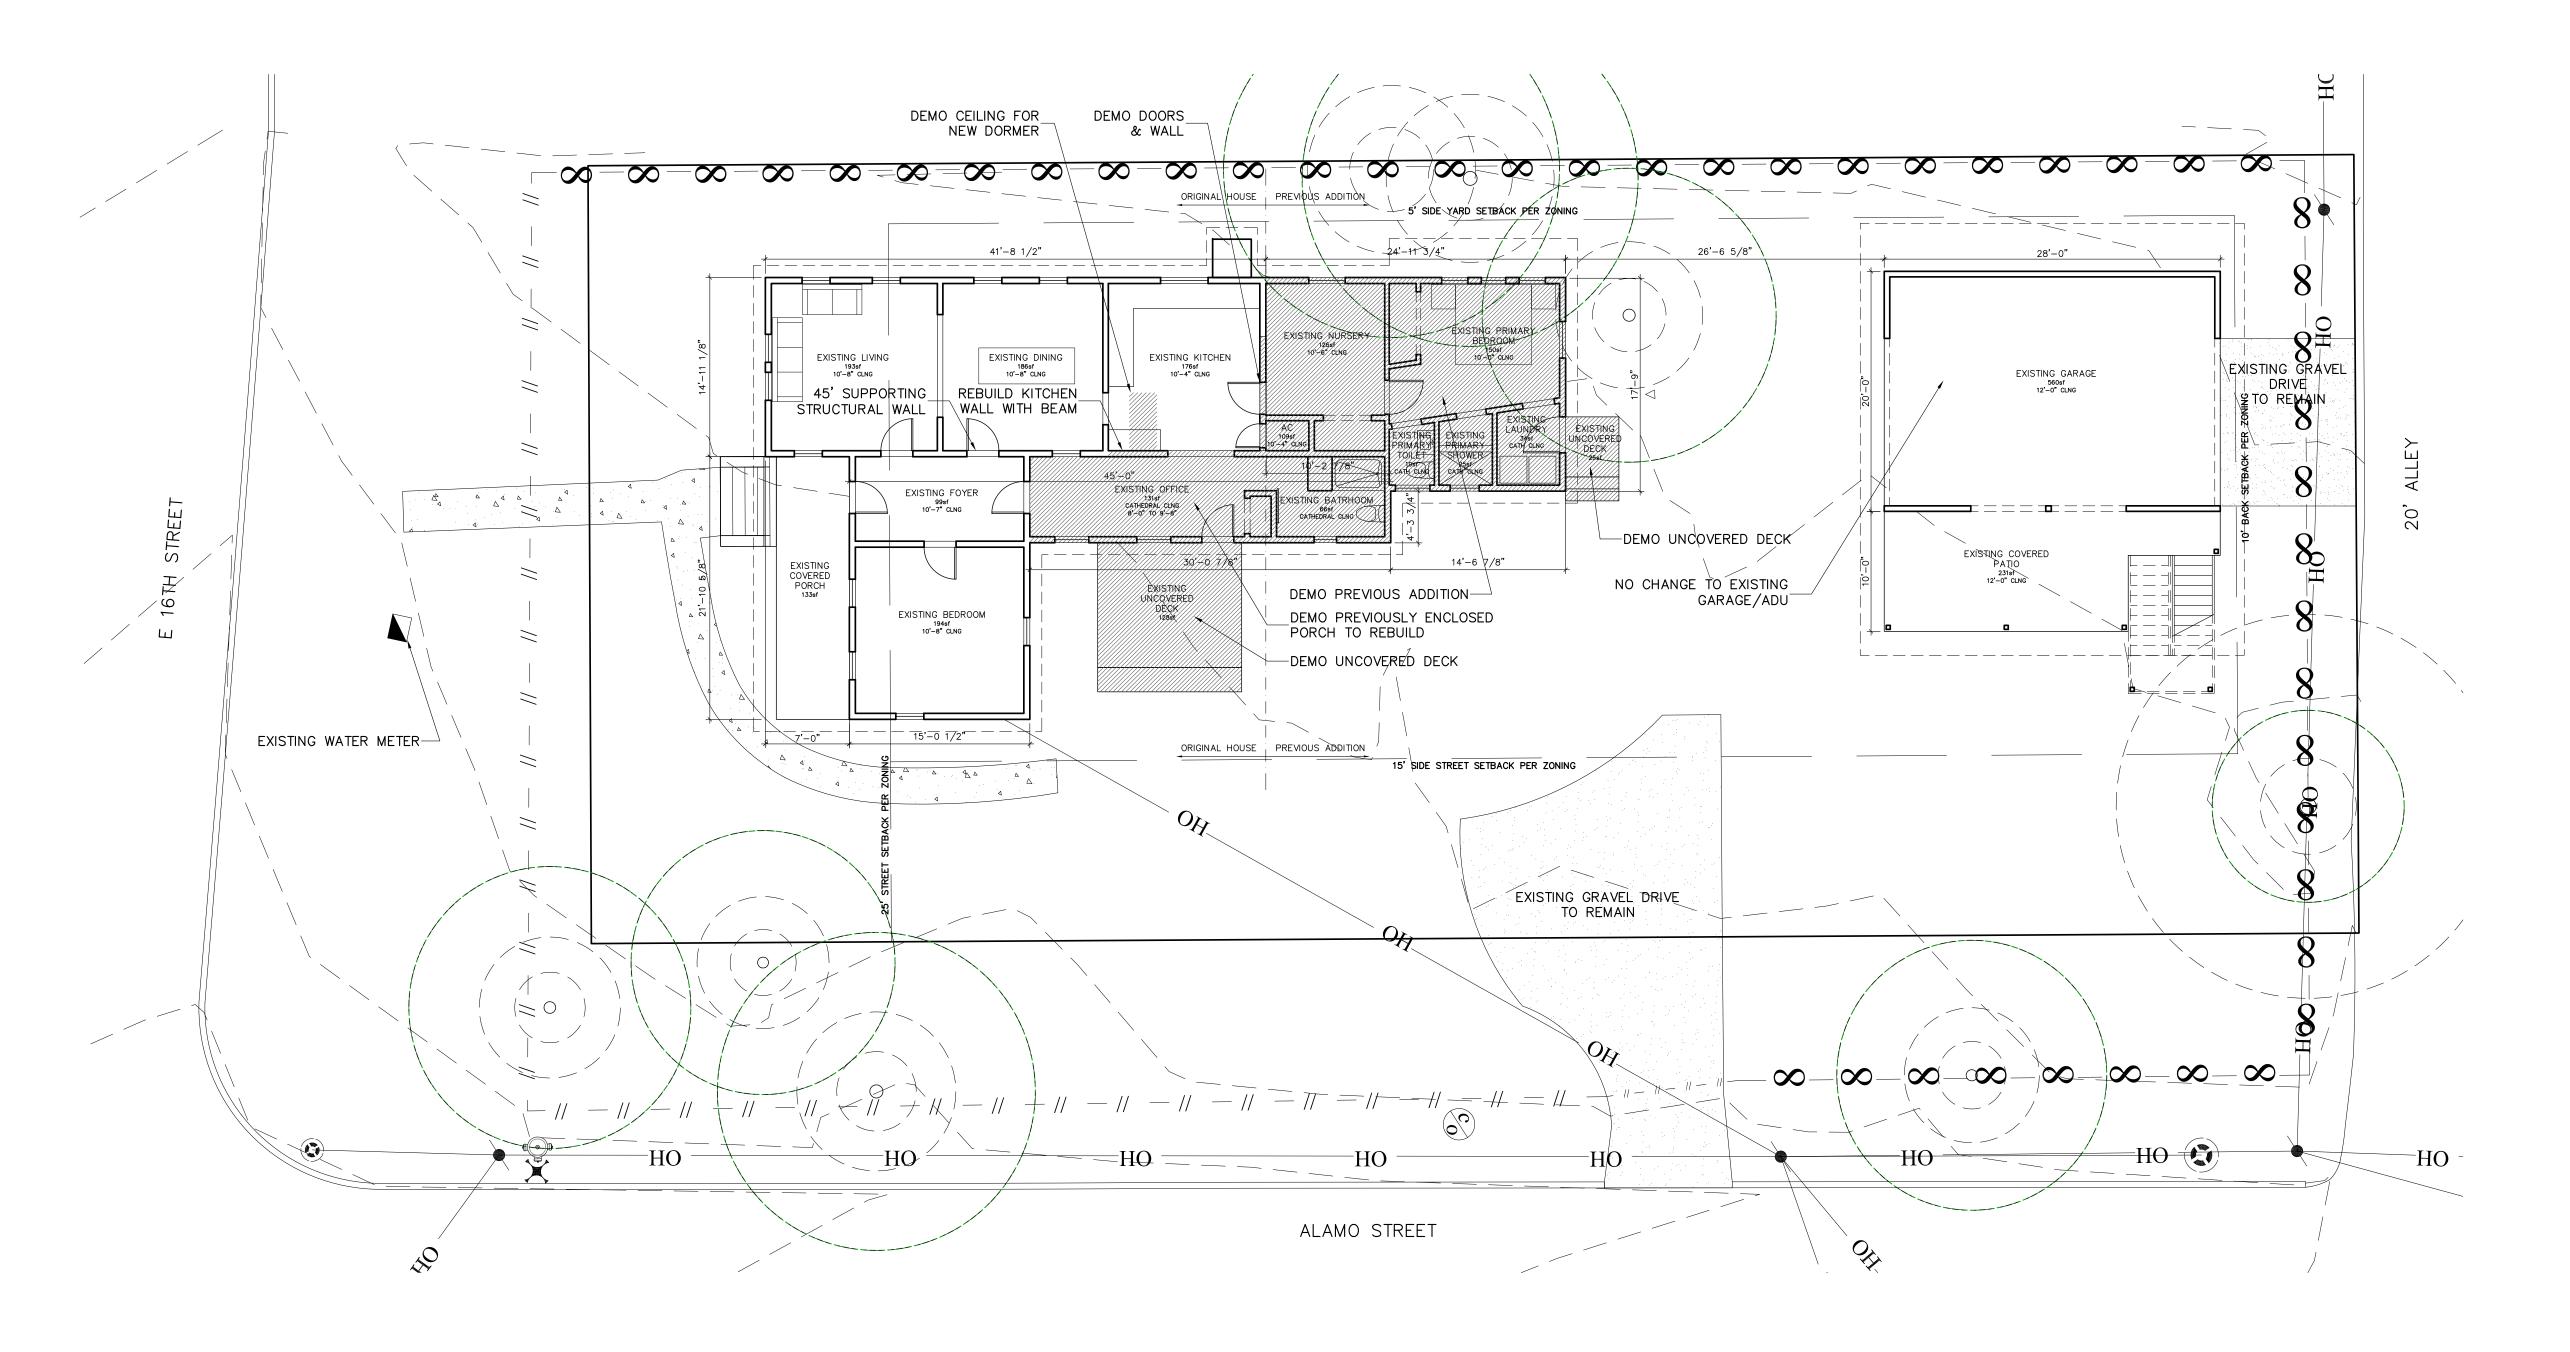

LEGAL DESCRIPTION: LOT 6 BLOCK 4 OLT 35 DIV B CROWS SUBDIVISION PROPERTY ZONING: SF-3-NP

9,547sf LOT AREA EXISTING BUILDING COVERAGE 2,640sf % BUILDING COVERAGE 27.7% IMPERVIOUS COVERAGE 3,491sf % IMPERVIOUS COVERAGE 36.6% TOTAL GROSS FLOOR AREA 2,343sf % FAR 24.5%

DEMO OF EXISTING NONCOMPLYING STRUCTURE CALCULATIONS 25-2-963(B) TOTAL LINEAR FEET EXT WALL TOTAL STRUCTURAL INT WALL TOTAL EXT AND STRUCTURAL INT WALL REMOVED

% STRUCTURAL WALL REMOVED

207.0' 45.0'

101.6

40.3%

2 Existing Site and Demo Plan 1/8" = 1'-0 printed on 22x34

1/16" = 1'-0 printed on 11x17



Ryan O'Connor and Sheer Nisman

2012 E 16th Street Austin, Texas 78702 Mobile +1 713 703 3141

Low Design Office 2601A S 2nd St Austin, TX 78704 Telephone +1 832 729 7962 www.lowdo.net

Fort Structures

2235 East 6th Street #105 Austin, TX 78702 Telephone +1 512 817 9264 sam@fortstructures.com

12/28/21 COA Permit Set



Copyright 2014

Any reproduction or translation of all or any part of this work without the written consent of Low Design Office, LLC is unlawful. For any information please contact Low Design Office, LLC

O'CONNOR/NISMAN RESIDENCE ADDITION

2012 E 16th Street Austin, Texas 78702

201202

Existing Plans

1/8" = 1'-0"

Drawing Date Plot Date 12/28/21 12/28/21



3/16" = 1'-0 printed on 22x34

3/32" = 1'-0 printed on 11x17



3 Existing North Elevation (Back)

3/16" = 1'-0 printed on 22x34 3/32" = 1'-0 printed on 11x17


3/16" = 1'-0 printed on 22x34

3/32" = 1'-0 printed on 11x17



1 Existing South Elevation (Front)

3/16" = 1'-0 printed on 22x34 3/32" = 1'-0 printed on 11x17

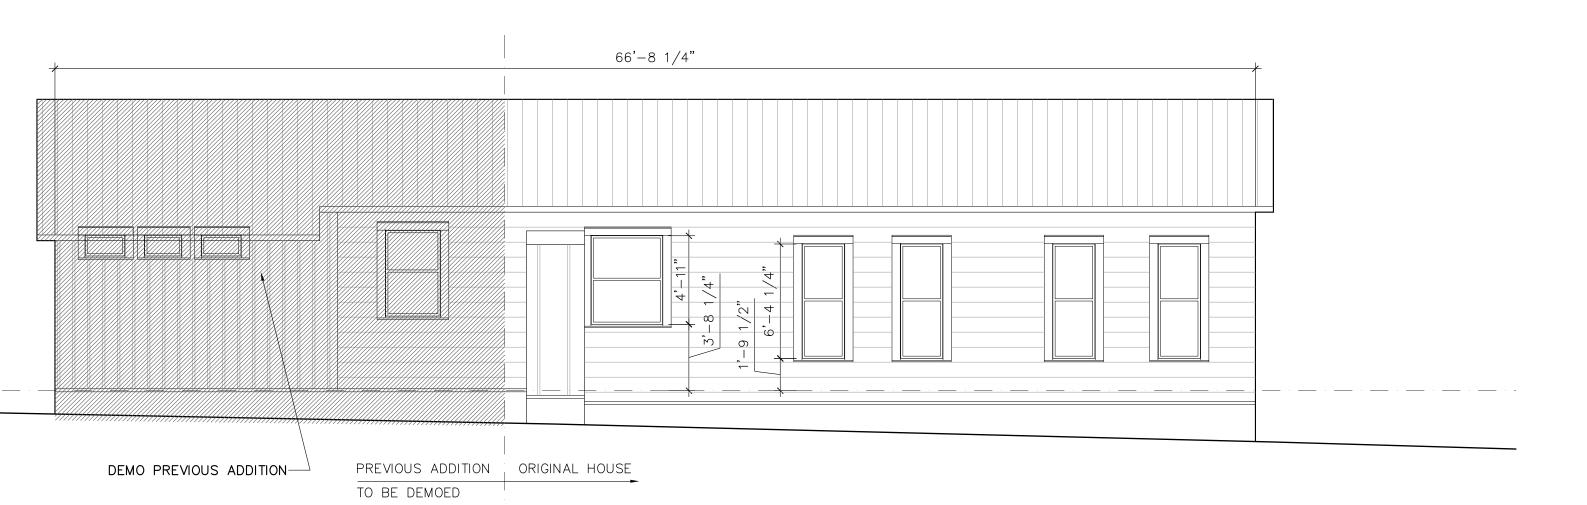

3/16" = 1'-0 printed on 22x34


3/32" = 1'-0 printed on 11x17

4 Existing West Elevation (Side)

3/16" = 1'-0 printed on 22x34 3/32" = 1'-0 printed on 11x17

3/16" = 1'-0 printed on 22x34

3/32" = 1'-0 printed on 11x17

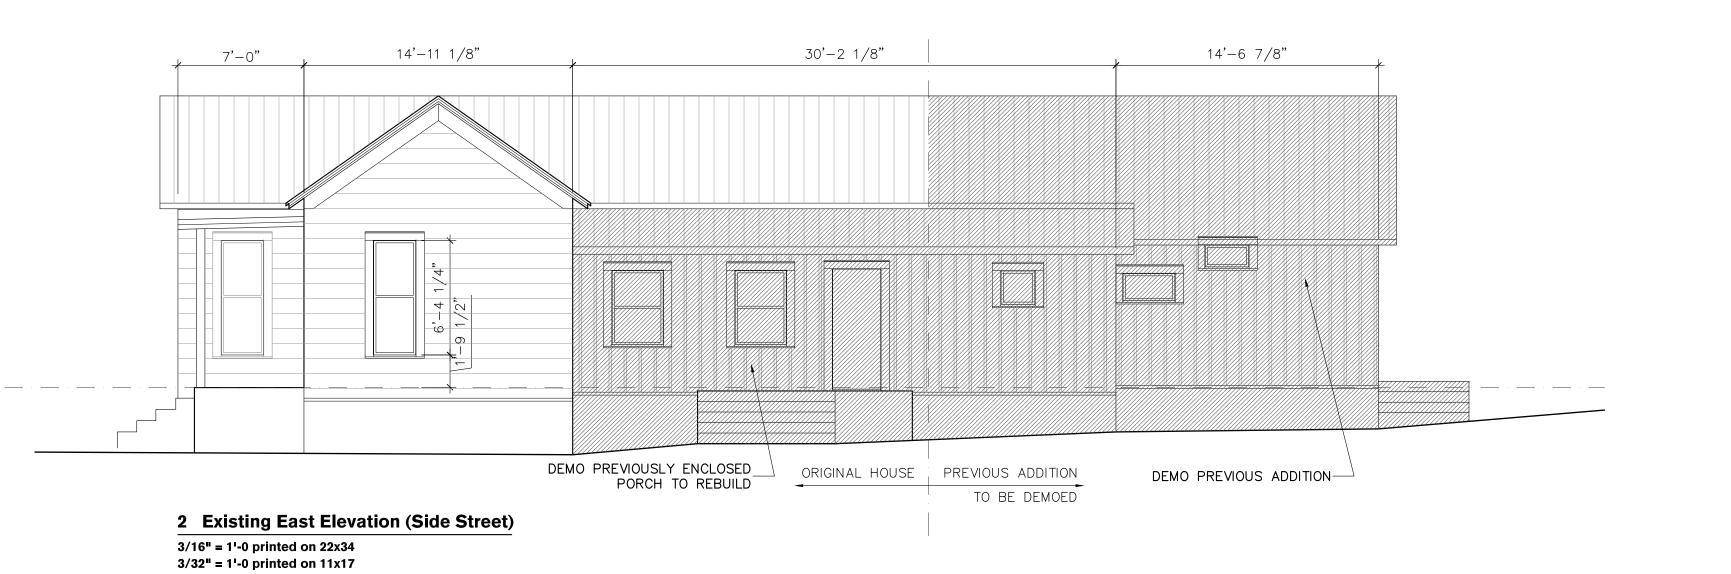

Ryan O'Connor and Sheer Nisman

2012 E 16th Street Austin, Texas 78702 Mobile +1 713 703 3141

Low Design Office

2601A S 2nd St Austin, TX 78704 Telephone +1 832 729 7962 www.lowdo.net

Fort Structures

2235 East 6th Street #105 Austin, TX 78702 Telephone +1 512 817 9264 sam@fortstructures.com

12/28/21 COA Permit Set



Any reproduction or translation of all or any part of this work without the written consent of Low Design Office, LLC is unlawful. For any information please contact Low Design Office, LLC

O'CONNOR/NISMAN RESIDENCE ADDITION

2012 E 16th Street Austin, Texas 78702

Job Number


201202

Existing Plans

3/16" = 1'-0"

Drawing Date Plot Date

12/28/21 12/28/21

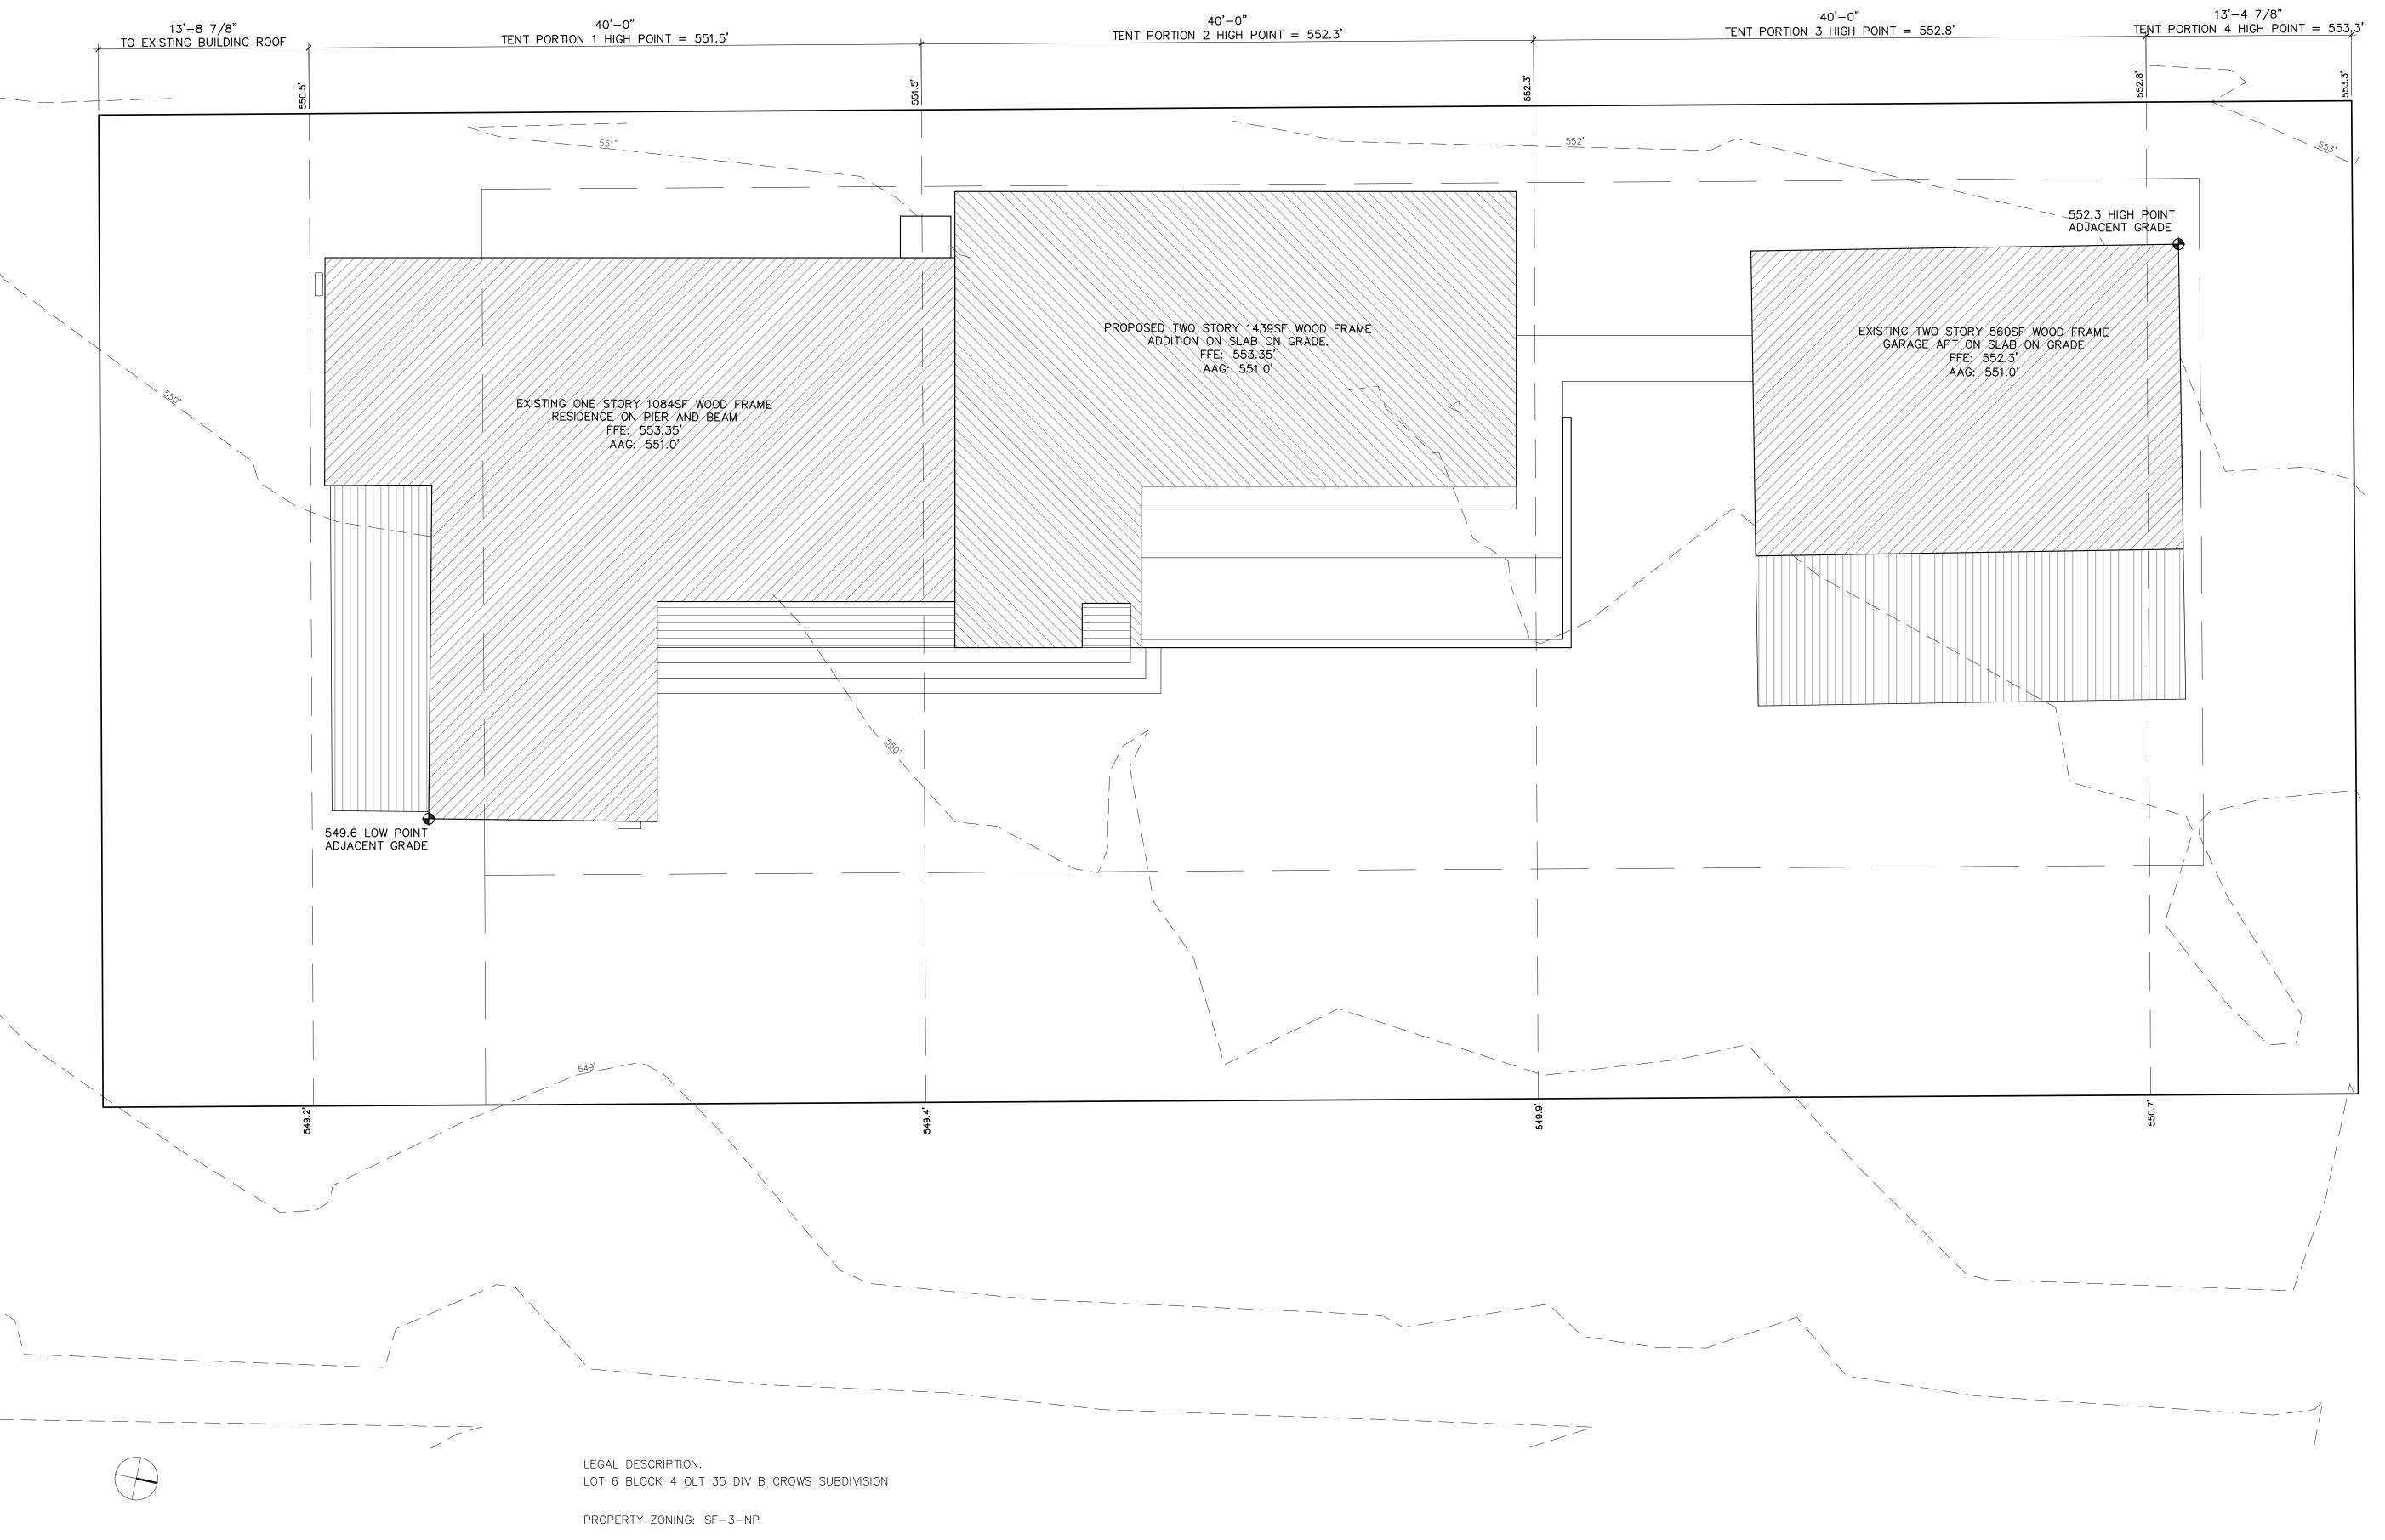

1 Setkback Compliance Plan

3/16" = 1'-0 printed on 22x34 3/32" = 1'-0 printed on 11x17



Ryan O'Connor and Sheer Nisman

2012 E 16th Street Austin, Texas 78702 Mobile +1 713 703 3141

Low Design Office 2601A S 2nd St Austin, TX 78704

Telephone +1 832 729 7962 www.lowdo.net

Fort Structures

2235 East 6th Street #105 Austin, TX 78702 Telephone +1 512 817 9264 sam@fortstructures.com

12/28/21 COA Permit Set



Any reproduction or translation of all or any part of this work without the written consent of Low Design Office, LLC is unlawful. For any information please contact Low Design Office, LLC

O'CONNOR/NISMAN RESIDENCE ADDITION 2012 E 16th Street

Austin, Texas 78702

201202

Setback Compliance Plan

3/16" = 1'-0"

Drawing Date Plot Date 12/28/21 12/28/21

Drawing Number

A0.4

Ryan O'Connor and Sheer Nisman

2012 E 16th Street Austin, Texas 78702 Mobile +1 713 703 3141

Low Design Office 2601A S 2nd St Austin, TX 78704 Telephone +1 832 729 7962 www.lowdo.net

Fort Structures

2235 East 6th Street #105 Austin, TX 78702 Telephone +1 512 817 9264 sam@fortstructures.com

TOP OF PROPOSED ROOF ADDITION

TOP OF EXISTING ROOF

L2 SUBFLOOR AT ADDITION

L1 TOP OF FLOOR AT EXISTING: 553.35'

TENT 1 LOW POINT 549.4

L1 PLATE AT ADDITION

12/28/21 COA Permit Set



Any reproduction or translation of all or any part of this work without the written consent of Low Design Office, LLC is unlawful. For any information please contact Low Design Office, LLC

O'CONNOR/NISMAN RESIDENCE ADDITION 2012 E 16th Street

Austin, Texas 78702

201202


Tent Envelope Compliance Drawings

3/16" = 1'-0"

Drawing Date Plot Date

12/28/21 12/28/21

Drawing Number

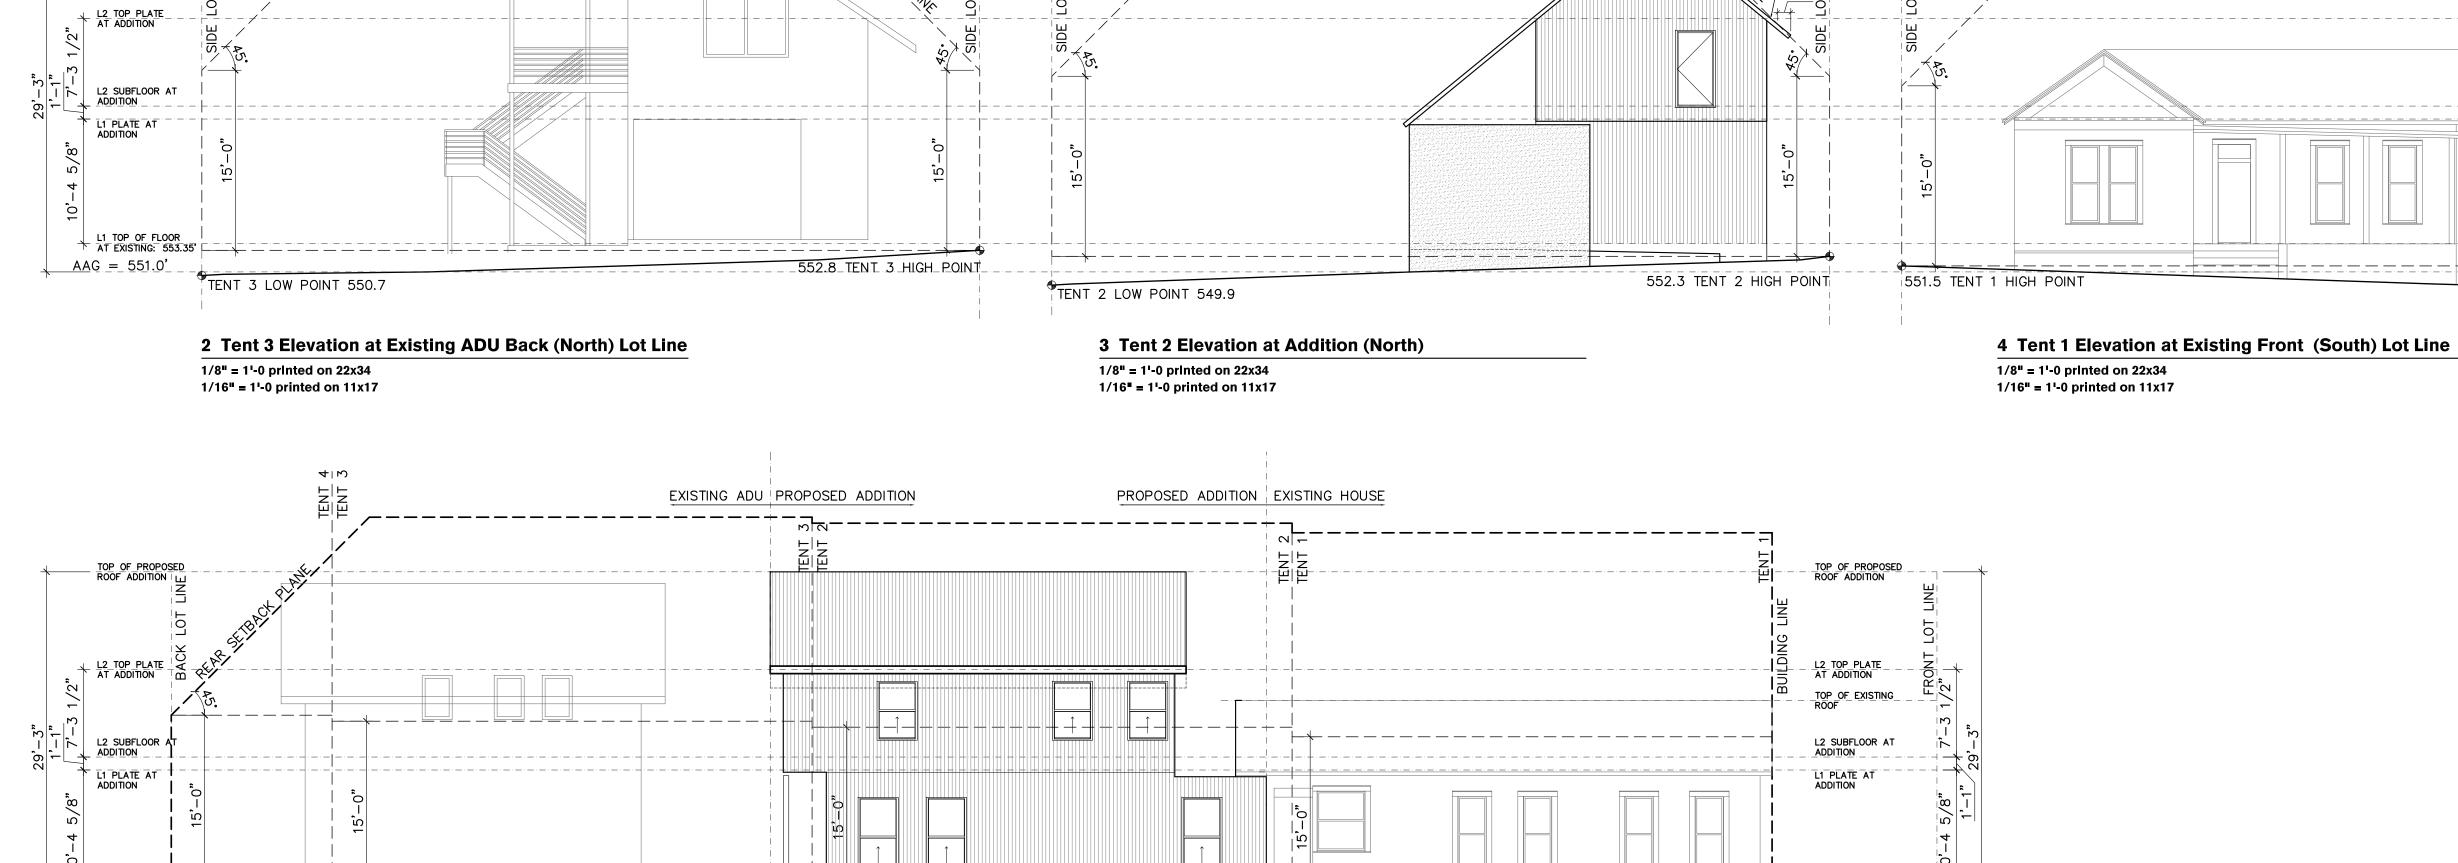

551.5 TENT 1 HIGH POINT

552.3 TENT 2 HIGH POINT

ROOF OVERHANG MAY EXTEND
INTO SETBACK PLANE PER
SUBCHAPTER F 2.6 E 1

L1_TOP_OF_FLOOR_ AT_EXISTING: 553.35'

AAG = 551.0'

13'-8 3/4"


1 Tent Elevation at Side (West) Lot Line

1/8" = 1'-0 printed on 22x34 1/16" = 1'-0 printed on 11x17

13'-4 3/4" TENT 4

AAG = 551.0, 553.3 TENT 4

TOP OF PROPOSED ROOF ADDITION

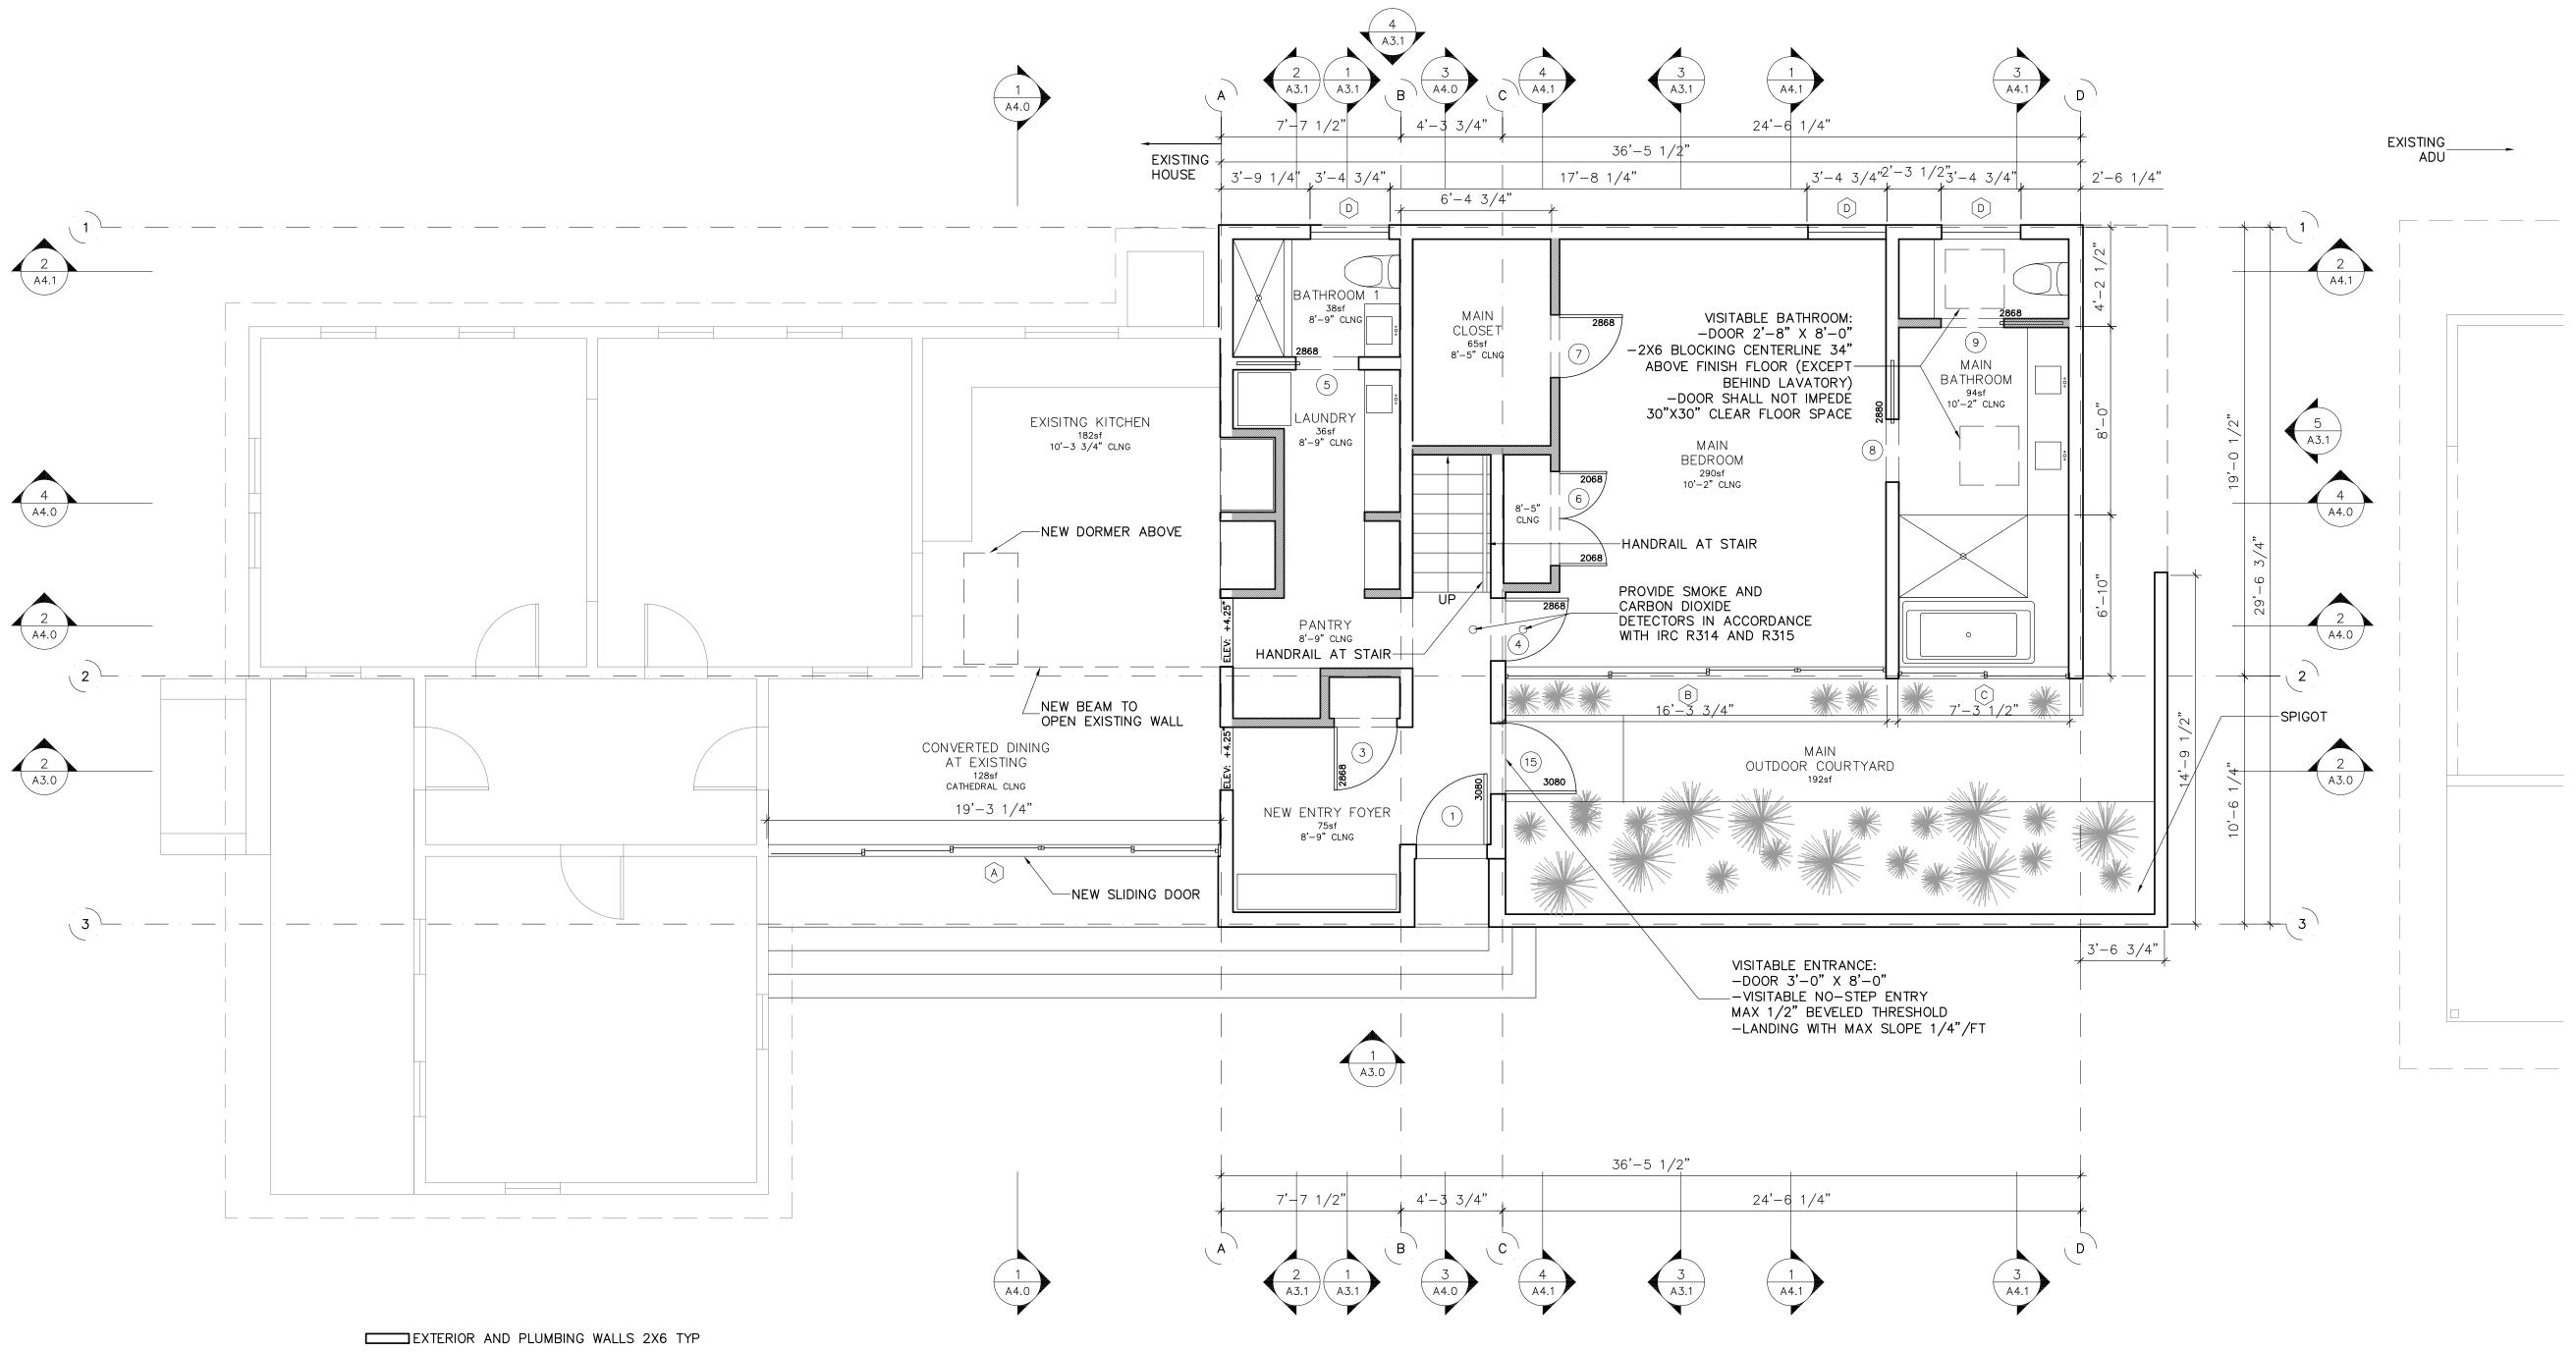

INTERIOR WALLS 2X4 TYP



1 First Floor Plan

1/4" = 1'-0 printed on 22x34 1/8" = 1'-0 printed on 11x17

GENERAL NOTES

- 1. ALL DIMENSIONS NOTED REFER TO STUD FRAMING, NOT FINISH MATERIALS
- 2. PROVIDE CLOTHES DRYER EXHAUST SYSTEM AT LAUNDRY ENCLOSURE. PER IRC SECTION M1502
- 3. PROVIDE SMOKE DETECTOR SYSTEM HARD WIRED, INTERCONNECTED, BATTERY BACKUP, AT EACH SLEEPING ROOM AND VICINITY. IN ACCORDANCE WITH 2012 IRC SEC R314
- 4. INSTALL 2X6 BLOCKING 2'-10" AFF IN ALL BATHROOM WALLS

- GENERAL CONTRACTOR SHALL VERIFY FOR SMOKE DETECTORS TO BE LOCATED AT LEAST 36" AWAY
- FROM HORIZONTAL PATH OF MECHANICAL AIR FLOW. PER 2007 NFPA 72 CHAPTER 11.
- APPROVED CARBON MONOXIDE ALARM SHALL BE INSTALLED OUTSIDE OF EACH SEPARATE SLEEPING AREA IN THE IMMEDIATE VICINITY OF THE BEDROOMS IN DWELLING UNITS WITHIN WHICH FUEL-FIRED APPLIANCES ARE INSTALLED AND IN DWELLING UNITS THAT HAVE ATTACHED GARAGES. IN ACCORDANCE WITH 2012 IRC SEC R315.1

Ryan O'Connor and Sheer Nisman

2012 E 16th Street Austin, Texas 78702 Mobile +1 713 703 3141

Low Design Office 2601A S 2nd St

Austin, TX 78704 Telephone +1 832 729 7962 www.lowdo.net

Fort Structures

2235 East 6th Street #105 Austin, TX 78702 Telephone +1 512 817 9264 sam@fortstructures.com

12/28/21 COA Permit Set



Any reproduction or translation of all or any part of this work without the written consent of Low Design Office, LLC is unlawful. For any information please contact Low Design Office, LLC

O'CONNOR/NISMAN RESIDENCE ADDITION

2012 E 16th Street Austin, Texas 78702

201202


Plans

1/4" = 1'-0"

Drawing Date Plot Date 12/28/21 12/28/21

Drawing Number

A1.0

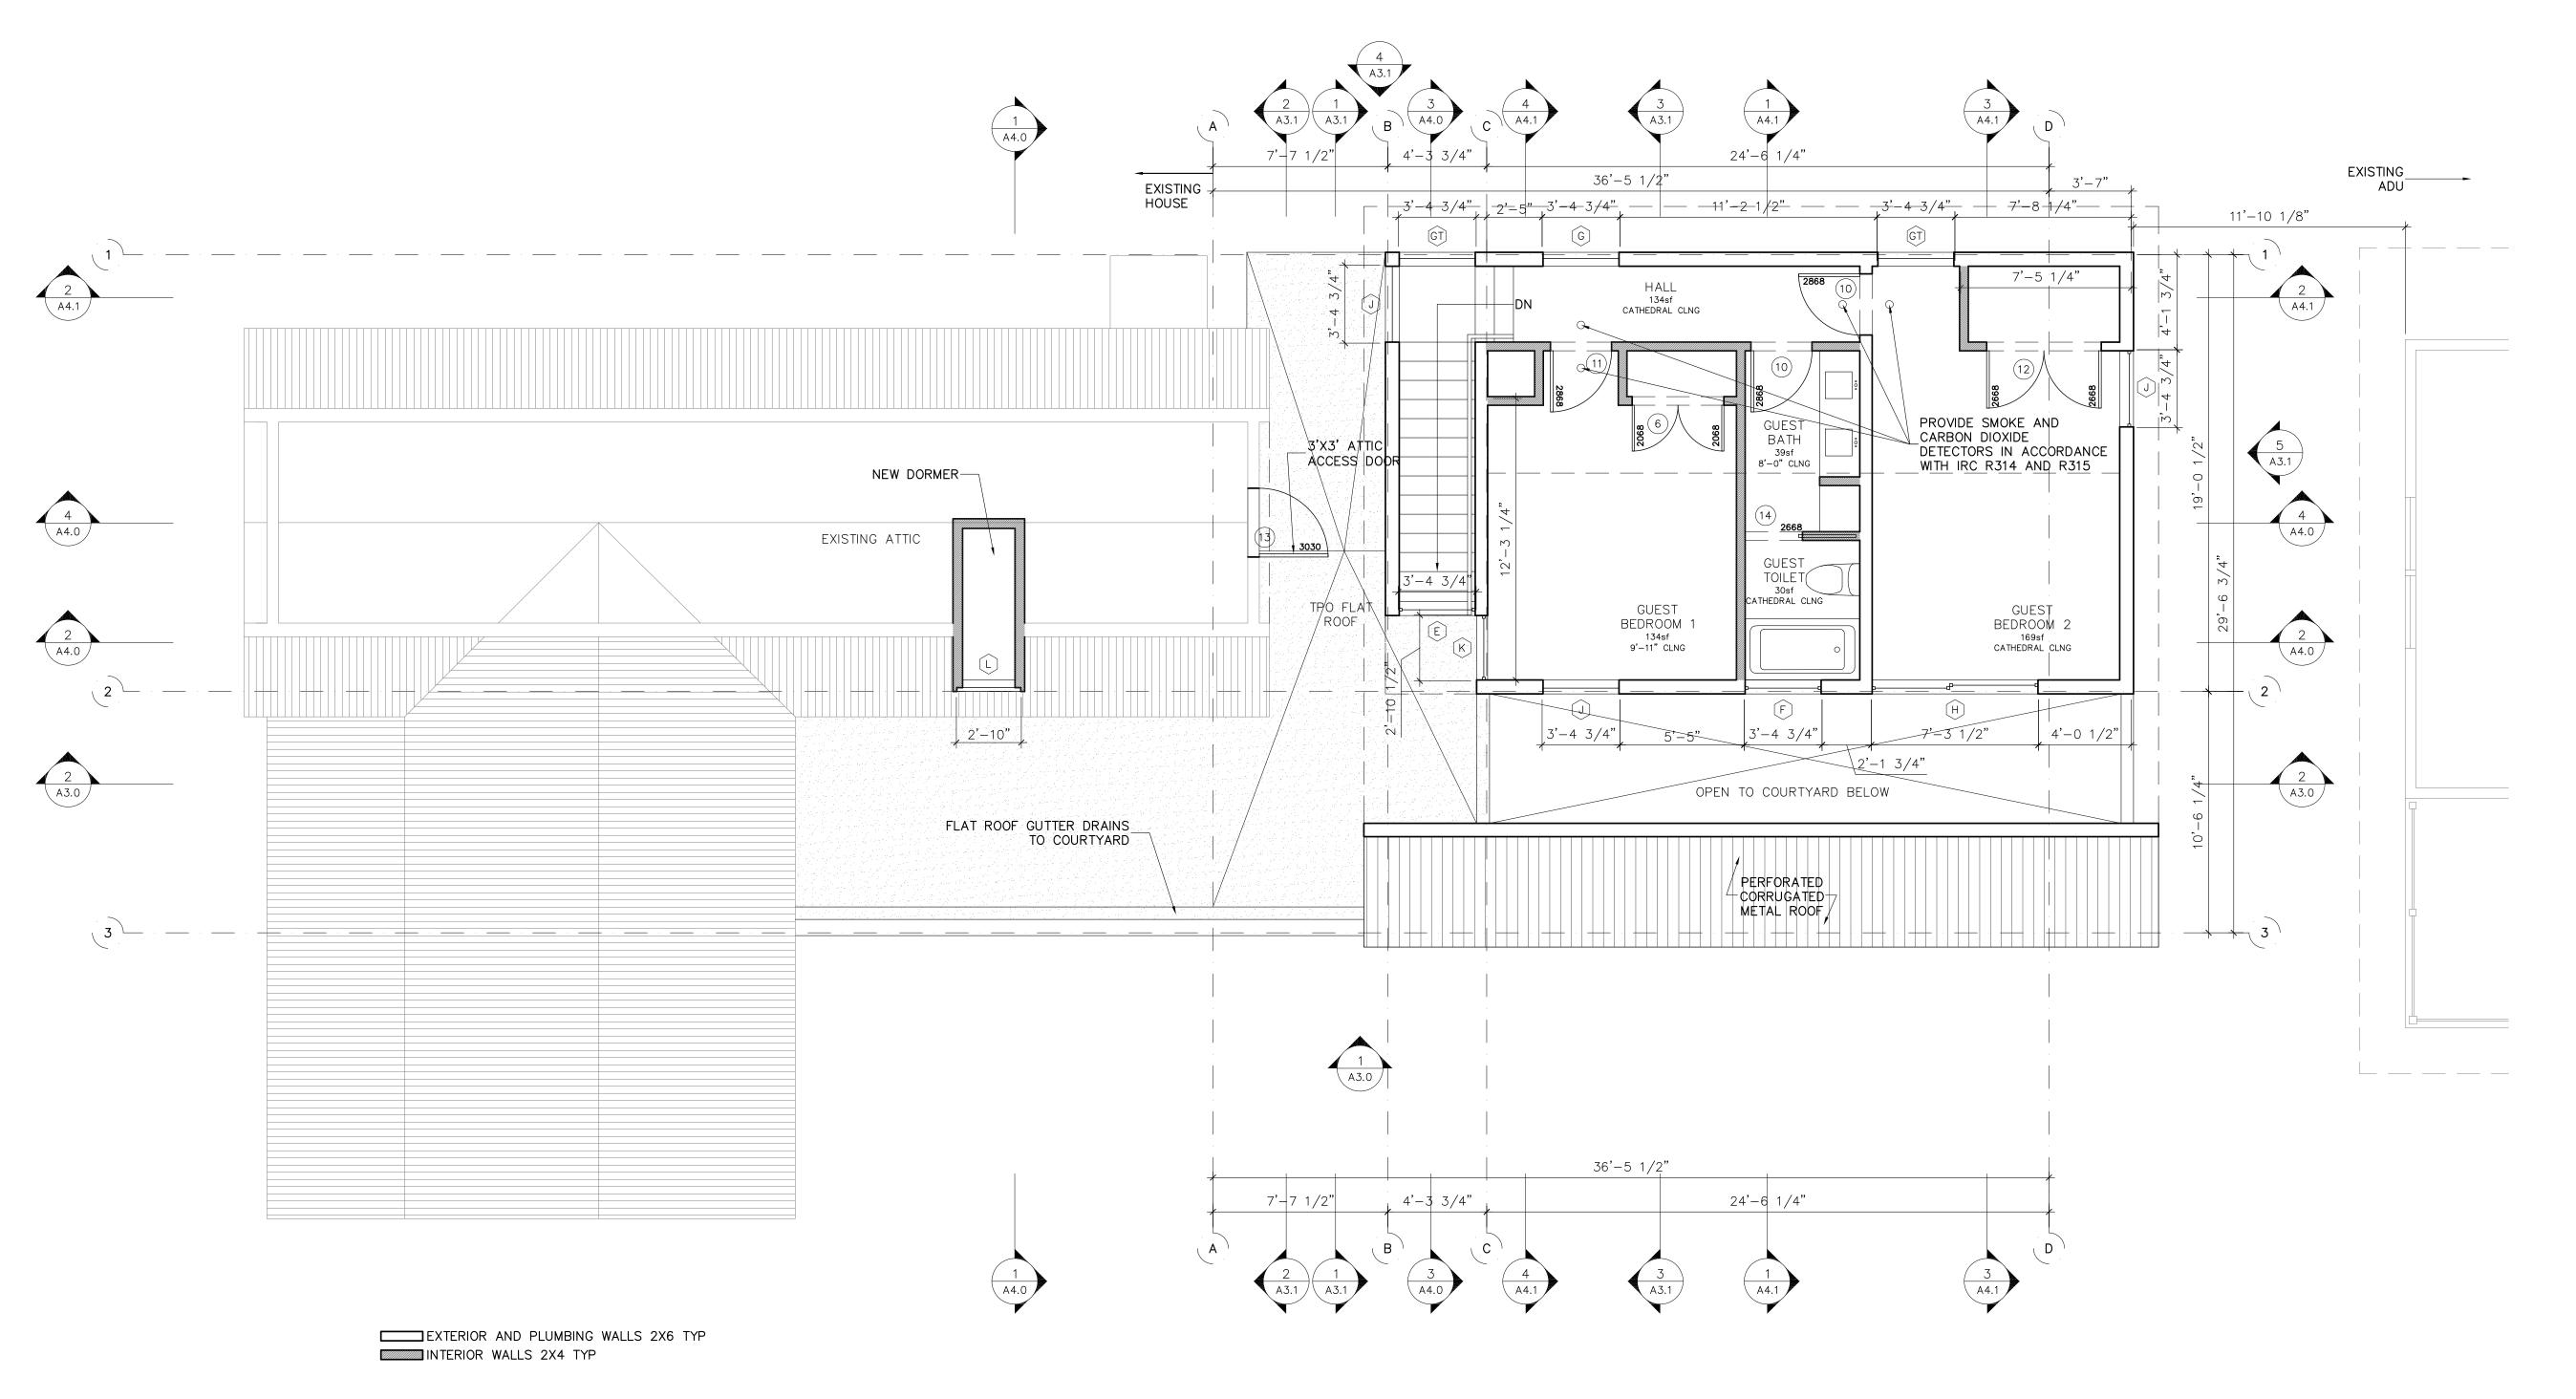



1 Second Floor Plan

1/4" = 1'-0 printed on 22x34 1/8" = 1'-0 printed on 11x17

GENERAL NOTES

- 1. ALL DIMENSIONS NOTED REFER TO STUD FRAMING, NOT FINISH MATERIALS
- 2. PROVIDE CLOTHES DRYER EXHAUST SYSTEM AT LAUNDRY ENCLOSURE. PER IRC SECTION M1502
- 3. PROVIDE SMOKE DETECTOR SYSTEM HARD WIRED, INTERCONNECTED, BATTERY BACKUP, AT EACH SLEEPING ROOM AND VICINITY. IN ACCORDANCE WITH 2012 IRC SEC R314
- 4. INSTALL 2X6 BLOCKING 2'-10" AFF IN ALL BATHROOM WALLS

- 5. GENERAL CONTRACTOR SHALL VERIFY FOR SMOKE DETECTORS TO BE LOCATED AT LEAST 36" AWAY
- FROM HORIZONTAL PATH OF MECHANICAL AIR FLOW. PER 2007 NFPA 72 CHAPTER 11.
- APPROVED CARBON MONOXIDE ALARM SHALL BE INSTALLED OUTSIDE OF EACH SEPARATE SLEEPING AREA IN THE IMMEDIATE VICINITY OF THE BEDROOMS IN DWELLING UNITS WITHIN WHICH FUEL—FIRED APPLIANCES ARE INSTALLED AND IN DWELLING UNITS THAT HAVE ATTACHED GARAGES. IN ACCORDANCE WITH 2012 IRC SEC R315.1

Owner

Ryan O'Connor and Sheer Nisman

2012 E 16th Street Austin, Texas 78702 Mobile +1 713 703 3141

signer

Low Design Office 2601A S 2nd St Austin, TX 78704

Telephone +1 832 729 7962 www.lowdo.net

Fort Structures

2235 East 6th Street #105 Austin, TX 78702 Telephone +1 512 817 9264 sam@fortstructures.com

12/28/21 COA Permit Set



Copyright 20

Any reproduction or translation of all or any part of this work without the written consent of Low Design Office, LLC is unlawful. For any information please contact Low Design Office, LLC

O'CONNOR/NISMAN RESIDENCE ADDITION

2012 E 16th Street Austin, Texas 78702

Job Num

201202


Plans

1/4" = 1'-0"

Drawing Date Plot Date 12/28/21 12/28/21

Drawing Number

A1.1

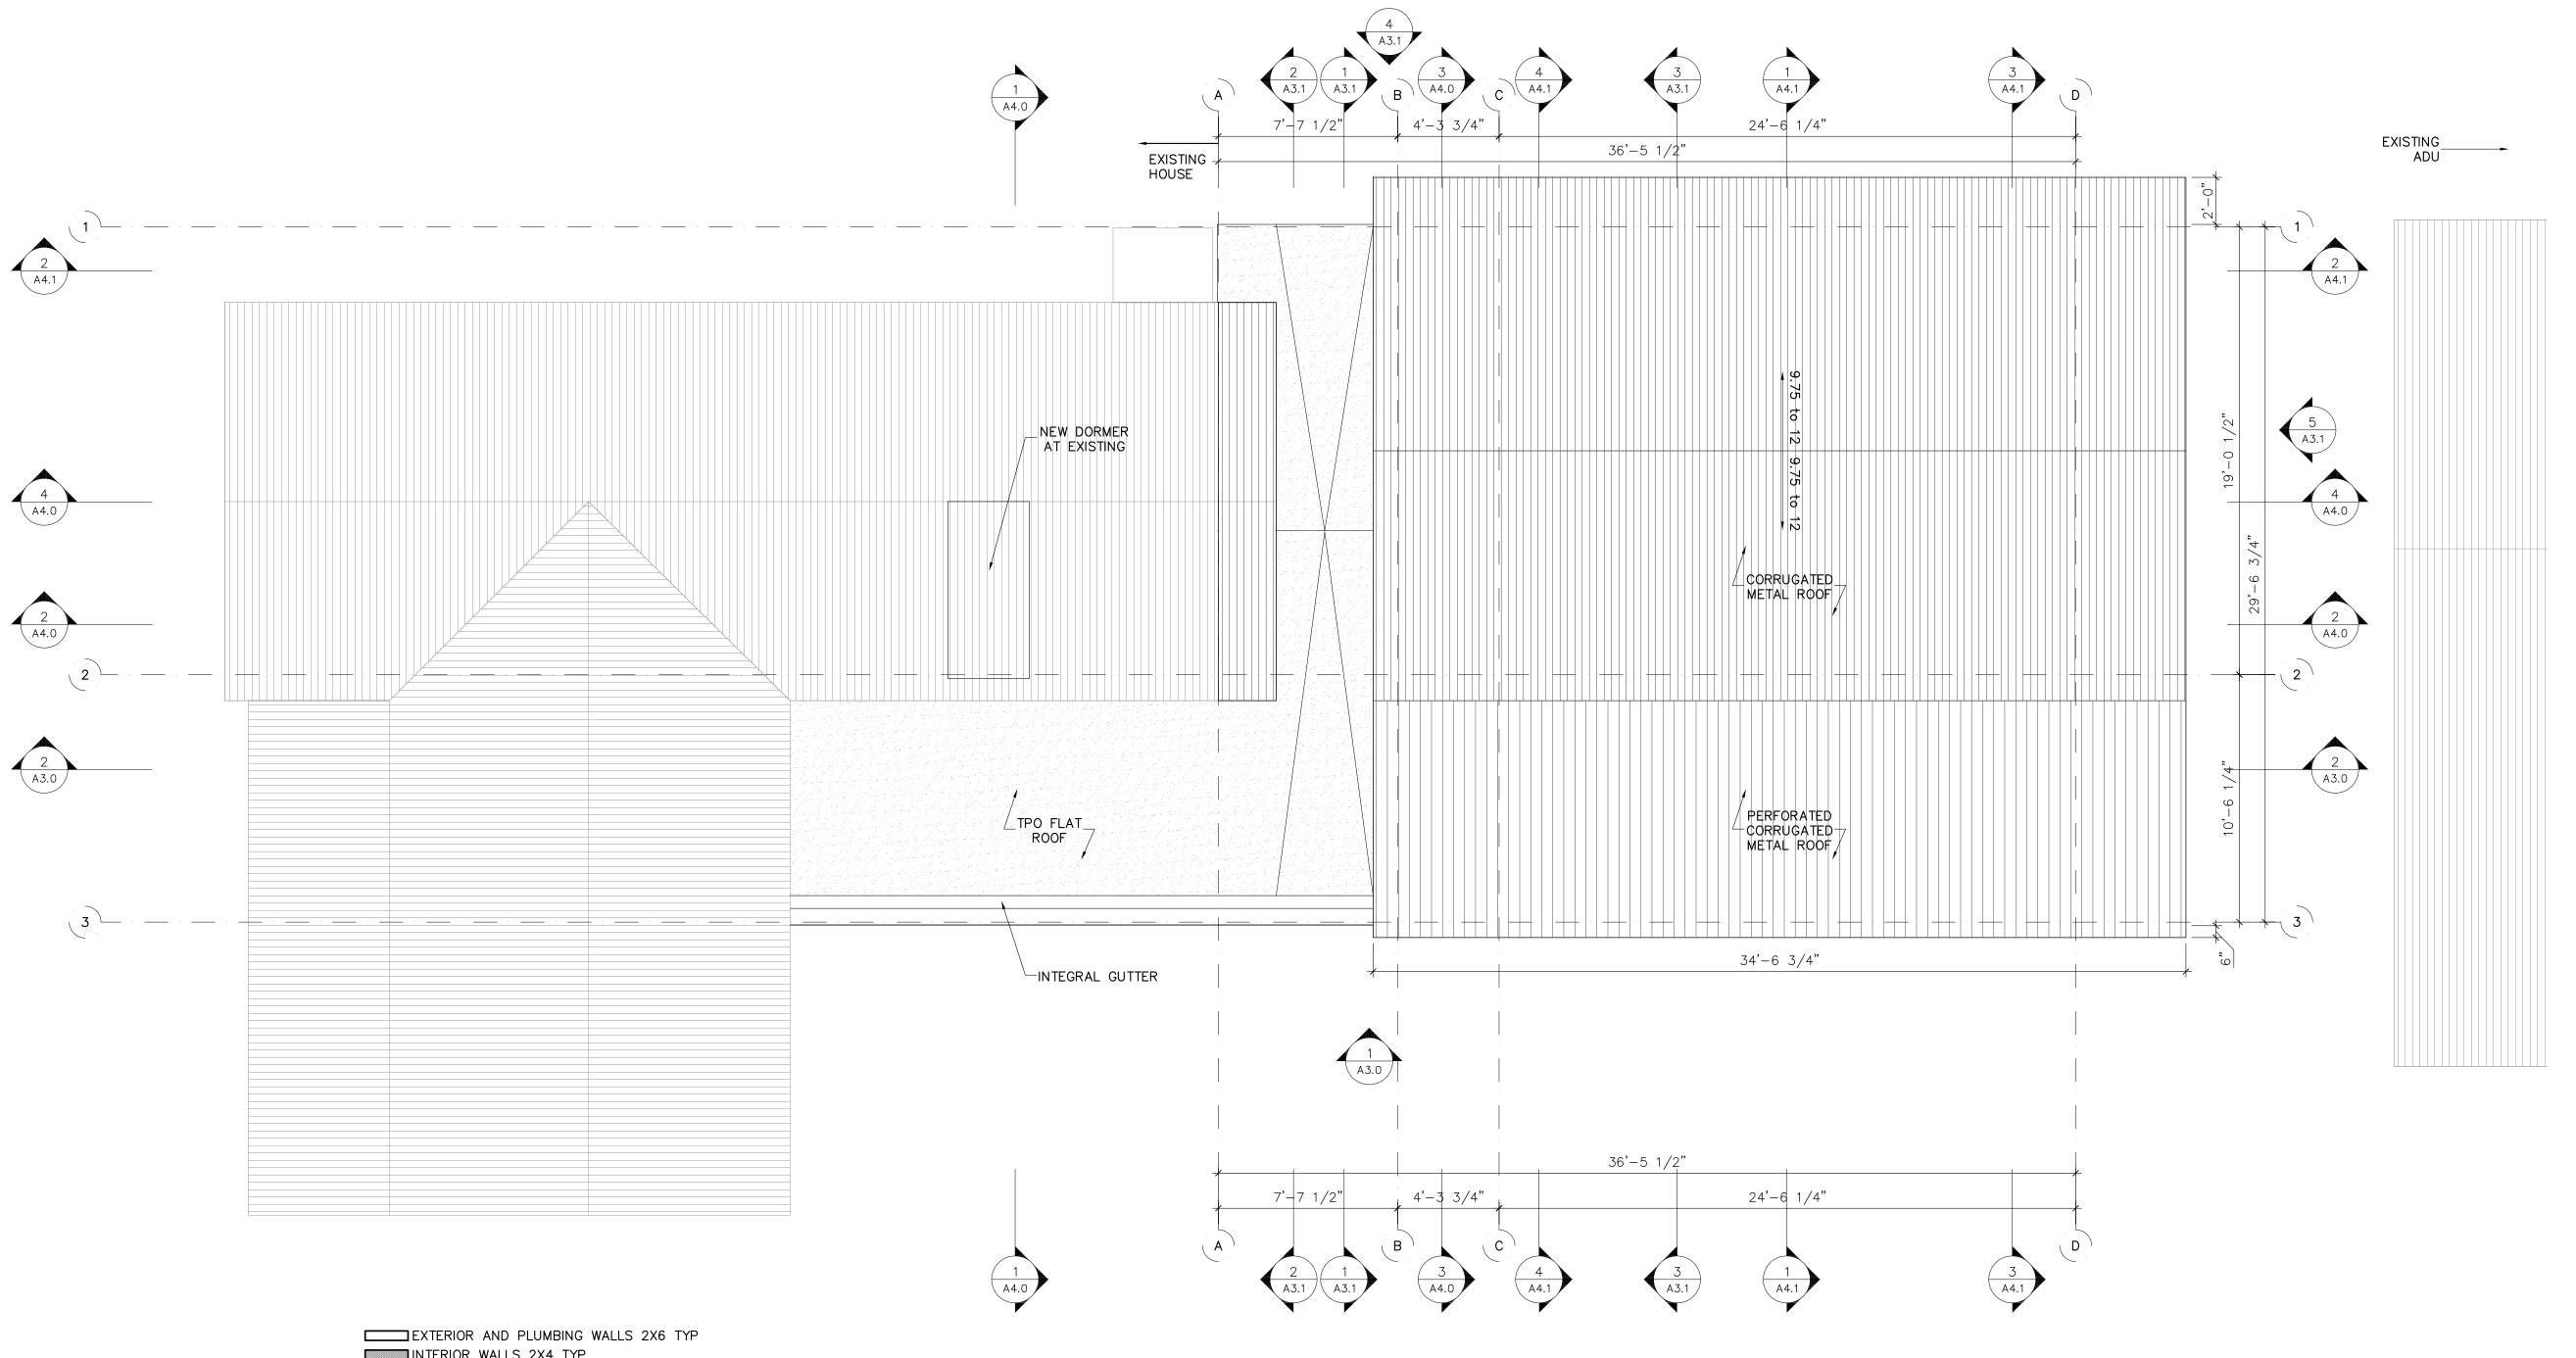

INTERIOR WALLS 2X4 TYP



1 Roof Plan

1/4" = 1'-0 printed on 22x34 1/8" = 1'-0 printed on 11x17

GENERAL NOTES

- 1. ALL DIMENSIONS NOTED REFER TO STUD FRAMING, NOT FINISH MATERIALS
- 2. PROVIDE CLOTHES DRYER EXHAUST SYSTEM AT LAUNDRY ENCLOSURE. PER IRC SECTION M1502
- 3. PROVIDE SMOKE DETECTOR SYSTEM HARD WIRED, INTERCONNECTED, BATTERY BACKUP, AT EACH SLEEPING ROOM AND VICINITY. IN ACCORDANCE WITH 2012 IRC SEC R314
- 4. INSTALL 2X6 BLOCKING 2'-10" AFF IN ALL BATHROOM WALLS

- 5. GENERAL CONTRACTOR SHALL VERIFY FOR SMOKE DETECTORS TO BE LOCATED AT LEAST 36" AWAY
- FROM HORIZONTAL PATH OF MECHANICAL AIR FLOW. PER 2007 NFPA 72 CHAPTER 11.
- APPROVED CARBON MONOXIDE ALARM SHALL BE INSTALLED OUTSIDE OF EACH SEPARATE SLEEPING AREA IN THE IMMEDIATE VICINITY OF THE BEDROOMS IN DWELLING UNITS WITHIN WHICH FUEL-FIRED APPLIANCES ARE INSTALLED AND IN DWELLING UNITS THAT HAVE ATTACHED GARAGES. IN ACCORDANCE WITH 2012 IRC SEC R315.1

Ryan O'Connor and Sheer Nisman

2012 E 16th Street Austin, Texas 78702 Mobile +1 713 703 3141

Low Design Office 2601A S 2nd St Austin, TX 78704

Telephone +1 832 729 7962 www.lowdo.net

Fort Structures

2235 East 6th Street #105 Austin, TX 78702 Telephone +1 512 817 9264 sam@fortstructures.com

12/28/21 COA Permit Set



Any reproduction or translation of all or any part of this work without the written consent of Low Design Office, LLC is unlawful. For any information please contact Low Design Office, LLC

O'CONNOR/NISMAN RESIDENCE ADDITION

2012 E 16th Street Austin, Texas 78702


201202

Plans

1/4" = 1'-0"

Drawing Date Plot Date 12/28/21 12/28/21



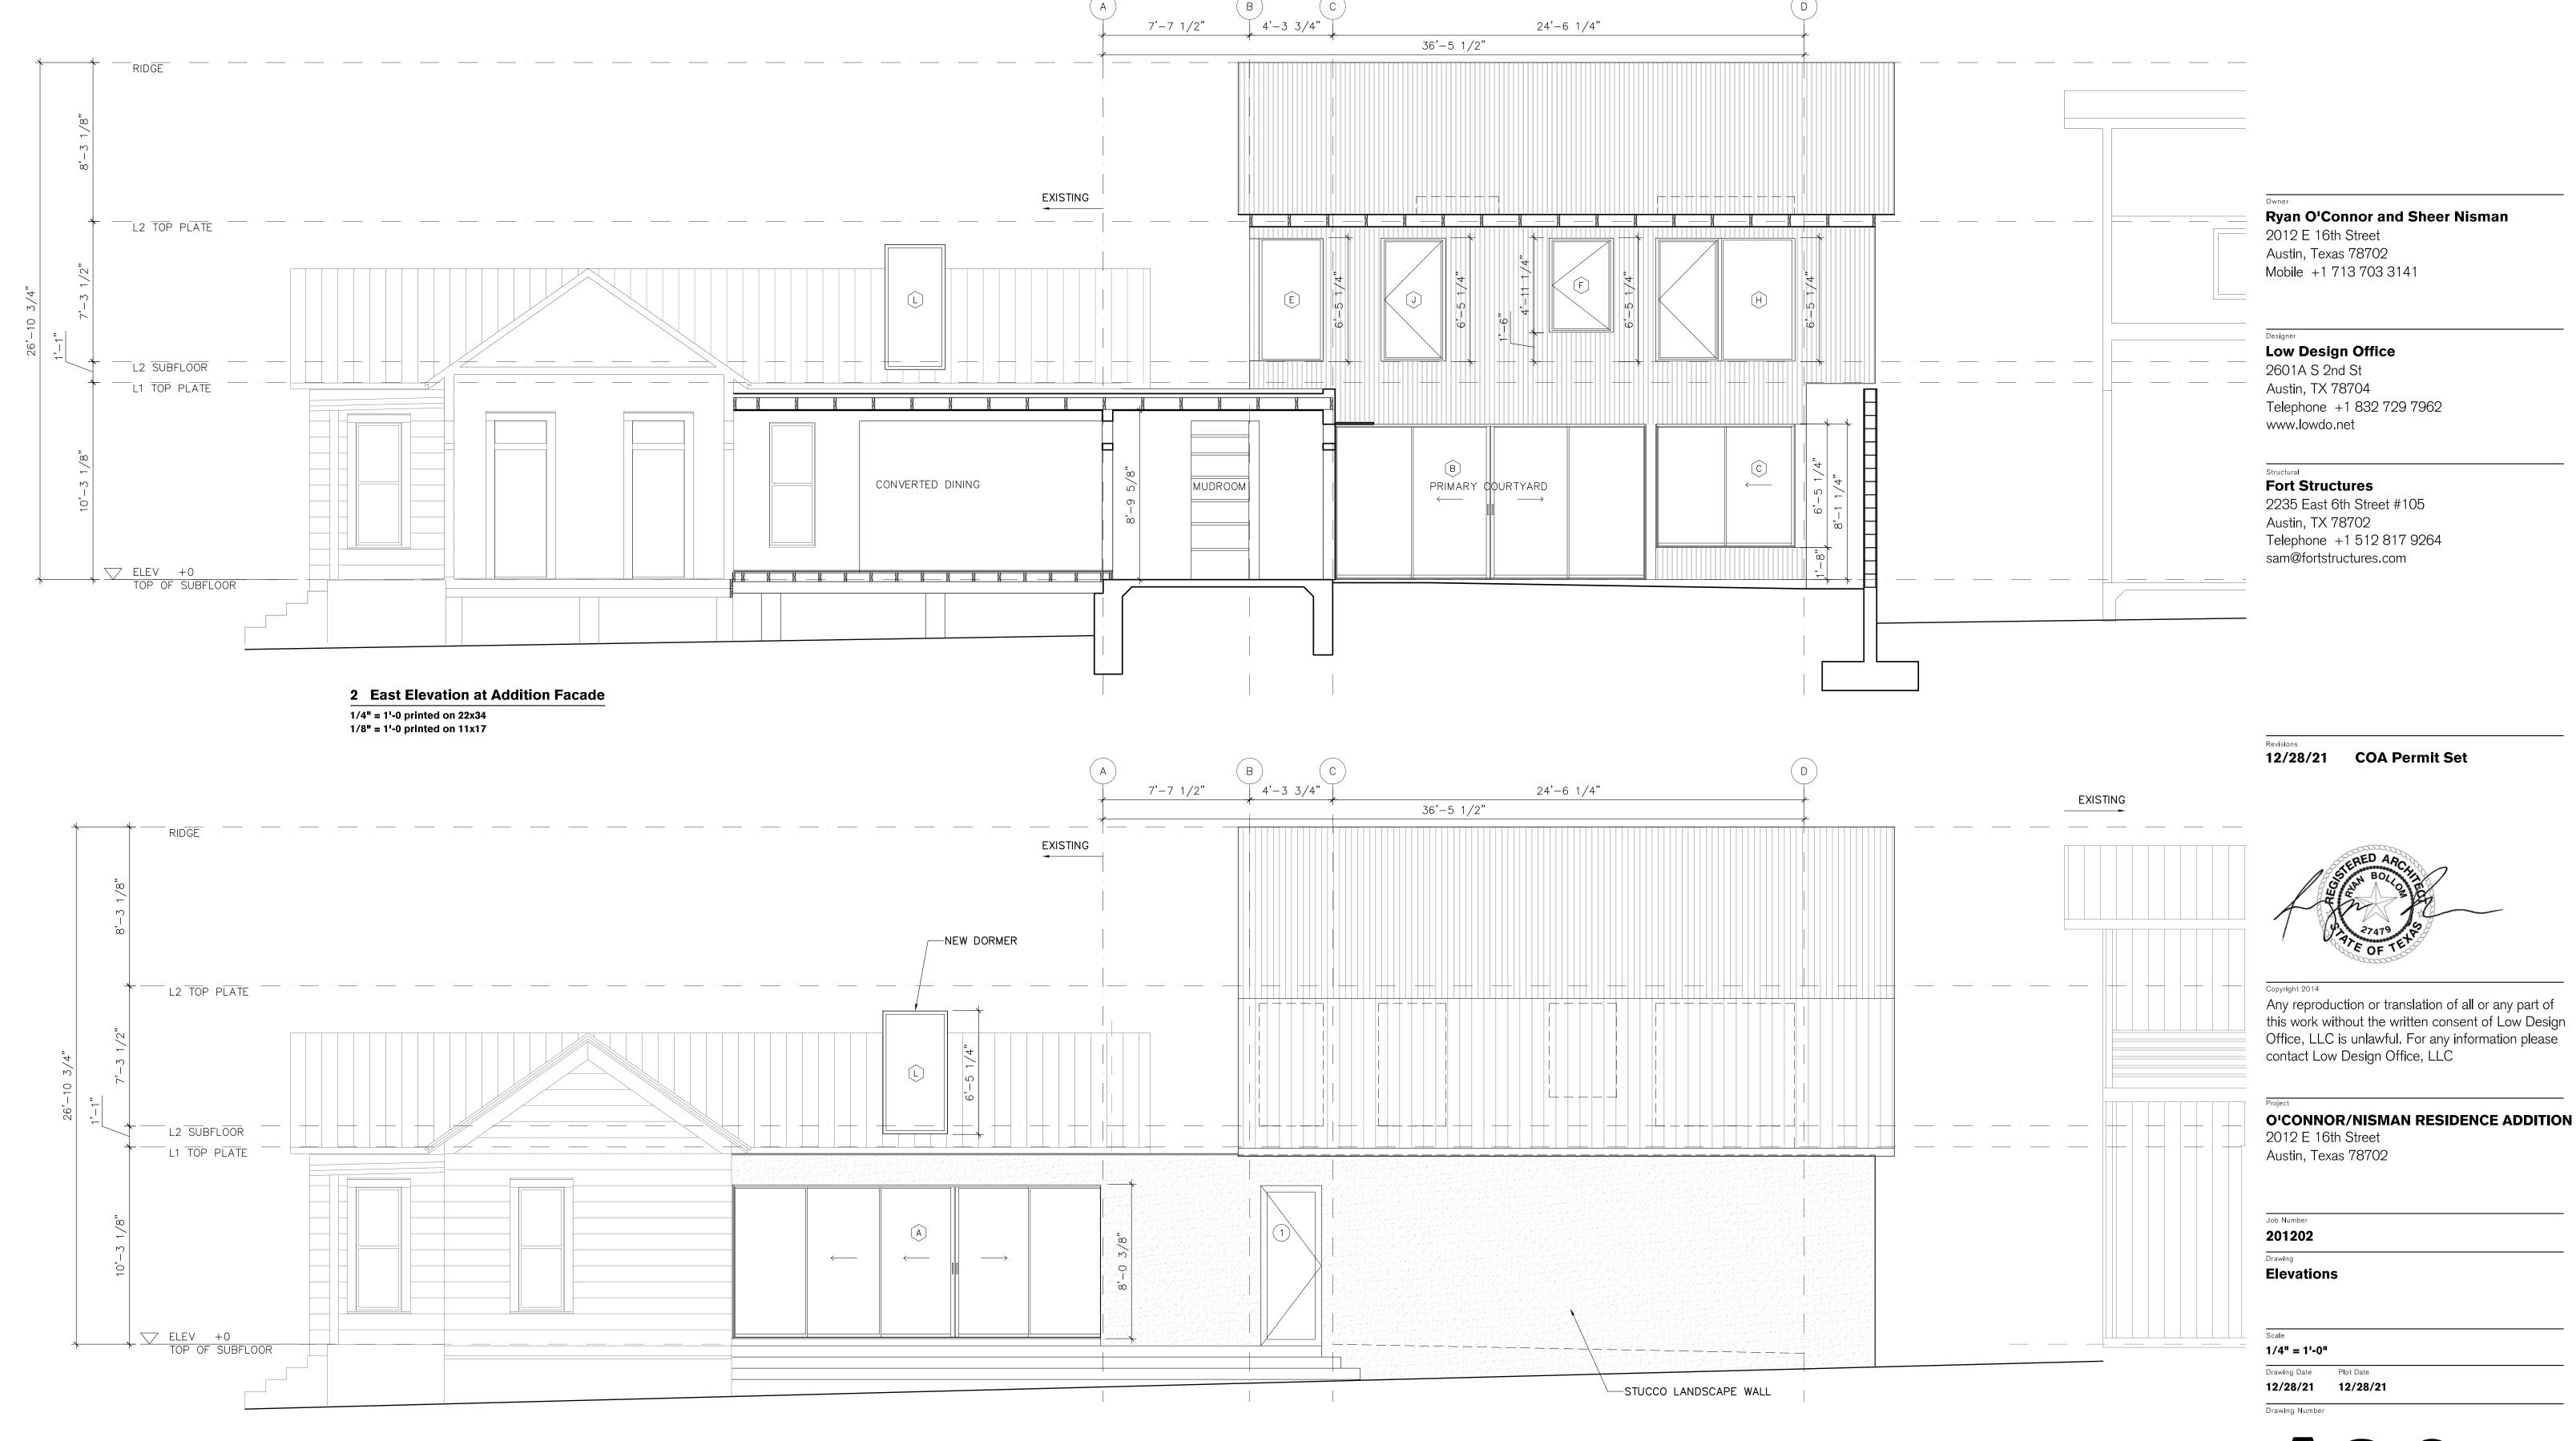


1 East Elevation @ Landscape Wall

1/4" = 1'-0 printed on 22x34

1/8" = 1'-0 printed on 11x17

A3.0

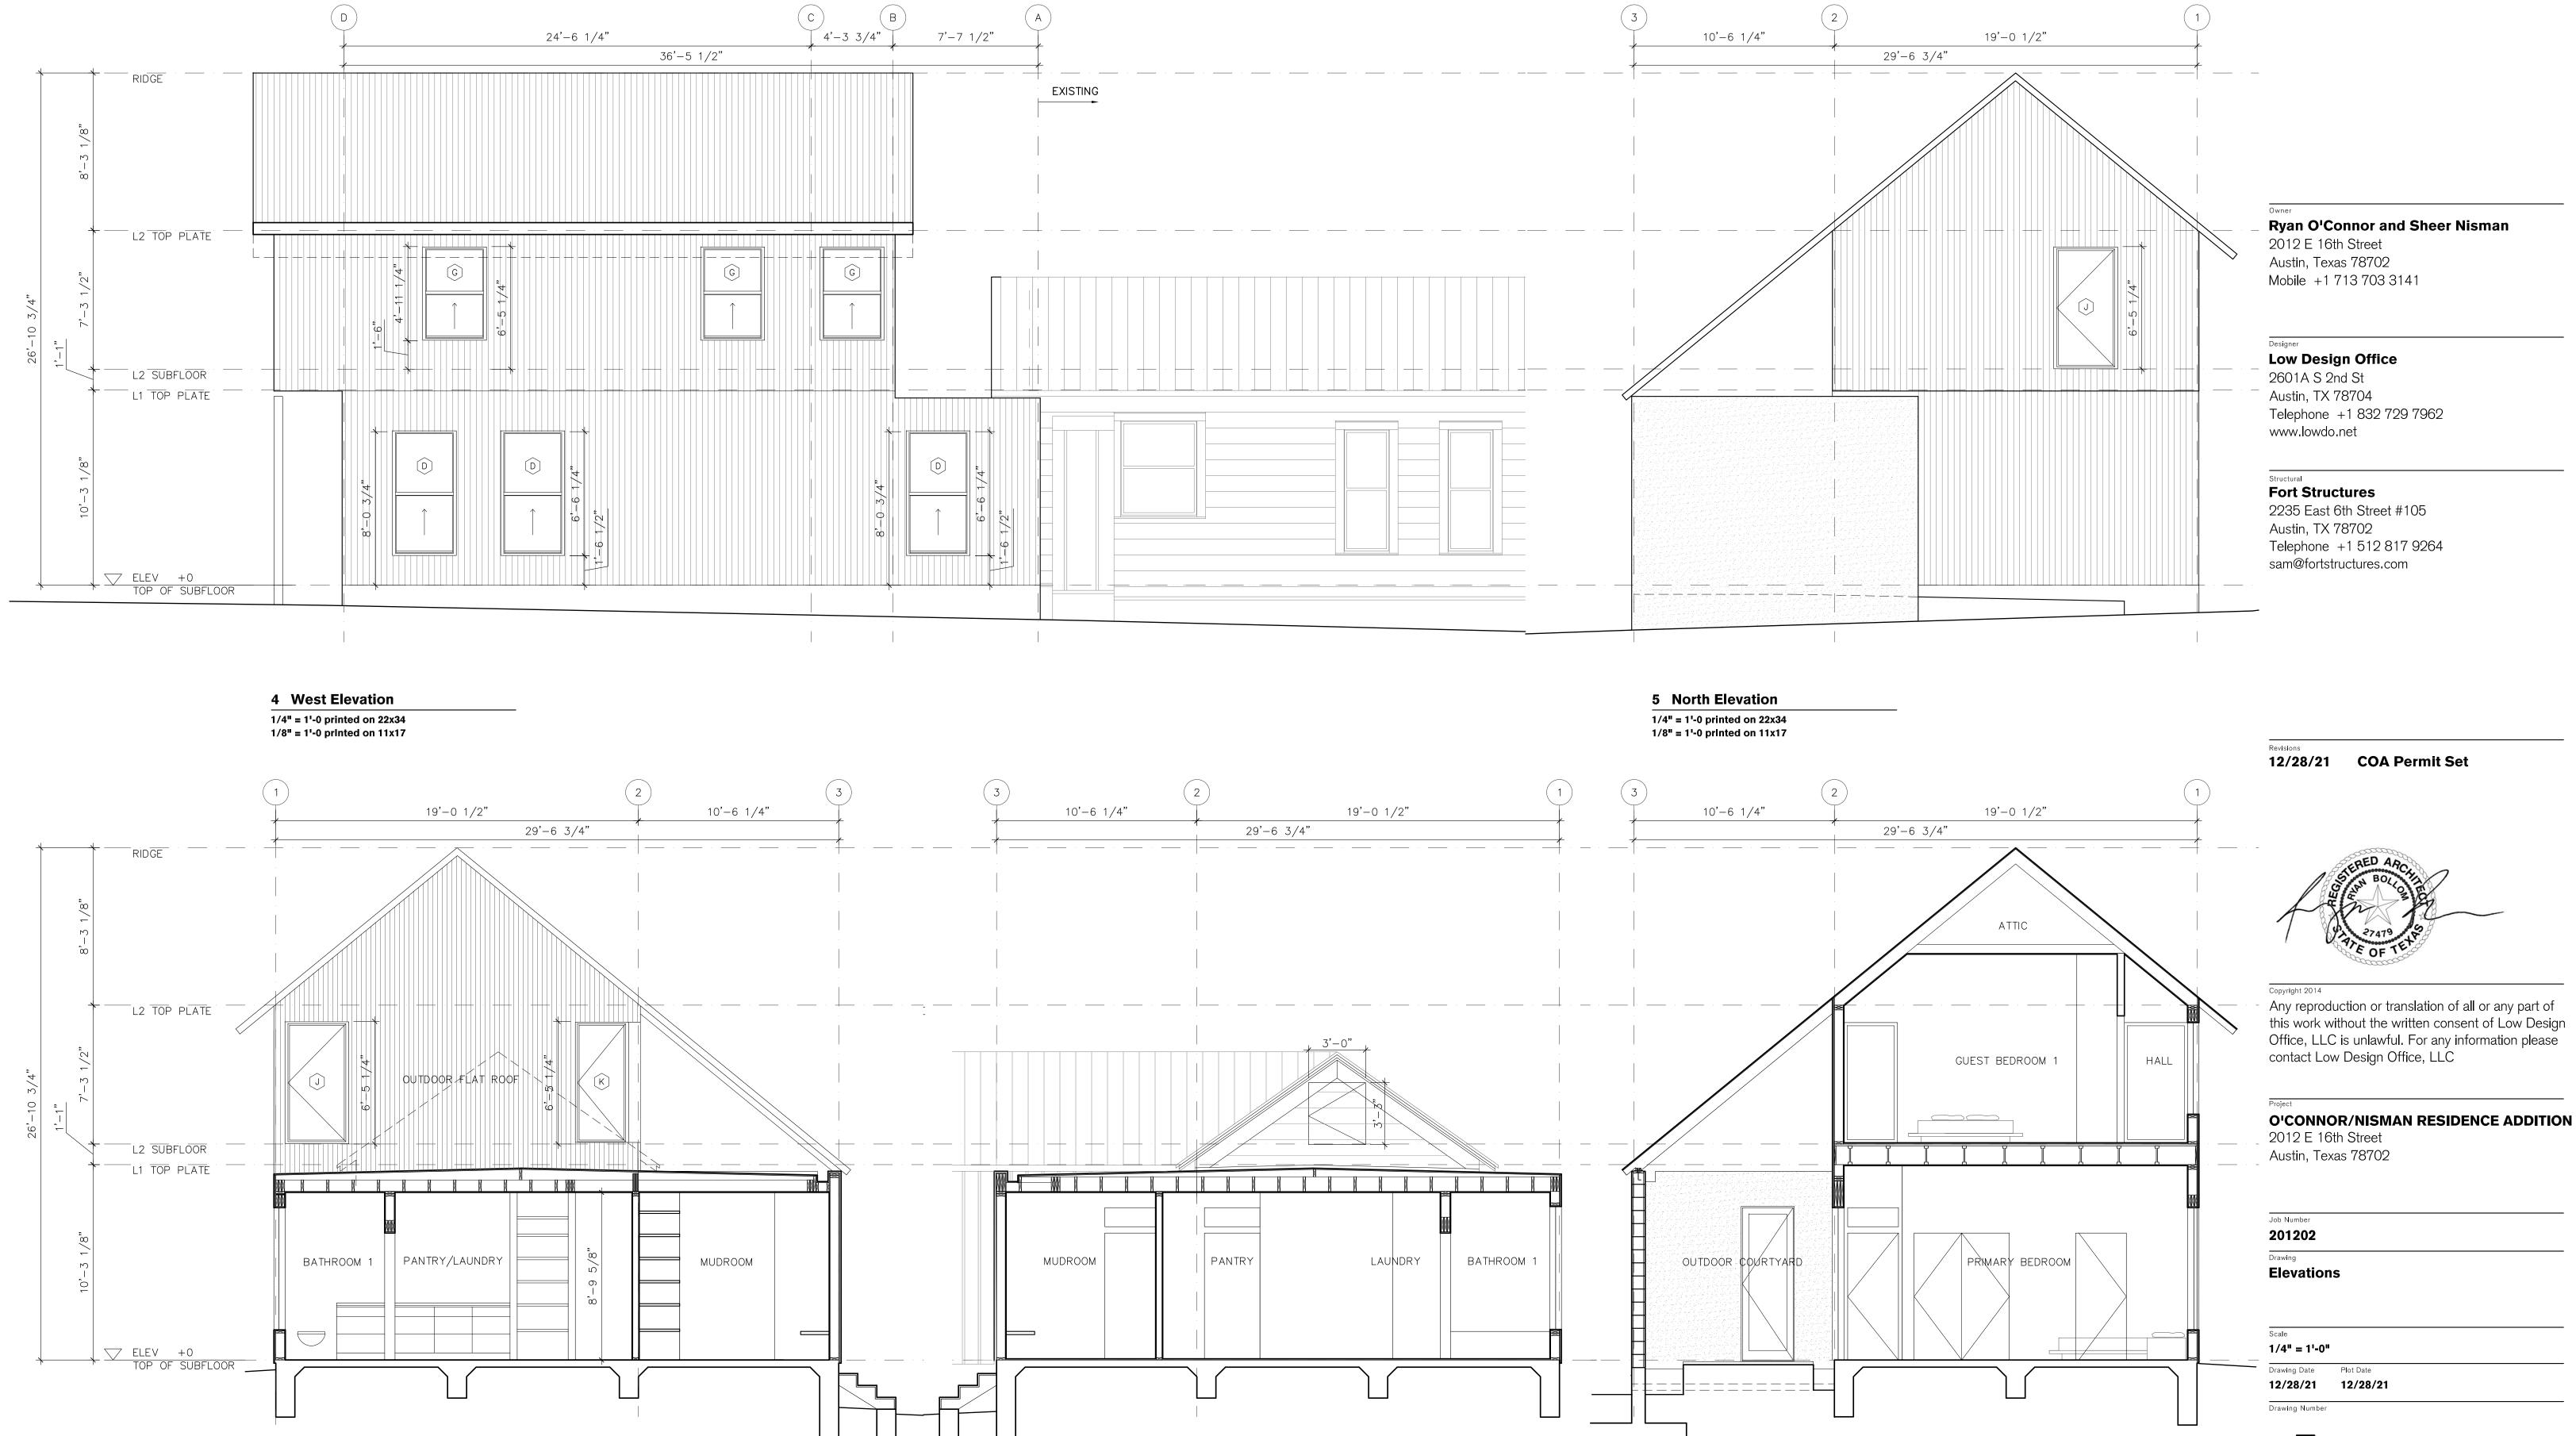

3 North Elevation @ Courtyard Wall

1/4" = 1'-0 printed on 22x34 1/8" = 1'-0 printed on 11x17


2 North Elevation @ Connection to Existing

1/4" = 1'-0 printed on 22x34 1/8" = 1'-0 printed on 11x17


1 South Elevation at Addition


1/4" = 1'-0 printed on 22x34

1/8" = 1'-0 printed on 11x17

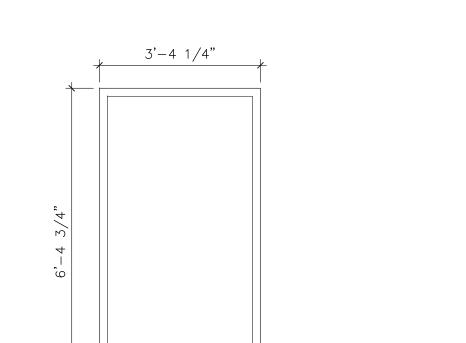



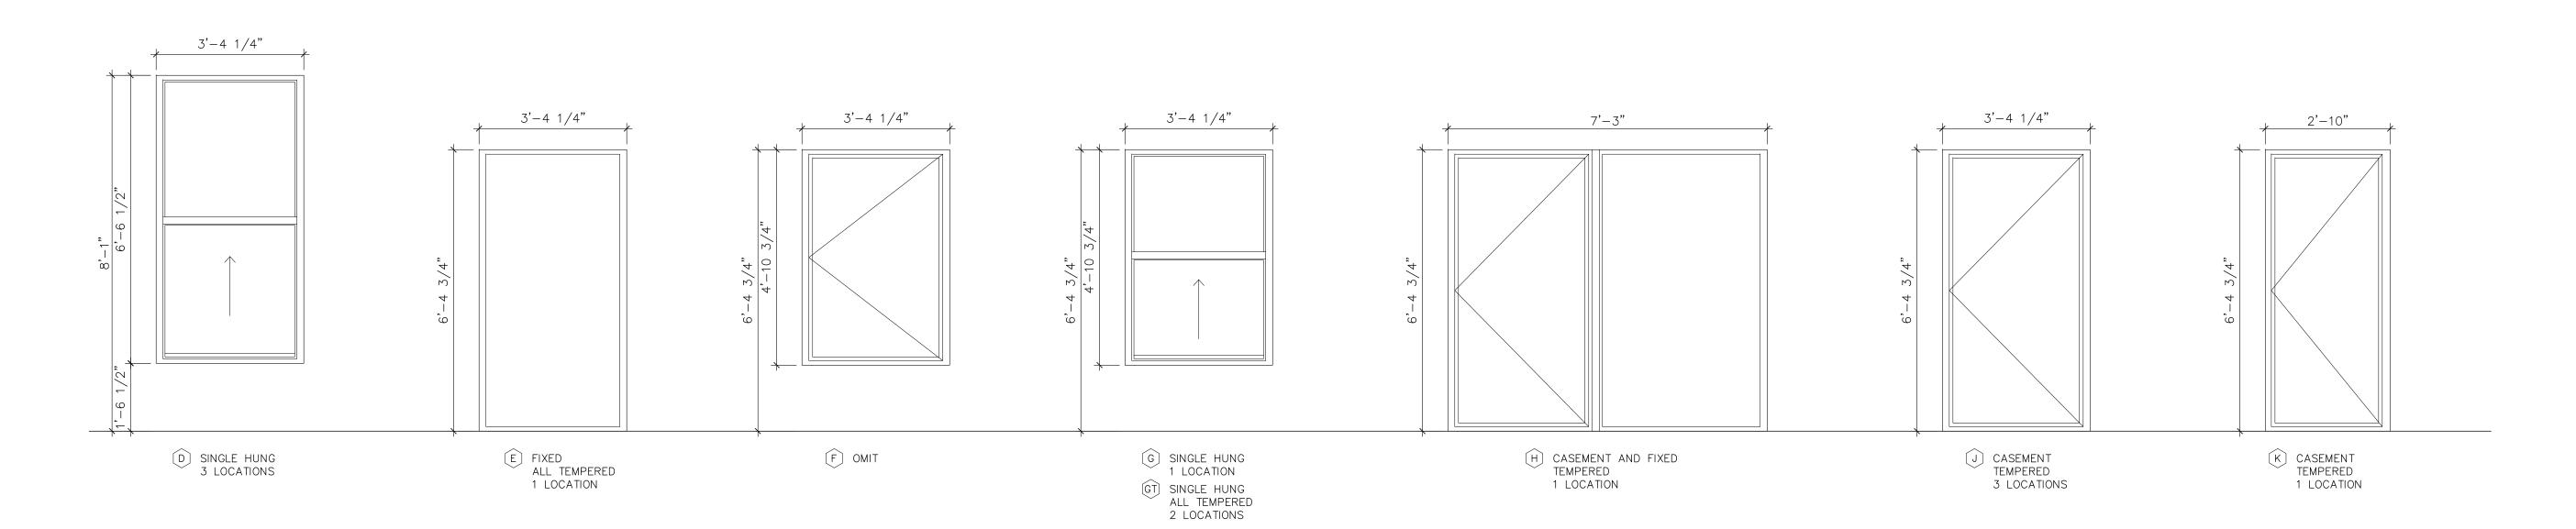

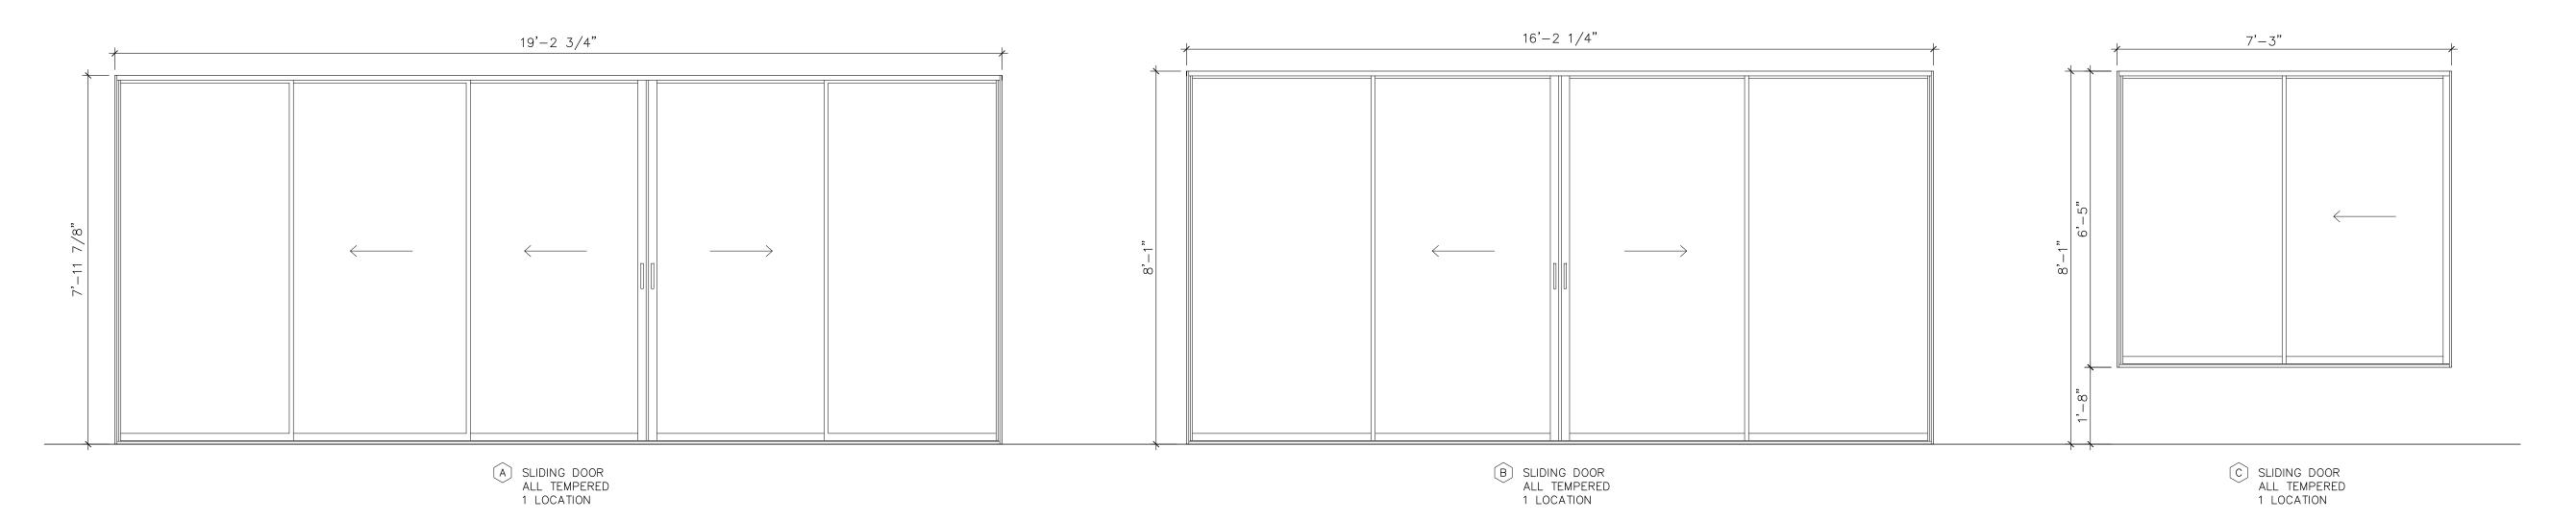

1 Window Schedule

1/2" = 1'-0 printed on 22x34 1/4" = 1'-0 printed on 11x17



Ryan O'Connor and Sheer Nisman

2012 E 16th Street Austin, Texas 78702 Mobile +1 713 703 3141

Low Design Office 2601A S 2nd St

Austin, TX 78704 Telephone +1 832 729 7962 www.lowdo.net

Fort Structures

2235 East 6th Street #105 Austin, TX 78702 Telephone +1 512 817 9264

sam@fortstructures.com

12/28/21 COA Permit Set



Any reproduction or translation of all or any part of this work without the written consent of Low Design Office, LLC is unlawful. For any information please contact Low Design Office, LLC

O'CONNOR/NISMAN RESIDENCE ADDITION 2012 E 16th Street

Austin, Texas 78702


201202

Window & Sliding Door Schedule

1/2" = 1'-0"

Drawing Date Plot Date

11/09/21 11/09/21

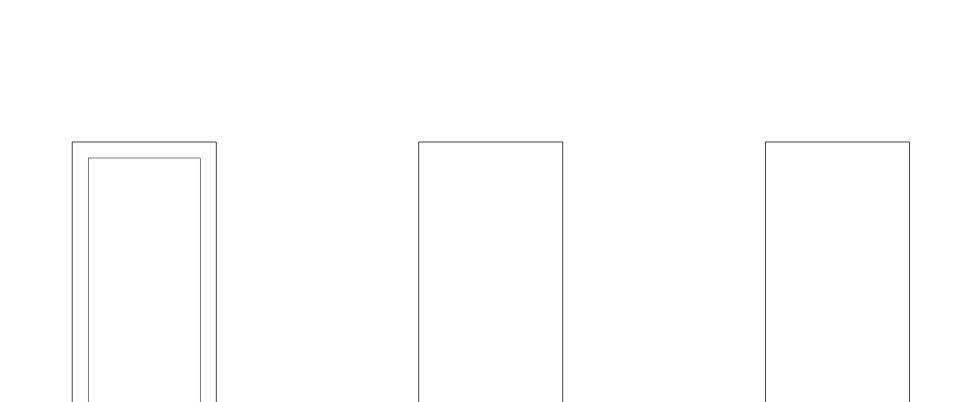

(A) ENTRY W/ FULL LITE

B HOLLOW CORE FLUSH PANEL

C SOLID CORE FLUSH PANEL

DOOR SCHEDULE

DOOR	DOOR !	SIZE			DOOR				Ff	RAME	JAMB	HDWR	REMARKS
#	WIDTH	HEIGHT	THICKNESS	TYPE	MAT'L	FINISH	GLAZ.	SWING	MAT'L	FINISH		TYPE	
1	3'-0"	8'-0"	1 3/8"	А	COMPOSITE	PAINT	TEMPERED LOW E W/ ARGON GAS	RIGHT - IN	WD	PAINT	6 9/16"	ENTRY	FIELD VERIFY R.O.
2	2'-8"	6'-8"	1 3/8"	А	COMPOSITE	PAINT	TEMPERED LOW E W/ ARGON GAS	RIGHT — OUT	WD	PAINT	6 9/16"	ENTRY	FIELD VERIFY R.O.
3	2'-8"	6'-8"	1 3/8"	В	MDF	PAINT	_	RIGHT - OUT	WD	PAINT	4 9/16"	PASSAGE	FIELD VERIFY R.O.
4	2'-8"	6'-8"	1 3/8"	С	MDF	PAINT	_	LEFT - IN	WD	PAINT	6 9/16"	PRIVACY	FIELD VERIFY R.O.
5	2'-8"	6'-8"	1 3/8"	С	MDF	PAINT	_	POCKET	WD	PAINT	6 9/16"	POCKET P	FIELD VERIFY R.O.
6	2'-0" DOUBLE	6'-8"	1 3/8"	В	MDF	PAINT	_	OUT	WD	PAINT	4 9/16"	DUMMY	FIELD VERIFY R.O.
7	2'-8"	6'-8"	1 3/8"	В	MDF	PAINT	_	LEFT - OUT	WD	PAINT	4 9/16"	PASSAGE	FIELD VERIFY R.O.
8	2'-8"	8'-0"	1 3/8"	С	MDF	PAINT	_	POCKET	WD	PAINT	6 9/16"	POCKET P	FIELD VERIFY R.O.
9	2'-8"	6'-8"	1 3/8"	С	MDF	PAINT	_	POCKET	WD	PAINT	4 9/16"	POCKET P	FIELD VERIFY R.O.
10	2'-8"	6'-8"	1 3/8"	С	MDF	PAINT	_	RIGHT — IN	WD	PAINT	4 9/16"	PRIVACY	FIELD VERIFY R.O.
11	2'-8"	6'-8"	1 3/8"	С	MDF	PAINT	_	LEFT - IN	WD	PAINT	4 9/16"	PRIVACY	FIELD VERIFY R.O.
12	2'-6" DOUBLE	6'-8"	1 3/8"	В	MDF	PAINT	_	OUT	WD	PAINT	4 9/16"	DUMMY	FIELD VERIFY R.O.
13	3'-0"	3'-0"	1 3/8"	С	COMPOSITE	PAINT	_	RIGHT - OUT	WD	PAINT	4 9/16"	ENTRY	FIELD VERIFY R.O.
14	2'-6"	6'-8"	1 3/8"	С	MDF	PAINT	_	POCKET	WD	PAINT	4 9/16"	POCKET P	FIELD VERIFY R.O.
15	3'-0"	8'-0"	1 3/8"	А	COMPOSITE	PAINT	TEMPERED LOW E W/ ARGON GAS	RIGHT — OUT	WD	PAINT	6 9/16"	ENTRY	FIELD VERIFY R.O.

HARDWARE

HARDWARE HANDLE		LOC	KSET		MISCELLANEOUS	
GROUP	TYPE	FINISH		DEADBOLT	KEYED	
ENTRY	LEVER	BRUSHED NICKEL	ENTRY FUNCTION	KEYLOCK ON ONE SIDE, THUMBTURN LATCH OPP	KEYED ALIKE	SILL AND WEATHERSTRIPPING
PASSAGE	LEVER	BRUSHED NICKEL	NONE	_	_	-
PRIVACY	LEVER	BRUSHED NICKEL	PRIVACY FUNCTION	_	_	-
POCKET P	FLUSH	BRUSHED NICKEL	PRIVACY FUNCTION	_	_	-
BIFOLD	GRAB	BRUSHED NICKEL	NONE	_	_	BIFOLD HARDWARE
BYPASS	FLUSH	BRUSHED NICKEL	NONE	_	_	TOP HUNG BYPASS HARDWARE
DUMMY	LEVER	BRUSHED NICKEL	NONE	_	_	LEVER ONE SIDE ONLY WITH BALLCATCH

1 Door Schedule

1/2" = 1'-0 printed on 22x34 1/4" = 1'-0 printed on 11x17

LOVDO

Ryan O'Connor and Sheer Nisman

2012 E 16th Street Austin, Texas 78702 Mobile +1 713 703 3141

Low Design Office 2601A S 2nd St Austin, TX 78704 Telephone +1 832 729 7962 www.lowdo.net

Fort Structures

2235 East 6th Street #105 Austin, TX 78702 Telephone +1 512 817 9264 sam@fortstructures.com

12/28/21 COA Permit Set



Any reproduction or translation of all or any part of this work without the written consent of Low Design Office, LLC is unlawful. For any information please contact Low Design Office, LLC

O'CONNOR/NISMAN RESIDENCE ADDITION 2012 E 16th Street

Austin, Texas 78702

201202

Door Schedule

1/2" = 1'-0" Drawing Date Plot Date

12/28/21 12/28/21