

SITE PLAN NOTES

1. REFER TO SHEET AS1.2 FOR TREE PROTECTION INFORMATION.

2. REFER TO SURVEY ON SHEET AS1.0 FOR ADDITIONAL SITE INFORMATION.

3. PER IRC, SLOPE HARDSCAPE AWAY FROM STRUCTURES AT 1/4" PER 12" MIN FOR 10"

4. GRADE TO SLOPE 6" MIN AWAR FROM SLAB WITHIN 10"MIN.

5. SITE INFORMATION TAKEN FROM SURVEY PERFORMED BY ALL STAR LAND SURVEYORS ON 08/25/2020. REFER TO SHEET AS1.0.

6. BUILDING ELEVATION 100'-0" IS EQUIVALENT TO TOPOGRAPHY ELEVATION 558'-0".

7. ALL STRUCTURES MUST MAINTAIN 7'-6" CLEARANCE FROM AUSTIN ENERGY ENERGIZED DISTRIBUTION POWER LINES. ENFORCED BY AE AND NESC CODES.

8. ALL DIMENSIONS SHOWN ARE TO FACE OF STUD, FACE OF MASONRY WALL, AND EDGE OF SLAB. TICK MARK INDICATED SELECTED FACE.

9. CONTRACTOR SHALL VERIFY DIMENSIONS OF EXISTING CONDITIONS AND PROPERTY BOUNDARIES FOR COMPLIANCE WITH REQUIRED SETBACKS PRIOR TO CONSTRUCTING FORMWORK FOR FOUNDATION. NOTIFY ARCHITECT OF ANY DISCREPANCIES PRIOR TO STARTING WORK.

10. CONTRACTOR SHALL VERIFY ALL EXISTING UNDERGROUND UTILITY LOCATIONS PRIOR TO STARTING WORK.

11. CONTRACTOR SHALL COORDINATE ALL UTILITIES TO RESIDENCE INCLUDING ELECTRIC POWER, WATER, WASTEWATER, GAS AND CABLE. COORDINATE ALL UNDERGROUND UTILITY PLACEMENT.

12. CONTRACTOR SHALL REGRADE LOT TO PROVIDE POSITIVE DRAINAGE SLOPE AWAY FROM HOUSE.

13. CONTRACTOR SHALL PROVIDE FRENCH DRAINS AROUND HOUSE PERIMETER AT REQUIRED LOCATIONS.

14. ALL DOWNSPOUT LOCATIONS SHALL BE COORDINATED WITH PLANTING AREAS.

15. TURFGRASS/LAWN IS APPROVED LOW-WATER VARIETY (I.E. BERMUDA, ZOYSIA JAPONICA, BUFFALO)

16. COORDINATE PLANTING BEDS WITH OWNER AND ARCHITECT.

SQUARE FOOTAGE CALCS.

LOT AREA A 1ST FLOOR CONDITIONED AREA 1,267 **B** 2ND FLOOR CONDITIONED AREA 1,431 C 3RD FLOOR CONDITIONED AREA **D** BASEMENT **E** ATTACHED COVERED PARKING 444 F DETACHED COVERED PARKING G COVERED WOOD DECK **H** COVERED PATIO I COVERED PORCH **J** BALCONY **K** OTHER **TOTAL BUILDING AREA (TBA)** 3,290 (ADD: A THROUGH K) **TOTAL BUILDING COVERAGE (TBC)** 1,825 (26.49%) (TBA - B, C, D, AND J IF APPLICABLÉ) L DRIVEWAY M SIDEWALKS AND PAVERS M.1 FRONT M.2 SIDE N UNCOVERED PATIO O UNCOVERED WOOD DECKS 319 (50% OF 638 SF) P PADS AND OTHER FLATWORK **Q** OTHER (POOL COPING)

VISITABILITY

TOTAL IMPERVIOUS COVER

(SECTION R320 OF CITY CODE SECTION 25-12-243)

EXTERIOR ROUTE

POINT OF ORIGIN VISITABLE ENTRANCE VISITABLE ROUTE

LOCATION **ELEVATION** EDGE OF DRIVEWAY 577'-6" INTERIOR GARAGE DOOR 577'-10" GARAGE TO BATH 1 56'-9" LENGTH

101 18" PECAN TREE

100 8.5" HACKBERRY TREE

0.5% SLOPE

NON-PROTECTED TREES (PER COA CODE)

1/16" / 12" (<1/12)

2,932 (42.56%)

NOTE: REFER TO SHEET G1.0 FOR ADDITIONAL VISITIBILITY ANALYSIS


TREE LIST

PROTECTED TREES (PER COA CODE)

142 20.5" PECAN TREE

NOTE: REFER TO SHEET AS1.2 FOR TREE LIST AND PROTECTION ANALYSIS

LEGEND AND SCALE

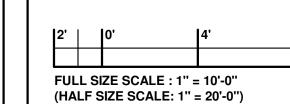






RIVENDALE HOMES TEXAS, LLC

1114 LOST CREEK BLVD. SUITE 200 AUSTIN, TX 78746 T 512-900-8797 WWW.RIVENDALEHOMESTEXAS.COM

© RIVENDALE HOMES TEXAS, LLC

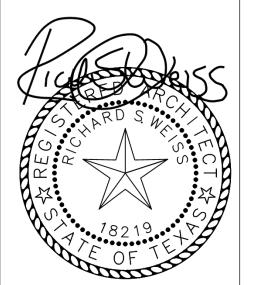

Ш

REVISIONS


STAMP:

CURRENT ISSUE: SET DATE 03.04.22 CHECK SET PROJECT NO: ----

SCALE 1/8" = 1'-0" DRAWING TITLE

SITE PLAN

SHEET NUMBER

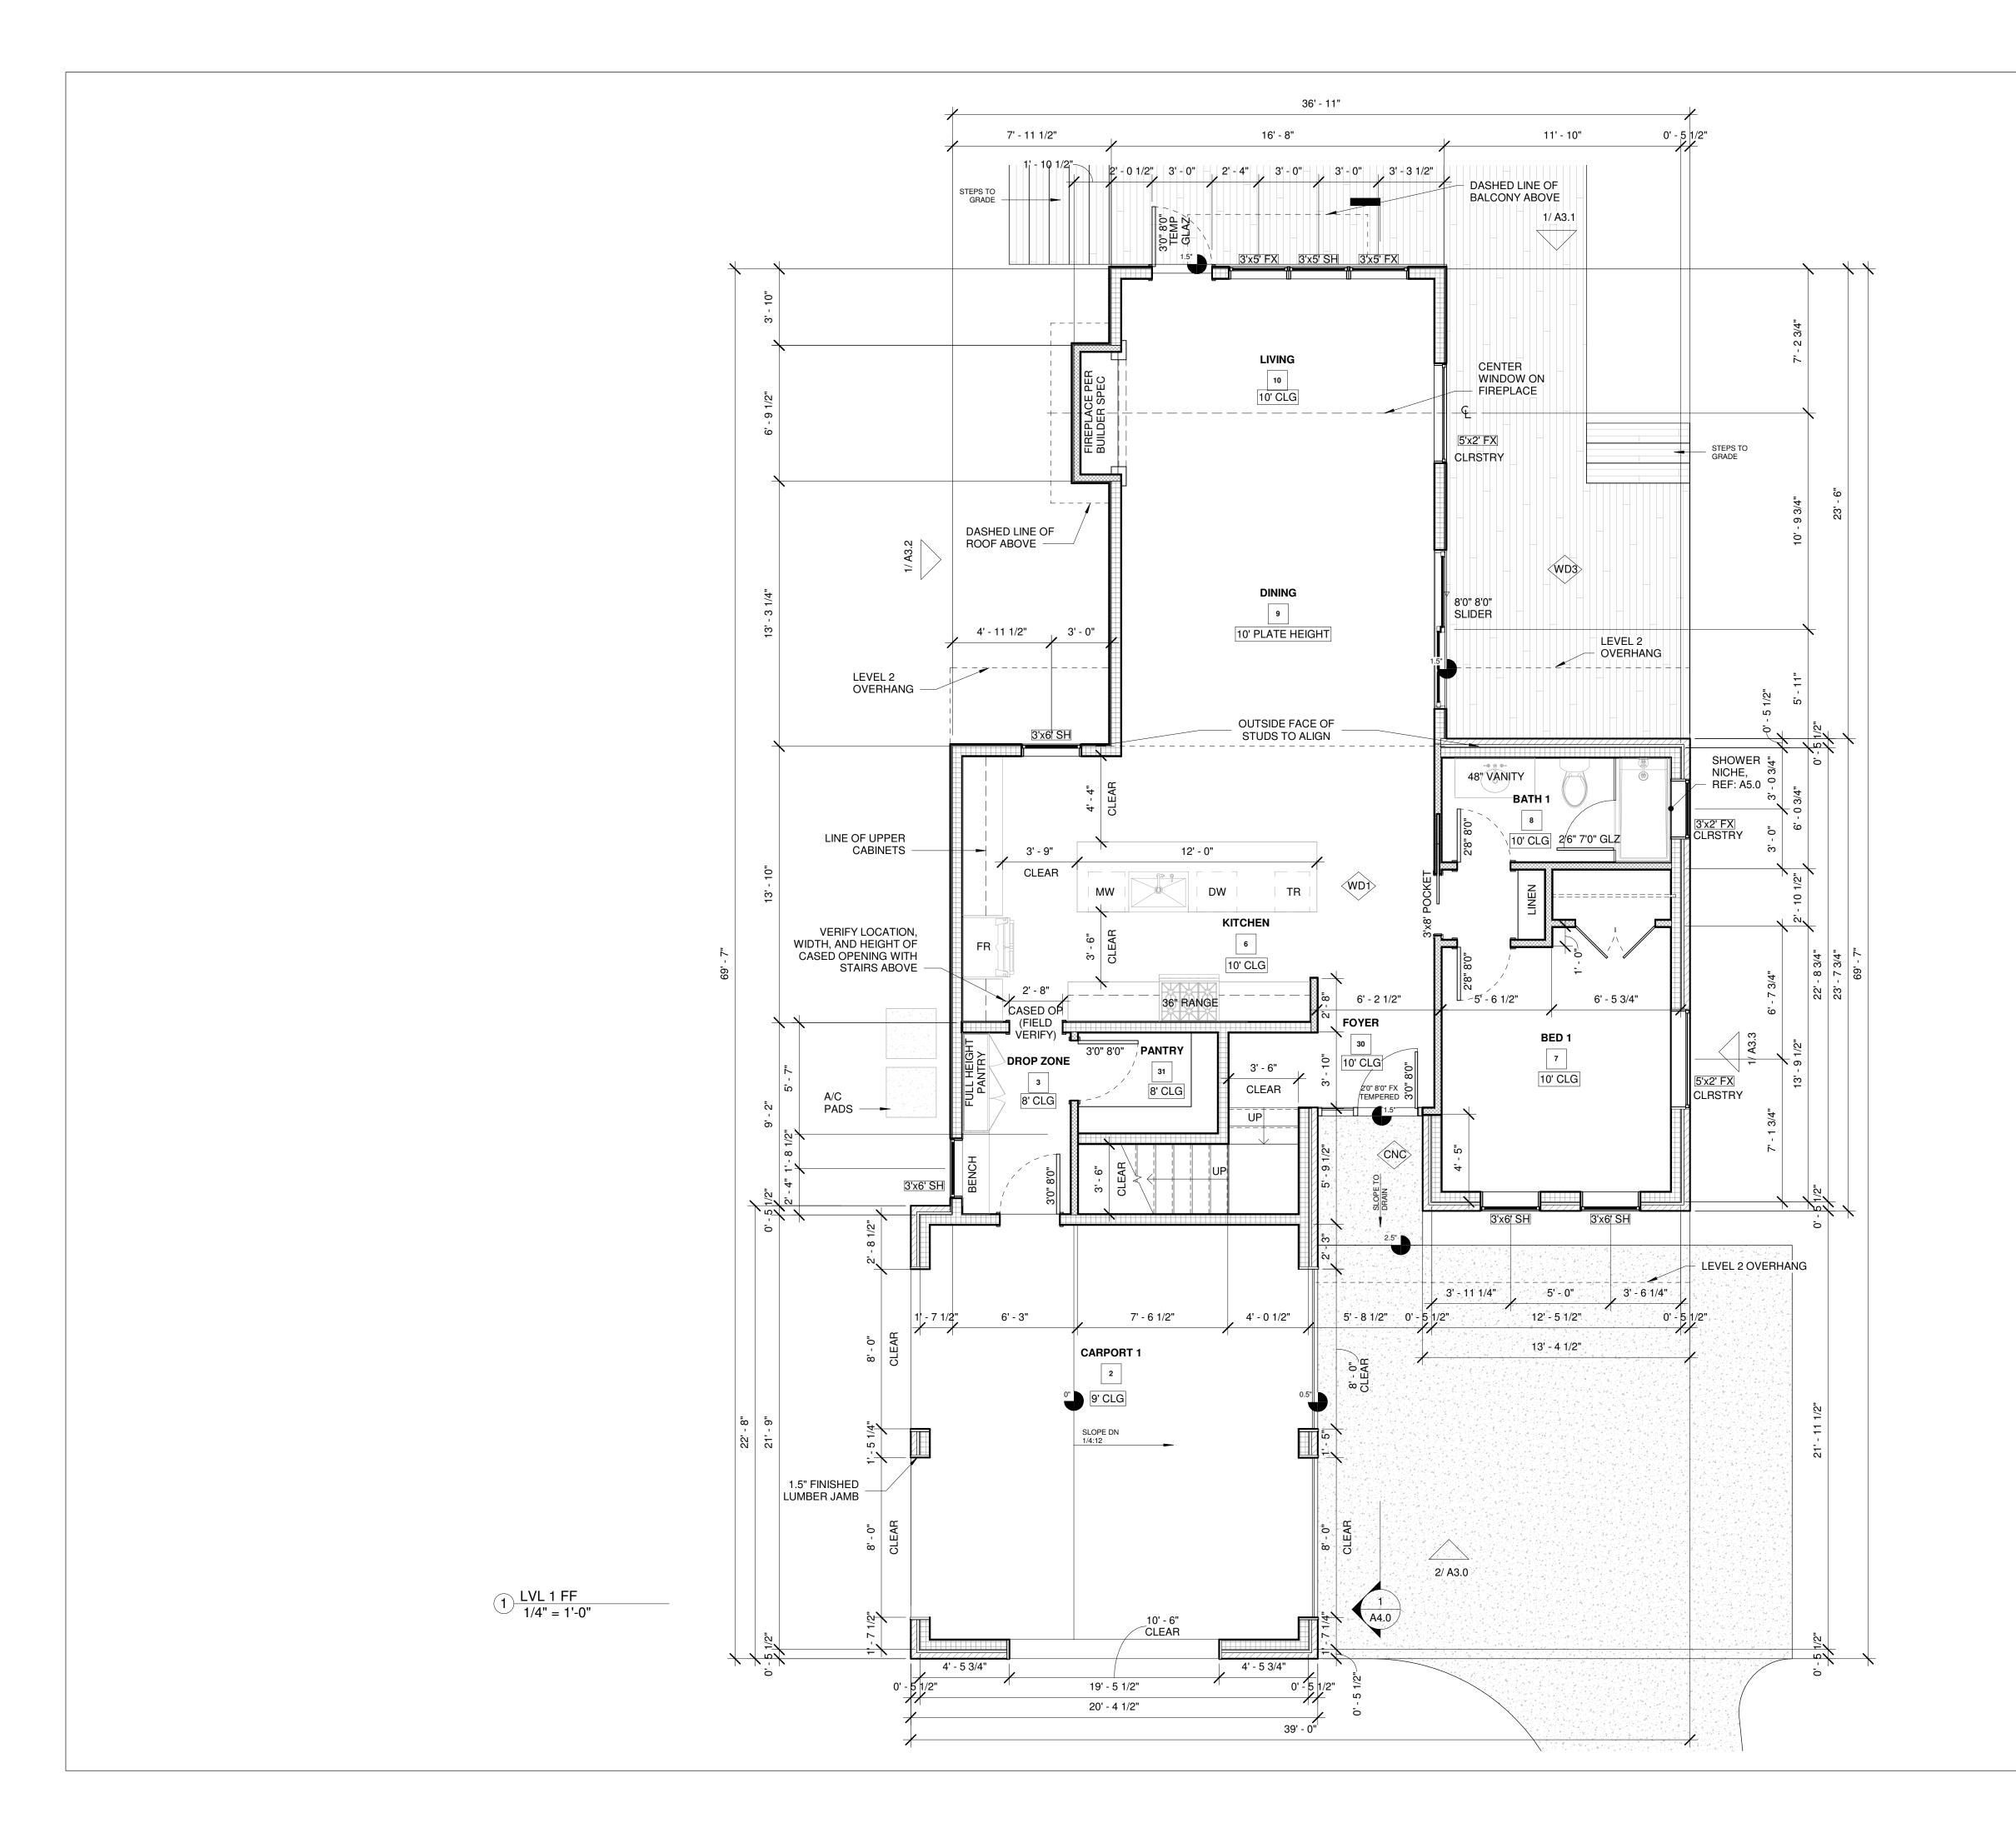

1. REFER TO SHEET G1.0 FOR CODE COMPLIANCE.

2. REFER TO SHEET G2.0 FOR GENERAL NOTES.

3. REFER TO SHEET G1.0 FOR VISITABILITY REQUIREMENTS.

WINDOW TAGS.

6. VERIFY ALL DIMENSIONS IN FIELD AND REPORT ALL DISCREPANCIES TO

4. REFER TO A3.0 SERIES FOR EXTERIOR ELEVATIONS AND ADDITIONAL

7. ALL DOOR FRAMES SHALL BE LOCATED 4" FROM NEAREST

8. WALL FRAMING SHALL BE AS NOTED BELOW UNLESS NOTED OTHERWISE BY STRUCTURAL ENGINEER. CONSULT ARCHITECT ON ANY DISCREPANCIES.

B. ALL SIMPLE (NON-LOAD BEARING) INTERIOR PARTITIONS SHALL BE CONSTRUCTED WITH 2X4 WOOD FRAMING AT 24" ON CENTER,

C. ALL INTERIOR AND EXTERIOR PLUMBING WALLS TO BE CONSTRUCTED WITH 2X6 FRAMING, U.N.O.

D. ALL INTERIOR PARTITIONS SUPPORTING POCKET DOORS TO BE

9. ROOF AND FLOOR FRAMING SHALL BE PER STRUCTURAL DRAWINGS. TRUSS MANUFACTURER SHALL SUPPLY SHOP DRAWINGS SEALED BY AN

LAYER ADJACENT TO EXTERIOR WALL.

12. FLOOR INSULATION - ALL SPACES BETWEEN FLOORS SHALL RECEIVE

13. INTERIOR WALL INSULATION - ALL BEDROOMS, BATHROOM AND

14. CONTRACTOR SHALL PROVIDE BLOCKING IN WALLS AND CEILINGS AS REQUIRED FOR ALL ACCESSORIES, WALL MOUNTED ITEMS, CEILING FANS,

15. USE 1/2" WATER RESISTANT GYP BD IN BATHROOM AND KITCHEN ON ALL WALLS EXCEPT BEHIND CERAMIC TILE AND BATH TUB WHERE TILE

16. TRUSS MANUFACTURER SHALL SUPPLY SHOP DRAWINGS SEALED BY AN ENGINEER TO ARCHITECT AND CONTRACTOR FOR APPROVAL PRIOR

17. CONTACT ARCHITECT/OWNER WITH ANY FRAMING QUESTIONS/DISCREPANCIES.

SHEET NOTES

5. DO NOT SCALE DRAWINGS.

THE ARCHITECT FOR RESOLUTION PRIOR TO COMMENCEMENT OF WORK.

PERPENDICULAR WALL OR CENTER ON WALL SEGMENT AS ILLUSTRATED, UNLESS DIMENSIONED OTHERWISE.

> A. ALL EXTERIOR & LOADING BEARING WALLS SHALL BE CONSTRUCTED WITH 2X6 OR 2X4 WOOD FRAMING AT 18" ON CENTER, U.N.O. REFER TO WALL LEGEND BELOW.

CONSTRUCTED WITH 2X6 FRAMING, U.N.O.

ENGINEER TO DESIGN TEAM AND CONTRACTOR FOR APPROVAL PRIOR TO

10. EXTERIOR WALL INSULATION - ALL EXTERIOR WALLS SHALL RECEIVE MIN. R-19 CELLULOSE BLOWN-IN INSULATION WITH OPTIONAL SPRAY FOAM

11. ROOF INSULATION - ALL ROOF SHALL RECEIVE MIN. R-36 OPEN CELL SPRAY FOAM INSULATION.

MIN. R-30 BATT INSULATION BETWEEN FLOORS.

LAUNDRY ROOM WALLS SHALL RECEIVE SOUND BATT INSULATION.

BACKER BOARD (DENSSHIELD) IS USED.

TO FABRICATION.



EXTERIOR - 2X6 WALL WITH BRICK

LEGEND AND SCALE

EXTERIOR - 2X4 WALL WITH BRICK


EXTERIOR - 2X6 WALL WITH STUCCO

EXTERIOR - 2X4 WALL WITH STUCCO


INTERIOR 2X6 WALL

INTERIOR 2X4 WALL

FULL SIZE SCALE : 1" = 10'-0" (HALF SIZE SCALE: 1" = 20'-0")

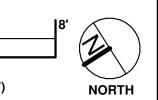

RIVENDALE HOMES TEXAS, LLC 1114 LOST CREEK BLVD. SUITE 200 AUSTIN, TX 78746 T 512-900-8797 WWW.RIVENDALEHOMESTEXAS.COM © RIVENDALE HOMES TEXAS, LLC

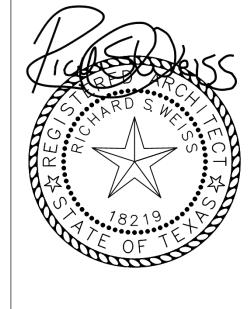

RESIDENCE RIVENDALE


REVISIONS STAMP:

> CURRENT ISSUE: DATE CHECK SET 03.04.22 PROJECT NO: ----SCALE

> DRAWING TITLE FIRST FLOOR

1/4" = 1'-0"

SHEET NUMBER

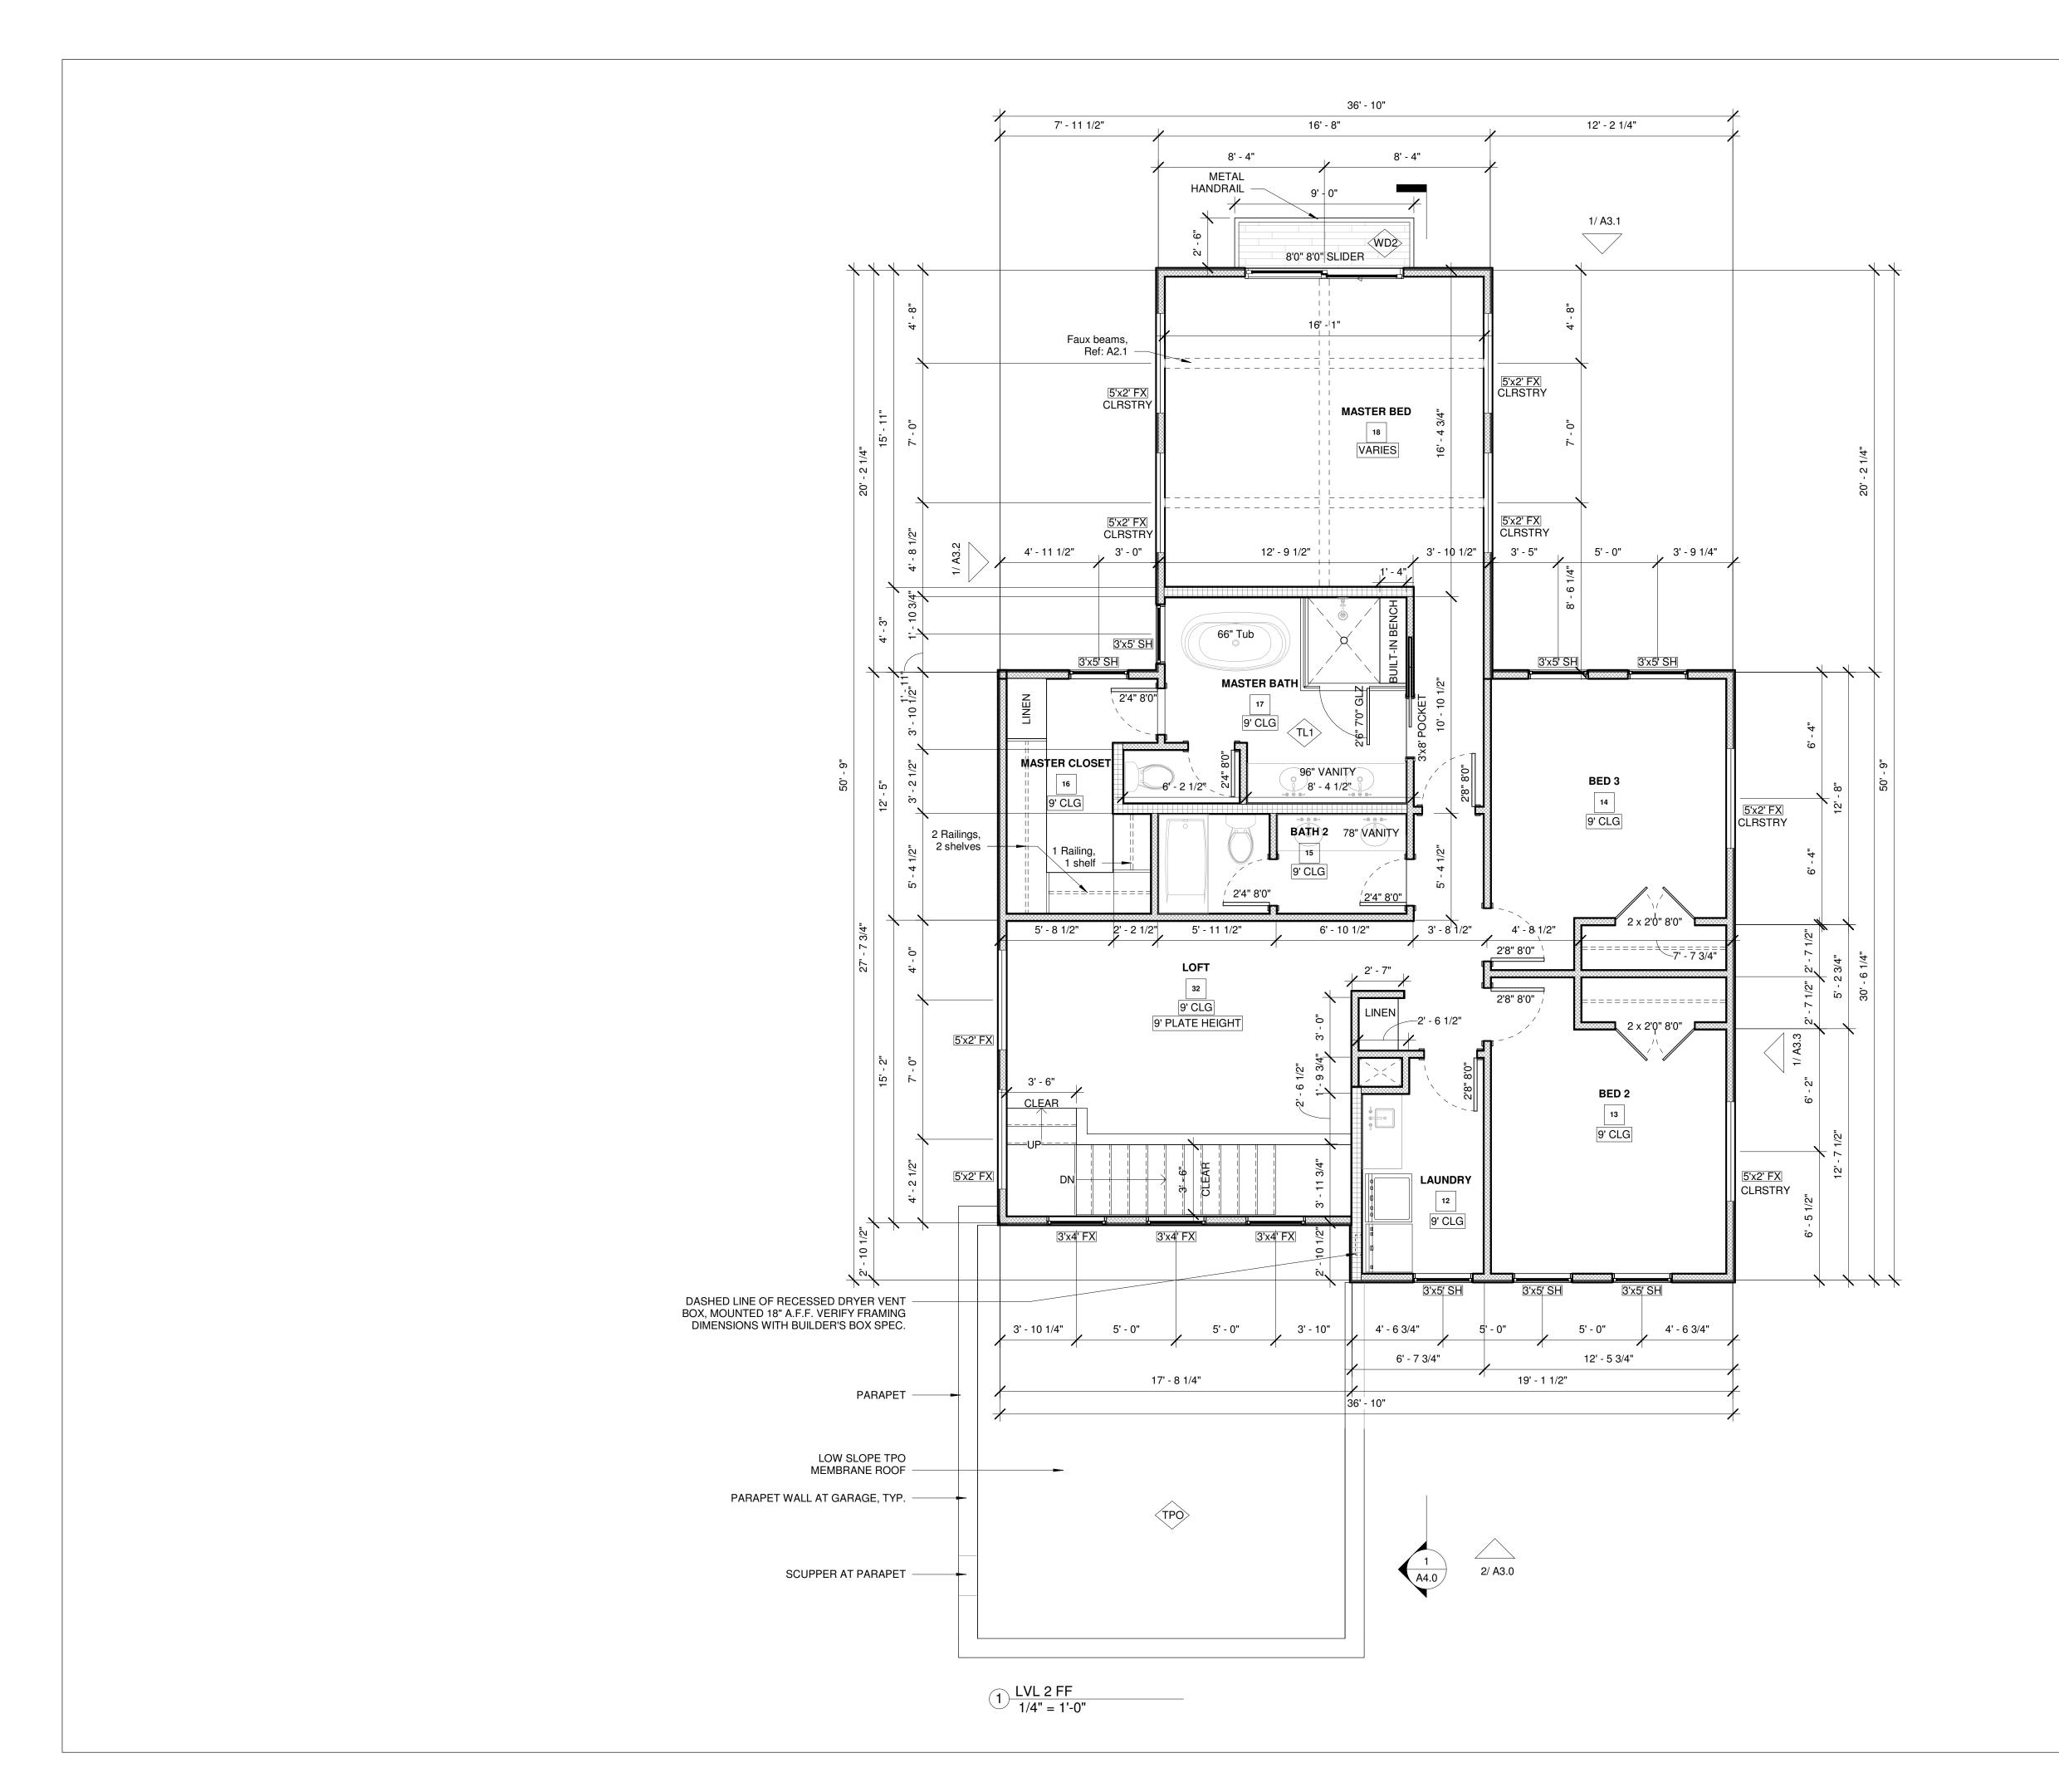

SHEET NOTES

1. REFER TO SHEET G1.0 FOR CODE COMPLIANCE.

2. REFER TO SHEET G2.0 FOR GENERAL NOTES.

3. REFER TO SHEET G1.0 FOR VISITABILITY REQUIREMENTS.

4. REFER TO A3.0 SERIES FOR EXTERIOR ELEVATIONS AND ADDITIONAL WINDOW TAGS.

5. DO NOT SCALE DRAWINGS.

6. VERIFY ALL DIMENSIONS IN FIELD AND REPORT ALL DISCREPANCIES TO THE ARCHITECT FOR RESOLUTION PRIOR TO COMMENCEMENT OF WORK.

7. ALL DOOR FRAMES SHALL BE LOCATED 4" FROM NEAREST PERPENDICULAR WALL OR CENTER ON WALL SEGMENT AS ILLUSTRATED, UNLESS DIMENSIONED OTHERWISE.

8. WALL FRAMING SHALL BE AS NOTED BELOW UNLESS NOTED OTHERWISE BY STRUCTURAL ENGINEER. CONSULT ARCHITECT ON ANY DISCREPANCIES.

A. ALL EXTERIOR & LOADING BEARING WALLS SHALL BE CONSTRUCTED WITH 2X6 OR 2X4 WOOD FRAMING AT 18" ON CENTER, U.N.O. REFER TO WALL LEGEND BELOW.

B. ALL SIMPLE (NON-LOAD BEARING) INTERIOR PARTITIONS SHALL BE CONSTRUCTED WITH 2X4 WOOD FRAMING AT 24" ON CENTER, U.N.O.

C. ALL INTERIOR AND EXTERIOR PLUMBING WALLS TO BE CONSTRUCTED WITH 2X6 FRAMING, U.N.O.

D. ALL INTERIOR PARTITIONS SUPPORTING POCKET DOORS TO BE CONSTRUCTED WITH 2X6 FRAMING, U.N.O.

9. ROOF AND FLOOR FRAMING SHALL BE PER STRUCTURAL DRAWINGS. TRUSS MANUFACTURER SHALL SUPPLY SHOP DRAWINGS SEALED BY AN ENGINEER TO DESIGN TEAM AND CONTRACTOR FOR APPROVAL PRIOR TO FABRICATION.

10. EXTERIOR WALL INSULATION - ALL EXTERIOR WALLS SHALL RECEIVE MIN. R-19 CELLULOSE BLOWN-IN INSULATION WITH OPTIONAL SPRAY FOAM LAYER ADJACENT TO EXTERIOR WALL.

12. FLOOR INSULATION - ALL SPACES BETWEEN FLOORS SHALL RECEIVE

11. ROOF INSULATION - ALL ROOF SHALL RECEIVE MIN. R-36 OPEN CELL SPRAY FOAM INSULATION.

MIN. R-30 BATT INSULATION BETWEEN FLOORS.

13. INTERIOR WALL INSULATION - ALL BEDROOMS, BATHROOM AND

LAUNDRY ROOM WALLS SHALL RECEIVE SOUND BATT INSULATION.

14. CONTRACTOR SHALL PROVIDE BLOCKING IN WALLS AND CEILINGS AS REQUIRED FOR ALL ACCESSORIES, WALL MOUNTED ITEMS, CEILING FANS, ETC.

15. USE 1/2" WATER RESISTANT GYP BD IN BATHROOM AND KITCHEN ON ALL WALLS EXCEPT BEHIND CERAMIC TILE AND BATH TUB WHERE TILE BACKER BOARD (DENSSHIELD) IS USED.

16. TRUSS MANUFACTURER SHALL SUPPLY SHOP DRAWINGS SEALED BY AN ENGINEER TO ARCHITECT AND CONTRACTOR FOR APPROVAL PRIOR TO FABRICATION.

LEGEND AND SCALE

EXTERIOR - 2X6 WALL WITH BRICK

EXTERIOR - 2X4 WALL WITH BRICK

EXTERIOR - 2X6 WALL WITH STUCCO

EXTERIOR - 2X4 WALL WITH STUCCO

INTERIOR 2X6 WALL

INTERIOR 2X4 WALL

FULL SIZE SCALE : 1" = 10'-0"


(HALF SIZE SCALE: 1" = 20'-0")

17. CONTACT ARCHITECT/OWNER WITH ANY FRAMING QUESTIONS/DISCREPANCIES.

RIVENDALE HOMES TEXAS, LLC

1114 LOST CREEK BLVD. SUITE 200 AUSTIN, TX 78746 T 512-900-8797 WWW.RIVENDALEHOMESTEXAS.COM

© RIVENDALE HOMES TEXAS, LLC

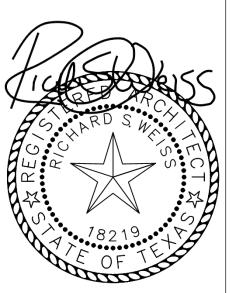

RESIDENCE RIVENDALE HOME

REVISIONS

STAMP:

 CURRENT ISSUE:

 SET
 DATE

 CHECK SET
 03.04.22

 PROJECT NO: --- SCALE


 1/4" = 1'-0"

SECOND FLOOR

SHEET NUMBER

NORTH

A1.1

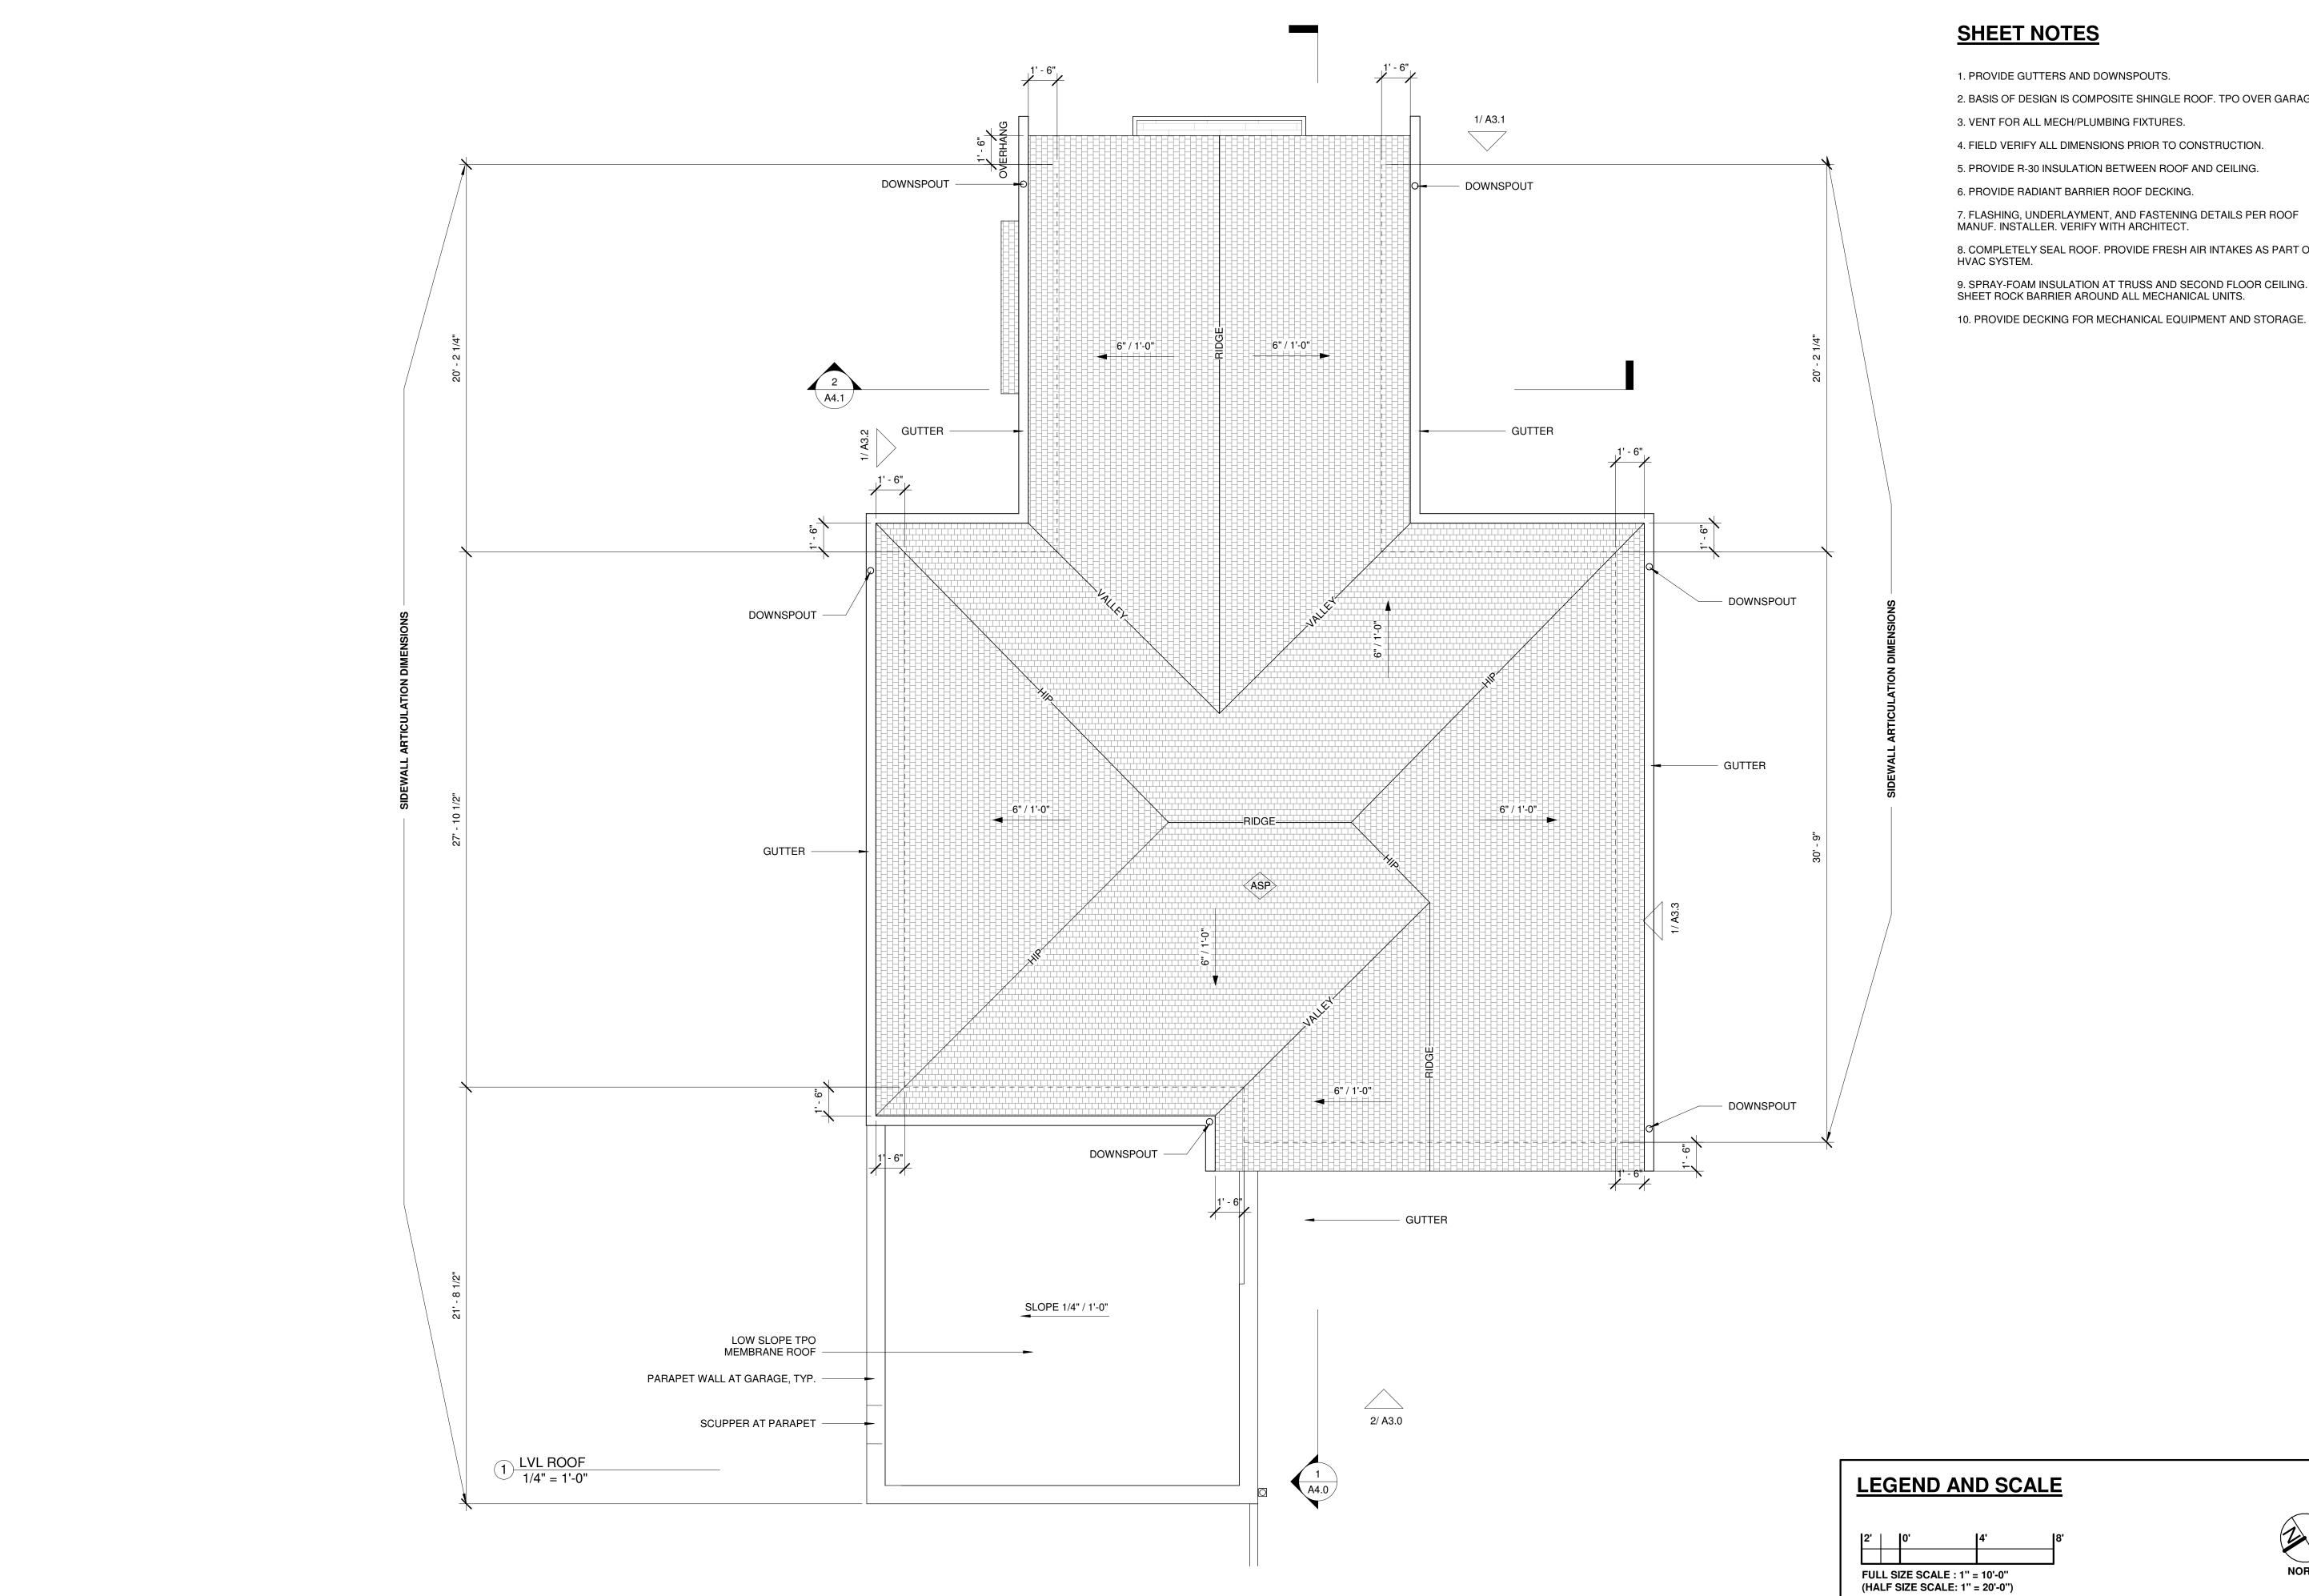

1. PROVIDE GUTTERS AND DOWNSPOUTS.

- 2. BASIS OF DESIGN IS COMPOSITE SHINGLE ROOF. TPO OVER GARAGE.


- 8. COMPLETELY SEAL ROOF. PROVIDE FRESH AIR INTAKES AS PART OF
- 9. SPRAY-FOAM INSULATION AT TRUSS AND SECOND FLOOR CEILING. SHEET ROCK BARRIER AROUND ALL MECHANICAL UNITS.
- 10. PROVIDE DECKING FOR MECHANICAL EQUIPMENT AND STORAGE.



RIVENDALE HOMES TEXAS, LLC

1114 LOST CREEK BLVD. SUITE 200 AUSTIN, TX 78746 T 512-900-8797 WWW.RIVENDALEHOMESTEXAS.COM

© RIVENDALE HOMES TEXAS, LLC

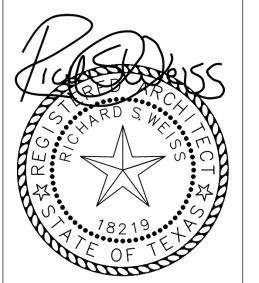

REVISIONS

STAMP:


| CURRENT ISSUE: | |
|----------------|----------|
| SET | DATE |
| CHECK SET | 03.04.22 |
| PROJECT NO: | |

SCALE 1/4" = 1'-0" DRAWING TITLE

ROOF PLAN

SHEET NUMBER

NORTH

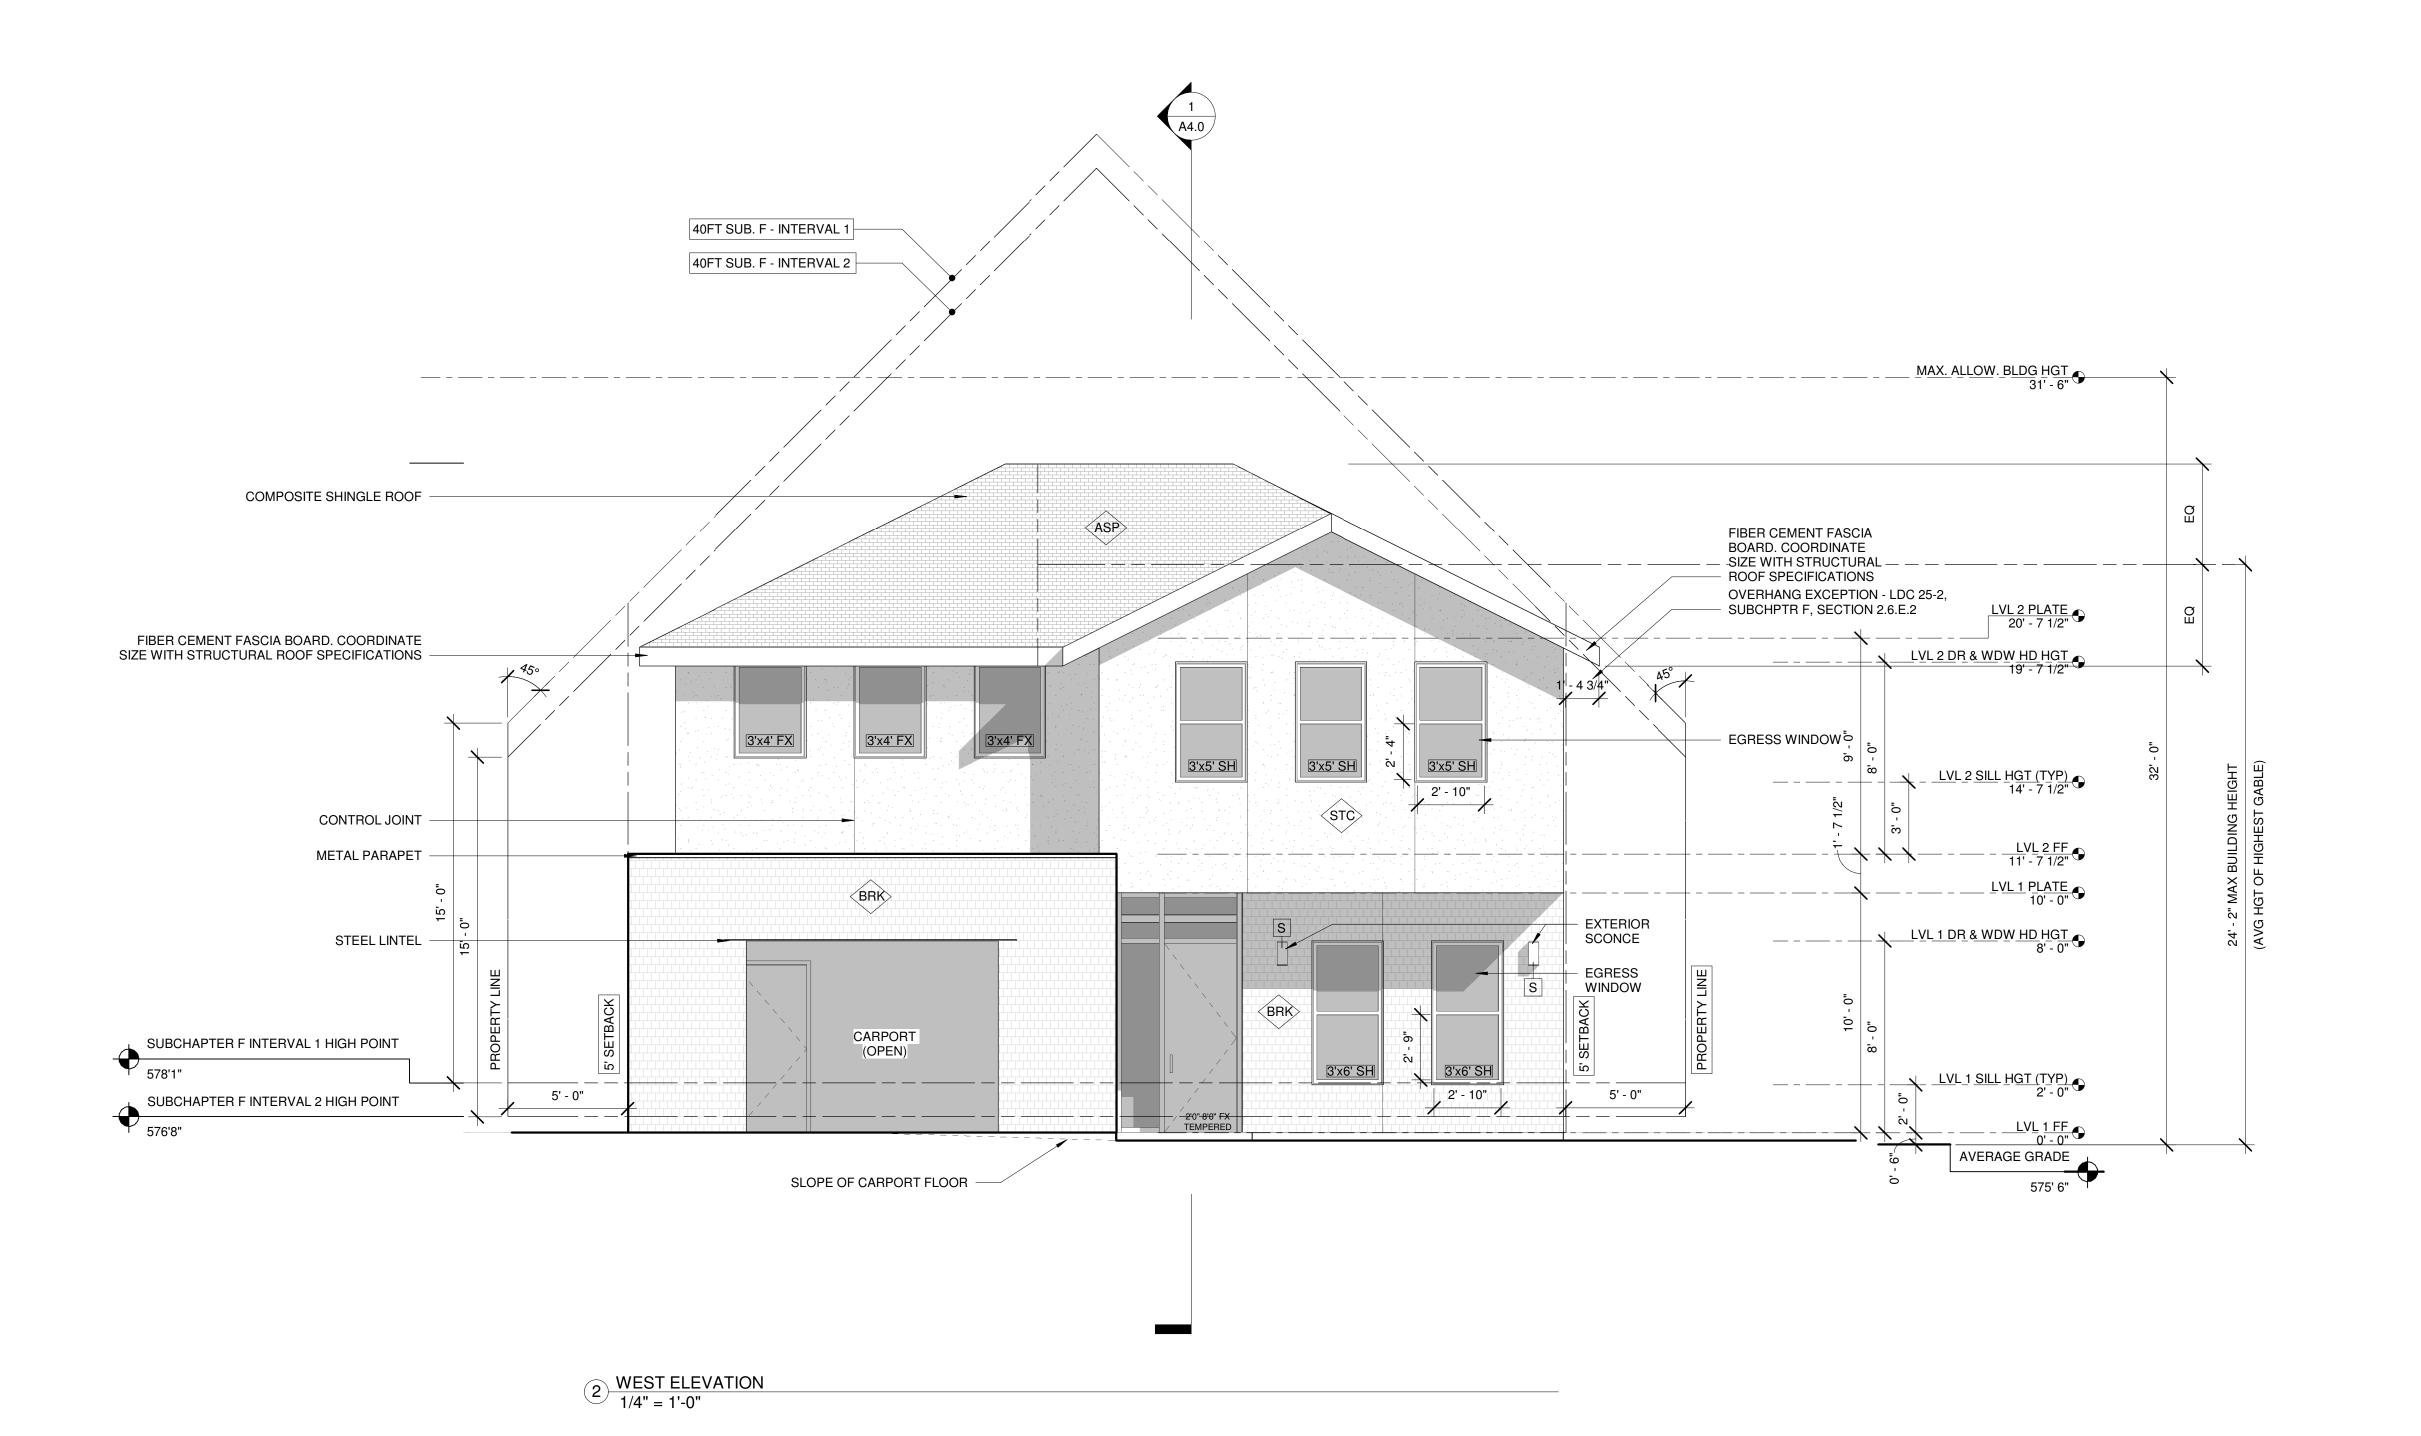

SHEET NOTES

1. REFER TO G1.0 FOR CODE COMPLIANCE.

2. REFER TO G2.0 FOR GENERAL NOTES.

3. REFER TO XXX FOR EXTERIOR ASSEMBLY NOTES AND SPECIFICATIONS.

4. REFER TO XXX FOR DOOR AND WINDOW TYPES & SCHEDULE

5. CONTRACTOR SHALL PROVIDE GUTTER AND DOWNSPOUT SYSTEM TO POSITIVELY DRAIN ROOF AWAY FROM BUILDING AND INTO LANDSCAPE BEDS.

6. ALL WINDOW HEADER HEIGHTS ON LOWER AND UPPER FLOOR SHALL BE 7'-8"' AFF UNO.

7. ALL WINDOWS LOCATED WITHIN 24" OF AN EXTERIOR OR INTERIOR DOOR SHALL RECEIVE TEMPERED SAFETY GLASS PER IRC 2021. WINDOW MANUFACTURER AND CONTRACTOR SHALL VERIFY ALL TEMPERED GLASS LOCATIONS PER APPLICABLE CODES.

8. WINDOW MANUFACTURER AND CONTRACTOR SHALL VERIFY ALL EGRESS WINDOWS ARE INSTALLED PER APPLICABLE CODE REQUIREMENTS.

9. ALL WINDOWS SHALL HAVE U-FACTOR 0.40 OR LESS PER CITY OF AUSTIN CODE AMENDMENT.

10. ALL WINDOWS SHALL BE ALUMINUM CLAD AND FACTORY MULLED WHEN POSSIBLE.

11. PROVIDE MIN. 4" TRIM AT ALL SIDES OF ALUMINUM WINDOWS.

12. EXPOSED FOUNDATION SHALL BE MIN. 8" AND A MAXIMUM OF x INCHES ABOVE GRADE. UNDERPIN ALL EXPOSED

FOUNDATIONS.

13. GRADE LINES SHOWN ON ELEVATION DRAWINGS SHALL NOT BE CONSTRUED TO REPRESENT ACTUAL FINISH GRADES. VERIFY

14. ACTUAL ELEVATIONS TO VARY PER GRADE OF EXISTING LOT.

FINISH GRADE ON JOB SITE AND NOTIFY ARCHITECT OF ANY SIGNIFICANT DISCREPANCIES PRIOR TO STARTING WORK.

15. ALL PLUMBING, APPLIANCE, AND GAS VENTS TO BE GANGED TO THE LEAST POSSIBLE NUMBER OF ROOF PENETRATIONS AND KEPT TO REAR OF ROOF WHENEVER POSSIBLE.

ASSEMBLIES PER MANUFACTURER'S RECOMMENDED INSTALLATION.

17. ALL EXTERIOR SYSTEMS SHALL BE INSTALLED TO ASSURE ADEQUATE DRAINAGE IS PROVIDED.

16. CONTRACTOR SHALL INSTALL ALL PRODUCTS AND


18. TEMP GLZ = PROVIDE TEMPERED SAFETY GLASS AT ALL REQUIRED LOCATIONS AS REQUIRED BY CODE.

R

RIVENDALE HOMES TEXAS, LLC

1114 LOST CREEK BLVD. SUITE 200 AUSTIN, TX 78746 T 512-900-8797 WWW.RIVENDALEHOMESTEXAS.COM

© RIVENDALE HOMES TEXAS, LLC

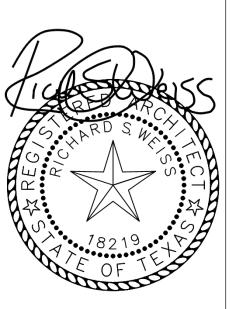

RESIDENCE RIVENDALE HOMES

REVISIONS

STAMP:

CURRENT ISSUE:

SET DATE

CHECK SET 03.04.22

PROJECT NO: ----


SCALE 1/4" = 1'-0"

DRAWING TITLE

BUILDING ELEVATIONS

SHEET NUMBER

A3.0

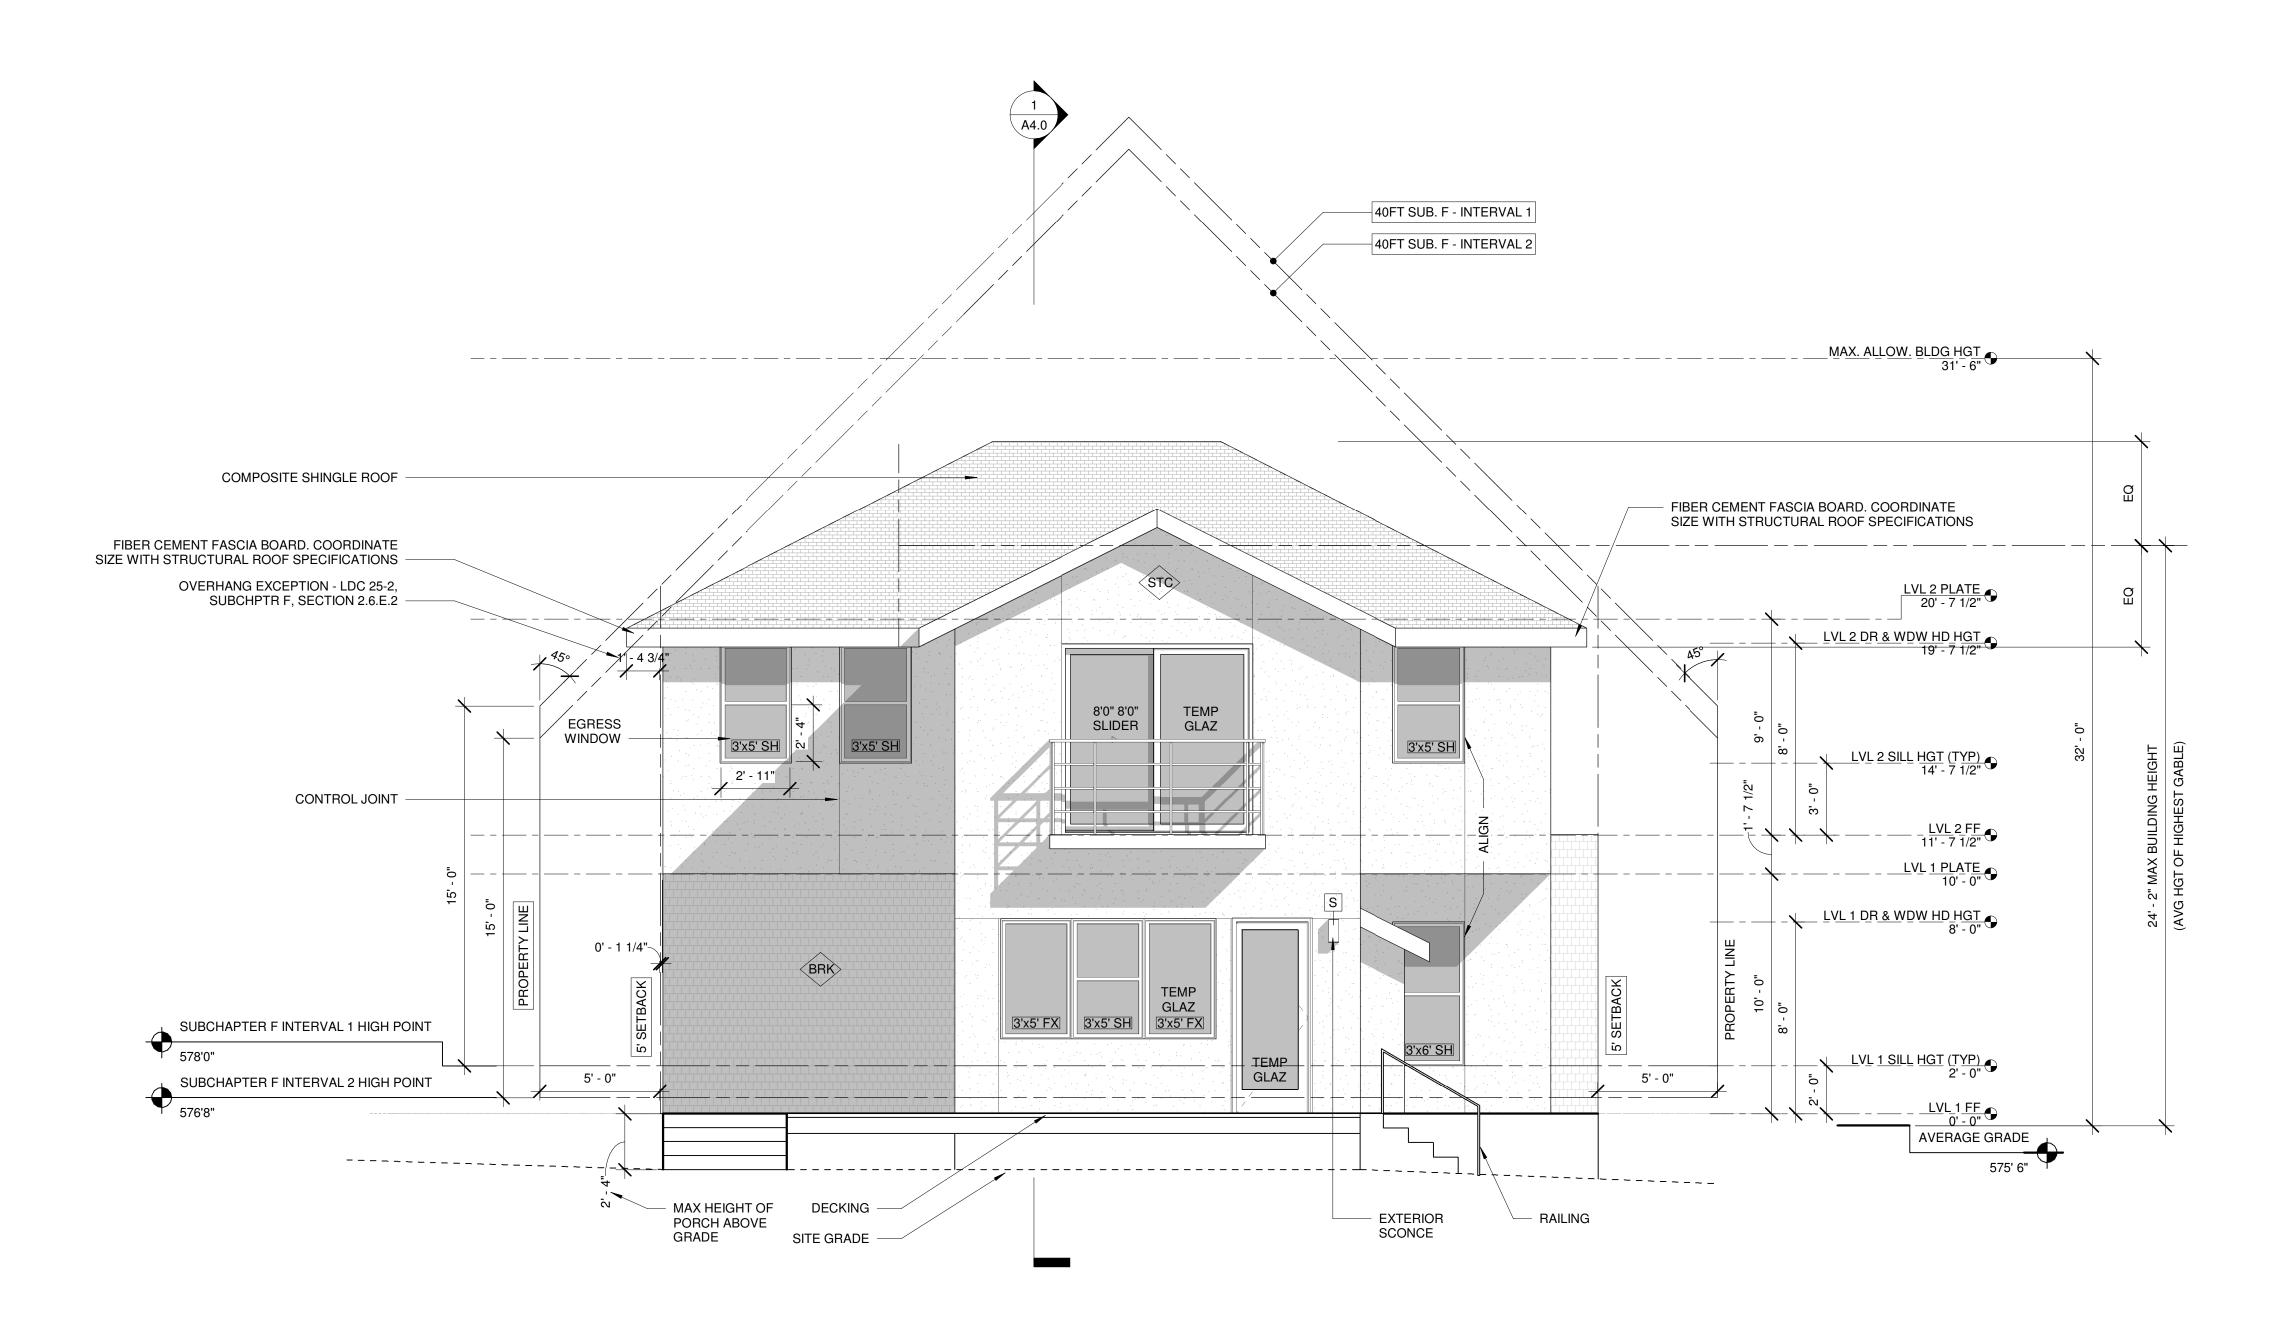

1) EAST ELEVATION 1/4" = 1'-0"

3. REFER TO XXX FOR EXTERIOR ASSEMBLY NOTES AND SPECIFICATIONS.

4. REFER TO XXX FOR DOOR AND WINDOW TYPES & SCHEDULE

5. CONTRACTOR SHALL PROVIDE GUTTER AND DOWNSPOUT SYSTEM TO POSITIVELY DRAIN ROOF AWAY FROM BUILDING AND

SHALL BE 7'-8"' AFF UNO.

7. ALL WINDOWS LOCATED WITHIN 24" OF AN EXTERIOR OR CODES.

8. WINDOW MANUFACTURER AND CONTRACTOR SHALL VERIFY ALL EGRESS WINDOWS ARE INSTALLED PER APPLICABLE CODE

9. ALL WINDOWS SHALL HAVE U-FACTOR 0.40 OR LESS PER CITY OF AUSTIN CODE AMENDMENT.

12. EXPOSED FOUNDATION SHALL BE MIN. 8" AND A MAXIMUM OF

FOUNDATIONS. 13. GRADE LINES SHOWN ON ELEVATION DRAWINGS SHALL NOT

FINISH GRADE ON JOB SITE AND NOTIFY ARCHITECT OF ANY SIGNIFICANT DISCREPANCIES PRIOR TO STARTING WORK.

15. ALL PLUMBING, APPLIANCE, AND GAS VENTS TO BE GANGED

TO THE LEAST POSSIBLE NUMBER OF ROOF PENETRATIONS AND KEPT TO REAR OF ROOF WHENEVER POSSIBLE.

INSTALLATION.

17. ALL EXTERIOR SYSTEMS SHALL BE INSTALLED TO ASSURE ADEQUATE DRAINAGE IS PROVIDED.

18. TEMP GLZ = PROVIDE TEMPERED SAFETY GLASS AT ALL REQUIRED LOCATIONS AS REQUIRED BY CODE.

SHEET NOTES

1. REFER TO G1.0 FOR CODE COMPLIANCE.

2. REFER TO G2.0 FOR GENERAL NOTES.

INTO LANDSCAPE BEDS.

6. ALL WINDOW HEADER HEIGHTS ON LOWER AND UPPER FLOOR

INTERIOR DOOR SHALL RECEIVE TEMPERED SAFETY GLASS PER IRC 2021. WINDOW MANUFACTURER AND CONTRACTOR SHALL VERIFY ALL TEMPERED GLASS LOCATIONS PER APPLICABLE

REQUIREMENTS.

10. ALL WINDOWS SHALL BE ALUMINUM CLAD AND FACTORY MULLED WHEN POSSIBLE.

11. PROVIDE MIN. 4" TRIM AT ALL SIDES OF ALUMINUM WINDOWS.

x INCHES ABOVE GRADE. UNDERPIN ALL EXPOSED

BE CONSTRUED TO REPRESENT ACTUAL FINISH GRADES. VERIFY


14. ACTUAL ELEVATIONS TO VARY PER GRADE OF EXISTING LOT.

16. CONTRACTOR SHALL INSTALL ALL PRODUCTS AND ASSEMBLIES PER MANUFACTURER'S RECOMMENDED

RIVENDALE HOMES TEXAS, LLC

1114 LOST CREEK BLVD. SUITE 200 AUSTIN, TX 78746 T 512-900-8797

WWW.RIVENDALEHOMESTEXAS.COM © RIVENDALE HOMES TEXAS, LLC

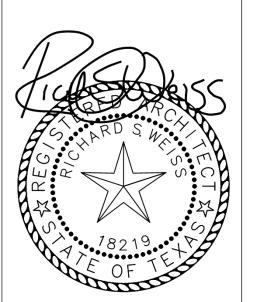


REVISIONS

STAMP:

| CURRENT ISSUE: | |
|----------------|--------------|
| SET | DATE |
| CHECK SET | 03.04.22 |
| PROJECT NO: | |
| SCALE | 1/4" = 1'-0" |

DRAWING TITLE BUILDING

ELEVATIONS SHEET NUMBER

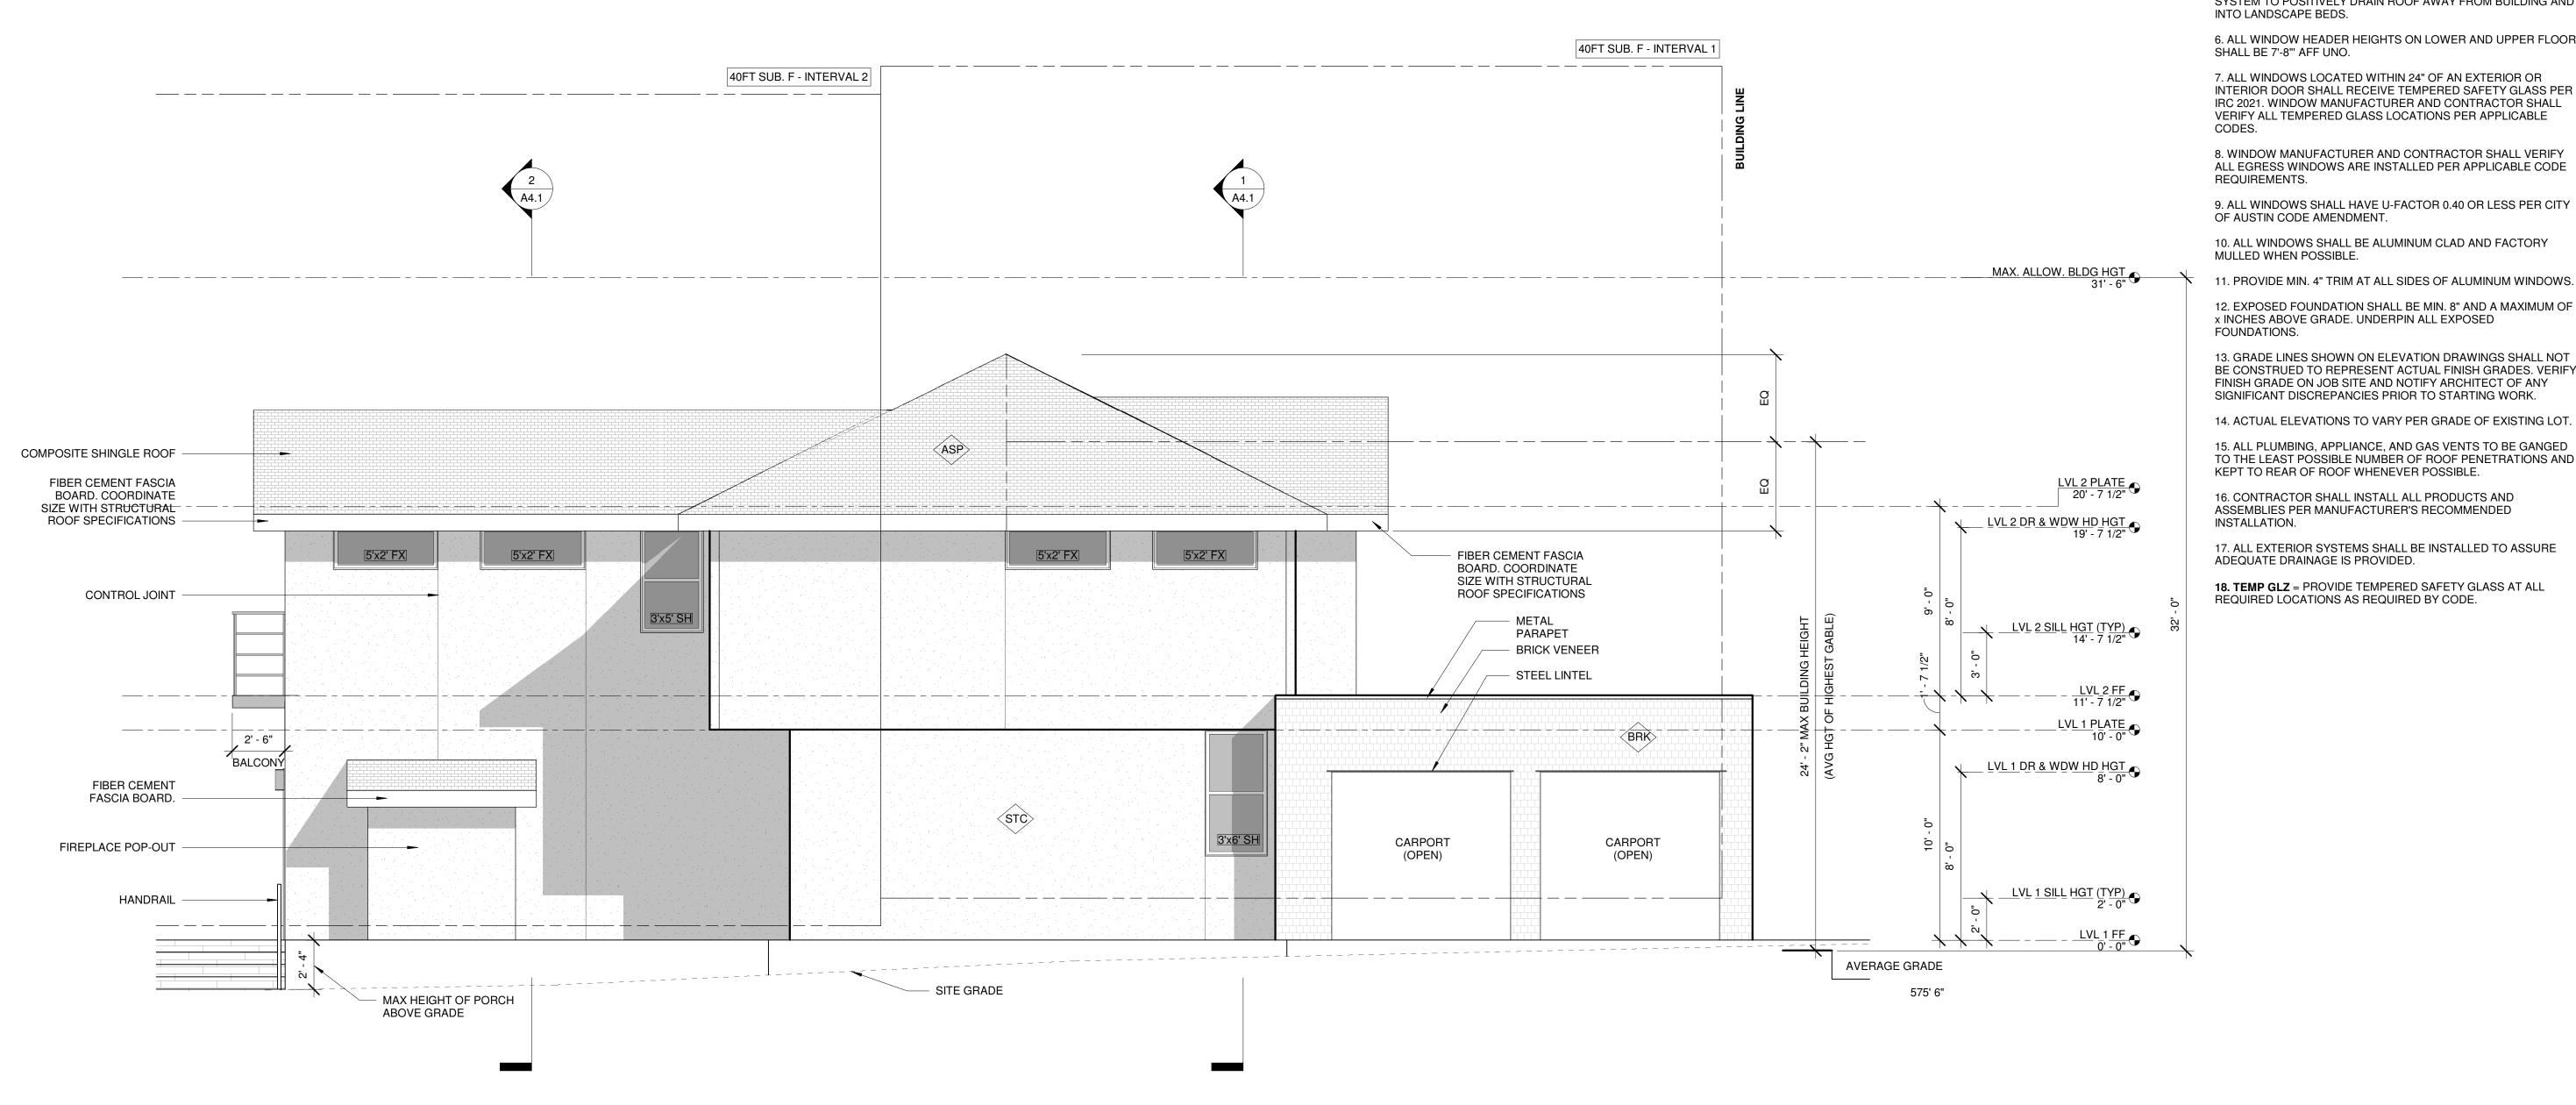

1 NORTH ELEVATION 1/4" = 1'-0"

SHEET NOTES

1. REFER TO G1.0 FOR CODE COMPLIANCE.

2. REFER TO G2.0 FOR GENERAL NOTES.

3. REFER TO XXX FOR EXTERIOR ASSEMBLY NOTES AND SPECIFICATIONS.

4. REFER TO XXX FOR DOOR AND WINDOW TYPES & SCHEDULE

5. CONTRACTOR SHALL PROVIDE GUTTER AND DOWNSPOUT SYSTEM TO POSITIVELY DRAIN ROOF AWAY FROM BUILDING AND INTO LANDSCAPE BEDS.

6. ALL WINDOW HEADER HEIGHTS ON LOWER AND UPPER FLOOR SHALL BE 7'-8"' AFF UNO.

7. ALL WINDOWS LOCATED WITHIN 24" OF AN EXTERIOR OR INTERIOR DOOR SHALL RECEIVE TEMPERED SAFETY GLASS PER IRC 2021. WINDOW MANUFACTURER AND CONTRACTOR SHALL VERIFY ALL TEMPERED GLASS LOCATIONS PER APPLICABLE CODES.

8. WINDOW MANUFACTURER AND CONTRACTOR SHALL VERIFY ALL EGRESS WINDOWS ARE INSTALLED PER APPLICABLE CODE REQUIREMENTS.

9. ALL WINDOWS SHALL HAVE U-FACTOR 0.40 OR LESS PER CITY OF AUSTIN CODE AMENDMENT.

10. ALL WINDOWS SHALL BE ALUMINUM CLAD AND FACTORY MULLED WHEN POSSIBLE.

12. EXPOSED FOUNDATION SHALL BE MIN. 8" AND A MAXIMUM OF

x INCHES ABOVE GRADE. UNDERPIN ALL EXPOSED FOUNDATIONS. 13. GRADE LINES SHOWN ON ELEVATION DRAWINGS SHALL NOT BE CONSTRUED TO REPRESENT ACTUAL FINISH GRADES. VERIFY

FINISH GRADE ON JOB SITE AND NOTIFY ARCHITECT OF ANY SIGNIFICANT DISCREPANCIES PRIOR TO STARTING WORK.

15. ALL PLUMBING, APPLIANCE, AND GAS VENTS TO BE GANGED TO THE LEAST POSSIBLE NUMBER OF ROOF PENETRATIONS AND

KEPT TO REAR OF ROOF WHENEVER POSSIBLE. 16. CONTRACTOR SHALL INSTALL ALL PRODUCTS AND

INSTALLATION.

17. ALL EXTERIOR SYSTEMS SHALL BE INSTALLED TO ASSURE ADEQUATE DRAINAGE IS PROVIDED.


18. TEMP GLZ = PROVIDE TEMPERED SAFETY GLASS AT ALL

REQUIRED LOCATIONS AS REQUIRED BY CODE.

RIVENDALE HOMES TEXAS, LLC

1114 LOST CREEK BLVD. SUITE 200 AUSTIN, TX 78746 T 512-900-8797 WWW.RIVENDALEHOMESTEXAS.COM

© RIVENDALE HOMES TEXAS, LLC

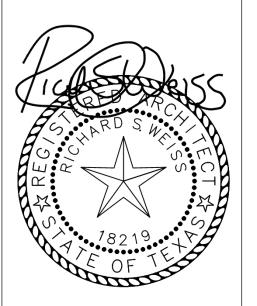

REVISIONS


STAMP:

| CURRENT ISSUE: | |
|----------------|--------------|
| SET | DATE |
| CHECK SET | 03.04.22 |
| PROJECT NO: | |
| SCALE | 1/4" = 1'-0" |

DRAWING TITLE BUILDING

ELEVATIONS

SHEET NUMBER

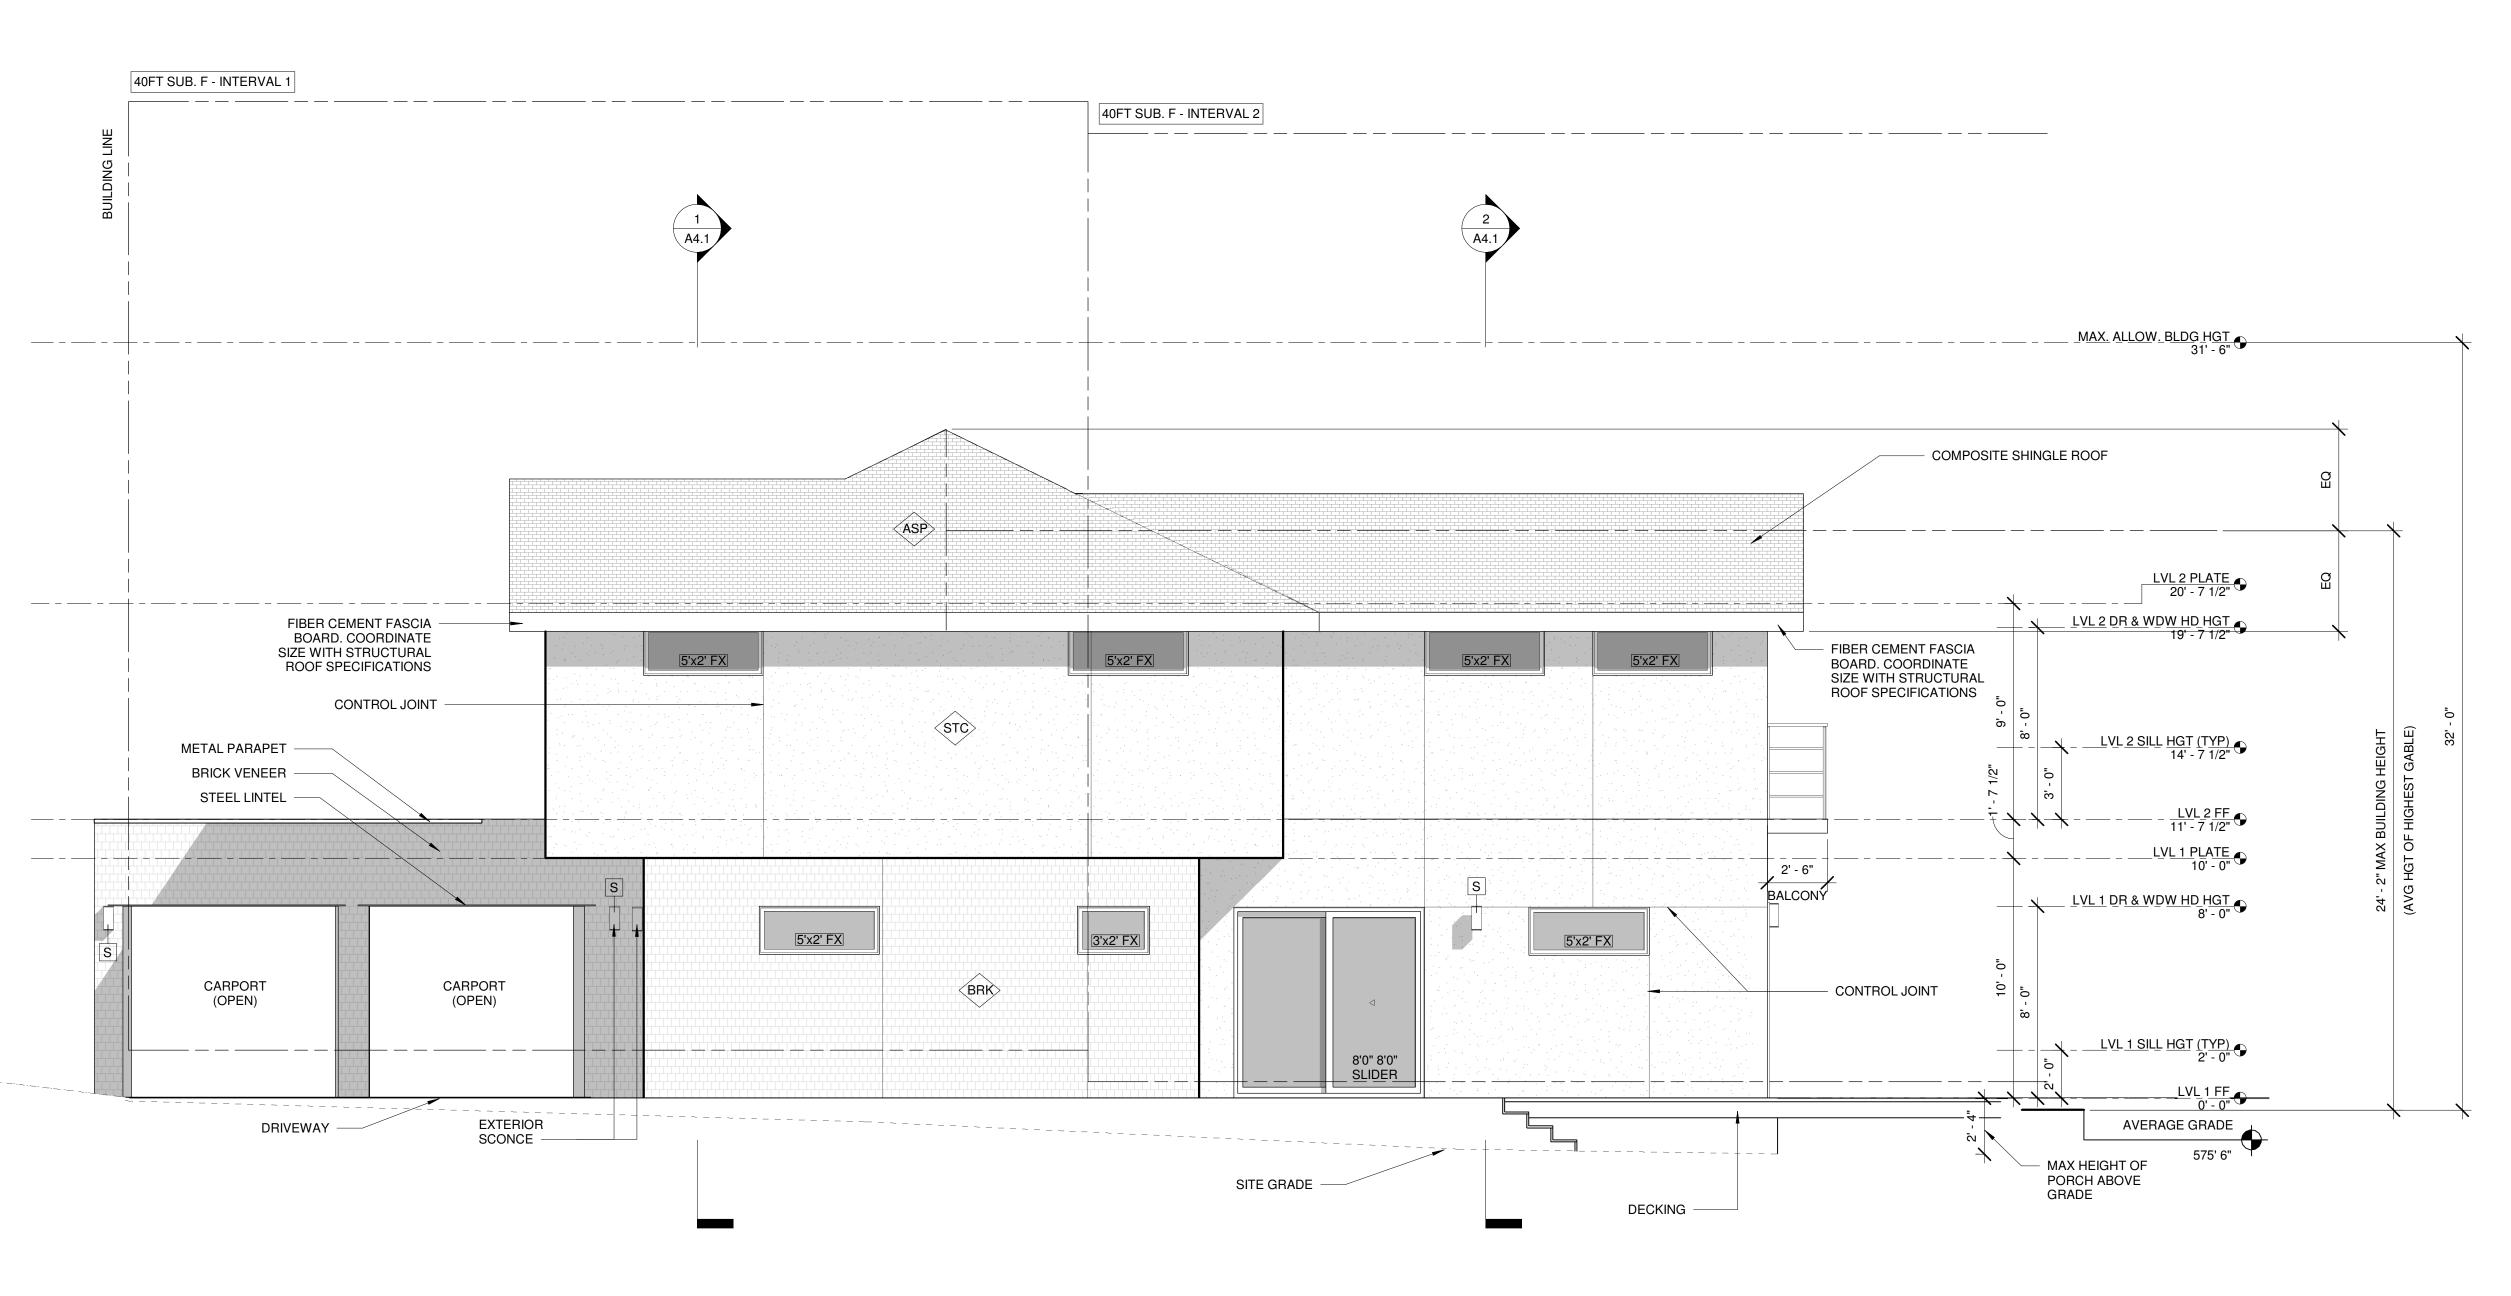

1) SOUTH ELEVATION 1/4" = 1'-0"

SHEET NOTES

1. REFER TO G1.0 FOR CODE COMPLIANCE.

2. REFER TO G2.0 FOR GENERAL NOTES.

3. REFER TO XXX FOR EXTERIOR ASSEMBLY NOTES AND SPECIFICATIONS.

4. REFER TO XXX FOR DOOR AND WINDOW TYPES & SCHEDULE

5. CONTRACTOR SHALL PROVIDE GUTTER AND DOWNSPOUT SYSTEM TO POSITIVELY DRAIN ROOF AWAY FROM BUILDING AND INTO LANDSCAPE BEDS.

6. ALL WINDOW HEADER HEIGHTS ON LOWER AND UPPER FLOOR SHALL BE 7'-8"' AFF UNO.

7. ALL WINDOWS LOCATED WITHIN 24" OF AN EXTERIOR OR INTERIOR DOOR SHALL RECEIVE TEMPERED SAFETY GLASS PER IRC 2021. WINDOW MANUFACTURER AND CONTRACTOR SHALL VERIFY ALL TEMPERED GLASS LOCATIONS PER APPLICABLE CODES.

8. WINDOW MANUFACTURER AND CONTRACTOR SHALL VERIFY ALL EGRESS WINDOWS ARE INSTALLED PER APPLICABLE CODE REQUIREMENTS.

9. ALL WINDOWS SHALL HAVE U-FACTOR 0.40 OR LESS PER CITY OF AUSTIN CODE AMENDMENT.

10. ALL WINDOWS SHALL BE ALUMINUM CLAD AND FACTORY MULLED WHEN POSSIBLE.

11. PROVIDE MIN. 4" TRIM AT ALL SIDES OF ALUMINUM WINDOWS.

12. EXPOSED FOUNDATION SHALL BE MIN. 8" AND A MAXIMUM OF X INCHES ABOVE GRADE. UNDERPIN ALL EXPOSED

FOUNDATIONS.

13. GRADE LINES SHOWN ON ELEVATION DRAWINGS SHALL NOT BE CONSTRUED TO REPRESENT ACTUAL FINISH GRADES. VERIFY

FINISH GRADE ON JOB SITE AND NOTIFY ARCHITECT OF ANY SIGNIFICANT DISCREPANCIES PRIOR TO STARTING WORK.

14. ACTUAL ELEVATIONS TO VARY PER GRADE OF EXISTING LOT.

15. ALL PLUMBING, APPLIANCE, AND GAS VENTS TO BE GANGED TO THE LEAST POSSIBLE NUMBER OF ROOF PENETRATIONS AND KEPT TO REAR OF ROOF WHENEVER POSSIBLE.

16. CONTRACTOR SHALL INSTALL ALL PRODUCTS AND ASSEMBLIES PER MANUFACTURER'S RECOMMENDED INSTALLATION.

17. ALL EXTERIOR SYSTEMS SHALL BE INSTALLED TO ASSURE ADEQUATE DRAINAGE IS PROVIDED.


18. TEMP GLZ = PROVIDE TEMPERED SAFETY GLASS AT ALL REQUIRED LOCATIONS AS REQUIRED BY CODE.



RIVENDALE HOMES TEXAS, LLC

1114 LOST CREEK BLVD. SUITE 200 AUSTIN, TX 78746 T 512-900-8797 WWW.RIVENDALEHOMESTEXAS.COM

© RIVENDALE HOMES TEXAS, LLC

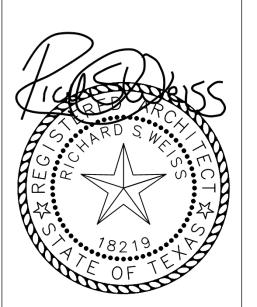

SESIDENCE SIVENDALE HOMES

REVISIONS

STAMP:

CURRENT ISSUE:
SET DATE
CHECK SET 03.04.22

PROJECT NO: ---
SCALE 1/4" = 1'-0"

DRAWING TITLE

BUILDING ELEVATIONS

SHEET NUMBER

A3.3