MAUFRAIS GARAGE/ ADU

906 MAUFRAIS ST AUSTIN, TX 78703

PERMIT SET | APRIL 06, 2022

DESIGNTRAIT ARCHITECTS

PROJECT LOCATION | PROXIMITY MAP



PROJECT DATA

9,149 SQ FT 41% (3,758 SQ FT) 40% (3,618 SQ FT) 1ST FLOOR: 2.138 SQ FT 2ND FLOOR:

ADU NEW AIR CONDITIONED AREA TOTAL: 550 SQ FT 2ND FLOOR: 550 SQ FT


EXISTING COVERED AREAS
FRONT PORCH: 118 SQ FT REAR PATIO: 200 SQ FT

MAIN CARPORT: 207 SQ FT ADU GARAGE: 528 SQ FT


DRIVEWAY
MAIN STRIPS: 187 SQ FT ADU STRIPS: 93 SQ FT

ARCHITECTURAL SYMBOLS

DRAWING NUMBER

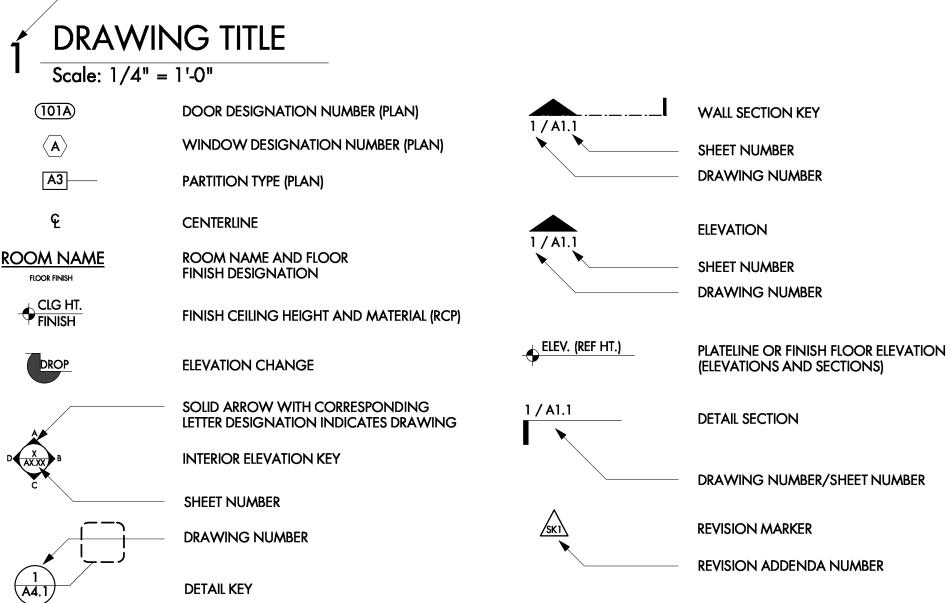

GRAPHIC LEGEND

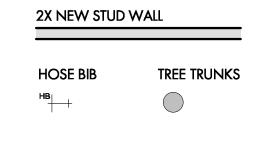

NOTES:

- FOR INTERIOR WALL FINISHES REVIEW INTERIOR ELEVATIONS

SHEET NUMBER

- FOR EXTERIOR WALL FINSH- SEE EXTERIOR ELEVATIONS
- VERIFY ALL DIMENSIONS IN FIELD

GENERAL NOTES

- 1. CONTRACTOR TO COORDINATE STAGING AREAS
- 2. ALL PROPOSALS SHALL TAKE INTO CONSIDERATION ALL SITE CONDITIONS AFFECTING WORK UNDER THIS CONTRACT.
- THE DRAWINGS , SPECIFICATIONS , AND IDEAS CONTAINED HEREIN ARE THE INTELLECTUAL AND MATERIAL PROPERTY OF THE ARCHITECT , AND SHALL NOT BE RE-USED. REPRODUCED. OR ALTERED WITHOUT THE EXPRESS WRITTEN PERMISSION OF THE ARCHITECT. FAILURE TO OBTAIN PERMISSION VIOLATES UNITED STATES COPYRIGHT LAWS AND SUBJECTS THE VIOLATOR TO LEGAL PROSECUTION
- 5. THE CONTRACTOR SHALL BE RESPONSIBLE FOR CONSTRUCTING THE PROJECT IN ACCORDANCE WITH ALL PROVISIONS OF APPLICABLE CODES AND ORDINANCES. WORKMANSHIP AND MATERIALS TO BE OF THE HIGHEST INDUSTRY STANDARDS.
- THE PLANS AND SPECIFICATIONS HAVE BEEN DEVELOPED WITH THE INTENT OF MEETING OF EXCEEDING THE MINIMUM REQUIRED STANDARDS. SHOULD THE PLANS AND SPECIFICATIONS DISAGREE WITH THEMSELVES , THE GREATER QUALITY OR GREATER QUANTITY SHALL BE PERFORMED OR
- 7. NOTICE TO ALL SUBCONTRACTORS: IT IS YOUR RESPONSIBILITY TO BID YOUR SCOPE OF WORK USING THE COMPLETE SET OF PLANS AND SPECIFICATIONS. THE FACT THAT SOMETHING WAS NOT INDICATED ON YOUR PORTION OF THE DRAWINGS WILL NOT BE ACCEPTABLE AS A REASON FOR AN EXTRA, IF IT CAN BE FOUND ELSEWHERE IN THE DRAWINGS OR SPECIFICATIONS.
- THE CONTRACTOR MUST VERIFY ALL EXISTING CONDITIONS, ITEMS AND NOTIFY THE ARCHITECT OF ANY DISCREPANCIES
- EACH PRIME CONTRACTOR SHALL REPLACE AND/OR RESTORE ALL MATERIALS STORED OR INSTALLED ON THE SITE SHALL BE SUBJECT TO DAMAGE OR
- CONTRACT WORK, INCLUDING JOB SITE TELEPHONE. MAKE ALL TEMPORARY CONNECTIONS TO EXISTING UTILITIES IN LOCATIONS ACCEPTABLE TO LOCAL AUTHORITIES HAVING JURISDICTION THEREOF. PAY ALL COSTS FOR TEMPORARY ELECTRICAL POWER, WATER AND HEATING.
- 11. PROVIDE FIRST AID AND FIRE PROTECTION AS REQUIRED BY OSHA
- 12. A COMPLETE SET OF AS-BUILTS SHALL BE FURNISHED TO THE ARCHITECT AT COMPLETION OF THE PROJECT. THE CLOSE OUT PACKAGE IN A FORM OF A HARD BINDER, INDEXED, LABELED AND DIVIDERS FOR THE CLIENT INCLUDES COPIES OF PERMITS AND THE CERTIFICATE OF OCCUPANCY, A LIST OF SUB-CONTRACTOR AND PHONE NUMBERS, ALL WARRANTIES AND MANUALS, ETC. LIST OF PAINT TYPES AND FORMULAS. ONE COPY SHOULD GO DIRECTLY TO THE OWNER. PROVIDE PAINT COLORS AND FORMULAS OF ALL PAINTS
- 13. GENERAL CONTRACTOR AND SUB-CONTRACTOR ARE TO BID THIS PROJECT AS DESIGNED. VALUE ENGINEERING IS WELCOMED IN AN EFFORT TO GET THE BEST VALUE. GENERAL CONTRACTOR SHALL SUBMIT HIS BID PER PLANS AND SPECIFICATIONS AND SUBMIT VALUE ENGINEERING ITEMS SEPARATELY.
- 14. ALL WORK DESCRIBED BY THESE DOCUMENTS SHALL BE IN FULL COMPLIANCE WITH ALL APPLICABLE CODES AS MANDATED BY ALL GOVERNING
- 15. CONSTRUCTION DRAWINGS AND DOCUMENTS ARE GENERAL IN NATURE AND DO NOT INCLUDE OR ANTICIPATE EVERY CONDITION POSSIBLE. CONTRACTOR & SUBCONTRACTORS SHALL REVIEW THE CONSTRUCTION DRAWINGS THOROUGHLY AND MAKE A DETAILED SITE VISIT TO REVIEW EXISTING FIELD CONDITIONS . ANY INCONSISTENCY , DISCREPANCY , AMBIGUITY , OR ANY OTHER QUESTIONS SHALL BE IMMEDIATELY REPORTED TO THE ARCHITECT AND/OR OWNER FOR CLARIFICATION AND RESOLUTION PRIOR TO THE DELIVERY OF ANY BID AND PRIOR TO PROCEEDING WITH THE WORK IN QUESTION AND/OR OTHER RELATED WORK, FAILURE TO DO SO SHALL CAUSE THE CONTRACTOR TO BE INELIGIBLE FOR EXTRAS RELATING TO SUCH MATTERS AND SHALL RELIEVE THE ARCHITECT FROM ANY CONSEQUENCES THEREBY ARISING.
- 16. CONTRACTOR IS RESPONSIBLE FOR ALL FEES AND PERMITS REQUIRED FOR CONSTRUCTION .
- 17. ALL DESIGN OF STRUCTURAL COMPONENTS INCLUDING THE FOUNDATION, BEAMS, POSTS, STRUCTURAL FRAMING, CONNECTORS, AND FASTENERS ARE NOT IN THE ARCHITECT'S SCOPE AND MUST BE PROVIDED BY OTHERS PRIOR TO CONSTRUCTION .
- 18. THE CONTRACTOR SHALL PROVIDE ALL LABOR, MATERIALS, EQUIPMENT AND SERVICES NECESSARY TO COMPLETE THE WORK, ALL OF WHICH SHALL BE PROVIDED IN FULL ACCORDANCE WITH AND REASONABLY INFERABLE FROM THE CONTRACT DOCUMENTS AS BEING NECESSARY TO PRODUCE THE
- 19. DRAWINGS AND NOTES TO DRAWINGS, INCLUDING THOSE OF THE ENGINEER OR CONSULTANT, ARE CORRELATIVE AND HAVE EQUAL AUTHORITY AND PRIORITY. SHOULD THERE BE DISCREPANCIES IN THEMSELVES OR BETWEEN THEM, CONTRACTOR SHALL BASE BID PRICING ON THE MOST EXPENSIVE COMBINATION OF QUALITY AND/OR QUANTITY OF THE WORK INDICATED. IN THE EVENT OF DISCREPANCIES, THE APPROPRIATE INTENT AND/OR ITEMS TO BE INCORPORATED INTO THE SCOPE OF THE WORK SHALL BE DETERMINED BY THE ARCHITECT OR ENGINEER .
- 20. WRITTEN DIMENSIONS SHALL GOVERN THESE DRAWINGS . THESE DRAWINGS ARE NOT TO BE SCALED .
- 21. CONTRACTOR IS SOLELY RESPONSIBLE FOR THE SAFETY, ACTIONS, AND CONDUCT OF HIS EMPLOYEES AND HIS SUBCONTRACTOR'S EMPLOYEES WHILE IN THE PROJECT AREA, ADJACENT AREAS AND IN THE BUILDING AND ITS VICINITY.
- 22. CONTRACTOR SHALL COORDINATE WITH ALL TRADES AND SUBCONTRACTORS TO PROVIDE COMPLETE WORKING SYSTEMS THROUGHOUT PROJECT.
- 23. CONTRACTOR TO SUBMIT ALL REQUIRED SHOP DRAWINGS TO ARCHITECT AND/OR OWNER BEFORE PROCEEDING WITH THE WORK RELATED TO THE

24. ALL WORK NOTED "BY OTHERS" OR "NOT IN CONTRACT" IS TO BE ACCOMPLISHED BY A CONTRACTOR OTHER THAN THE GENERAL CONTRACTOR

- AND IS NOT TO BE A PART OF THE CONSTRUCTION AGREEMENT. THE GENERAL CONTRACTOR IS TO COORDINATE WITH OTHER CONTRACTORS AS REQUIRED AND SHALL PROVIDE ACCESS TO THE PROJECT AS NEEDED.
- 25. PRIOR TO THE START OF CONSTRUCTION, CONTRACTOR SHALL FURNISH THE ARCHITECT AND/OR OWNER A SCHEDULE OF VALUES THAT INCLUDES A DETAILED LIST OF ENTIRE SCOPE OF WORK AND THE MATERIAL QUANTITIES INVOLVED IN THE PROJECT AND THEIR RESPECTIVE CONTRACT DOLLAR AMOUNTS, INCLUDING A SEPARATE COLUMN FOR SALES TAX.
- 26. CONTRACTOR SHALL FURNISH THE ARCHITECT AND/OR OWNER A PUNCH LIST INCLUDING ALL THE ITEMS TO BE COMPLETED PRIOR TO THE PROJECT'S SUBSTANTIAL COMPLETION . ARCHITECT AND/OR OWNER SHALL REVIEW CONTRACTOR'S PUNCH LIST AND PROVIDE ADDITIONAL ITEMS TO BE INCLUDED
- 27. ALL MATERIALS, FINISHES, MANUFACTURED ITEMS, AND EQUIPMENT SHALL BE INSTALLED IN FULL ACCORDANCE WITH THE SUPPLIER'S OR MANUFACTURER'S WRITTEN RECOMMENDATIONS OR CODE OR THESE DOCUMENTS, WHICHEVER IS MORE STRINGENT.
- 28. ALL DIMENSIONS, NOTES, FINISHES, AND FIXTURES SHOWN ON TYPICAL DRAWINGS SHALL APPLY TO ALL SIMILAR, SYMMETRICAL, OR OPPOSITE HAND
- 29. STORE AND HANDLE ALL MATERIALS IN STRICT COMPLIANCE WITH MANUFACTURER'S INSTRUCTIONS AND RECOMMENDATIONS. PROTECT ALL MATERIALS FROM DAMAGE, WEATHER, EXCESSIVE TEMPERATURES, AND CONSTRUCTION OPERATIONS.
- 30. REQUESTS TO SUBSTITUTE ANY PRODUCT OR MATERIAL SHALL BE SUBMITTED IN WRITING TO THE ARCHITECT AND/OR OWNER FOR APPROVAL. SAMPLES, PRODUCT INFORMATION, AND DRAWINGS SHALL BE REQUIRED PRIOR TO SUBSTITUTION APPROVAL. PROPOSED SUBSTITUTION SHALL BE OF EQUAL QUALITY AND PERFORMANCE SPECIFICATION TO THAT ORIGINALLY SPECIFIED.
- 31. CONTRACTOR SHALL REVIEW ALLOWANCES AND NOTIFY THE ARCHITECT AND/OR OWNER OF AMOUNTS THAT SEEM INSUFFICIENT OR NOT ACCURATE. ALLOWANCE AMOUNTS INCLUDE ONLY THE COST OF MATERIAL, DELIVERY, AND SALES TAX.
- 32. ALL WORKMANSHIP, MATERIAL, AND EQUIPMENT SHALL BE GUARANTEED FOR THE GREATER OF THE MANUFACTURER'S WARRANTY OR ONE YEAR FROM DATE OF OWNER ACCEPTANCE . ANY FAILURE OR DETERIORATION WITHIN THIS PERIOD SHALL BE CORRECTED BY THE CONTRACTOR AT THE
- 33. CONTRACTOR SHALL EXERCISE REASONABLE PRECAUTION IN THE PROTECTION OF THE OWNER'S PROPERTY, SITE VEGETATION, AND ALL TREES THAT
- 34. CONTRACTOR SHALL BE RESPONSIBLE ON A DAILY BASIS FOR SITE CLEAN UP AND REMOVAL OF ANY AND ALL DEBRIS GENERATED BY CONSTRUCTION OPERATIONS, MAKING READY FOR ALL SUBSEQUENT SUBCONTRACTORS.
- 35. PROVIDE CONSTRUCTION WASTE MANAGEMENT INCLUDING THE SEPARATION OF REUSABLE OR RECYCLABLE MATERIALS INTO SEPARATE CONTAINERS .

PROJECT DESCRIPTION

LEVEL STUDIÓ, AND ROOF DECK. IT WILL BE CONSTRUCTED ON A LOT WITH AN EXISTING SINGLE FAMILY RESIDENCE THAT IS REGISTERED IN THE NATIONAL REGISTER OF HISTORIC DISTRICTS.

ASSOCIATED PERMITS & DOCUMENTS

CLIENT	
WM CAPITAL PARTNERS	
100 CONGRESS AVE, STE 1.	51
ALIOTIN I TV	

ARCHITECT CONTACT: BECKY JEANES 2525 SOUTH LAMAR STE #9 AUSTIN, TX 78704 PH: (512) 542-0073 E-MAIL: BÉCKY@DESIGNTRAIT.COM

STRUCTURAL ENGINEER AMO STRUCTURAL ENGINEERING CONTACT: ALEX OLIVAS

CONTACT: JARROD ACRES PH: (737) 202-0435 1250 SOUTH CAPITAL OF TEXAS HIGHWAY E-MAIL: JARRODACRES@GMAILCOM BLDG. 3 | SUITE 400 | AUSTIN, TX | 78746 PH: (432) 894-5744

DRAWING INDEX

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- AO.1 SURVEY
- A1.0 PLOT PLAN
- A1.2 REFLECTED CEILING PLAN
- A2.0 EXTERIOR ELEVATIONS A2.1 EXTERIOR ELEVATIONS
- A6.0 INTERIOR ELEVATIONS
- A7.0 DOOR & WINDOW SCHEDULES

S001	FOUNDATION PLAN
\$102	FOUNDATION DETAILS
S201	LEVEL 1 HEADERS PLAN
S202	LEVEL 1 CEILING FRAMING PLAN
S203	LEVLE 2 HEADERS PLAN
S204	ROOF (LEVEL 2 CEILING) FRAMING PL
S205	LEVEL 1 WIND BRACING
S206	LEVEL 1 WIND BRACING
S301	WIND BRACING DETAILS
S302	WIND BRACING DETAILS
S303	STAIR FRAMING PLAN
S304	STAIR FRAMING ELEVATIONS
S305	STAIR FRAMING DETAILS

A NEW ADU, SECONDARY DELLING UNIT, WITH A TWO CAR GARAGE, SECOND

Demo Permit: City of Austin 2019-067026 BP Building Permit: Clity of Austin 2020-038722 BP

PROJECT TEAM

CLIENT
WM CAPITAL PARTNERS
100 CONGRESS AVE, STE 1510
AUSTIN. TX

CONTRACTOR

E-MAIL: AOLIVAS@AMO-SE.COM


- A1.1 FLOOR PLAN GARAGE/STUDIO
- A3.0 BUILDING SECTIONS

A7.1 FINISH, PLUMBING, & APPLIANCE SCHEDLUES


STRUCTURAL

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S306	STAIR FRAMING DETAILS
S307	TYPICAL STRUCTURAL CONNECTORS

TYPICAL FRAMING DETAILS

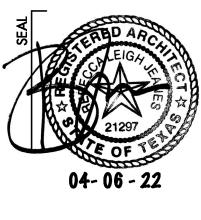

COVER

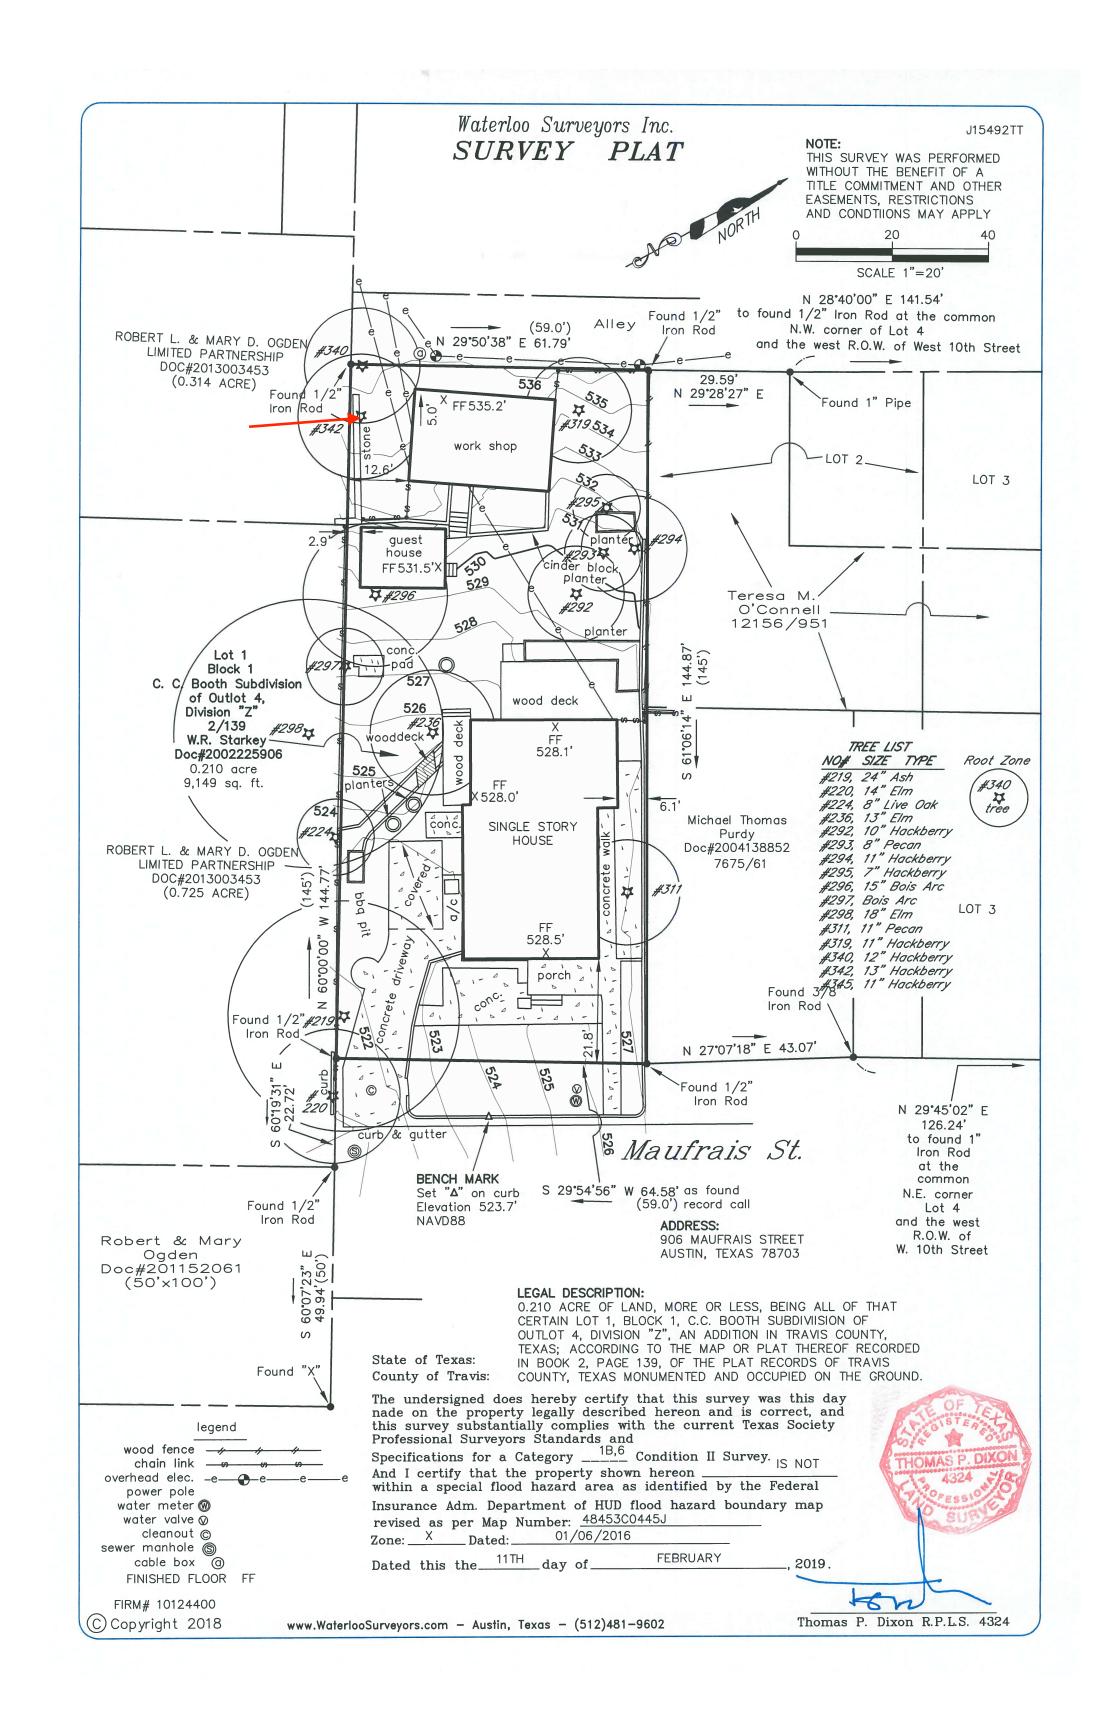


Maufrais Garage/ ADU
906 Maufrais St

SET ISSUE DRAWN BY

06 April 2022 Permit Set mp, bn, ch

SURVEY

ΔO 1

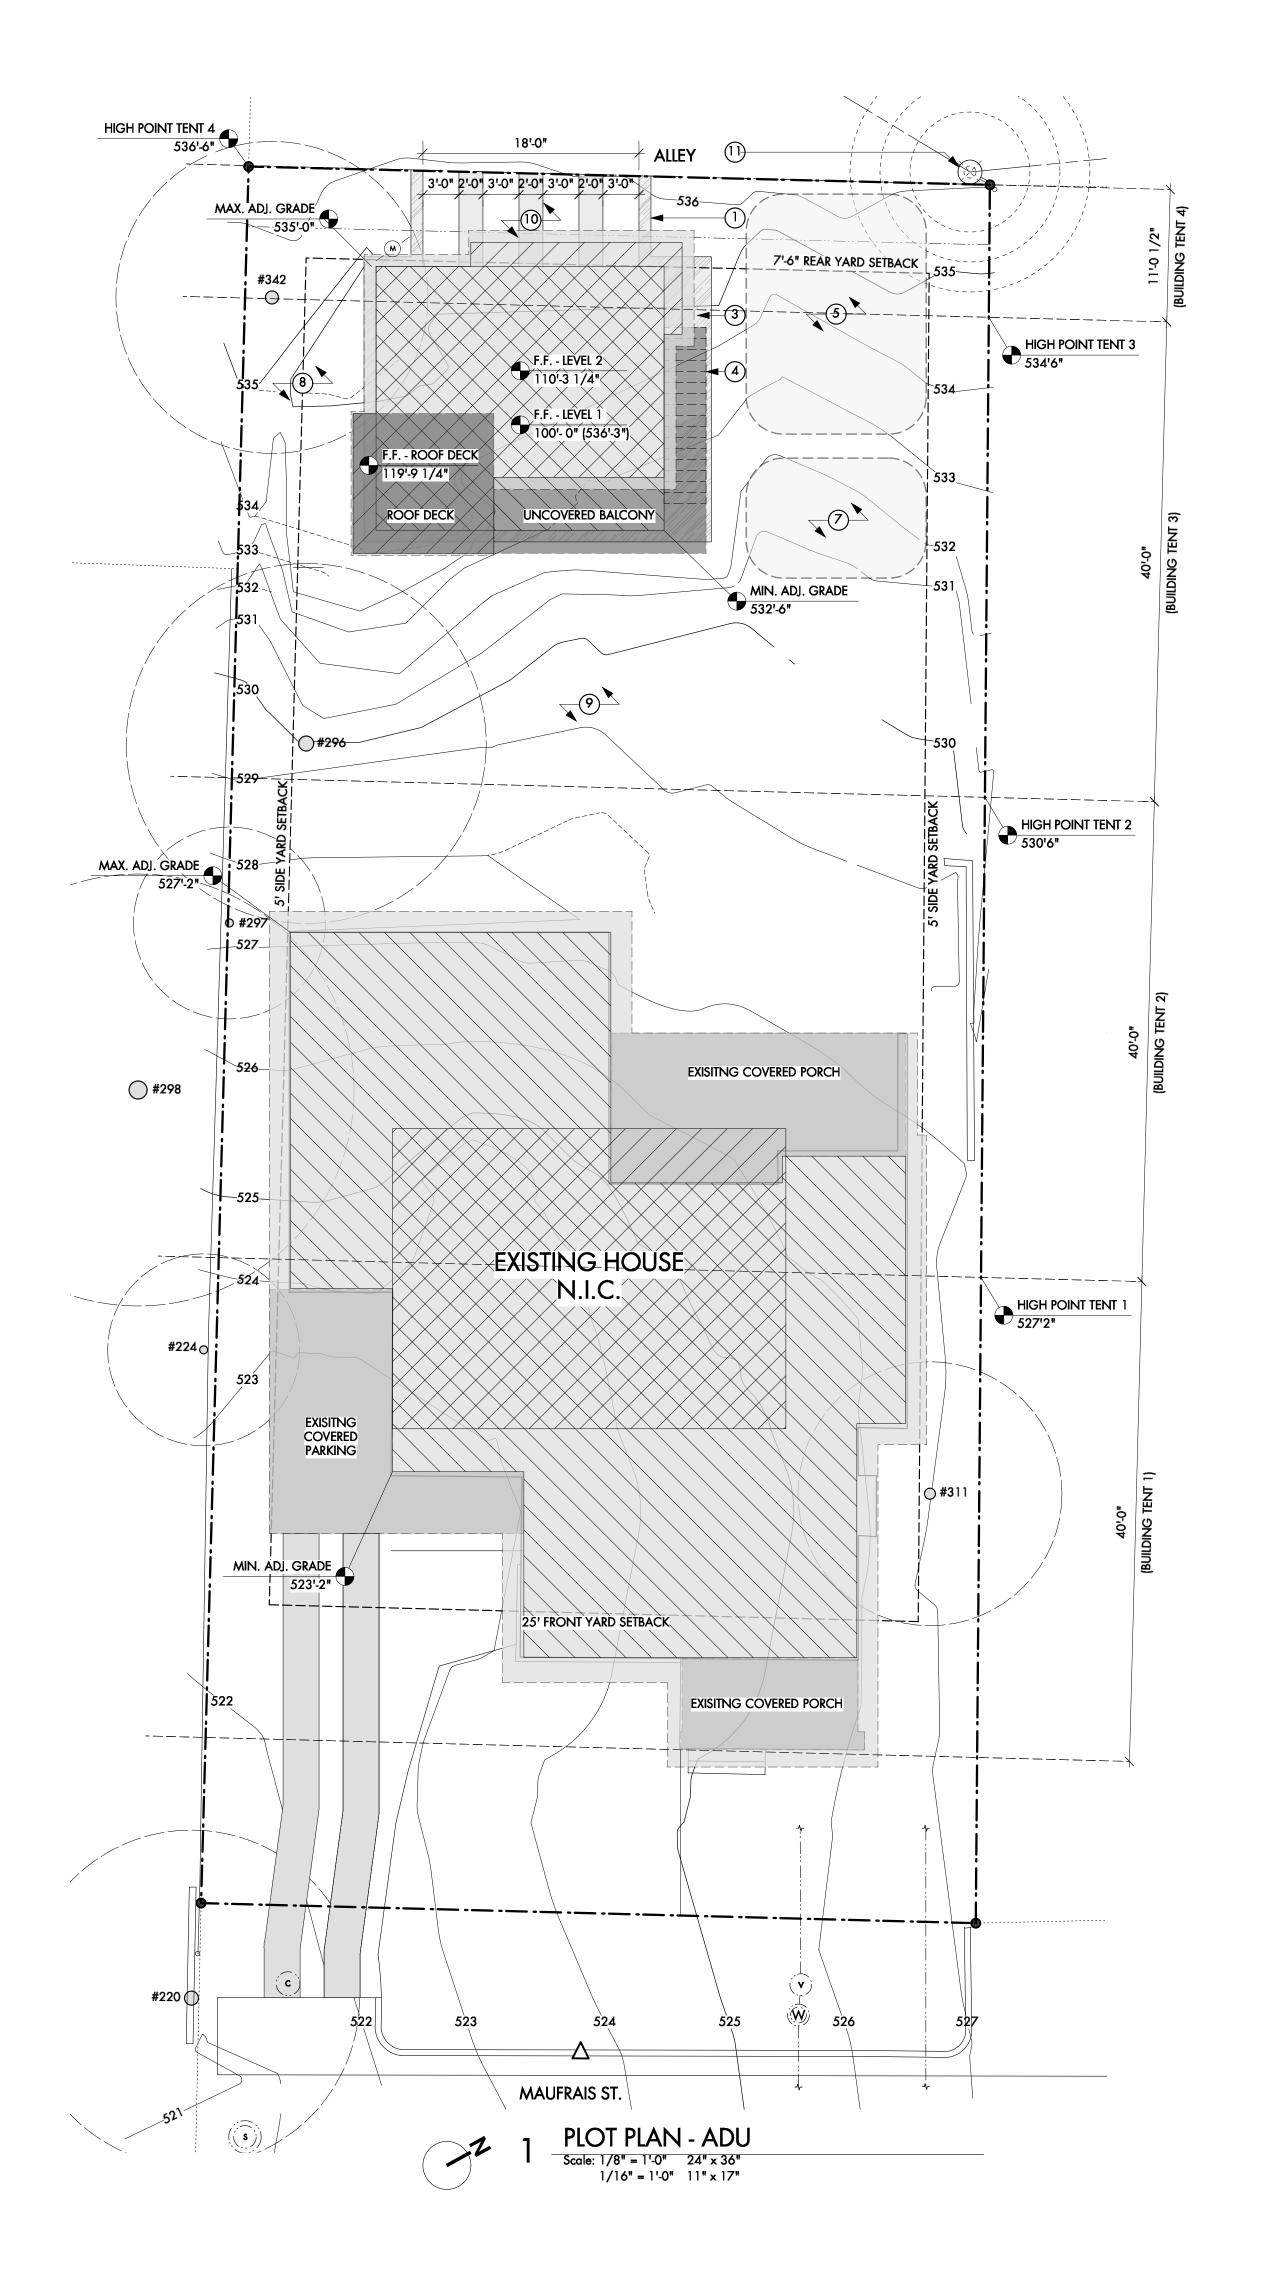

GENERAL NOTES | ARCHITECTURAL SITE PLAN

- 1. Do not scale the drawings. If a specific dimension is not given, contact designtrait for
- clarification.

 2. Keynotes located on this sheet are for this sheet only.

- Xeynotes located on this sheet are for this sheet only.
 Tree locations are approximate.
 The design illustrated in these documents is furnished by the architect under a limited scope services agreement with the Owner and are therefore provided as a "builder's set" for general intent only. All products and the detailing of their installation, including flashing, underlayments, and weather resistive barriors, should be installed in strict compliance with manufacturer's recommendations and in compliance with all applicable codes as mandated by all governing jurisdictions.
 Tree protection must remain in place through the landscaping and sprinklers need to be placed to stay out of the 1/4 CRZ with a preferred drip system in the 1/2 / full CRZ if possible.
 Tree protection fencing is required for all trees within the limits of construction. Fencing should be indicated to protect the entire Critical Root Zone (CRZ) area or as much of the CRZ as is practical. Fencing is required to be chain-link mesh at a minimum height of five feet. When the tree protection fencing cannot incorporate the entire 1/2 Critical Root Zone, an eight inch layer of mulch within the entire available root zone area is required for all trees which have any disturbance indicated within any portion of the Critical Root Zone.
 Foot traffic is considered a root zone disturbance, as well. 2x4 or greater size planks (6' tall minimum) are required to be strapped securely around protected trees trunks and root flares when protective fencing does not incorporate the entire 1/2 CRZ for any reason at any time in the project.

- and root flares when protective fencing does not incorporate the entire 1/2 CRZ for any reason at any time in the project.
 8. Protect trees on site as required in the Environmental Criteria Manual section 3.5.2. Do not cut or fill greater than 4" in the 1/2 CRZ of protected trees. No impact allowed within the 1/4 CRZ of protected trees.
 9. Avoid the 1/2 Critical Root Zones of Protected Trees with any newly proposed work. If trenching within the 1/2 CRZ of Protected Trees cannot be avoided, the trenches will have to be air spaded by a Certified Arborist for the 30" to avoid damaging roots 1.5"+ in diameter and the paid receipt for the work will be required by the Final Tree Inspector.
 10.GC to coordinate and locate utilities contact Designate the location area.
- 10.GC to coordinate and locate utilities, contact Designtrait for location approval.
 11.Fire, gas and water service lanes to be coordinated with general contractor based on
- site conditions.

 12.8" layer of mulch within the entire available root zone are is required for all trees which have disturbance indicated within any portion of the Critical Root Zone.

ARCHITECTURAL SITE PLAN LEGEND

AC	A/C UNIT	— OE — UTILITY LINE
G	GAS METER	— // WOOD FENCE
Ø	UTILITY POLE	— W — WATER LINE
M	ELECETRIC METER	—SEWER— SEWER
	STAGING AREA	

KEY NOTES | ARCHITECTURAL SITE PLAN

- Metal edging.
 Existing water meter.
 Gravel or crushed granite.
 New ADU stair.
- Proposed material staging area. Dumpster and spoils placement cannot be located within the 1/2 CRZ of any protected trees. Use existing driveway as an


- Area designated for portable toilet and concrete washout. Cannot be within the full CRZ of any protected tree.
 Swale to divert drainage. GC to field verify location.
 Landscape terraced gravel or crushed grainte filled steps w/ metal edging.
 Concrete driveway paths w/ gravel or crushed granite between.
 Pole mounted electrical meter w/ underground feed to A & B units. GC to verify location.

CONCRETE FOUNDATION NOTES:

•Concrete line pump: Wrap connections of concrete line pump with plastic to prevent concrete slurry from leaching into ground and near roots of trees.

•Concrete truck: If heavy equipment of any kind will be rolling over any area of the full CRZ of protected trees, provide 3/4" plywood over 2x4 lumber over 12" layer of mulch to bridge over the roots and prevent soil/root compaction. After construction is completed, spread mulch around site to leave a max layer of 3" within root zones.

TREE	LEGEND	NOTE	KEY P	LOT PLAN
#219	24" Ash	Removed		
#220	14" Elm			FIRST FLOOR
#224	8" Live Oak			
#236	13" Elm	Demo		SECOND FLOOR
#292	10" Hackberry	Removed		SECOND FLOOR
#293	8" Pecan	Removed		
#294	11" Hackberry	Removed		ROOF
#295	7" Hackberry	Removed		
#296	15" Bois Arc			COVERED BATIO
#297	Bois Arc		i	COVERED PATIO
#298	18" Elm			
#311	11" Pecan			STAGING AREA
#319	11" Hackberry	Removed		
#340	12" Hackberry		V/71 TT/1	DROTECTED AREA
#342	13" Hackberry		<u> </u>	PROTECTED AREA
#345	11" Hackberry		7/77/77/7	

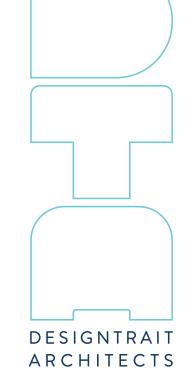





darage/ Maufrais

SHEET TITLE

PLOT PLAN

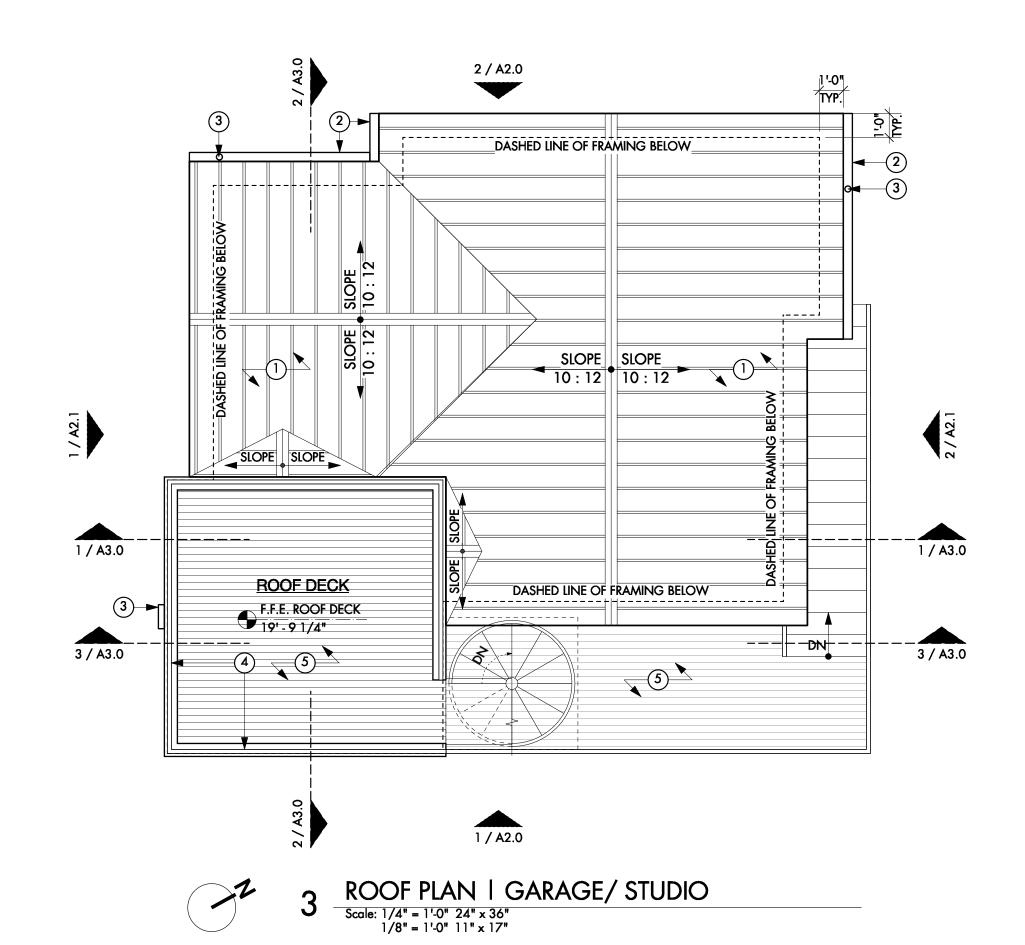

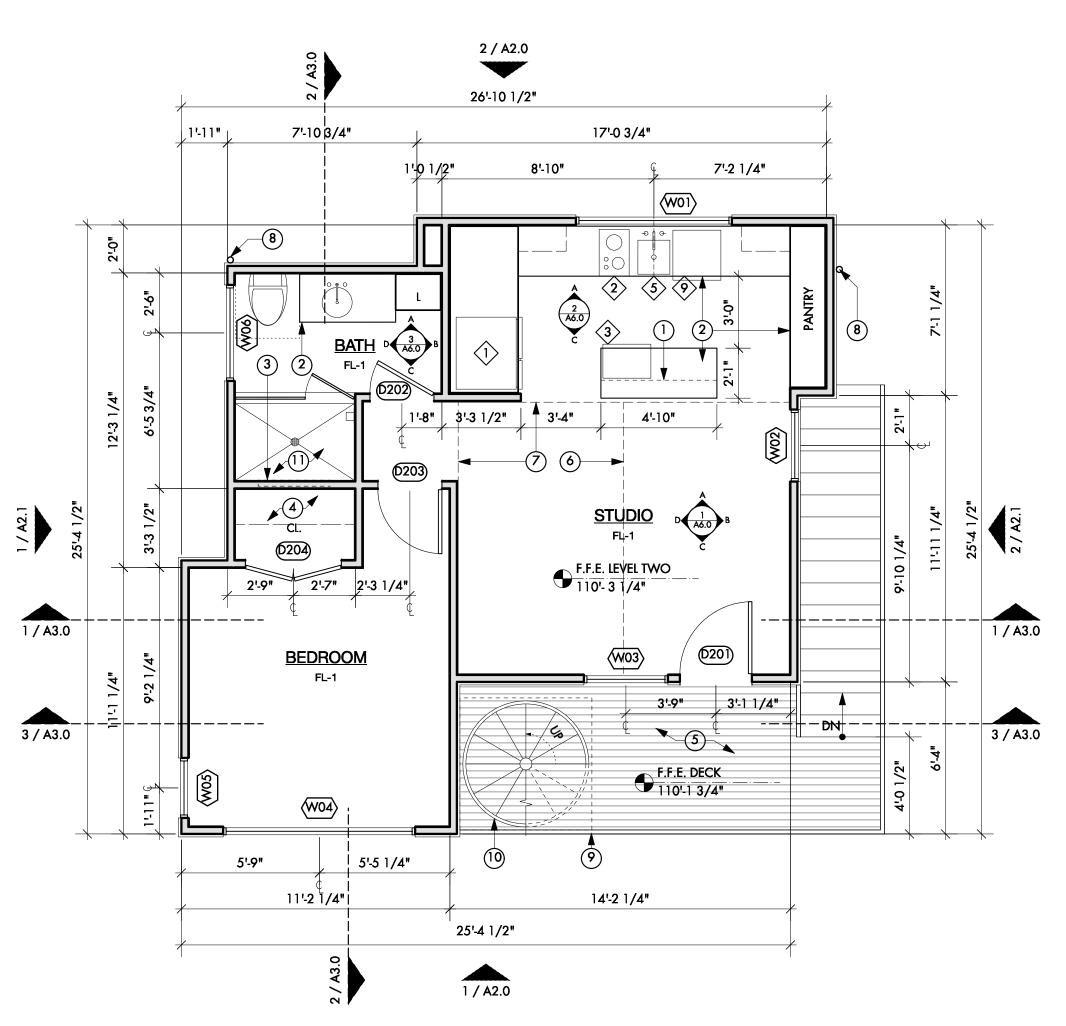

FLOOR PLAN LEVEL 2 | GARAGE/ STUDIO

Scale: 1/4" = 1'-0" 24" x 36"
1/8" = 1'-0" 11" x 17"


GENERAL NOTES | PLAN

- Keynotes located on this sheet are for this sheet only.
 Do not scale the drawings. If a specific dimension is not given, contact Designtrait for clarification.
- 3. Dimensions are to face of frame or centerline of frame as noted. 4. Contractor shall exercise reasonable precaution in the protection of all existing finishes to remain and/or all existing substrates to receive new finish; Contractor shall: provide protective coverings and impact protection for all floor, partition, ceiling, window, glass, and all other existing finishes in the project area and for all finishes which may be subject to traffic or construction activity in adjacent areas; extend protection from hardeling acts (fine) to exist the project. building entry(ies) to project area(s).
- Contractor shall walk project site with Architect and Owner to review extent of demolition and identify any additional components that need to be removed in order to provide proposed new construction or that the Owner wishes to be removed as part of the scope of project.
- Existing walls might carry or transfer roof and/or ceiling loads. Consult with a qualified structural engineer
 to verify load bearing status of all existing walls prior to any demolition work. Provide transfer beams or
 alternate structure if neccesary. Provide temporary shoring where required.
- 7. Repair all finishes and materials that occur from the removal or demolition procedure. 8. The Contractor shall remove from demolished walls or portions of walls all power circuits and switch legs back to first junction box. Remove any millwork or wall-mounted fixtures from walls indicated to be demolished and not otherwise shown. Any building fixtures removed from the Project and not disposed of shall be salvaged as directed by the Owner's representative. The Contractor shall take care not to unreasonably cause damage to the building fixtures. 9. Provide tempered glazing as required by local codes.
- 10. Provide submittals and shop drawings showing number of windows, locations of tempered glazing, etc.
 11. Window and door types indicate rough sizes only. GC shall field verify the appropriate glazing and leaf sizes in the field prior to ordering. For any questions contact Designtrait.
- 12. GC responsible for removing any temporary infill panels at all window locations.


 13. Verify final finishes with owner.

KEYNOTES | PLANS (#)

- Dashed line of wall below.
 Pre manufactured millwork. Verify dimension with owner.
 Tiled shower niche, refer to interior elevations.
- 4. Closet finish out provided by owner.
- Pressure treated and sealed wood decking. . Dashed line of sloped ceiling above.
- Dashed line of ceiling transition above.
 Downspout. Dump into area drain and daylight down grade.
 Guardrail.
- 10. Spiral stair to roof deck above.11. Kerdi-Shower-Kit, refer to plumbing scheulde, P9.

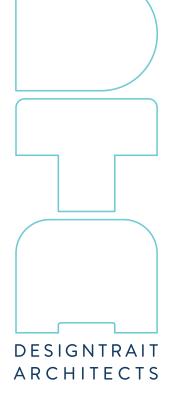



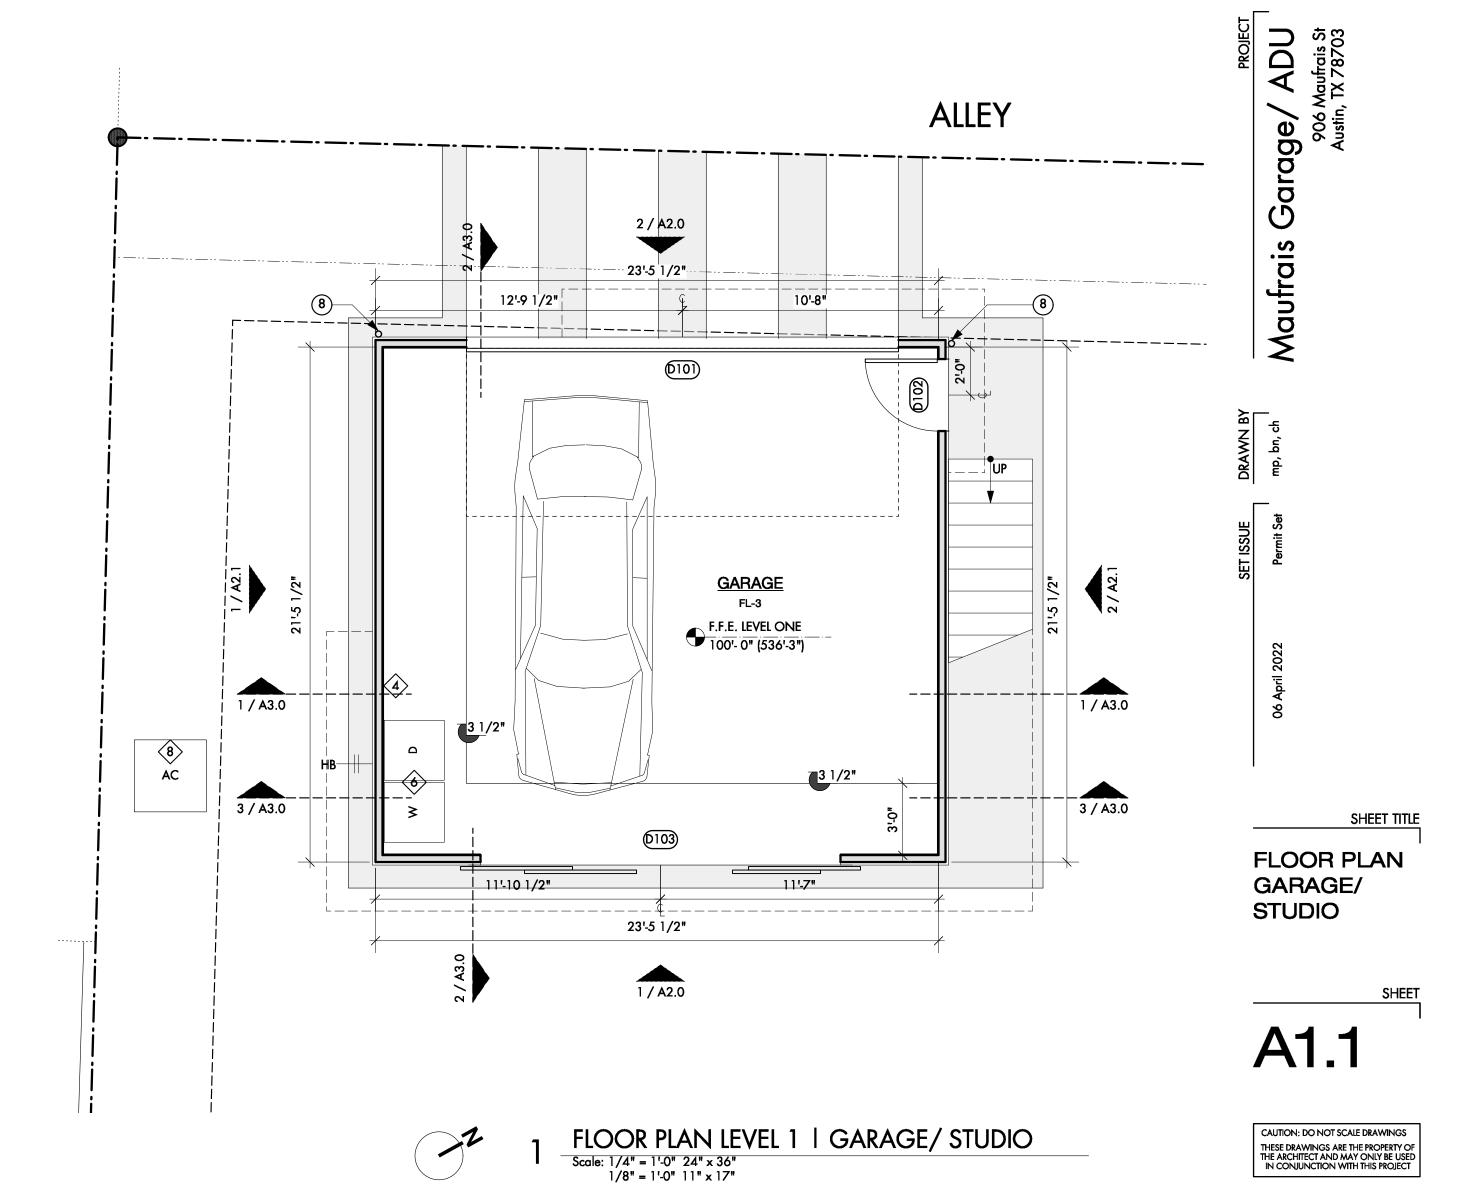

	ELECTRICAL LEGEND		
MATERIAL HT. A.F.F re (HT. A.F.F c	CEILING HEIGHT AND MATERIAL CALL OUT potential courses over all in the control of the course of the		DISPOSAL
⇔ ⇔	DUPLEX CEILING RECEPTACLE DUPLEX RECEPTACLE	(S) (D)	RECESSED CEILING EXHAUST FAN AND/OR LIGH SMOKE, HEAT OR IONIZATION DETECTOR
ြာ	UNDER-COUNTER RECEPTACLE	T	THERMOSTAT
GFI APP	APPLIANCE RECEPTACLE GROUND FAULT INTERRUPTER		SURFACE MOUNTED PANELBOARD ELECTRICAL METER
<u>କିନ୍ଦି</u> ନ	GROUND FAULT INTERRUPTER IN CABINET		SLOT DIFUSSER
	WATER PROOF RECEPTACLE UNDER-COUNTER WATER PROOF RECEPTACLE	<u> </u>	SLOT RETURN
220	220 VOLT RECEPTACLE DUPLEX FLOOR RECEPTACLE	A	CEILING SUPPLY
- 0	SWITCH-SINGLE		TELEPHONE OUTLET
	SWITCH W/DIMMER	-	DATA OUTLET
	SURFACE MOUNTED FIXTURE	2	TELEVISION OUTLET
\Leftrightarrow	PENDANT	$\langle \rangle$	
\Diamond	WALL SCONCE		CEILING FAN
	CONTINUOS LINEAR LIGHTING	$\langle \rangle$	

KEY NOTES | RCP (X)


- 1. Verify location w/ Owner.
- 2. Electrical panel
- 3. Stucco finish.
- 4. Floor outlet recessed, flush w/ decking.

LIC	GHTING FIXTURE SCHEDULE					
ID	TYPE	LOCATION	MANUF.	MODEL	LAMP	REMARKS
Α	3" RECESSED CAN	VARIES	-	-	LED	DIMMABLE
В	RECESSED 3" LIGHT FIXTURE WALL WASHER	LIVING	-	-	LED	DIMMABLE
С	RECESSED 3" LIGHT FIXTURE WET LOC.	BATHROOM			LED	DIMMABLE
D	WALL SCONCE	BATHROOM	-	-	LED	CENTER ON SINK, REFER TO INT. ELEVATIONS. VERIFY W/ OWNER.
E	SURFACE MOUNTED FIXTURE	GARAGE	-	-	LED	VERIFY LOCATION AND TYPE W/ OWNER
F	EXHAUSTFAN	BATHROOM	-	-	LED	USE W/ HUMIDITY SENSOR SWITCH
G	WALL SCONCE	EXTERIOR	-	-	LED	VERIFY LOCATION AND TYPE W/ OWNER
Н	LINEAR STRIP	UPPER CABINETS	-	-	LED	DIMMABLE
I	CEILING FAN	VARIES	-	-	LED	DIMMABLE


RCP/ELECT. NOTES

- 1. SCHEDULE WALK THRU & VERIFY LOCATIONS OF ALL ELECT. FIXTURE, OUTLET, PANEL, CABLE DATA, SMOKE DETECTORS, SWITCHES, ETC. W/OWNER & ARCH. IN FIELD FOR FINAL
- 2. ALL FIXTURES TO BE ALIGNED & SPACED AS SHOWN, PLAN FRAMING AS REQ'D.
- 3. ALL SWITCH PLATES & WALL PLATES TO BE SELECTED BY OWNER & ARCH.
- 4. ALL SWITCHES, EXCEPT IN MECH. AREAS TO BE DIMMABLE
- 5. ALL CEILING/WALL MOUNTED EQUIPMENT INCLUDING FIXTURE TRIMS, NON-DECORATIVE MECH. GRILLES, EXHAUST FANS, SPEAKER COVERS, SMOKE DETECTORS, ETC. TO BE PAINTED TO MATCH ADJ. SURFACE FINISH UNLESS NOTED OTHERWISE, CONSULT W/ARCH. PRIOR TO WORK
- 6. ALL SWITCH PLATES TO BE MOUNTED AT 48" A.F.F. U.N.O.
- 7. SCH. WALK THRU WITH MECH. SUB/ARCH & OWNER TO VERIFY AIR SUPPLY &AIR RETURN LOC.
- 8. ALL ELECT. WALL MOUNTED OUTLETS TO BE MOUNTED ON BASE BOARD U.N.O. PLATES TO MATCH BASE BOARD. ALL ELECT. FLOOR MOUNTED OUTLETS TO HAVE STL. PLATE COVER. INSTALL FLUSH W/F.F.
- 9. LIGHT BEAM PATTERN OF EACH LAMP IS TO BE DETERMINED BY THE ARCH.
- 10. FOR PRODUCTS ALTERNATES CONTRACTOR & SUBS SHALL PROVIDE CUT SHEETS FOR ARCH. APPROVAL PRIOR TO PURCHASE
- 11. PROVIDE CUT SHEETS FOR ALL AIR SUPPLY & AIR RETURN GRILLS, LINEAR DIFFUSERS &
- 12. CONTRACTOR SHALL PROVIDE APPROPRIATE DOCUMENTS THAT REFLECT ANY CHANGES TO THE ORIGINAL SPECIFICATIONS OR LAYOUT


- 13. PROVIDE 2 SPARE LAMPS OF EACH TYPE FOR THE OWNER
- 14. PROVIDE OWNER WITH ALL MANUF. INSTRUCTIONS
- 15. CONTRACTOR TO PROVIDE GFI OUTLETS AT ALL WET AREAS AS REQUIRED BY CODE
- 16. SWITCHES TO BE GANGED
- 17. FOR EACH FIXTURE PROVIDE ALL NECESSARY PARTS (I.E. TRANSFORMERS, TRIM, LEADS, LAMPS, FITTINGS)
- 18. CONTRACTOR TO COORDINATE SECURITY/MEDIA/SOUND & COMPUTER SYSTEMS W/OWNER. CONTRACTOR TO PROVIDE NECESSARY ELECTRICAL CONNECTIONS PER OWNER'S CONSULTANT.
- 19. EACH FIXTURE TO BE SUITABLE FOR INTENDED LOC. & INSTALLATION CONDITION, I.E. INSULATED CEILING, ADJ. CAN IN SLOPED CEILING, SAME TRIM SIZE/STYLE IN EACH SPACE OR CIRCUIT ETC.
- 20. ELECTRICIAN TO USE I.C. OR NON I.C. FIXTURE KITS AS REQUIRED
- 21. ALL LIGHT FIXTURES LOCATED IN WET LOC. & CLOSETS SHALL HAVE LENS COVER & COMPLY W/CODE REQUIREMENTS
- 22. PROVIDE CORRECT HOUSING/PLATFORM FOR EACH RECESSED FIXTURES ACCORDING TO MANUF. RECOMMENDATIONS, CEILING CONDITION & LOC.
- 23. LOCATE ALL STUCCO WEEP SCREEDS & VENTS IN FIELD W/ARCHITECT
- 24. ALL DIFFERENT RECESSED CANS TO MATCH STYLE & SIZE U.N.O.
- 25. PROVIDE DIMMERS ON ALL BATHROOM AND BEDROOM RECESSED LIGHTING FIXTURES. VERIFY W/ OWNER.

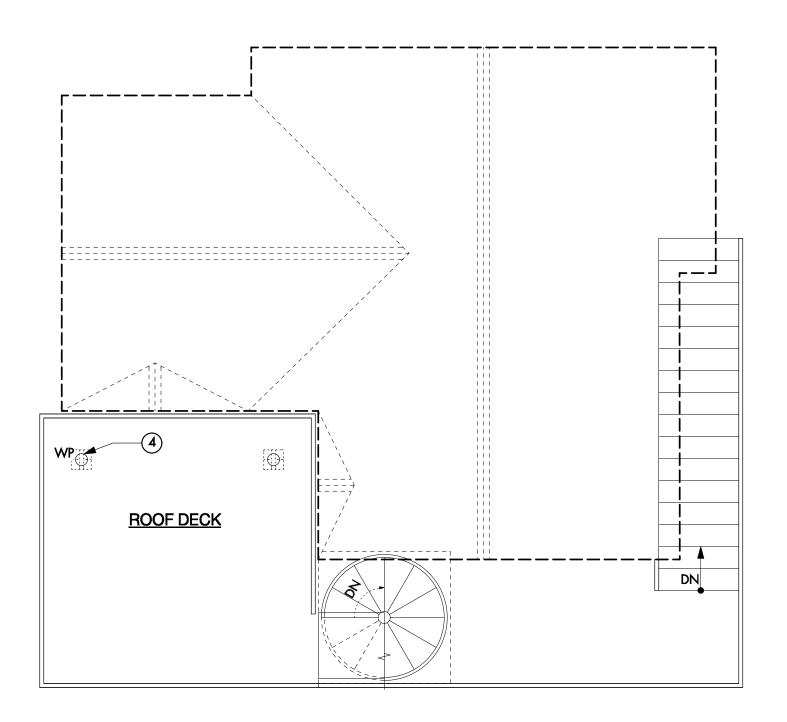

3 POWER & LIGHTING - ROOF
Scale: 1/4" = 1'-0"

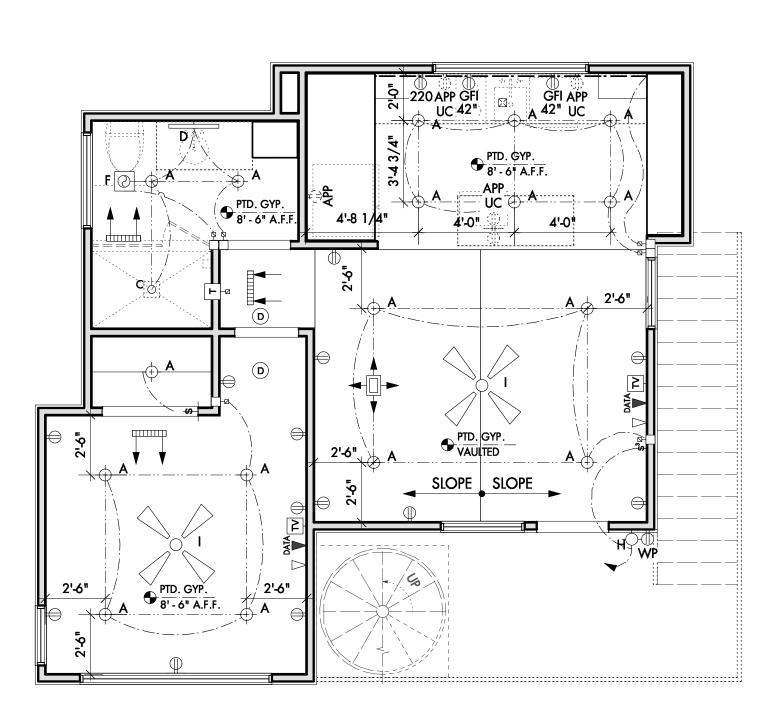

2 RCP STUDIO - LEVEL 2
Scale: 1/4" = 1'-0"

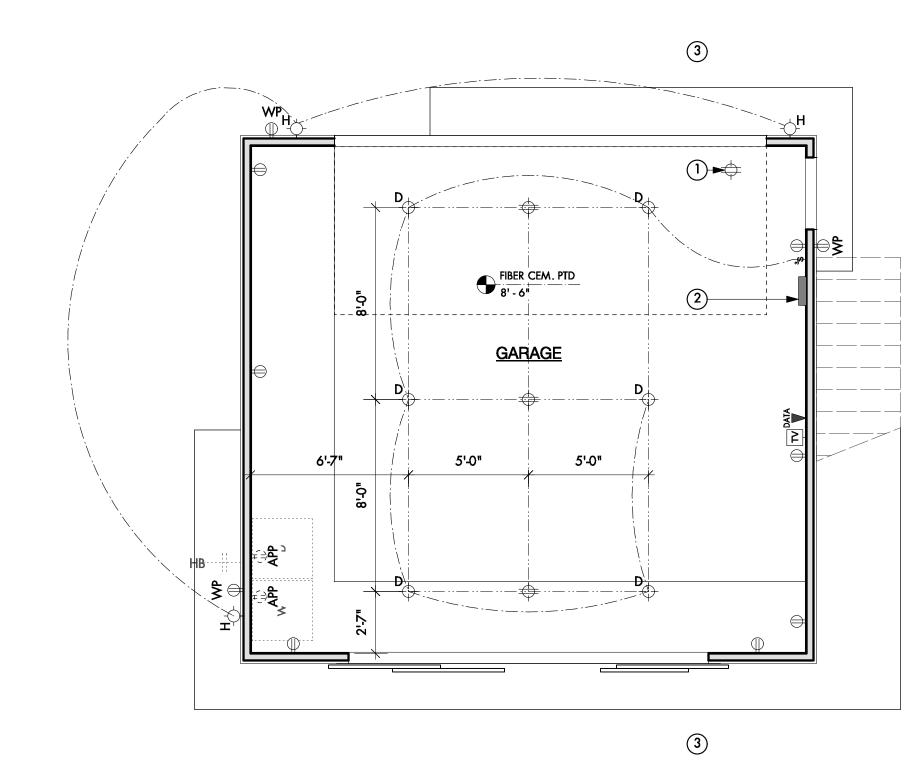

1 RCP GARAGE - LEVEL 1
Scale: 1/4" = 1'-0"

DESIGNTRAIT




Naufrais Garage/ ADU


SET ISSUE DRAWN
Permit Set mp, bn,

SHEET TITLE

REFLECTED CEILING PLAN


A1.2

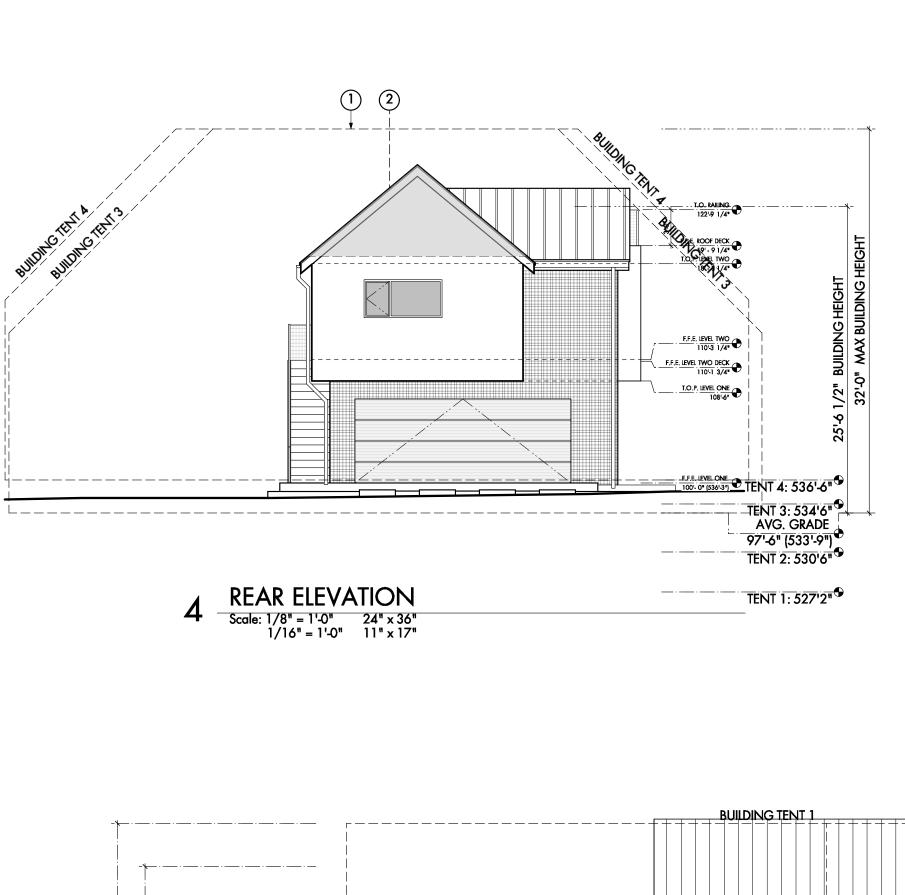

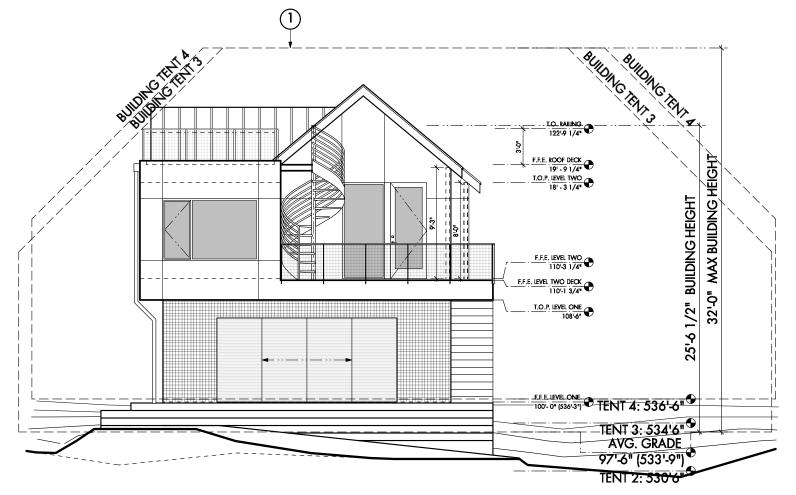




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Scale: 1/8" = 1'-0" 24" × 36" 1/16" = 1'-0" 11" × 17"

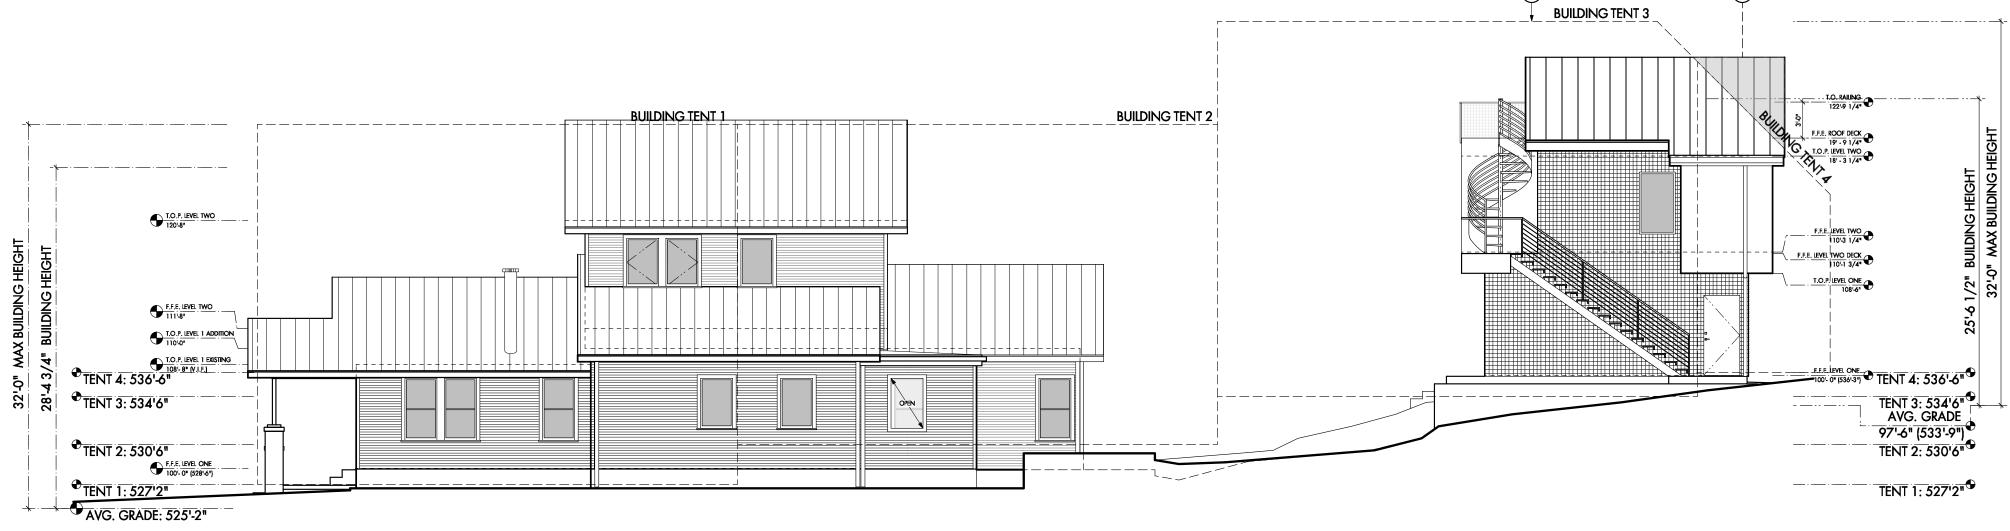



GENERAL NOTES | ELEVATIONS

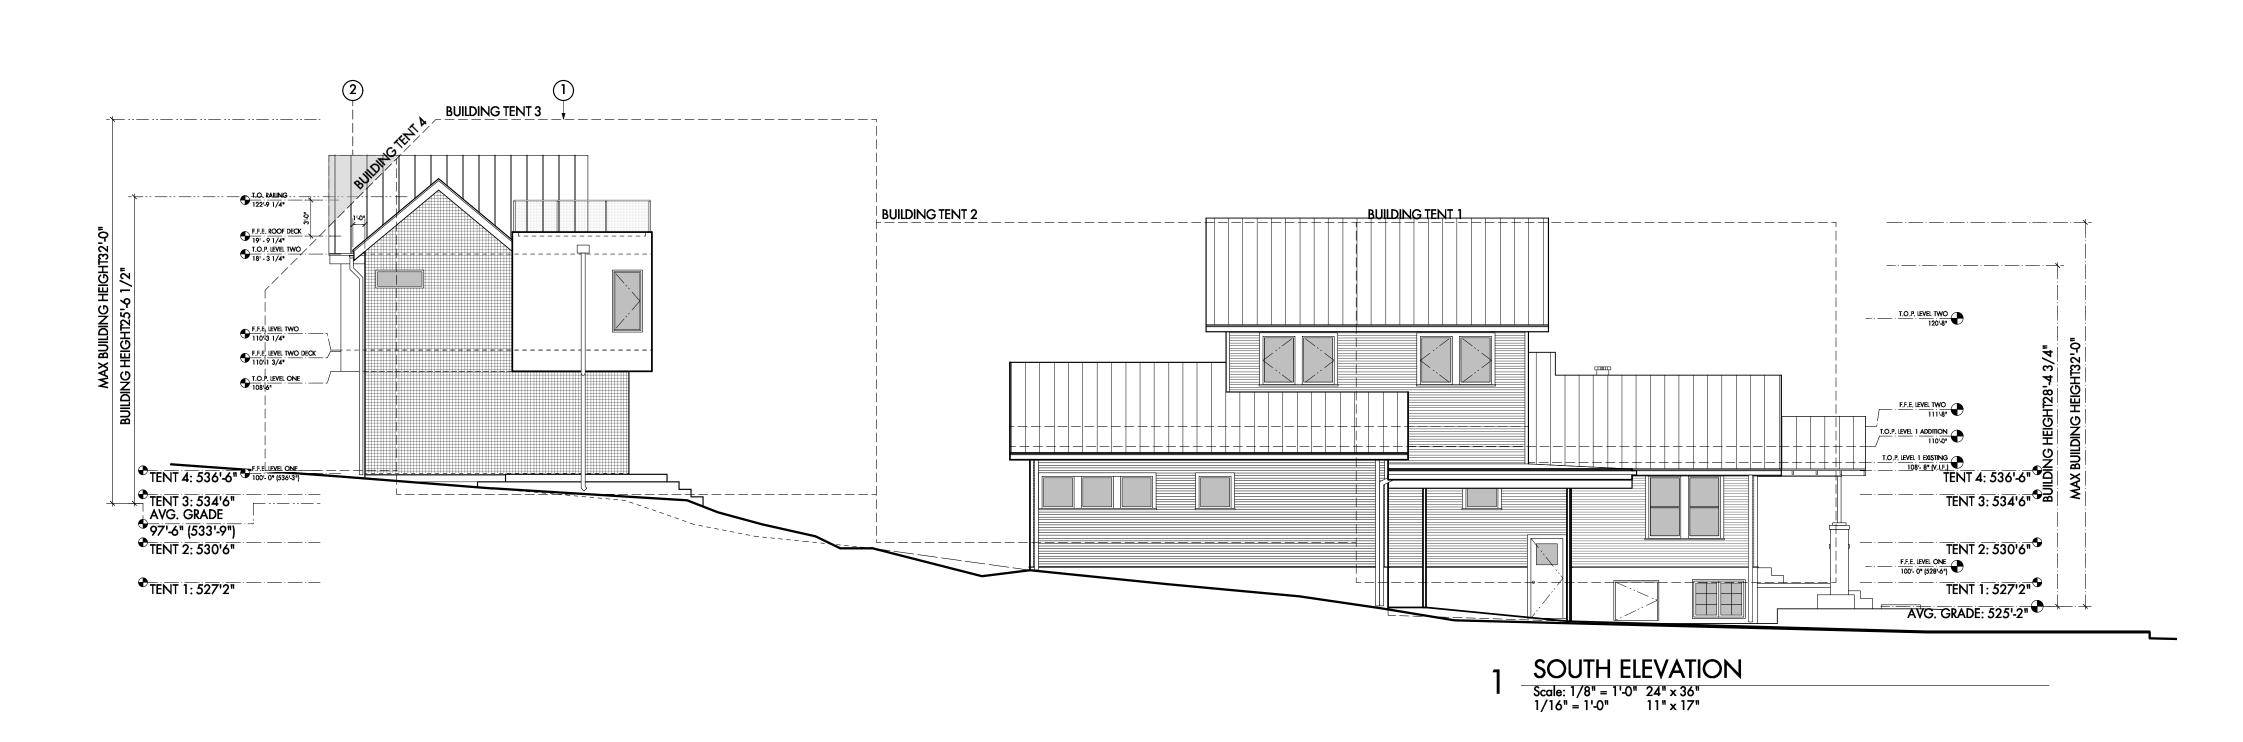- Do not scale the drawings. If a specific dimension is not given, contact designtrait for clarification.
 Keynotes located on this sheet are for this sheet only.
 Frame sample and all hardware to be approved by designtrait.
 Provide submittals & shop drawings showing number of windows, locations, of tempered glazing, etc.

KEYNOTES | TENT ELEVATIONS

- McMansion Tent.
 McMansion compliant. Refer to Subchapter F: Residential Design and Compatibility Standards Article 2 Section 2.6 E.

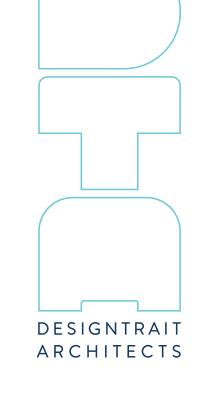

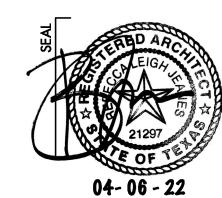



Maufrais (


SHEET TITLE

TENT **ELEVATIONS**

A2.0

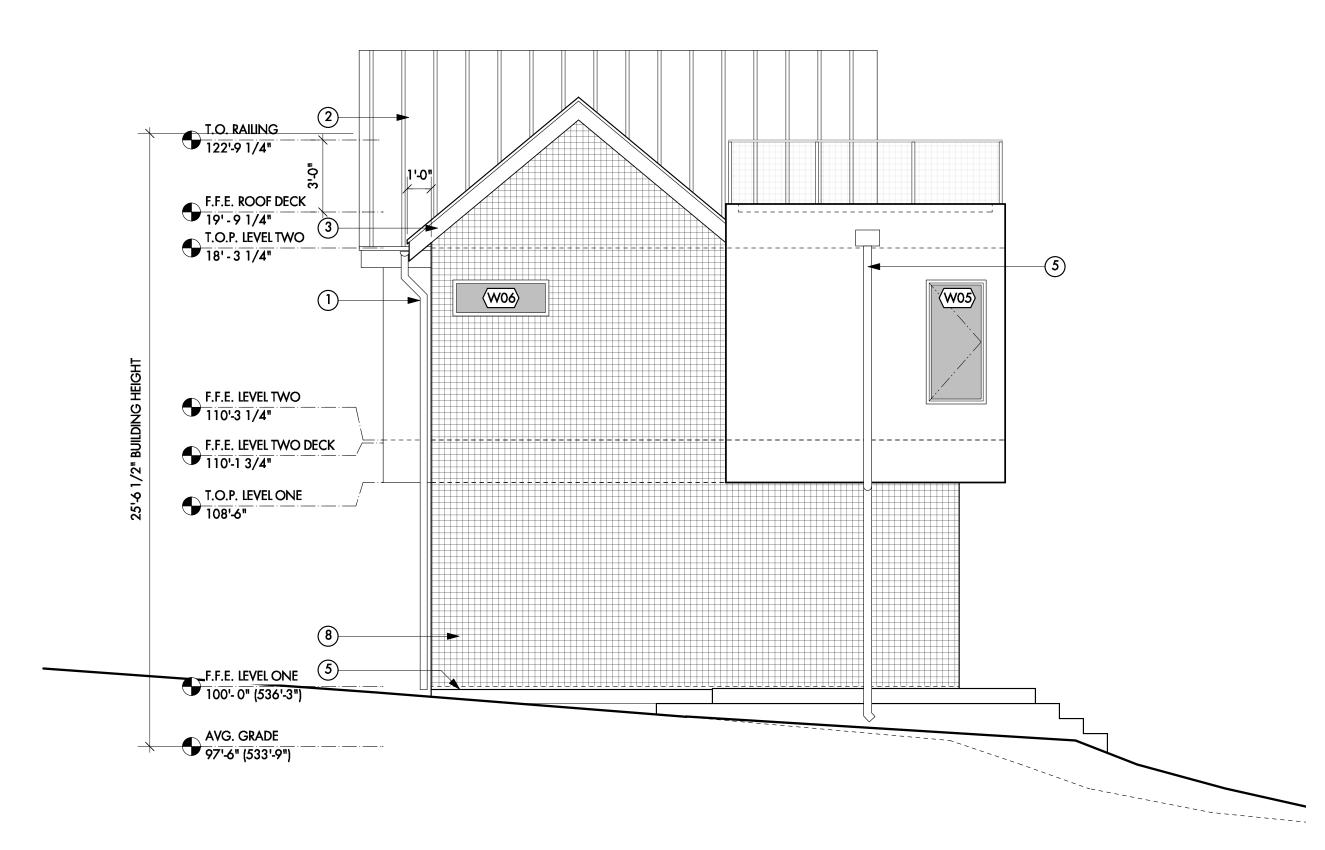

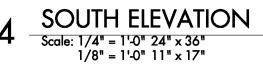

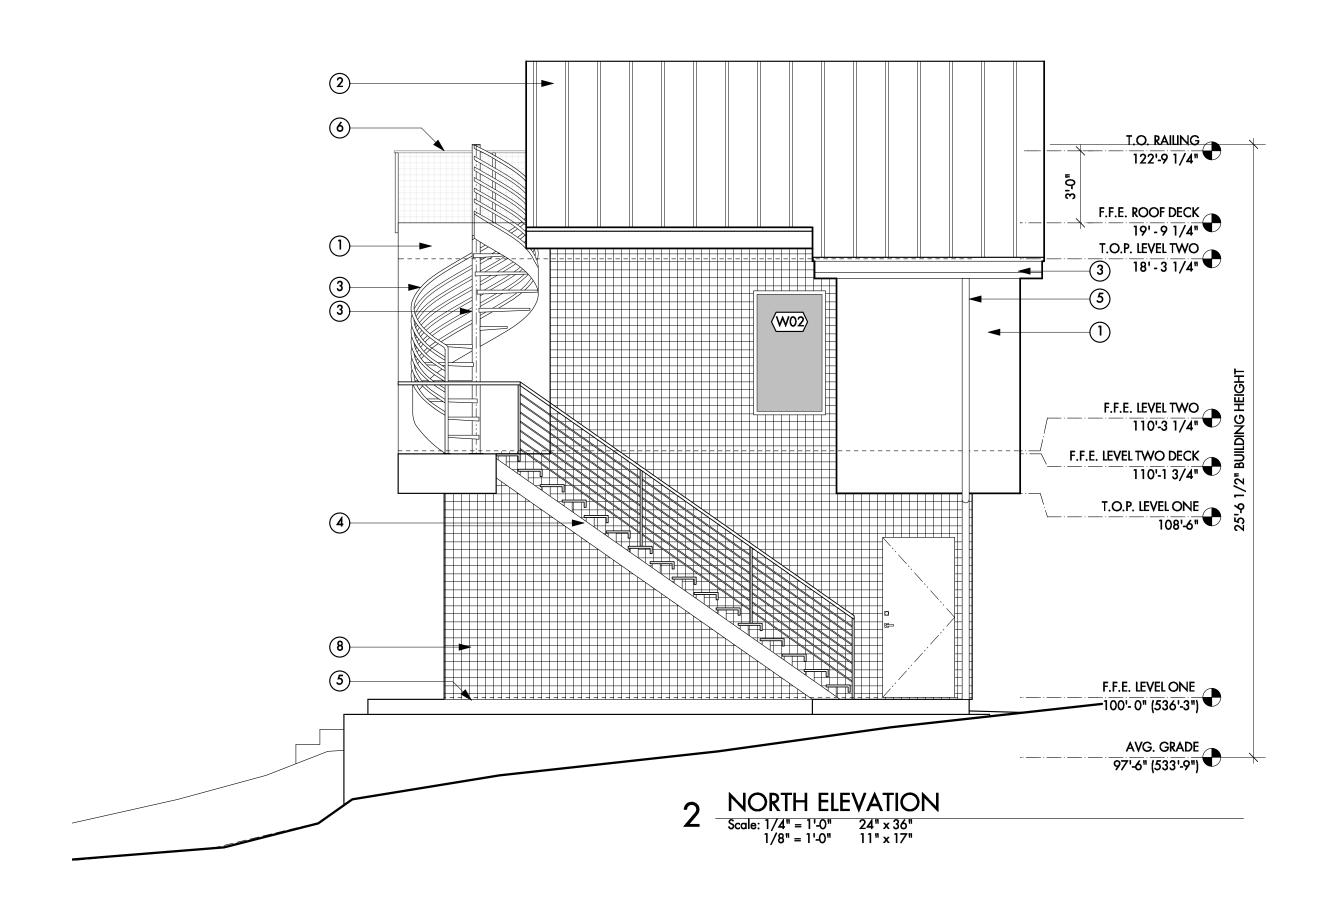

KEYNOTES | ELEVATIONS #


Stucco.
 Standing seam metal roof.
 Ptd. Hardie fascia.
 Wood stair, Refer to strucutral.
 Landscaping per landscape designer.
 Railing, (E) MTL-1
 Downspout, coordinate size accordingly w/ roof area for efficient drainage.
 Metal mesh, (E) MTL-1.
 Spiral stair.

GENERAL NOTES | ELEVATIONS

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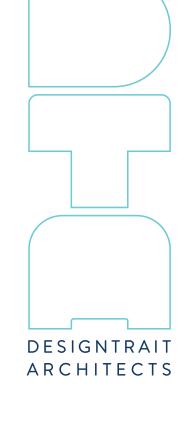
T.O. RAILING 122'-9 1/4" F.F.E. ROOF DECK T.O.P. LEVEL TWO
18' - 3 1/4" (W04) (W03) F.F.E. LEVEL TWO 110'-3 1/4" F.F.E. LEVEL TWO DECK T.O.P. LEVEL ONE 108'-6" -4 -F.F.E. LEVEL ONE 100'- 0" (536'-3") AVG. GRADE 97'-6" (533'-9")

Scale: 1/4" = 1'-0" 24" × 36" 1/8" = 1'-0" 11" × 17"

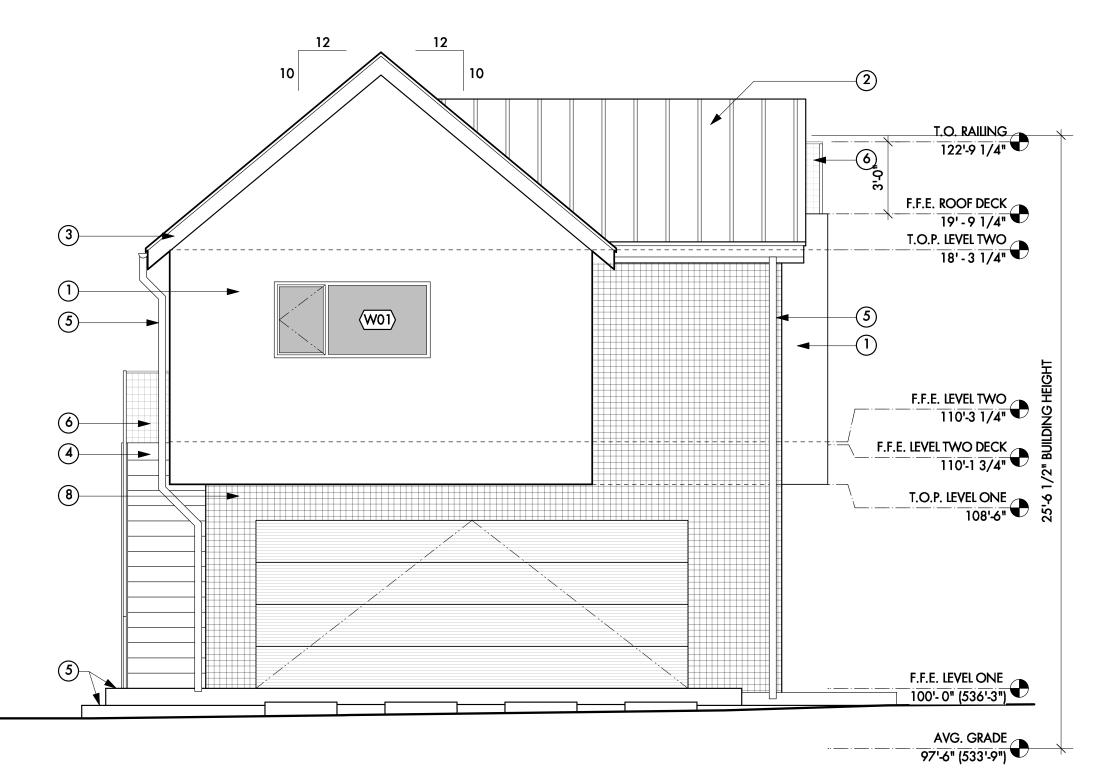

WEST ELEVATION

Scale: 1/4" = 1'-0" 24" x 36"
1/8" = 1'-0" 11" x 17"






ADU Aufrais St TX 78703 Garage/ Maufrais (

SHEET TITLE


EXTERIOR ELEVATIONS

A2.0

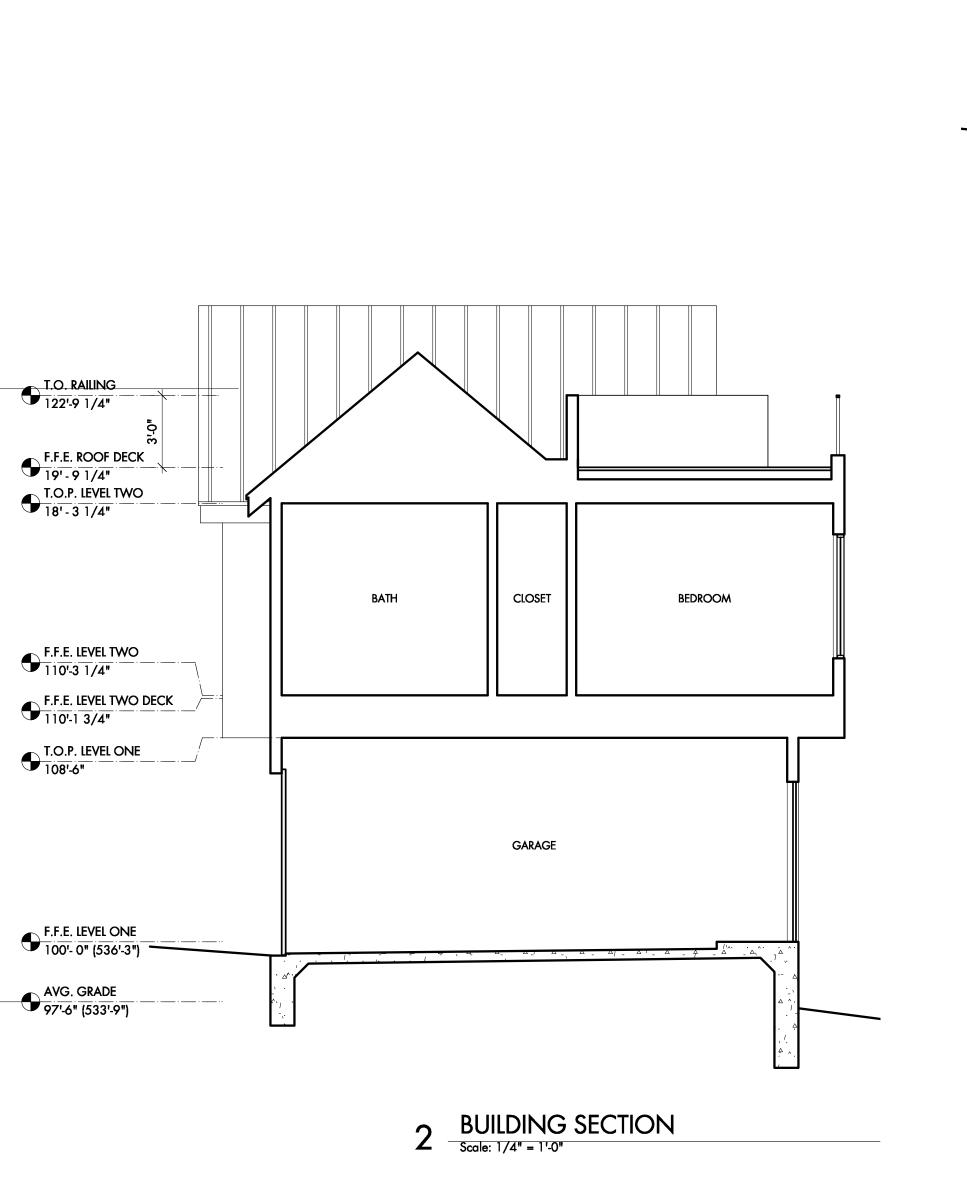




- Do not scale the drawings. If a specific dimension is not given, contact designtrait for clarification.
 Keynotes located on this sheet are for this sheet only.
 Frame sample and all hardware to be approved by designtrait.
 Provide submittals & shop drawings showing number of windows, locations, of tempered glazing, etc.

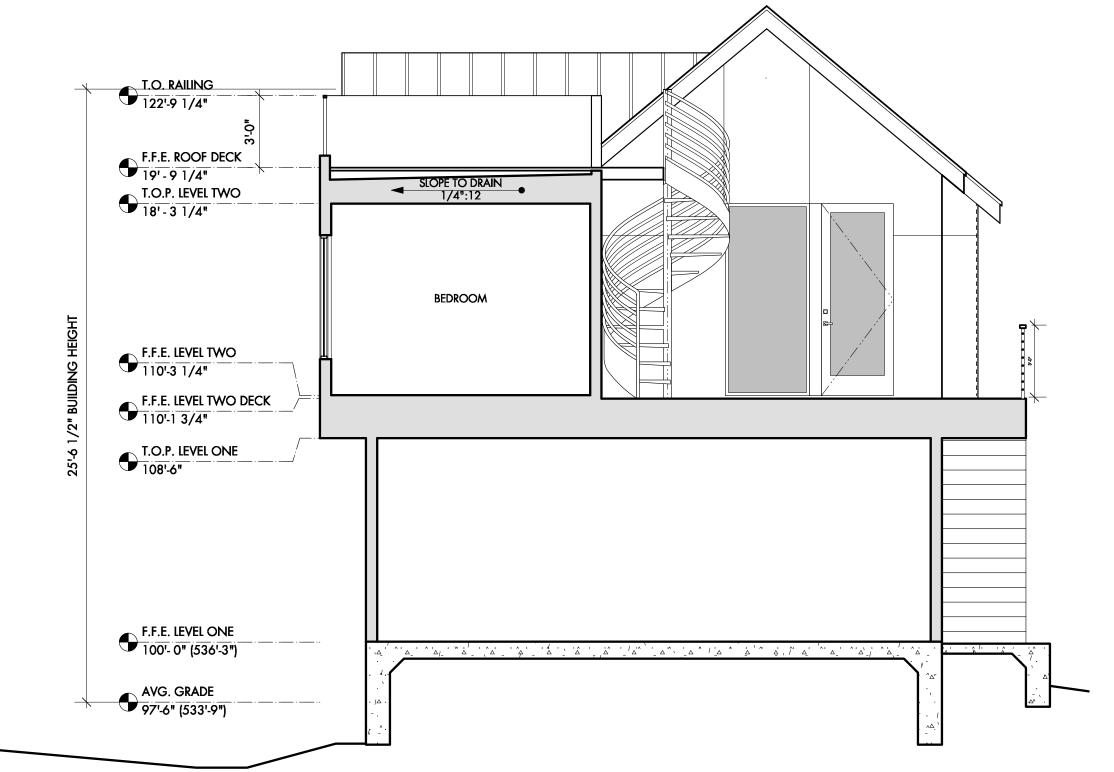

3 BUILDING SECTION Scale: 1/4" = 1'-0"

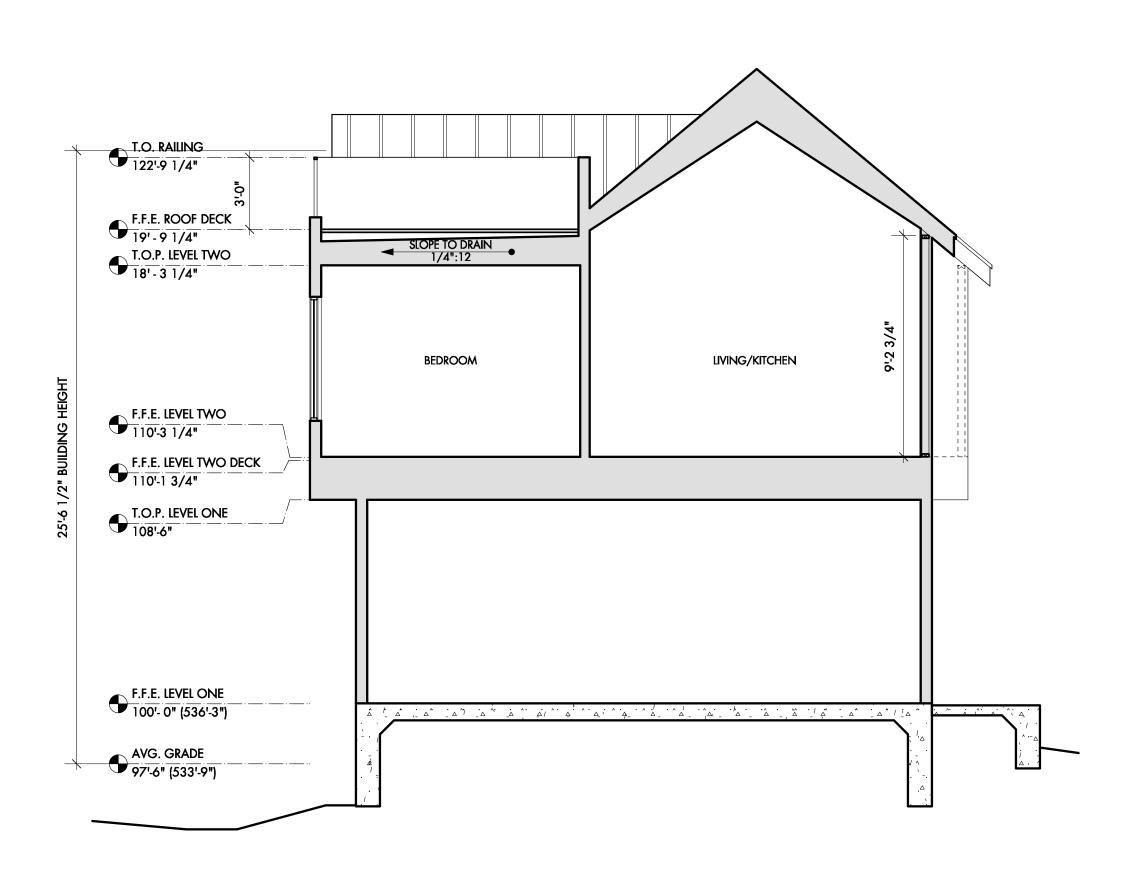

BUILDING SECTION

Scale: 1/4" = 1'-0"

DESIGNTRAIT ARCHITECTS



Maufrais Garage/

SHEET TITLE BUILDING SECTION

A3.0

SYMBOL LEGEND | INTERIOR FINISHES XX-X LOCATION AND DESIGNATION KEY NOTES | INTERIOR ELEVATIONS

- Light fixture per schedule.
 Towel bar
 Tiled niche.
- 5. Glass shower door, owner provided and installed.
 6. HVAC return grille, refer to manuf. for size.
 7. Open shelves

GENERAL NOTES


- Do not scale the drawings. If a specific dimension is not given, contact designtrait for clarification. Keynotes located on this sheet are for this sheet only.

 Provide tempered glazing as required by local codes.

 Frame sample and all hardware to be approved by designtrait.

 Provide submittals & shop drawings showing number of windows, locations, of tempered glazing,


- etc.
 Window types indicate rough sizes only. GC shall field verify the appropriate glazing sizes in the field prior to ordering. For any questions contact designtrait.
 GC responsible for removing temporary infill panels at all window locations.

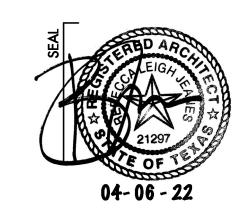



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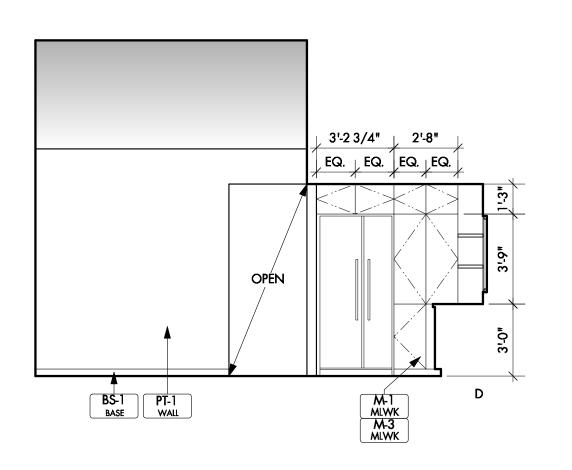
SHEET TITLE INTERIOR ELEVATIONS


A6.0




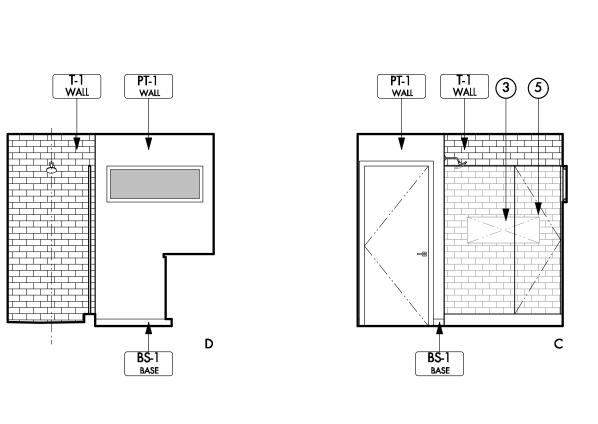


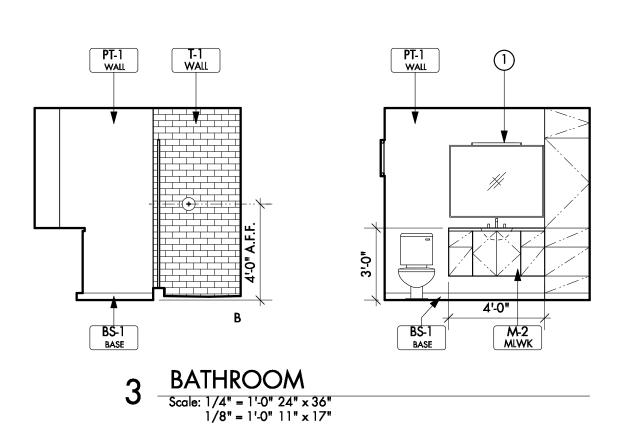

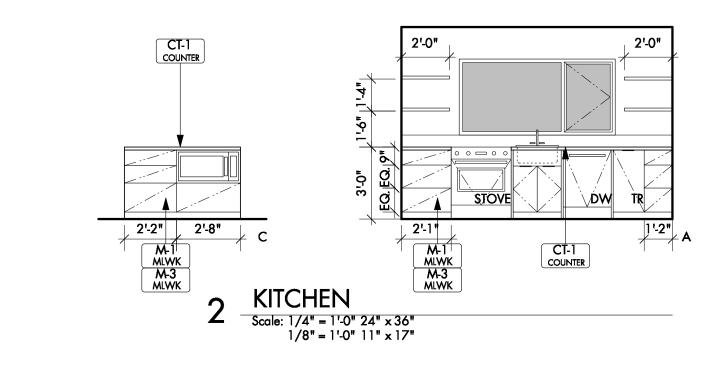

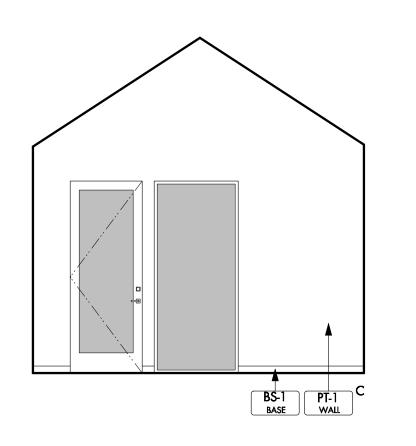

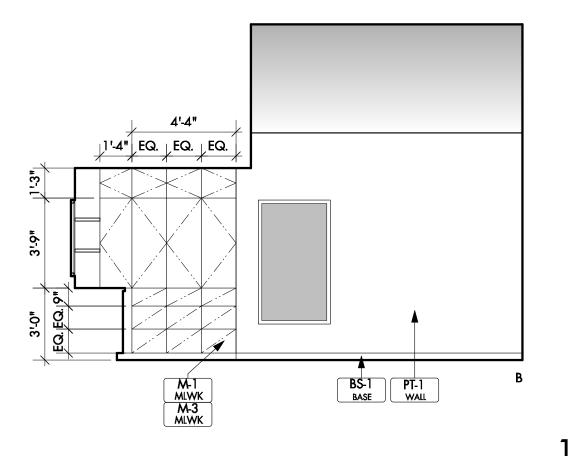

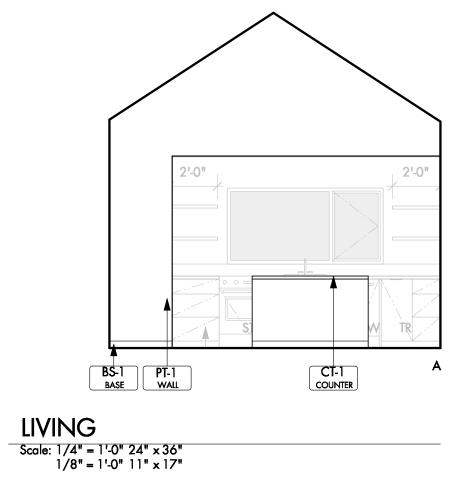



Maufrais Garage/ ADU 906 Maufrais St Austin, TX 78703


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SET ISSUE

06 April 205

DOOR AND WINDOW SCHEDULES

A7.0

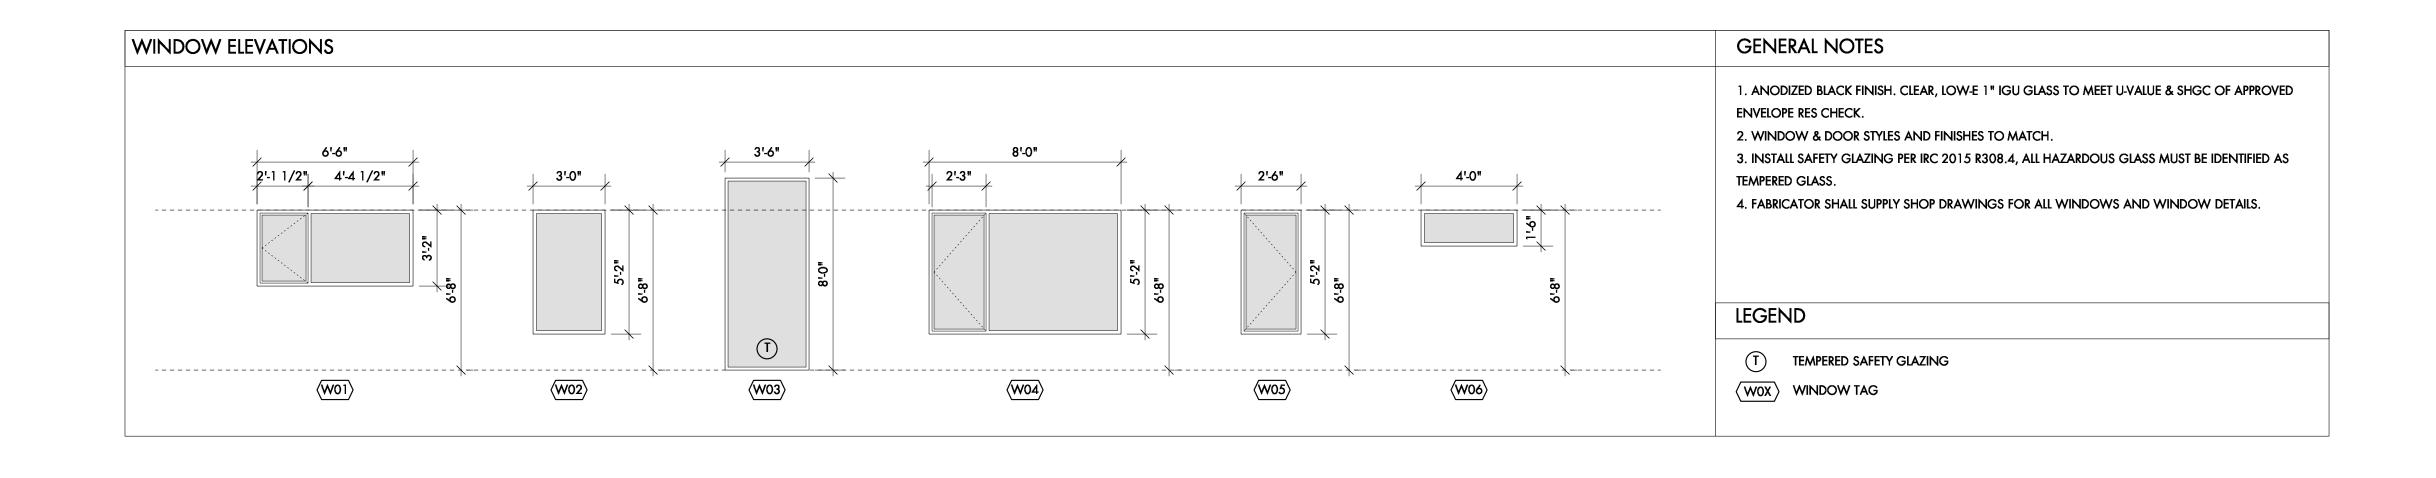

DOOR S	CHEDULE														DOOR GENERAL NOTES
уре #	Size (WxHxD)	Door Material	Door Finish	Manufacturer	Frame Material	Frame Finish	Jamb	Head	Threshold	Transom/ Sidelite	Hardware Set	Notes			1. ALL DOOR DIMENSIONS TO BE VERIFIED IN FIELD
D101	18'-0" x 7'-0"	Roll Up	Anodized Black	TBD	Metal	Anodized Black	-	-	-	-	_	Insulate door pane			2. USE SILL PAN, THRESHOLD & WEATHERSTRIPPING ON ALL EXT. DOORS.
	3'-0" x 6'-8"	Metal w/ Insulation	Painted	Armor Door	Metal	Painted	-	-	-	-	#2	Insulate door pane	,		3. ALL GLAZING FOR EXT. DOORS TO BE CLEAR, LOW-E, & FOLLOW APPLICABLE CODES
D103	15'-0" x 7'-0"	Metal w/ Insulation	Painted		Metal	Painted	-	-	_	-					4. FABRICATORR TO COORDINATE THE INSTALLATION OF ALL DOORS WITH MANUFUCATURER SPECS
	3'-0" x 8'-0"	Solid Core w/ Glass		Krosswood Doors	Wood	Painted	-		-	W03	#2	Insulate door pane	l, Clear Low E 1" IGU,	Frosted Safety Glazing	5. ALL DOOR FINISHES, STYLES, AND DETAILS VERIFIED BY DESIGNER VIA SUBMITTALS.
	2'-8" x 6'-8"	Solid Core Wood	Painted	Krosswood Doors	Wood	Painted	-	-	-	-	#1				
	2'-8" x 6'-8"	Solid Core Wood	Painted	Krosswood Doors	Wood	Painted	-	-	-	-	#1				6. FABRICATOR TO COORDINATE INSTALLATION OF TEMPERED GLASS WHERE APPLICABLE BY CODE.
D204	4'-0" x 6'-8"	Solid Core Wood	Painted	TBD	Wood	Painted	-	-	-	-	#3				7. PROVIDE SAMPLES OF ALL HARDWARE FOR APPROVAL
DOOR T	YPES														8. INTERIOR DOORS ADJACENT TO PERPENDICULAR WALLS TO HAVE 6" JAMB, MEASURED FROM INS
															CORNER TO INSIDE OF JAMB, TYP. OR ADJ. LOCATION SO TRIM BUTTS AGAINST PERPENDICULAR W
															· ·
															FINISH.
															9. PROVIDE SPECIFICATIONS, CUT SHEETS & SHOP DWGS. FOR APPROVAL BY DESIGNER AND OWN
											``				10. ALL ROUGH OPENINGS TO BE OVERSIZED & COORDINATED W/DETAILS
ſ		,^ <u>`</u>									1	``. <u>`</u>			
			`_		```										LEGEND
			``.												
															TENANCIPED CASETY OF A ZINIO
			,,,,												T TEMPERED SAFETY GLAZING
		·′	,,,,				◀			▶	٥	/			A DOOR TYPE
			````	`.											
				,,,,											
				,,,,,											HARDWARE KEY
				,,,,							ļ,				
		<u> </u>				·— ·— ·					· <del>-</del>		r		SET #1 - KWIKSET 155HFL PASSAGE LATCH WITH PRIVACY LOCK
		Α			B			C				D	E	г	
															SET #2 - KWIKSET 156HFL-S KEYED LOCKSET W/ DEAD BOLT, THRESHOLD, & WEATHERSTRIPPING

EXTERIOR FINISH SCHEDULE							LEGEND (E) REFERS TO EXTERIOR FINISH	EXTERIOR FINISH SCHEDULE NOTES		
ateria	I ID	Material	Manufacturer	Style/MFG. #/Color	r Finish - Finish Class	Notes	VELVANA ANATERIAL DECICALIATION LIEURERE TO EXTERIOR FINICIAL			
iints	(E) PT-1	Paint	-	-	-	Verify w/Owner & Designtrait.	(E) XX-X MATERIAL DESIGNATION (E) REFERS TO EXTERIOR FINISH	1. All products and the detailing of their installation, including flashing, underlayments, and weather resistive barriors, should be installed in strict compliance with manufacturer's recommendations and in compliance with all applicable codes as mandated by all governing jurisdictions. Consult with architect and third party envelope consultant when needed.		
pecialty	(E) SPT-1	Decking	-	-	-	Owner Provided				
ietal	(E) MTL-1	Wire Mesh	McNichols	3"x3", 3603190041	(E) PT-1	Provide submittal for equivalent products				
	(E) MTL-2	-	-	-	-	-				
	(E) MTL-3	Fascia	-	-	(E) PT-1	-				
	(E) MTL-4	-	-	-	-	-				
iding	(E) SD-1	Hardie Panel	James Hardie	Smooth 4'x10'	(E) PT-1	-				

APPLIANCE SCHEDULE			LEGEND	APPLIANCE SCHEDULE NOTES	
KEY # EQUIPMENT TYPE	MANUFACTURER/MODEL/FINISH	COMMENTS		1	
1 Refrigerator	KitchenAid, KUDR204EPA	Undercounter, panel ready, Use Proflow PFX146205 water line	EQUIPMENT SYMBOL	1	
2 Cook Top	KitchenAid, KECC056R	Black			
3 Microwave	LG, LMHM2237S	Built in over cook top			
4 Water Heater, Tankless	_	Refer to MEP			
5 Disposer	InSinkErator, Badger 5XP	3/4 HP, GC provide power cord, use sink-top switch push button.			
6 Washer/Dryer	_	Owner Provided			
7 Heat Pump	-	-			
8 Air Handler	-	-			
9 Dishwasher	<b>-</b>	-			

PLUA	PLUMBING SCHEDULE						LEGEND	PLUMBING SCHEDULE NOTES
#	ITEM	MANUF.	MODEL NAME	MODEL #	COLOR/FINISH	COMMENTS	X FIXTURE SYMBOL	Owner provided items will be installed after prefab construction and installation is completed.
P1	Kitchen Faucet	Kohler	Evoke	K-6332	Polished Chrome	-		
P2	Kitchen Sink	Kohler	Vault 15"	K-3840-1	Stainless Steel	Drop In		
Р3	Bathroom Faucet	Kohler	Purist Widespread	K-14406-3	Chrome	-		
P4	Bathroom Mirror	-	-	-	-	Owner Provided		
P5	Shower Door	-	-	-	-	Owner Provided		
P6	Toilet	Kohler	Santa Rosa	K-10491-0	White	-		
P7	Shower Trim	Kohler	Purist Single Hdl	K-TS14422-3	Chrome	-		
P8	Shower Valve	Kohler	Rite Temp 1/2"	K-8304-K	n/a	-		
<b>P9</b>	Shower Kit	Schluter	Kerdi-Shower Kit SS	KSK9651525PVCI	E Stainless Steel			

A7.1