

MATERIALS LEGEND		
BRICK MASONRY	FRAMING WOOD (Detail Scale)	BATT INSULATION
CONCRETE (Detail Scale)	BLOCKING - NON-CONTINUOUS (Detail Scale)	RIGID INSULATION PLASTER OR CONCRETE
EARTH	FINISHED WOOD	AS NOTED (Detail Scale)
STEEL (Detail Scale)	PLYWOOD	NEW PARTITION WALL (see plan legend)

**ABBREVIATIONS** 

& 4	And	EQ	Equal Spacing, Equivalent		Manufacturer	S	South
#	Pound	EQUIP	Equipment	MAX	Maximum	SALV	Salvage
@	At	EXH	Exhaust	MECH	Mechanical	SAU	Self-Adhering Underlayment
		EXST'G	Existing	M/E	Mechanical/Electrical	SCH'D	Scheduled
A/C	Air Conditioning	EXT	Exterior	MEP	Mechanical, Electrical,	SECT	Section
ACOUST	Acoustical				& Plumbing	SEP	Seperate, Seperated
ADD'L	Additional	FAR	Floor-Area Ratio	MIN	Minimum	SF	Square Feet
ADJ	Adjacent	FF(E)	Finished Floor (Elevation)	MISC	Miscellaneous	SHT	Sheet
AFF	Above Finish Floor	FIN		MTD	Mounted	SIM	Similar
			Finish(ed)				
AHJ	Authority Having Jurisdiction	FIXT	Fixture	MTL	Metal	SHTG	Sheathing
AHU	Air Handling Unit	FLR	Floor			SK	Sink
APPROX	( Approximately	FT	Feet, Foot	N	North	SMACN	A Sheet Metal & Air Conditioning
ARCH	Architect	FTG	Footing	NA	Not Applicable		National Association, Inc.
ASTM	American Society for Testing	FV	Field Verify	NIC	Not in Contract	SPECS	Specifications
	& Materials	FV HT	Field Verify Height	NO	Number	SPEC'D	Specified
			,	NSF	Net Square Feet	SQ	Square
BOR	Bottom of Rafter	GA	Gauge	NTS	Not to Scale	SS	Stainless Steel
BRD	Board		_	IVIS	Not to Scale		
		GALV	Galvanized	00	0 - 0	STL	Steel
BLDG	Building	GC	General Contractor	OC	On Center		Structural
BDRM	Bedroom	GFCI	Ground Fault Circuit Interrupt		On Center Each Way	SUSP	Suspended
BTM	Bottom	GL	Glass	OP'G	Opening	SW	Switch
BTWN	Between	GM	Gas Meter	OVHD	Overhead	SYM	Symmetrical
		GPM	Gallons Per Minute	OZ	Ounce		
CAB	Cabinet	GR	Grade			T&G	Tongue & Groove
CF	Cubic Feet	GRND	Ground	P&I	Provide & Install	TEMP	Temporary, Tempered
CJ	Control Joint	GSF	Gross Square Feet	PC	Photo Cell	THK	Thick
CL	Centerline					IIIK	THICK
		GYPBD	Gypsum Wall Board	PG	Page		
CLG	Ceiling		_	PL	Plate or Plateline	TOT	Total
CLO	Closet	HB	Hose Bib			TOW	Top of Wall
CLR	Clear	HDR	Header	PR	Pair	TRTD	Treated
COL	Column	HDWR	Hardware	PSF	Pounds Per Square Foot	TYP	Typical
COMP	Composite	HORIZ	Horizontal	PSI	Pounds Per Square Inch		
CONC	Concrete	HR	Hour	PT	Pressure Treated	UC	Under Counter
CONST	Construction	HT	Height	PTD	Painted	UCR	Under Counter Refrigerator
CONT	Continuous	HTG	Heating	PVC	Polyvinyl Chloride	UL	Underwriter's Laboratory
	Coordinate, Coordination		_				Unfinished
CRZ	Critical Root Zone	HVAC	Heat/Ventilation/	PVMT	Pavement	UNFIN	
			Air Conditioning	PWD	Plywood	UNO	Unless Noted Otherwise
CVR	Cover						
CW	Cold Water	I.E.	Id Est (That Is)	QTR	Quarter	VB	Vapor Barrier
		IN	Inches			VERT	Vertical
D	Deep, Depth, Dryer	INAC	Inaccessible	R	Radius/Refrigerator	VFY	Verify
DBL	Double	INCL	Including	RCP	Reflected Ceiling Plan		
DEMO	Demolish, Demolition	INFO	Information		Reference	W	Wide, Width, West,
DH	Double Hung	INSUL	Insulation	REINF	Reinforced	•••	Washing Machine
DIA	Diameter				Required	\A//	With
		INT	Interior	REQ'D	•	W/	
DIAG	Diagonal, Diagonally				S Requirements	W/O	Without
DN	Down	JNT	Joint	REV	Revision	W/D	Stackable Washer Dryer
DS	Downspout	JST	Joist	RFG	Roofing	WD	Wood
DW	Dishwasher			RM	Room	WDW	Window
DWG	Drawing	KIT	Kitchen	RO	Rough Opening	WH	Water Heater
DWR	Drawer			ROW	Right of Way	WM	Water Meter
		L	Length		,	WP	Waterproofing
E	East	LAM	Laminated			WT	Weight
EA	Each	LAV	Lavatory			V V I	· · · · · · · · · · · · · · · · · · ·
EJ	Expansion Joint					VD	Vards
	-	LB(S)	Pound(s)			YD	Yards
EM	Electric Meter	LF	Linear Foot				
EQ	Equal Spacing, Equivalent	LP	Light Pole or Lightning Protect	ion			
EQUIP	Equipment	LT	Light				
EXST'G	Existing	LVR	Louver				

#### 811-813 Park Blvd 23089.5 SF LAND AREA MAIN HOUSE Existing New Basement \*\* 229 1637 First Floor 1645 Second Floor Attic \* UNF GARAGE Existing New First Floor \* 575 575 Second Floor Building Impervious Cover SITE Existing New Site Walls & Fencing Driveway Sidewalks 238 **Equipment Pads** 151 445 2657 Impervious Cover, total

**DESIGN TEAM** 

TERESA O'CONNELL, AIA

AUSTIN, TEXAS 78751

TSEN ENGINEERING

CIVIL ENGINEERING

DUNAWAY ASSOCIATES, L.P.

AUSTIN, TEXAS. 78735

817.335.1121

AUSTIN, TEXAS 78704

3908 AVENUE B, SUITE 309

STRUCTURAL ENGINEERING

210 BARTON SPRINGS RD. SUITE 250


5707 SOUTHWEST PARKWAY, SUITE 2-250

O'CONNELL ARCHITECTURE, LLC

ARCHITECTURE

512.751.1374

512.474.4001

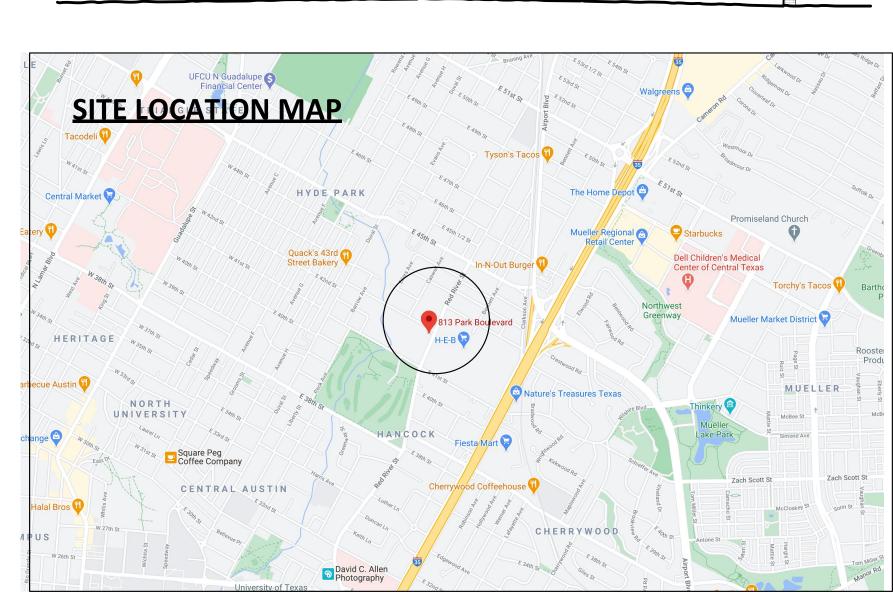

# **PROJECT INFORMATION**

**LEGAL DESCRIPTION:** LOT 33 AND 34 BLK 23 OLT 14 DIV C PERRY ESTATE

**ZONING:** SF-3

Total

Total

Total

227 2763

1625

397

16

5028

12%

0.17

\* Garage and Attic finished as Living Space

\*\* Basement Mechanical Space Exempt from FAR

578

1637

1645

578

575

2212

9.58%

2763

1863

5473

7685

33.28%

0.2170

**YEAR CONSTRUCTED:** 1929

Eligible for Austin Historic Landmark and National Register of Historic Places

**APPLICABLE CODES:** International Residential Code, 2021

OCCUPANCY: R-1, R-3

**CONSTRUCTION TYPE:** V-B

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GARAGE	PERMIT	2022-055330-PR
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-	A-907	SCHEDULES & ELECTRIC PLANS

# **GENERAL NOTES**

- 1. All work shall be performed in a professional matter, and in accordance with the International Residential Code, 2021, related trade codes, and applicable local codes, ordinances and laws.
- 2. Historic designation of this building requires the Contractor and his subcontractors to exercise special caution in executing the work to prevent unnecessary damage to historic features, conditions, or materials. Contractor shall inform all subcontractors and workmen of these requirements.
- 3. The Contractor shall thoroughly example and familiarize himself with the requirements of the Contract Documents. Any conflicts shall be brought to the Architect's attention for resolution prior to the work being installed.
- 4. Perform all work in a safe and conscientious manner to prevent injuries and damage to the building and workers. Contractor shall maintain OSHA Standards for job safety and worker protection, and comply with applicable state and local government requirements.
- 5. Building permitting will be coordinated by the Owner and Architect prior to construction. Contractor is responsible for all trade permits, inspections, and compliance requirements.
- 6. Maintain the building and site in a clean and orderly condition.
- 7. The Contractor shall visit the site of the proposed work and full acquaint himself with the existing conditions regarding site access, staging, parking limitations, security, and other aspects of constructibility.
- 8. The Contractor shall coordinate work between all trades in this contract to ensure a smooth and timely workflow.
- 9. All work to be warranted for one year from the date of Substantial Completion unless otherwise noted.







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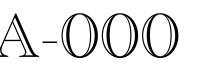
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SHEET NAME

COVER SHEET

SHEET NUMBER









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RESTORATION
RK BOULEVARD, AUSTIN, TEXAS 78751


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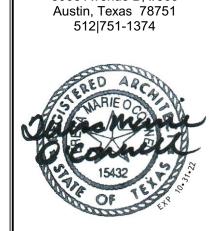
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PROPOSED SITE PLAN

SHEET NUMBER



O'Connell ARCHITECTURE

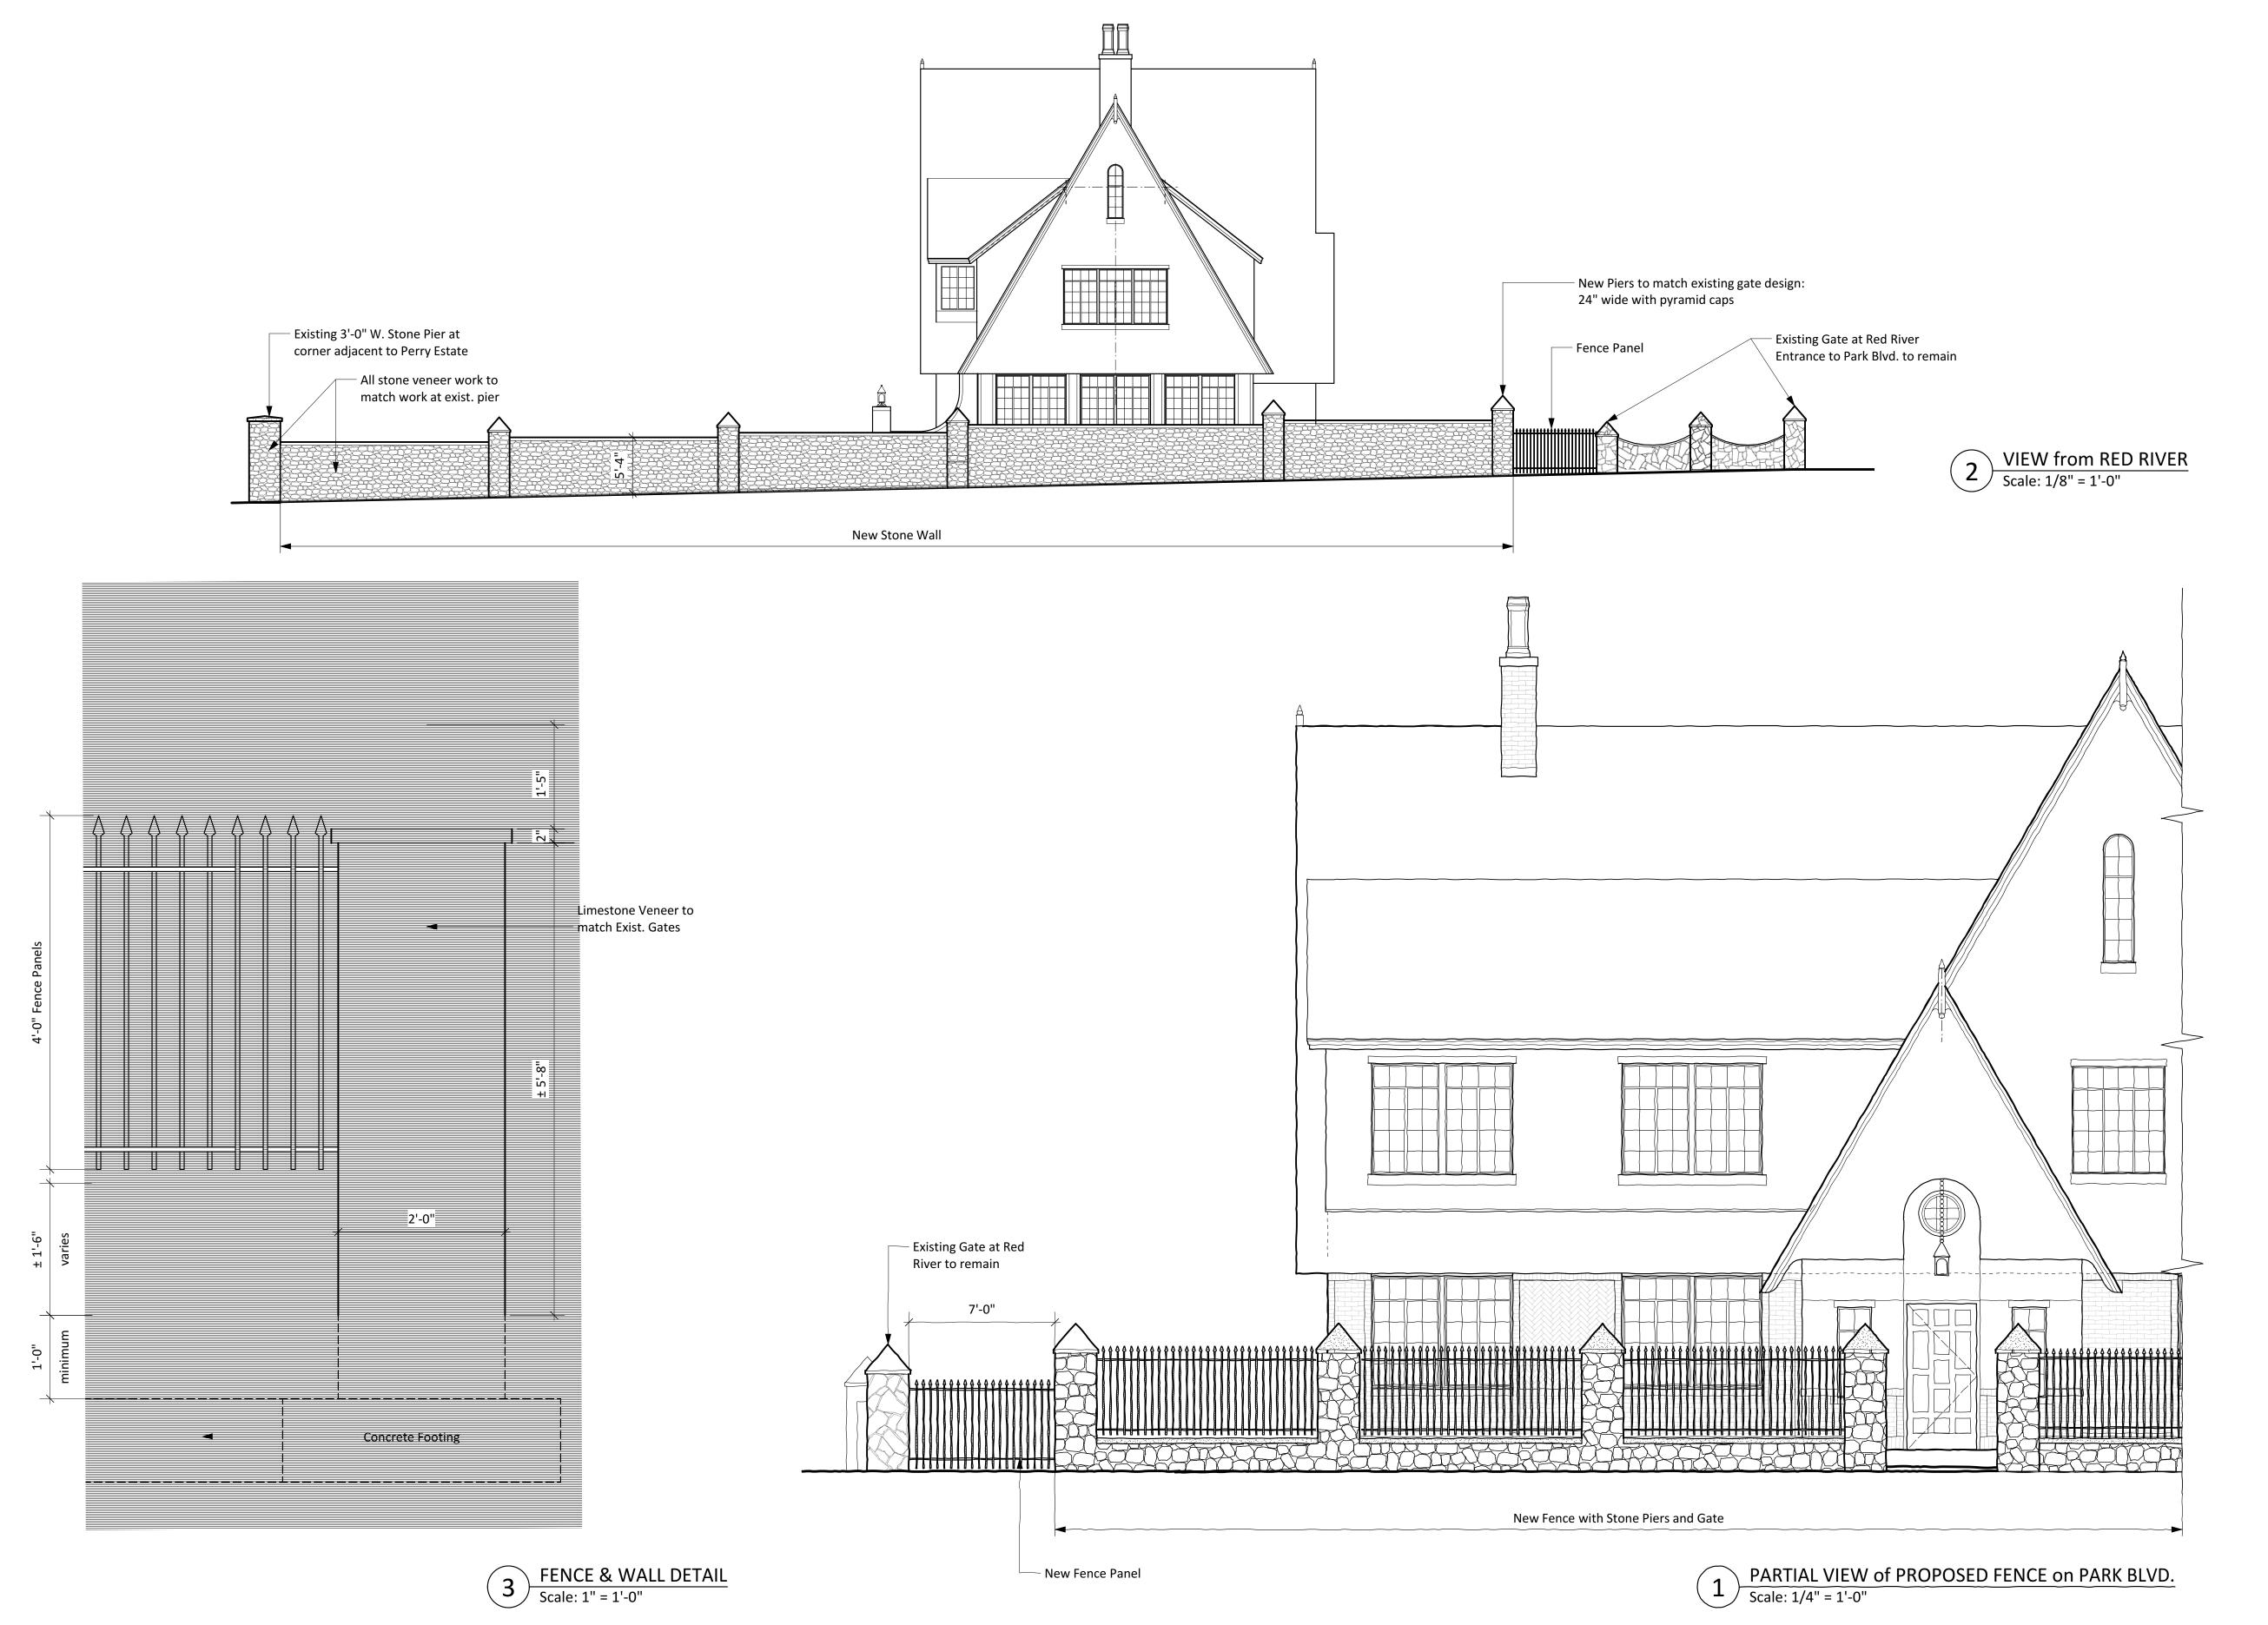

3908 Avenue B, #309

MILLER-LONG HOUSE RESTORATION


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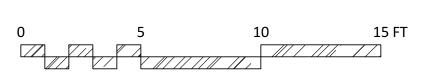
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PROPOSED FENCES

SHEET NUMBER





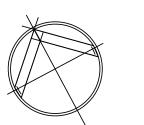

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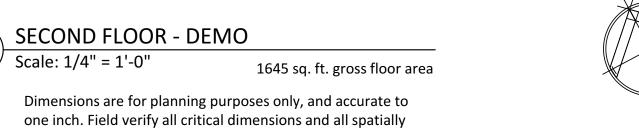
FIRST FLOOR PLAN - DEMO

SHEET NUMBER

A-111


1 FIRST FLOOR - DEMO
Scale: 1/4" = 1'-0"
1637 sq. ft. gross floor area

Dimensions are for planning purposes only, and accurate to one inch. Field verify all critical dimensions and all spatially sensitive locations.



Scale: 1/4" = 1'-0"

sensitive locations.

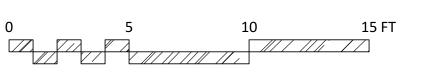





HOUSE 

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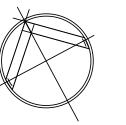
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SECOND FLOOR PLAN -**DEMO** 


SHEET NUMBER

FOUNDATION PLAN
Scale: 1/4" = 1'-0"

Dimensions are for planning purposes only, and accurate to one inch. Field verify all critical dimensions and all spatially sensitive locations.



– NEW TERRACE TBD –

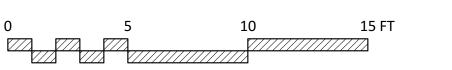



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RESTORATION
813 PARK BOULEVARD, AUSTIN, TEXAS 78751


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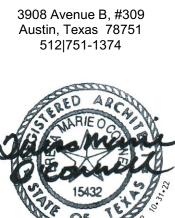
FOUNDATION PLAN

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O'Connell ARCHITECTURE



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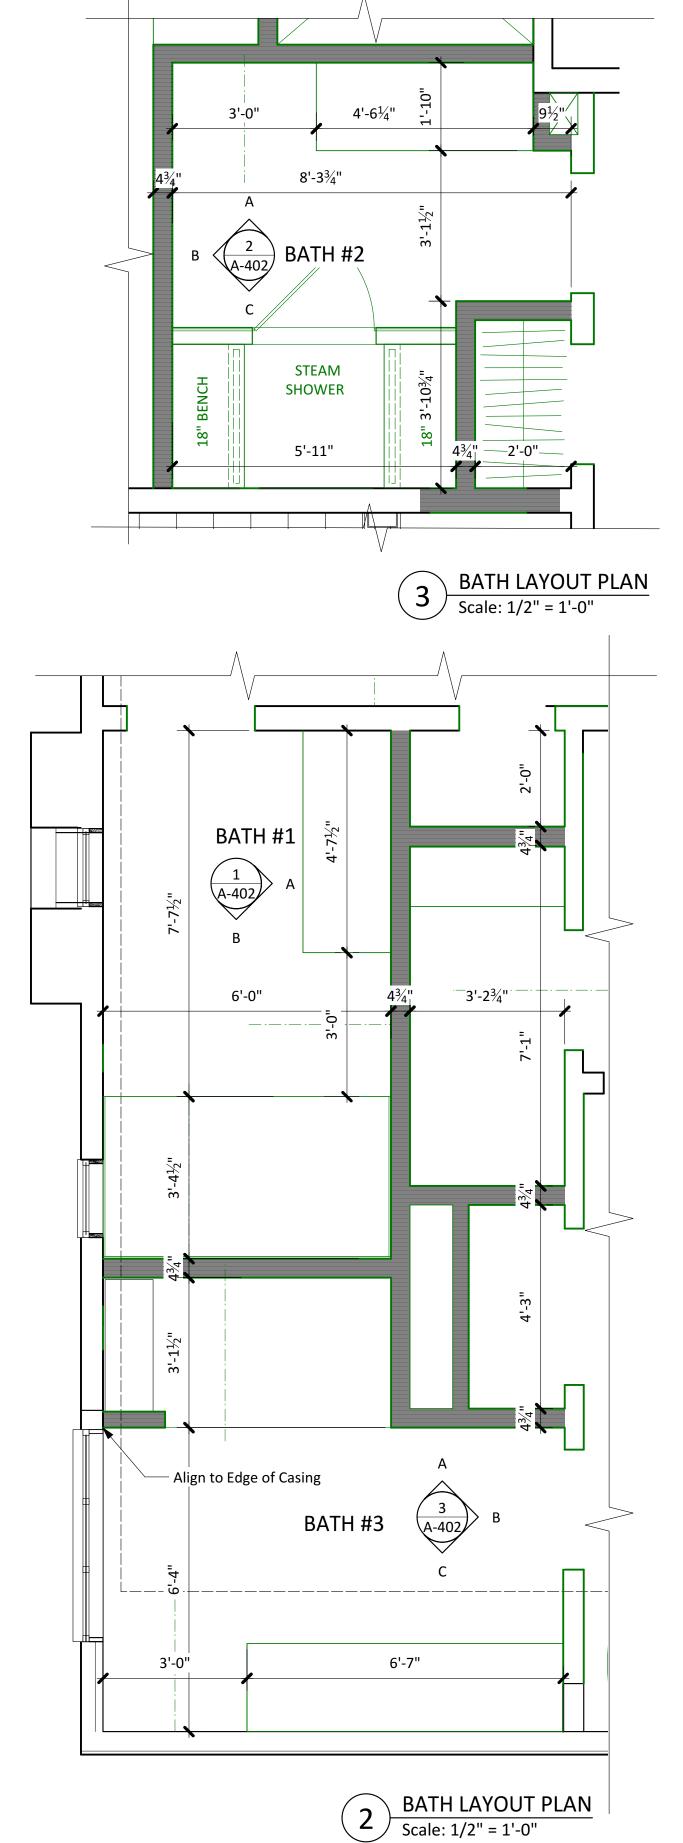
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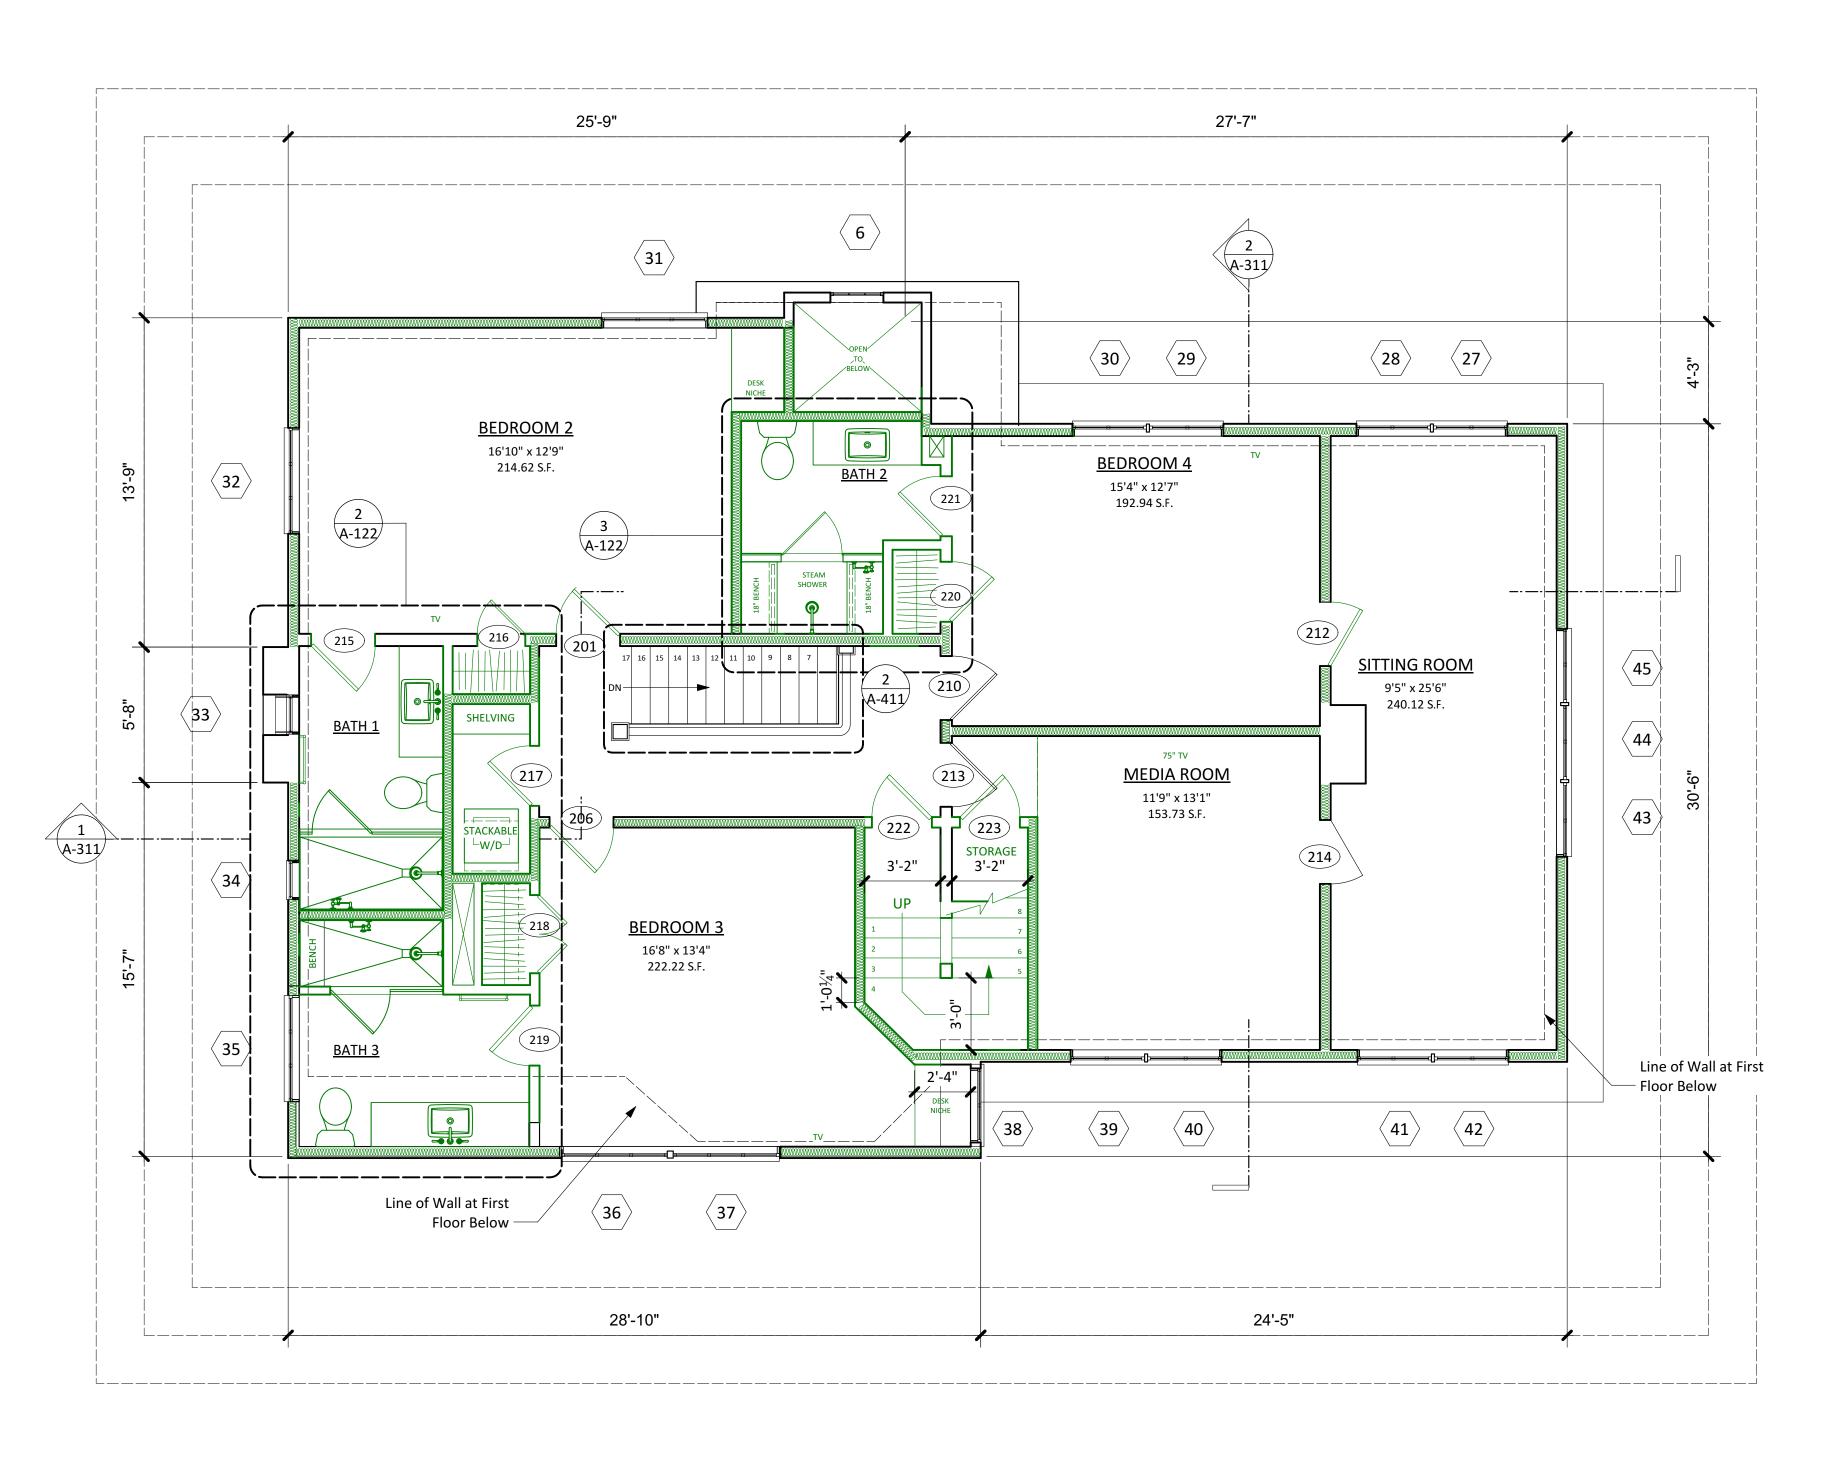
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FIRST FLOOR PLAN

SHEET NUMBER

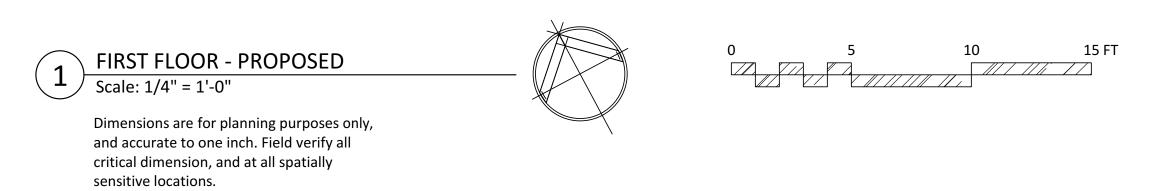




SECOND FLOOR - PROPOSED


Scale: 1/4" = 1'-0"

sensitive locations.

Dimensions are for planning purposes only, and accurate to one inch. Field verify all critical dimensions and all spatially



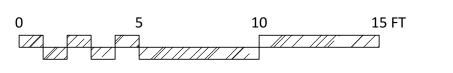

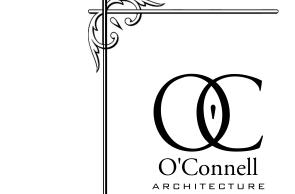



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SECOND FLOOR PLAN

SHEET NUMBER

Remove Window

ATTIC PLAN - DEMO

Scale: 1/8" = 1'-0"







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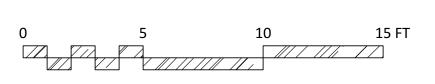
SHEET NAME

ATTIC FLOOR PLAN

SHEET NUMBER

1-123











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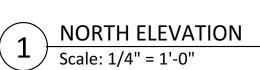
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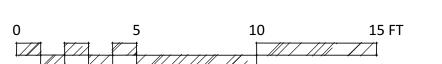
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SHEET NAME

ROOF PLAN

SHEET NUMBER





## **RESTORATION SCOPE**

#### Concrete

 Repair/replace concrete foundation skirt over original buff-brick perimeter beam to match historic character, texture, and finish.

#### Stucco

- 2. Throughout second floor and first floor entry area, remove stucco finish and replace with new 3-coat stucco over wire lath. Insulate wall and install vapor barrier per details. Finish texture to match original "Lace and Skip" trowel finish see supplemental information provided by Architect.
  - 3. Window heads and sills at second and third floor are currently formed stucco verify original detailing with Architect through selective demolition and investigations.

#### Masonry

- Repoint all broken and deteriorated mortar joints with new mortar to match original in color, composition, texture, and tooling. Take particular note of mortar aggregate which must be matched.
- 5. Remove existing brick sills, clean bricks, install new sill flashing and relay with proper pitch to exterior. Refer to detail herein. Mortar to match original in color, composition, texture, and tooling. Take particular note of mortar aggregate which must be matched. Brick salvaged from the south elevation of the garage may be used in these repairs.
- Repair and repoint brickwork at chimneys, reset chimney pots.
- 7. Clean all masonry to remove algae staining using gentlest means possible. Pressurized water not to exceed 400psi. Cleaning program including all products and processes to be approved by Architect and mocked-up prior to use.

#### Woo

- 8. Replace rotted wood at eaves and rake boards, finials, moldings, door and window trim with new to match original detailing. Wood species to be approved by Architect through submittal samples. Acceptable wood species include selected types of mahogany, smooth-finished cedar, or other rot-, warp-, and check-resistant wood. Paint finish to match historic or approved equal.
- 9. Restore exterior doors by removing finishes and using epoxy consolidation repair techniques in lieu of replacement to the maximum extent possible. Review condition of all doors and verify Restoration Program with Architect prior to start of work. Allow Architect access for evaluation of original finishes. Replace all door thresholds with solid oak tapered thresholds.

## Hardware

- Restore all original door hardware, or replace in kind if damage is beyond repair. Provide and install new deadbolts at exterior doors and as scheduled.
- Replace broken hardware at casement windows to match original character.
   Weatherstrip all operable windows.

## Steel Casement Windows

- Remove, restore, and reinstall steel casement windows. Replace irreparable stock to match original character. Match original exterior finish: Black paint.
- 13. New steel casement window at attic level to match original character, refer to window

## Roof

- 14. 10. Remove existing composition shingle roof and flashings and install new felt, flashings and architectural composition shingle roof. Product:
- 15. Replace all roof vents and appurtenances at roof, and paint finish to match roof. Locate all on the south (rear) face of the building.
- 16. Provide and install new skylights as indicated in Roof Plan.

## Mechanical

17. New Mitsubishi mini-split ducted systems throughout.

# throughout.

- 18. New electrical service to be underground to meter and disconnect where indicated on plan.
- 19. Restore all historic exterior light fixtures including new wiring and restored finishes.





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MILLER-LONG HOUSE RESTORATION

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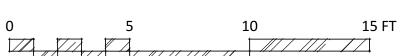
SHEET NAME

NORTH ELEVATION

SHEET NUMBER



Scale: 1/4" = 1'-0"



## **RESTORATION SCOPE**

#### Concrete

 Repair/replace concrete foundation skirt over original buff-brick perimeter beam to match historic character, texture, and finish.

#### Stucco

- 2. Throughout second floor and first floor entry area, remove stucco finish and replace with new 3-coat stucco over wire lath. Insulate wall and install vapor barrier per details. Finish texture to match original "Lace and Skip" trowel finish – see supplemental information provided by Architect.
- 3. Window heads and sills at second and third floor are currently formed stucco – verify original detailing with Architect through selective demolition and investigations.

#### Masonry

- 4. Repoint all broken and deteriorated mortar joints with new mortar to match original in color, composition, texture, and tooling. Take particular note of mortar aggregate which must be matched.
- 5. Remove existing brick sills, clean bricks, install new sill flashing and relay with proper pitch to exterior. Refer to detail herein. Mortar to match original in color, composition, texture, and tooling. Take particular note of mortar aggregate which must be matched. Brick salvaged from the south elevation of the garage may be used in these repairs.
- 6. Repair and repoint brickwork at chimneys, reset chimney pots.
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## Hardware

- 10. Restore all original door hardware, or replace in kind if damage is beyond repair. Provide and install new deadbolts at exterior doors and as scheduled.
- 11. Replace broken hardware at casement windows to match original character. Weatherstrip all operable windows.

## **Steel Casement Windows**

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## Roof

- 14. 10. Remove existing composition shingle roof and flashings and install new felt, flashings and architectural composition shingle roof. Product:
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- 16. Provide and install new skylights as indicated in Roof Plan.

## Mechanical

17. New Mitsubishi mini-split ducted systems throughout.

## **Electrical**

- 18. New electrical service to be underground to meter and disconnect where indicated on
- 19. Restore all historic exterior light fixtures including new wiring and restored finishes.





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HOUSE ILLER-LONG 


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SHEET NAME

EAST **ELEVATION** 

SHEET NUMBER



## **RESTORATION SCOPE**
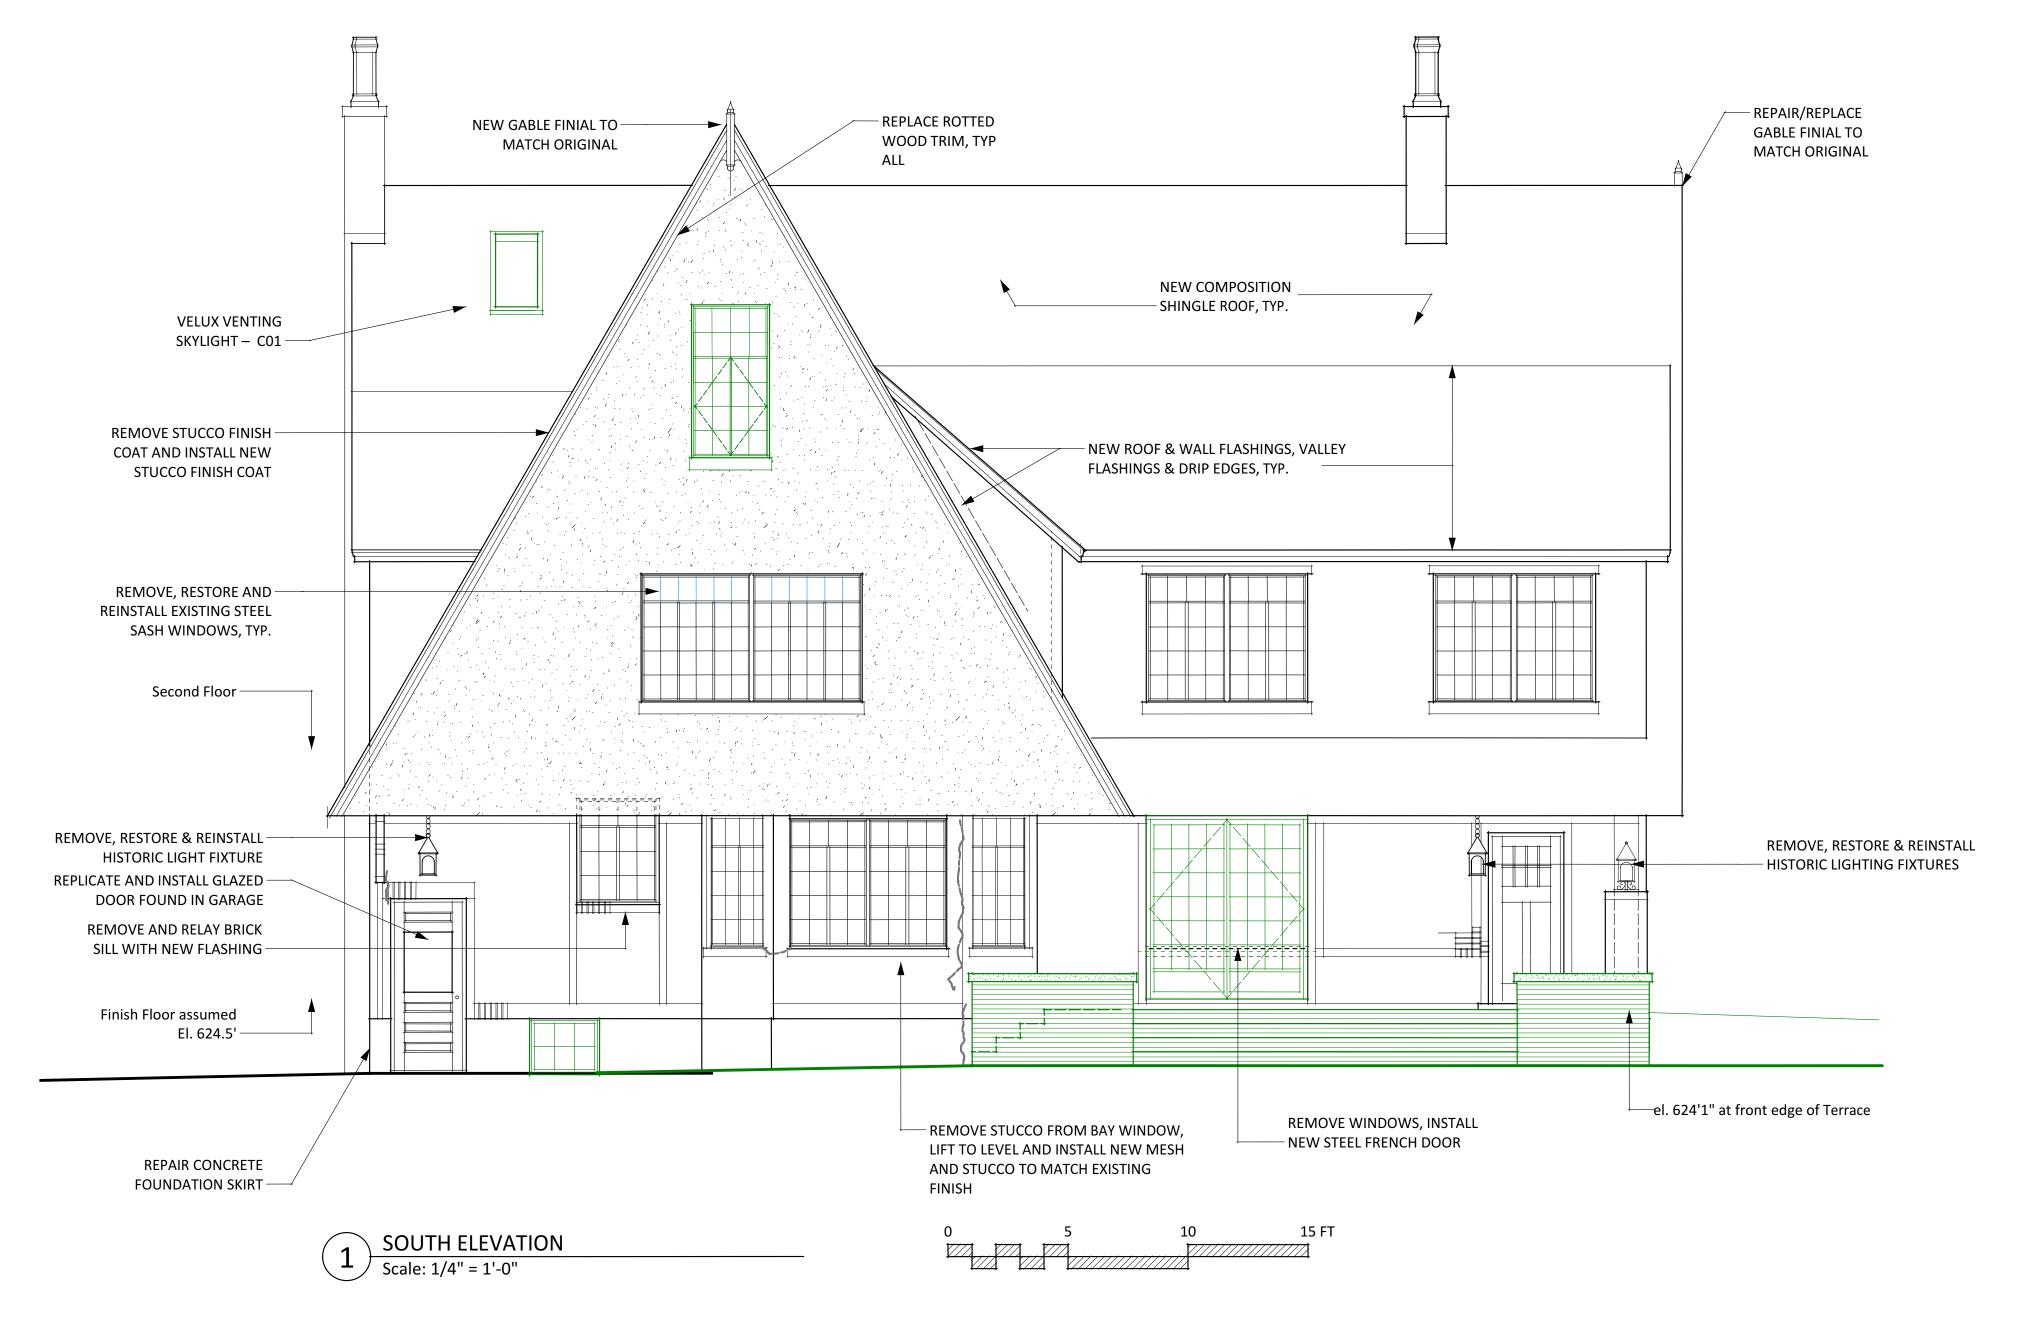
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- Window heads and sills at second and third floor are currently formed stucco – verify original detailing with Architect through selective demolition and investigations.

#### Masor

- Repoint all broken and deteriorated mortar joints with new mortar to match original in color, composition, texture, and tooling. Take particular note of mortar aggregate which must be matched.
- 5. Remove existing brick sills, clean bricks, install new sill flashing and relay with proper pitch to exterior. Refer to detail herein. Mortar to match original in color, composition, texture, and tooling. Take particular note of mortar aggregate which must be matched. Brick salvaged from the south elevation of the garage may be used in these repairs.
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- 16. Provide and install new skylights as indicated in Roof Plan.

## Mechanical

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## Electrical

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- 19. Restore all historic exterior light fixtures including new wiring and restored finishes.





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SOUTH ELEVATION

SHEET NUMBER



## **RESTORATION SCOPE**

#### Concrete

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- Window heads and sills at second and third floor are currently formed stucco – verify original detailing with Architect through selective demolition and investigations.

#### Masonry

- Repoint all broken and deteriorated mortar joints with new mortar to match original in color, composition, texture, and tooling.
   Take particular note of mortar aggregate which must be matched.
- 5. Remove existing brick sills, clean bricks, install new sill flashing and relay with proper pitch to exterior. Refer to detail herein. Mortar to match original in color, composition, texture, and tooling. Take particular note of mortar aggregate which must be matched. Brick salvaged from the south elevation of the garage may be used in these repairs.
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- 7. Clean all masonry to remove algae staining using gentlest means possible. Pressurized water not to exceed 400psi. Cleaning program including all products and processes to be approved by Architect and mocked-up prior to use.

#### Woo

- 8. Replace rotted wood at eaves and rake boards, finials, moldings, door and window trim with new to match original detailing. Wood species to be approved by Architect through submittal samples. Acceptable wood species include selected types of mahogany, smooth-finished cedar, or other rot-, warp-, and check-resistant wood. Paint finish to match historic or approved equal.
- 9. Restore exterior doors by removing finishes and using epoxy consolidation repair techniques in lieu of replacement to the maximum extent possible. Review condition of all doors and verify Restoration Program with Architect prior to start of work. Allow Architect access for evaluation of original finishes. Replace all door thresholds with solid oak tapered thresholds.

## Hardware

- Restore all original door hardware, or replace in kind if damage is beyond repair. Provide and install new deadbolts at exterior doors and as scheduled.
- Replace broken hardware at casement windows to match original character.
   Weatherstrip all operable windows.

## Steel Casement Windows

- Remove, restore, and reinstall steel casement windows. Replace irreparable stock to match original character. Match original exterior finish: Black paint.
- 13. New steel casement window at attic level to match original character, refer to window

## Roof

- 14. 10. Remove existing composition shingle roof and flashings and install new felt, flashings and architectural composition shingle roof. Product:
- 15. Replace all roof vents and appurtenances at roof, and paint finish to match roof. Locate all on the south (rear) face of the building.
- 16. Provide and install new skylights as indicated in Roof Plan.

## Mechanical

17. New Mitsubishi mini-split ducted systems throughout.

# Electrical

- 18. New electrical service to be underground to meter and disconnect where indicated on plan.
- 19. Restore all historic exterior light fixtures including new wiring and restored finishes.





3908 Avenue B, Suite 309 Austin, Texas 78751 512|751-1374



ILLER-LONG HOUSE
RESTORATION
PARK ROLLI EVARD ALISTIN TEXAS 78751

ISSUE DATE


PRINT: 5/6/22

SHEET NAME

WEST ELEVATION

SHEET NUMBER

1-214

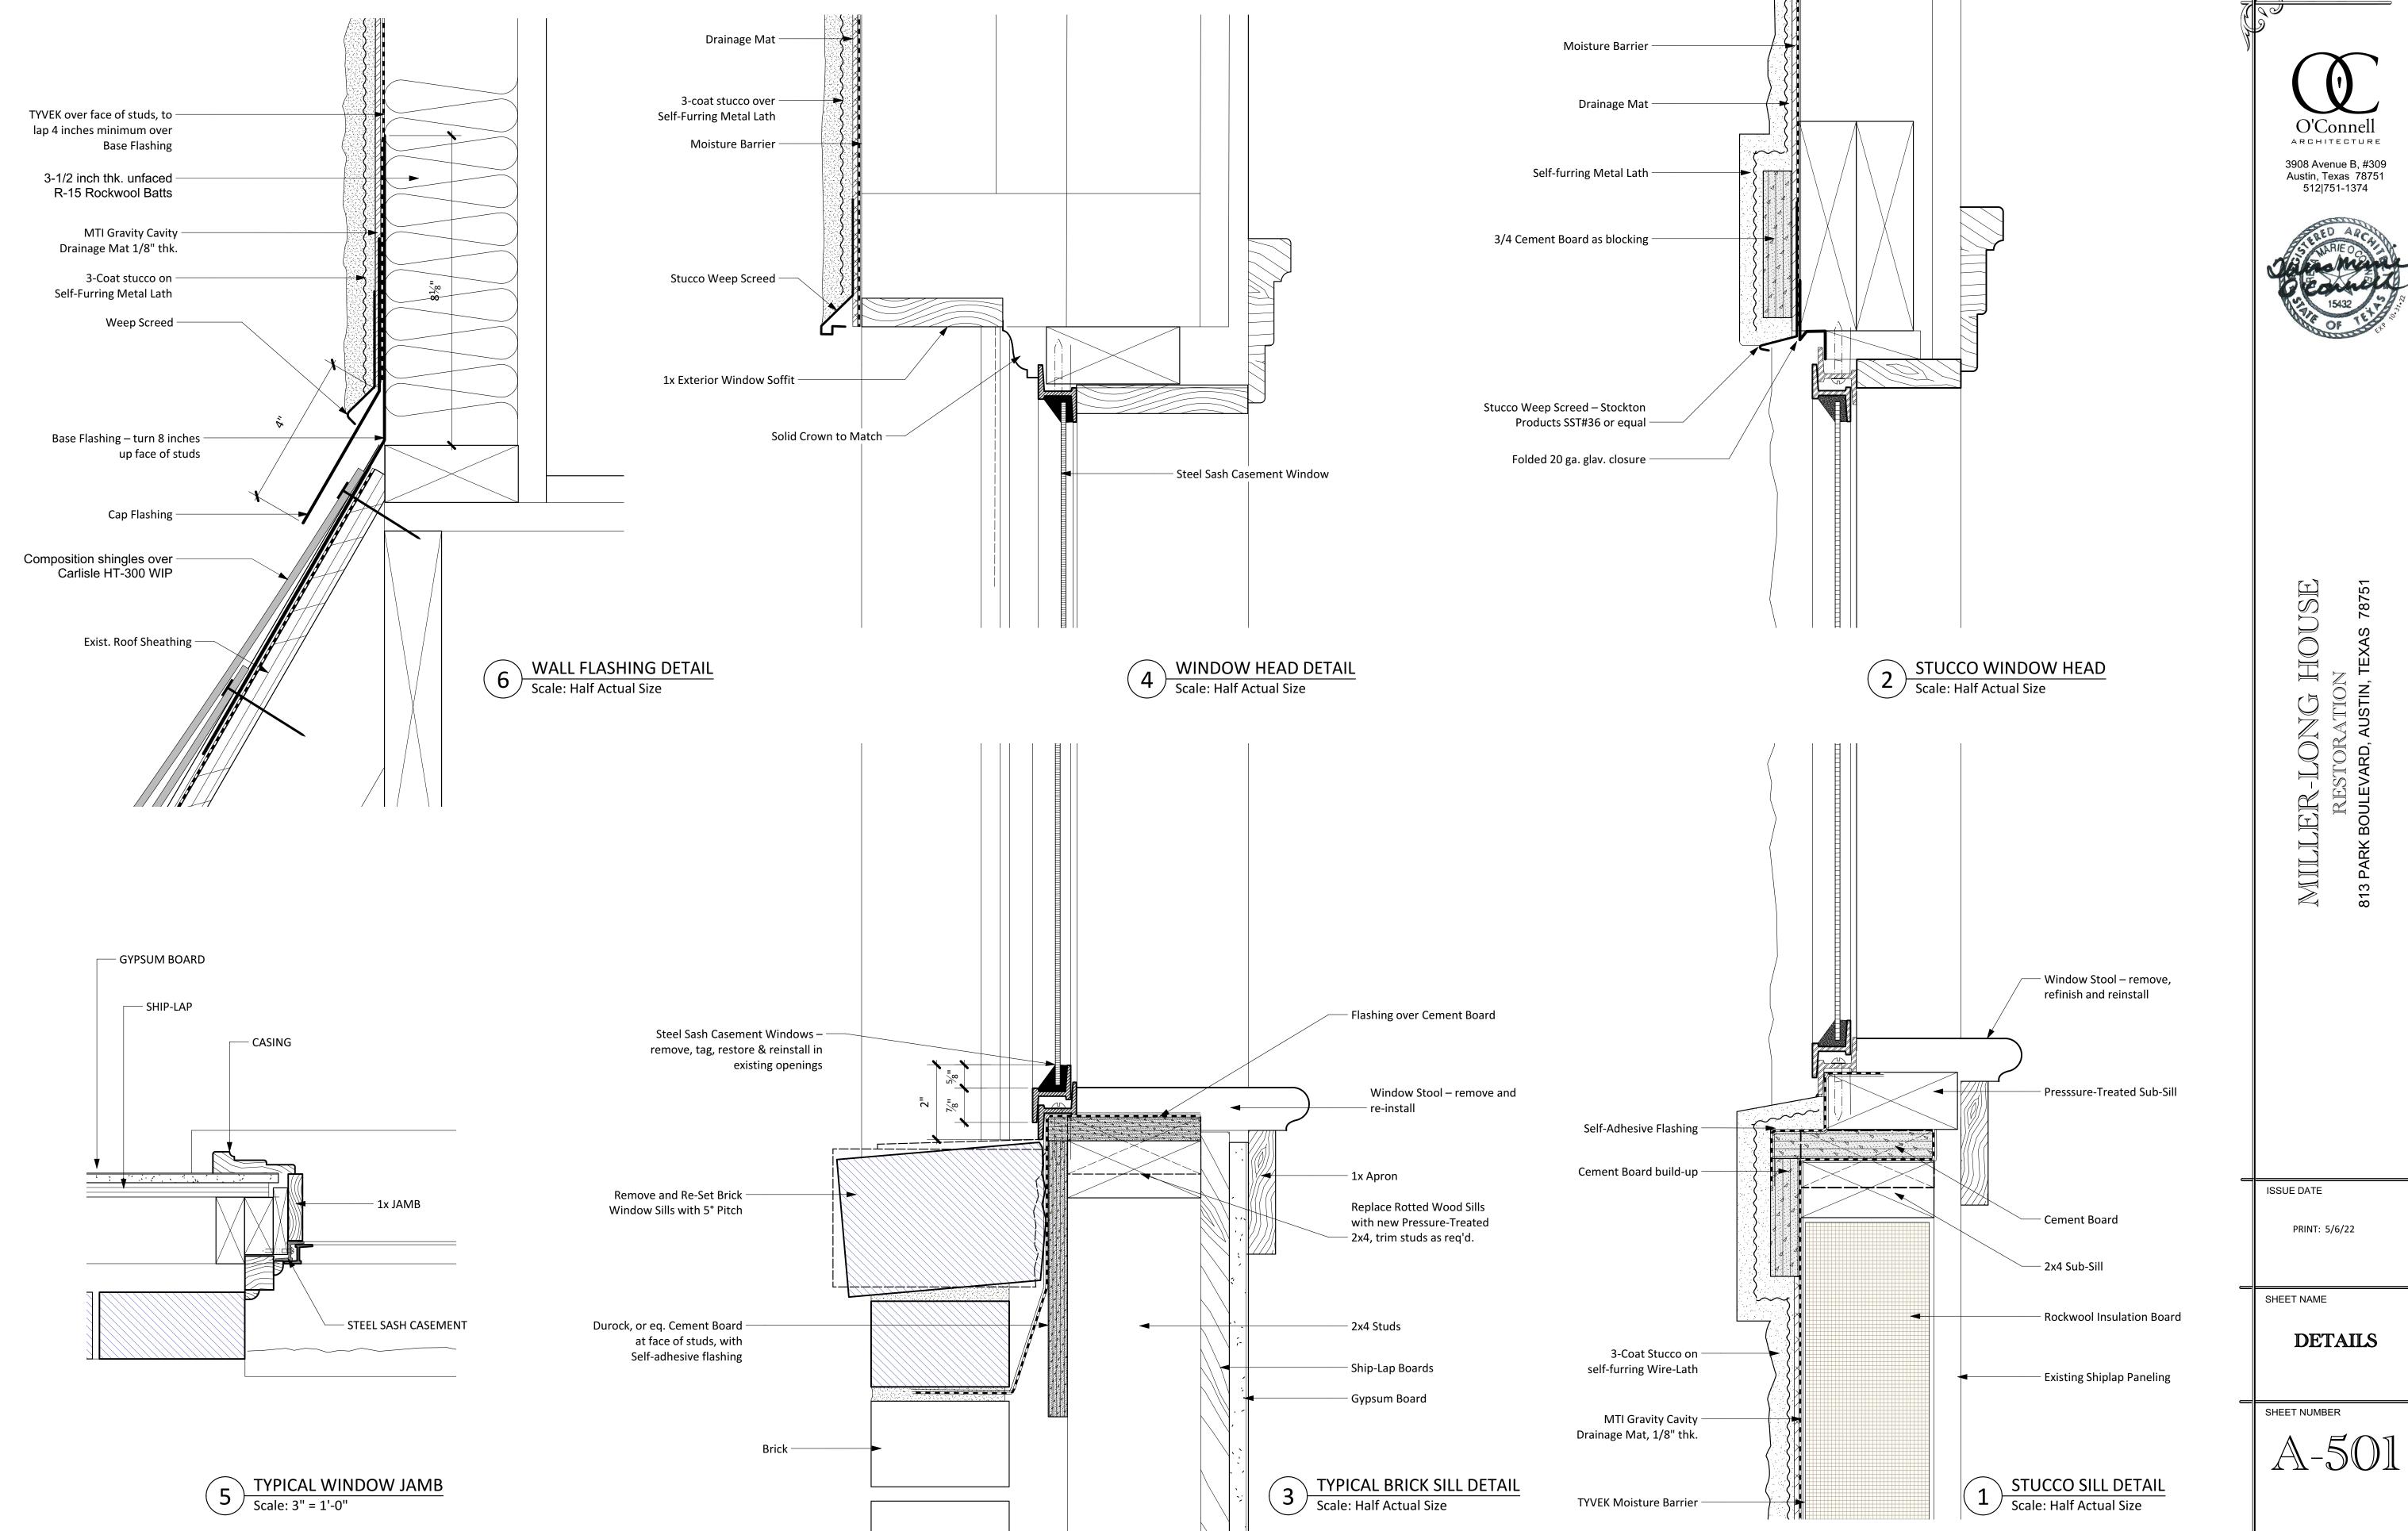





Austin, Texas 78751

512|751-1374



HOUSE 

ISSUE DATE

PRINT: 5/6/22

SHEET NAME

DOORS & WINDOWS

SHEET NUMBER

 Outswing Sash 11/4"

Fixed Sash Head & Jamb Scale: Half Actual Size

French Csmt. Meeting Stile

Outswing Sash

Frame

Scale: Half Actual Size

Csmt. Sill Detail


2¾"

G Hopper Jamb Detail
Scale: Half Actual Size

Scale: Half Actual Size

\ Fixed Transom over Csmt. Scale: Half Actual Size

Fixed Transom Bar

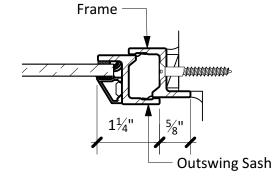


Csmt. Jamb Detail Scale: Half Actual Size

Basis of Window Design: Torrance Steel Window Co, 2600 Series

All Dimensions on details shown at the exterior of window


Installation shall conform to details on Sheet A-501

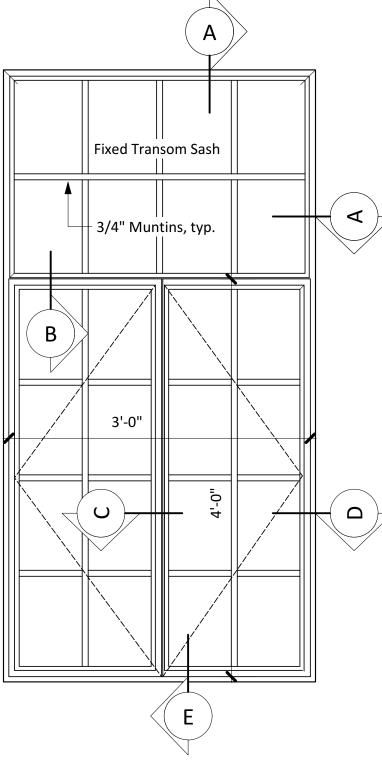


WINDOW 47 (New) Scale: 1" = 1'-0"


NEW BSMT. WINDOWS
Scale: 1" = 1'-0"


( U

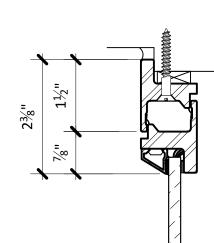


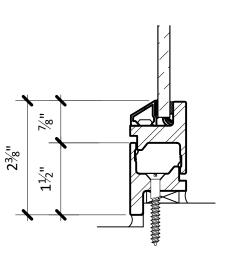

Hopper Sill Detail
Scale: Half Actual Size

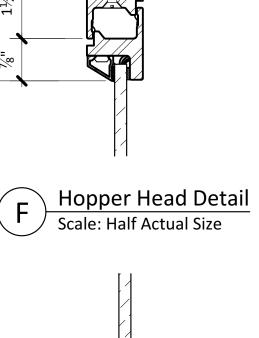

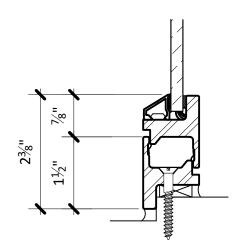

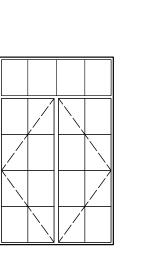

WINDOW SCHEDULE

Mark Room

1 Sun Room

2 Sun Room

3 Living Room

4 Living Room

5 Half Bath #1

8 Guest Room

9 Guest Room

10 Guest Room

11 Guest Room

14 Half Bath #2

15 Dining Room

16 Dining Room

17 Dining Room

18 Dining Room

19 Living Room

20 Living Room

21 Sun Room

21 Sun Room

22 Sun Room

23 Sun Room

24 Sun Room

25 Sun Room

26 Sun Room

27 Sitting Room

28 Sitting Room

29 Bedroom 4

30 Bedroom 4

31 Bedroom 2

32 Bedroom 2

33 Bath 1

34 Bath 1

35 Bath 3

36 Bedroom 3

37 Bedroom 3

38 Bedroom 3

39 Media Room

40 Media Room

41 Sitting Room

42 Sitting Room

43 Sitting Room

44 Sitting Room

45 Sitting Room

46 Attic - North Side

48 Attic - East Side

THIRD FLOOR

47 Attic

49 Attic

50 Basement

51 Basement

BASEMENT

SECOND FLOOR

12 Bath Guest Rm. #1

13 Bath Guest Rm. #1

6 Entry

7 Closet

FIRST FLOOR

CONTRACTOR TO FIELD VERIFY ALL DIMENSIONS

Height

5'-1"±

5'-1"±

5'-1"±

5'-1"±

4'-1"±

4'-1"±

5'-1"±

5'-1"±

5'-1"±

5'-1"±

4'-1"±

4'-1"±

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5'-1"± 5'-1"±

5'-1"±

5'-1"±

6'-2"

6'-3"±

6'-2"

2'-2"

2'-2"

Dimensions

Width

3'-1"±

3'-1"±

3'-1"±

3'-1"±

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2'2" DIA

1'-7"±

3'-1"±

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3'-1"±

3'-1"±

1'-7"±

2'-9"

2'-9"

Velux venting skylight or approved equal

Α

B sim

Material Lites

4x5 lights

4x5 lights

4x5 lights

4x5 lights

2x4 lights

2x4 lights

4x5 lights

4x5 lights

4x5 lights

4x5 lights

2x4 lights

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6x5 lights

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2x3 lights

2x4 lights

6x5 lights

6x5 lights

6x5 lights

4x4 lights

4x5 lights

2x6 light-arch

2x5 light-arch

4x6 lights

3x2 lights

3x2 lights

Steel

Steel

Steel

Steel

Wood

Steel

Head Ht

7'-4 ½"

7'-4 ½"

7'-4 ½"

7'-4 ½"

6'-6"±

6'-6"±

7'-4 ½"

7'-4 ½"

7'-4 ½"

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7'-2"

7'-2"

9'-2"

9'-0"

8'-0"

Notes

Interior wooden screens

Interior wooden screens

Interior wooden screens

Interior wooden screens

Remove and Salvage for Parts

Remove and Salvage for Parts

Interior wooden screens

Interior wooden screens

Interior wooden screens

Interior wooden screens

Missing right-hand sash

Interior wooden screens

Interior wooden screens, mismatched handle

Replace missing center bar to match original

New window sim to type A, but with add'l

New window to replace missing original

New window to replace missing original

Sprung L/H Sash


No transom

transom row


3-lite tall operable sash


Missing Center Bar


HINGE SIDE

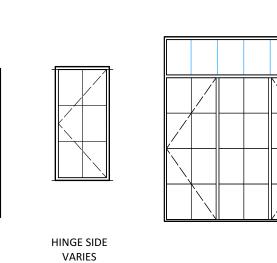

D

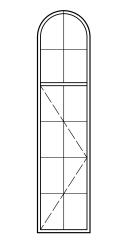

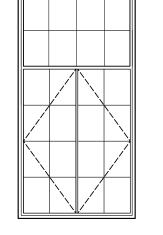


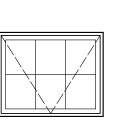



Η

WINDOW TYPES Scale: 3/8" = 1'-0"

VARIES

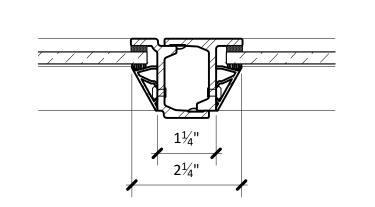

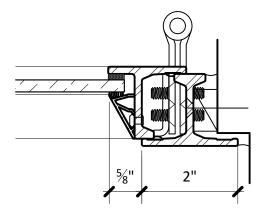

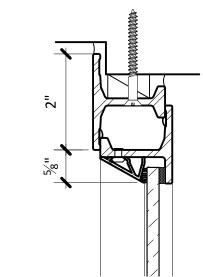




6'-2"

Verify Existing Opening Width



Plain Bottom Panel, Align to Existing Window Sill Height



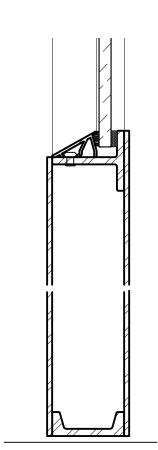


Scale: 1" = 1'-0"


$\bigwedge$	Door Bottom Rail
A	Scale: Half Actual Size


000.0.1 1 0
Basis of design: Torrance Steel Window
Co. 1900 Series French Door

	_		Dimension	<u> </u>	Material	Lites	Notes
Mark	Room	Туре	Width	Height			
101	Front Door	F	3'-4"	7'-0"	Wood		Refinish historic Front Door
102	Entry Closet	А	2'-0"	6'-8"	Wood		Sand & refinish
103	Entry Half Bath	А	2'-0"	6'-8"	Wood		Sand & refinish
104	Bed Room #1	С	(2x) 2'-0"		Wood		planked @ inner, consult with archited
105	Closet- Bed Room #1	А	2'-8"	6'-8"	Wood		Reverse Swing, sand & refinish
106	Bath- Bed Room #1	А	3'-0"	6'-8"	Wood		New Door
107	Living Room	С	(2x) 2'-0"	7'-2"	Wood		planked @ inner, sand & refinish
108	Living Room	D	(2x) 2'-8"	7'-2"	Wood	15 each	Pair of historic French doors, sand & re
109	Living Room	D	(2x) 2'-8"	7'-2"	Wood	15 each	Pair of historic French doors, sand & re
110	Sun Room	E	2'-10"	7'-9"	Wood	8 lights	Refinish door and hardware
111	Dining Room	В	2'-8"	7'-2"	-		Salvage
112	Opening-close up		2'-8"	6'-8"	-		no door
113	Closet	А	2'-8"	6'-8"	-		Salvage for reuse
114	Kitchen	Α	2'-8"	6'-8"	-		Salvage for reuse
115	Back Stair	Α	2'-7"	6'-7"	Wood		Salvage for reuse
116	Rear Door from kitchen	G	2'-10"	6'-8"	Wood		Historic Door in Garage fits in existing
117	Kitchen back stair	Α	2'-6"	6'-8"	Wood		New Door
118	Cellar Stair	Α	2'-0"	6'-8"	Wood		New Door
119	Kitchen Half Bath	Α	2'-6"	6'-8"	Wood		New Door
120	Dining Room	cased opn'g	2'-8"	6'-8"	-		
121	Dining Room	cased opn'g	5'-4"	7'-2"	-		
122	Living Room	NEW			Steel		New French doors
201	Bed Room #2	Α	2'-8"	6'-7"	Wood		Reverse swing, sand & refinish
202	Bath- Bed Room #2	А	2'-8"	6'-8"	Wood		salvage door for use at #215
203	Closet- Bed Room #2	Α	2'-0"	6'-7 ½"	Wood		Salvage door to owner
204	Hall to Bath	Α	2'-8"	6'-7"	Wood		salvage door for use at #222
205	Closet	Α	2'-0"	6'-7 ½"	Wood		salvage door for use at #216
206	Bedroom #3	Α	2'-8"	6'-7 ½"	Wood		Reverse swing, sand & refinish
207	Bathroom #3	Α	2'-8"	6'-7"	Wood		salvage door for use at #219
208	Closet- Bedroom #3	А	2'-8"	6'-7"	Wood		Salvage door to owner
209	Closet	Α	2'-0"		Wood		Salvage door to owner
210	Bed Room #4	Α	2'-8"	6'-7 ½"	Wood		Sand & refinish
211	Bath-Bed Room #4	А	2'-8"		Wood		Salvage door for use at #217
212	Sitting Room	Α	2'-8"		Wood		Reverse swing, sand & refinish
213	Media Room	Α	2'-8"		Wood		Sand & refinish
214	Sitting Room	А	2'-8"		Wood		Sand & refinish
215	Bath- Bed Room #2	Α	2'-8"	6'-8"	Wood		Relocate door & frame 202, sand & ref
216	Closet- Bed Room #2	Α	2'-0"	6'-8"	Wood		Relocate door & frame 205, sand & ref
217	Laundry Closet	А	2'-8"	6'-8"	Wood		Relocate door & frame 211, sand & re
218	Closet Bed Room #3	Α	(2x) 1'-8"	6'-8"	Wood		New Door
219	Bath Bed Room #3	А	2'-8"	6'-8"	Wood		Relocate door & frame 207, sand & re
220	Closet Bed Room #4	А	2'-6"	6'-8"	Wood		New Door
221	Bath Bed Room #4	Α	2'-6"	6'-8"	Wood		New Door
222	Attic Stair	A	2'-8"	6'-8"	Wood		Relocate door & frame 204, sand & re
223	Closet Media Room	A	2'-6"	6'-8"	Wood		New Door
301	Attic	Α	2'-6"	6'-8"	Wood		New Door
302	Bath	A	2'-8"	6'-8"	Wood		New Sliding Barn Door
	1	+	-				:0

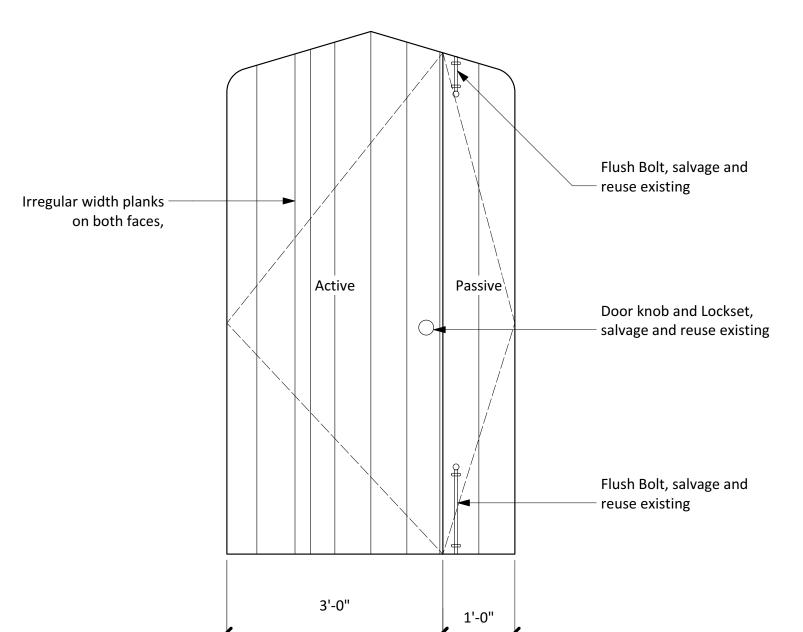


± 2'-11"

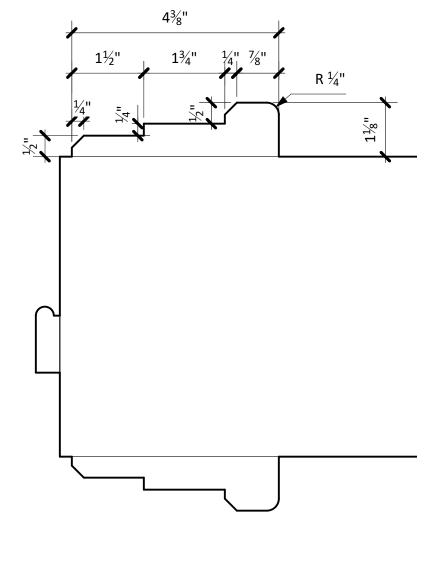

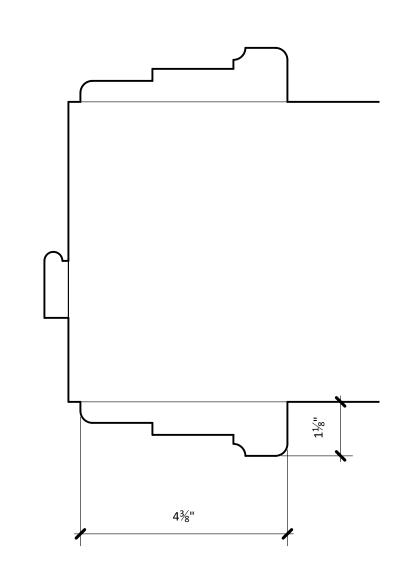


303 Linen Closet

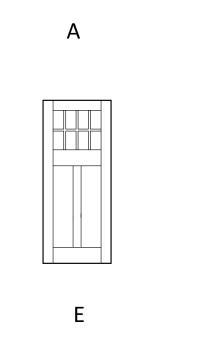


6'-8"


Wood

A 2'-0"

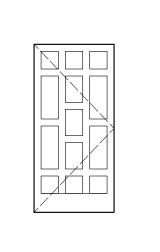

New Door

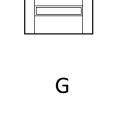

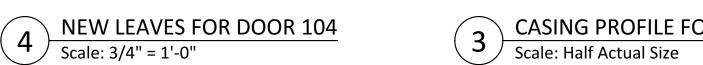


3 CASING PROFILE FOR NEW DOORS
Scale: Half Actual Size

2 Scale: Half Actual Size TYPICAL EXISTING DOOR CASING DOOR TYPES
Scale: 1/4" = 1'-0"



ARCHITECTURE

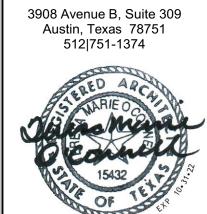

HOUSE 

ISSUE DATE

D


PRINT: 5/6/22

SHEET NAME


**DOORS** 

SHEET NUMBER

# **SYMBOL LEGEND**

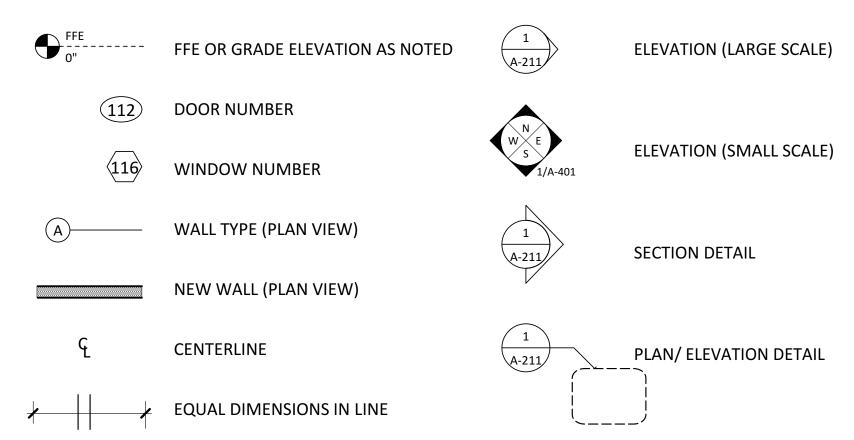

# **MATERIALS LEGEND**

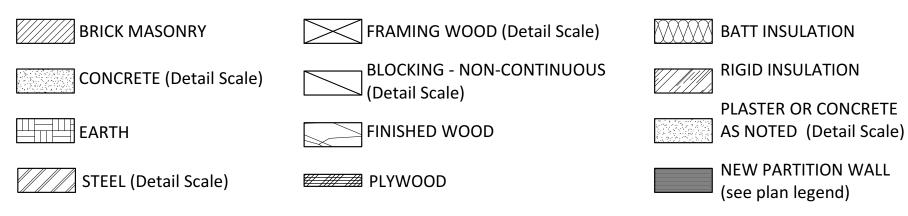


# **DESIGN TEAM**

#### **ARCHITECTURE**

O'CONNELL ARCHITECTURE, LLC TERESA O'CONNELL, AIA 3908 AVENUE B, SUITE 309 AUSTIN, TEXAS 78751 512.751.1374

#### STRUCTURAL ENGINEERING

TSEN ENGINEERING 210 BARTON SPRINGS RD., SUITE 250 AUSTIN, TEXAS 78704 512.474.4001

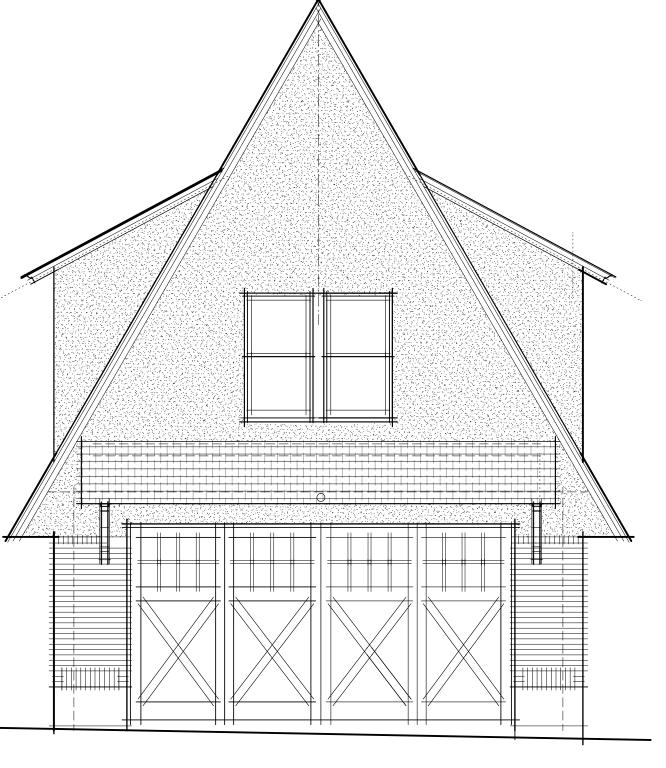

NORTH ELEVATION - FACING PARK BLVD

# **SHEET LIST**

## **Architectural Drawings**

	U
A-000	Cover Shee
A-900	Site Plan

Site Plan Demoltion Plans & Floor Plans North and West Elevations South and East Elevations Sections & Wall Details

A-905 Details

Garage Door Details Schedules & Lighting Plans

#### Structural Drawings

S-801 Structural Notes Structural Notes S-803 Structural Notes

Garage Foundation and Floor Framing Plan

S-902 Ceiling and Roof Framing Plan S-1001 Typical Details

S-1101 Foundation Details S-1201 Framing Details S-1202 Framing Details

# **GENERAL NOTES**

- 1. All work shall be performed in a professional matter, and in accordance with the International Residential Code, 2012, related trade codes, and applicable local codes, ordinances and laws.
- 2. Base drawings used in these documents were prepared by others, and may contain dimensional discrepancies. Contractor shall verity critical dimensions before beginning work. Do not scale drawings. Ask Architect for needed dimensions if not provided.
- 3. Historic designation of this building requires the Contractor and his subcontractors to exercise special caution in executing the work to prevent unnecessary damage to historic features, conditions, or materials. Contractor shall inform all subcontractors and workmen of these requirements.
- 4. The Contractor shall thoroughly example and familiarize himself with the requirements of the Contract Documents. Any conflicts shall be brought to the Architect's attention for resolution prior to the work being installed.
- 5. Perform all work in a safe and conscientious manner to prevent injuries and damage to the building and workers. Contractor shall maintain OSHA Standards for job safety and worker protection, and comply with applicable state and local government
- 6. Building permitting will be coordinated by the Owner and Architect prior to construction. Contractor is responsible for all trade permits, inspections, and compliance requirements.
- 7. Maintain the building and site in a clean and orderly condition.
- 8. The Contractor shall visit the site of the proposed work and full acquaint himself with the existing conditions regarding site access, staging, parking limitations, security, and other aspects of constructibility.
- 9. The Contractor shall coordinate work between all trades in this contract to ensure a smooth and timely workflow.
- 10. All work to be warranted for one year from the date of Substantial Completion unless otherwise noted.

# **HISTORY**

The Miller-Long House and Garage located at the corner of Park Blvd and Red River were constructed in the Tudor Revival style for Tom Miller and his wife Nellie in 1929. Tom Miller was an influential community leader who served as Mayor from 1933-1949 and 1955-1961, 22 years in all. The Tom Miller Dam is named in his honor.

Emma and Stuart Long purchased the property in 1950. Emma Long was the first female council member in Austin and later served as Mayor Pro Tem, another first for a woman. Long was a strong advocate for desegregation of public buildings, fair housing, and lower utility rates, as well as fair pay for firefighters, and police. Emma Long Park (formerly "City Park") is named in her honor.

Tom Miller and Emma Long are arguably two of Austin's most influential, effective, and dynamic leaders at a pivotal time in the city's history and development. A classic example of the Tudor Revival style of the early 20th century, the house has many distinctive features and finishes and remains closely associated with Miller and Long. Applications to the National Register of Historic Places and Austin Landmark designation are in process.

## **PROJECT INFORMATION**

LOT 33 AND 34 BLK 23 OLT 14 DIV C PERRY **LEGAL DESCRIPTION:** 

**ESTATE** 

SF-3 **ZONING:** 

**APPLICABLE CODE:** 

Secondary Dwelling **OCCUPANCY:** 

YEAR CONSTRUCTED:

**HISTORIC**: Officially determined eligible for individual

listing on the National Register of Historic

Places

# SITE LOCATION MAP HYDE PARK ERSITY Square Peg Coffee Company CENTRAL AUSTIN

# **AREA CALCULATIONS**

811 Park - Lot 33		8662
813 Park - Lot 34		14427
	Total Lot Area per UDA	23089
Gross Floor Area		
Main House - Existing to Remain	First Floor	1637
	Second Floor	1637
	Attic over 6 ft. hgt.	709
	Area - House	3983
Secondary Dwelling (This Permit)	Ground Floor (conversion from garage)	575
	Second Floor	57!
	Area - ADU	115
Floor/Area Ratio		22.2%
Impervious Cover		
House - Existing (NIC)		163
Stair and Site Wall - Existing		34
Garage/Apartment - Existing		57.
Concrete Driveway		1554
Easement Access Drive		1289
Concrete Walks		350
Transformer Pads (NIC)		14
New stone wall		
Terrace, ramp, and stairs		
New path to Perry gate		
Brick Walk - New		11
AC Pad - New		
Total Impervious Cover		570
% Impervious Cover		24.7%

ISSUE DATE

PRINT: 5/6/22

MIII GE A

ARCHITECTURE

3908 Avenue B, Rm 309

Austin, Texas 78751

512|751-1374

SHEET NAME COVER

SITE PLAN

NOTES

SHEET NUMBER

# **ABBREVIATIONS**

&	And
#	Pound
@	At
A/C	Air Conditioning
ACOUST	Acoustical
ADD'L	Additional
ADJ	Adjacent
AFF	Above Finish Floor
AHJ	Authority Having Jurisdiction
AHU	Air Handling Unit
APPROX	Approximately
ARCH	Architect
ASTM	American Society for Testing
	& Materials
BRD	Board
BLDG	Building
BDRM	Bedroom
BTWN	Between
CAB	Cabinet
CL	Centerline
CLG	Ceiling
CLO	Closet
CLR	Clear

COMP Composite

CONC CONT COORD Coordinate, Coordination Critical Root Zone Cold Water Deep, Depth, Dryer Double DEMO Demolish, Demolition D-H Double Hung Diameter Diagonal, Diagonally Downspout Dishwasher DWG DWR

Drawing

Expansion Join

Equal Spacing, Equivalent

Electric Meter

Equipment

Exterior

EXST'G Existing

Drawer

East

EQ

EQUIP

EXT

Each

Floor-Area Ratio FIN Finish(ed) FIXT Fixture FLR Floor Feet, Foot FTG Footing Field Verify FV HT Field Verify Height Gauge GALV Galvanized GFCI Ground Fault Circuit Interrup GPM Gallons Per Minute GR **Gross Square Feet** GYP BD Gypsum Wall Board

Hose Bib

Hardwar

Horizontal

Heat/Ventilation/

Hour

Height

HB

**HDWR** 

HORIZ

Id Est (That Is) Inches Inaccessible INCL Including INSUL Insulation Interior Joist Length LB(S) Pound(s) Linear Foot Light Pole or Lightning Protection Light Louver MFGR Manufacturer MAX Maximum Mechanical

Mechanical/Electrical

Mechanical, Electrical

& Plumbing

Miscellaneous

Minimum

MTD

Not Applicable Not in Contract Number Net Square Feet NTS Not to Scale On Center OCEW On Center Each Way OP'G Provide & Install Photo Cell Plate or Plateline Pounds Per Square Foot Pounds Per Square Inch Pressure Treated

Painted

Plywood

Quarter

PVC

**PVMT** 

QTR

RCP Reflected Ceiling Plan RE/REF Reference REINF Reinforced REQ'D Required **REQMT'S Requirements** REV Roofing RM SALV Salvage Self-Adhering Underlayment SCH'D Scheduled Square Feet Sheet SIM Similar Sheathing SMACNA Sheet Metal & Air Conditioning National Association, Inc. SPECS Polyvinyl Chloride Specifications

SPEC'D

Specified

Stainless Stee

Radius/Refrigerator

THK Thick TOT Total TOW Top of Wall TRTD Treated TYP UNFIN UNO VERT W/O W/D WD WDW WH WM

Washing Machine With Without Wood Window Water Heater Water Meter

STRUCT Structural


T&G

TEMP


Tongue & Groove

Temporary, Tempered

Typical **Under Counter** Unfinished Unless Noted Otherwise Wide, Width, West, Stackable Washer Dryer

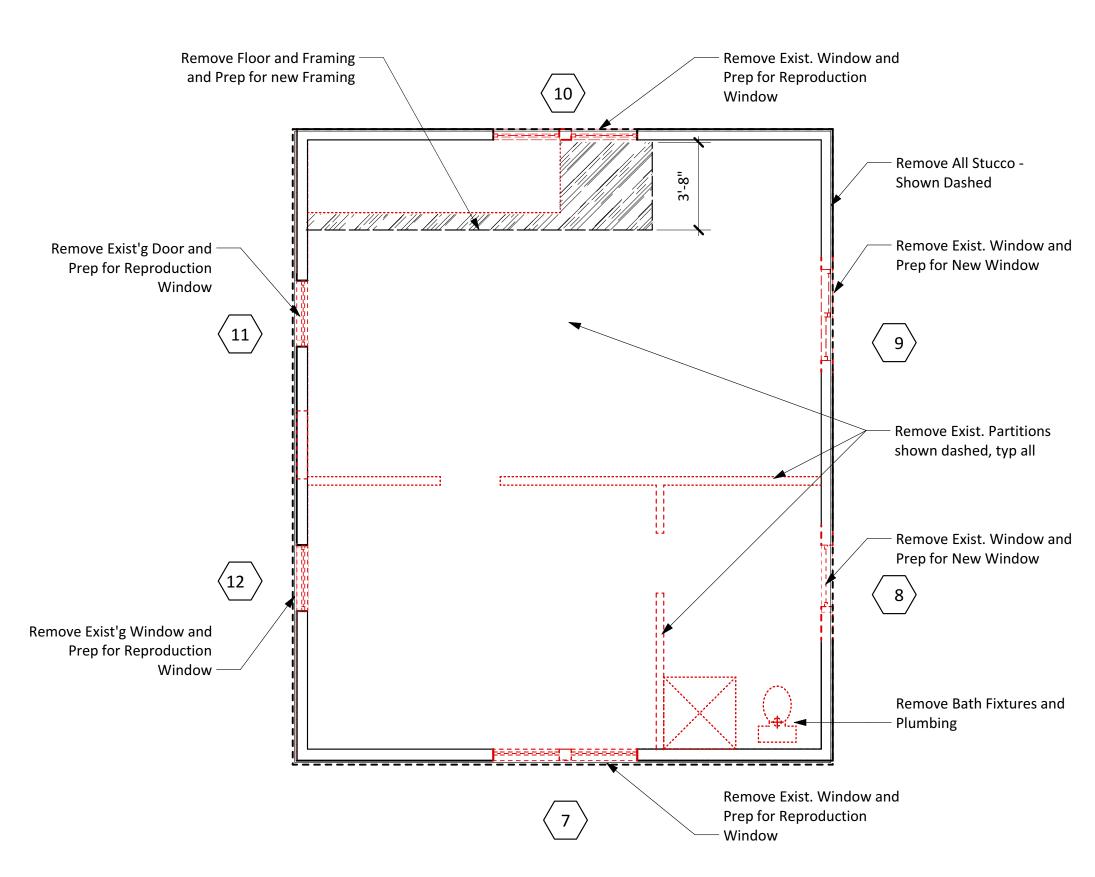


SECOND FLOOR - Demolition Plan
Scale: 1/4" = 1'-0"

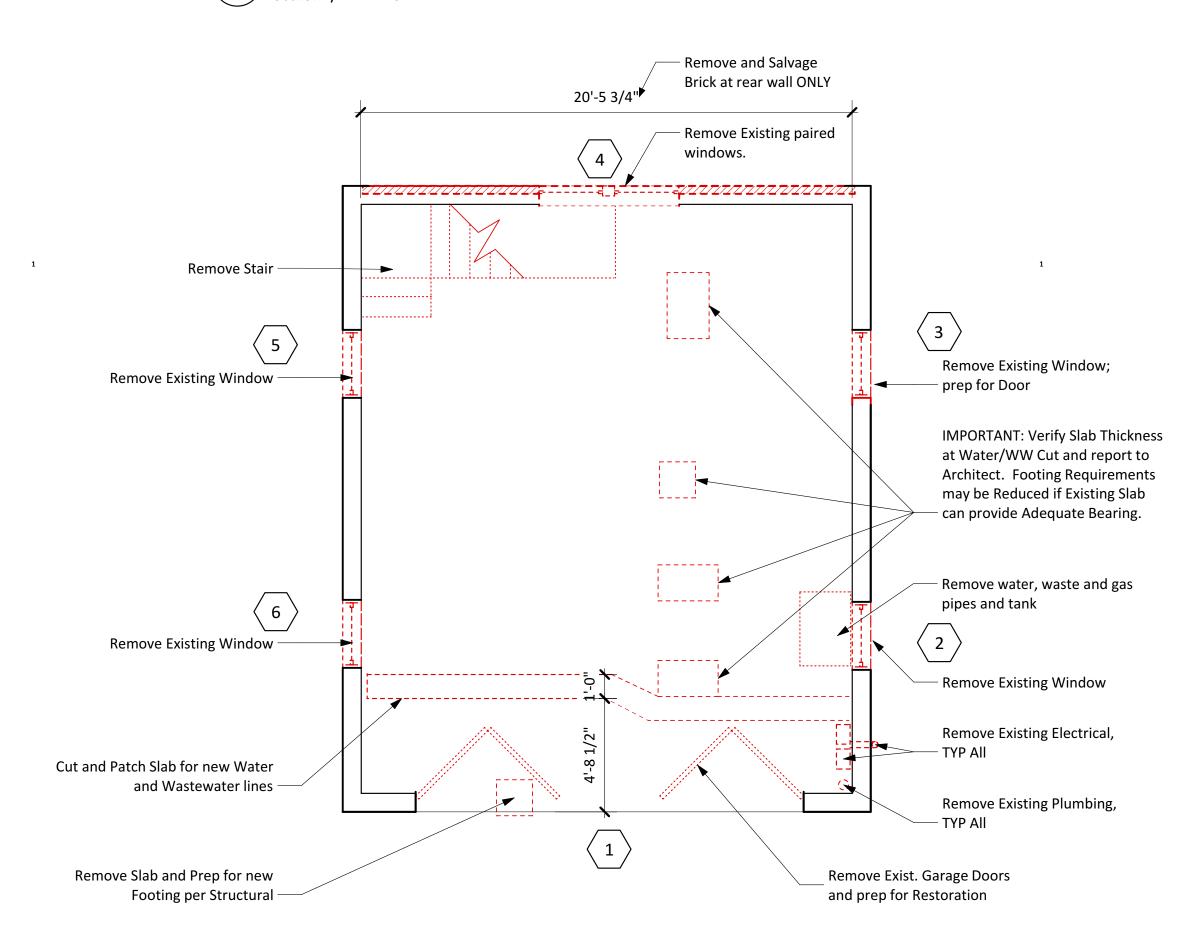

GROUND FLOOR - Demolition & Footing Work

Scale: 1/4" = 1'-0"

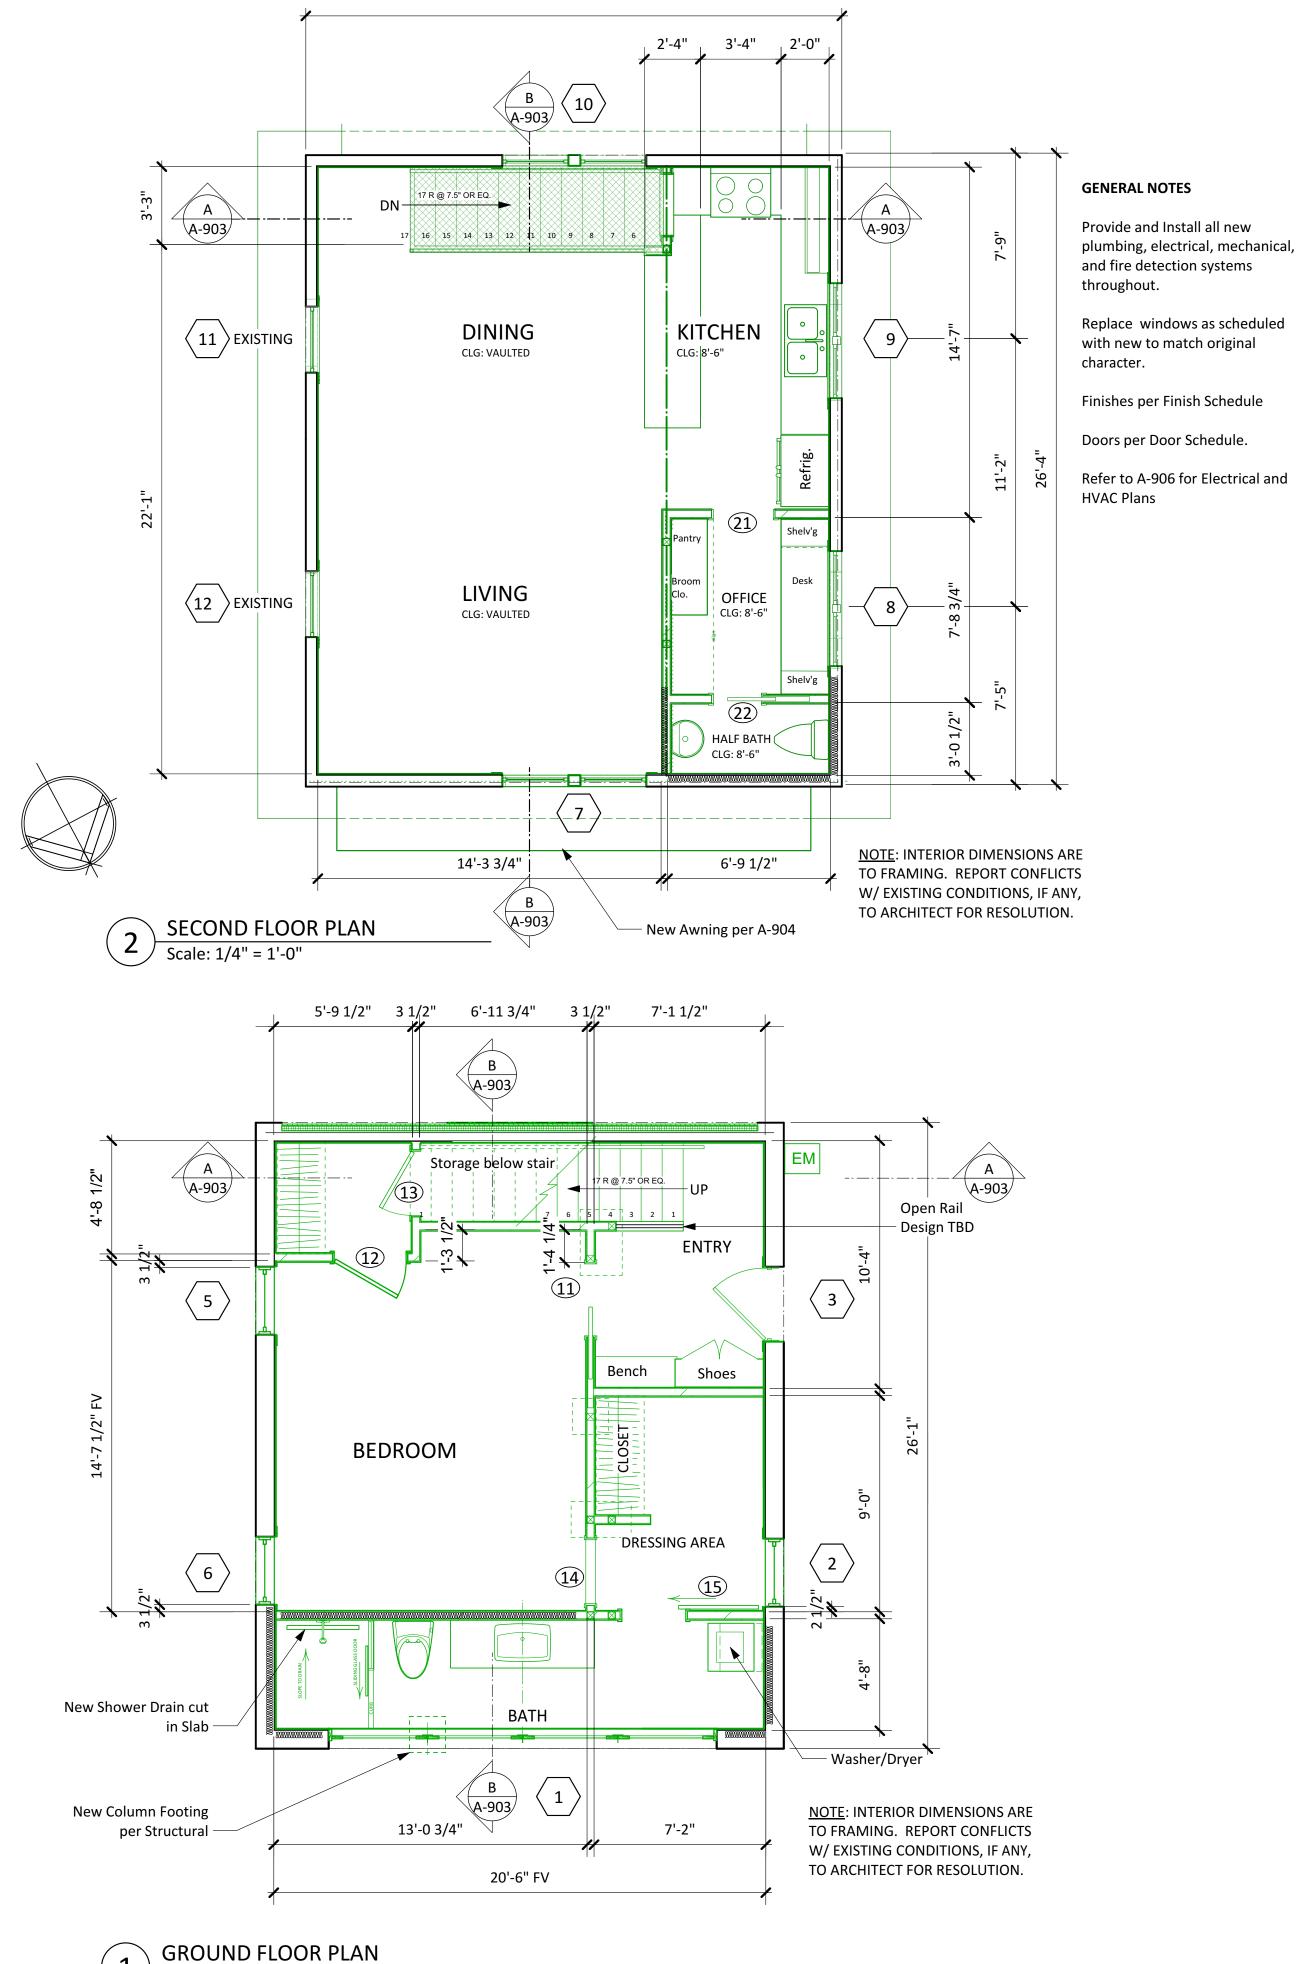

GROUND FLOOR PLAN
Scale: 1/4" = 1'-0"

O'Connell ARCHITECTURE

3908 Avenue B, Rm 309 Austin, Texas 78751 512|751-1374



EXP 10.31.21


ISSUE DATE

PRINT: 5/6/22

SHEET NAME


DEMO AND NEW PLANS

SHEET NUMBER

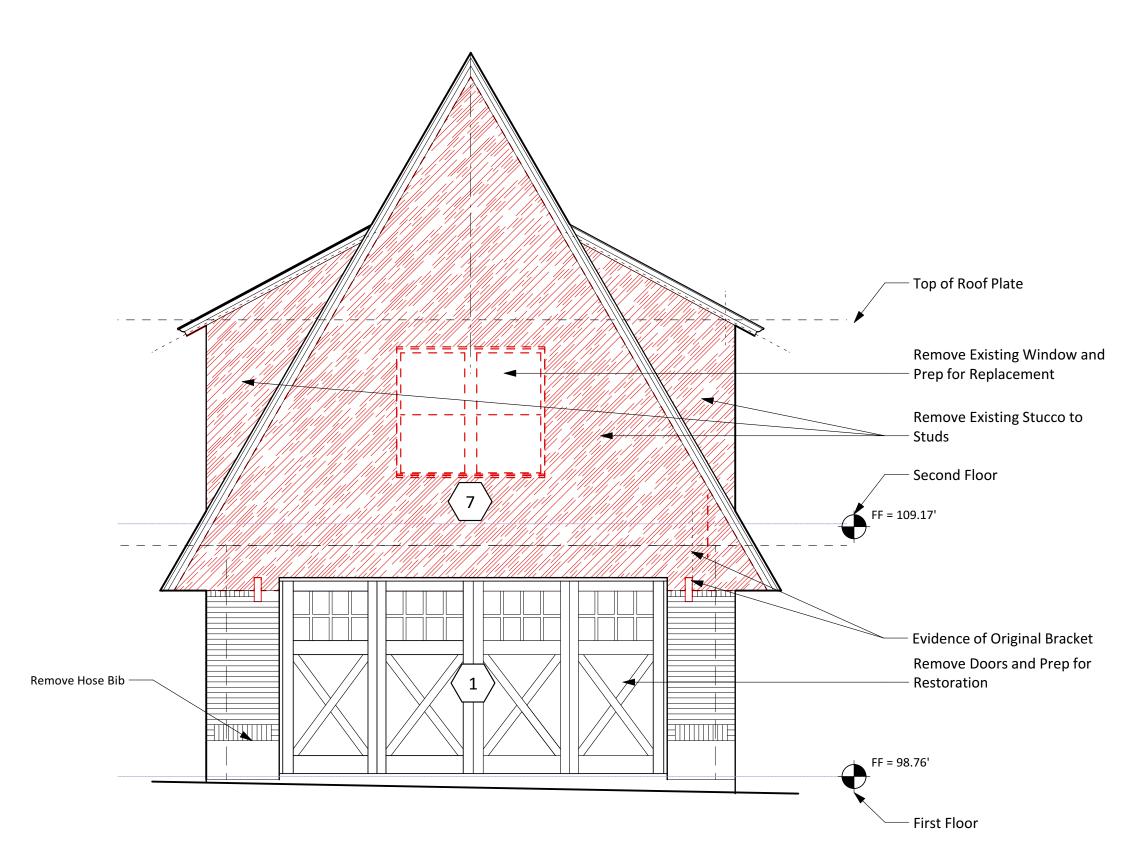


NORTH ELEVATION - Demolition

Scale: 1/4" = 1'-0"

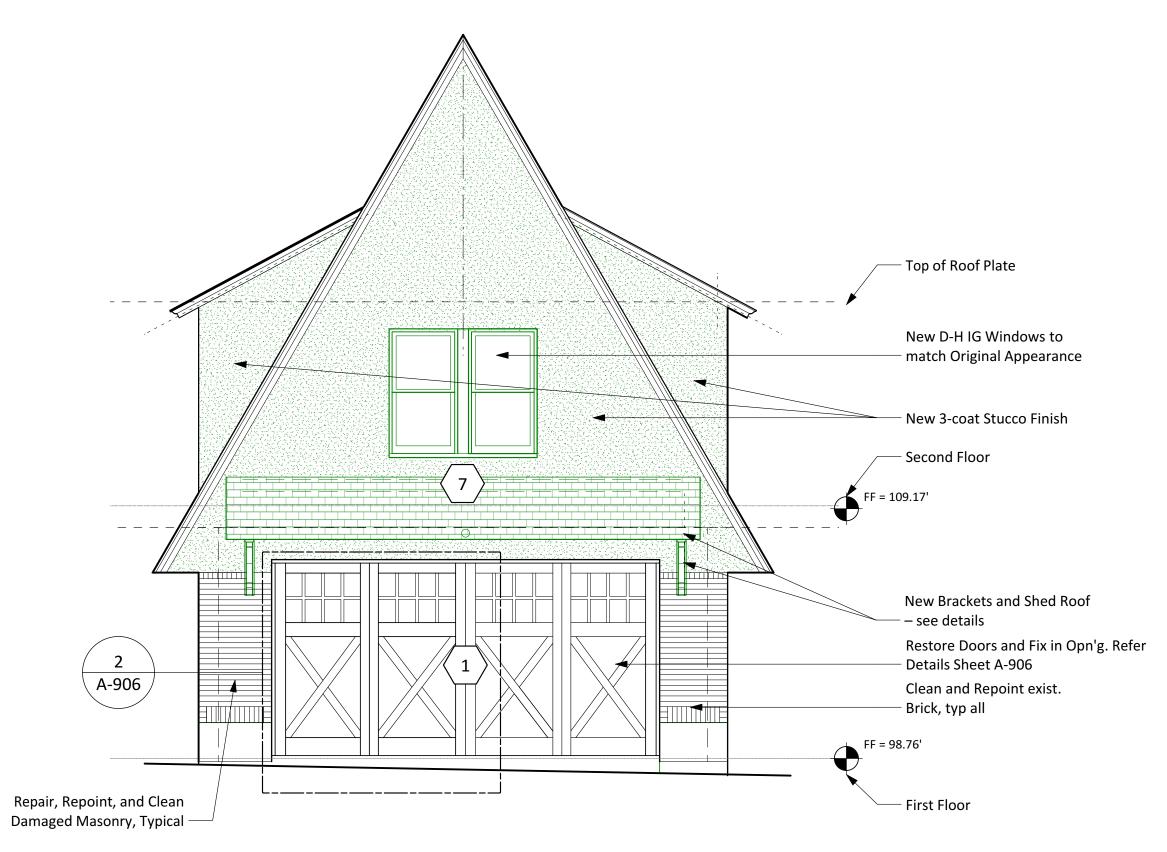

NORTH ELEVATION

Scale: 1/4" = 1'-0"

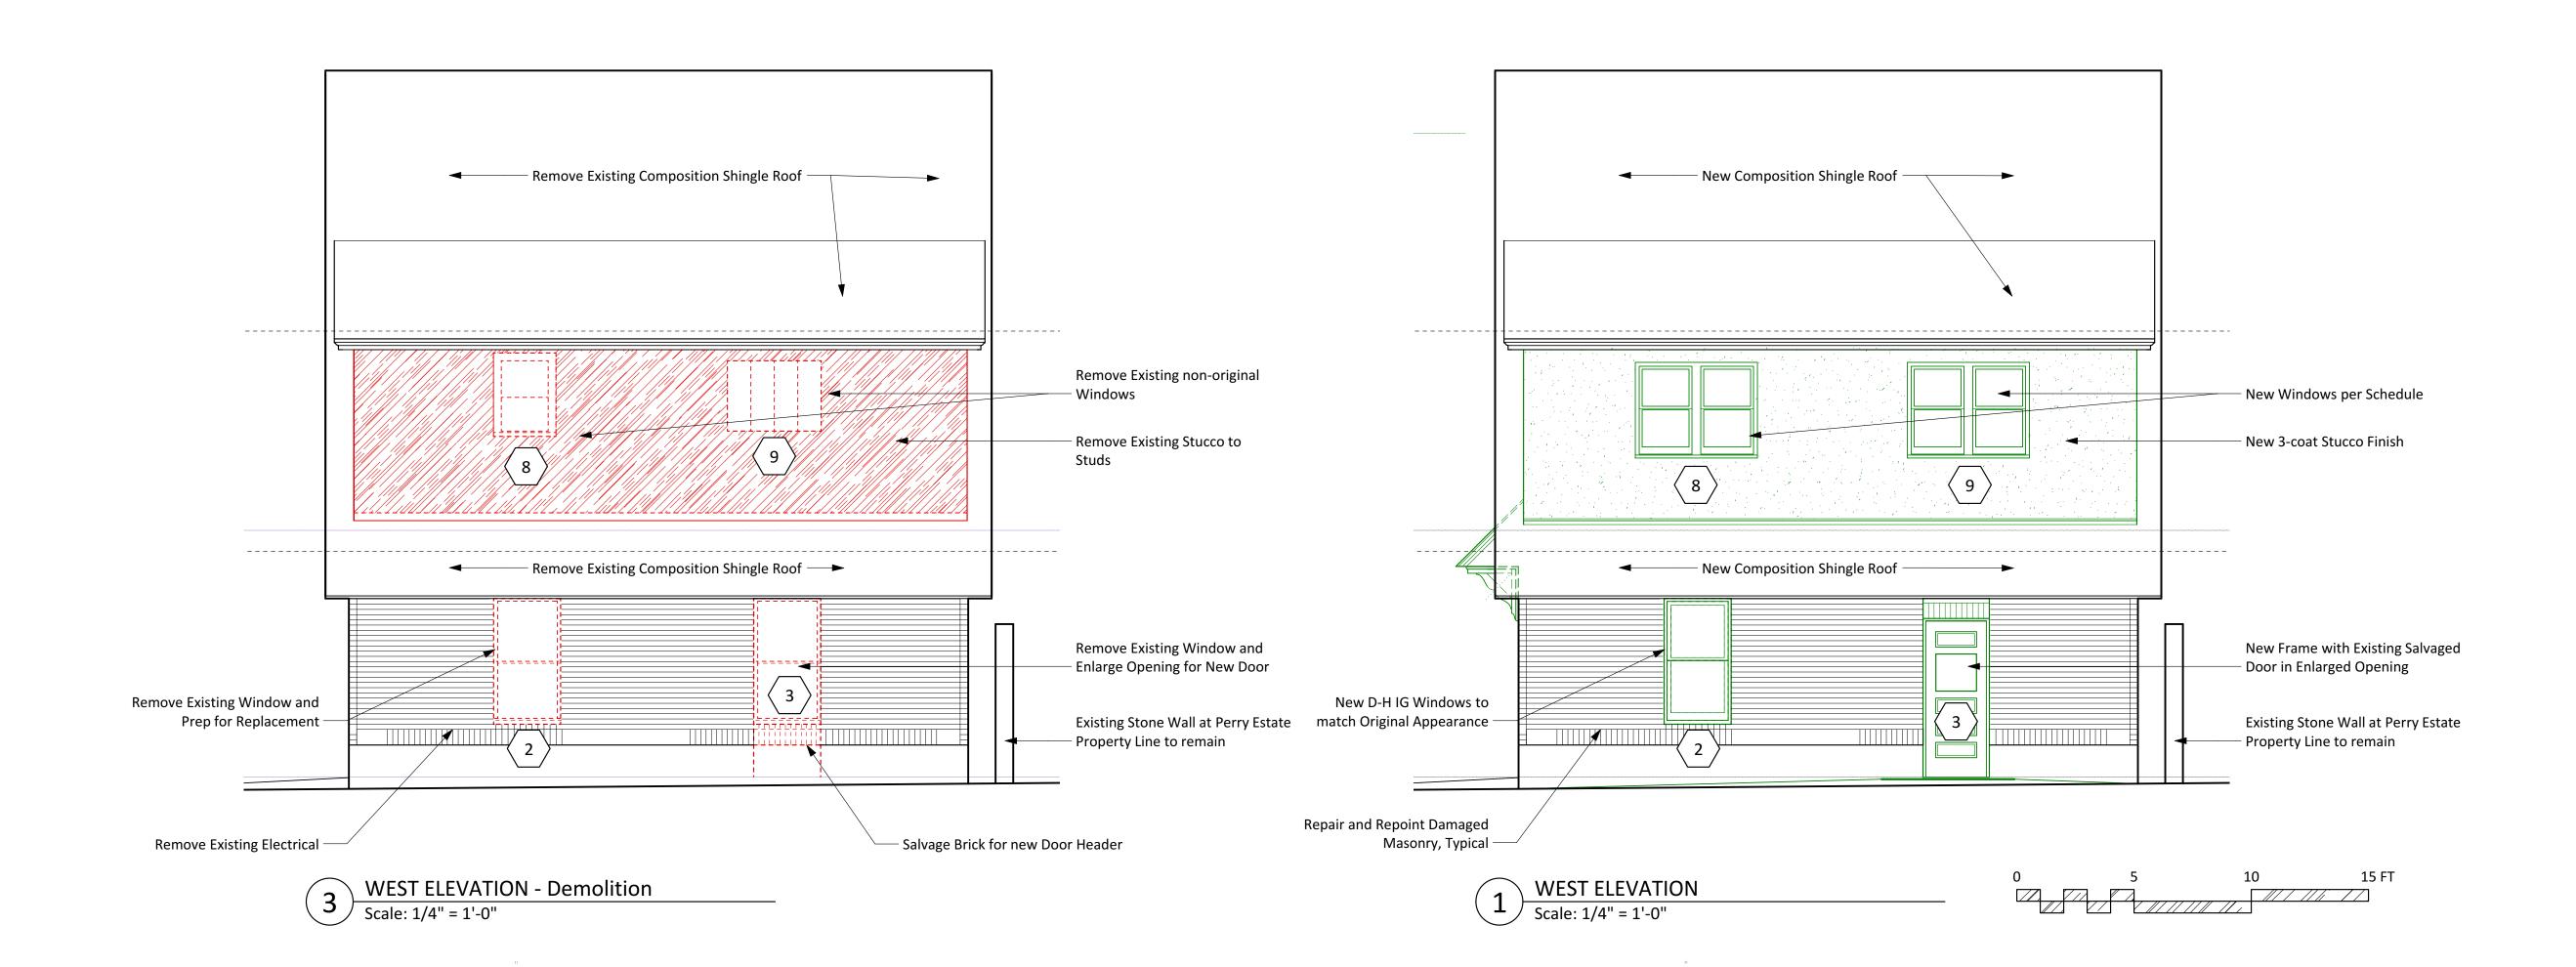

O'Connell ARCHITECTURE

> 3908 Avenue B, Rm 309 Austin, Texas 78751 512|751-1374



EXP 10.31

MILLER-LONG HOUSE

ARAGE APARTMENT RENOVATION

813 PARK ROLLI EVARD ALISTIN TEXAS 78751


ISSUE DATE


PRINT: 5/6/22


SHEET NAME


North and West ELEVATIONS

SHEET NUMBER

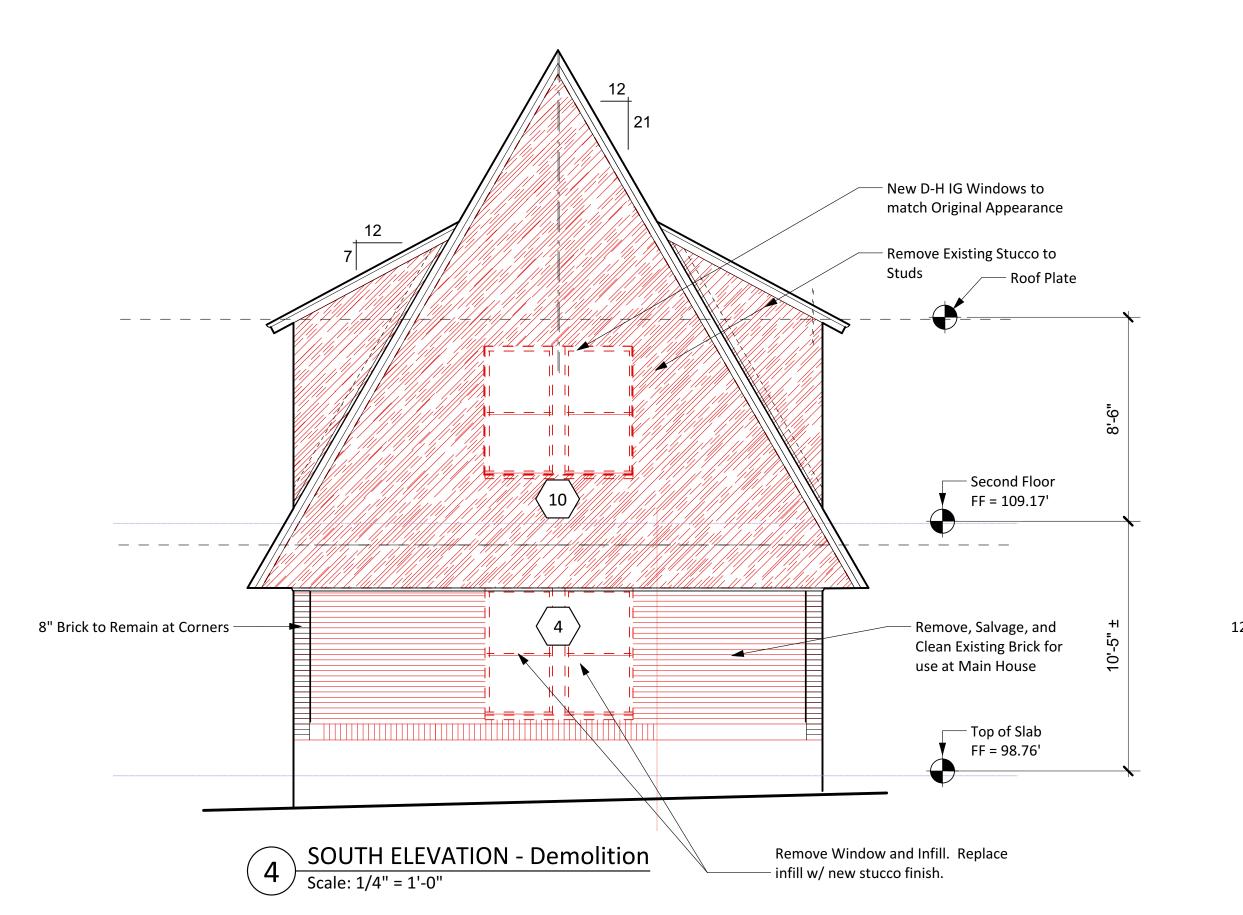

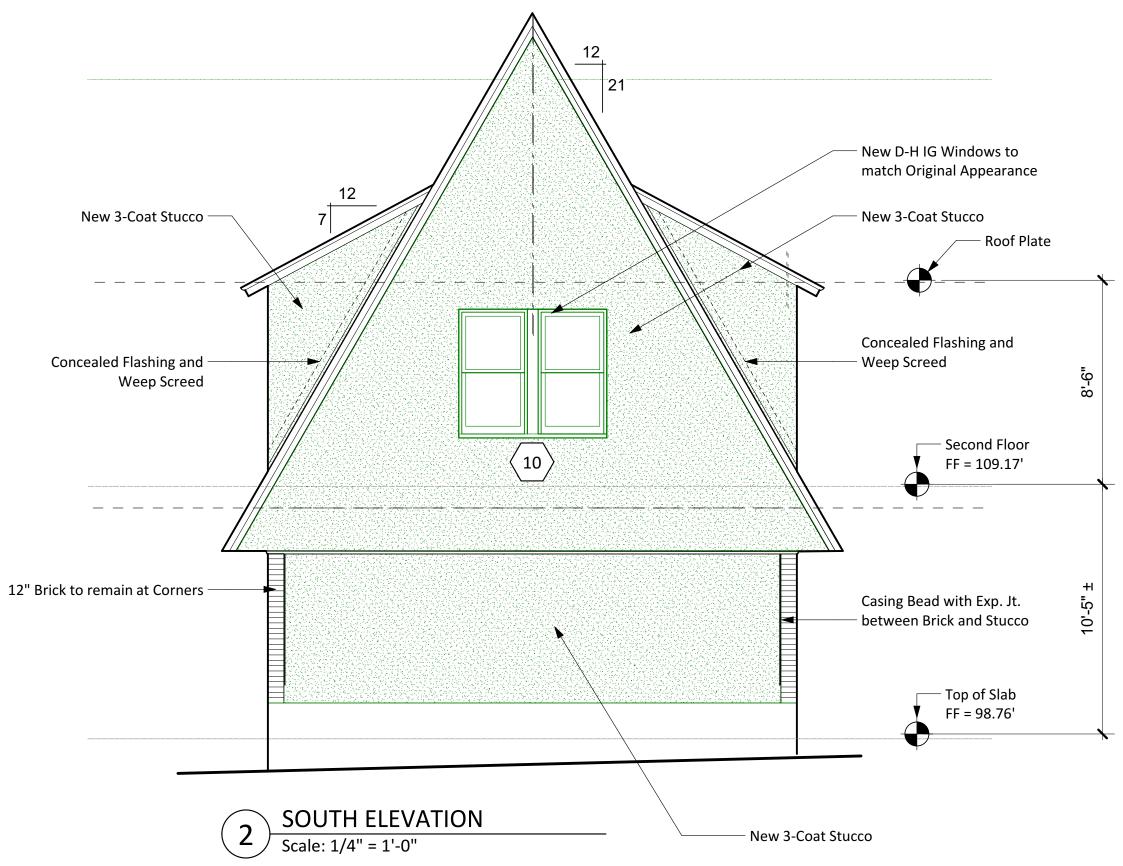

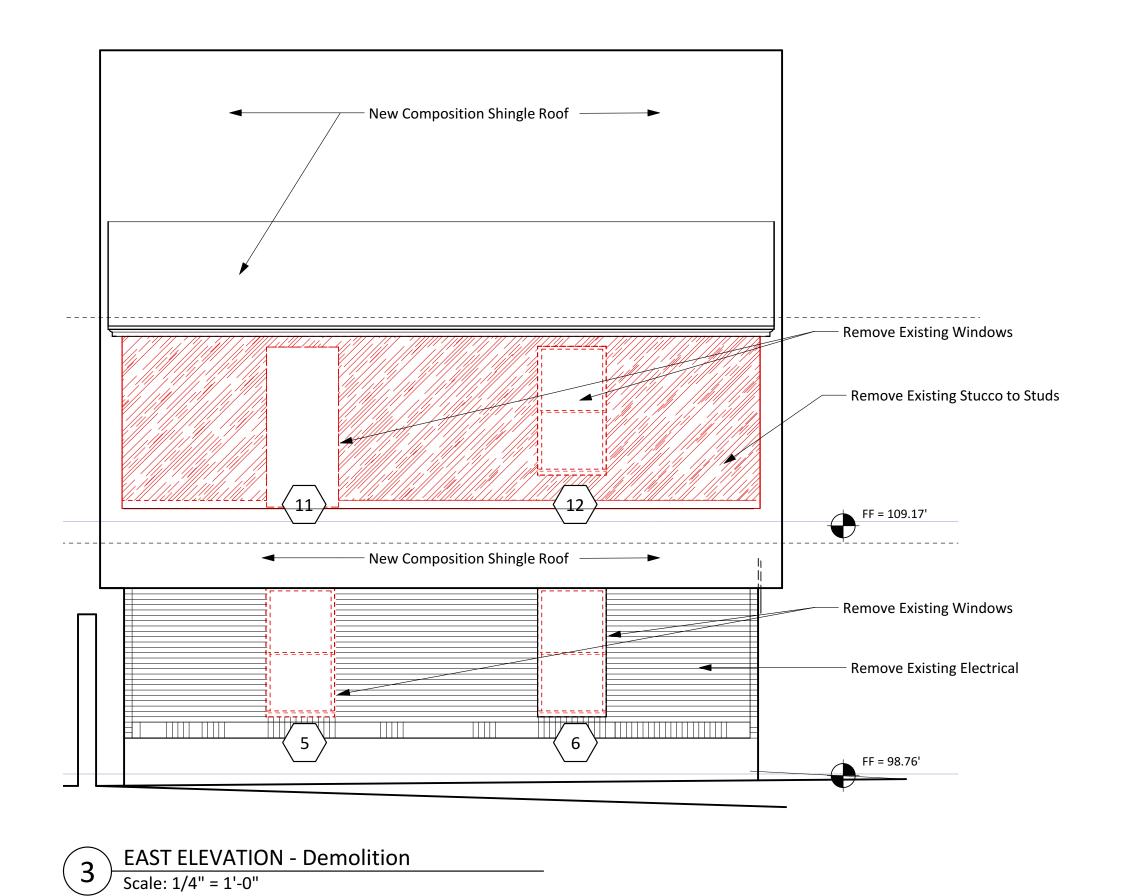

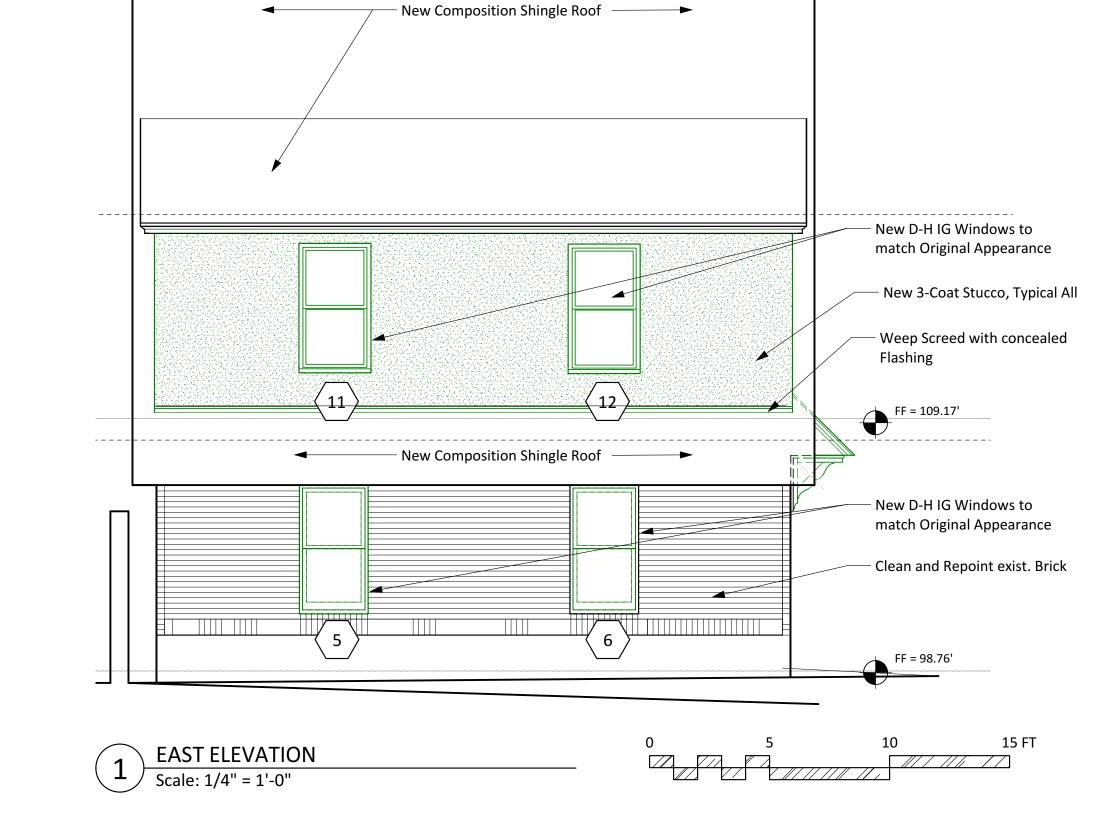

O'Connell
ARCHITECTURE

3908 Avenue B, Rm 309
Austin, Texas 78751
512|751-1374



EXP 10.31.21

MILLER-LONG HOUSE

JARAGE APARTMENT RENOVATION
813 PARK BOULFVARD AUSTIN TEXAS 78751


ISSUE DATE

PRINT: 5/6/22

SHEET NAME


South and East ELEVATIONS

SHEET NUMBER

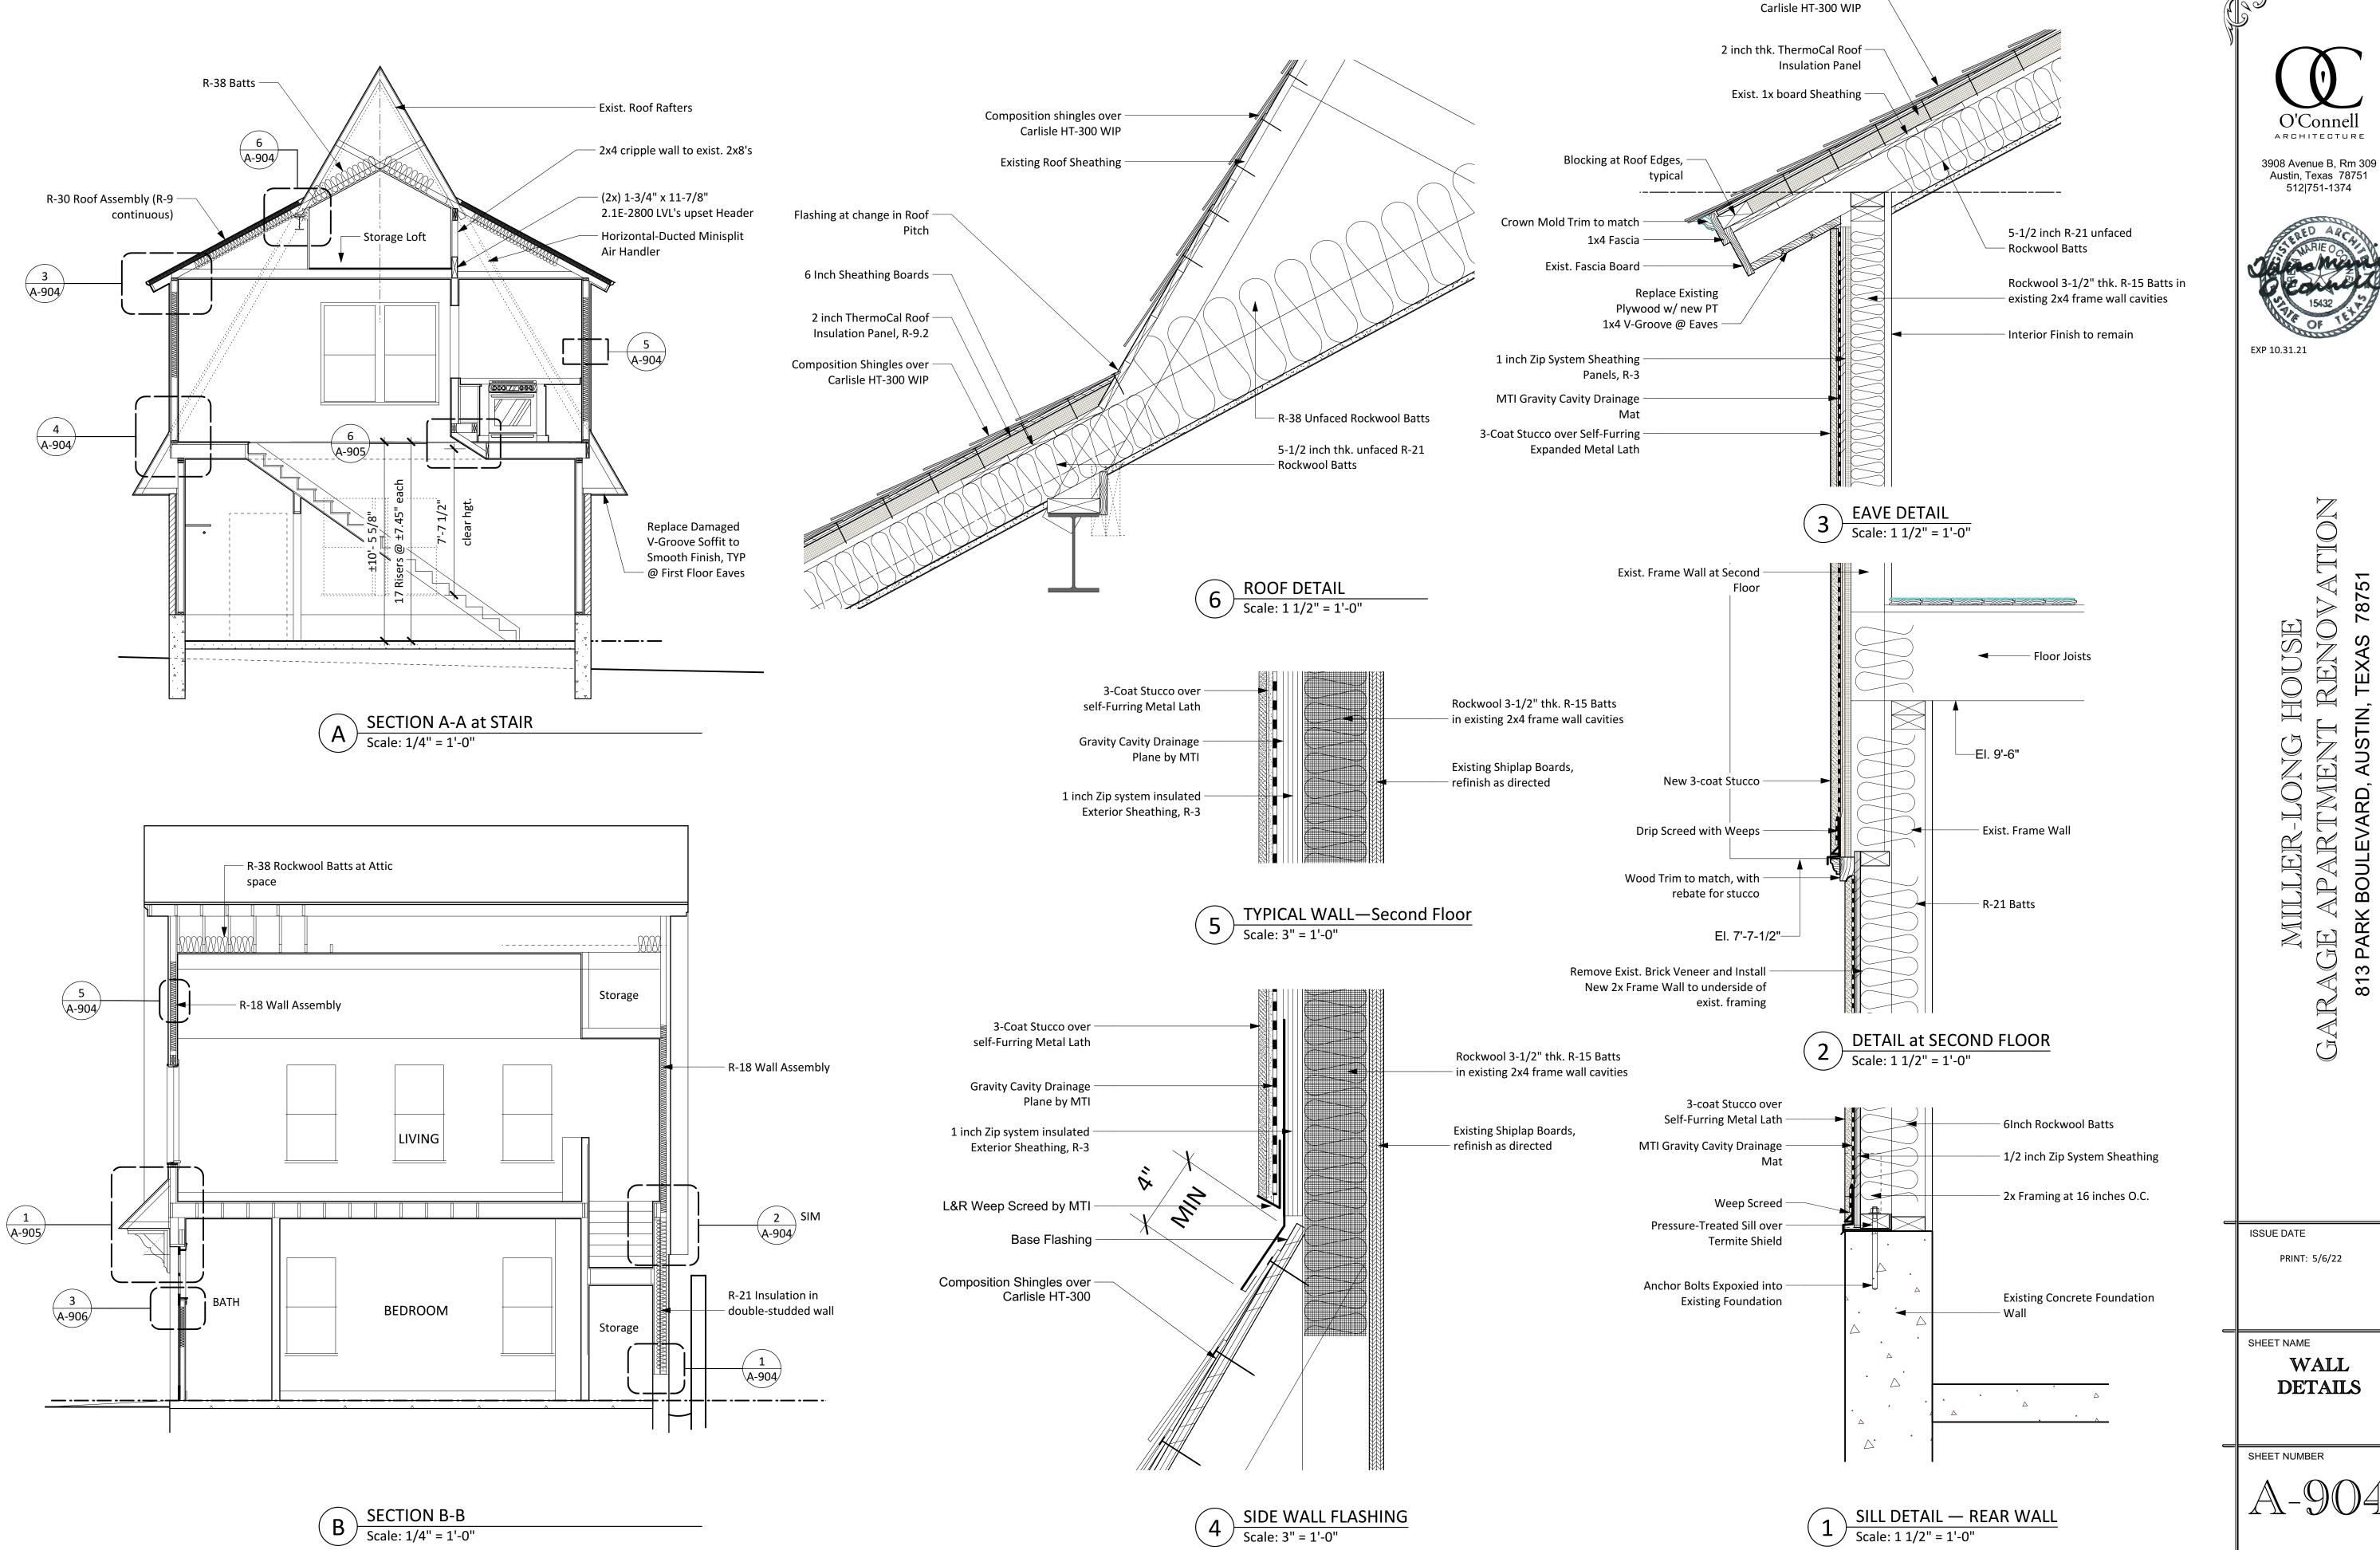



Composition Shingles over -



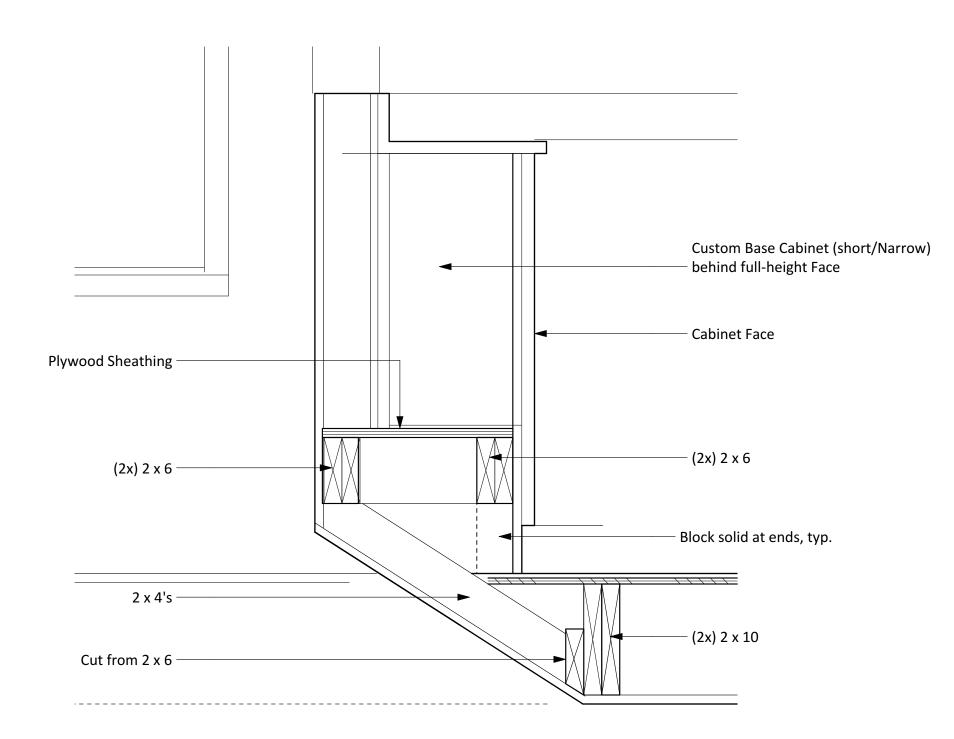


6 SPLAY at STAIR OPENING
Scale: 1 1/2" = 1'-0"

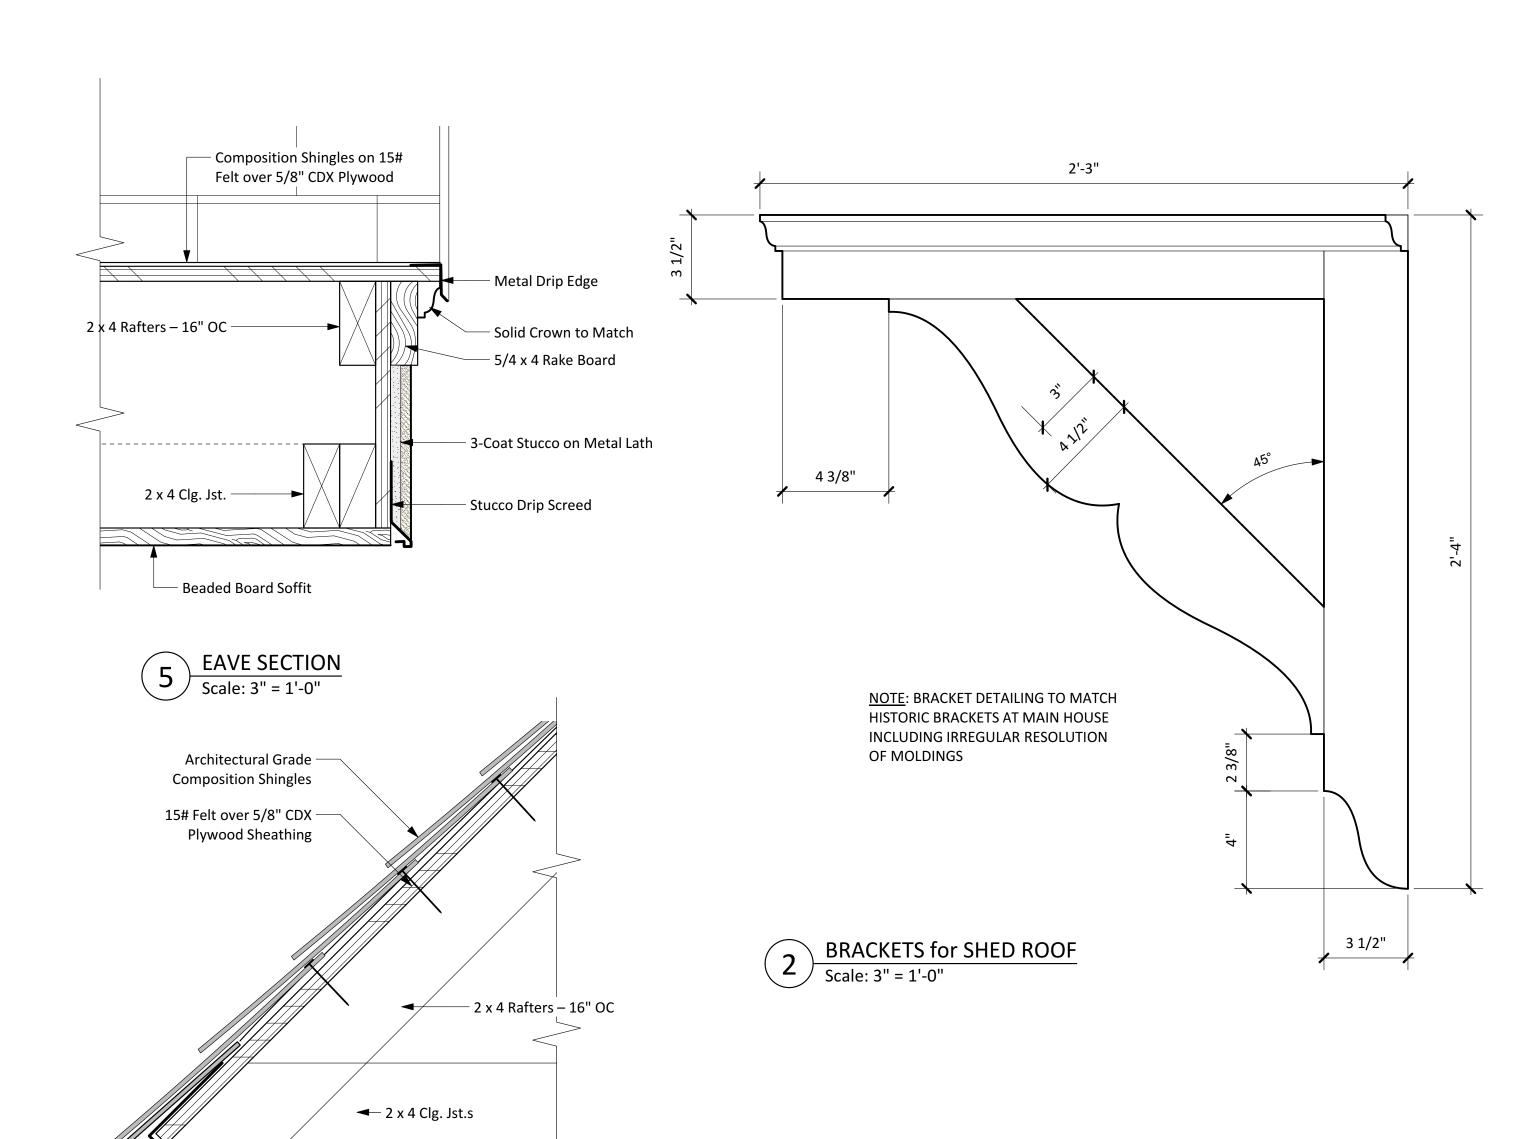


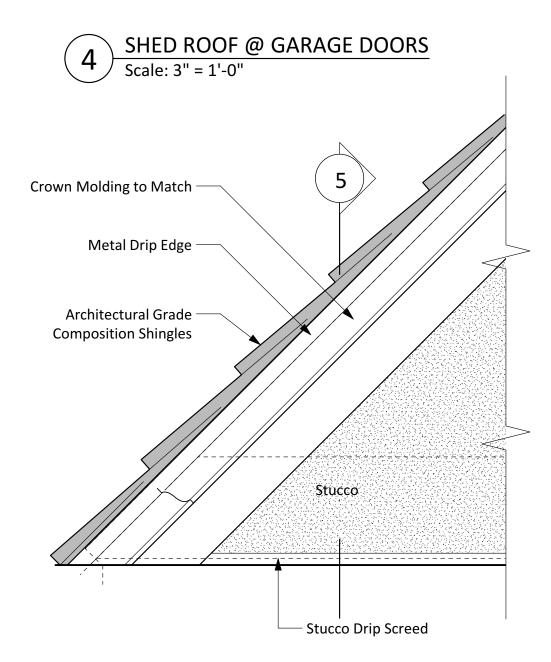

— Metal Drip Edge

└── V-Groove 1x4 T&G Soffit

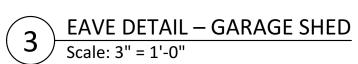

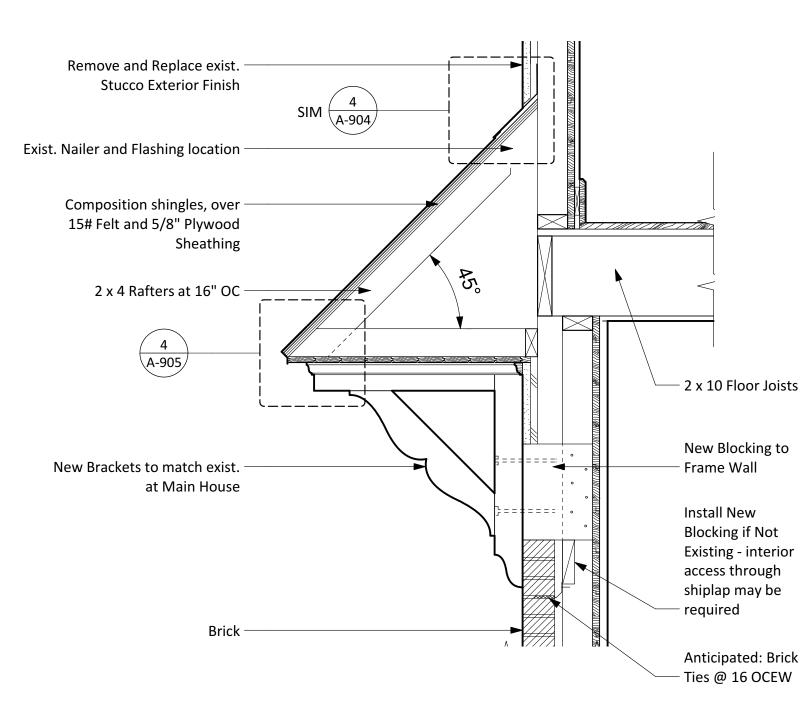

SHED ROOF over GARAGE DOORS
Scale: 1" = 1'-0"

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HOUSE I RENOVATION


MILLER-LONG HOUSI AGE APARTMENT REN( 813 PARK BOULEVARD, AUSTIN, TEXAS


ISSUE DATE

PRINT: 5/6/22


SHEET NAME **DETAILS** 

SHEET NUMBER A-905

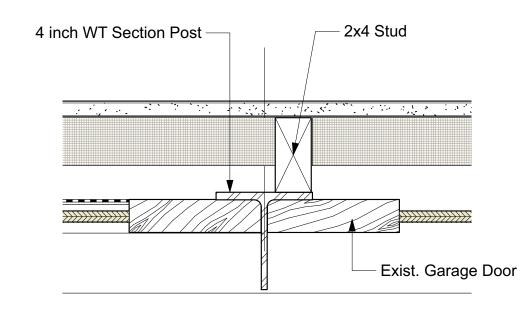


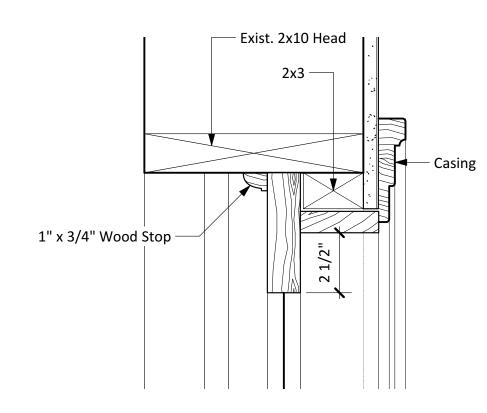

GARAGE DOOR — DETAIL
Scale: 3" = 1'-0"

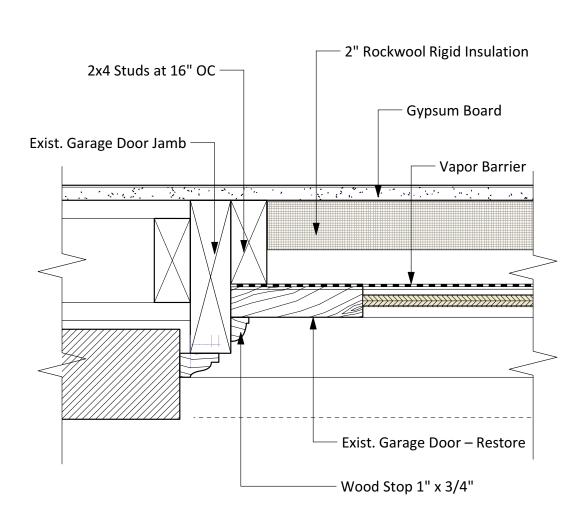

GARAGE DOOR – HEAD DETAIL
Scale: 3" = 1'-0"

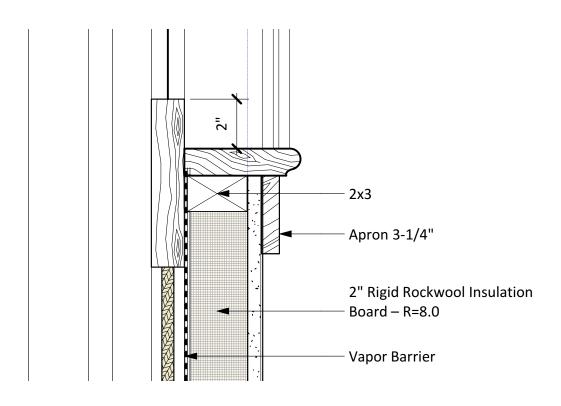

JAMB DETAIL – GARAGE DOOR
Scale: 3" = 1'-0"

3 GARAGE DOOR – SILL DETAIL
Scale: 3" = 1'-0"

