


EXISTING SITE PLAN

SCALE: 1/8" = 1'-0"

ARCHITECTURAL SHEETS		
ID	ID Name	
A001	EXISTING SITE PLAN	
A002	PROPOSED SITE PLAN	
A003	TRANSPORTATION STANDARDS	
A004	TREE PROTECTION PLAN	
A005	TREE PROTECTION PLAN	
A006	SUB CHAPTER F EXHIBITS	
A007	AE OH LINE EXHIBITS	
A008	SPECIFICATIONS AND SCHEDULES	
A009	ARCHITECTURAL FOUNDATION PLAN	
A010	FLOOR PLANS	
A011	FLOOR PLANS	
A012	ELECTRICAL PLANS	
A013	ROOF PLAN	
A014	EXTERIOR ELEVATIONS	
A015	EXTERIOR ELEVATIONS	

WATER SUPPLY LINE GAS SUPPLY LINE GOVERHEAD POWER LINE
-0 $-$ 0 $-$ 0 $-$ 0 $-$ 0 $-$ 0 $-$ 0 $-$ 0 $-$ 0 $-$ 0
TREE PROTECTION FENCII

RESIDENCE BRACKENRIDGE ATX **ARCHITECTS** p.o. box 81002, austin, tx 78708 512.809.0406 www.atxarchitects.com **EXISTING SITE PLAN** 220702 10/20/2022 Drawn: **EMP** EMP Sheet Number

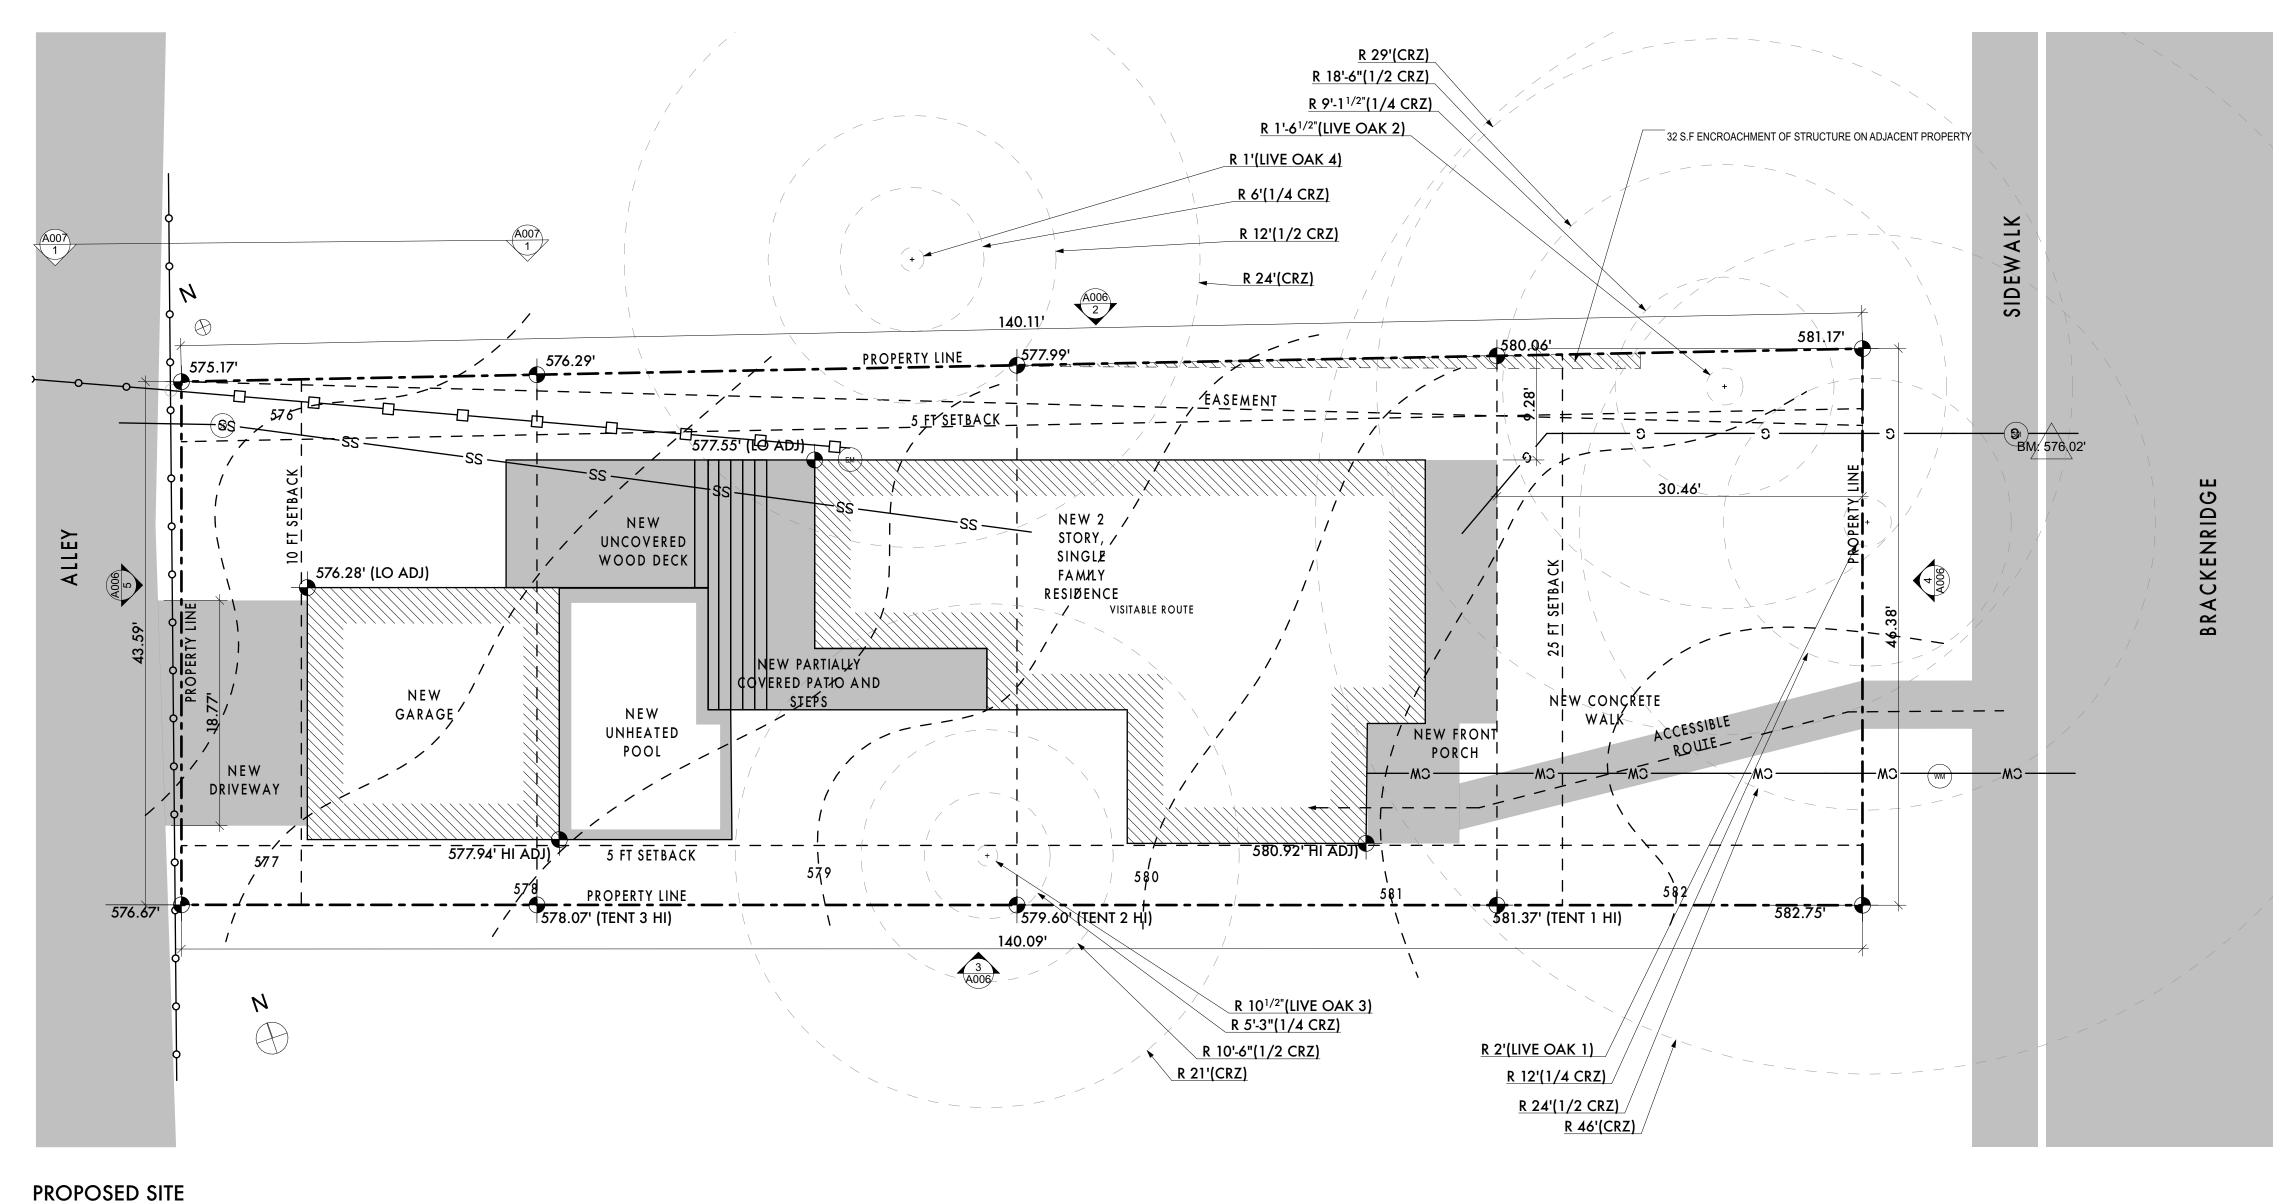

SCALE: 1/8" = 1'-0"


SEWER LINE WATER SUPPLY LINE GAS SUPPLY LINE OVERHEAD POWER LINES TREE PROTECTION FENCING ____ A GUY ANCHOR LINE

SEE A003 FOR ADDITIONAL APPROACH AND APRON STANDARDS

RESIDENCE BRACKENRIDGE

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PROPOSED SITE PLAN


Project #: 220702

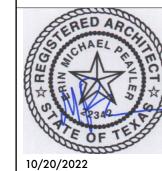
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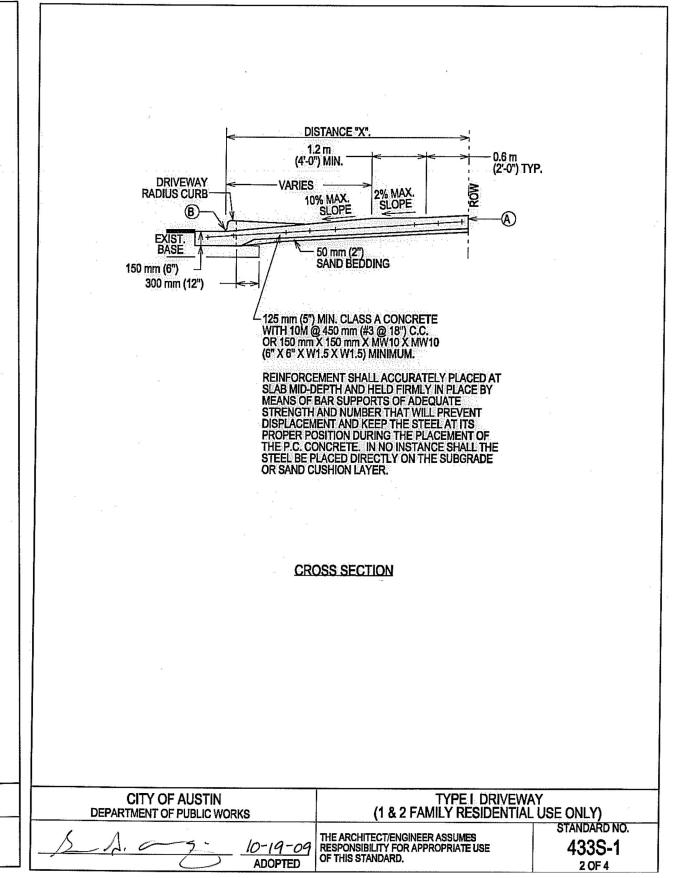
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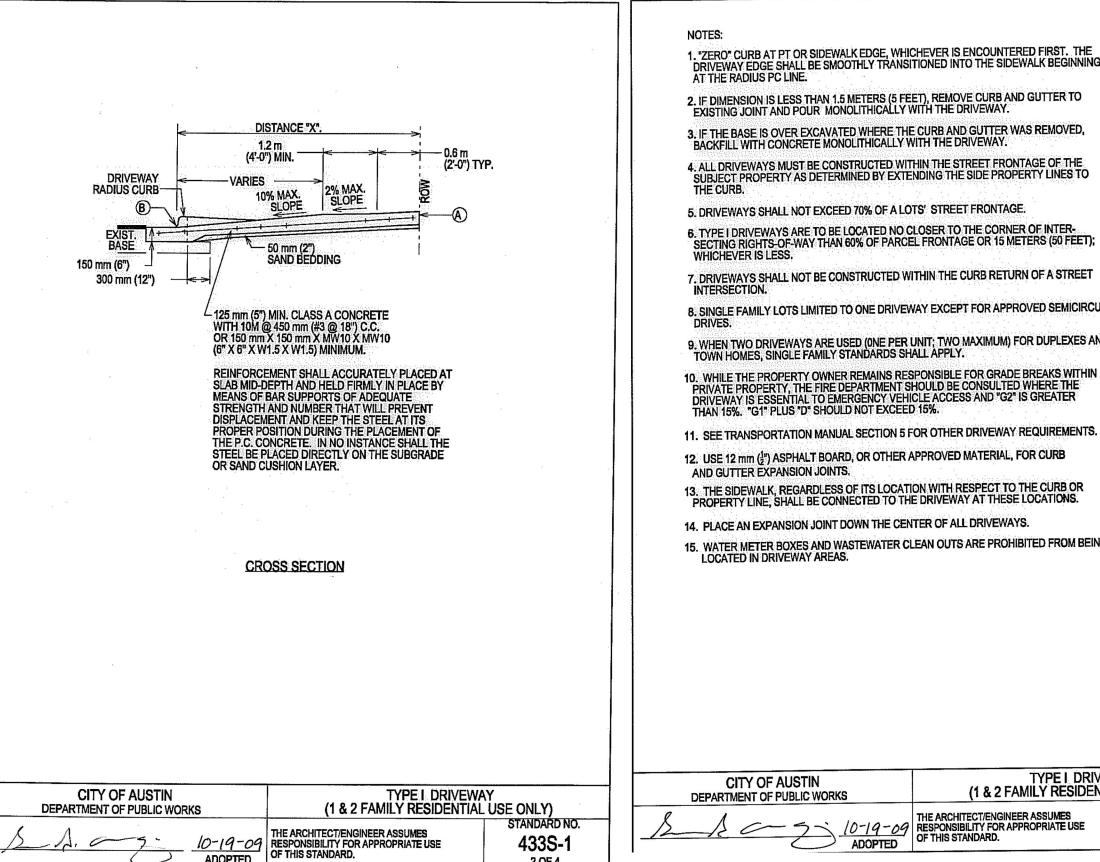
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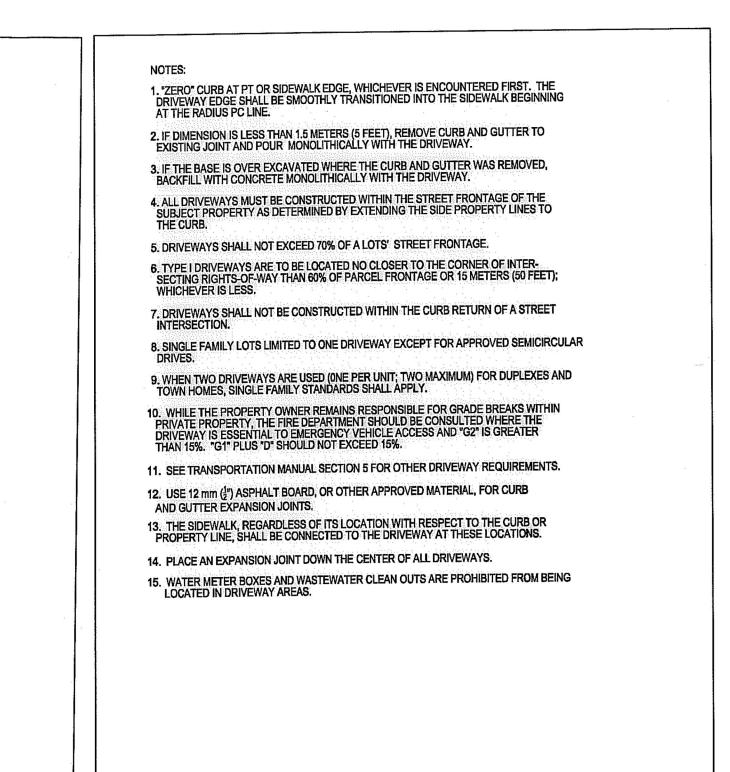
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TYPE I DRIVEWAY
(1 & 2 FAMILY RESIDENTIAL USE ONLY)

STANDARD NO.

433S**-1**

4 OF 4

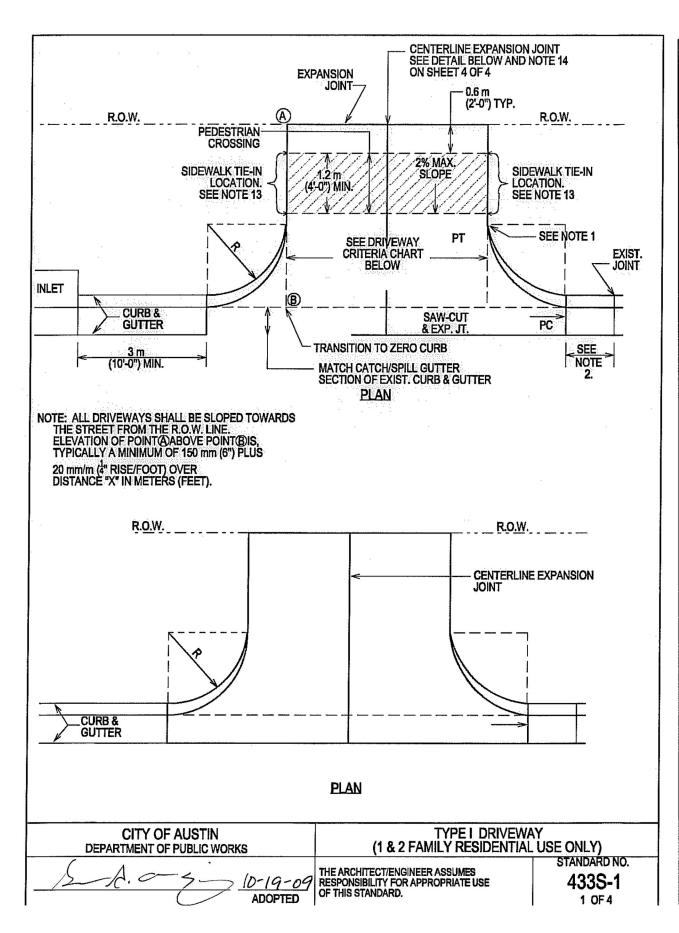S ш (7) CKEN
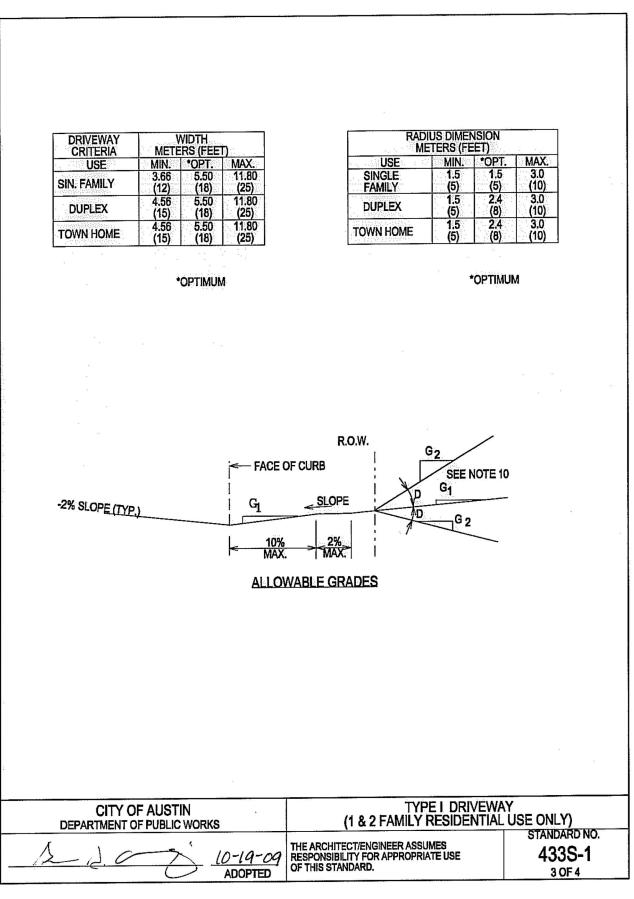
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ISSUED FOR PERMITTING AND CONSTRUCTION


RANSPORTATION STANDARDS

220702

10/20/2022

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The City of Austin Tree and Natural Area Preservation code is based on the fundamental precepts of sound urban forest management. Proposed development projects are evaluated on a case-by-case (and tree-by-tree) basis, which entails evaluating the existing tree resources on a site, understanding the dynamics of trees and development impacts, and negotiating a solution that results in a development with a balanced mixture of tree species and age. The goal of each review is to assure that, through a combination of preservation and reforestation, a final product is achieved which results in a diversified and sustainable urban forest.


Trees 19 inches in diameter (60 inches in circumference) and greater are classified as "protected size" and receive enhanced preservation evaluation. Protected trees require a permit to remove them, impact the critical root zone (i.e. utility trench, sidewalk, driveway, irrigation lines, foundation), or remove more than 30% of the canopy.

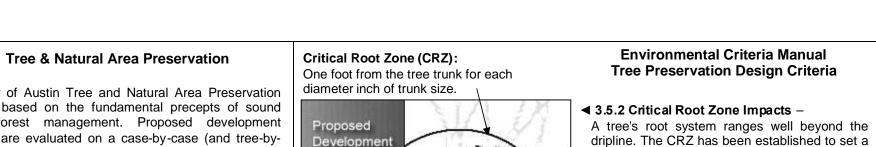CRITICAL ROOT ZONE VARIES WOOD CHIP MULCH
150 mm (6") DEPTH

*AS NEEDED TO PROVIDE MINIMUM NECESSARY WORK SPACE. IF LESS THAN 1.5 m (5'), THEN ADD BOARDS STRAPPED TO TRUNK.

RECORD COPY SIGNED | II/15/99 | THE ARCHITECT/ENGINEER ASSUMES | STANDARD NO. | S

TREE PROTECTION FENCE
MODIFIED TYPE A - CHAIN LINK
STANDARD NO

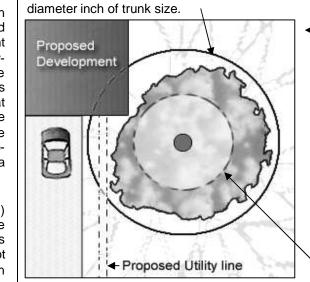

Example: a tree with a 20-inch diameter trunk has a 20-foot CRZ, and a 10-foot ½ CRZ.

■Tree Protection
In order to assure that trees are adequately preserved, tree protection fencing is required for trees within the limits of construction. Fencing should protect the entire Critical root zone (CRZ) area. Fencing is required to be chain-link mesh at a minimum height of five feet. A 6-inch layer of mulch within the entire available root zone area is required for trees which have any disturbance indicated within any portion of the critical root zone.

Trunk Measurements ►
Diameters of tree trunks are measured at 4 ½ feet above grade. If the tree is on a slope, measure from the high side of the slope. Measure above or below unusual swells in the trunk. To determine the diameter of a multi-trunk tree, measure all the trunks; add the total diameter of the largest

For more information visit www.ci.austin.tx.us/trees or contact the City Arborist at (512) 974-1876 or Michael.Embesi@ci.austin.tx.us.

trunk to ½ the diameter of each additional trunk.

No cut or fill greater than four (4) inches will be located closer to the tree trunk than the ½ CRZ. Normal Line of Measurement Actual Line of Measurement Actual Line of Measurement Varies

ground cover, and

practical limit beyond which any loss of roots

would not have a significant impact on a tree's

survival. Design constraints often dictate that

trees slated for preservation have some

encroachment on their critical root zone.


Weighing this fact with what appears to be an


acceptable degree of risk to most trees, the


following minimum design criteria (maximum allowable impacts) have been established:

A minimum of 50% of the CRZ must be

preserved at natural grade, with natural

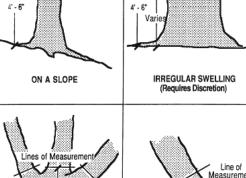

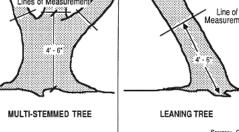


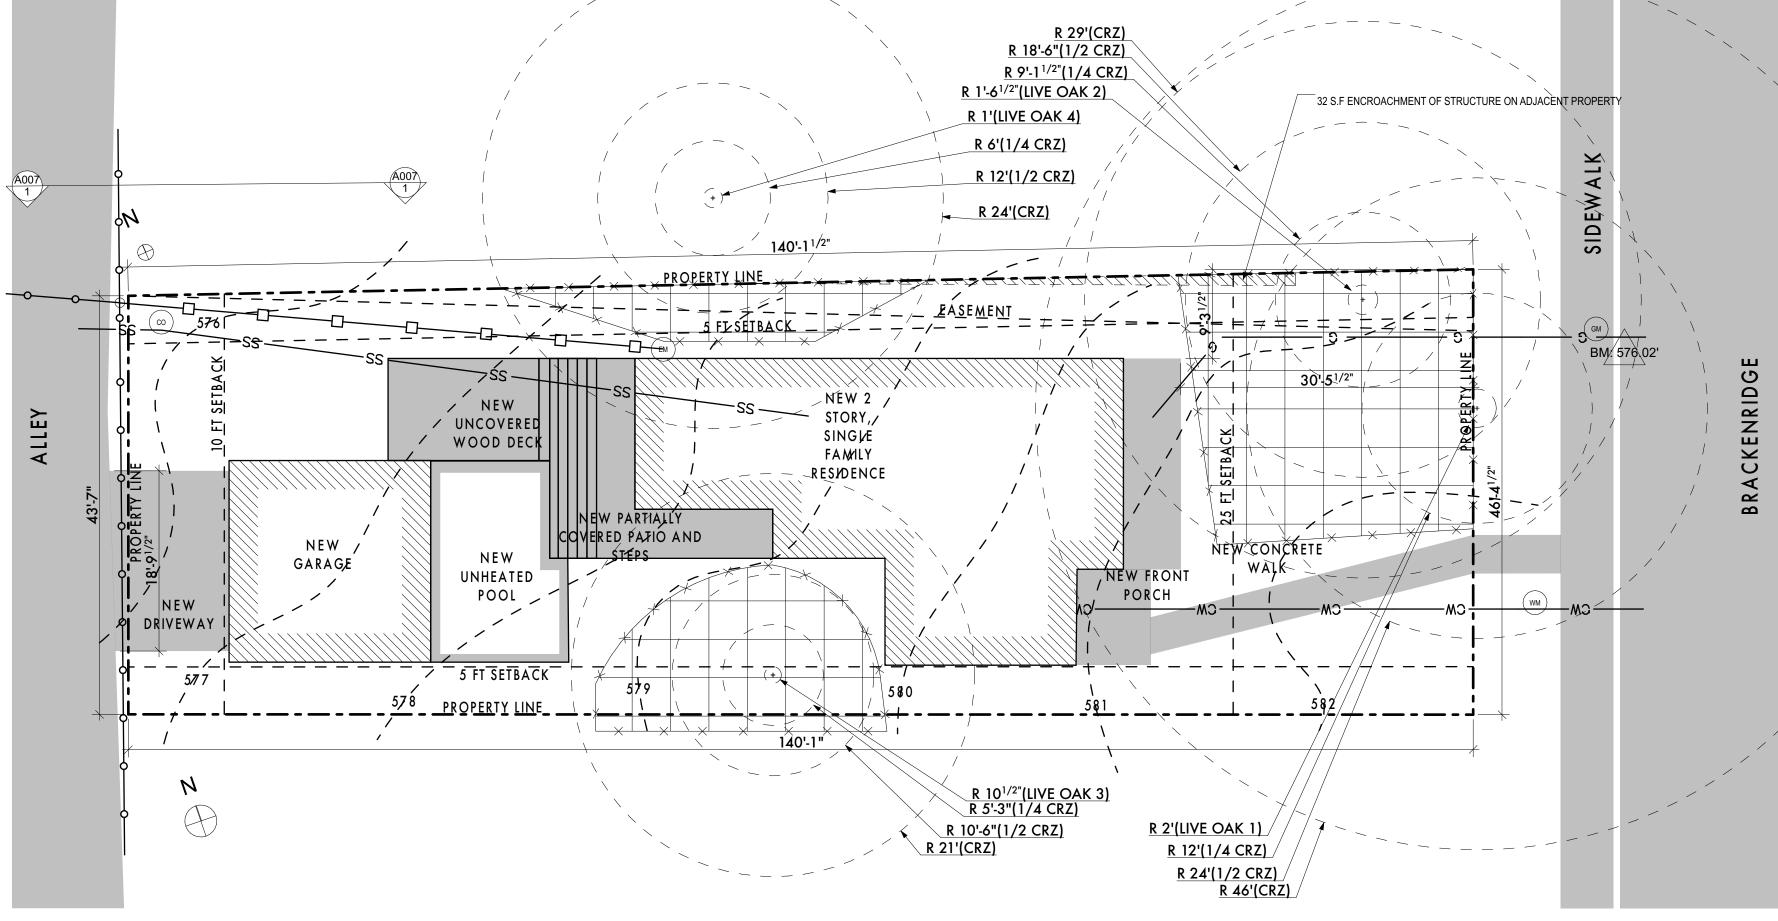

AUSTIN ENERY GUY LINE


TREE PROTECTION PLAN

SCALE: 1" = 10'

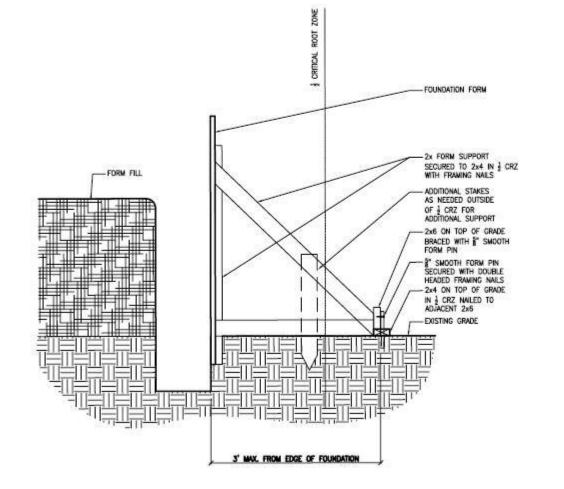

FORM BRACING DETAIL #1

NOTE: THE CONTRACTOR MAY BE REQUIRED TO UTILIZE ALTERNATE FORM BRACING METHODS SUCH AS "FORM BRACING DETAIL #1" WHERE FORMS WOULD BE PLACED WITHIN THE 1/2 CRITICAL ROOT ZONE. CONTRACTOR WILL COORDINATE WITH THE ENGINEER AND ARBORIST AS REQUIRED

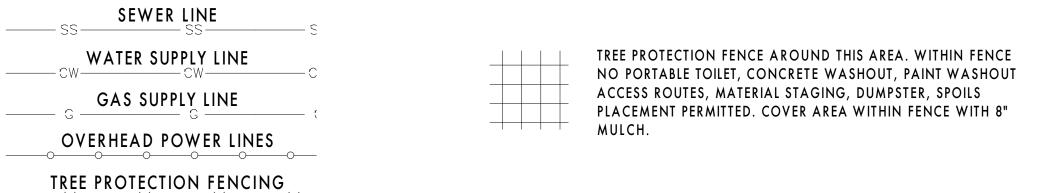

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ON PLAN


TREE PROTECTION PLAN

Project #: 220702


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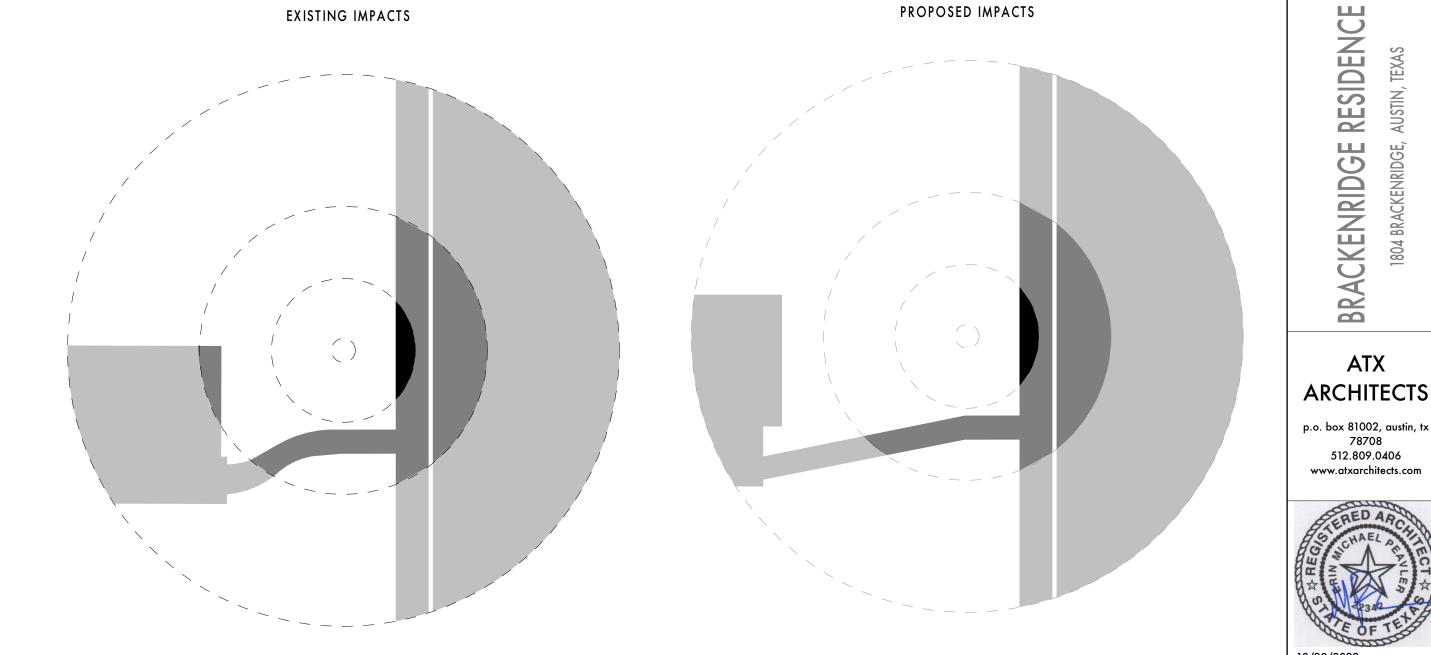
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LIVE OAK 2 SCALE: 1/16" = 1'-0"



NOTE: PROPOSED IMPACT ON LIVE OAK 4 CRZ= 17%

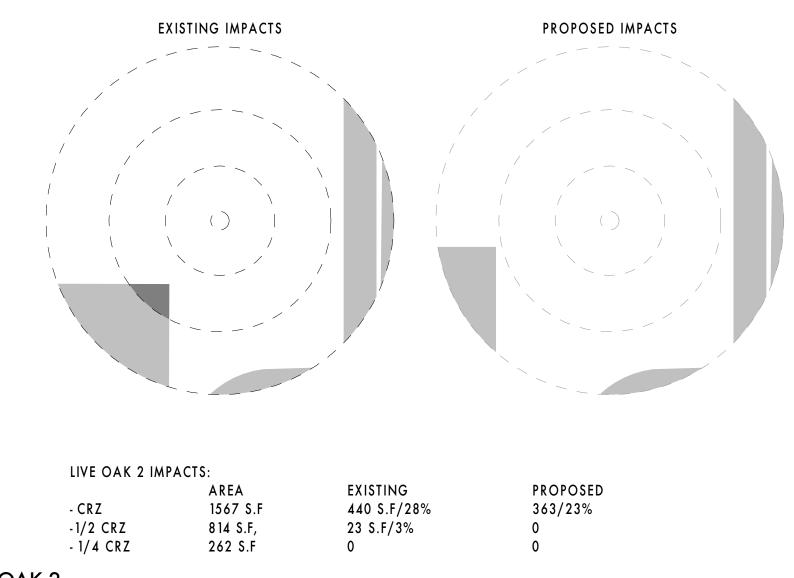

LIVE OAK #1

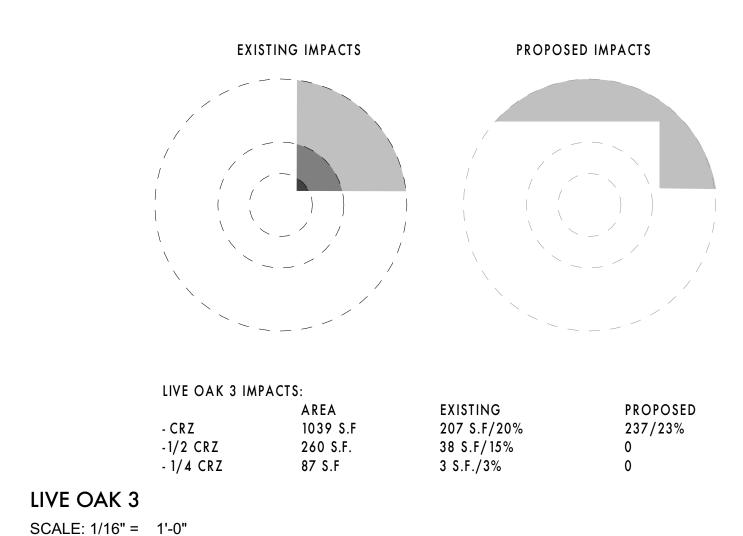- CRZ -1/2 CRZ - 1/4 CRZ EXISTING 2610S.F/54% 558 S.F/41% 37 S.F./8%

PROPOSED 2461/50% 523 S.F/39% 37 S.F./8%

LIVE OAK 1 SCALE: 1/16" = 1'-0"

AREA

4838 S.F

1357 S.F.

452 S.F

Tree & Natural Area Preservation

The City of Austin Tree and Natural Area Preservation code is based on the fundamental precepts of sound urban forest management. Proposed development projects are evaluated on a case-by-case (and tree-bytree) basis, which entails evaluating the existing tree resources on a site, understanding the dynamics of trees and development impacts, and negotiating a solution that results in a development with a balanced mixture of tree species and age. The goal of each review is to assure that, through a combination of preservation and reforestation, a final product is achieved which results in a diversified and sustainable urban forest.

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CITY OF AUSTIN
WATERSHED PROTECTION DEPARTMENT
WATERSHED PROTECTION DEPARTMENT
WATERSHED PROTECTION FENCE
MODIFIED TYPE A - CHAIN LINK
STANDARD NO
STANDARD NO


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BY J. PATRICK MURPHY

II/15/99

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OF THE ARCHITECT/ENGINEER ASSUMES
RESPONSIBILITY FOR APPROPRIATE USE

6 105-4

RADIUS= 12 mm PER mm (1 ft PER In)
OF TRUNK DIAMETER

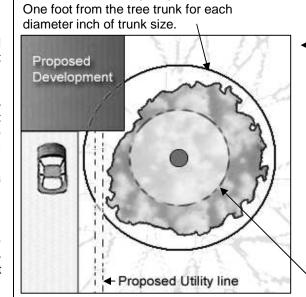

Example: a tree with a 20-inch diameter trunk has a 20-foot CRZ, and a 10-foot ½ CRZ.

Critical Root Zone (CRZ):

◀Tree Protection In order to assure that trees are adequately preserved, tree protection fencing is required for trees within the limits of construction. Fencing should protect the entire Critical root zone (CRZ) area. Fencing is required to be chain-link mesh at a minimum height of five feet. A 6-inch layer of mulch within the entire available root zone area is required for trees which have any disturbance indicated within any portion of the critical root zone.

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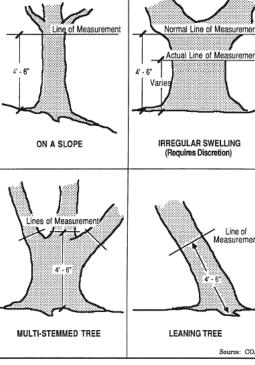
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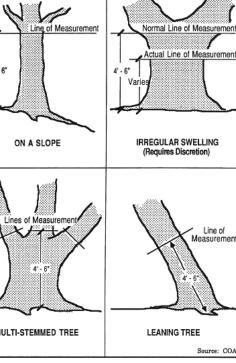
Environmental Criteria Manual Tree Preservation Design Criteria

■ 3.5.2 Critical Root Zone Impacts – A tree's root system ranges well beyond the dripline. The CRZ has been established to set a practical limit beyond which any loss of roots would not have a significant impact on a tree's survival. Design constraints often dictate that trees slated for preservation have some encroachment on their critical root zone. Weighing this fact with what appears to be an acceptable degree of risk to most trees, the following minimum design criteria (maximum allowable impacts) have been established:

• A minimum of 50% of the CRZ must be preserved at natural grade, with natural ground cover, and

No cut or fill greater than four (4) inches will be located closer to the tree trunk than the ½ CRZ.





220702

10/20/2022

PROTECTION PLAN

TREE

ESIDEN


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EMP **EMP**



1804 BRACKENRIDGE

BUILDING AND SITE AREA LOT SIZE SITE DEVELOPMENT INFORMATION (APPLICATION PAGE 2) A) 1ST FLOOR CONDITIONED AREA
B) 2ND FLOOR CONDITIONED AREA
C) 3RD FLOOR CONDITIONED AREA
D) BASEMENT
E) GARAGE (ATTACHED)
GARAGE (DETACHED)
CARPORT (ATTACHED)
CARPORT (DETACHED)
F) COVERED PATIO, DECK, PORCH AND/OR BALCONY
G) OTHER COVERED OR ROOFED AREA (STRUCTURE ON ADJACENT PROPERTY)
H) UNCOVERED WOOD DECK
TOTAL BUILDING A 189 TOTAL BUILDING AREA J) SPA K) REMODELED FLOOR AREA, EXCLUDING ADDITION/ NEW CONSTRUCTION TOTAL BUILDING COVERAGE SURPLUS BUILDING COVERAGE SQUARE FEET: 1944 % OF LOT SIZE: 30.85% 576.8 TOTAL IMPERVIOUS COVERAGE SURPLUS I.C. SQUARE FEET: 2731.5 % OF LOT SIZE: 43.34% 104.4

		NEW/ADDED	PROPOSED	APPLIED	
	EXISTING S.F.	S.F.	EXEMPTION	EXEMPTION	TOTAL S.F.
ST FLOOR	0	1217	N/A		1217
ND FLOOR	0	1300	N/A		1300
RD FLOOR	0	0	N/A		0
REA W/ CEILINGS > 15'	0	0	FOLLOW 3.3.5		0
			FULL		
GROUND FLOOR PORCH	0	277	PORCH/200S.F.	277	0
BASEMENT	0	0	FOLLOW 3.3.3B		
ATTIC	0	0	FOLLOW 3.3.3C	0	0
GARAGE (ATTACHED)	0	0	200	0	0
GARAGE (DETACTCHED)	0	450	450/200	450	0
CARPORT (ATTACHED	0	0	450/200	0	0
CARPORT (DETACHED)	0	0	450	0	0

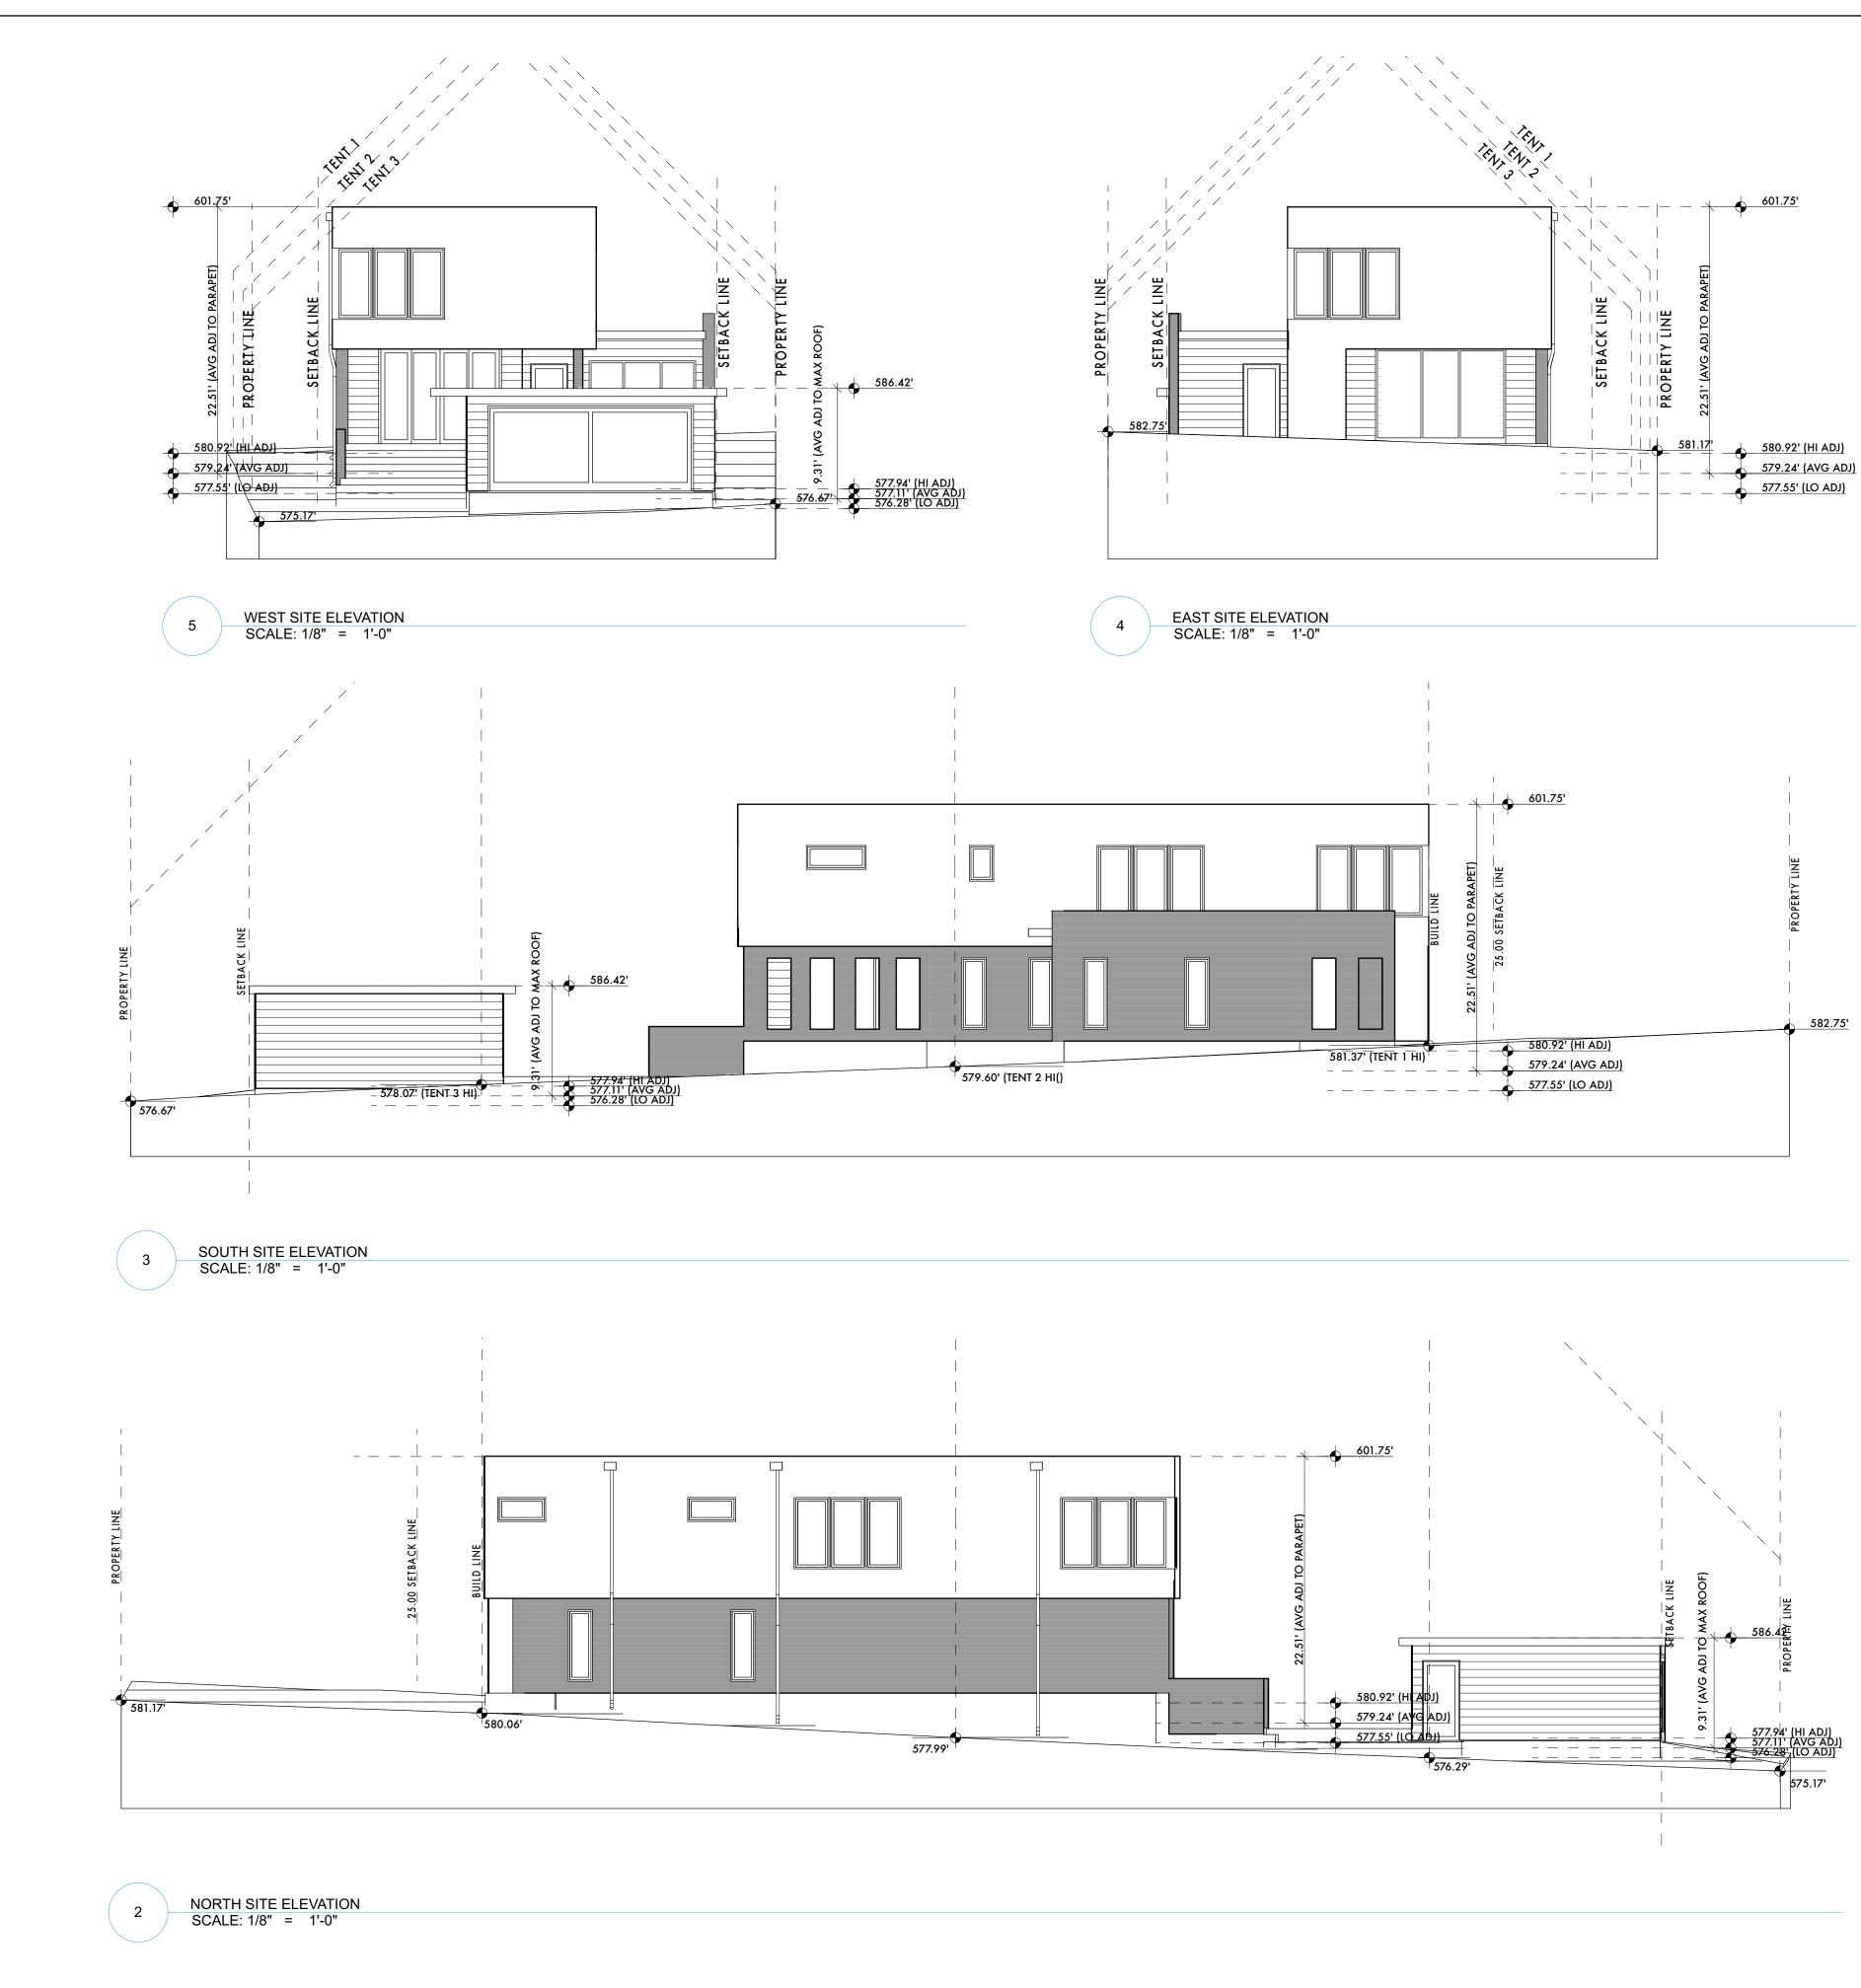TOTAL GROSS FLOOR AREA (TOTAL GROSS FLOOR AREA / LOT AREA) X 100 SURPLUS F.A.R.

		NEW/ADDED	
	EXISTING S.F.	S.F.	TOTAL S.F.
A) 1ST FLOOR CONDITIONED AREA	0	1217	1217
2) 2ND FLOOR CONDITIONED AREA	0	1300	1300
3RD FLOOR CONDITIONED AREA	0	0	0
D) BASEMENT	0	0	0
GARAGE (ATTACHED)	0	0	0
GARAGE (DETACHED)	0	450	450
CARPORT (ATTACHED)	0	0	0
CARPORT (DETACHED)	0	0	0
G) COVERED WOOD DECKS			0
H) COVERED PATIOS	0	277	277
COVERED PORCH			0
BALCONY			0
OTHER			0
OTAL BUILDING AREA	0	3244	3244
TOTAL BUILDING COVERAGE	0	1944	1944
.) DRIVEWAY		230	230
n) SIDEWALKS		133	133
I) UNCOVERED PATIO			0
N) UNCOVERED PATIO		213	213
) UNCOVERED WOOD DECKS (COUNTED AT 50%)	0	189	94.5
P) AC PADS AND OTHER CONCRETE FLATWOORK		18	18
O) OTHER (STRUCTURE ON ADJACENT PROPERTY: 32; POOL COPING: 67)	32	67	99
OTAL SITE IMPERVIOUS COVERAGE	32	2794	2731.5
Q) POOLS	0	281	281
S) SPA			

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10/20/2022

REVISION HISTORY


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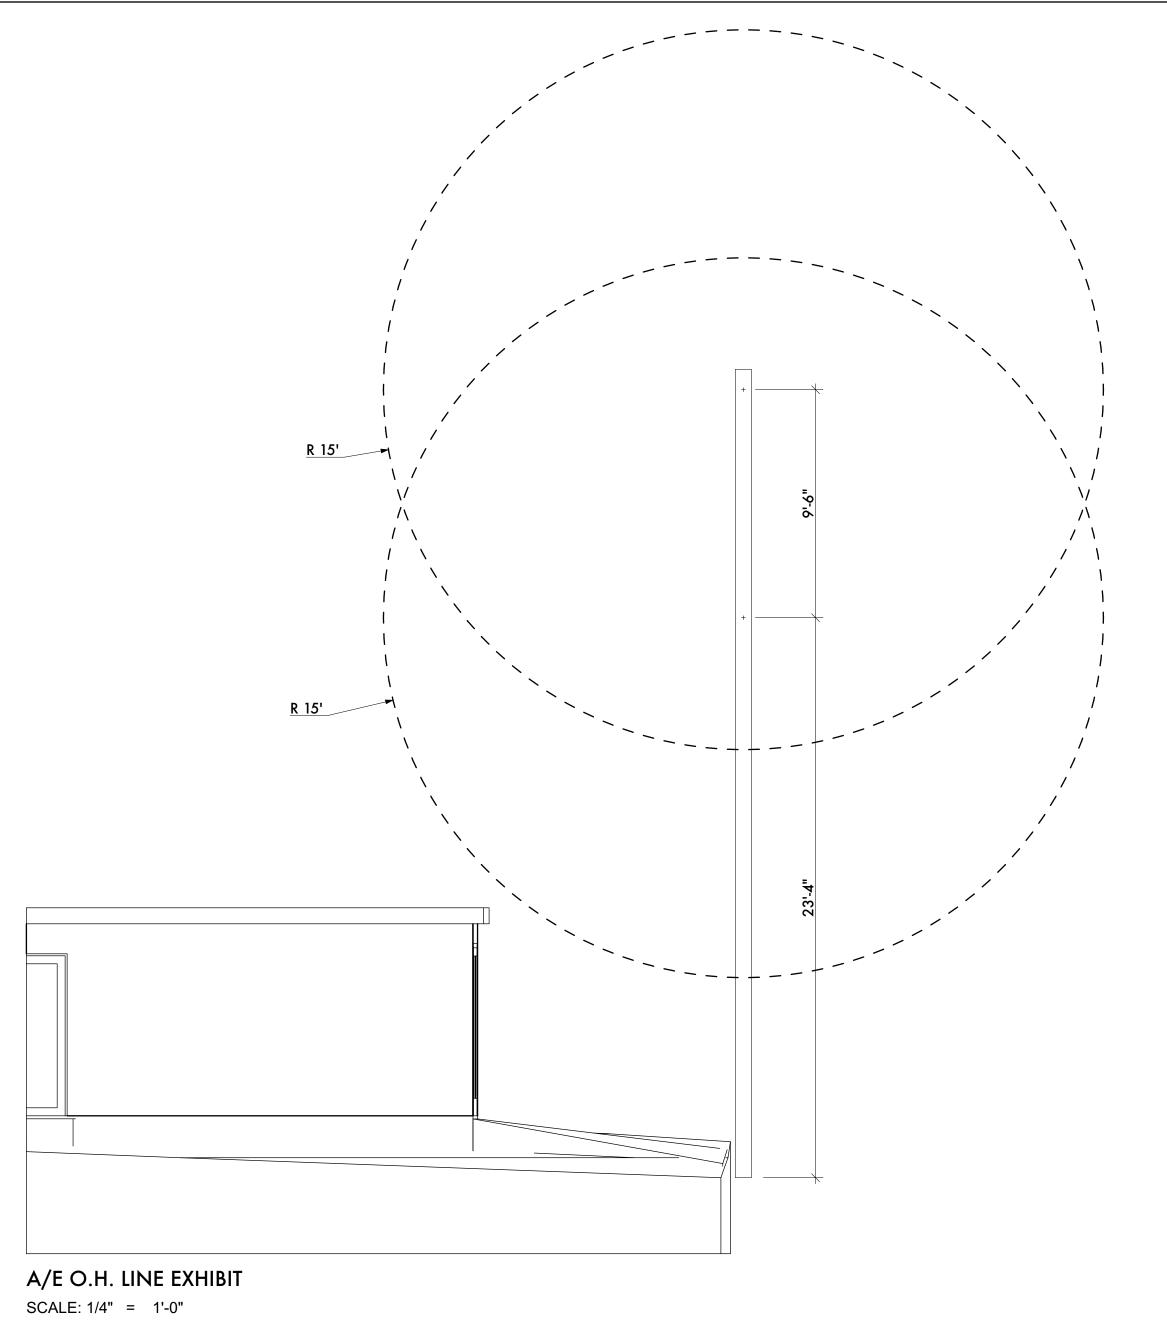
SUB CHAPTER F EXHIBITS

Project #: 220702

10/20/2022 Drawn: **EMP**

Chkd: **EMP**



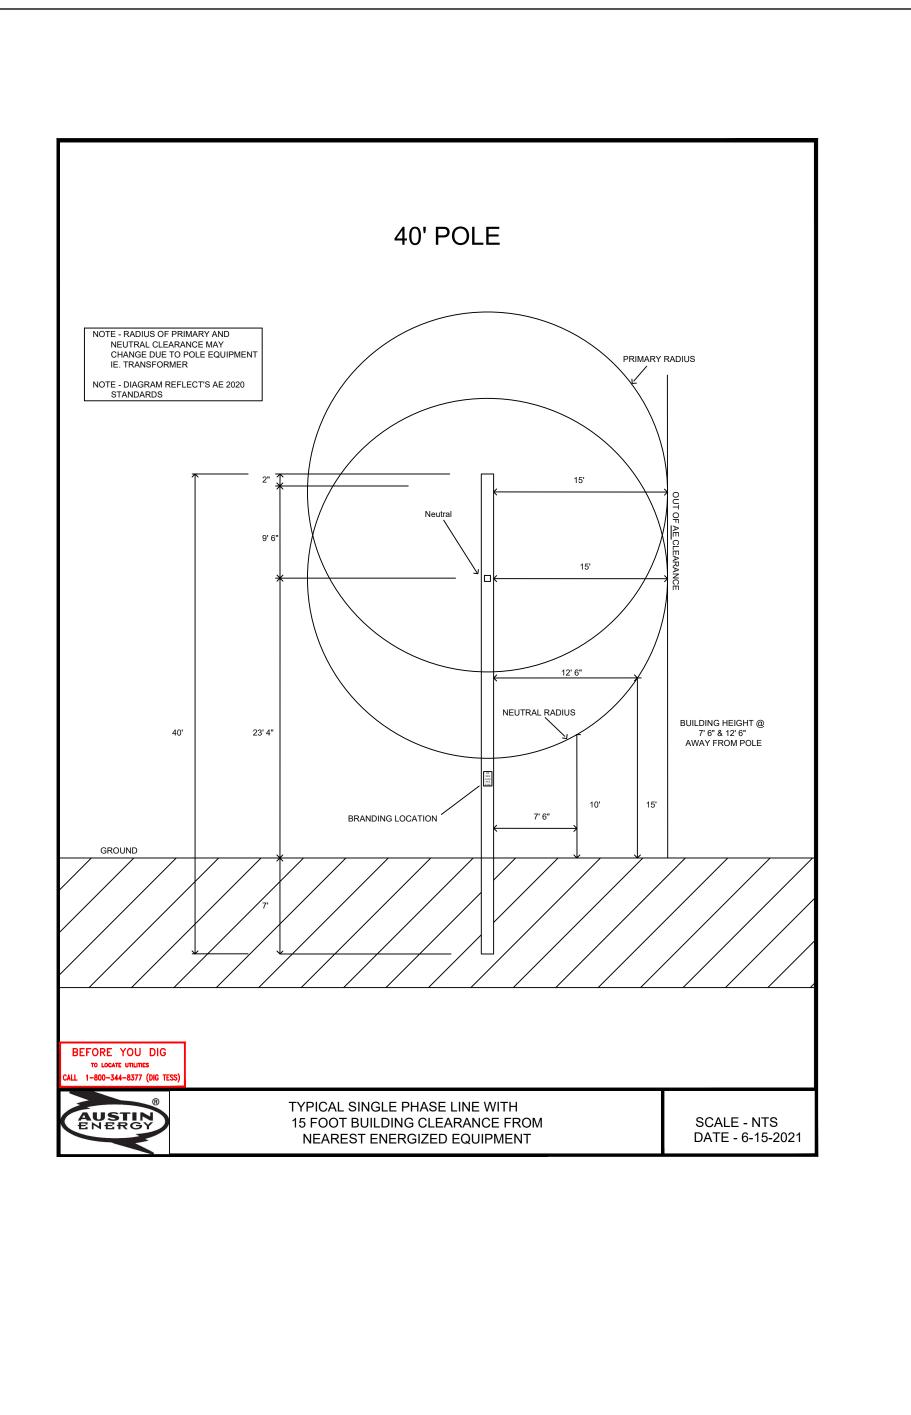

RESIDENCE, AUSTIN, TEXAS

BRACKENRIDGE

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AE OH LINE EXHIBITS

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Drawn: **EMP**

Chkd: **EMP**

Date: 10/20/2022

Sheet Number

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GENERAL

1. CONTRACT DOCUMENTS - THE DRAWINGS AND SPECIFICATIONS ISSUED BY THE ARCHITECT DATED 10/20/2022, AND AS MAY BE AMENDED BY THE ARCHITECT IN SUBSEQUENT ISSUANCES. 2. EXISTING CONDITIONS - BEFORE BEGINNING WORK EXAMINE THE SITE FOR COMPLIANCE WITH THE DRAWINGS. NO EXTRA CHARGE OR COMPENSATION WILL BE ALLOWED FOR REASONS OF ERROR OR

OMISSION. 3. STANDARDS, CODES AND ORDINANCES - REFER TO INDUSTRY STANDARDS AND MANUFACTURER'S INSTRUCTIONS. WHERE THE CONTRACT DOCUMENTS CONFLICT WITH INDUSTRY STANDARDS OR MANUFACTURER'S INSTRUCTIONS INFORM THE OWNER AND DO NOT PROCEED WITHOUT PRIOR APPROVAL.

4. ALL WORK WILL COMPLY WITH ALL PRESIDING CODES AND ORDINANCES. WHERE THE CONTRACT DOCUMENTS CONFLICT WITH PRESIDING CODES AND ORDINANCES INFORM THE OWNER AND DO NOT PROCEED WITHOUT PRIOR APPROVAL.

5. PURPOSE OF THE CONTRACT DOCUMENTS IS TO PROVIDE THE INFORMATION REQUIRED TO ACHIEVE THE ARCHITECTURAL INTENT. WHERE DETAILS OR PROCEDURES ARE IN CONFLICT WITH ANY OF THE TERMS OF THESE SPECIFICATIONS INFORM THE OWNER AND DO NOT PROCEED WITHOUT PRIOR APPROVAL.

6. SAFETY - ERECT SUCH SAFETY EQUIPMENT AND SIGNAGE AS REQUIRED AND MAINTAIN THESE ELEMENTS FOR THE DURATION OF THE PROJECT.

7. SUPPORT FACILITIES - CONTRACTOR IS RESPONSIBLE FOR PAYING FOR ALL TEMPORARY FEATURES SUCH AS UTILITIES, TRASH AND RECYCLING, AND SANITARY FACILITIES. ALL TEMPORARY FEATURES MUST BE REMOVED BEFORE FINAL CLEANING.

8. INSURANCE - PROVIDE AND COORDINATE ALL INSURANCE REQUIREMENTS AS PRESCRIBED BY THE CONSTRUCTION CONTRACT. 9. WARRANTY - ALL WORK SHALL BE WARRANTED AS COMPLYING WITH THE CONTRACT DOCUMENTS AND AGAINST DEFECTS FOR THE PERIOD REQUIRED BY LAW AND THE CONSTRUCTION CONTRACT. REPAIRS REQUIRED DURING THE WARRANTY PERIOD WILL BE PROVIDED BY THE CONTRACTOR AT NO EXPENSE TO THE OWNER.

10. PROTECTION OF EXISTING CONDITIONS - PROTECT ALL EXISTING CONDITIONS TO REMAIN OR TO BE REUSED DURING CONSTRUCTION. FINAL CLEANING WILL INCLUDE ALL EXTERIOR AND INTERIOR SURFACES. PATCHING AND REPAIRING WILL BE PERFORMED SUCH THAT NEW AND EXISTING ELEMENTS MAY NOT BE DIFFERENTIATED. 11. SUBSTITUTIONS - WHERE A PARTICULAR MATERIAL, COLOR OR

PRODUCT IS SPECIFIED AN ALTERNATE MAY ONLY BE SUBSTITUTED WITH THE EXPRESS PERMISSION OF THE OWNER. 12. CONTRACTOR IS RESPONSIBLE FOR MAINTAINING "AS-BUILT"

DRAWINGS TO BE PROVIDED TO THE OWNER AT THE COMPLETION OF

13. CONTRACTOR WILL RETAIN THE SERVICES OF RELEVANT ENGINEERS WHERE REQUIRED TO COMPLETE THE WORK.

14. ALL PARTITION TYPES INDICATED ON THIS DRAWING MAY NOT NECESSARILY BE USED ON THIS SPECIFIC PHASE OF THE PROJECT. 15. VERIFY THE THE REQUIREMENTS OF ALL OWNER SUPPLIED APPLIANCES AND PRODUCTS BEFORE BEGINNING THE WORK. NO EXTRA CHARGE OR COMPENSATION WILL BE ALLOWED FOR REASONS OF ERROR OR OMISSION.

. SITE WORK

1. PROTECTION

1. SEE SURVEY FOR EXISTING CONDITIONS AND PROTECTED TREES. 3. CONTRACTOR IS RESPONSIBLE FOR IDENTIFYING LOCATION OF ON SITE UTILITIES.

4. PROTECT SITE ELEMENTS TO REMAIN DURING CONSTRUCTION. 2. DRAINAGE - NO WORK WILL INTERFERE WITH EXISTING DRAINAGE SYSTEMS WITHOUT CREATING EQUALLY EFFECTIVE SYSTEMS.

3. ROOF DRAINS AND FRENCH DRAINS WILL TIE INTO EXISTING DRAINAGE SYSTEMS WHERE POSSIBLE.

WOOD

1. ROUGH FRAMING

RESERVED.

2. FRAMING TO BE INSTALLED TO RECEIVE INTERIOR FINISHES. 3. CONTRACTOR RESPONSIBLE FOR COORDINATION OF LUMBER TAKE OFFS, TRUSS SUBMITTALS, AND SHOP DRAWINGS. 4. STUD SPACING TO BE 16" O.C. U.N.O. THE PROJECT MANDATORY MAXIMUM ALLOWABLE DEFLECTION DESIGN CRITERIA RATIO IS L/ 240 USING STUDS @ 16" O.C.

5. WHERE "BRITTLE" FINISHES WILL BE APPLIED SUCH AS PLASTER OR CERAMIC TILE, MAX. ALLOWABLE DEFLECTION CRITERIA RATIO IS L/ 360.

2. EXTERIOR CARPENTRY RESERVED

3. INTERIOR FINISH CARPENTRY - ALL WORK TO COMPLY WITH MOST RECENT QUALITY STANDARDS OF THE ARCHITECTURAL WOODWORK

1. ALL FASTENERS TO BE COUNTERSUNK AND FILLED, SANDED SMOOTH AND PAINTED.

2. CORNERS TO BE MITERED UNLESS NOTED OTHERWISE.

NECESSARILY BE USED ON THIS SPECIFIC PHASE OF THE PROJECT.

3. INSTALL BLOCKING AS REQUIRED.

4. CABINETRY AND MILLWORK FINISHES TO BE COORDINATED WITH

THE OWNER. 4. ALL PARTITION TYPES INCLUDED IN THE DRAWINGS MAY NOT

4. THERMAL AND MOISTURE PROTECTION

1. BUILDING WRAP - DUPONT TYVEK HOMEWRAP OR ALTERNATE APPROVED BY OWNER

2. FENESTRATION FLASHING - SELF ADHERED FLASHING TAPES WITH CORNER DETAILING SYSTEMS TO CREATE CONTINUOUS WATERPROOFED DETAILS. INSTALL WINDOW AND DOOR FLASHING

PER FLASHING TAPE MANUFACTURER'S INSTRUCTIONS. 3. INSULATION - CAVITY INSULATION AT ROOF AND WALLS TO BE SPRAY-IN FOAM INSULATION. MINIMUN R-VALUES PER CITY REQUIREMENTS AND OWNER'S PREFERENCE.

4. RESERVED

5. JOINT SEALANTS - ELASTOMERIC SEALANTS AT

1. DISIMILAR MATERIAL JOINTS

2. BETWEEN DOORS AND WINDOWS 3. SEALANT COLORS TO BE COMPATIBLE WITH ADJACENT FINISHES. 6. SIDING TO BE REAL WOOD GRAIN CEMENTITIOUS FIBERBOARD, PAINTED. SEE ALSO ASSEMBLIES.

7. EXTERIOR ACCENT BANDS TO BE SMOOTH FINISH CEMENTITIOUS FIBERBOARD, PAINTED.

8. WHERE NOT DETAILED EXTERIOR SIDING CORNERS TO BE TRIMMED IN EITHER SMOOTH FINISH CEMENTITIOUS FIBERBOARD, PAINTED, OR MITERED.

9. ALL FLASHING DETAILS PER SMACNA.

1. GYPSUM BOARD ASSEMBLIES

1. WALLS IN DRY LOCATIONS TO BE STANDARD 1/2 INCH GYPSUM

2. WALLS IN WET LOCATIONS TO BE 1/2 INCH CEMENTITIOUS PANEL

3. CEILINGS TO BE 5/8" GYPSUM BOARD 4. CEILINGS IN WET AREAS TO BE 5/8" WATER RESISTANT GYPSUM BOARD

5. ALL OUTSIDE CORNERS TO HAVE CORNER BEADS

2. TILE 1. USE COMPATIBLE WATERPROOFING AND THIN SET CEMENT 2. TILE FLOORS TO BE THIN SET TILE OVER PLIABLE, SHEET-APPLIED, BONDED WATERPROOF MEMBRANE AND VAPOR RETARDER WITH CRACK-BRIDGING CAPABILITIES

3. TILE WALLS TO BE THIN SET TILE OVER SHEET-APPLIED, BONDED WATERPROOF MEMBRANE AND VAPOR RETARDER WITH CRACK-BRIDGING CAPABILITIES, OR APPROVED ALTERNATE, OVER CEMENTITIOUS BOARD

4. COORDINATE TILE AND GROUT COLOUR SELECTIONS WITH OWNER.

5. TILE TRANSITIONS TO BE BULL-NOSE FINISH, O.A.A. 3. PAINT

1. COORDINATE PAINT COLOURS WITH OWNER. 2. EXTERIOR PAINTED WOOD TO MATCH EXISTING COLOR AND QUALITY.

3. PAINTED GYPSUM BOARD TO MATCH EXISTING COLOR AND QUALITY.

4. FILL ALL HOLES, LEVEL ALL SURFACES, SEAL ALL JOINTS, CRACKS AND INTERSECTIONS AND SAND SURFACES SMOOTH. 5. REMOVE HARDWARE PRIOR TO PAINTING. 6. PROVIDE MINIMUM ONE COAT OF PRIMER AND TWO COLOR

7. COORDINATE PAINT COLOUR SELECTIONS WITH OWNER.

6. DOORS AND WINDOWS

1. NEW WINDOWS TO MATCH EXISTING TYPE, QUALITY, INSTALLATION AND TRIMS.

2. NEW DOORS TO MATCH EXISTING TYPE, QUALITY, INSTALLATION AND TRIMS.

3. PROVIDE TEMPERED GLASS WHERE REQUIRED BY CODE.

7. MECHANICAL - HVAC AND PLUMBING

1. U.N.O. CONTRACTOR IS RESPONSIBLE FOR THE DESIGN AND INTEGRATION OF NEW AND EXISTING HVAC SYSTEMS AND PRODUCTS. 2. DUCT WORK, GRILLS AND TERMINATIONS

1. PROVIDE SHEET METAL PRIMARY TRUNKS WITH FLEX DUCT SECONDARY DUCTS.

2. PROVIDED DUCTED RETURNS AT BEDROOM.

3. ROOF TERMINATIONS TO MATCH EXISTING. 4. NO VISIBLE EQUIPMENT, PENETRATIONS, GRILLS, METERS OR OTHER EQUIPMENT WITHOUT OWNER'S CONSENT.

3. RESERVED.

4. U.N.O. CONTRACTOR IS RESPONSIBLE FOR THE DESIGN AND INTEGRATION OF NEW AND EXISTING PLUMBING SYSTEMS AND PRODUCTS. 5. CONTRACTOR RESPONSIBLE FOR COORDINATION OF ROOF

PENETRATIONS AND ROOFING.

6. PROVIDE AND INSTALL PLUMBING FIXTURES PER CONTRACT DOCUMENTS.

7. CONTRACTOR TO COORDINATE FIXTURE SELECTIONS WITH OWNER. 8. ENSURE PROPER CONNECTION OF NEW AND EXISTING PLUMBING SYSTEMS TO CITY SUPPLY AND SEWER.

8. ELECTRICAL

1. CONTRACTOR IS RESPONSIBLE FOR THE DESIGN AND INTEGRATION OF NEW ELECTRICAL SYSTEMS AND PRODUCTS. 2. SMOKE DETECTORS INSTALLED PER CODE REQUIREMENTS

3. INTEGRATE NEW DOORS AND WINDOWS WITH EXISTING SECURITY SYSTEMS

4. ALL RECEPTICALS IN WET AREAS TO BE GFCI OR WATERPROOF GFCI AS REQUIRED BY CODE

ACOUSTICAL

1. USE ACOUSTICAL SEALANT AT TOP AND BOTTOM OF STUD

WALLS.

2. ACOUSTICALLY SEAL AROUND ALL PENETRATIONS IN GYP BD WALLS AND CEILINGS

3. STAGGER GYP BD JOINTS

4. PROVIDE AT LEAST ONE STUD BETWEEN PLUGS, SWITCHES, J-BOXES, ETC., THAT BACK UP TO EACH OTHER

10. DEMOLITION

1. PROTECT ALL EXISTING, STRUCTURES, FENCING, LANDSCAPING, TREES, WALKS, ASPHALT PAVING TO REMAIN DURING CONSTRUCTION. 2. PROTECT ALL TREES AND LANDSCAPING TO REMAIN.

3. ANY EXISTING ELEMENTS TO REMAIN THAT ARE DAMAGED DURING CONSTRUCTION WILL BE REPLACE BY THE CONTRACTOR

4. LOCATION AND PROTECTION OF UTILITIES TO REMAIN IS THE RESPONSIBILITY OF THE CONTRACTOR.

5. ALL AREAS OF DISTURBED LANDSCAPE WILL BE REPLANTED WITH NEW GRASS SEED.

6. RE: FLOOR PLAN FOR LOCATION OF WINDOWS TO BE REMOVED AND PATCHED AND WINDOWS TO BE REMOVED AND REPLACED. 7. ALL EXTERIOR SIDING TO BE REMOVED AND REPLACED. RE: ELEVATIONS

8. ALL ROOFS TO BE REMOVED AND REPLACED. RE: ROOF PLAN, ELEVATIONS AND STRUCTURE.

11. EXTERIOR SPECIALTIES

RESERVED

12. ALTERNATES

1. RESERVED

13. ACCESSIBILITY AND VISITABILITY

1. FOR ALL NEW SINGLE-FAMILY AND DUPLEX CONSTRUCTION WITHIN THE CITY OF AUSTIN THE FOLLOWING WILL APPLY.

2. AT LEAST ONE BATHROOM OR HALF BATH ON THE FIRST FLOOR

MUST MEET THE FOLLOWING REQUIREMENTS: 1. MINIMUM CLEAR OPENING OF 30 INCHES

2. LATERAL TWO-INCH BY SIX-INCH OR LARGER NOMINAL WOOD BLOCKING INSTALLED FLUSH WITH THE STUD EDGES OF BATHROOM WALLS: AND

3. THE CENTERLINE OF THE BLOCKING MUST BE 34" FROM AND PARALLEL TO THE INTERIOR FLOOR LEVEL, EXCEPT FOR THE PORTION OF THE WALL LOCATED DIRECTLY BEHIND THE LAVATORY

3. SWITCHES, RECEPTACLES AND ENVIRONMENTAL CONTROLS ON THE FIRST FLOOR MUST MEET THE FOLLOWING REQUIREMENTS:

1. LIGHT SWITCHES AND ENVIRONMENTAL CONTROLS MUST BE NO HIGHER THAN 48 INCHES ABOVE THE INTERIOR FLOOR LEVEL; AND 2. OUTLETS AND RECEPTACLES MUST BE A MINIMUM OF 15 INCHES ABOVE THE INTERIOR FLOOR LEVEL, EXCEPT FOR FLOOR OUTLETS AND RECEPTACLES

4. THE ROUTE TO A DESIGNATED VISITABLE BATH OR HALF BATH MUST BE ACCESSIBLE BY A ROUTE WITH A MINIMUM CLEAR OPENING OF 32 INCHES BEGINNING AT THE DESIGNATED VISITABLE ENTRANCE AND CONTINUING THROUGH THE LIVING ROOM, DINING ROOM, AND KITCHEN AND BE LEVEL WITH RAMPED OR BEVELED CHANGES AT

5. THE DESIGNATED VISITABLE ENTRANCE MUST BE A NO-STEP ENTRANCE WITH A BEVELED THRESHOLD OF ONE-HALF INCH OR LESS AND A DOOR WITH A CLEAR WIDTH OF AT LEAST 32 INCHES. THE ENTRANCE MAY BE LOCATED AT THE FRONT, REAR, OR SIDE, OR IN THE GARAGE OR CARPORT OF THE DWELLING

6. THE EXTERIOR VISITABLE ROUTE MUST HAVE A CROSS SLOPE LESS THAN TWO PERCENT THAT ORIGINATES FROM A GARAGE, PUBLIC STREET, OR PUBLIC SIDEWALK. A RAMP INCLUDED IN AN EXTERIOR VISITABLE ROUTE MUST COMPLY WITH THE RESIDENTIAL CODE 7. EXCEPTIONS FOR EXTERIOR VISITABLE ROUTES

1. LOTS WITH 10% OR GREATER SLOPE PRIOR TO DEVELOPMENT 2. PROPERTIES FOR WHICH COMPLIANCE CANNOT BE ACHIEVED WITHOUT THE USE OF SWITCHBACKS


TREE PROTECTION NOTES:

-TREE PROTECTION FENCING IS REQUIRED TO BE CHAIN-LINK MESH AT A MINIMUM HEIGHT OF FIVE FEET. WHEN THE TREE PROTECTION FENCING CANNOT INCORPORATE THE ENTIRE 1/2 CRITICAL ROOT ZONE, AN EIGHT INCH LAYAER OF MULCH WITHIN THE ENTIRE AVAILABLE ROOT ZONE AREA IS REQUIRED FOR ALL TREES WHICH HAVE ANY DISTURBANCE INDICATED WITHIN ANY PORTION OF THE CRITICAL ROOT ZONE.

-2X4 OR GREATER SIZE PLANKS (6'-0" TALL MINIMUM) TO BE STRAPPED SECURELY AROUND PROTECTED TREES TRUNKS AND ROOT FLARES WHEN PROTECTIVE FENCING DOES NOT INCORPORATE THE ENTIRE 1/2 CRZ FOR ANY REASON AT ANY TIME IN THE PROJECT.


-TO THE DEGREE THAT PROTECTED TREES ON ADJACENT LOTS MAY BE IMPACTED BY THE PROJECT AND TO THE DEGREE ACCESS TO THOSE TREES CAN BE COORDINATED WITH THE OWNERS OF THE ADJACENT LOTS THOSE TREES WILL RECIEVE THE SAME PROTECTION MEASURES AS TREES ON THE PROJECT LOT.

-FOR ADDITIONAL DETAILS REGARDING TREE PROTECTION RE: THE ENVIRONMENTAL CRITERIA MANUAL SECTION 3.5.2.

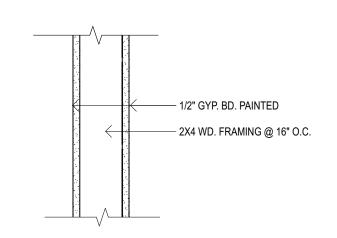

P1 PARTITION

SCALE: 1 1/2"= 1'-0"

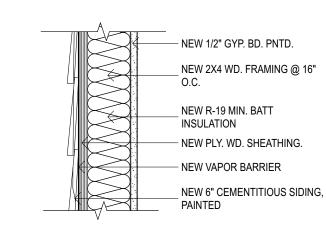

W1 WALL SCALE: 1 1/2"= 1'-0"

ADDITIONAL NOTES:

1. HANDRAILS WILL BE PROVIDED ON NOT LESS THAN ONE SIDE OF EACH CONTINUOUS RUN OF TREADS OR FLIGHT WITH FOUR OR MORE RISERS. 2. HANDRAIL HEIGHT, MEASURED VERTICALLY FROM THE SLOPED PLAN ADJOINING THE TREAD NOSING, OR FINISH

SURFACE OF RAMP SLOE, SHALL BE NOT LESS THAN 34 INCHES AND NOT MOR THAN 38 INCHES 3. HAINRAILS FOR STAIRWAYS SHALL BE CONTINUOUS FOR THE FULL LENGTH OF THE FLIGHT, FROM A POINT DIRECTLY ABOVE THE TOP RISER OF THE FLIGHT TO A POINT DIRECTLY ABOVE THE LOWEST RISER OF THE FLIGHT. HANDRAIL ENDS SHALL BE RETURNED OR SHALL TERMINATE IN NEWEL POSTS OR SAFETY TERMINALS. HANDRAILS ADJACENT TO A WALL SHALL HAVE A SPACE OF NOT LESS THAN 1 1/2" INCHES BETWEEN THE WALL AND THE HANDRAILS.

4. HANDRAILS SHALL HAVE A CIRCULAR CROSS SECTION AND SHALL HAVE AN OUTSIDE DIAMATER OF NOT LESS THAN 1 1/4" AND NOT GREATER THAN 2"


1. GUARDS SHALL BE LOCATED ALONG OPEN-SIDED WALKING SURFACES THAT ARE LOCATED MORE THAN 30" MEASURED VERTICALLY TO THE FLOOR OR GRADE BELOW AT ANY POINT WITHIN 36 INCHES HORIZONTALLY TO THE EDGE OF THE OPEN SIDE. INSECT SCREENING SHALL NOT BE CONSIDERED AS A GUARD. 2. REQUIRED GUARDS SHALL BE NOT LESS THAN 36 INCHES IN HEIGHT AS MEASURED VERTICALLY ABOVE THE ADJACENT WALKING SURFACE OR THE LINE CONNECTING THE LEADING EDGES OF THE TREADS. 3. REQUIRED GUARDS SHALL NOT HAVE OPENIGNS FROM THE WALKING SURFACE TO THE REQUIRED GUARD HEIGHT THAT ALLOW PASSAGE OF A SPHERE 4 INCHES IN DIAMETER.

1 - CONTRACTOR TO PROVIDE SMOKE ALARMS. SMOKE ALARMS TO BE HARD WIRED, INTERCONNECTED, BATTERY BACKUP, AT EACH SLEEPING ROOM AND IMMEDIATE COMMON AREA OUTSIDE OF SLEEPING ROOMS, AND LOCATED NOT LESS THAN 3 FT. FROM A DOOR TO A BATHROOM WITH A TUB OR SHOWER EXCEPT WHEN THIS REQUIREMENT WILL PREVENT THE INSTALLATION OF A SMOKE ALARM IN A REQUIRED LOCATION, AND IF APPLICABLE, ON EACH ADDITIONAL STORY INCLUDING BASEMENTS AND HABITABLE ATTICS. NOTE: INTERCONNECTION OF SMOKE ALARMS IN EXISTING AREAS SHALL NOT BE REQUIRED WHERE ALTERATIONS/REPAIRS DO NOT RESULT IN REMOVAL OF INTERIOR WALL OR CEILING FINISHES EXPOSING THE STRUCTURE

2 - CONTRACTOR TO INSTALL CARBON MONOXIDE ALARMS. CARBON MONOXIDE ALARMS TO BE HARD WIRED WITH BATTERY BACKUP, INSTALLED OUTSIDE OF EACH SEPARATE SLEEPING AREA IN THE IMMEDIATE VICINITY OF HE BEDROOMS IN DWELLING UNITS WITHIN WHICH FUEL-

VISITABLITY STANDARDS

DIRECTLY BEHIND THE LAVATORY

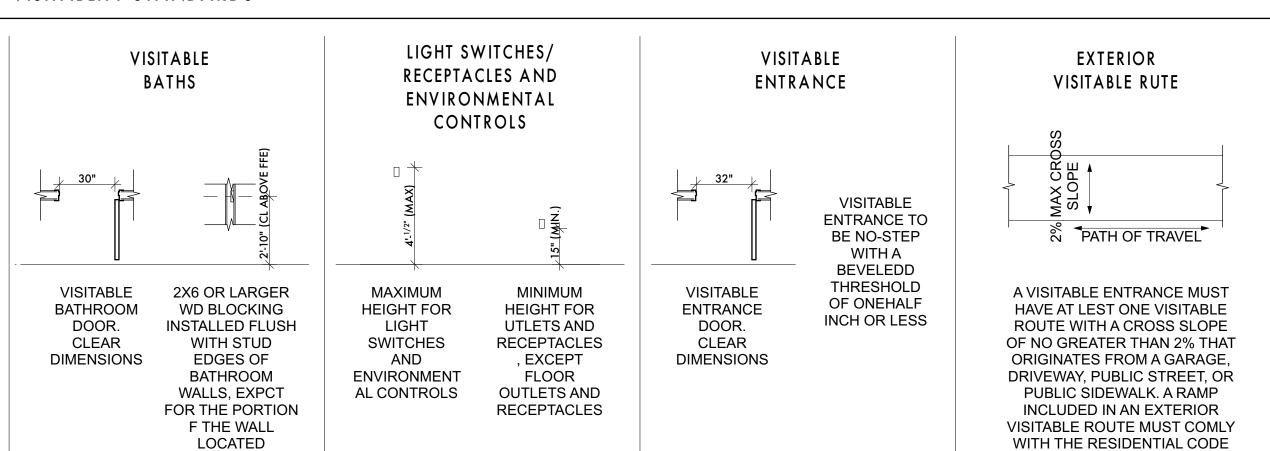

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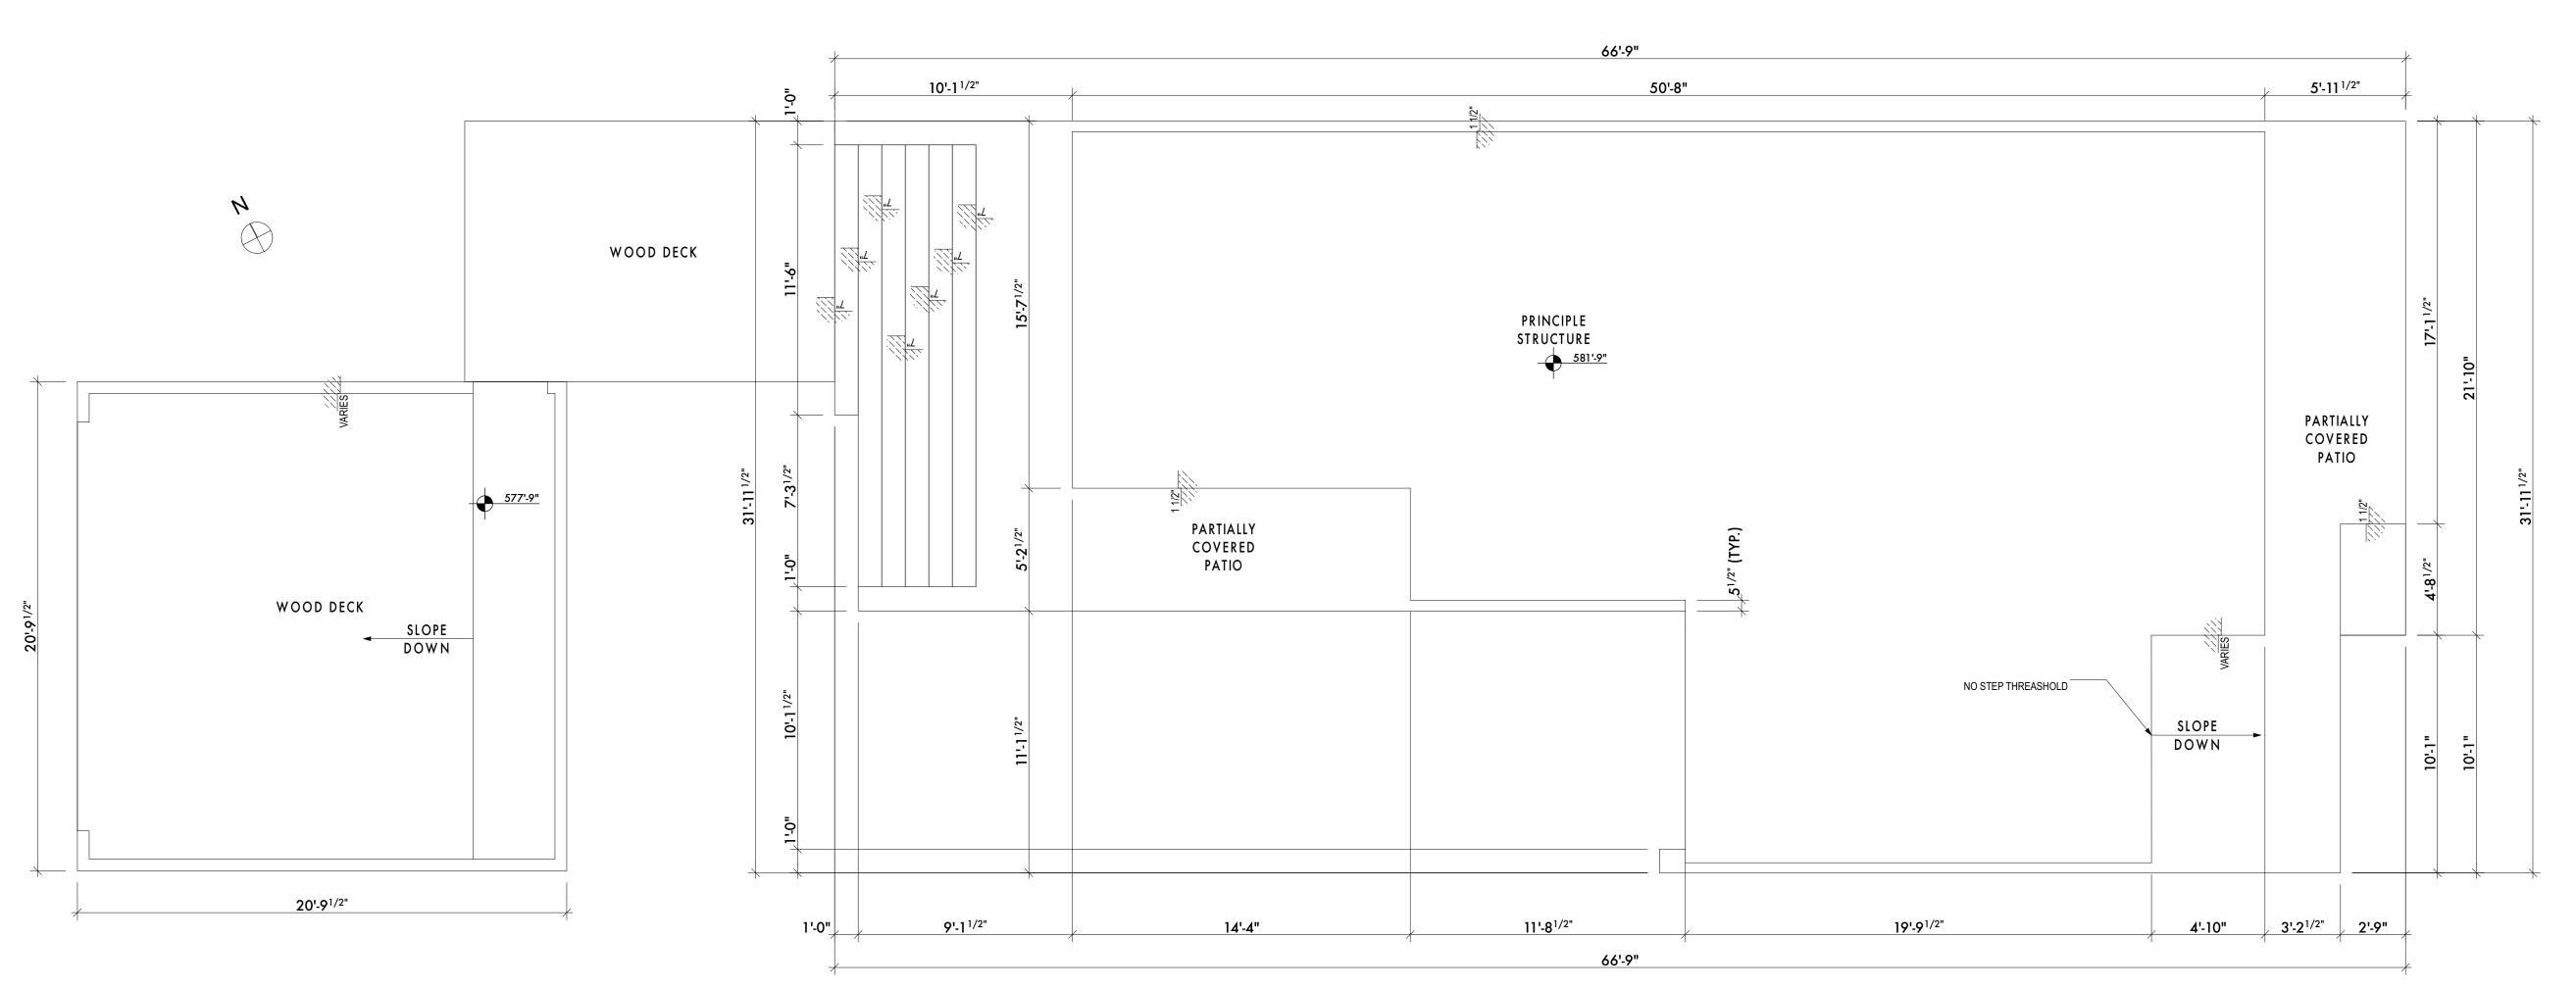


CIFICATIONS / SCHEDULES

220702

10/20/2022 EMP

EMP Sheet Number



ARCHITECTURAL FOUNDATION PLAN

SCALE: 1/4" = 1'-0"

NOTE: FOUNDATION MUST BE DESIGNED BY A TEXAS REGISTERED STRUCTURAL ENGINEER.

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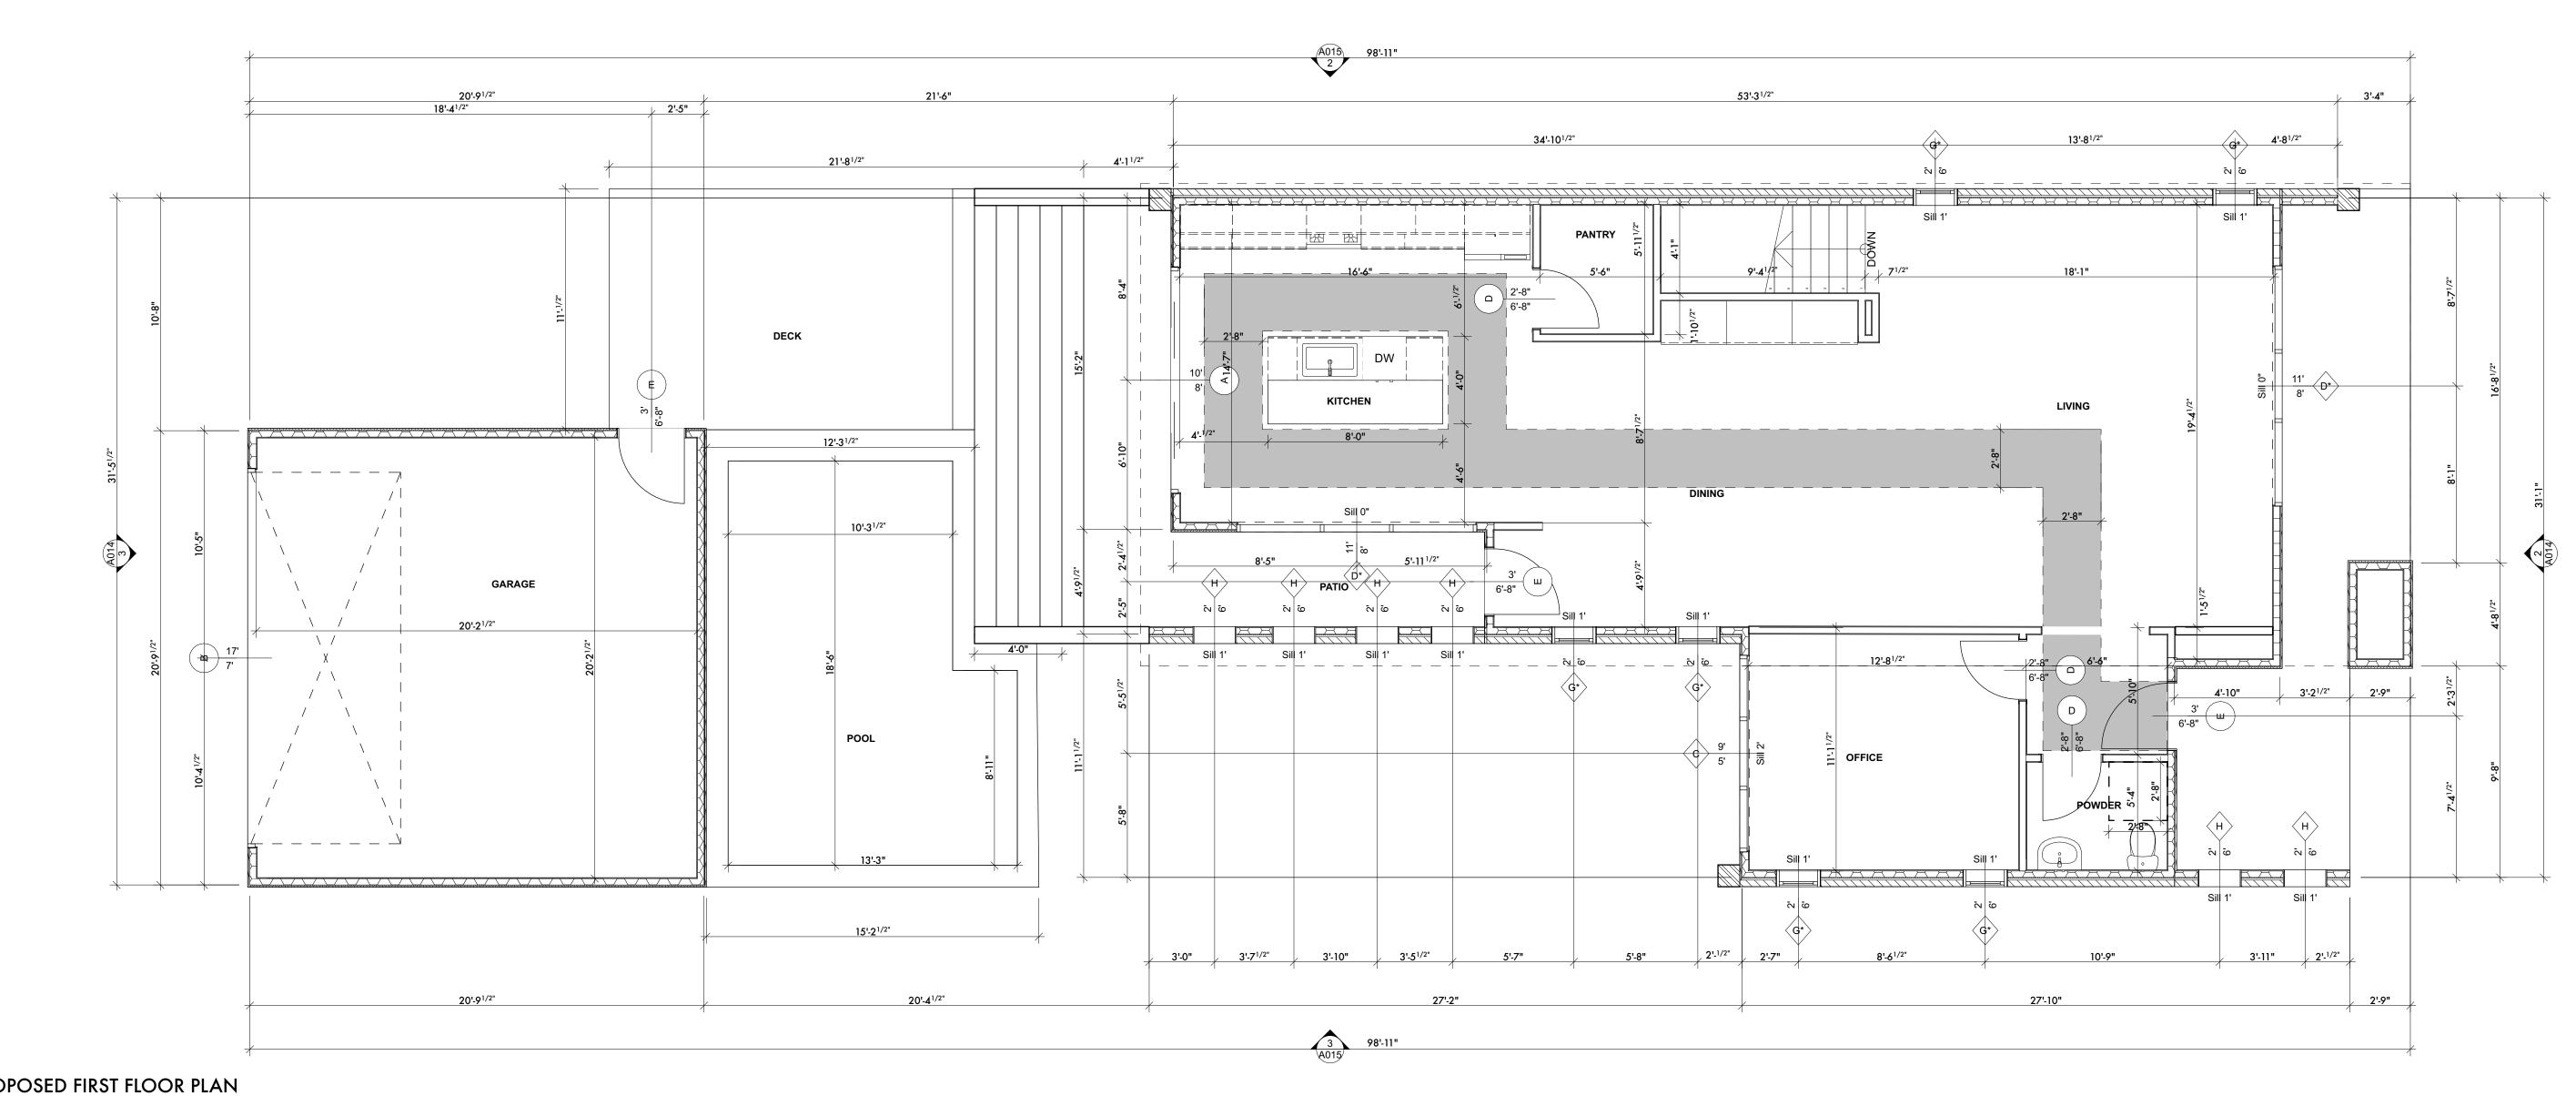
ARCHITECTURAL FOUNDATION
PLAN

Project #: 220702 Date: 10/20/2022

Drawn:

Chkd: EMP


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PROPOSED FIRST FLOOR PLAN

SCALE: 1/4" = 1'-0"

NOTE: UNLESS NOTED OTHERWISE C.H. TO BE 8'-0" AFF



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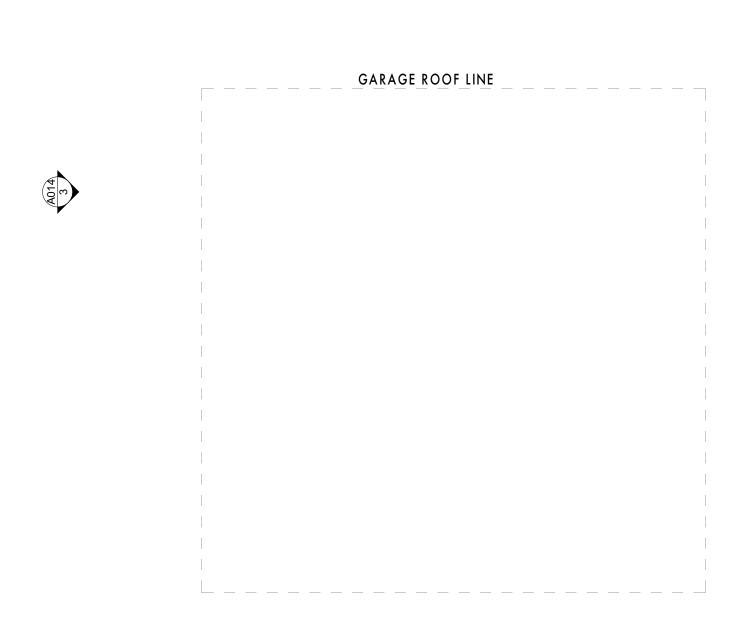
FLOOR PLANS

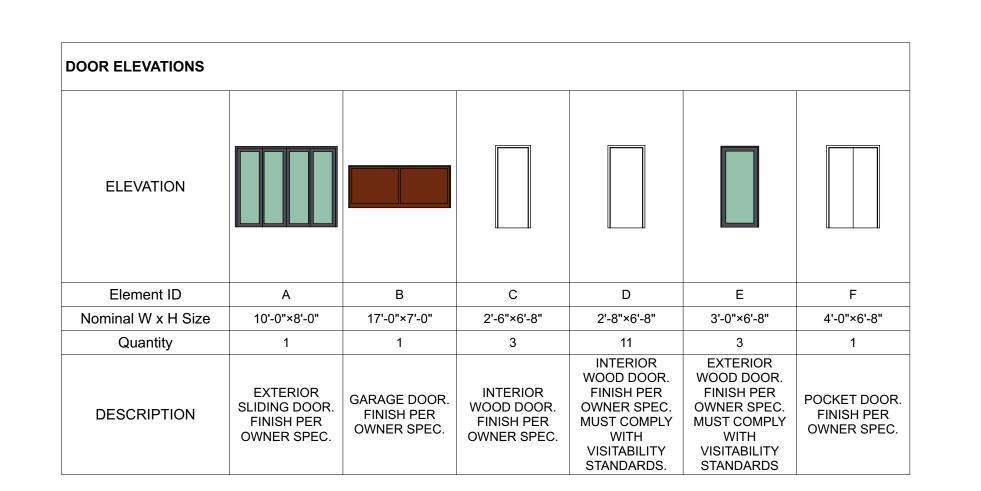220702

10/20/2022

Drawn: **EMP**


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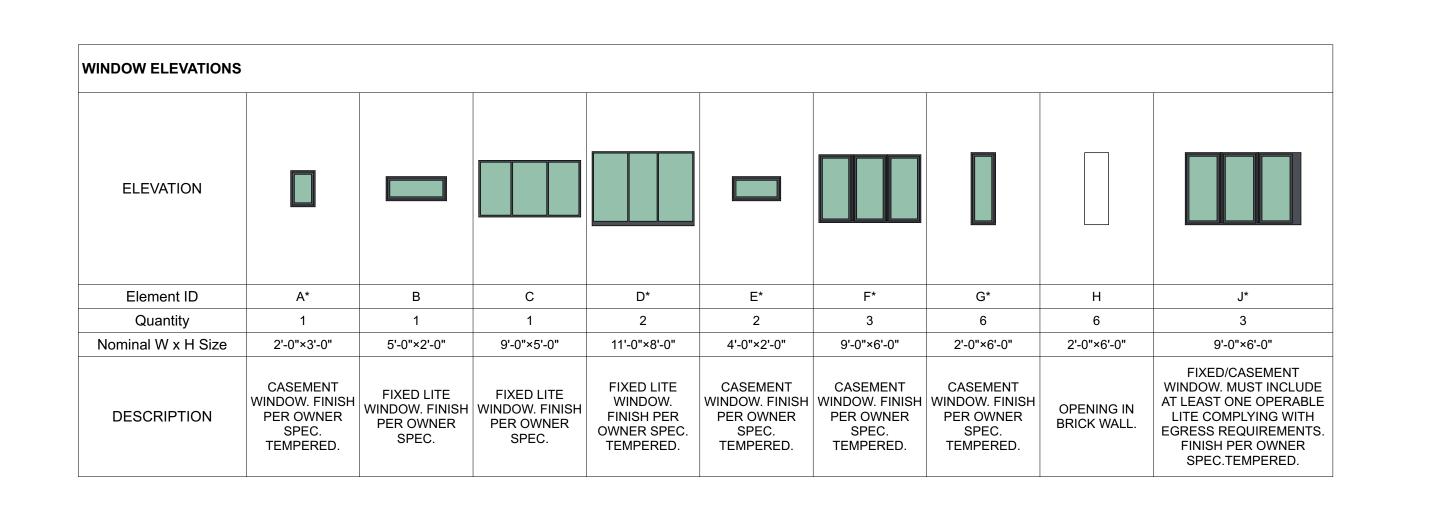


PROPOSED SECOND FLOOR PLAN

SCALE: 1/4" = 1'-0"

NOTE: UNLESS NOTED OTHERWISE C.H. TO BE 8'-0" AFF



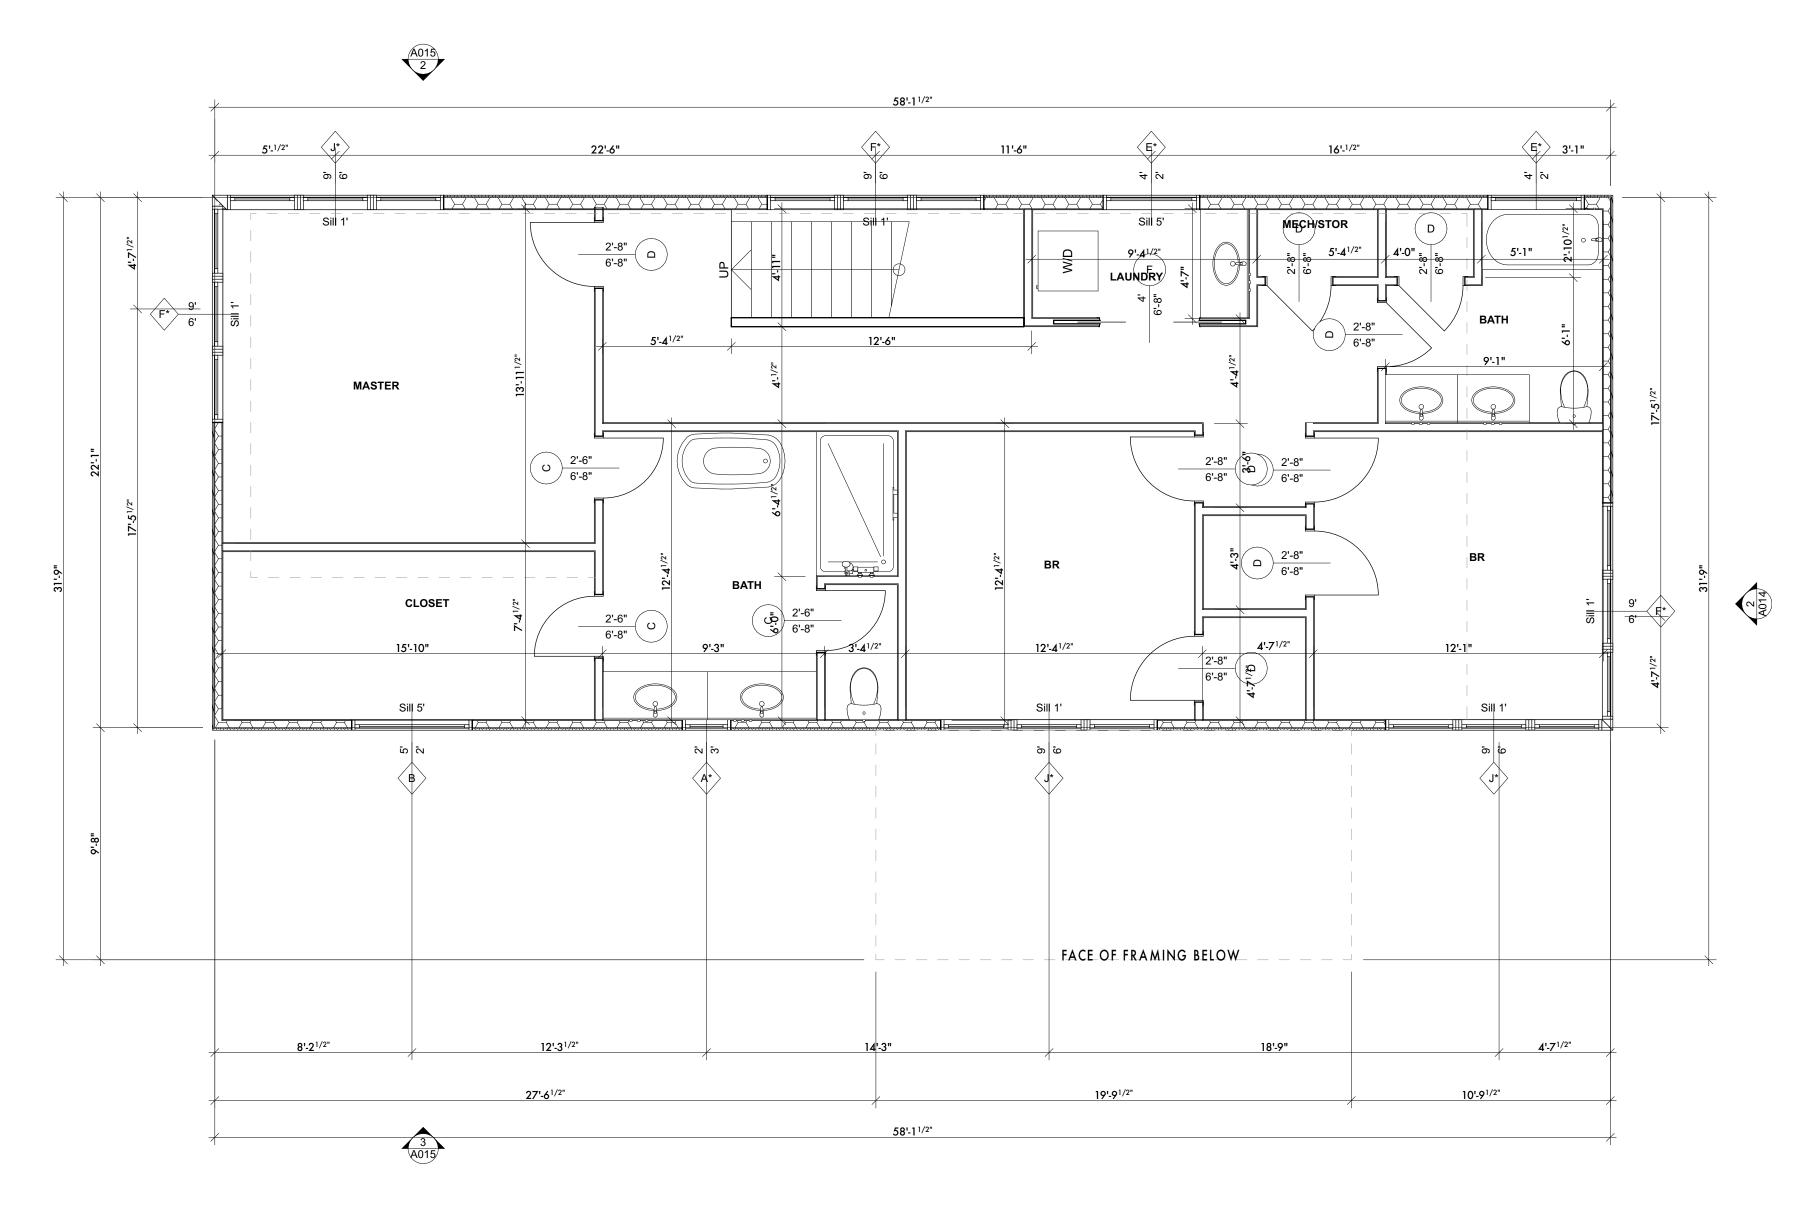

BRACKENRIDGE RESIDENCE
1804 BRACKENRIDGE, AUSTIN, TEXAS

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10/20/2022

ISSUED FOR PERMITTING AND CONSTRUCTION

FLOOR PLANS

Project #: 220702

Date: 10/20/2022

Drawn: EMP

Chkd: **EMP**

ADDITIONAL NOTES:

1. HANDRAILS WILL BE PROVIDED ON NOT LESS THAN ONE SIDE OF EACH CONTINUOUS RUN OF TREADS OR FLIGHT WITH FOUR OR MORE RISERS. WITH FOUR OR MORE RISERS.

2. HANDRAIL HEIGHT, MEASURED VERTICALLY FROM THE SLOPED PLAN ADJOINING THE TREAD NOSING, OR FINISH SURFACE OF RAMP SLOE, SHALL BE NOT LESS THAN 34 INCHES AND NOT MOR THAN 38 INCHES 3. HAINRAILS FOR STAIRWAYS SHALL BE CONTINUOUS FOR THE FULL LENGTH OF THE FLIGHT, FROM A POINT DIRECTLY ABOVE THE TOP RISER OF THE FLIGHT TO A POINT DIRECTLY ABOVE THE LOWEST RISER OF THE FLIGHT. HANDRAIL ENDS SHALL BE RETURNED OR SHALL TERMINATE IN NEWEL POSTS OR SAFETY TERMINALS. HANDRAILS ADJACENT TO A WALL SHALL HAVE A SPACE OF NOT LESS THAN 1 1/2" INCHES BETWEEN THE WALL AND THE HANDRAILS. 4. HANDRAILS SHALL HAVE A CIRCULAR CROSS SECTION AND SHALL HAVE AN OUTSIDE DIAMATER OF NOT LESS THAN 1 1/4" AND NOT GREATER THAN 2"


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2. REQUIRED GAARDS SHALL BE NOT LESS THAN 36 INCHES IN HEIGHT AS MEASURED VERTICALLY ABOVE THE ADJACENT WALKING SURFACEOUS THE ADJACENT WALKING SURFACE OR THE LINE CONNECTING THE LEADING EDGES OF THE TREADS. 3. REQUIRED GUARDS SHALL NOT HAVE OPENIGNS FROM THE WALKING SURFACE TO THE REQUIRED GUARD HEIGHT THAT ALLOW PASSAGE OF A SPHERE 4 INCHES IN DIAMETER.


ALARMS: 1 - CONTRACTOR TO PROVIDE SMOKE ALARMS. SMOKE ALARMS TO BE HARD WIRED, INTERCONNECTED, BATTERY BACKUP, AT EACH SLEEPING ROOM AND IMMEDIATE COMMON AREA OUTSIDE OF SLEEPING ROOMS, AND LOCATED NOT LESS THAN 3 FT. FROM A DOOR TO A BATHROOM WITH A TUB OR SHOWER EXCEPT WHEN THIS REQUIREMENT WILL PREVENT THE INSTALLATION OF A SMOKE ALARM IN A REQUIRED LOCATION, AND IF APPLICABLE, ON EACH ADDITIONAL STORY INCLUDING BASEMENTS AND HABITABLE ATTICS. NOTE: INTERCONNECTION OF SMOKE ALARMS IN EXISTING AREAS SHALL NOT BE REQUIRED WHERE ALTERATIONS/REPAIRS DO NOT RESULT IN REMOVAL OF INTERIOR WALL OR CEILING FINISHES EXPOSING THE STRUCTURE. 2 - CONTRACTOR TO INSTALL CARBON MONOXIDE ALARMS. CARBON MONOXIDE ALARMS TO BE HARD WIRED WITH BATTERY BACKUP, INSTALLED OUTSIDE OF EACH SEPARATE SLEEPING AREA IN THE IMMEDIATE VICINITY OF HE BEDROOMS IN DWELLING UNITS WITHIN WHICH FUEL-

SCALE: 1/4" = 1'-0"

		<u></u>	
ŒΑ	RECESSED CAN LIGHT	\\\\\\\\\\\\\\\\\\\\\\\\\\\\\\\\\\\\\\	LED STRIP LIGHT
Жв	PULL CHAIN LIGHT	®	SMOKE DETECTOR
Øc.	CHANDELIER	®	CARBON MONOXIDE DETECTOR
ŀф-×	EXTERIOR WALL SCONCE	Ø	JUNCTION BOX
 ф-а	INTERIOR WALL SCONCE	+	DUPLEX OUTLET
Ю-ч	VANITY SINK LIGHT	₩	UNDER COUNTER DUPLEX OUTLET
ΩP	PENDANT LIGHT	Ø	CABLE TV/ INTERNET JACK
Ð	SURFACE MOUNTED FLOUR. FIXTURE	\$	SWITCH
	CEILING FAN	S	PUSH BUTTON SWITCH
Ø	COMBO LIGHT/FAN		

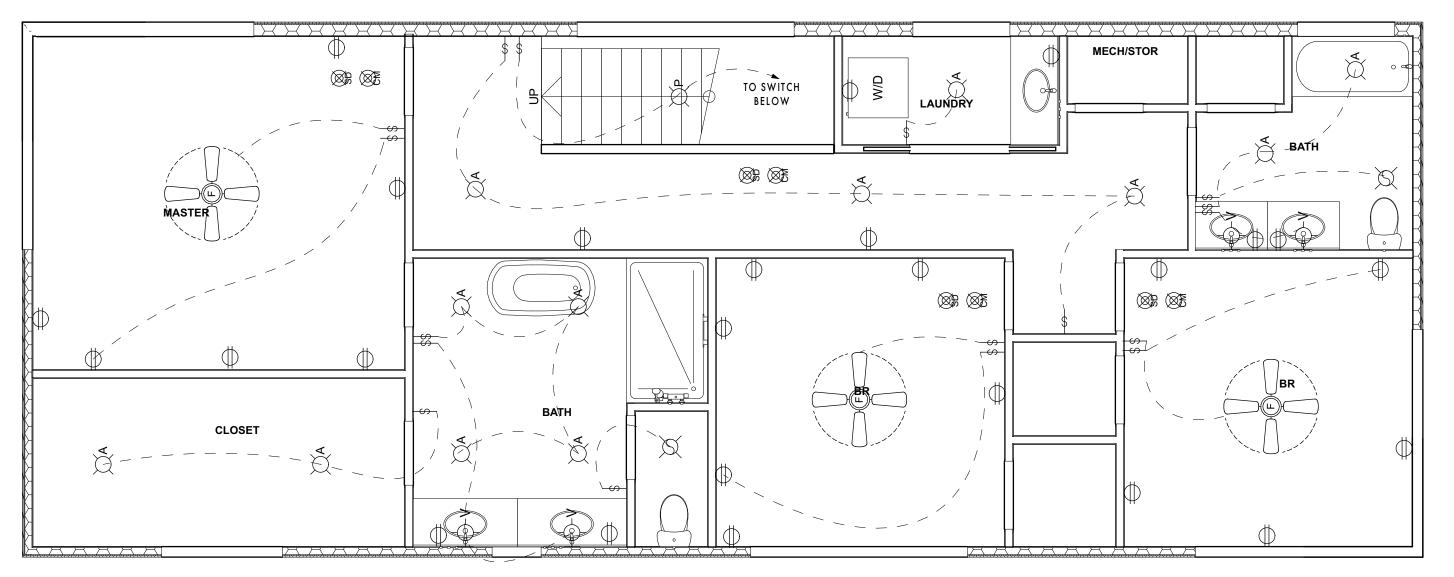

PROPOSED SECOND FLOOR ELECTRICAL PLAN SCALE: 1/4" = 1'-0"

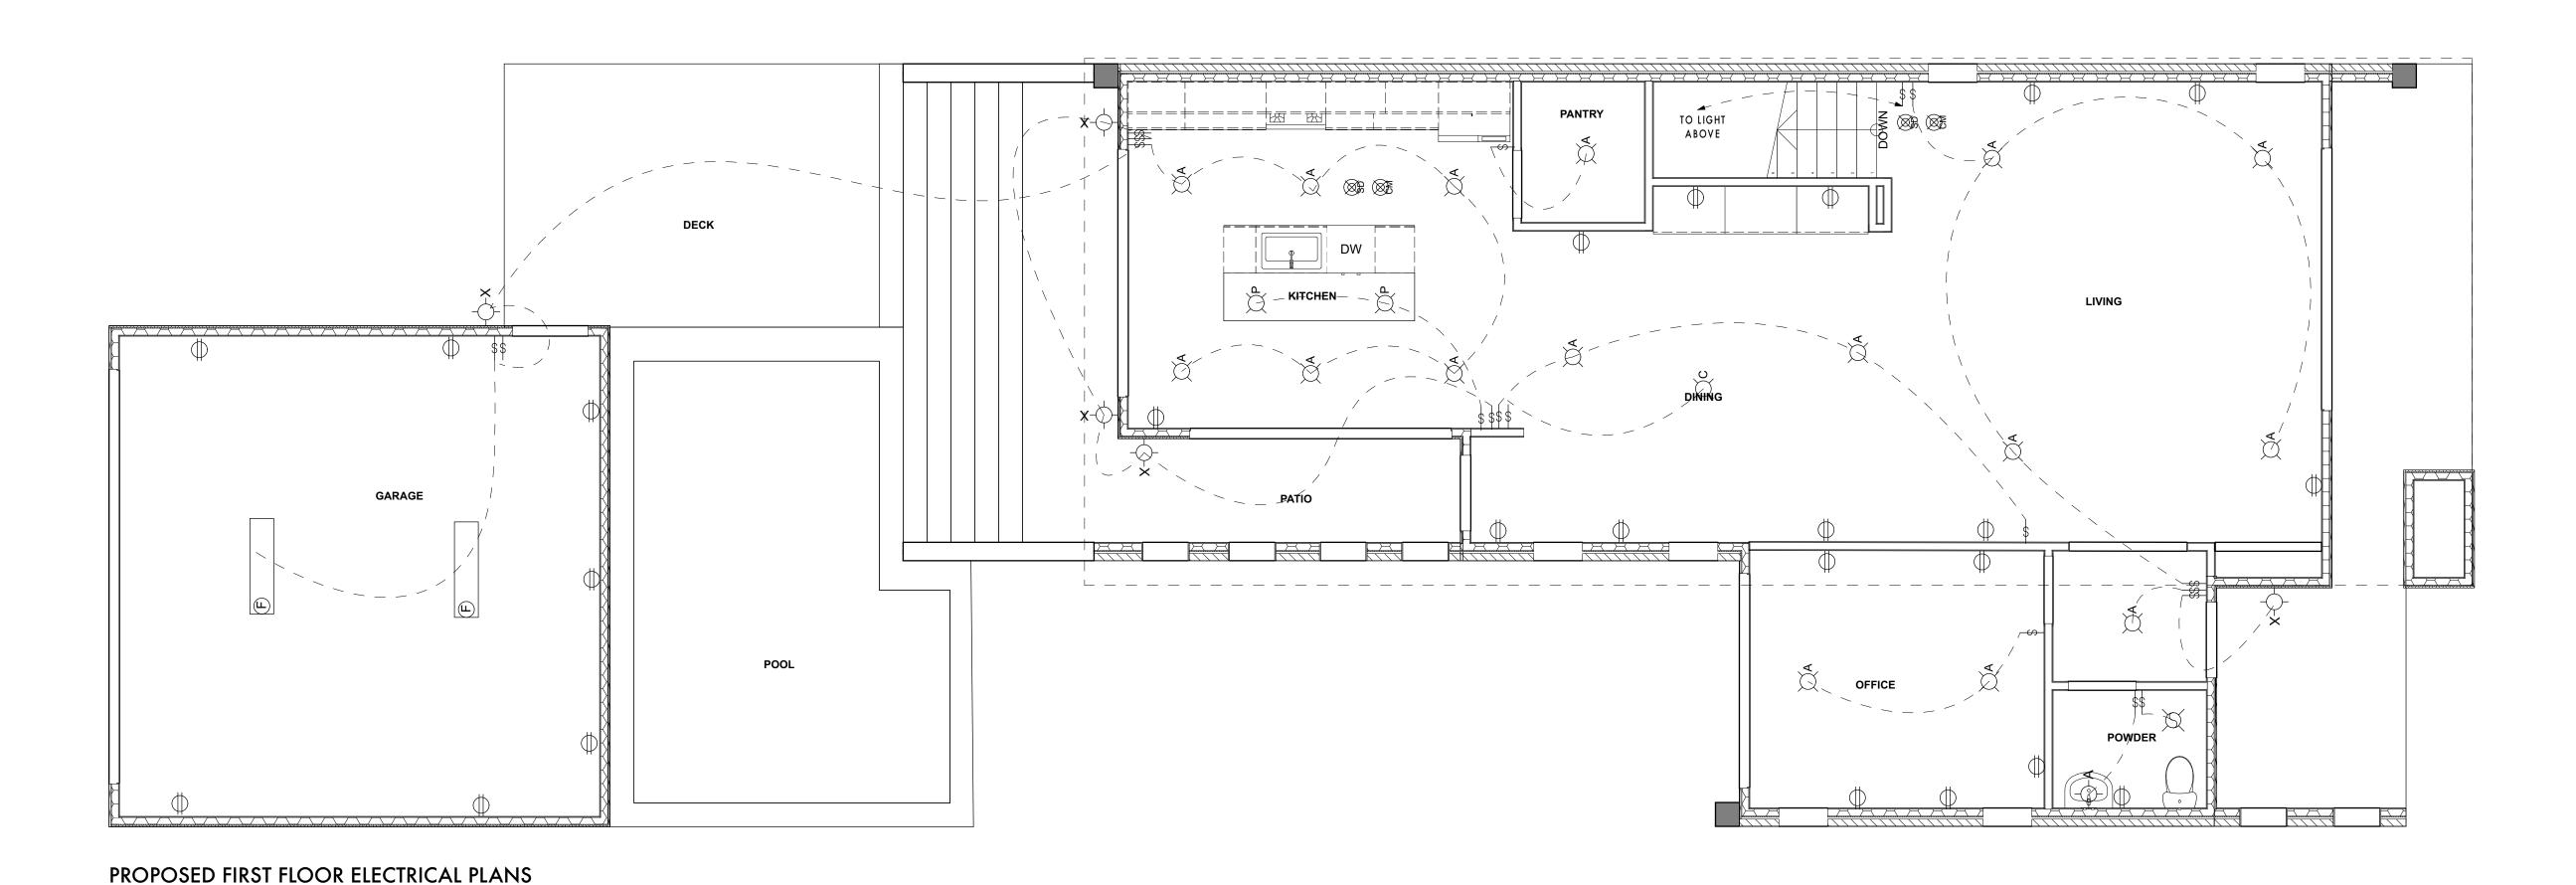

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ELECTRICAL PLANS

220702


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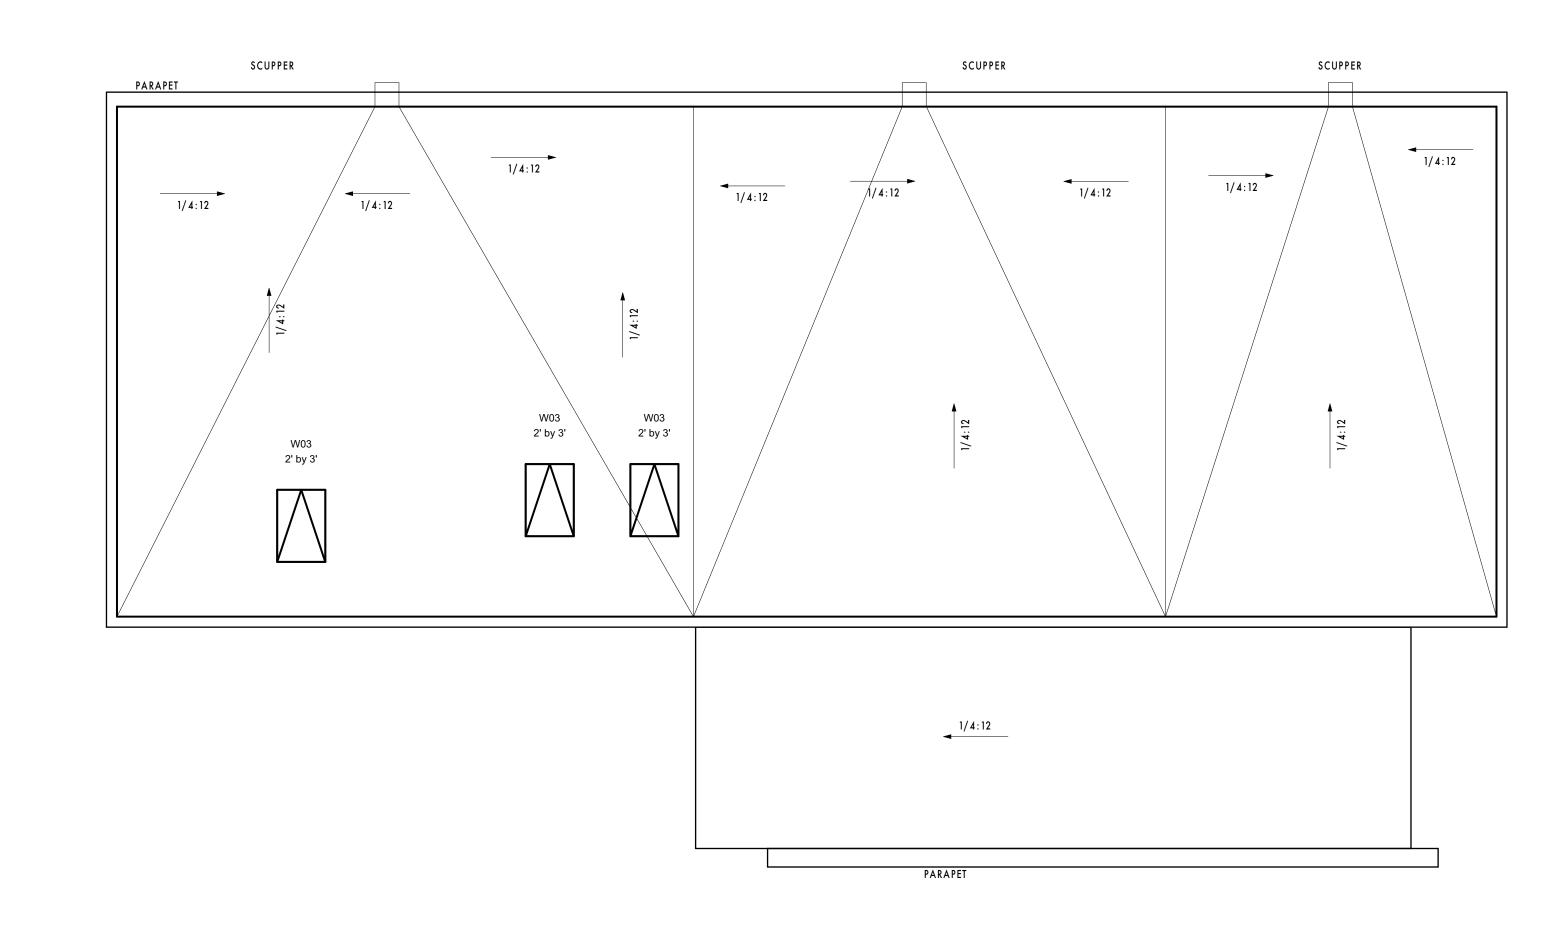
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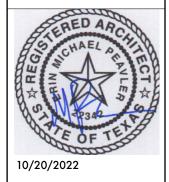




BRACKENRIDGE RESIDENCE
1804 BRACKENRIDGE, AUSTIN, TEXAS

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DN HISTORY

ISSU

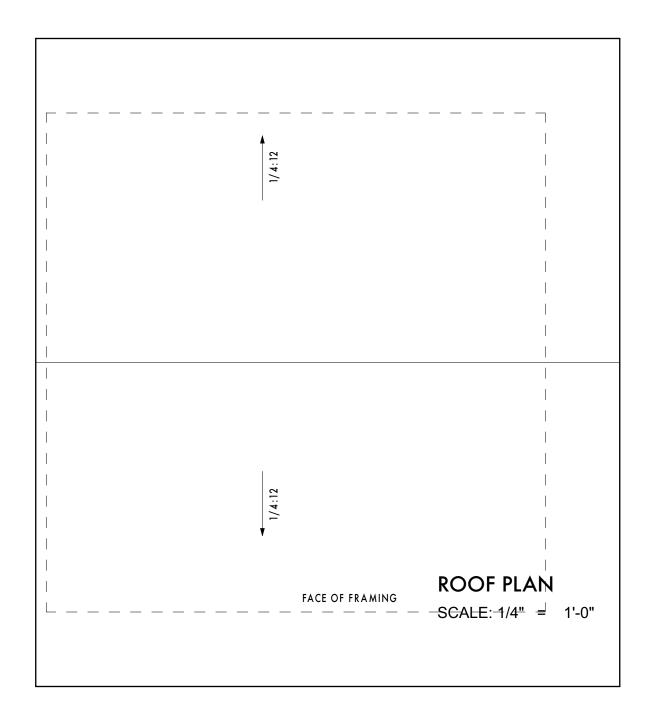ISSU

PERMIT

CONS:

ROOF PLAN

Project #: 220702

Date: 10/20/2022

Drawn: EMP

Chkd: EMP

Sheet Number


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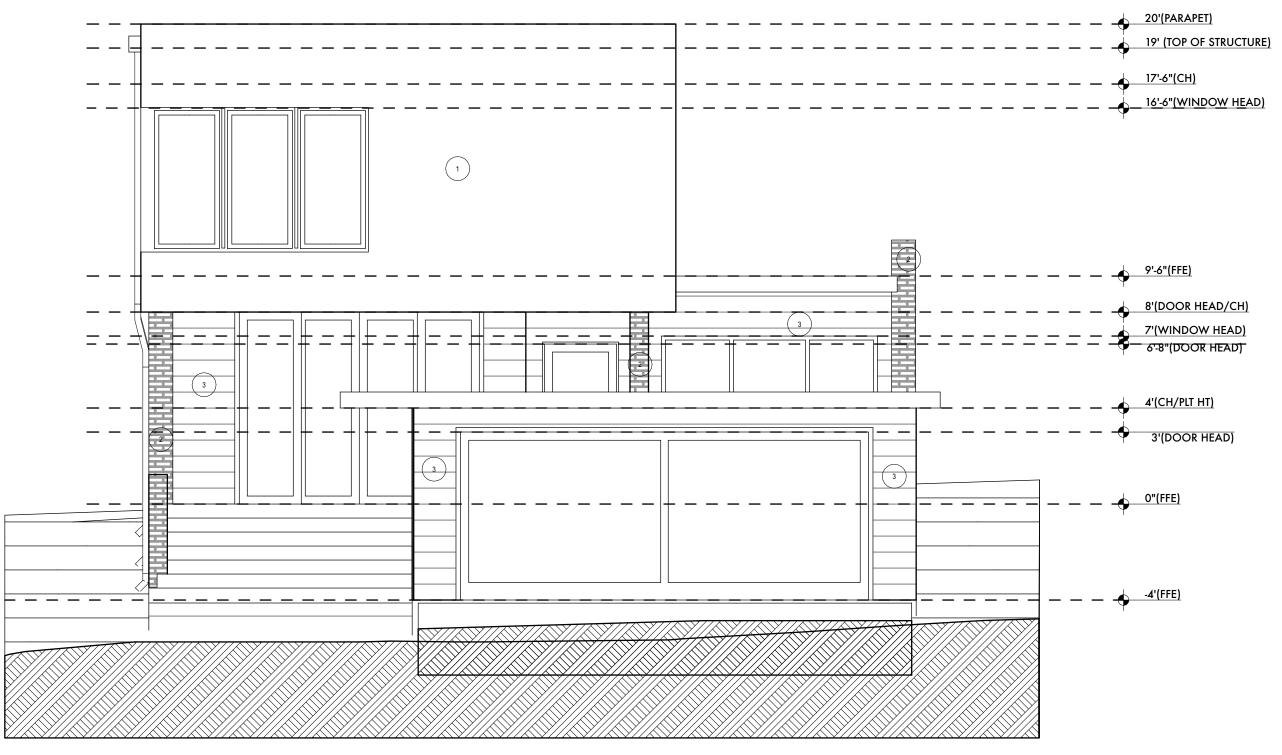



VIEW FROM NE SCALE: 1/8" = 1'-0"



VIEW FROM SE SCALE: 1/8" = 1'-0"



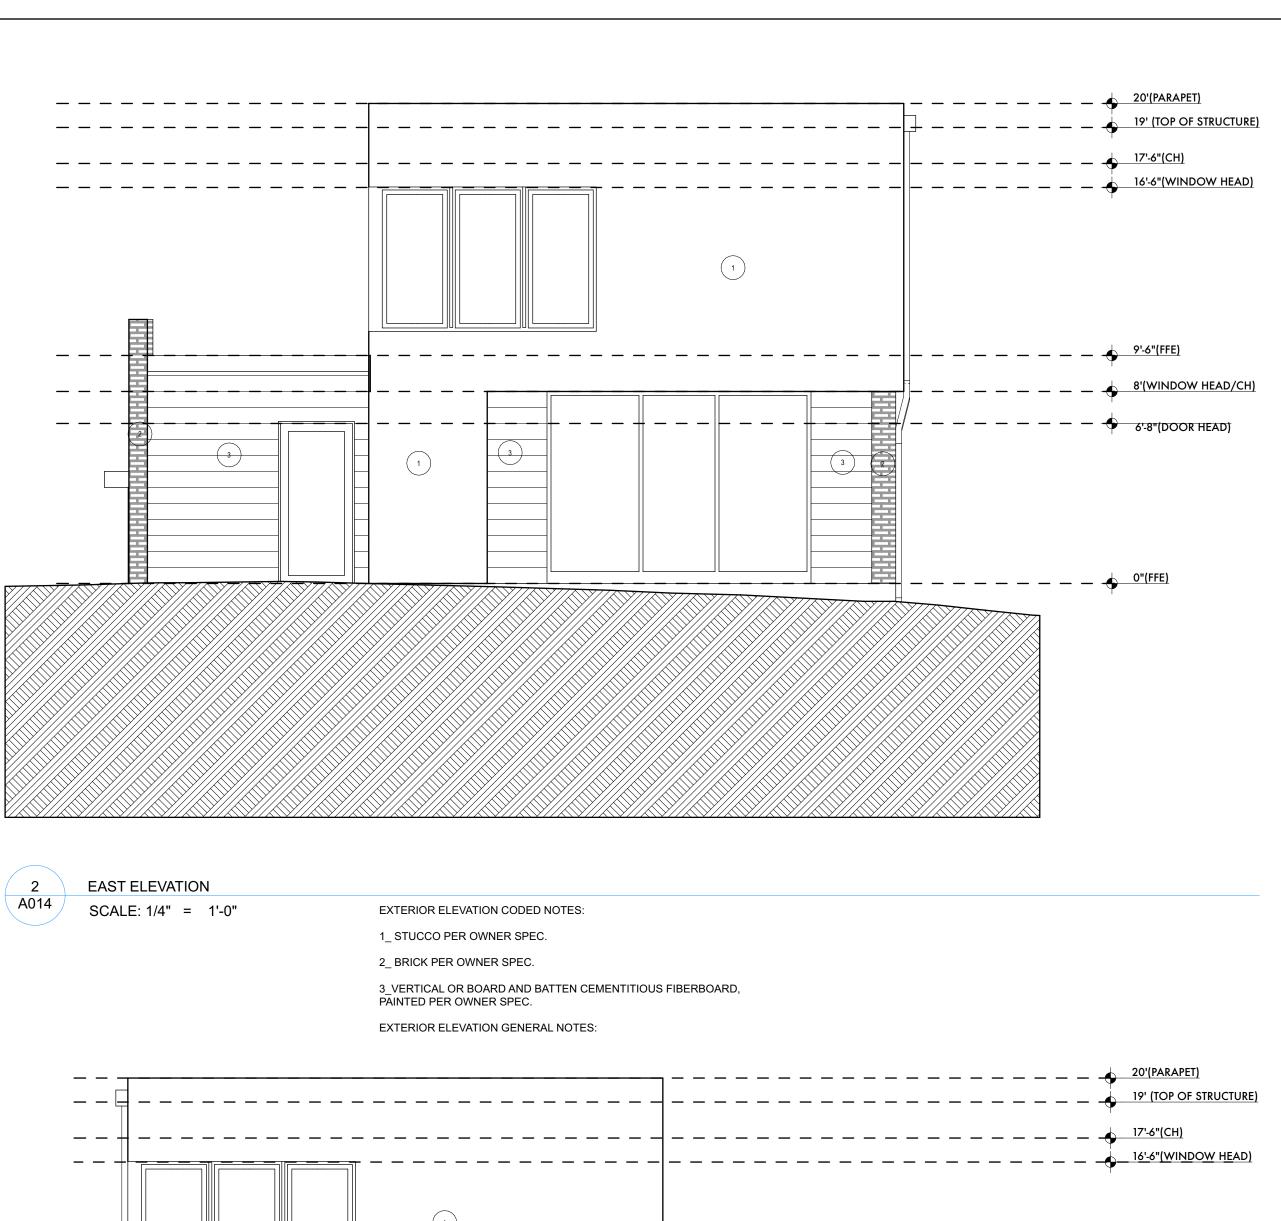

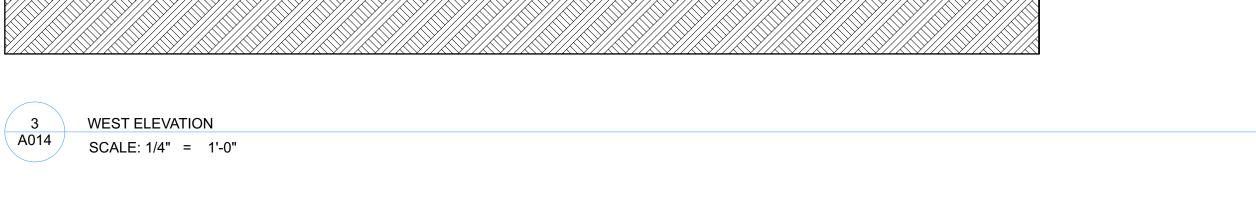

EXTERIOR ELEVATIONS

Sheet Number

Project #: 220702

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Chkd: **EMP**


RESIDENCE

BRACKENRIDGE

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To Whom It May Concern,

I have authorized Erin Michael Peavler and Lindsey Nicole Peavler to act as my agent in investigating requirements, obtaining permits and performing related activities regarding construction projects at my property at 1804 Brackenridge, Austin, TX.

Ihu, Justee of Gelman Trust

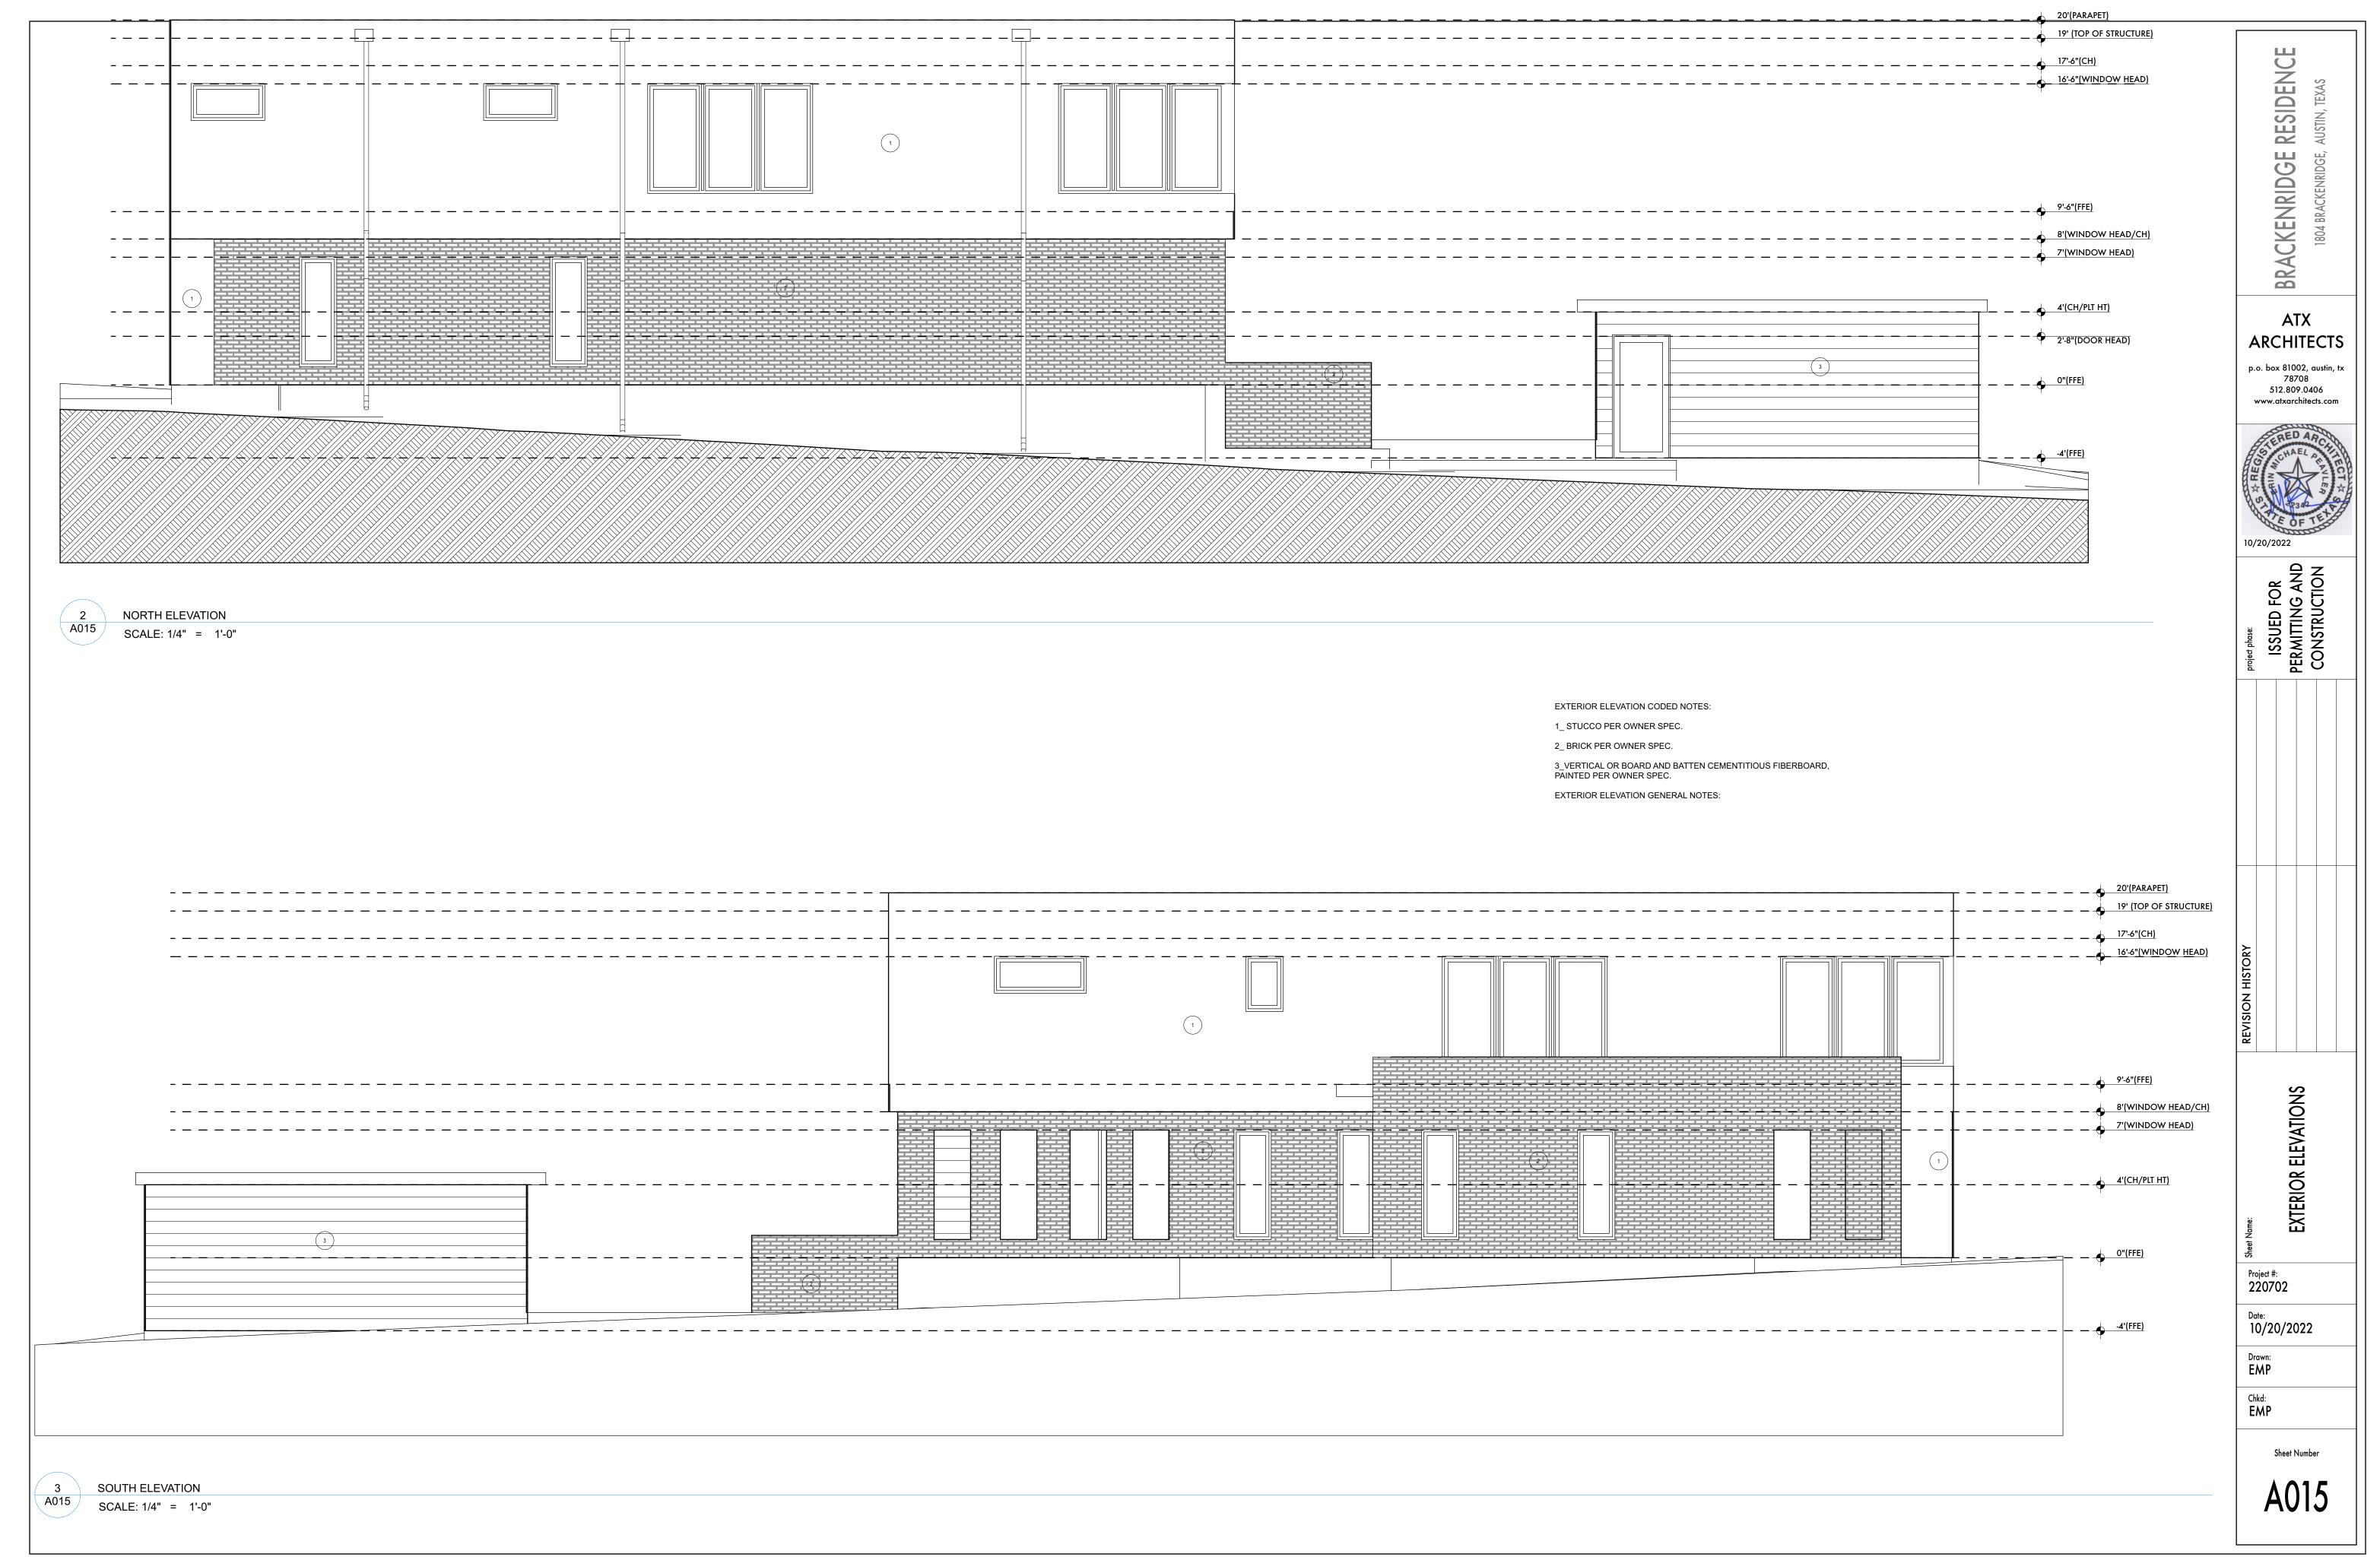See attached to notarization

Lisa M Gellman, Gellman Trust

Notary Confirmation:

State of Texas

County of Travis

This instrument was acknowledged before me on \(\bigcup_{29\bigcup_{27}} \) by Lisa M Gellman

Notary Public Signature

	LENGAN MANGAGABAN MENGAGABAN MENGAGABAN MENGAGABAN MENGAGABAN MENGAGABAN MENGAGABAN MENGAGABAN MENGAGABAN MENGAGA		
A notary public or other officer completing this certificate veri to which this certificate is attached, and not the truthfulness	fies only the identity of the individual who signed the document, accuracy, or validity of that document.		
State of California			
County of Los Angeles			
On (0 29 2027 before me,	Mitchell Chiasion, Notary Public		
Date	Here Insert Name and Title of the Officer		
personally appeared Lisa Gellman			
1	Name(s) of Signer(s)		
to the within instrument and acknowledged to me tha authorized capacity(ies), and that by his/her/their signupon behalf of which the person(s) acted, executed the	ature(s) on the instrument the person(s), or the entity		
MITCHELL CHIASSON Notary Public - California Los Angeles County	I certify under PENALTY OF PERJURY under the laws of the State of California that the foregoing paragraph is true and correct.		
Commission = 2374399 v, Comm. Expires Sep 9, 2025	WITNESS my hand and official seal.		
	Signature		
Place Notary Seal and/or Stamp Above	Signature of Notary Public		
OPTI	ONAL		
	deter alteration of the document or form to an unintended document.		
Description of Attached Document			
Title or Type of Document:			
Document Date:	Number of Pages:		
Signer(s) Other Than Named Above:			
Capacity(ies) Claimed by Signer(s)			
	Signer's Name		
Signer's Name: Corporate Officer – Title(s):	Signer's Name: Corporate Officer – Title(s):		
□ Partner - □ Limited □ General	□ Partner - □ Limited □ General		
☐ Individual ☐ Attorney in Fact	☐ Individual ☐ Attorney in Fact		
☐ Trustee ☐ Guardian or Conservator	☐ Trustee ☐ Guardian or Conservator		
□ Other:	□ Other:		
Signer is Representing:	Signer is Representing:		