PΚ

PM

PO

PP

PR

PSF

PSI

PLYWOOD

STEEL

STONE

PLASTER OR STUCCO

PREFAB

PLAST

Plate or Plateline

Plastic Laminate

Project Manual

Plaster Opening

Power Pole

Prefabricated

Pounds per Square Foot

Pounds per Square Inch

Plaster

Plumbing

GENERAL NOTES

TO, DUSTING, SWEEPING, AND MOPPING.

CODE COMPLIANCE: ALL WORK PERFORMED SHALL BE COMPLETED IN ACCORDANCE WITH ALL STATE, FEDERAL, AND LOCAL CODES, ORDINANCES, AND LAWS, INCLUDING, AS A MINIMUM STANDARD, THE 2021 INTERNATIONAL

PERMITTING: CONTRACTOR SHALL APPLY FOR AND FUND ALL APPLICABLE PERMITS AND COORDINATE ALL INSPECTIONS WITH THE CITY OF AUSTIN AS REQUIRED.

COORDINATION: CONTRACTOR SHALL COORDINATE WORK BETWEEN ALL TRADES IN THIS CONTRACT. ANY CONFLICTS SHALL BE BROUGHT TO THE ARCHITECT'S ATTENTION PRIOR TO THE WORK BEING INSTALLED. FAILURE TO DO SO WILL MAKE THE CONTRACTOR RESPONSIBLE FOR THE COST TO CORRECT THE WORK.

BID DOCUMENTS: THE INFORMATION CONTAINED IN THESE CONSTRUCTION DOCUMENTS (DRAWINGS) IS IN ITSELF INCOMPLETE AND VOID UNLESS USED IN CONJUNCTION WITH ALL OF THE CONTRACT DOCUMENTS AND WITH ALL OF THE SPECIFICATIONS. TRADE PRACTICES, OR APPLICABLE STANDARDS, CODES, ETC. INCORPORATED THEREIN BY REFERENCE WHICH THE CONTRACTOR CERTIFIES KNOWLEDGE OF BY SIGNING THE CONTRACT.

FAMILIARITY WITH CONDITIONS: THE CONTRACTOR SHALL VISIT THE SITE OF THE PROPOSED WORK AND FULLY ACQUAINT HIMSELF WITH THE EXISTING CONDITIONS RELATING TO CONSTRUCTION AND LABOR, AND SHALL FULLY INFORM HIMSELF AS TO THE FACILITIES INVOLVED, THE DIFFICULTIES, RESTRICTIONS, AND LOGICAL EXTENSIONS OF SCOPE ATTENDING THE PERFORMANCE OF THE CONTRACT. THE CONTRACTOR SHALL THOROUGHLY EXAMINE AND FAMILIARIZE HIMSELF WITH THE REQUIREMENTS OF THE CONTRACT DOCUMENTS. THE CONTRACTOR BY THE EXECUTION OF THE CONTRACT SHALL IN NO WAY BE RELIEVED OF ANY OBLIGATION UNDER THE CONTRACT BECAUSE OF HIS FAILURE TO RECEIVE OR EXAMINE ANY FORM OR LEGAL DOCUMENT OR TO VISIT THE SITE AND INFORM HIMSELF THOROUGHLY REGARDING ANY AND ALL CONDITIONS AND REQUIREMENTS THAT MAY IN ANY MANNER AFFECT THE WORK TO BE PERFORMED UNDER THE CONTRACT. LACK OF KNOWLEDGE ON THE PART OF THE CONTRACTOR WILL IN NO WAY RELIEVE HIM OF THE OBLIGATIONS AND RESPONSIBILITIES ASSUMED UNDER THE

WORK IN HISTORICAL BUILDINGS AND SITES: HISTORICAL DESIGNATION OF BUILDINGS ON SITE REQUIRES CONTRACTOR TO EXERCISE SPECIAL CAUTION IN EXECUTING ALL STAGES OF WORK TO PREVENT UNNECESSARY DAMAGE TO HISTORICAL FEATURES, CONDITIONS, OR MATERIALS. CONTRACTOR TO APPRISE ALL SUB-CONTRACTORS AND WORKMEN OF SPECIAL PRECAUTIONS REQUIRED WHEN WORKING WITH HISTORIC BUILDINGS. CONTRACTOR TO MONITOR THE WORK OF ALL TRADES TO PREVENT UNNECESSARY OR OTHERWISE AVOIDABLE DAMAGE TO HISTORICAL FEATURES, CONDITIONS, OR MATERIALS. CONTRACTOR SHALL IMMEDIATELY NOTIFY ARCHITECT AND OWNER AS CONCEALED HISTORICAL CONDITIONS ARE UNCOVERED DURING THE COURSE OF THE WORK AND SHALL ALLOW AND FACILITATE THE DOCUMENTATION OF THOSE CONDITIONS.

IF, DURING THE COURSE OF EXCAVATION, ARTIFACTS ARE DISCOVERED BELOW GRADE, STOP WORK IN THE AREA AND IMMEDIATELY CONTACT THE OWNER AND THE ARCHITECT TO COORDINATE ARCHEOLOGICAL DOCUMENTATION.

VERIFICATION OF DIMENSIONS: CONTRACTOR SHALL CHECK AND VERIFY ALL DIMENSIONS, BUILDING ELEVATIONS, AND CONDITIONS BOTH EXISTING AND NEW. REPORT ANY AND ALL DISCREPANCIES TO THE ARCHITECT BEFORE BEGINNING ANY PHASE OF WORK. DO NOT SCALE DRAWINGS. ALL NEW PARTITIONS SHALL BE MARKED ON THE EXISTING FLOOR SURFACE FOR REVIEW BY THE ARCHITECT PRIOR TO WALL CONSTRUCTION. CONTRACTOR IS RESPONSIBLE FOR ALL ACCURATE FIELD DIMENSIONS AND MEASUREMENTS INCLUDING SLOPE.

PROTECTION OF BUILDING AND SITE: CONTRACTOR SHALL PROTECT ALL SURFACES NOT SCHEDULED FOR WORK UNDER THIS CONTRACT. ANY DAMAGE TO THE EXISTING STRUCTURE AND SITE THAT OCCURS FOLLOWING THE NOTICE TO PROCEED SHALL BE CORRECTED TO PRE-CONSTRUCTION CONDITION AT NO EXPENSE TO THE OWNER. CONTRACTOR SHALL KEEP THE BUILDING SECURE AND WEATHER-TIGHT AT ALL TIMES. ALL NEW PENETRATIONS SHALL BE MARKED ON THE EXISTING SURFACES FOR REVIEW BY THE ARCHITECT PRIOR TO THEIR DEMOLITION.

INTERIOR CLIMATE CONTROLS: INTERIOR FINISH WORK SHALL NOT PROCEED UNTIL INTERIOR IS CLIMATE CONTROLLED. INTERIOR TEMPERATURE AND HUMIDITY CONTROLS SHALL BE STABLE FOR A MINIMUM OF 24 HOURS PRIOR TO COMMENCEMENT OF FINISH WORK AS REQUIRED IN APPLICABLE DIVISION 9 SECTIONS, AND REMAIN STABLE THROUGH PROJECT COMPLETION. TEMPORARY HEAT SHALL BE PROVIDED AS NEEDED TO PREVENT CONDENSATION ON THE WALLS AND CEILINGS THROUGHOUT THE COURSE OF THE WORK.

HAZARDOUS MATERIALS ABATEMENT/MANAGEMENT: THE ARCHITECT HAS NO RESPONSIBILITY OR LIABILITY FOR DESIGN, REMOVAL OF, OR TESTING FOR HAZARDOUS MATERIALS. CONTRACTOR SHALL FOLLOW ALL APPLICABLE FEDERAL, STATE AND LOCAL LAWS AND REGULATIONS REGARDING THE PROPER AND SAFE MANAGEMENT, REMOVAL AND DISPOSAL OF LEAD-CONTAINING PAINTS AND WASTE MATERIALS GENERATED BY FINISH REMOVAL

BUILDING MAINTENANCE: MAINTAIN AREAS FREE OF WASTE MATERIALS, DEBRIS, AND RUBBISH. MAINTAIN SITE IN A CLEAN AND ORDERLY CONDITION. AREAS USED AS PATHWAYS TO TRANSPORT MATERIALS OR TO REMOVE TRASH THAT ARE NOT DIRECTLY UNDER CONSTRUCTION ARE TO BE KEPT CLEAN. THIS SHALL INCLUDE, BUT NOT BE LIMITED

WARRANTY: ALL WORK SHALL BE WARRANTED BY THE GENERAL CONTRACTOR. REFER TO THE GENERAL CONDITIONS OF THE CONTRACT AND INDIVIDUAL SECTIONS OF DIVISIONS 2 THROUGH 26 FOR SPECIFIC WARRANTY DETAILS.

FIRE PROTECTION: NO SMOKING SHALL BE PERMITTED ON SITE. CONTRACTOR SHALL PROVIDE AND MAINTAIN TEMPORARY FIRE EXTINGUISHERS AT EACH FLOOR OF THE BUILDING UNTIL SUBSTANTIAL COMPLETION.


ACCESSIBILITY: WHERE INDICATED, NEW SIDEWALKS, STEPS, RAMPS, RESTROOMS, ETC. ARE TO COMPLY FULLY WITH

THE TEXAS ACCESSIBILITY STANDARDS AND THE AMERICANS WITH DISABILITIES ACT. TEMPORARY FACILITIES: COORDINATE LOCATION AND PLACEMENT OF CONSTRUCTION FENCE, FIELD OFFICE,

MATERIAL STORAGE, PORTABLE TOILET, DUMPSTER, ETC. WITH ARCHITECT AND OWNER PRIOR TO CONSTRUCTION. REFER TO SECTION 015000 - TEMPORARY FACILITIES.

SAFETY: PERFORM ALL WORK IN A SAFE AND CONSCIENTIOUS MANNER TO PREVENT INJURIES AND DAMAGE TO THE BUILDING. ITS CONTENTS. OR ITS SURROUNDINGS. CONTRACTOR SHALL MAINTAIN OSHA STANDARDS FOR JOB SAFETY AND WORKER PROTECTION AND COMPLY WITH ALL REQUIREMENTS OF THE HEALTH AND SAFETY CODE OF TEXAS, CHAPTER 756, SUBCHAPTER C FOR ADEQUATE TRENCH PROTECTION, BARRICADES, SIGNS, ETC

STORAGE: ESTABLISH A SECURE STORAGE AREA FOR ALL ITEMS MARKED "REMOVE FOR REINSTALLATION" OR "REMOVE AND SALVAGE". STORAGE IS TO BE A PROTECTED, SECURE, WEATHERPROOF LOCATION TO PREVENT DAMAGE TO MATERIALS. COORD W/ OWNER.

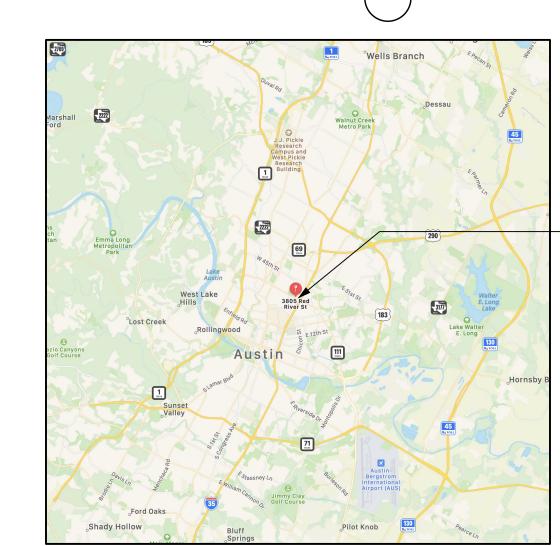

SHEET LIST

ARCHITECTURAL:

A-000 COVER SHEET

SUBJECT

PROPERTY

SPECIFICATIONS (NOT INCLUDED) SPECIFICATIONS (NOT INCLUDED)

SITE PLAN & DETAILS FIRST FLOOR PLAN

SECOND FLOOR PLAN UPPER ROOF PLAN

FIRST FLOOR REFLECTED CLG PLAN

SECOND FLOOR REFLECTED CLG PLAN **EAVE SECTIONS & DETAILS**


ENLARGED PLANS & ELEVATIONS

GARAGE PARAPET PLAN, ELEVATIONS & DETAILS

STRUCTURAL NOTES (NOT INCLUDED)

SECOND FLOOR FRAMING PLAN

SECOND ROOF FRAMING PLAN

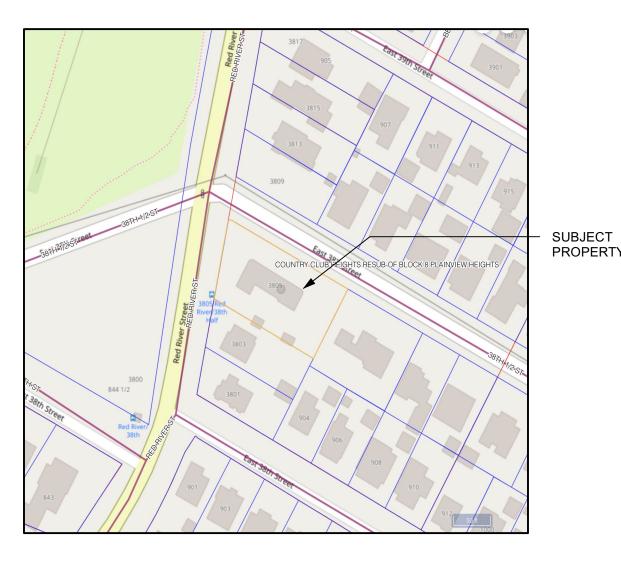

CODES / BUILDING DATA

TDLR PROJECT REGISTRATION # TO BE DETERMINED

LEGAL DESCRIPTION:

LOT #3, BLOCK 4, OLT 20-21 DIV C LOT 4 LESS N 5 SQ. FT., COUNTRY CLUB HEIGHTS IN THE CITY OF AUSTIN, TRAVIS COUNTY, TEXAS

DESCRIPTION OF WORK:

- RESTORATION OF HISTORIC MAIN BUILDING AND GARAGE EAVES

- NEW RESTROOM IN GARAGE SPACE. - REPLACEMENT OF GARAGE ROOF.

- NEW GARAGE DOOR

YEAR BUILT:

1947 - MAIN BUILDING AND GARAGE

HISTORIC DESIGNATIONS:

NATIONAL REGISTER OF HISTORIC PLACES RECORDED TEXAS HISTORIC LANDMARK (RTHL) CITY OF AUSTIN LANDMARK

50% CONSTRUCTION DOCUMENTS

CODES AND OR STANDARDS:

2021 INTERNATIONAL RESIDENTIAL CODE CHAPTER 25-12, TECHNICAL CODES (LOCAL AMENDMENTS) CHAPTER 25-2, LAND DEVELOPMENT CODE

PHONE: 512.474.5198 EMAIL: lindsey@preservationaustin.org

CONTACT: LINDSEY DERRINGTON

CONTRACTOR

OWNER CONTACT

PRESERVATION AUSTIN

P.O. BOX 2113

AUSTIN, TX 78768

T.B.D.

SYMBOLS

Fire Alarm Control Pane

Finished Floor (Elevation)

BRICK MASONRY

BATT INSULATION

FRAMING WOOD

FINISHED WOOD

CONCRETE

BLOCKING

EARTH

Face Brick

Floor Drain

Foundation

Fire Extinguisher

Fire Hose Cabinet

Fire Hydrant

Finish(ed)

Flow Line

FACP

FΒ

FDN

FIXT

REFERENCES

WWM

WWF

Wire Glass

Water Meter

Weight

Water Heater

Waterproof(ing)


Welded Wire Mesh

Welded Wire Fabric

ELEVATION REFERENCE MARKER A-100 CONCRETE BLOCK MASONRY **ROOM NUMBER** SECTION A1/A-100 DETAIL WINDOW NUMBER **ELEVATION** DOOR NUMBER TYPE NEW WOOD OR METAL STUD PARTITION OR SHAFT WALL KEYED CENTER LINE NOTES ELEVATION

X-X" CHANGE @ STEP

TYPICAL MOUNTING HEIGHTS

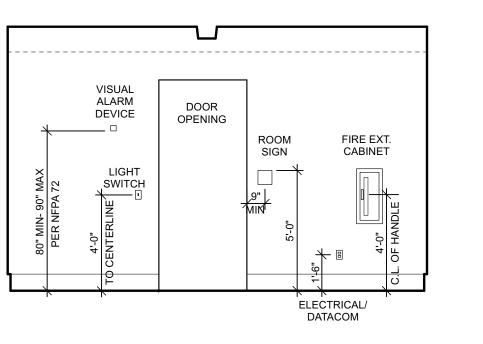

PERMITTING SERVICE

ÉREVIEW SET ONLY NOT FOR REGULATORY APPROVAL, PERMITTING OR CONSTRUCTION CHRISTOPHER E. HUTSON TX #15635

PROJECT NO: 01/12/2023 DATE:

3805

REV: SHEET NAME:

COVER SHEET

SHEET NO:

T.B.D.

REVIEW SET ONLY

NOT FOR REGULATORY
APPROVAL, PERMITTING
OR CONSTRUCTION

CHRISTOPHER E.
HUTSON
TX #15635

Hutson | Gallag

MCFARLAND HOI INTERIOR AND EXTERIOR RESTOR 3805 Red River Street · Austin,

PROJECT NO:

DATE: 01/12/2023

REV:

SHEET NAME:

SITE PLAN & DETAILS

SHEET NO:

- NOTES APPLY TO ALL SPACES

- A. REFER TO SPECIFICATIONS FOR DETAILED REQUIREMENTS RELATED TO ALL SCOPES OF WORK. KEY NOTES SUMMARIZE SCOPE THAT IS DEFINED WITHIN THE SPECIFICATIONS.
- B. PROTECT ALL SURFACES NOT SCH'D FOR WORK UNDER THIS CONTRACT. DAMAGE TO EXST'G FINISH SURFACES TO REMAIN BY THE CONTRACTOR OR SUBCONTRACTORS SHALL BE CORRECTED AT NO EXPENSE TO THE OWNER.
- C. MARK ALL CUTS IN EXIST'G BUILDINGS REQ'D FOR NEW UTILITY AND SYSTEMS INSTALLATIONS AND ALLOW REVIEW BY OWNER AND ARCHITECT BEFORE PROCEEDING.
- D. REPAIR ALL HOLES IN WALLS & CEILINGS. MATCH ADJACENT FINISHES IN PREPARATION TO RECEIVE NEW FINISHES UNLESS NOTED OTHERWISE.
- E. CONCEAL ALL NEW ELEC. CONDUIT & LOW VOLTAGE WIRING IN WALLS THROUGHOUT UNLESS OTHERWISE NOTED. WHERE EXPOSED, PAINT TO MATCH ADJACENT WALL OR CEILING
- F. REFER TO STRUCTURAL SHEETS FOR MAIN BUILDING EAVE AND GARAGE PARAPET RESTORATION.
- G. IN ORDER TO PROVIDE AN ACCESSIBLE ROUTE, SCREEN DOOR(S) SHALL BE REMOVED WHERE INDICATED ON THE PLAN & RETURNED TO OWNER. PATCH HINGE LOCATIONS WITH A DUTCHMAN REPAIR.

PLAN KEYNOTES

REPAIR GYP. BD. WALL TO MATCH ADJACENT FINISHES - REF. INTERIOR ELEVATIONS

REMOVE EXISTING DOOR & FRAME, CUT MASONRY OPENING TO ACCEPT NEW, WIDER DOOR - INSTALL NEW LINTERL PER STRUCT. - REPAIR CMU MASONRY AND STUCCO AT PERIMETER

REMOVE ALL EXISTING ROOFING AND
UNDERLAYMENT, THOROUGHLY CLEAN &
PREP FOR NEW INSULATION & PVC ROOF REPAIR DAMAGED WOOD UNDER ALLOWANCE

(R04) PROVIDE & INSTALL NEW THROUGH WALL SCUPPER - REF. DETAILS ON THIS SHEET

(R05) WINDOW REPAIRS T.B.D.

R06 SHORE AND RAISE EXIST'G BEAM TO LEVEL - INSTALL NEW STEEL COL. PER STRUCT. - PAINT COL. AND BASE PLATE PER SPECS

REMOVE EXISTING PLASTER AND LATH AT CEILING AND BEAM - INSTALL NEW 5/8" GYP. BD.

(**R08**) T.B.D.

R09) T.B.

(R10) T.B.D.

(R11) T.B.D

R12 TR

REVIEW SET ONLY

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APPROVAL, PERMITTING
OR CONSTRUCTION

CHRISTOPHER E.
HUTSON
TX #15635

1tSon | Crallaghe 1206 Quail Park Drive Austin, Texas 78758 Phone: (512) 960-0013


MCFARLAND HOUSE
INTERIOR AND EXTERIOR RESTORATION
3805 Red River Street • Austin, Texas

PROJECT NO:
DATE: 01/12/2023
REV:

SHEET NAME:

FIRST FLOOR PLAN

SHEET NO:

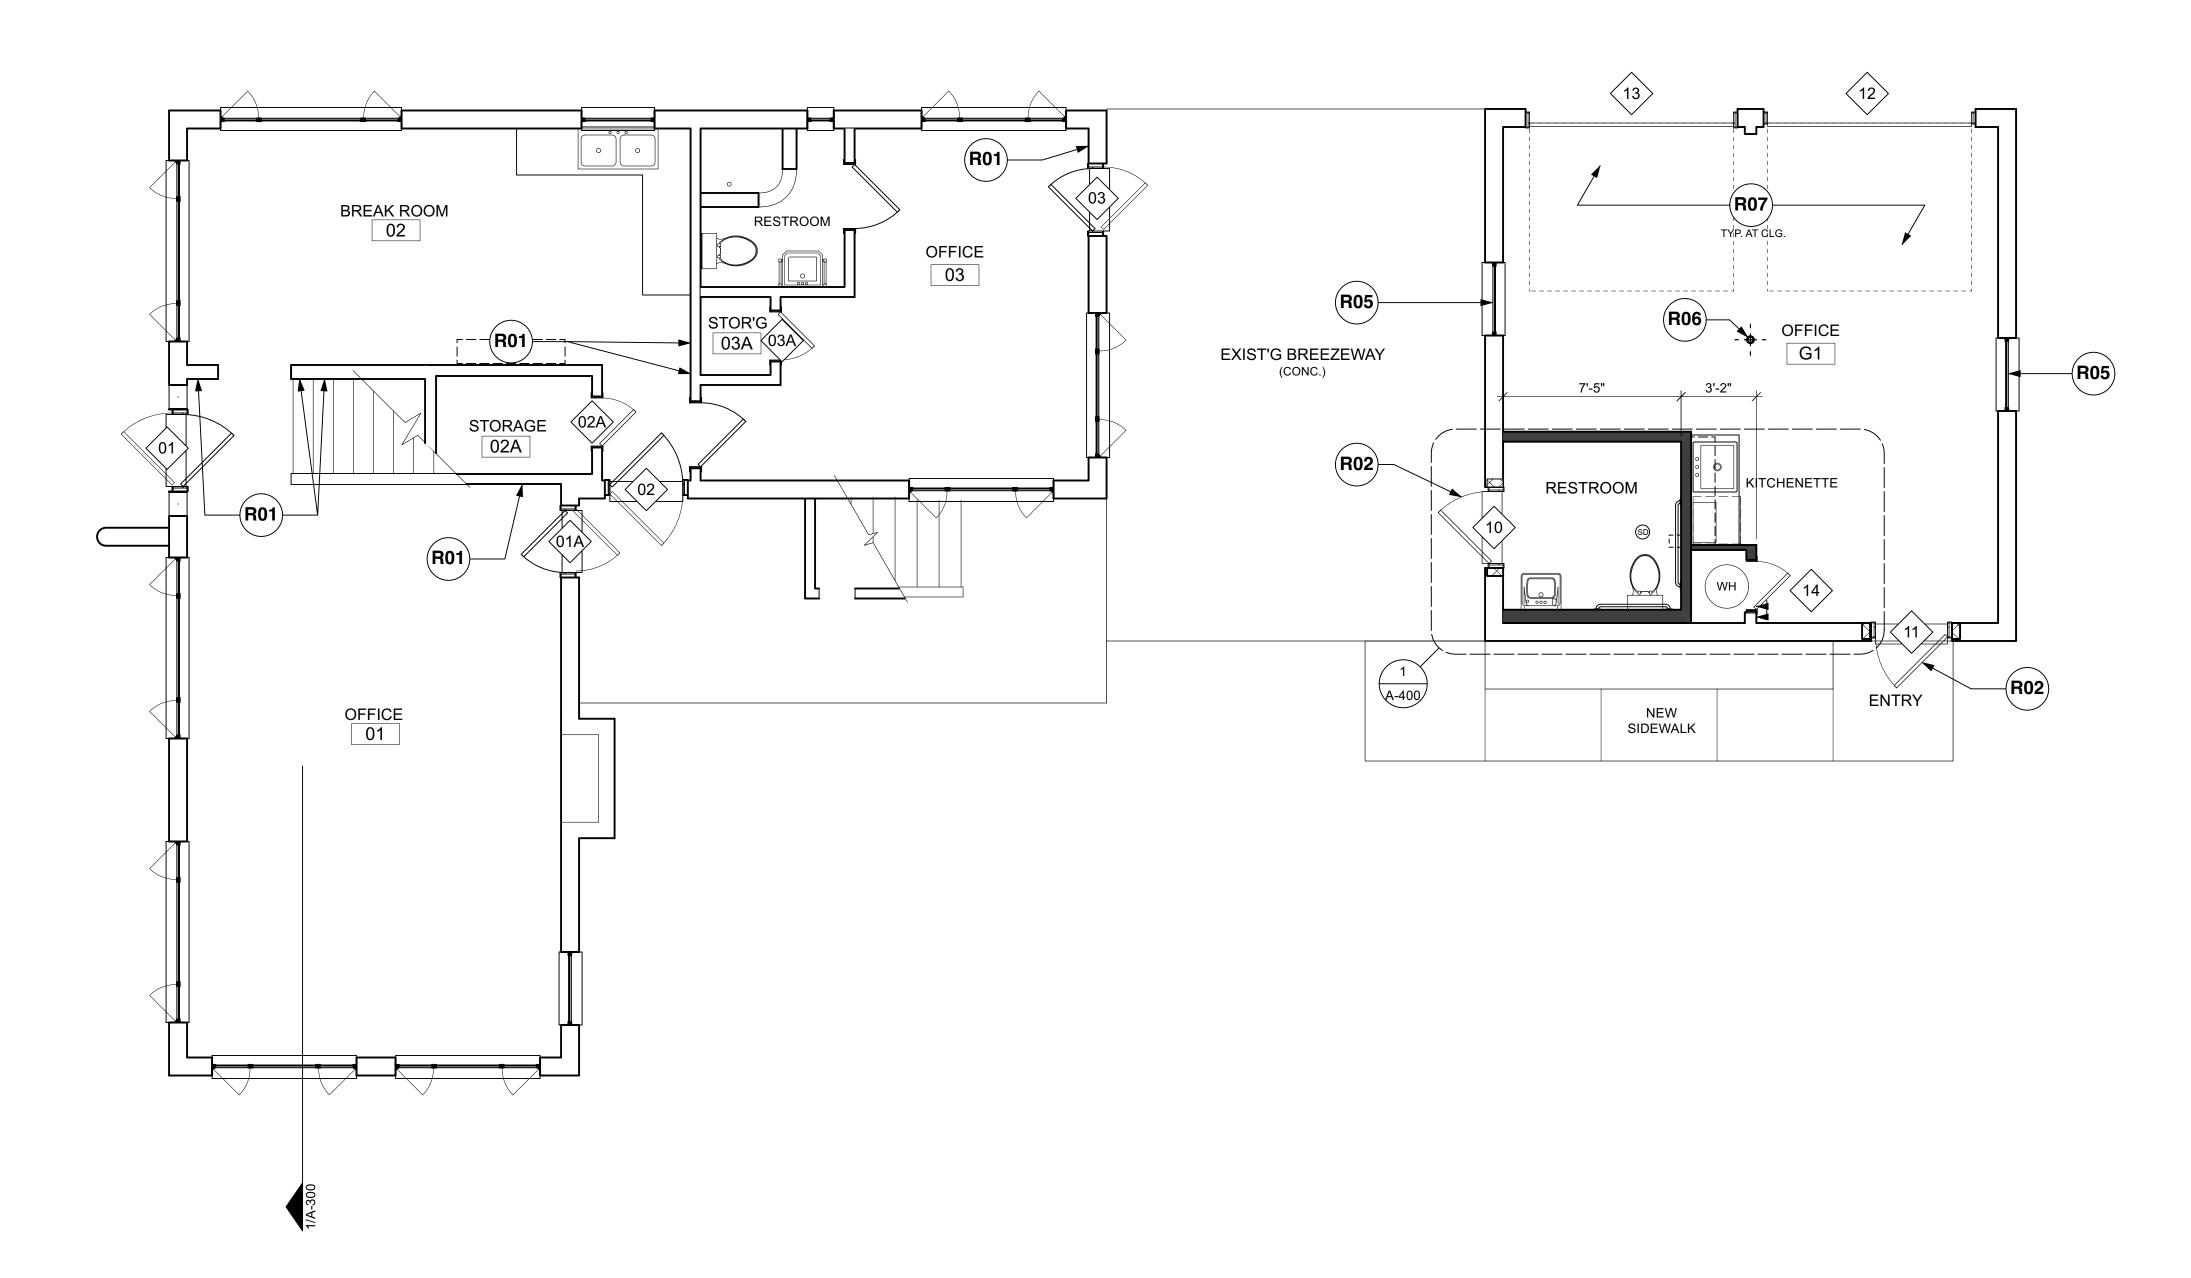

- A. REFER TO SPECIFICATIONS FOR DETAILED REQUIREMENTS RELATED TO ALL SCOPES OF WORK. KEY NOTES SUMMARIZE SCOPE THAT IS DEFINED WITHIN THE SPECIFICATIONS.
- B. PROTECT ALL SURFACES NOT SCH'D FOR WORK UNDER THIS CONTRACT. DAMAGE TO EXST'G FINISH SURFACES TO REMAIN BY THE CONTRACTOR OR SUBCONTRACTORS SHALL BE CORRECTED AT NO EXPENSE TO THE OWNER.
- C. MARK ALL CUTS IN EXIST'G BUILDINGS REQ'D FOR NEW UTILITY AND SYSTEMS INSTALLATIONS AND ALLOW REVIEW BY OWNER AND ARCHITECT BEFORE PROCEEDING.
- D. REPAIR ALL HOLES IN WALLS & CEILINGS. MATCH ADJACENT FINISHES IN PREPARATION TO RECEIVE NEW FINISHES UNLESS NOTED OTHERWISE.
- E. CONCEAL ALL NEW ELEC. CONDUIT & LOW VOLTAGE WIRING IN WALLS THROUGHOUT UNLESS OTHERWISE NOTED. WHERE EXPOSED, PAINT TO MATCH ADJACENT WALL OR CEILING
- F. REFER TO STRUCTURAL SHEETS FOR MAIN BUILDING EAVE AND GARAGE PARAPET RESTORATION.
- G. IN ORDER TO PROVIDE AN ACCESSIBLE ROUTE, SCREEN DOOR(S) SHALL BE REMOVED WHERE INDICATED ON THE PLAN & RETÙRNED TO OWNER. PATCH HINGE LOCATIONS WITH A DUTCHMAN REPAIR.

PLAN KEYNOTES

ELEVATIONS

(R01) REPAIR GYP. BD. WALL TO MATCH ADJACENT FINISHES - REF. INTERIOR

REMOVE EXISTING DOOR & FRAME, CUT MASONRY OPENING TO ACCEPT NEW, WIDER DOOR - SEE STRUCT.

DWGS. FOR HEADER REINFORCEMENT **(R03)** T.B.D.

(R04) T.B.D.

(**R10**) T.B.D.


(**R07**) T.B.D.

(**R08**) T.B.D.

(**R09**) T.B.D.

(R11) T.B.D.

(**R12**) T.B.D.

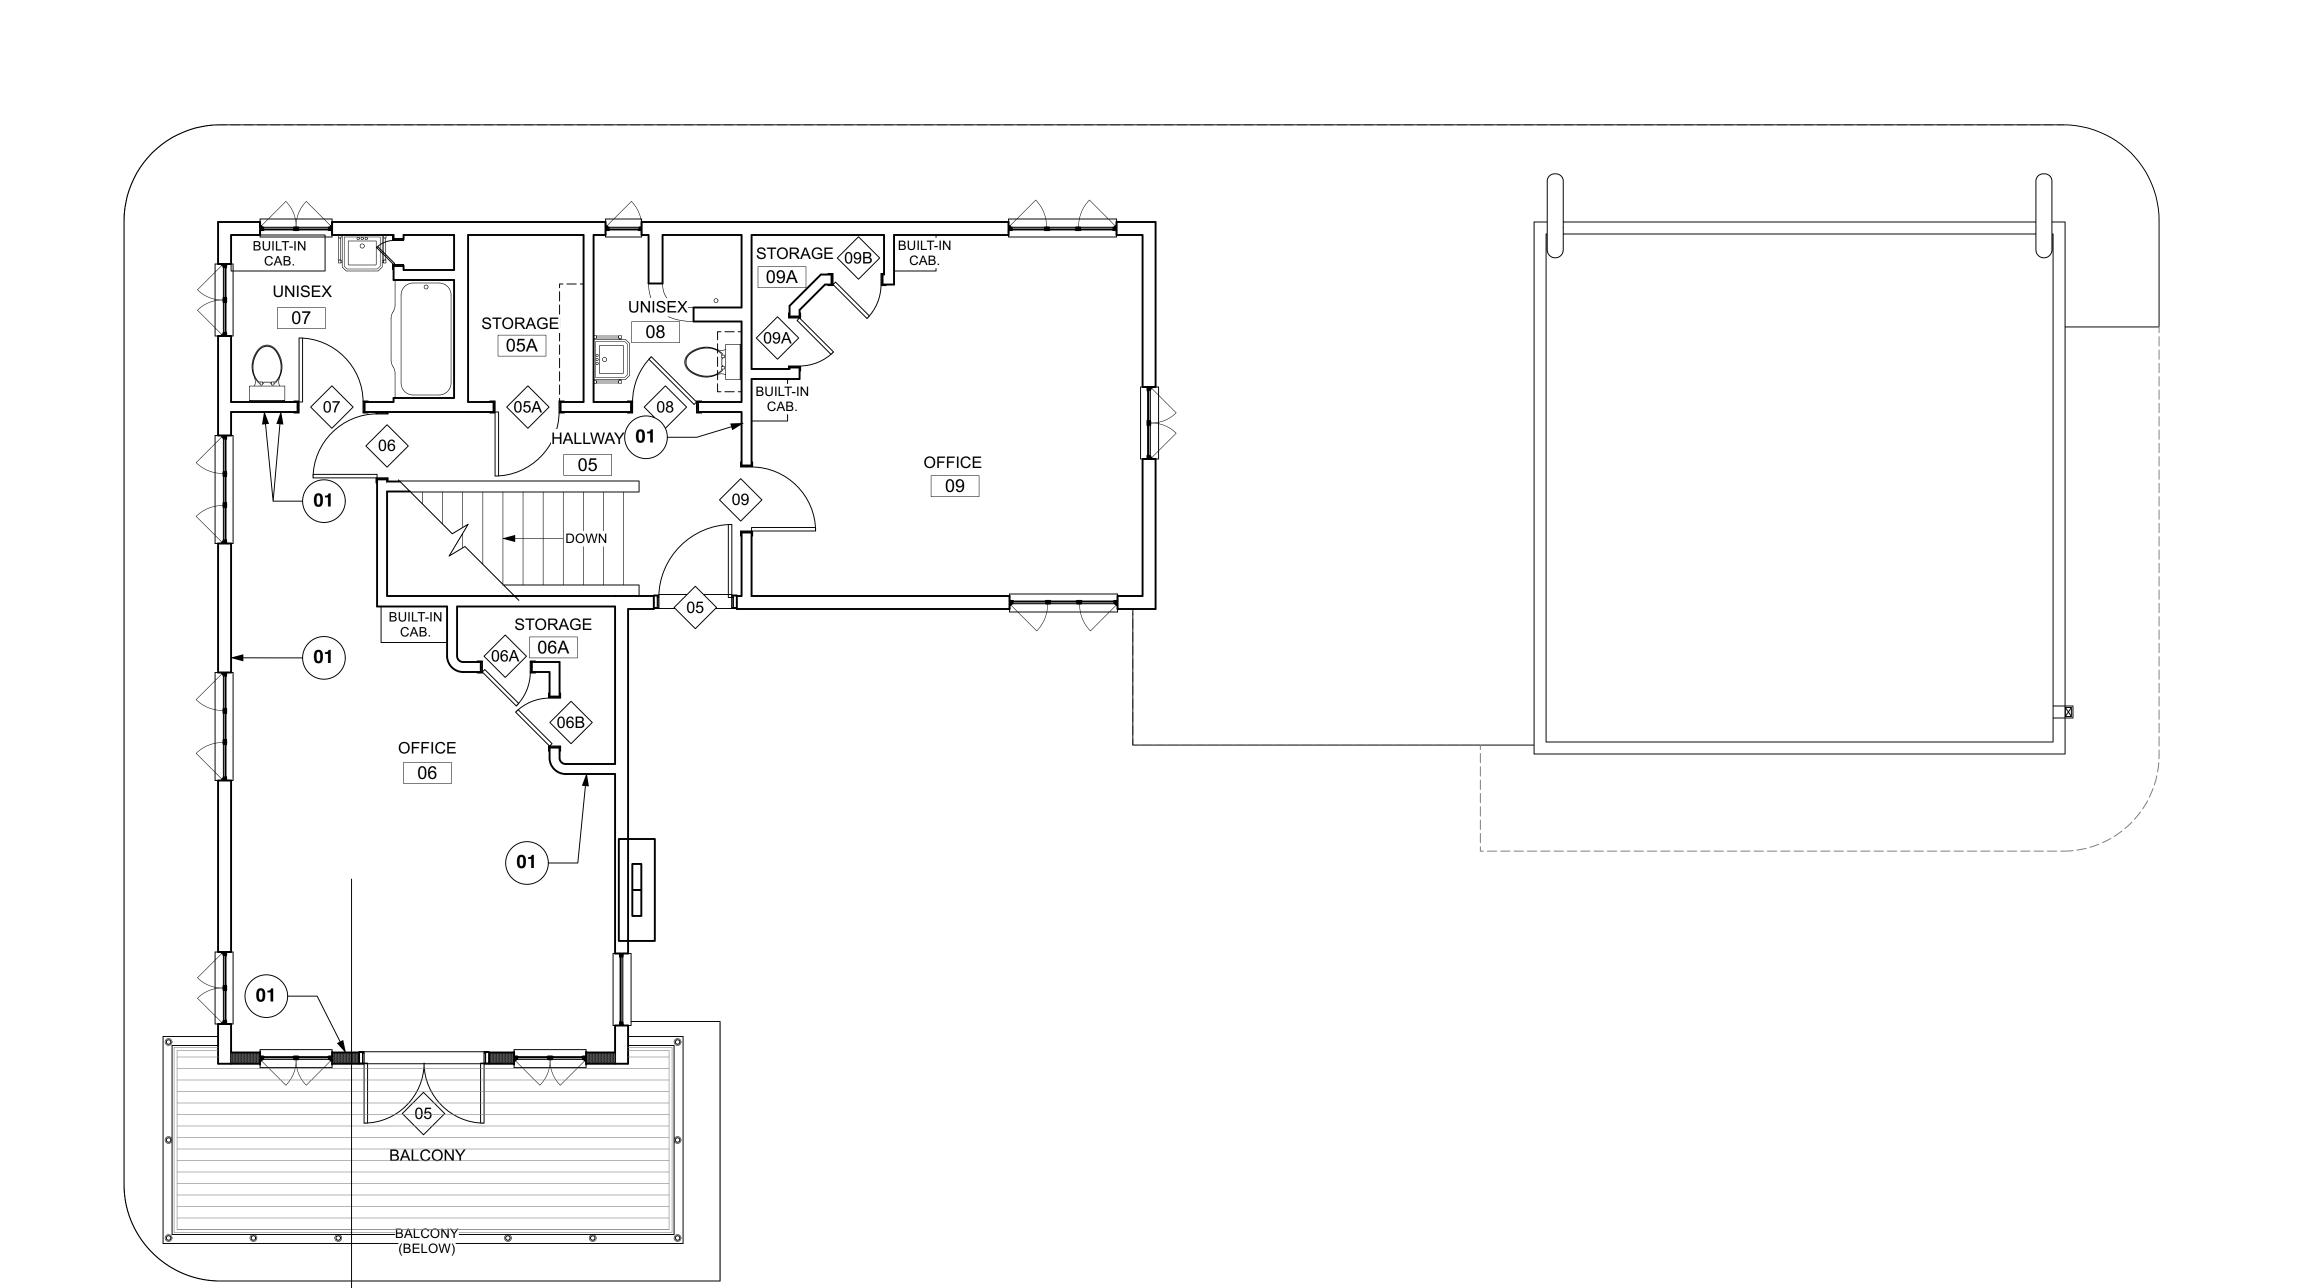



3805 Red

PROJECT NO: DATE: 01/12/2023 REV: SHEET NAME:

SECOND FLOOR PLAN

SHEET NO:

A-122

SCALE: 1/4" = 1'-0"

- A. REFER TO SPECIFICATIONS FOR DETAILED REQUIREMENTS RELATED TO ALL SCOPES OF WORK. KEY NOTES SUMMARIZE SCOPE THAT IS DEFINED WITHIN THE SPECIFICATIONS.
- B. PROTECT ALL SURFACES NOT SCH'D FOR WORK UNDER THIS CONTRACT. DAMAGE TO EXST'G FINISH SURFACES TO REMAIN BY THE CONTRACTOR OR SUBCONTRACTORS SHALL BE CORRECTED AT NO EXPENSE TO THE OWNER.
- C. MARK ALL CUTS IN EXIST'G BUILDINGS REQ'D FOR NEW UTILITY AND SYSTEMS INSTALLATIONS AND ALLOW REVIEW BY OWNER AND ARCHITECT BEFORE PROCEEDING. D. REPAIR ALL HOLES IN WALLS & CEILINGS. MATCH ADJACENT FINISHES IN PREPARATION TO RECEIVE NEW FINISHES UNLESS
- NOTED OTHERWISE.
- E. CONCEAL ALL NEW ELEC. CONDUIT & LOW VOLTAGE WIRING IN WALLS THROUGHOUT UNLESS OTHERWISE NOTED. WHERE EXPOSED, PAINT TO MATCH ADJACENT WALL OR CEILING
- F. REFER TO STRUCTURAL SHEETS FOR MAIN BUILDING EAVE AND GARAGE PARAPET RESTORATION.
- G. IN ORDER TO PROVIDE AN ACCESSIBLE ROUTE, SCREEN DOOR(S) SHALL BE REMOVED WHERE INDICATED ON THE PLAN & RETÙRNED TO OWNER. PATCH HINGE LOCATIONS WITH A DUTCHMAN REPAIR.

PLAN KEYNOTES


(R01) REPAIR GYP. BD. WALL TO MATCH ADJACENT FINISHES - REF. INTERIOR ELEVATIONS



REMOVE EXISTING DOOR & FRAME, (R02) CUT MASONRY OPENING TO ACCEPT NEW, WIDER DOOR - SEE STRUCT. DWGS. FOR HEADER REINFORCEMENT



(R03) UNDERLAYMENT, THOROUGHLY CLEAN & PREP FOR NEW INSULATION & PVC ROOF REPAIR DAMAGED WOOD UNDER ALLOWANCE

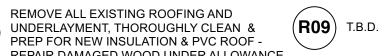

R04) PROVIDE & INSTALL NEW THROUGH WALL SCUPPER - REF. DETAILS ON THIS SHEET





(R05) T.B.D.

(**R12**) T.B.D.

KEY

AREA OF NEW WORK

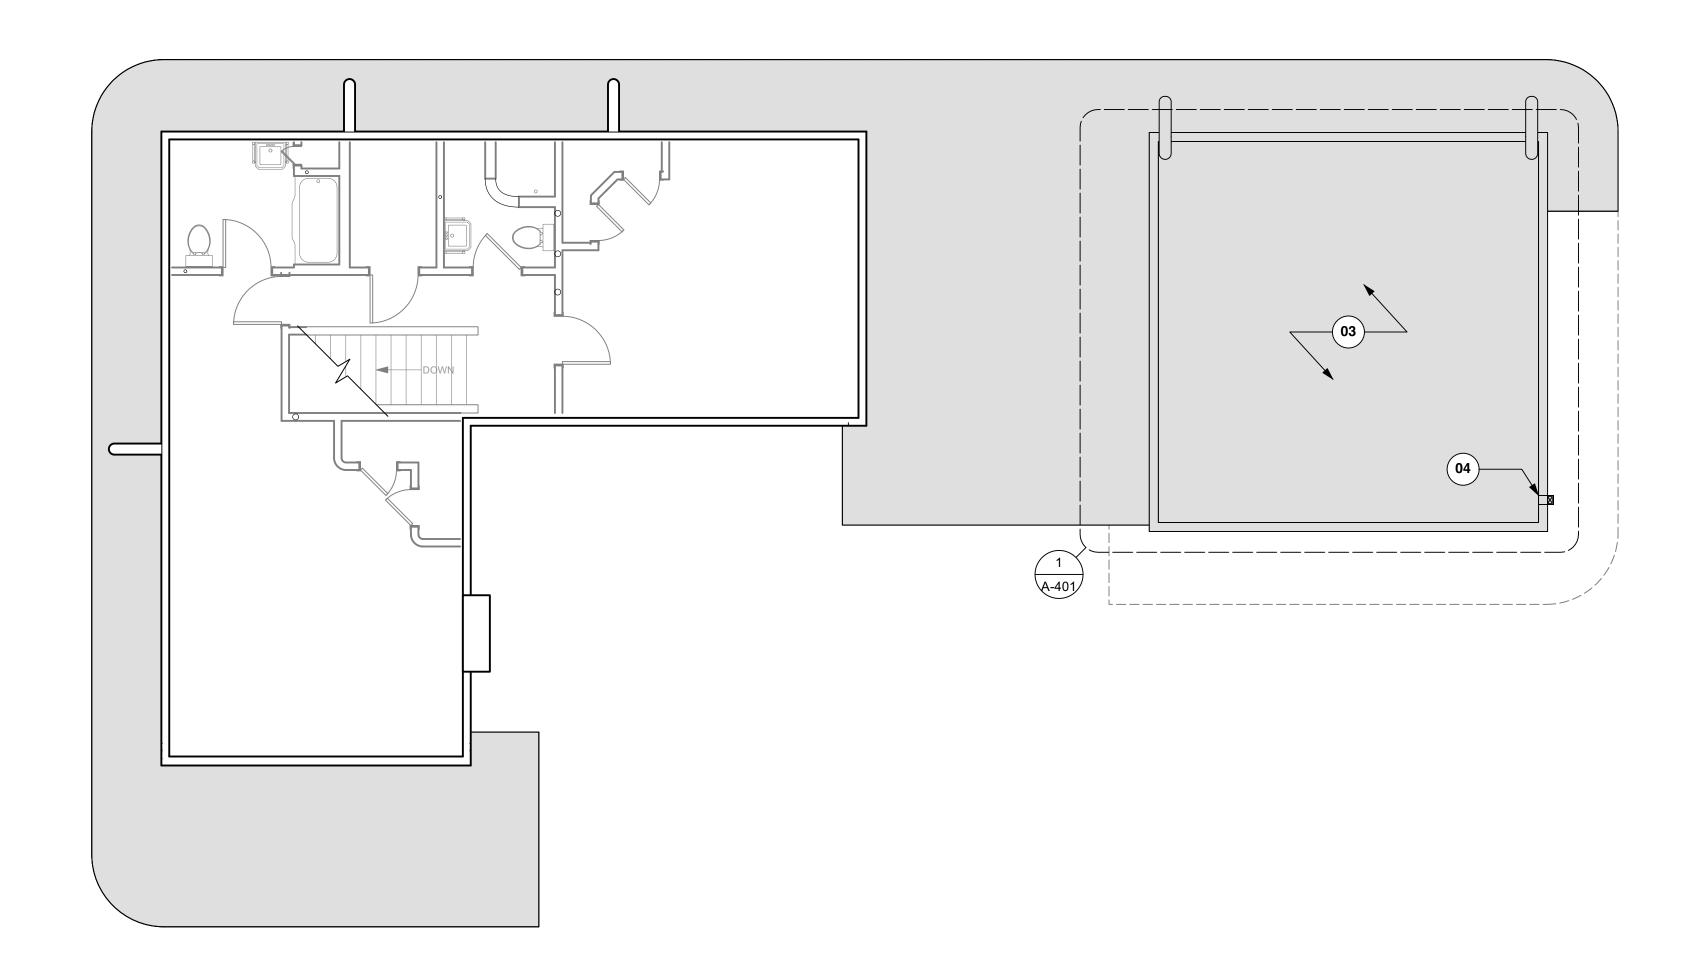

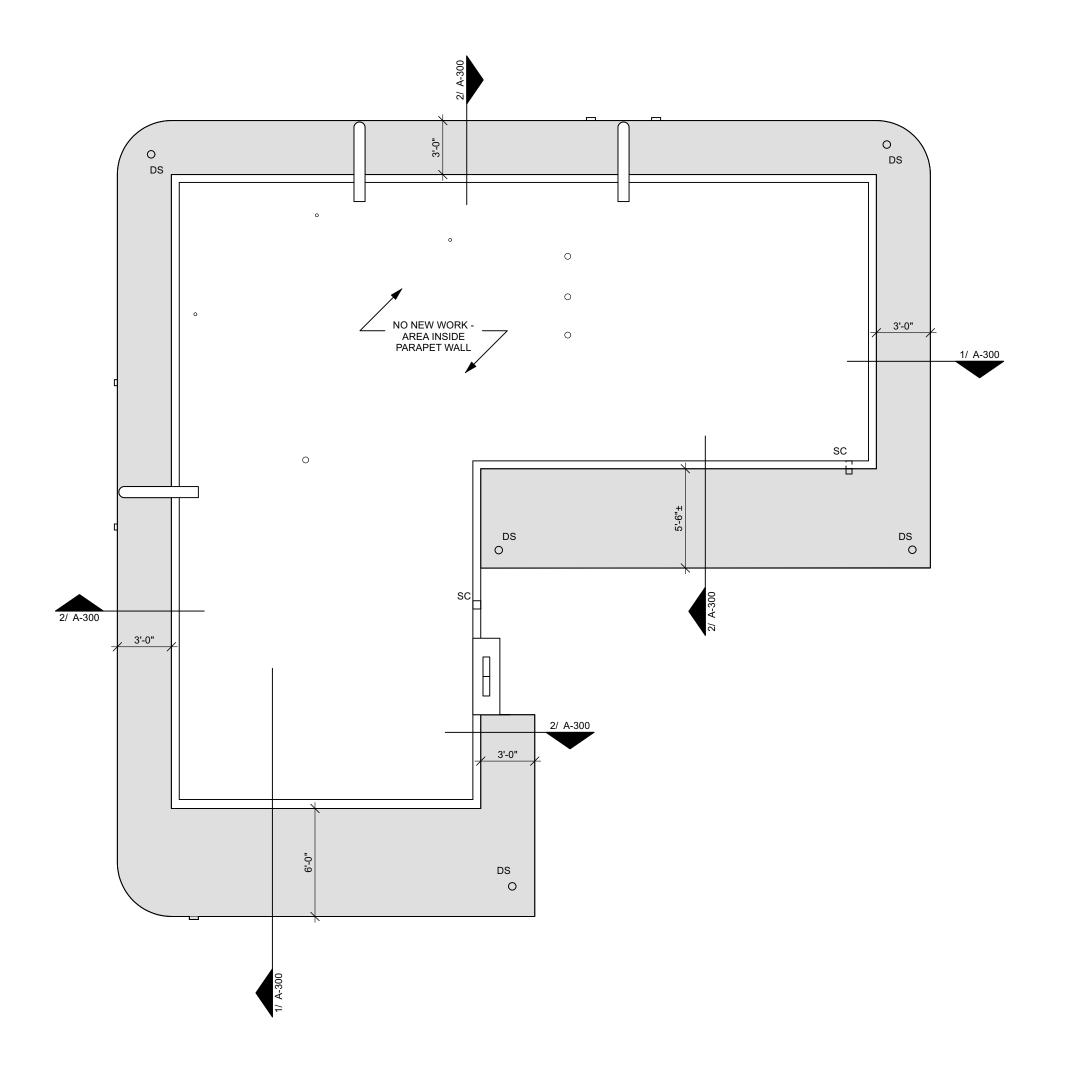

LOWER ROOF PLAN

SCALE: 3/16" = 1'-0"

UPPER ROOF PLAN

SCALE: 3/16" = 1'-0"

50% CONSTRUCTION DOCUMENTS

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UPPER ROOF PLAN

SHEET NO:

D. REFERENCE MEP FOR ADDITIONAL ELEC. REQUIREMENTS.

REPAIR EXIST'G GYP. BD. CEILING TO MATCH ADJACENT FINISHES (R55) VERIFY SCOPE (BREEZWAY)

REMOVE EXIST'G GYP. BD. CEILING AS REQUIRED TO PERFORM STRUCTURAL REPAIRS INSTALL NEW CLOUDON REPAIRS - INSTALL NEW CLG UPON COMPLETION TO MATCH ADJACENT

REMOVE EXIST'G PLASTER & LATH CEILING THROUGHOUT EXIST'G GARAGE - INSTALL NEW GYP. BD. CLG UPON COMPLETION

(R56) NEW EXHAUST FAN - VERIFY ROUTING AND PENETRATION THROUGH ROOF W/ ARCHITECT

(**R57**) T.B.D.

REMOVE PLASTER AT UNDERSIDE OF EAVES
- INSTALL NEW PLASTER AND LATH AFTER
COMPLETION OF STRUCTURAL REPAIRS

<u>KEY</u>

PENDANT LIGHT SURFACE MOUNTED LIGHT


SURFACE MOUNTED LIGHT

EXIT SIGN

AND ROOF WORK WALL MOUNTED SCONCE LIGHT -EXISTING TO REMAIN WALL MOUNTED SCONCE LIGHT -EXISTING TO REMAIN **CEILING FAN**

A/C

EXIST'G DRIVEWAY (R51)

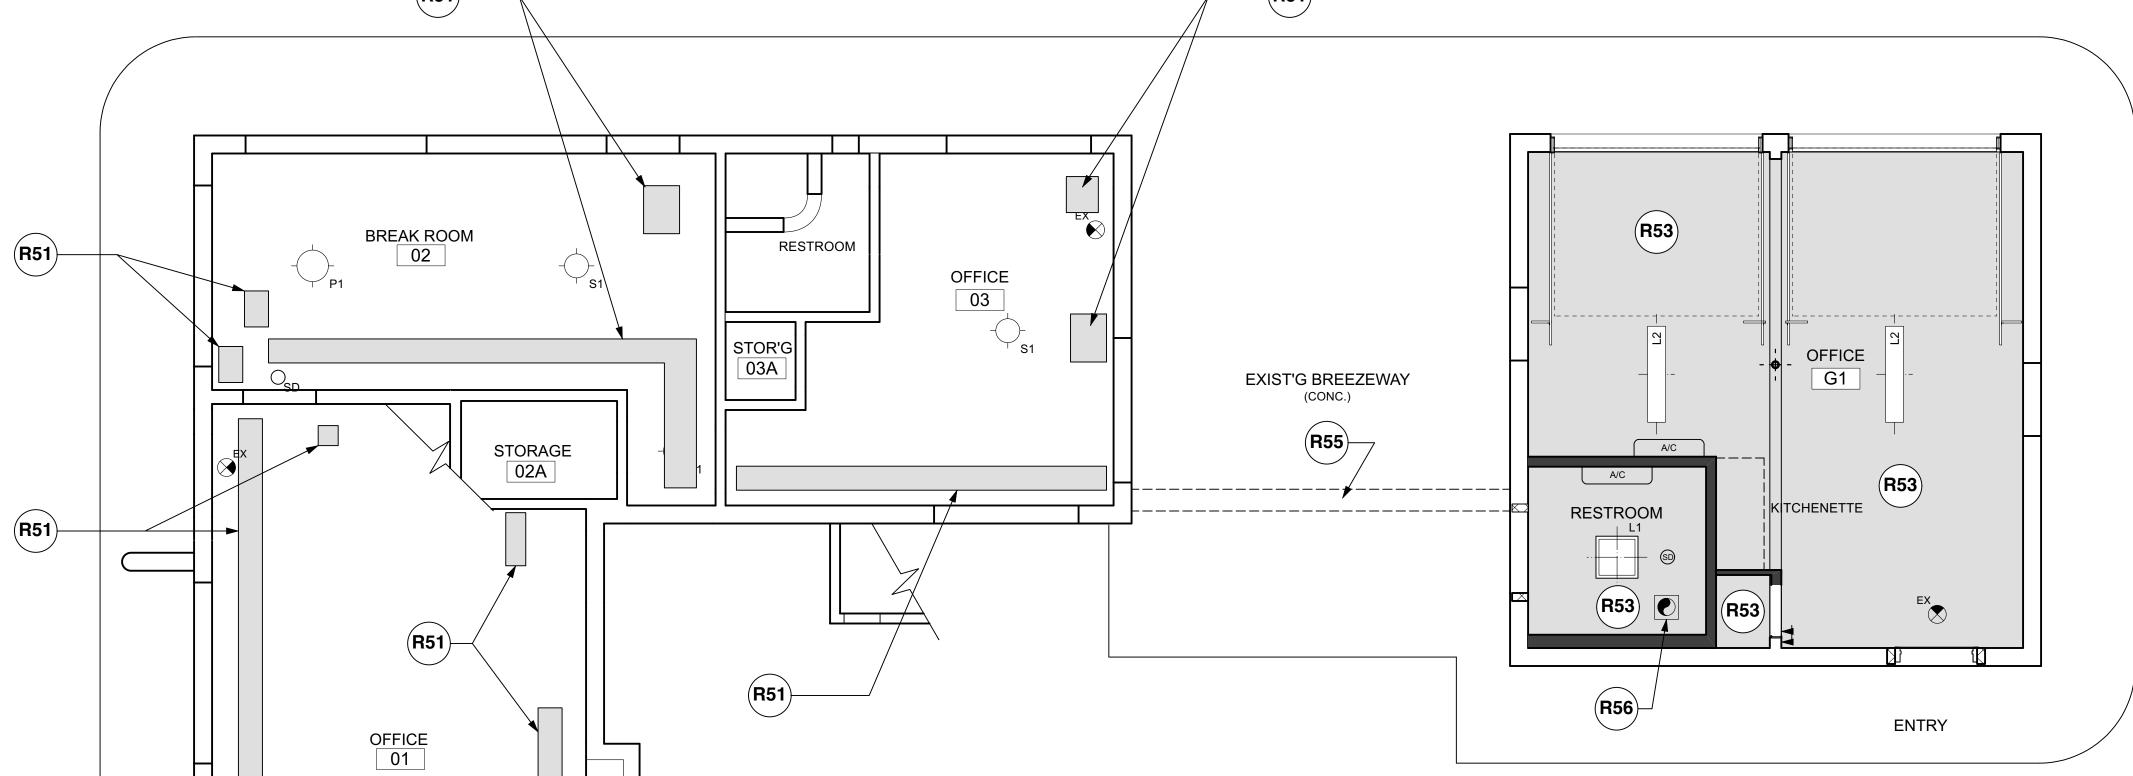

–(R52)--(R54)-

FIRST FLOOR REFLECTED CEILING PLAN 1 SCALE: 1/4" = 1'-0"



(CONC.)

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3805 Red

PROJECT NO: DATE: 01/12/2023 REV: SHEET NAME:

FIRST FLOOR RCP

SHEET NO:

CEILING PLAN KEYNOTES


PENETRATIONS THROUGH EXIST'G TOP PLATE WITH FIRE-RATED


B. NEW GYP BOARD CEILING TO BE 1-HR FIRE RATED - SEAL ALL SEALANT C. T.B.D.

D. REFERENCE MEP FOR ADDITIONAL ELEC. REQUIREMENTS.


- REMOVE EXIST'G GYP. BD. CEILING AS REQUIRED TO PERFORM STRUCTURAL REPAIRS INSTALL NEW CLG UPON COMPLETION TO MATCH ADJACENT
- REMOVE EXIST'G PLASTER & LATH CEILING THROUGHOUT EXIST'G GARAGE INSTALL NEW GYP. BD. CLG UPON COMPLETION
- (R54) REMOVE PLASTER AT UNDERSIDE OF EAVES
 INSTALL NEW PLASTER AND LATH AFTER COMPLETION OF STRUCTURAL REPAIRS AND ROOF WORK
- REPAIR EXIST'G GYP. BD. CEILING TO MATCH ADJACENT FINISHES (R55) VERIFY SCOPE (BREEZWAY)
 - (R56) NEW EXHAUST FAN VERIFY ROUTING AND PENETRATION THROUGH ROOF W/ ARCHITECT
 - (**R57**) T.B.D.

<u>KEY</u>

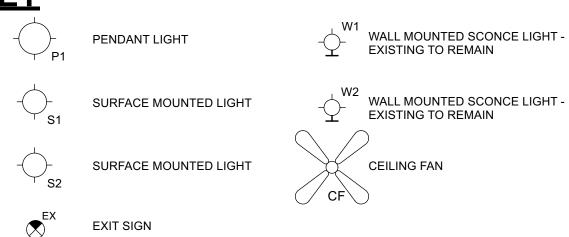

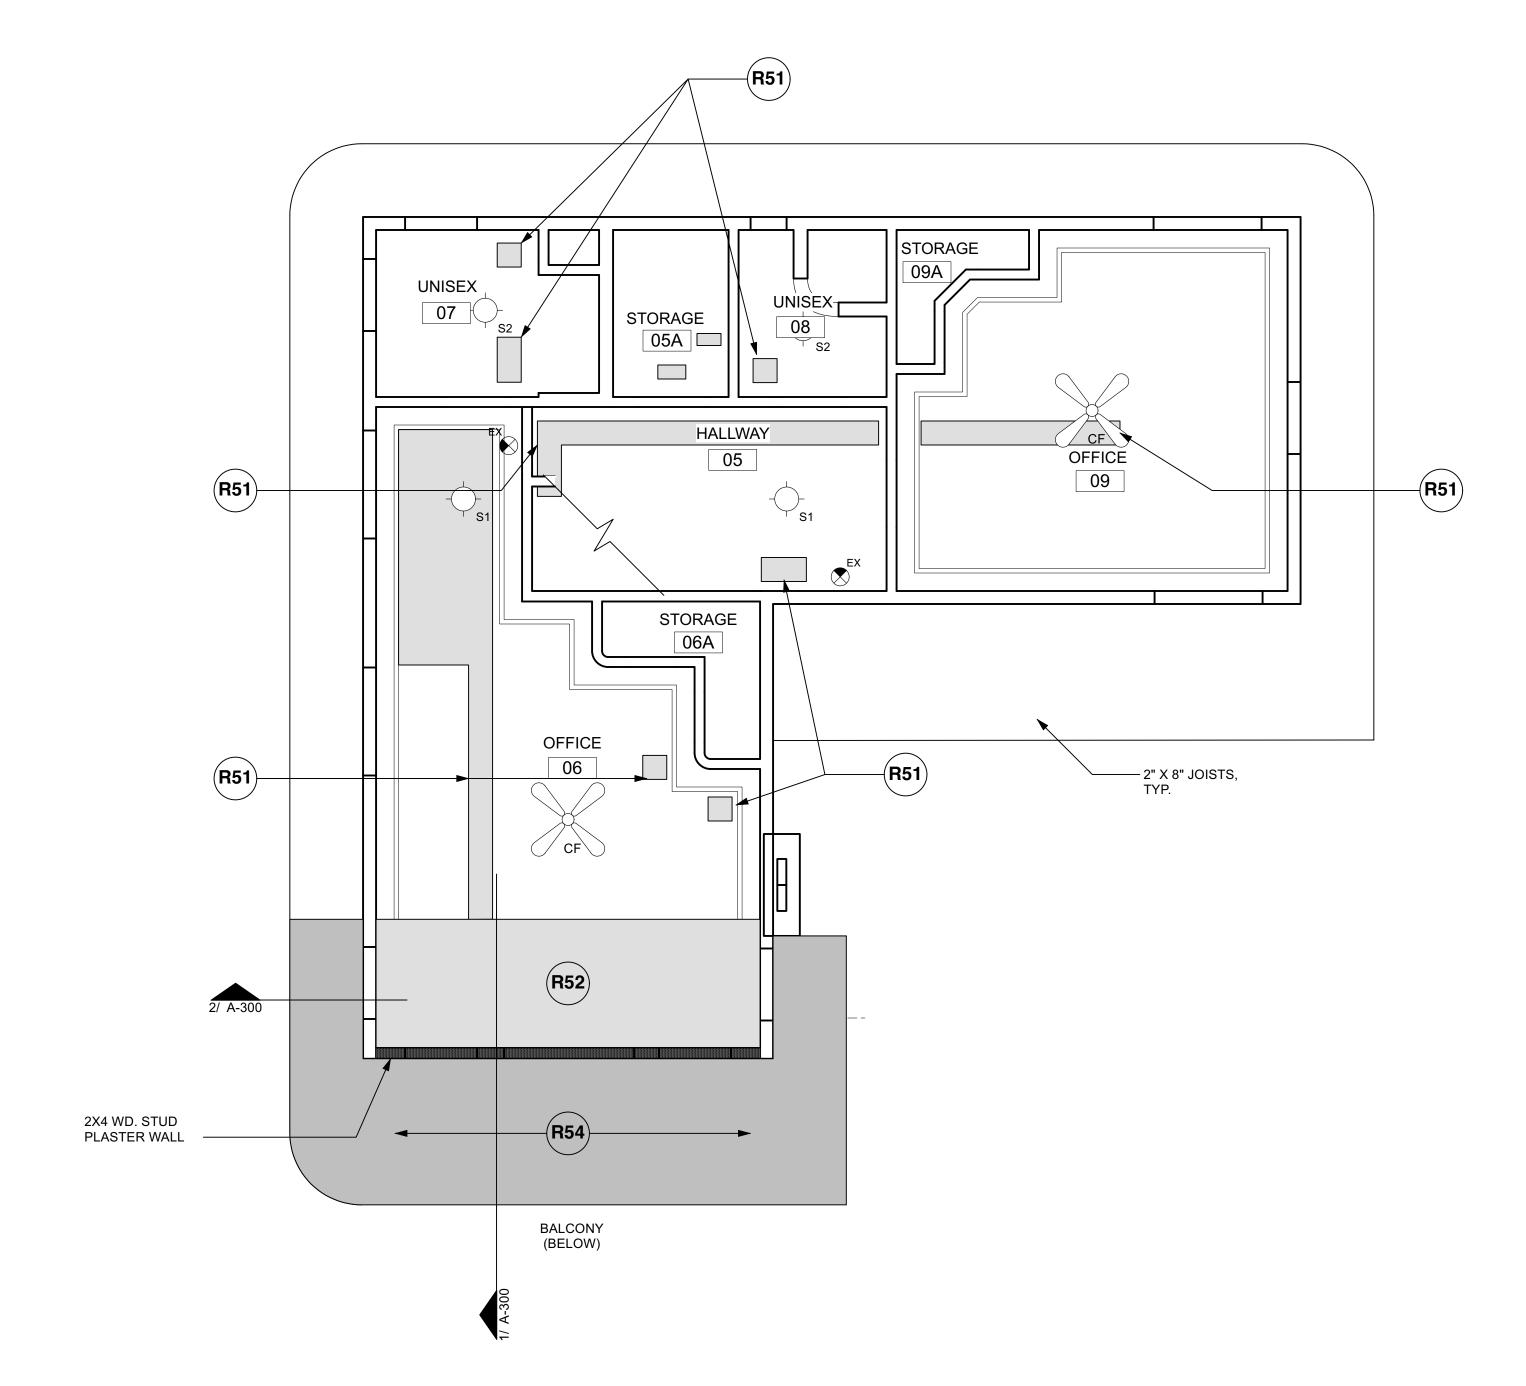



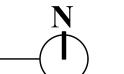


/ REVIEW SET ONLY NOT FOR REGULATORY APPROVAL, PERMITTING OR CONSTRUCTION CHRISTOPHER E. HUTSON `_TX #15635 _


3805 Red


PROJECT NO: DATE: 01/12/2023 REV: SHEET NAME:

SECOND FLOOR RCP

SHEET NO:

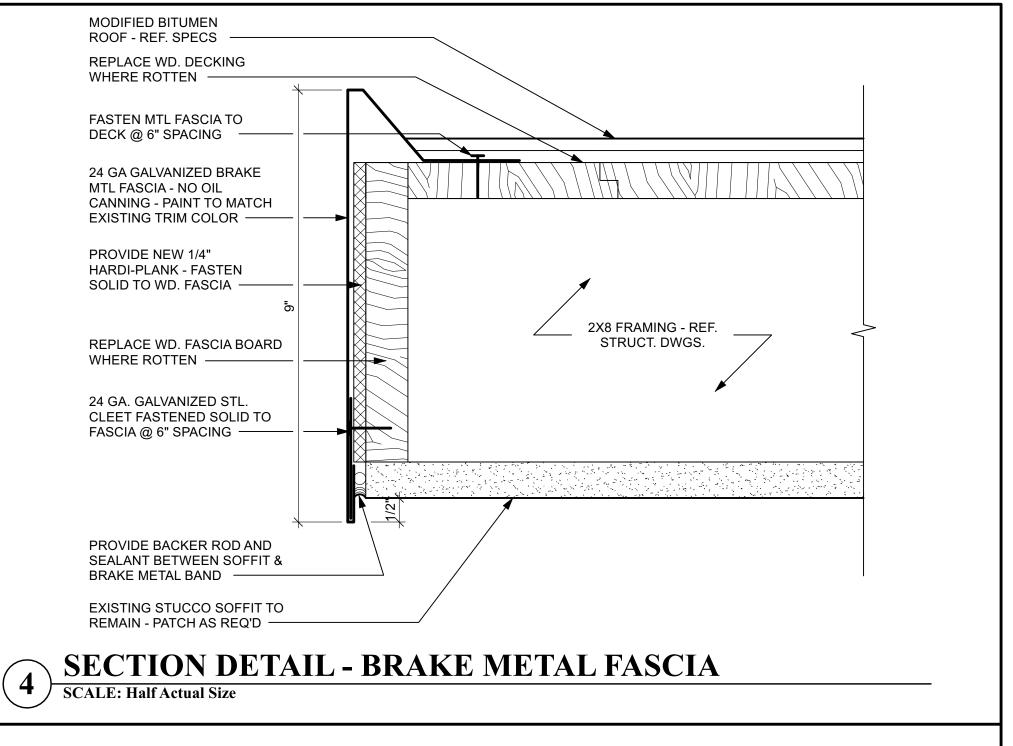

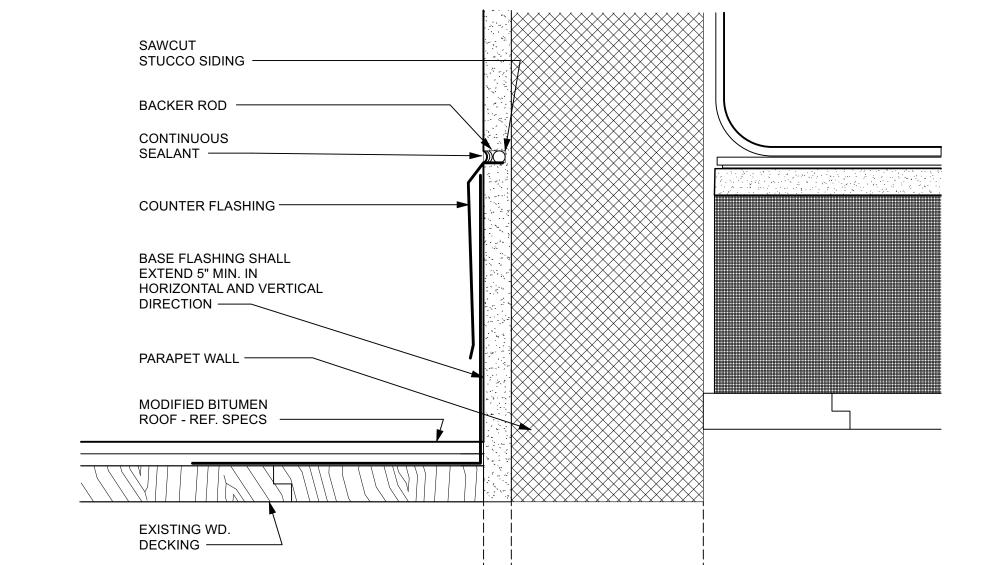

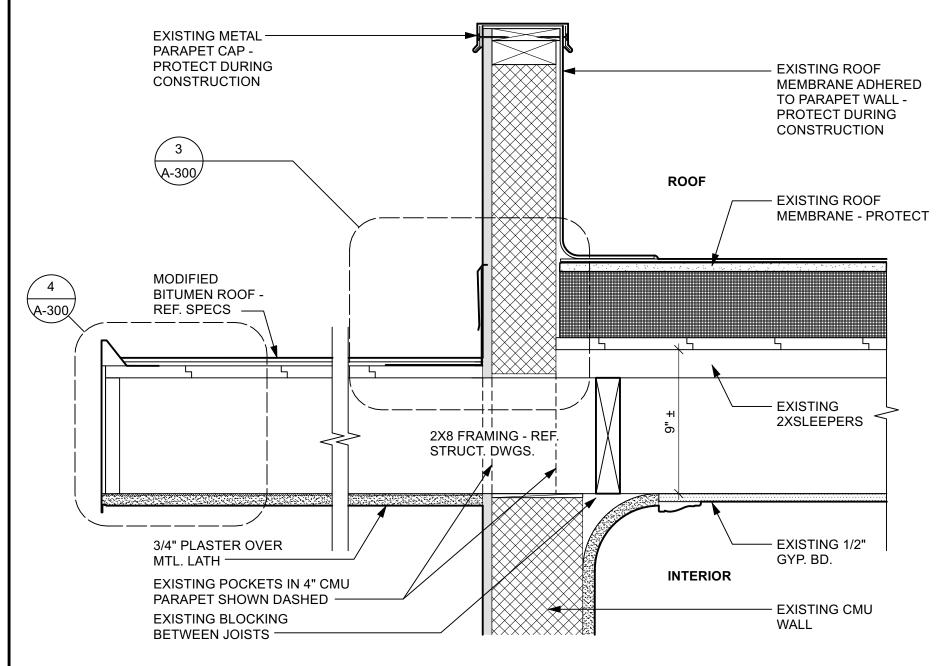

SECTION DETAIL - FLASHING AT PARAPET

SCALE: Half Actual Size

SECTION DETAIL - PARAPET WALL @ 2ND FLOOR ROOF

PROJECT NO: DATE: 01/12/2023 REV: SHEET NAME:

EAVE SECTIONS & DETAILS

MCFA

3805 Red

REVIEW SET ONLY

NOT FOR REGULATORY APPROVAL, PERMITTING OR CONSTRUCTION


> CHRISTOPHER E. HUTSON

TX #15635

A - 300

SHEET NO:

SECTION @ SOUTH BALCONY & EAVE SCALE: 3/4'' = 1'-0''

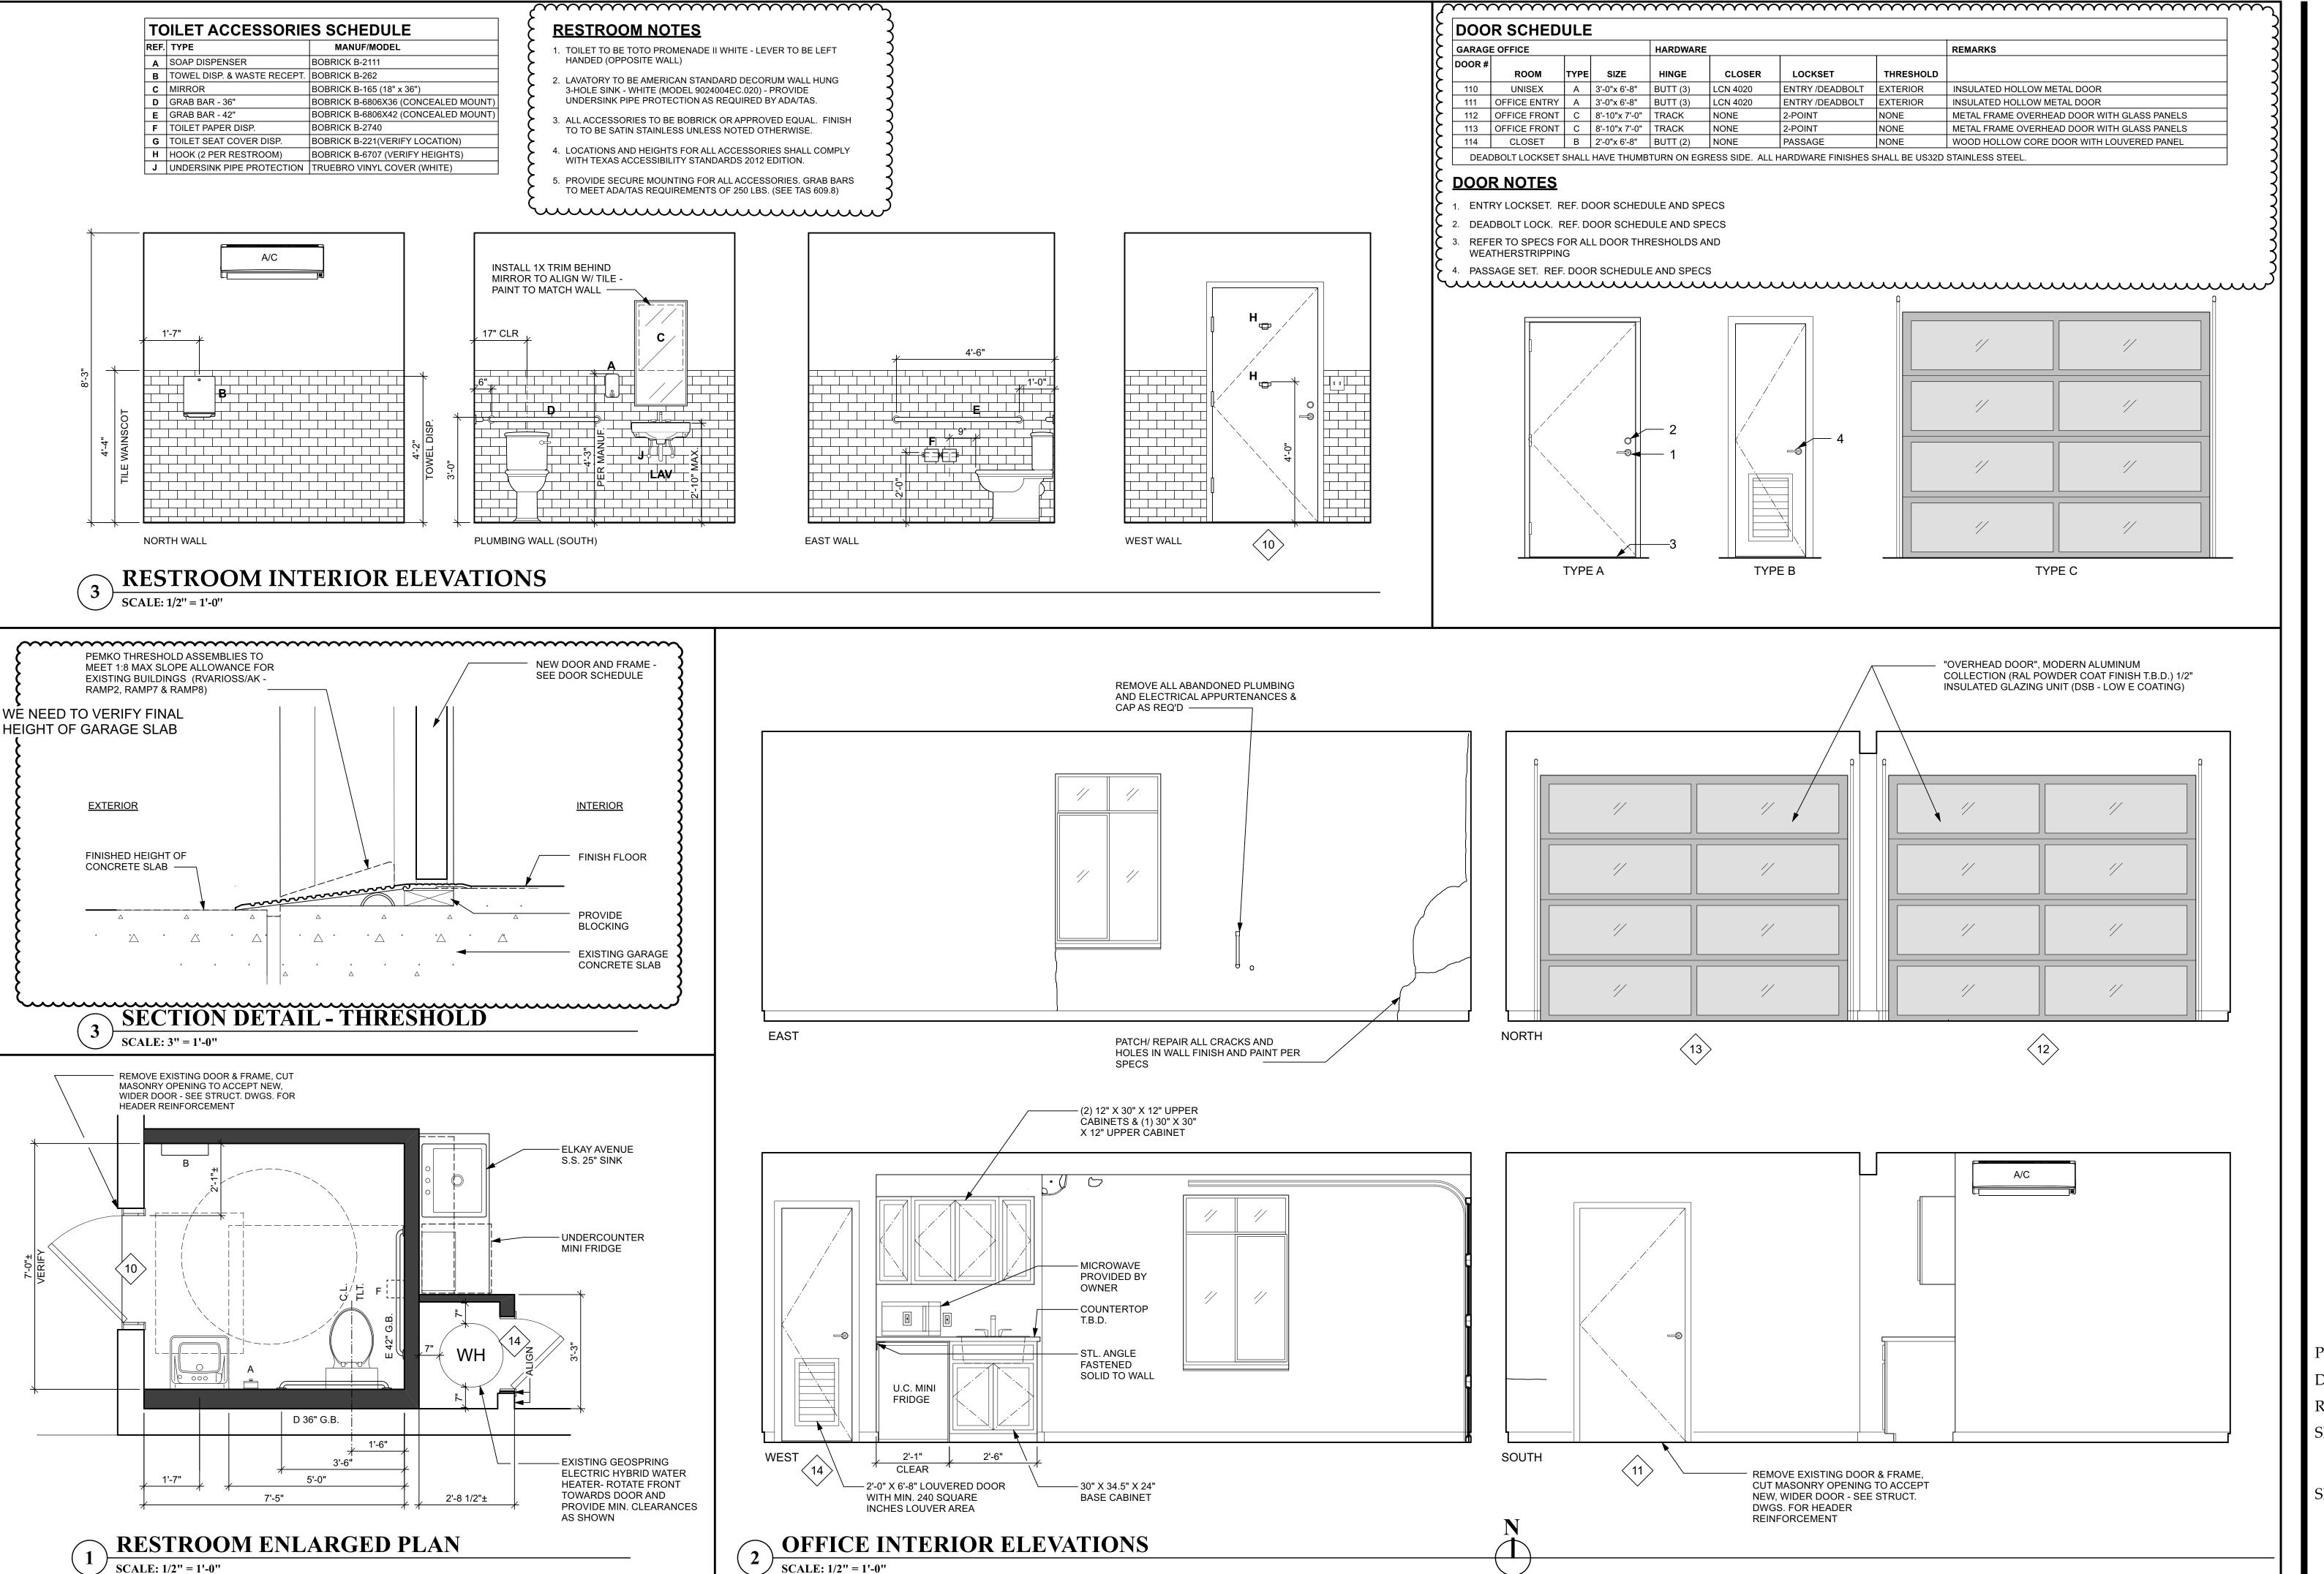

REVIEW SET ONLY

NOT FOR REGULATORY

APPROVAL, PERMITTING

OR CONSTRUCTION

CHRISTOPHER E.

HUTSON

TX #15635

1206 Quail Park Drive Austin, Texas 78758 Phone: (512) 960-0013

MCFARLAND HOU
INTERIOR AND EXTERIOR RESTORAT

PROJECT NO:

DATE: 01/12/2023

REV:


3805 Re

SHEET NAME:

ENLARGED PLANS & ELEVATIONS
SHEET NO:

A-400

50% CONSTRUCTION DOCUMENTS

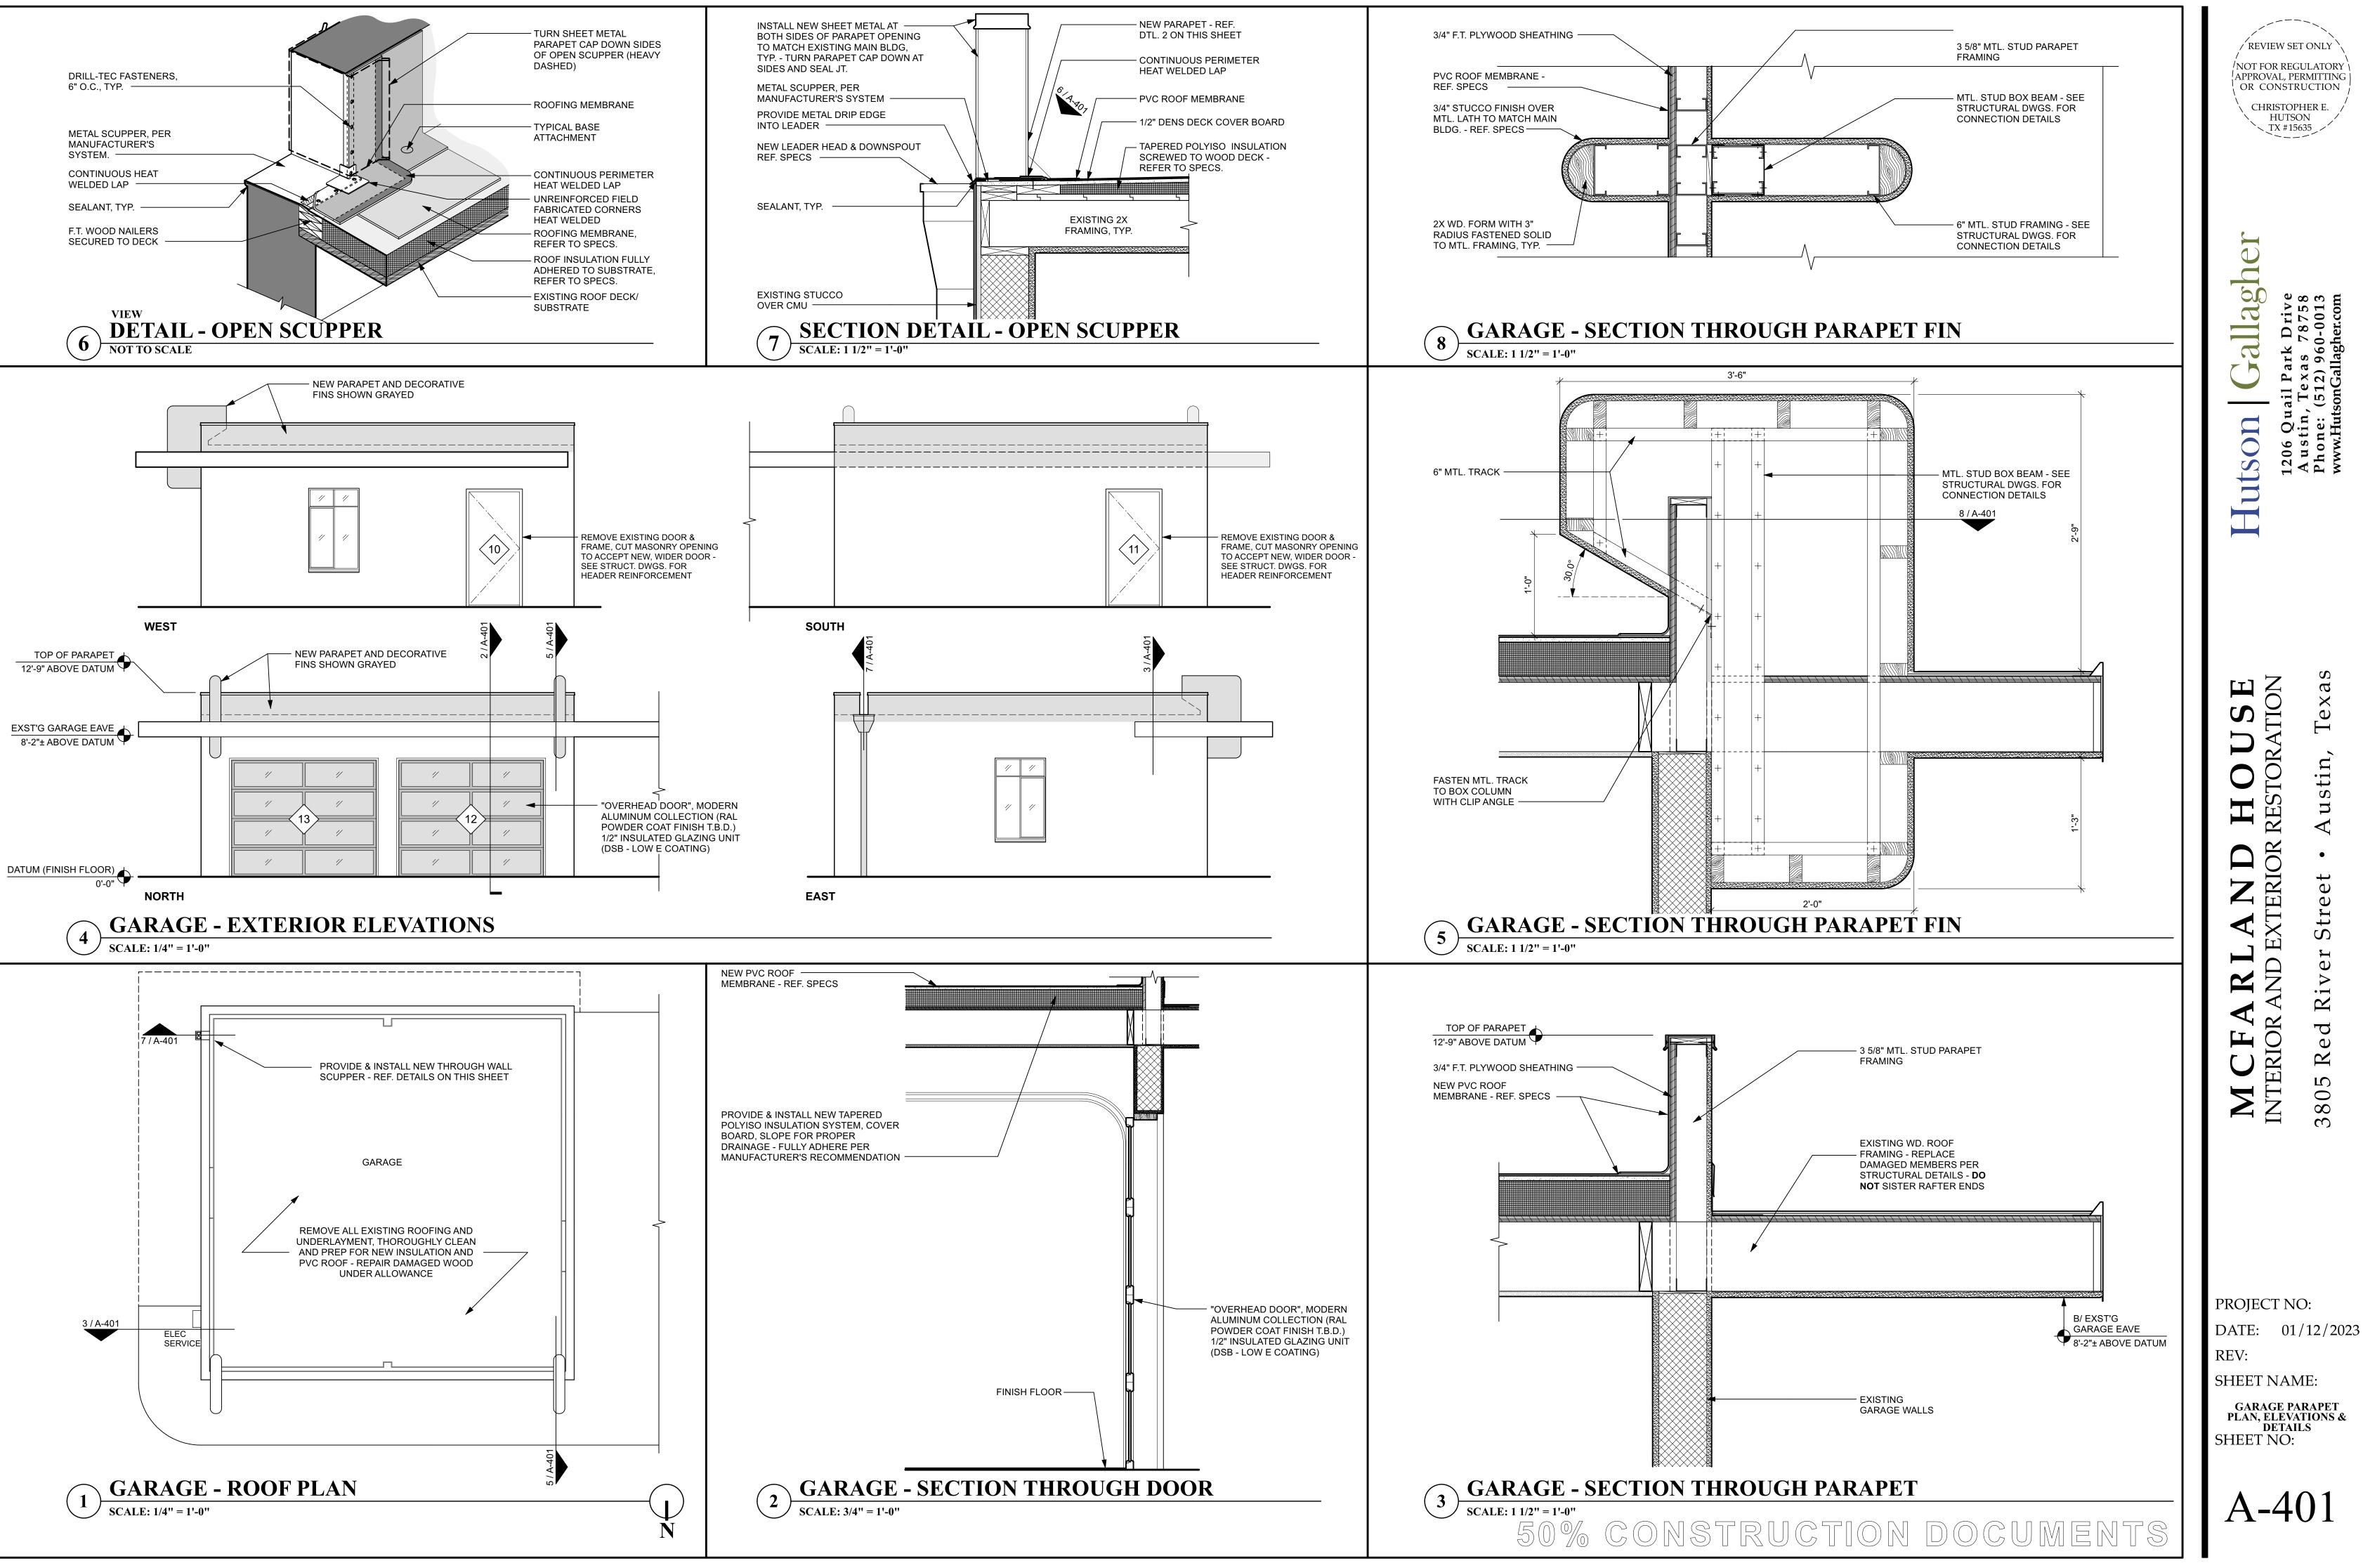

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PROJECT NO:

SHEET NAME:

GARAGE PARAPET PLAN, ELEVATIONS &

DETAILS SHEET NO:


DATE. 11/28

KEV.

SHEET NAME:

SECOND FLOOR FRAMING PLAN SHEET NO:

S-2

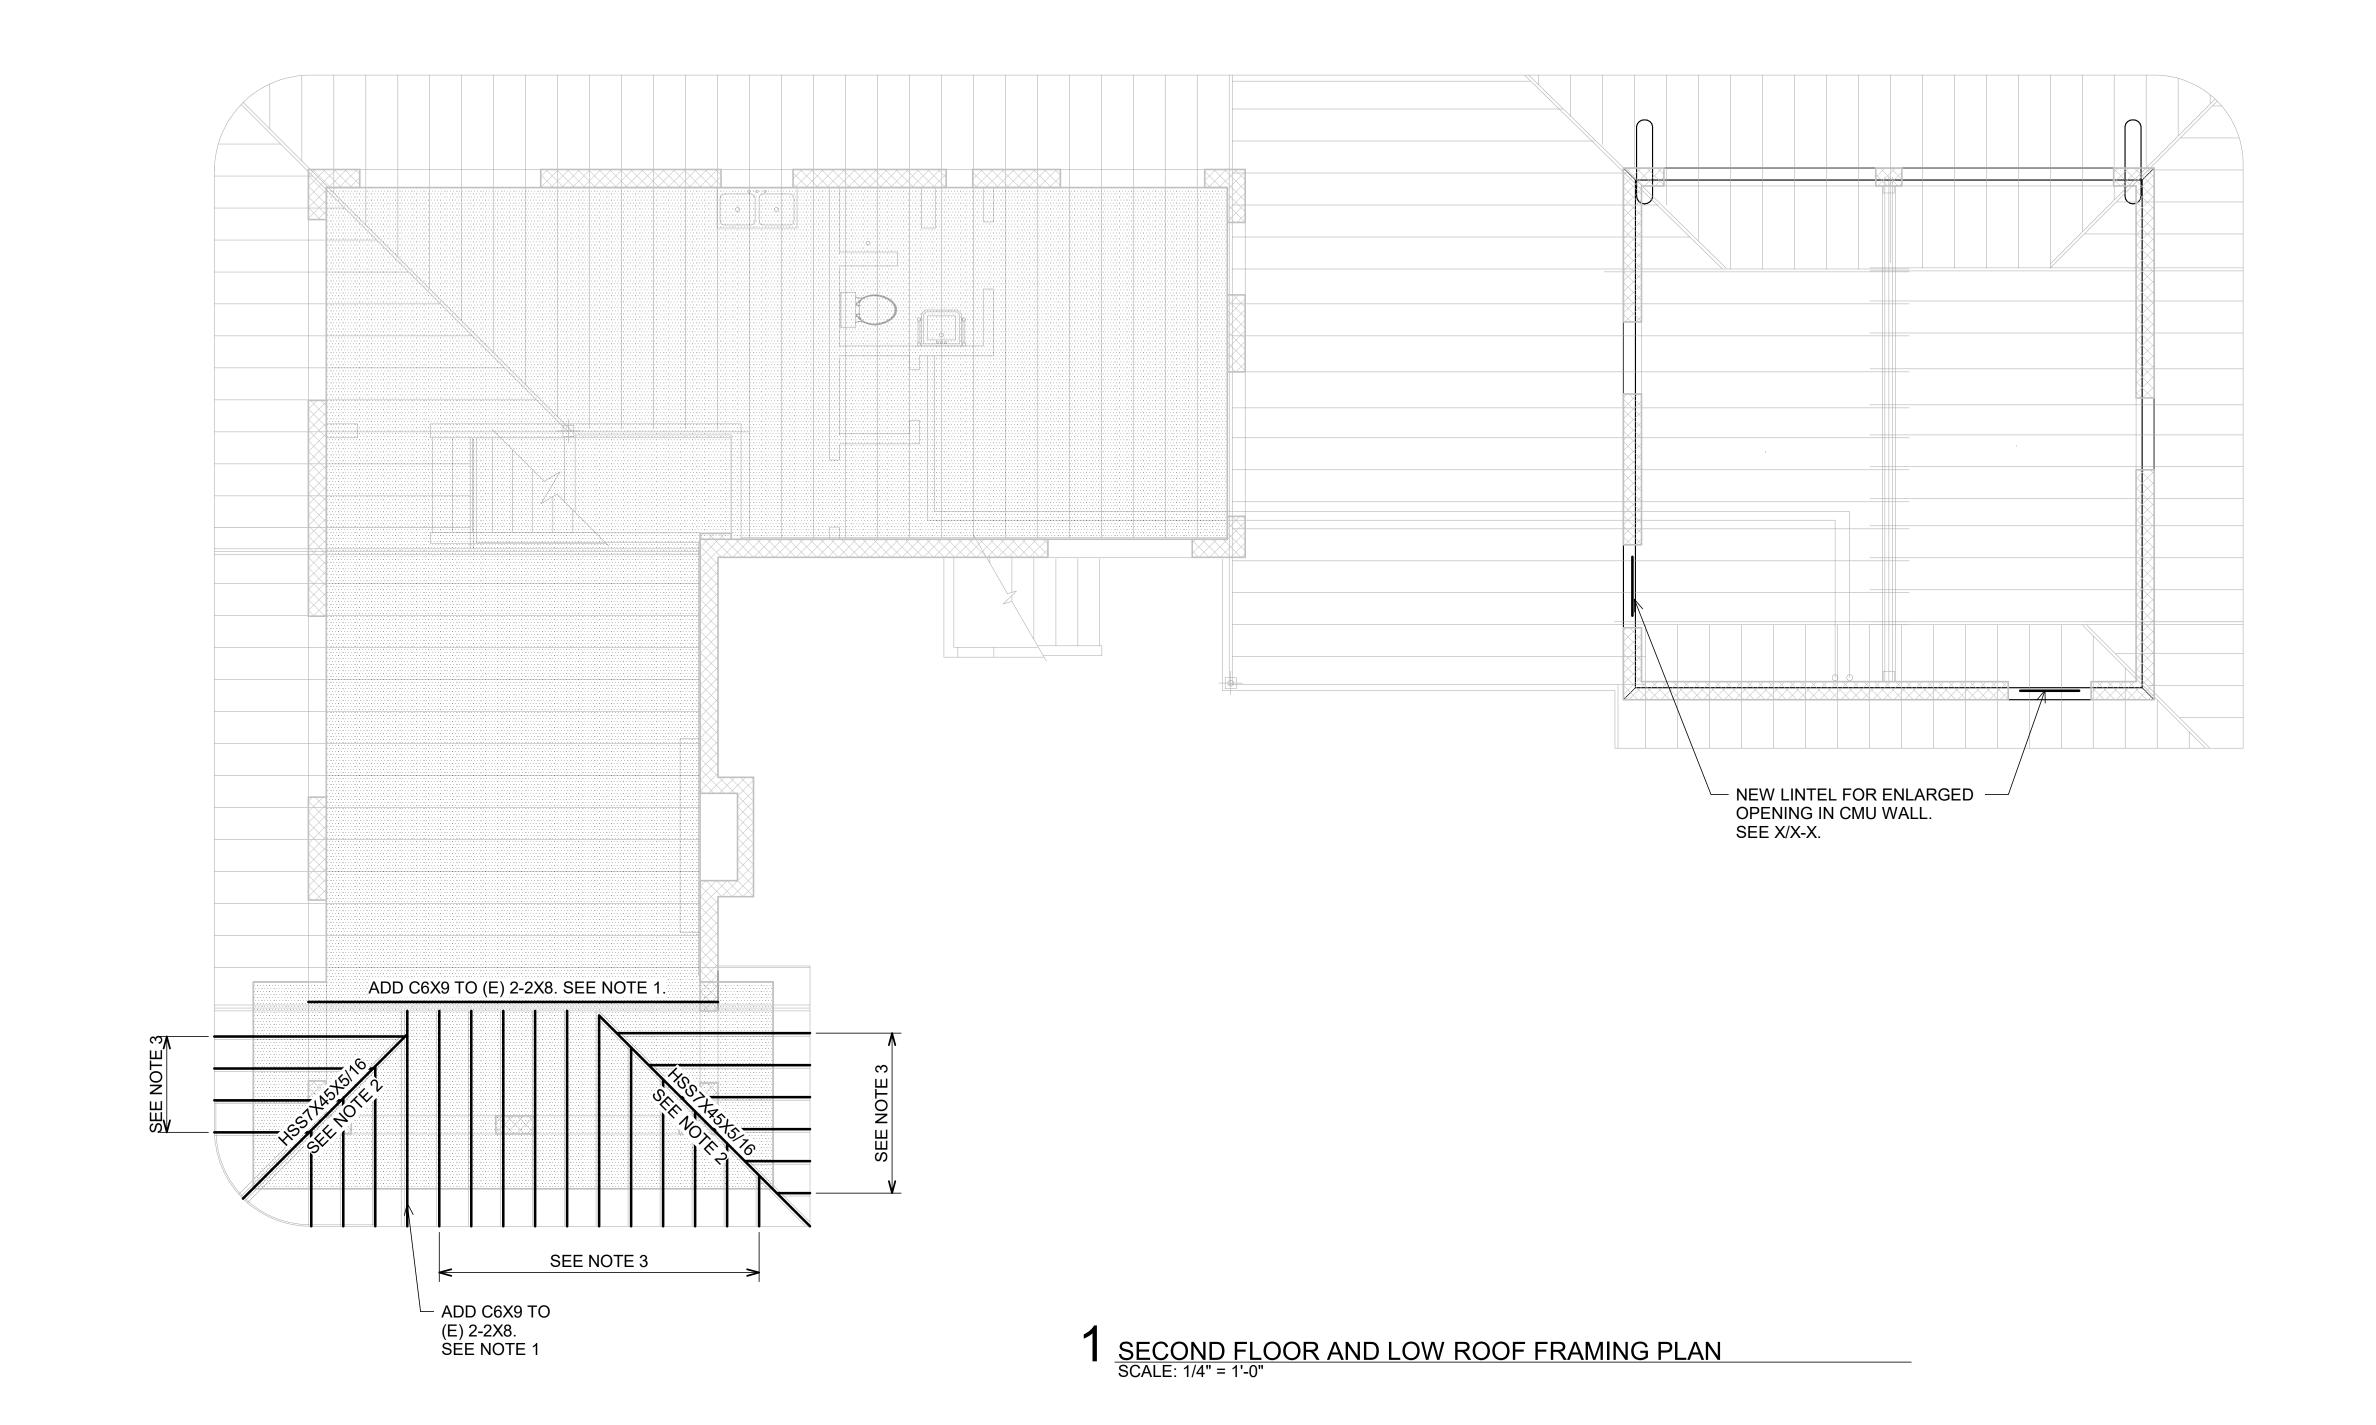

PLAN NOTES:

- STIFFEN EXISTING BEAM IN PLACE BY ADDING A STEEL CHANNEL. REESTABLISH FLAT CONDITION FOR EXISTING BEAM PRIOR TO INSTALLING THE STEEL CHANNEL.
- REPLACE EXISTING MULTI-PLY HIPS WITH STEEL TUBES. ATTACH NAILERS TO TUBES TO RECEIVE WOOD JOISTS.
- 3. ADD NEW 2X8 TO EXISTING 2X8 WOOD JOISTS. REMOVE 'SCABBED ON' WOOD. SEE NOTE 4 FOR ADDITIONAL INFO.
- 4. ADDITIONAL WOOD WAS 'SCABBED ON' DURING A PREVIOUS REPAIR TO REPLACE DETERIORATED WOOD; HOWEVER, IT DID NOT REEASTABLISH MEMBER'S ORIGINAL STRUCTURAL INTEGRITY. THEREFORE, ADDITIONAL 'SCABBED ON' WOOD SHALL BE REMOVED AS IT IS ADDING UNNECESSARY WEIGHT TO THE STRUCTURE.
- FLOOR AREAS ARE INDICATED WITH A STIPPLE. REMAINING AREAS ARE ROOF.
- 6. VERIFY AND COORDINATE ALL DIMENSIONS W/ ARCHITECTURAL DRAWINGS.

PLAN NOTES:

- STIFFEN EXISTING BEAM IN PLACE BY ADDING A STEEL CHANNEL. REESTABLISH FLAT CONDITION FOR EXISTING BEAM PRIOR TO INSTALLING THE STEEL CHANNEL.
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SHEET NAME:

ROOF FRAMING PLAN

SHEET NO: