# **605 HIGHLAND RESIDENCE**




PROJECT ADDRESS: 605 HIGHLAND AVE AUSTIN, TEXAS 78703

> PROJECT NUMBER: **PROJECT ISSUE DATE:**

TEL. 512-891-6766



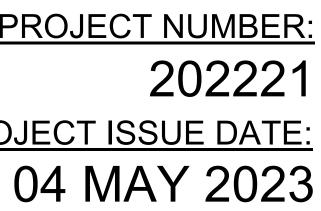

# LOCATION MAP

NSTRUCTION LOCATION

# **INDEX OF SHEETS**

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NE CORNER VIEW FROM STREET

PRELIMINARY NOT FOR CONSTRUCTION

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DONNA CARTER **TEXAS REGISTRATION NUMBER #8207** 

REVISIONS:			
NO	REFERENCE	ISSUED	

**ARCHITECT** 



#### ABBREVIATIONS

0	<b>Δ</b> .Τ	
@	AT	EWC
@.F.F., @FF	AT FINISHED FLOOR	
<i>ш</i> .г.г., <i>ш</i> гг		EXH.
ABV.	ABOVE	EXP.
	-	
ACOUST.	ACOUSTICAL	EXT.
A/C	AIR CONDITIONING	EXTING.
ADA	AMERICANS WITH DISABILITIES ACT	FEC
	ADMINISTRATION	
ADMIN.	ADMINISTRATION	F.F. (E.)
A/P/F/S.	AMPS/POLES/FUSE SIZE/STARTER SIZE	FH., F.H.
		,
A.F.F., AFF	ABOVE FINISH FLOOR	FHC
ALUM.	ALUMINUM	FIN.
ARCH(L).	ARCHITECT, ARCHITECTURAL	FIX.
ASST.	ASSISTANT	FLR.
A-V	AUDIO-VISUAL	FLUOR.
BD.	BOARD	F.O.C.
BET.	BETWEEN	FT.
BHL	BOREHOLE	FURR.
BLDG.	BUILDING	FXD.
BLK.	BLOCK	G.C.
BLKG	BLOCKING	GA.
BM(S).	BEAM(S)	GALV.
B.O.C.	BACK OF CURB	GFI.
BOT.	BOTTOM	GLZ.
BSMT.	BASEMENT	G.P.M.
BTWN.	BETWEEN	GR.
CL	CENTER LINE	GRND.
C.	CONDUIT	GYP.
		GIF.
C.J., CJ	CONTROL JOINT	H.C.; H/C
C.O.A.	CITY OF AUSTIN	HORIZ.
CAB.	CABINET	HR.
CAL.	CALIPER	HRDWD.
CCTS.		
6615.	CIRCUITS	HT.
CHAN.	CHANNEL	IN.
CLG.	CEILING	INFO
	CONCRETE MASONRY UNIT	
CMU, C.M.U.		INSULA.; IN
COL.	COLUMN	INT.
COM.	COMMUNICATION	JAN.
CONC.	CONCRETE	
		JST
CONN.	CONNECTION	JT., JNT
CONST		
CONST.	CONSTRUCTION	LAM.
CONT.	CONTINUOUS	LAV.
COORD	COORDINATION	LBS.
CORR.	CORRIDOR	
		LF, L.F.
CTR(D).	CENTER(ED)	LT.
CU.	COPPER	MAX.
CVR.	COVER	MANUF.
DET.	DETAIL	MECH.
DIAG.	DIAGONAL(LY)	
		M.E.P.
DIA.	DIAMETER	MFR.
DISP.	DISPENSER	MGR.
DIV.	DIVISION	MH.
DN.	DOWN	MIN.
DORM.	DORMITORY	MISC.
-		WISC.
DP.	DEEP	M.O.
D.S.	DOWNSPOUT	MTD.
DW	DISHWASHER	MTL.
DWG.	DRAWING	Ν.
DWLS.		NIC
	DOWELS	
E.	DOWELS	
	EAST	N.T.S.
EA.	EAST EACH	
	EAST EACH	N.T.S. NF.
EJ., E.J.	EAST EACH EXPANSION JOINT	N.T.S. NF. NO.
	EAST EACH	N.T.S. NF. NO.
EJ., E.J. ELEV.	EAST EACH EXPANSION JOINT ELEVATION	N.T.S. NF. NO. O.C.
EJ., E.J. ELEV. ENGR.	EAST EACH EXPANSION JOINT ELEVATION ENGINEER	N.T.S. NF. NO.
EJ., E.J. ELEV. ENGR.	EAST EACH EXPANSION JOINT ELEVATION ENGINEER	N.T.S. NF. NO. O.C. O.H.
EJ., E.J. ELEV. ENGR. EQ.	EAST EACH EXPANSION JOINT ELEVATION ENGINEER EQUAL	N.T.S. NF. NO. O.C. O.H. OPNG.
EJ., E.J. ELEV. ENGR.	EAST EACH EXPANSION JOINT ELEVATION ENGINEER	N.T.S. NF. NO. O.C. O.H.

EXHAUST EXPANSION EXTERIOR EXTINGUISHER FIRE EXTINGUISHER CABINET FINISHED FLOOR (ELEVATION) FIRE HYDRANT FIRE HOSE CABINET FINISH FIXTURE FLOOR FLUORESCENT FACE OF CURB FOOT, FEET FURRING FIXED GENERAL CONTRACTOR GAUGE GALVANIZED GROUND FAULT INTERRUPT GLAZING GALLONS PER MINUTE GRADE GROUND GYPSUM HANDICAPPED HORIZONTAL HOUR HARDWOOD HEIGHT INCHES INFORMATION NSULA.; INSUL. INSULATION INTERIOR JANITOR JOIST JOINT LAMINATE LAVATORY POUNDS LINEAR FEET LIGHT MAXIMUM MANUFACTURER MECHANICAL MECHANICAL, ELECTRICAL, PLUMBING MANUFACTURER MANAGER MANHOLE MINIMUM MISCELLANEOUS MASONRY OPENING MOUNTED METAL NORTH NOT IN CONTRACT NOT TO SCALE NON-FUSED NUMBER ON CENTER OVERHEAD OPENING OPPOSITE

ELECTRIC WATER COOLER


P.P., PP POWER POLE P.S.F. POUNDS PER SQ. FT. PUBLIC UTILITY EASEMENT P.U.E. PC. PHOTO CELL PG. PAGE PLATE PL. PLAS. PLUM. PLASTIC PLUMBING PLYWD. PLYWOOD PNT PAINT PREFAB. PREFABRICATED PRO. PROTECTION PVC. POLYVINYL CHLORIDE REFRIGERATOR R.O.W. RIGHT OF WAY RCP., R.C.P. REINFORCED CONCRETE PIPE ROOF DRAIN R.D. RECOMMENDATION RECOM. REF. REFER TO REINF. REINFORCED; REINFORCEMENT REQD. REQUIRED RM. R.R. ROOM RESTROOM SOUTH S.B.L. SETBACK LINE SAN. SANITARY SC. SCALE SCHED. SCHEDULED SF. SQUARE FEET SHT. SHWR. SHEET SHOWER SIM. SIMILAR SN. S.O.S. SOLID NEUTRAL SIMILAR OPPOSITE SIDE SQ. STD. STGT. SQUARE STANDARD SEALTIGHT STIFF. STIFFENER STL. STEEL STOR. STORAGE STRUCT. STRUCTURAL SUSP. SUSPENDED SW. SWITCH SWR SEWER TEL. TELEPHONE TWIST LOCK T.O.B.(M.) TOP OF BEAM T.O.S. TOP OF STEEL TOT. TOTAL TUBE STEEL TS TW. TOP OF WALL TYP. TYPICAL UNDERWRITER'S LABORATORY UL U.N.O., UNO UNLESS NOTED OTHERWISE VCT VINYL COMPOSITE TILE VERT. VERTICAL W/ WITH WEST WATER RESISTANT W.R. W.W.F. WOVEN WIRE FABRIC WD. WOOD WP. WT. WEATHER PROOF WEIGHT

R

S.

TI

W

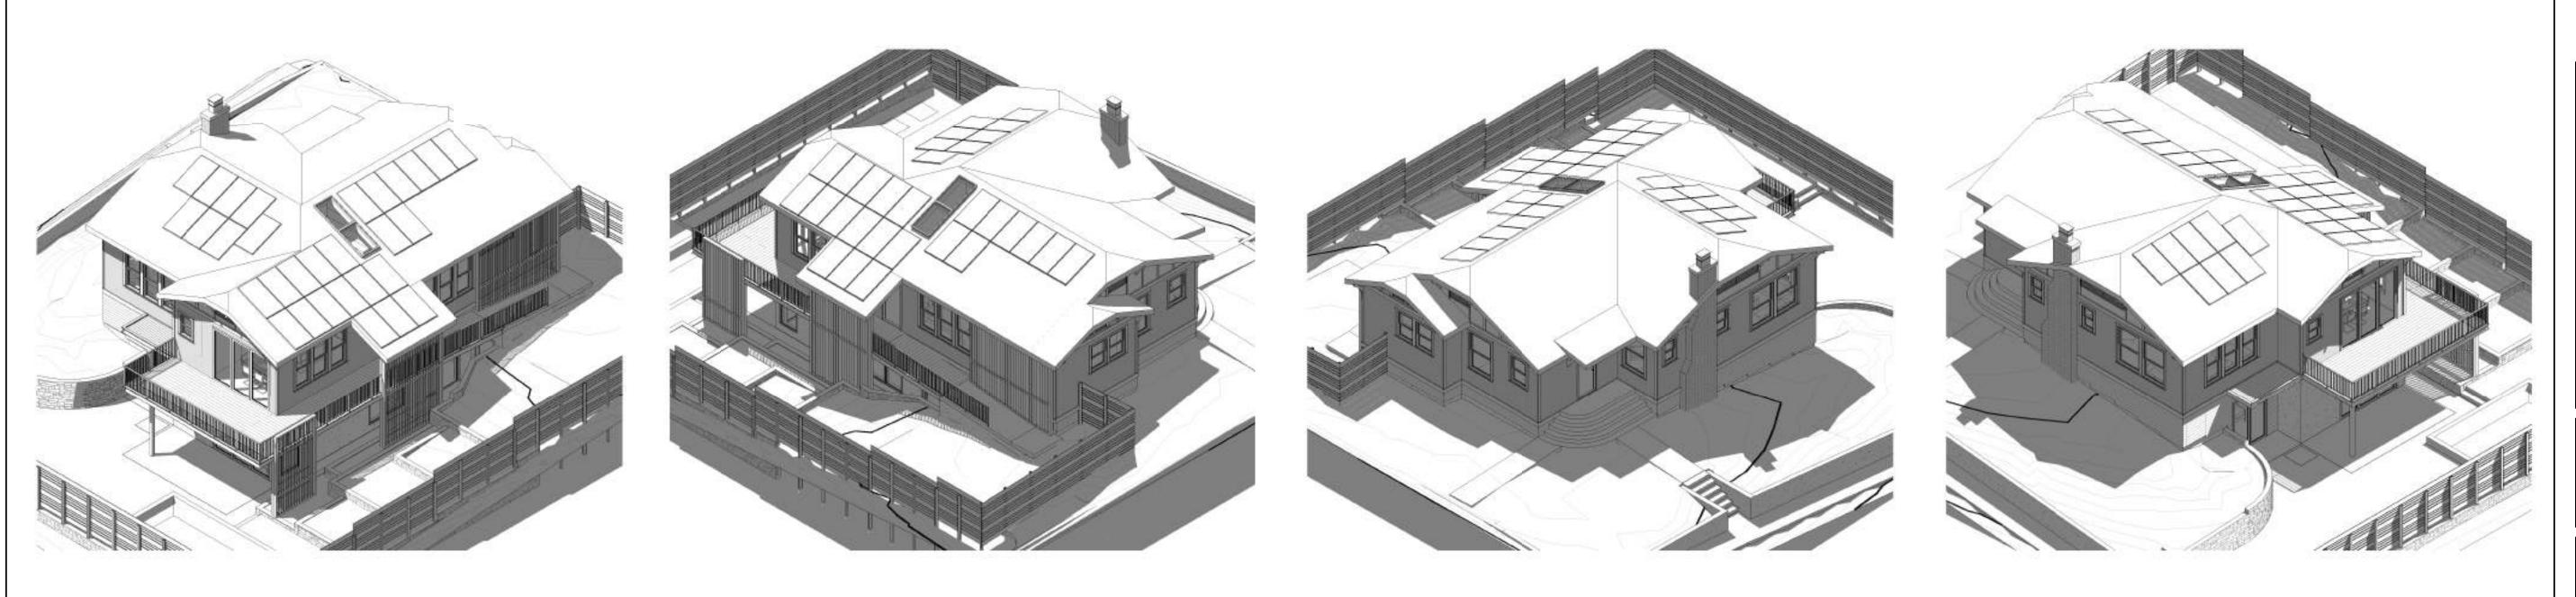

SYM	BOLS	PROJECT INFO PROJECT NAME ADDRESS	ORMATION 605 HIGHLAND RESIDEN 605 HIGHLAND A	
1 View Name 1/8" = 1'-0"	DRAWING TITLE	ZONING	SF-3 -HD	)-NP
PLAN TRUE	NORTH ARROWS	NEIGHBORHOOD LOT SIZE (SF)	CENTRAL WEST AUSTIN, OWANA, SMOOT TERRA	ACE 6000
NORTH NORTH FINISH FLOOR 100' - 0" FINISH FLOOR 100' - 0"	ELEVATION IDENTIFIER	SETBACKS:	FRONT YARD SETBACK (F) STREET SIDE YARD SETBACK (F) SIDEYARD SETBACK (F)	25' 15' 5'
	CEILING HEIGHT IDENTIFIER		REAR YARD SETBACK (F)	10'
A-101	ELEVATION MARKERS	MAX. BUILDING C MAX. IMPERVIOU		40% 45%
SIM 1 / A101	SECTION CUT MARKER	VISITABILITY REC	QUIRED REFER TO SHEET G102 FOR VISITIBILITY PLANS AND DETAILS	NO
1 A-101	DETAIL CALL-OUT MARKER	SUBCHAPTER F A	APPLICABLE REFER TO SHEET G102 FOR FAR PLANS AND CALCULATIONS	YES
0	COLUMN GRID IDENTIFIER	APPLICABLE O INTERNATIONAL I UNIFORM PLUMB	RESIDENTIAL CODE (IRC) 2	2021 2021
<b>ROOM NAME</b> 100	FLOOR PLAN ROOM IDENTIFIER	UNIFORM MECHA NATIONAL ELECT INTERNATION FIR	NICAL CODE (UMC)2RICAL CODE (NEC)2RE CODE (IFC)2	2021 2020 2020 2021 2021
<b>100</b> <u>8'-0"</u>	RCP ROOM IDENTIFIER		WILDLAND-URBAN INTERFACE CODE (IWUIC) 2 AREAS (CHAPTER 25-12, ARTICLE 3)	2015
(101)	DOOR IDENTIFIER			
<1i>	WINDOW IDENTIFIER			
11	WALL CONSTRUCTION IDENTIFIER			
<	SLOPE ARROW			


#### GENERAL PROJECT NOTES

- 1. THE ARCHITECT, ENGINEER OR OWNER SHALL NOT BE REPONSIBLE FOR, OR HAVE CONTROL OF, OR CHARGE OF CONSTRUCTION MEANS, METHODS, TECHNIQUES, SEQUENCES OR PROCEDURES, NOR FOR SAFETY PRECAUTIONS AND PROGRAMS IN CONNNECTION WITH THE WORK. THE ARCHITECT, ENGINEER OR OWNER SHALL NOT BE RESPONSIBLE NOR HAVE CONTROL OF THE CONTRACTOR. SUBCONTRACTORS OR ANY OF THEIR AGENTS OR EMPLOYEES, OR ANY OTHER PERSONS PERFORMING ANY OF THE WORK.
- 2. WORK SHALL COMPLY WITH APPLICABLE LOCAL, STATE, AND FEDERAL CODES AND ORDINANCES AND STANDARD SPECIFICATIONS OF ALL AGENCIES HAVING THE RESPONSIBILITY OF REVIEWING PLANS AND SPECIFICATIONS FOR CONSTRUCTION OF ALL ITEMS PER THESE PLANS AND SPECIFICATIONS IN THIS LOCALITY. COMPLY WITH ALL RECOMMENDED PRACTICES AS SET FORTH BY THE FOLLOWING, BUT NOT LIMITED TO: EPA, ASME, SMACNA, ASHRAE, NFPA, ALL LOCAL BUILDING, MECHANICAL, AND PLUMBING CODE, NATIONAL ELECTRICAL CODE, OSHA, AND REGULATIONS OF ALL GOVERNING BODIES AS THEY APPLY TO THIS PROJECT.
- 3. THE CONTRACTOR IS REQUIRED TO TAKE DUE PRECAUTIONARY MEASURES TO PROTECT THE UTILITIES OR STRUCTURES AT THE SITE. INTERRUPTION OF UTILITY SERVICES IS NOT PERMITTED WITHOUT FULL COORDINATION WITH OWNER. SOME AREAS MAY REQUIRE WORK ON WEEKENDS OR OFF HOURS.
- 4. IT SHALL BE THE CONTRACTOR'S RESONSIBILITY TO NOTIFY THE OWNER OF ALL UTILITIES OR STRUCTURES CONCERNED BEFORE STARTING WORK. WHEN ANY EXISTING UTILITY REQUIRES ADJUSTMENT OR RELOCATION, THE CONTRACTOR SHALL NOTIFY THE PROPER UTILITY SERVICE AND COORDINATE HIS WORK ACCORDINGLY.
- 5. THE CONTRACTOR SHALL NOTIFY THE PROPER UTILITY IMMEDIATELY UPON BREAK OR DAMAGE TO ANY UTILITY LINE OR APPURTENANCE, OR THE INTERRUPTION OF THEIR SERVICE. IF EXISTING UTILITY CONSTRUCTION CONFLICTS WITH PROJECT REQUIREMENTS, CONTRACTOR SHALL NOTIFY OWNER SO THE CONFLICT MAY BE RESOLVED.
- 6. CONTRACTOR SHALL BE RESPONSIBLE FOR DAMAGE TO EXISTING PROPERTY BY HIS STAFF OR SUBCONTACTORS.
- 7. THE CONTRACTOR SHALL OBTAIN ALL THE NECESSARY PERMITS AS REQUIRED FOR CONSTRUCTION OF THIS PROJECT. 8. THE DESIGN AND PROVISION OF ALL TEMPORARY SUPPORTS SUCH
- AS BUYING BRACES, FALSEWORK, SUPPORTS AND ANCHORS FOR SAFETY LINES, CURBBING, SHORING, OR ANY OTHER TEMPORARY ELEMENTS REQUIRED FOR THE EXECUTION OF THE CONTRACT ARE NOT INCLUDED IN THESE DRAWINGS AND SHALL BE THE RESPONIBILITY OF THE CONTRACTOR. TEMPORARY SUPPORTS SHALL NOT RESULT IN THE OVERSTRESS OR DAMAGE OF THE ELEMENTS TO BE BRACED NOR ANY ELEMENTS USED AS BRACE SUPPORTS.
- 9. CONTRACTOR SHALL MEET ALL LOCAL NOISE ORDINANCES.

ISSUE DATE:	04 MAY 2023
PROJECT NUMBER	R: <b>202221</b>
DRAWN BY:	ZWR
CHECKED BY:	DDC

#### **REVISIONS:**


NO	REFERENCE	ISSUED

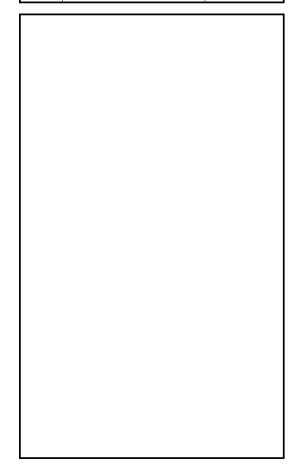

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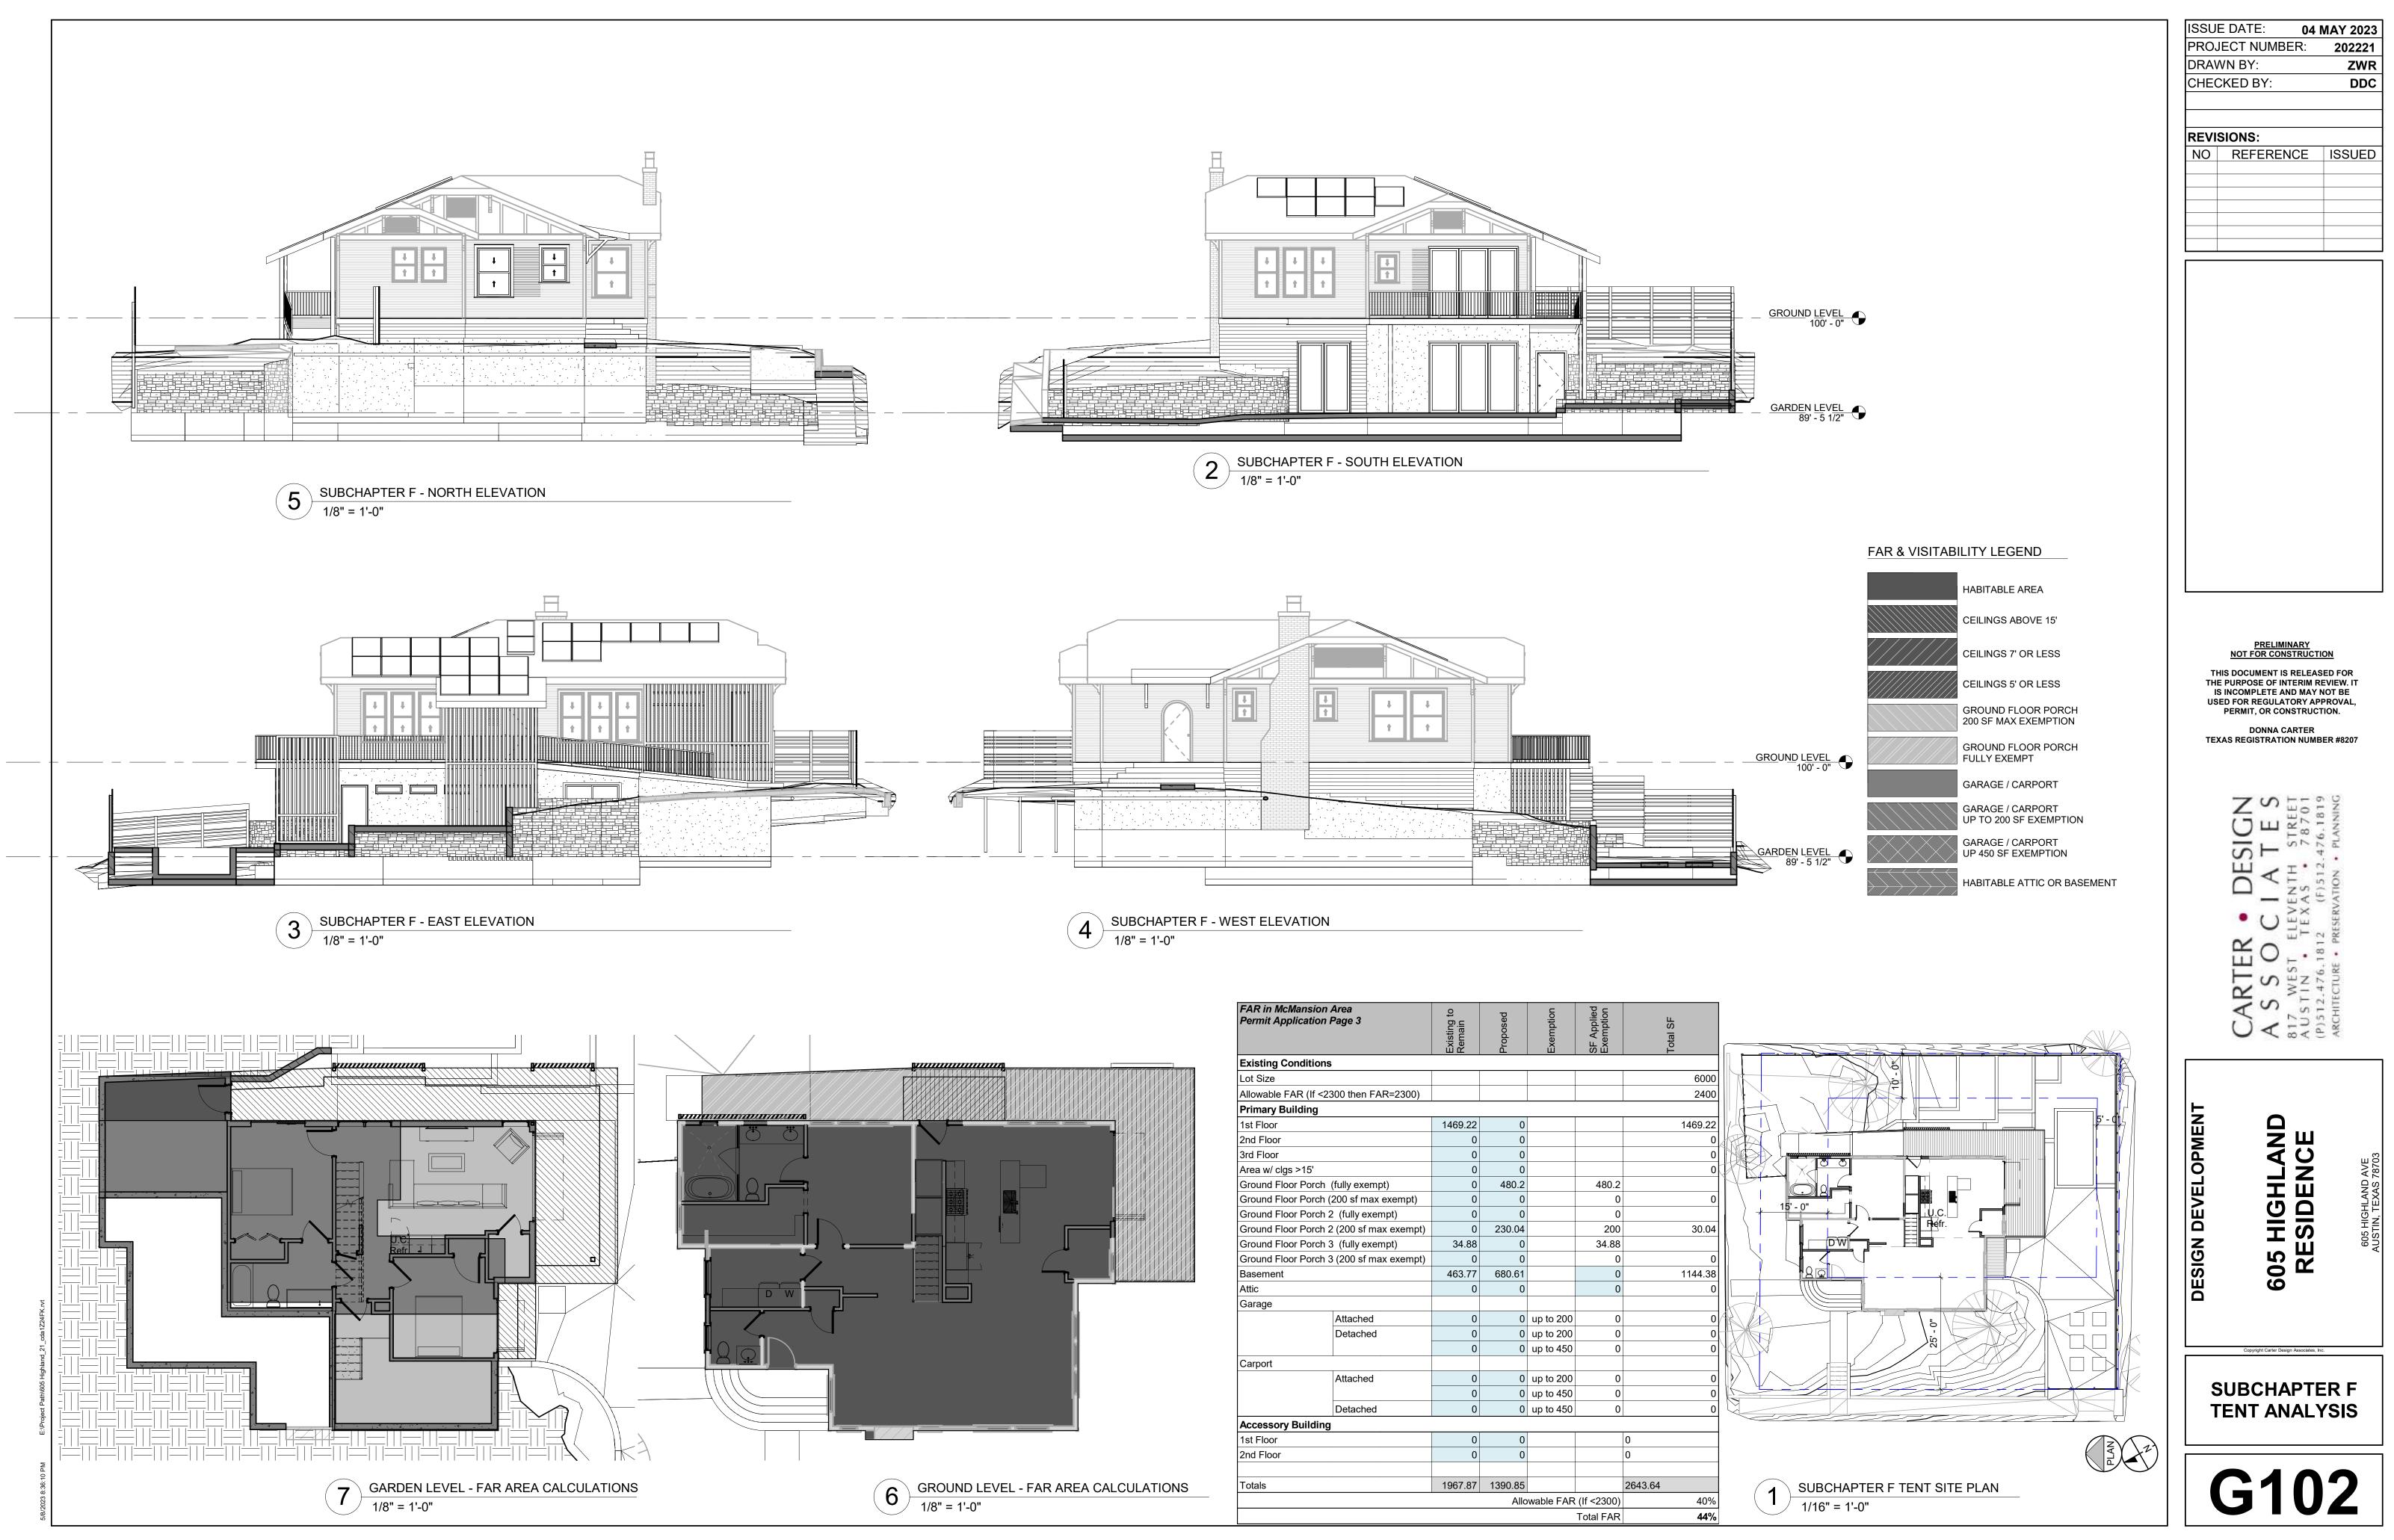
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DONNA CARTER **TEXAS REGISTRATION NUMBER #8207** 



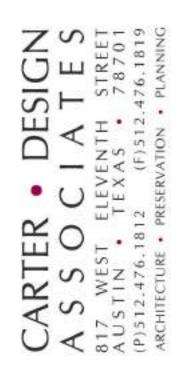

G101



FAR in McMansion Permit Application I		Existing to Remain	Proposed	Exemption	SF Applied Exemption	Total SF
<b>Existing Conditions</b>						
Lot Size						6000
Allowable FAR (If <23	300 then FAR=2300)					2400
Primary Building						
1st Floor		1469.22	0			1469.22
2nd Floor		0	0			
3rd Floor		0	0			(
Area w/ clgs >15'		0	0			(
Ground Floor Porch	(fully exempt)	0	480.2		480.2	
Ground Floor Porch (	200 sf max exempt)	0	0		0	(
Ground Floor Porch 2	2 (fully exempt)	0	0		0	
Ground Floor Porch 2	2 (200 sf max exempt)	0	230.04		200	30.04
Ground Floor Porch 3	3 (fully exempt)	34.88	0		34.88	
Ground Floor Porch 3	8 (200 sf max exempt)	0	0		0	(
Basement		463.77	680.61		0	1144.38
Attic		0	0		0	(
Garage						
	Attached	0	0	up to 200	0	
	Detached	0	0	up to 200	0	(
		0	0	up to 450	0	(
Carport						
	Attached	0	0	up to 200	0	
		0	0	up to 450	0	
	Detached	0	0	up to 450	0	(
Accessory Building						
1st Floor		0	0			0
2nd Floor		0	0			0
Totals		1967.87	1390.85			2643.64
			Allo	wable FAR	(lf <2300)	40%
					Total FAR	44%

# **CRAWL SPACE AND FOUNDATION**



LOOKING NORTHEAST

# HOUSE INTERIOR













LOOKING NORTHWEST



DINING ROOM



LIVING ROOM

# GARAGE



GARAGE - WEST ELEVATION

# **HOUSE EXTERIOR**



EAST ELEVATION



SOUTH ELEVATION







ISSU	ISSUE DATE: 04 MAY 2023			
PROJ	ECT NUMBER:	202221		
DRAV	VN BY:	ZWR		
CHEC	KED BY:	DDC		
REVIS	SIONS:			
NO	REFERENCE	ISSUED		



**GARAGE - NORTH ELEVATION** 



NORTH ELEVATION - 6TH 1/2 STREET




WEST ELEVATION - HIGHLAND AVENUE

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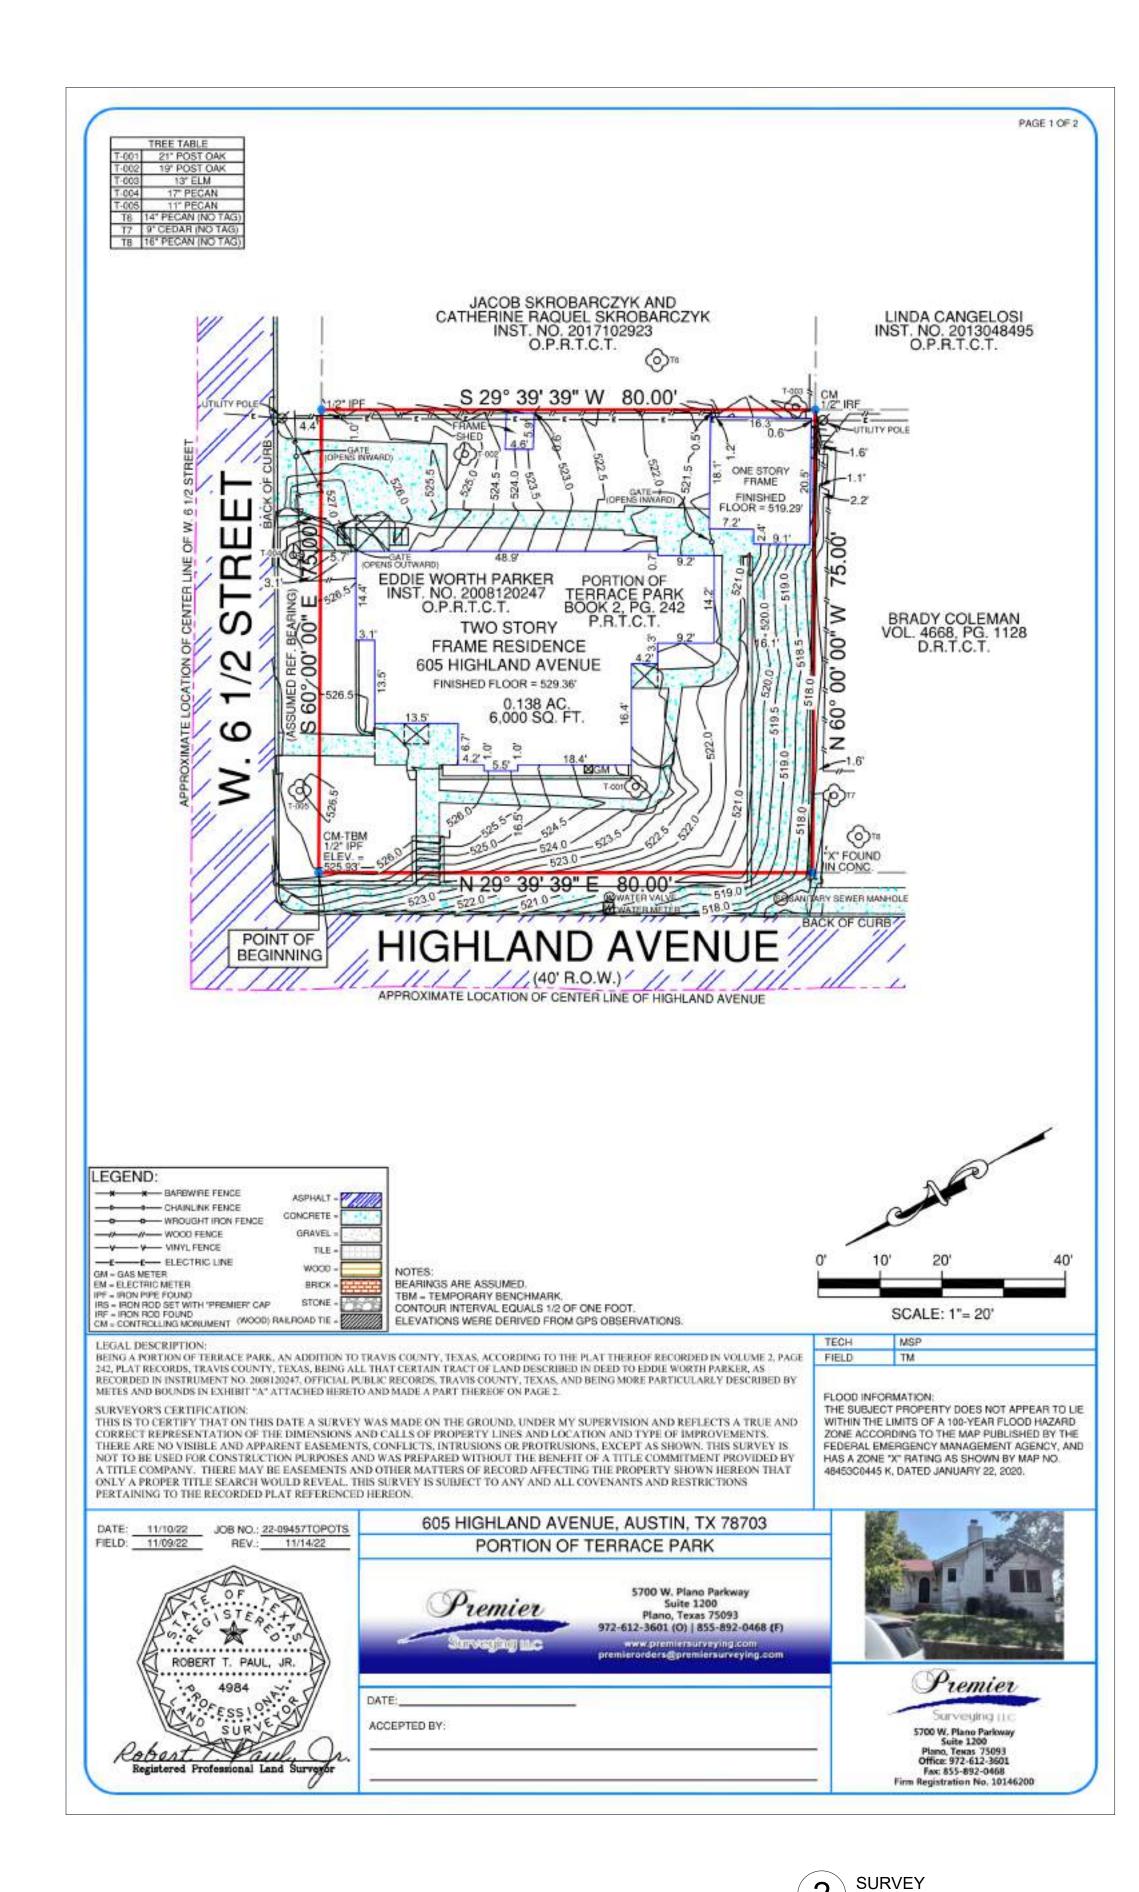
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2 / 1/2" = 1'-0"


# EXISTING CONCRETE TO REMAIN CONCRETE ASPHALT PERVIOUS PLANTINGS NEW ADDITION

LEGEND

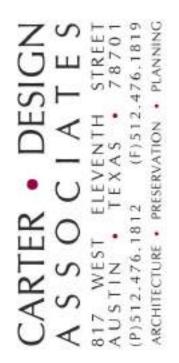572.3'

EXISTING ASPHALT TO REMAIN AREA TO BE REMODELED EXISTING BUILDING TO REMAIN CRITICAL ROOT ZONES OF PROTECTED TREES 1/2 AND 1/4 CRITICAL ROOT ZONES OF PROTECTED TREES GRAVEL AREA TO BE MULCHED

NEW TOPO LINE

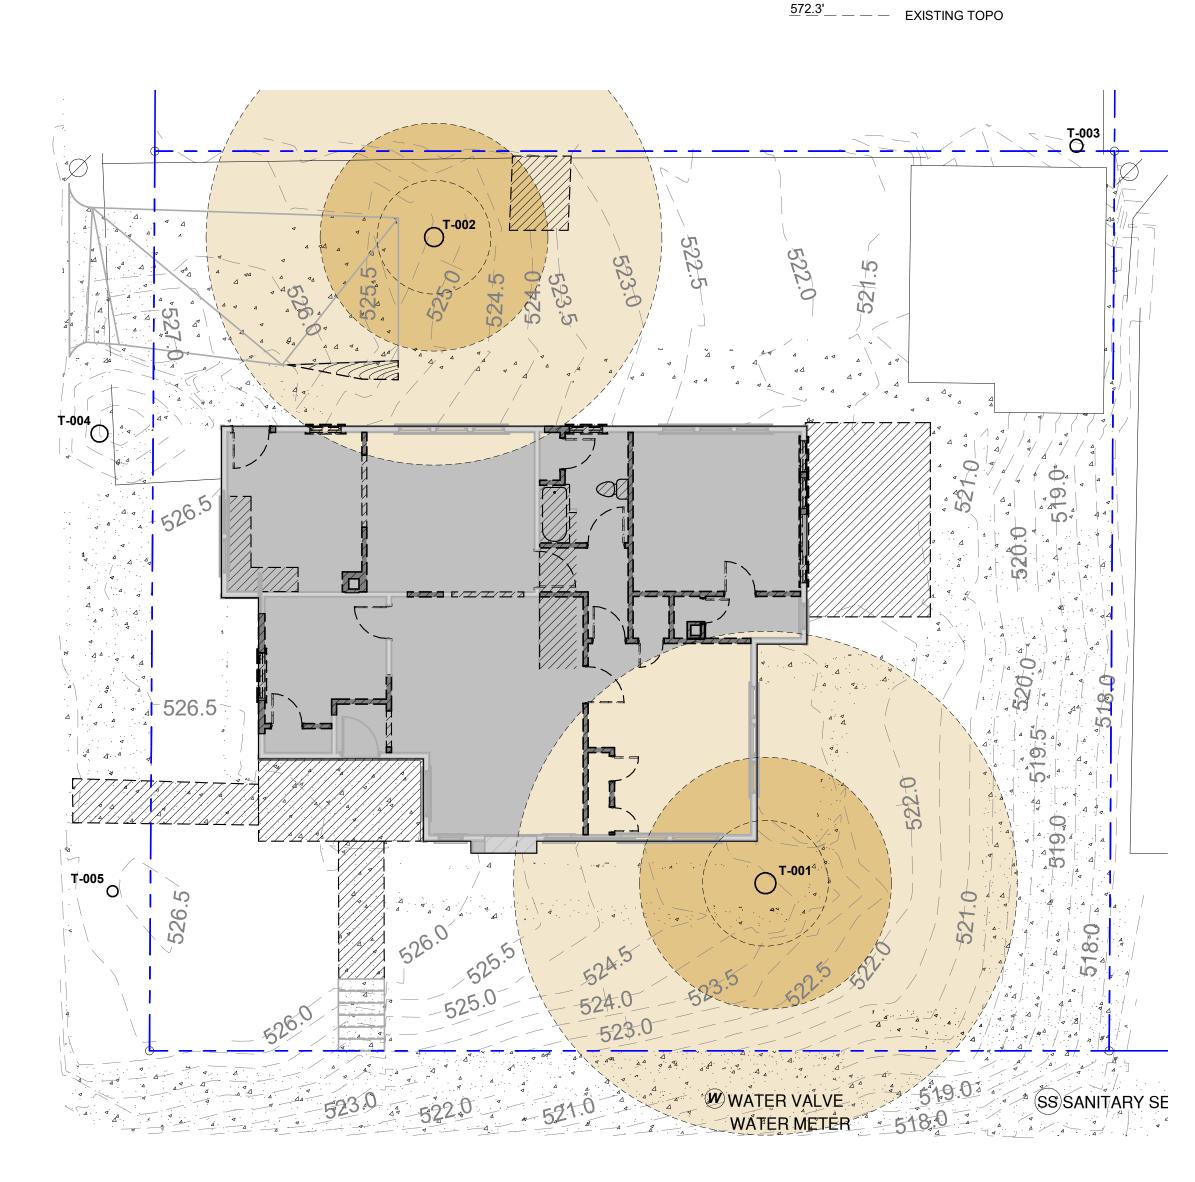



1.	EXISTINGS CONDITIONS ARE BASED ON SURVEY PERFORMED BY
	PREMIER SURVEYING LLC DATED 11/14/22, VISUAL INSPECTION AND
	OWNER PROVIDED INFORMATION.

SITE PLAN NOTES

- 2. VERIFY EXISTING SITE CONDITIONS AND REPORT ANY DISCREPANICES BETWEEN ACTUAL FIELD CONDITIONS AND THESE PLANS PRIOR TO COMMENCING WORK.
- ALL NEW SIDEWALKS TO HAVE MAX 1:20 GRADE WITH CROSS SLOPE TO DRAIN AT 1/4" PER FOOT AND BROOM FINISH UNLESS OTHERWISE NOTED.
- 4. REFER TO SHEET G101 FOR VISITIBILITY REQUIREMENTS.
- 5. FIRST FLOOR ENTRANCES SHALL HAVE MAX 1/2" BEVELED THRESHOLDS.
- 6. ENSURE GRADE SLOPES AWAY FROM BUILDING ALONG ENTIRE PERIMETER.
- 7. THE SITE PLAN SHOWS ONLY PROTECTED TREES. OTHER TREES BELOW 19" ARE SHOWN ON THE EXISTING CONDITIONS PLAN AND ARE TO REMAIN AND BE SIMILARLY PROTECTED DURING CONSTRUCTION AS REASONABLE UNLESS SPECIFICALLY LABELED TO BE REMOVED.
- 8. TREES ARE SHOWING WITH ACTUAL DIAMETER.
- 9. ALL SITE AREAS WITH NO NEW LANDSCAPE OR HARDSCAPE SHALL BE RESTORED TO EXISTING CONDITION.
- 10. FRONT YARD IMPERVIOUS COVER =

#### TREE PROTECTION NOTES

- 1 BEFORE CONSTRUCTION
- 1.1 ALL TREES AND NATURAL AREAS SHOWN ON PLAN TO BE PRESERVED SHALL BE PROTECTED PER ECM 3.6.1.
- 1.2 TREE PROTECTION SHALL BE INSTALLED PRIOR TO THE START OF ANY SITE WORK, INCLUDING DEMOLITION OR SITE PREPARATION. REFER TO ECM 3.6.1.A.
- 1.3 FENCING FOR TREE PROTECTION SHALL BE CHAIN-LINK MESH WITH A MINIMUM HEIGHT OF 5 FEET AND SHALL BE INSTALLED AROUND OR BEYOND THE CRITICAL ROOT ZONE EXCEPT AS ALLOWED IN ECM 3.6.1.B.4.
- 1.4 UNFENCED SECTIONS OF THE CRITICAL ROOT ZONE SHALL BE COVERED WITH MULCH AT A MINIMUM DEPTH OF 8 INCHES AND A MAXIMUM DEPTH OF 12 INCHES PER ECM 3.6.1.C.
- 1.5 WHERE FENCING IS LOCATED 5 FEET OR LESS FROM THE TRUNK OF A PRESERVED TREE, TRUNK WRAPPING SHALL BE INSTALLED PER ECM 3.6.1.D.
- 1.6 EROSION AND SEDIMENTATION CONTROLS SHALL BE INSTALLED AND MAINTAINED SO AS NOT TO CAUSE IMPACTS THAT EXCEED PRESERVATION CRITERIA LISTED IN ECM 3.5.3.D. 2 DURING CONSTRUCTION
- 2.1 TREES APPROVED FOR REMOVAL SHALL BE REMOVED IN A MANNER THAT DOES NOT EXCEED PRESERVATION CRITERIA FOR THE TREES TO REMAIN. REFER TO ECM 3.5.2 A.
- 2.2 FENCING MAY NOT BE TEMPORARILY MOVED OR REMOVED DURING DEVELOPMENT WITHOUT PRIOR AUTHORIZATION. THE FENCED CRITICAL ROOT ZONE SHALL NOT BE USED FOR TOOL OR MATERIAL STORAGE OF ANY KIND AND SHALL BE KEPT FREE OF LITTER. REFER TO ECM 3.6.1.B.3.
- 2.3 PRUNING SHALL BE IN COMPLIANCE WITH THE CURRENT ANSI A300 STANDARD FOR TREE CARE. 3 AFTER CONSTRUCTION
- 3.1 TREE PROTECTION SHALL BE REMOVED AT THE END OF THE PROJECT AFTER ALL CONSTRUCTION AND FINAL GRADING IS COMPLETE, BUT BEFORE FINAL INSPECTION. REFER TO ECM 3.6.1.A
- 3.2 LANDSCAPE INSTALLATION WITHIN THE CRZ OF PRESERVED TREES, INCLUDING IRRIGATION, SOIL AND PLANTINGS, SHALL NOT EXCEED PRESERVATION CRITERIA LISTED IN ECM 3.5.2.
- 3.3 DOCUMENTATION OF TREE WORK PERFORMED MUST BE PROVIDED TO INSPECTOR PER ECM APPENDIX P-6.
- 3.4 THIS LIST IS NOT EXHAUSTIVE. REFER TO APPROPRIATE ECM SECTIONS FOR FULL REQUIREMENTS.

#### TREE LIST

T-001	21" POST OAK
T-002	19" POST OAK
T-003	13" ELM
T-004	17" PECAN
T-005	11" PECAN


0'

4' 8'

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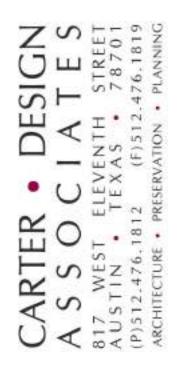
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HIGHLAN 605 I RE **EXISTING SITE CONDITIONS &** 

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SIGN


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16'

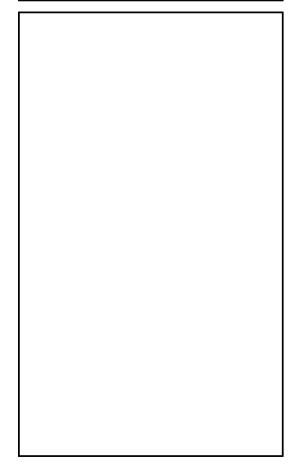


DEMO



ARCHITECTURAL SITE PLAN 1 1/8" = 1'-0"

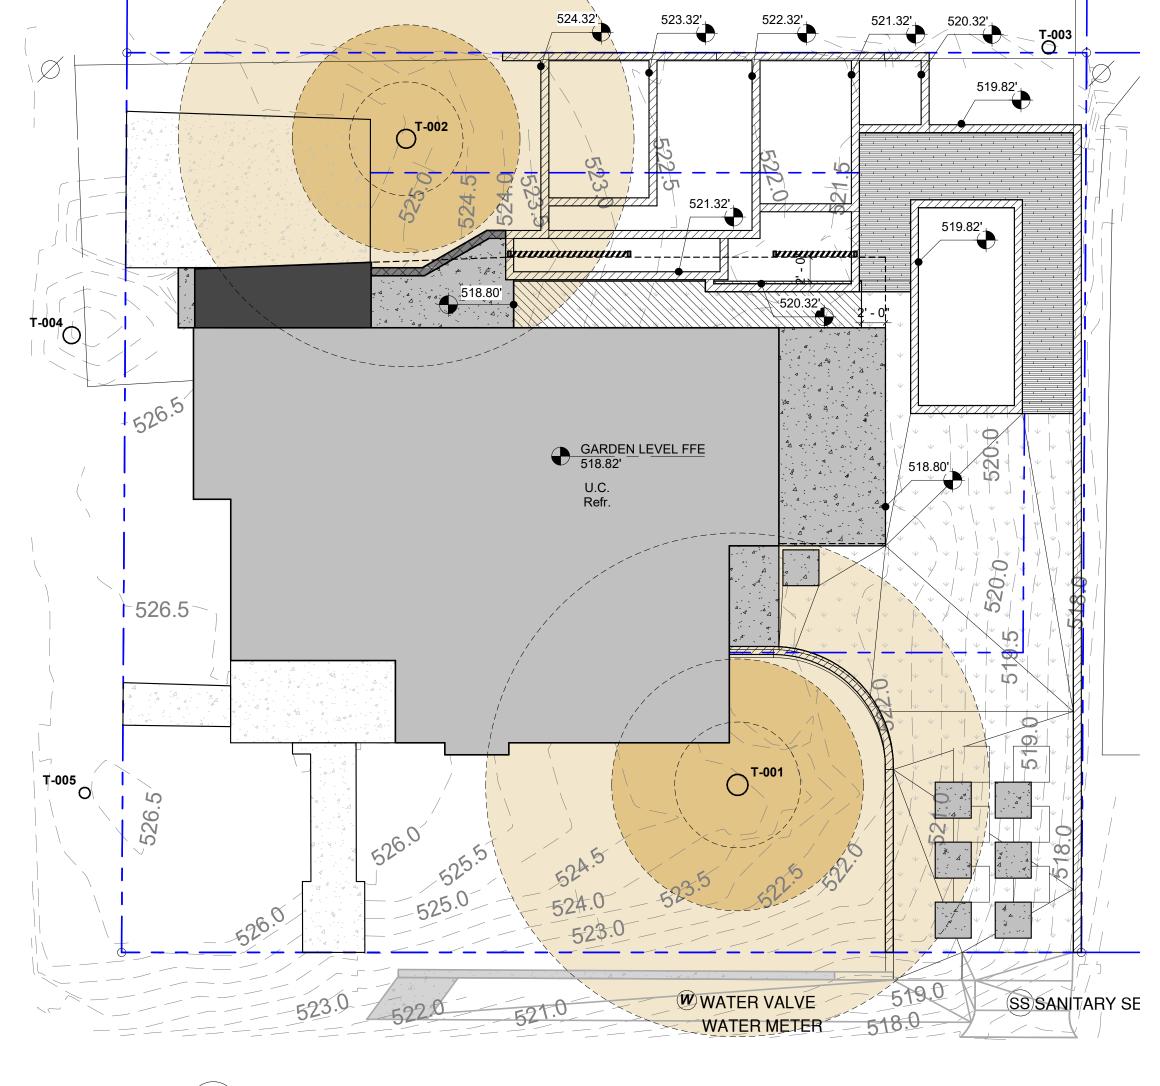Site Development Information	Development Information Existing to Remain		New/Added		Total S	
Permit Application page 2	Bldg 1	Bldg 2	Bldg 1	Bldg 2	Bldg 1	Blo
a) 1st Floor Conditioned Area	1469	0	0	0	1469	
<ul> <li>b) 2nd Floor Conditioned Area</li> </ul>	0	0	0	0	0	
c) 3rd Floor Conditioned Area	0	0	0	0	0	
d) Basement	463.77	0	604.59	0	1068	
e) Covered Parking (garage or carport)	0	0	0	0	0	
f) Covered patio, deck, porch and balconies	0	0	301.81	0	301.81	
g) Other covered or roofed areas	0	0	0	0	0	
h) Uncovered Wood Decks (counts at 50%)	0	0	203.18	0		
Total Building Area (a through h)	1932	0	906.4	0	2839	
i) Pool	0	0	131.86	0		
j) Spa	0	0	0	0		
<ul> <li>k) Remodeled Floor Area, excluding Addition/ New construction</li> </ul>	0	0				
Calculation Aid						
Permit Application page 7	Existi	ng SF	New/Ad	ded SF	Tota	al SF
		5				_
a) 1st Floor Conditioned Area		1469.22		0		146
b) 2nd Floor Conditioned Area		0		0		
c) 3rd Floor Conditioned Area		0		0		
d) Basement		463.77		604.59		106
e) Attached Covered Parking (garage or		0		0		
f) Detached Covered Parking (garage or		0		0		
g) Covered Wood Decks (count at 100%)		0		0		
h) Covered Patio		0		301.81		30
i) Covered Porch		0				00
				0		
j) Balcony		0		0		
k) Other: Specifiy Extended		0		76.02		7
Total Building Area (TBA) (add a thru k)		1932.99		982.42		291
Total Building Coverage (TBC) (TBA minus, if applicable: b,c,d and j)		1469.22		377.83		184
l) Driveway		255.87		0		25
m) Sidewalks		107.1		20		1
n) Uncovered Patio		94.12		150.12		24
o) Uncovered Wood Decks (counted at 50%)		0		101.59		10
p) AC pads & other Flatwork		0		63		
q) Other (Pool coping & Retaining Walls)		0		224.96		22
Total Site Impervious Coverage (sum TBC + I thru q)		1926.31				
r) Pool		1920.31		937.5 131.86		286 13
,		-		131.00		13
s) Spa		0		0		
Building Coverage Calculation	Exis	sting			Тс	otal
Existing Building Coverage		24%				

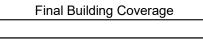

#### mpervious Coverage Calculation

Final Impervious Coverage

Existing Impervious Coverage	32%	


CONCRETE

EXISTING ASPHALT TO REMAIN

LEGEND


EXISTING CONCRETE TO REMAIN 



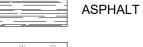


PERVIOUS PLANTINGS  $\psi \quad \psi \quad \psi$ NEW ADDITION



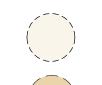





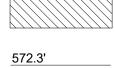

1/2 AND 1/4 CRITICAL ROOT ZONES OF PROTECTED TREES GRAVEL

CRITICAL ROOT ZONES OF PROTECTED TREES

AREA TO BE REMODELED

EXISTING BUILDING TO REMAIN

# AREA TO BE MULCHED


NEW TOPO LINE

<u>572.3'</u> \_\_\_\_ EXISTING TOPO


	GENERAL NOTES		-	4 MAY 202	23
		PRO	JECT NUMBER:	20222	:1
	ALL CONSTRUCTION SHALL COMPLY WITH THE CURRENT ADOPTED EDITION OF THE IRC INCLUDING ALL CURRENT LOCAL AMENDMENTS. WIND, SEISMIC AND THERMAL ENVELOPE REQUIREMENTS SHALL BE DETERMINED BASED ON SPECIFIC PROJECT LOCATION.		WN BY: CKED BY:	ZW DD	
•	PROVIDE SAFETY GLAZING IN DOORS AND WINDOWS IN				
	COMPLIANCE WITH IRC SECTION 308. GUARDRAILS AND WINDOW FALL PROTECTION SHALL BE IN	REV	ISIONS:		
	COMPLIANCE WITH IRC SECTION 312. PROVIDE FIRE SPRINKLERS IN COMPLIANCE WITH IRC SECTION 313.	NO	REFERENCE	ISSUE	D
	PROVIDE SMOKE DETECTORS IN AND OUTSIDE ALL BEDROOMS AND SLEEPING AREAS IN COMPLIANCE WITH IRC PER SECTION 314. MOUNT PER MANUFACTUER'S RECOMMENDATION.				
•	CARBON MONOXIDE ALARMS SHALL BE INSTALLED OUTSIDE SLEEPING ROOMS AND IN COMPLIANCE WITH IRC SECTION 315. mOUNT PER MANUFACTURES' RECOMMENDATION.				
	PROVIDE ATTIC ACCESS PULL DOWN LADDER AT EACH ATTIC SPACE. PROVIDE A MIN 30" SPACE CENTERED ON WATER CLOSETS AT ALL LOCATIONS UNLESS NOTED TO BE MORE. PROVIDE A MINIMUM OF 21" IN FRONT OF WATER CLOSETS.				
0	PROVIDE DRAFT BLOCKING BETWEEN FLOORS, BETWEEN FLOORS AND ATTIC, HORIZONTALLY AT 10' MAX INCREMENTS AND AS REQUIRED BY IRC SECTION 302.11.				
	SITE PLAN NOTES				
	EXISTINGS CONDITIONS ARE BASED ON SURVEY PERFORMED BY PREMIER SURVEYING LLC DATED 11/14/22, VISUAL INSPECTION AND OWNER PROVIDED INFORMATION. VERIFY EXISTING SITE CONDITIONS AND REPORT ANY DISCREPANICES BETWEEN ACTUAL FIELD CONDITIONS AND THESE PLANS PRIOR TO COMMENCING WORK. ALL NEW SIDEWALKS TO HAVE MAX 1:20 GRADE WITH CROSS SLOPE				
	TO DRAIN AT 1/4" PER FOOT AND BROOM FINISH UNLESS OTHERWISE NOTED. REFER TO SHEET G101 FOR VISITIBILITY REQUIREMENTS.				
	FIRST FLOOR ENTRANCES SHALL HAVE MAX 1/2" BEVELED THRESHOLDS. ENSURE GRADE SLOPES AWAY FROM BUILDING ALONG ENTIRE				
	PERIMETER. THE SITE PLAN SHOWS ONLY PROTECTED TREES. OTHER TREES BELOW 19" ARE SHOWN ON THE EXISTING CONDITIONS PLAN AND ARE TO REMAIN AND BE SIMILARLY PROTECTED DURING CONSTRUCTION AS REASONABLE UNLESS SPECIFICALLY LABELED TO BE DEMOVED				
	TO BE REMOVED. TREES ARE SHOWING WITH ACTUAL DIAMETER. ALL SITE AREAS WITH NO NEW LANDSCAPE OR HARDSCAPE SHALL BE RESTORED TO EXISTING CONDITION. FRONT YARD IMPERVIOUS COVER =				
	TREE PROTECTION NOTES	TH	NOT FOR CONSTRU THIS DOCUMENT IS RELE HE PURPOSE OF INTERIN IS INCOMPLETE AND MA	ASED FOR I REVIEW. IT	
	BEFORE CONSTRUCTION	U	SED FOR REGULATORY PERMIT, OR CONSTRU		
	ALL TREES AND NATURAL AREAS SHOWN ON PLAN TO BE PRESERVED SHALL BE PROTECTED PER ECM 3.6.1. TREE PROTECTION SHALL BE INSTALLED PRIOR TO THE START OF ANY SITE WORK, INCLUDING DEMOLITION OR SITE PREPARATION.	TE	DONNA CARTE EXAS REGISTRATION NU		
3	REFER TO ECM 3.6.1.A. FENCING FOR TREE PROTECTION SHALL BE CHAIN-LINK MESH WITH A MINIMUM HEIGHT OF 5 FEET AND SHALL BE INSTALLED AROUND OR BEYOND THE CRITICAL ROOT ZONE EXCEPT AS ALLOWED IN ECM		Z S E	19 NG	
	3.6.1.B.4. UNFENCED SECTIONS OF THE CRITICAL ROOT ZONE SHALL BE COVERED WITH MULCH AT A MINIMUM DEPTH OF 8 INCHES AND A MAXIMUM DEPTH OF 12 INCHES PER ECM 3.6.1.C.		SIGI T E	476.18 PLANNI	
	WHERE FENCING IS LOCATED 5 FEET OR LESS FROM THE TRUNK OF A PRESERVED TREE, TRUNK WRAPPING SHALL BE INSTALLED PER ECM 3.6.1.D.		DE S <sup>N TH</sup>	F)512. VTION •	
6	EROSION AND SEDIMENTATION CONTROLS SHALL BE INSTALLED AND MAINTAINED SO AS NOT TO CAUSE IMPACTS THAT EXCEED PRESERVATION CRITERIA LISTED IN ECM 3.5.3.D. DURING CONSTRUCTION		C -	2 ( RESERV/	
.1	TREES APPROVED FOR REMOVAL SHALL BE REMOVED IN A MANNER THAT DOES NOT EXCEED PRESERVATION CRITERIA FOR THE TREES TO REMAIN. REFER TO ECM 3.5.2 A.		ST O	6.181 IRE • P	
.2	FENCING MAY NOT BE TEMPORARILY MOVED OR REMOVED DURING DEVELOPMENT WITHOUT PRIOR AUTHORIZATION. THE FENCED CRITICAL ROOT ZONE SHALL NOT BE USED FOR TOOL OR MATERIAL STORAGE OF ANY KIND AND SHALL BE KEPT FREE OF LITTER. REFER		S S S	512.47 CHITECTL	
	TO ECM 3.6.1.B.3. PRUNING SHALL BE IN COMPLIANCE WITH THE CURRENT ANSI A300 STANDARD FOR TREE CARE.		$O \triangleleft \mathbb{I}_{2}^{2} \lor O$	(P) AR(	
1	AFTER CONSTRUCTION TREE PROTECTION SHALL BE REMOVED AT THE END OF THE PROJECT AFTER ALL CONSTRUCTION AND FINAL GRADING IS COMPLETE, BUT BEFORE FINAL INSPECTION. REFER TO ECM 3.6.1.A.				
	LANDSCAPE INSTALLATION WITHIN THE CRZ OF PRESERVED TREES, INCLUDING IRRIGATION, SOIL AND PLANTINGS, SHALL NOT EXCEED PRESERVATION CRITERIA LISTED IN ECM 3.5.2.	ENT	<b>9</b>	I	
	DOCUMENTATION OF TREE WORK PERFORMED MUST BE PROVIDED TO INSPECTOR PER ECM APPENDIX P-6. THIS LIST IS NOT EXHAUSTIVE. REFER TO APPROPRIATE ECM SECTIONS FOR FULL REQUIREMENTS.	DEVELOPMEN	LAN	AVE	AUSTIN. TEXAS 78703
		VEL	GHI DFI		LEXAS

١W	N BY:	ZWR
ECł	KED BY:	DDC
/IS	IONS:	
	REFERENCE	ISSUED

# REFERENCE ISSUED

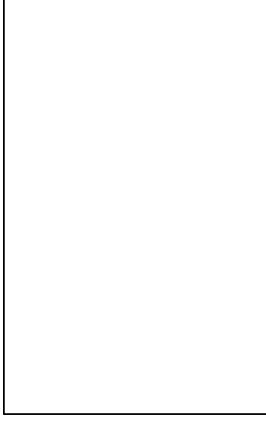

# PRELIMINARY IOT FOR CONSTRUCTION

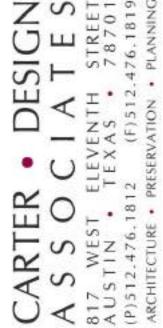





NP Z

32'

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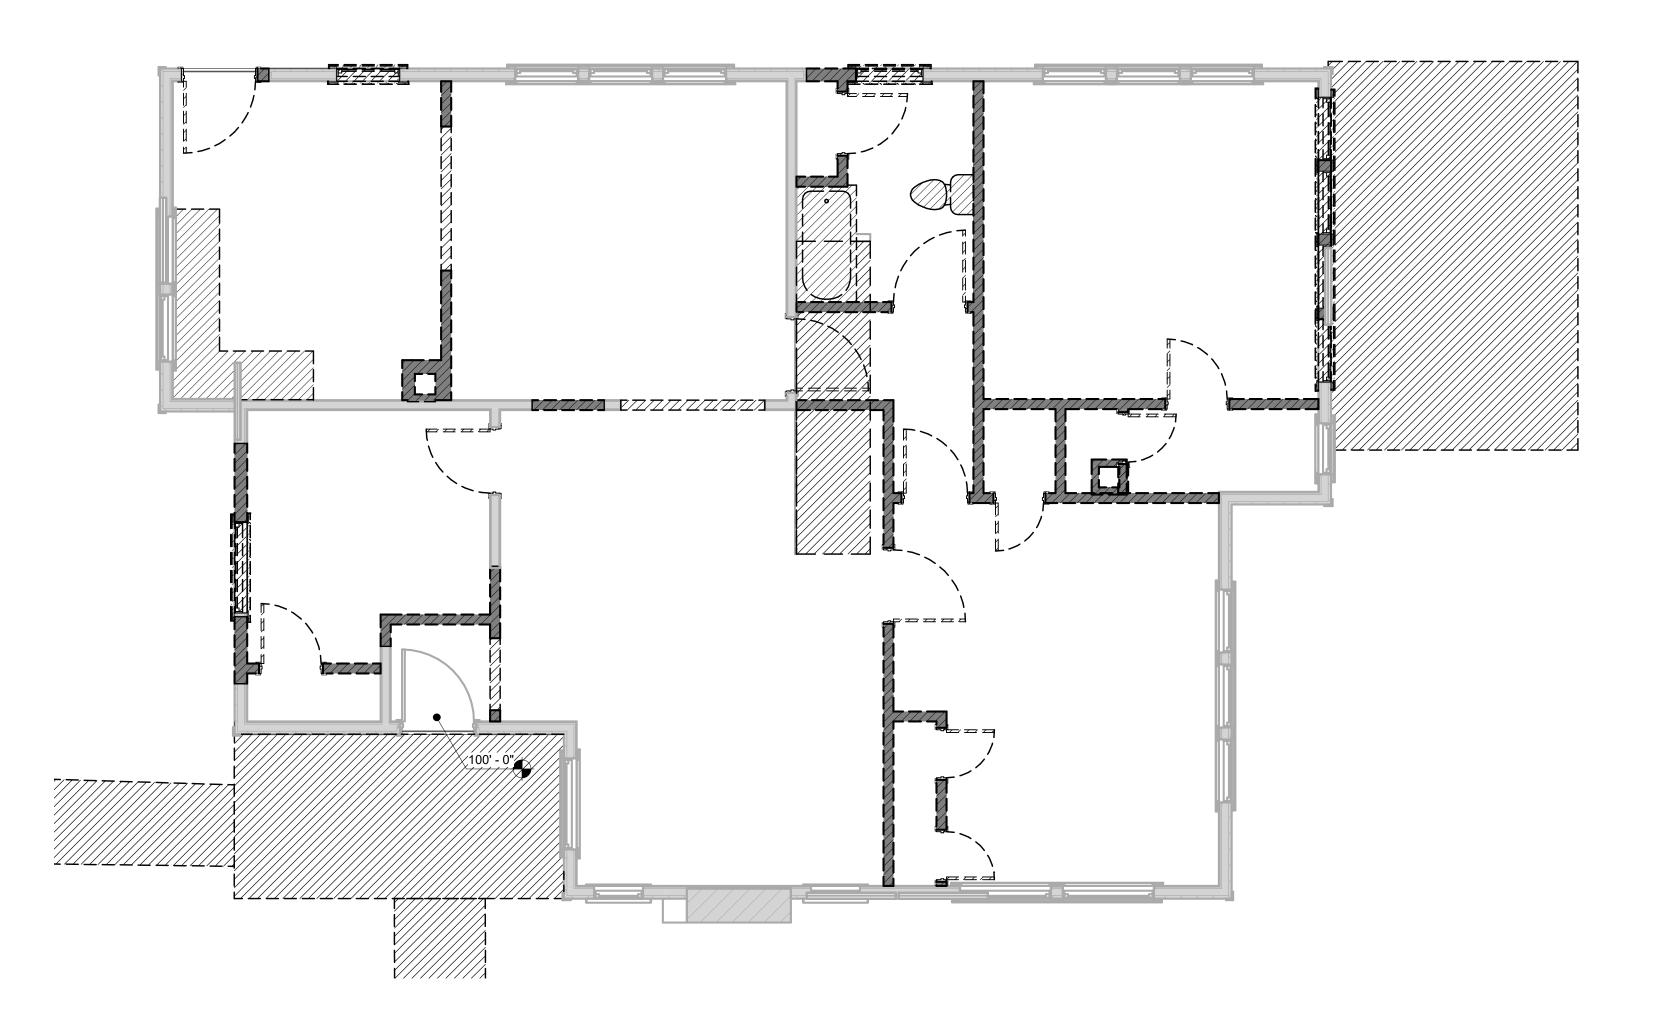
16'

 T-002
 19" POST OAK

 T-003
 13" ELM

 T-004
 17" PECAN

 T-005
 11" PECAN




GROUND LEVEL - DEMO PLAN1/4" = 1'-0"

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ISSUE DATE:	04	MAY 2023
PROJECT NUMBER	<b>?</b> :	202221
DRAWN BY:		ZWR
CHECKED BY:		DDC

#### **REVISIONS:**


NO	REFERENCE	ISSUED

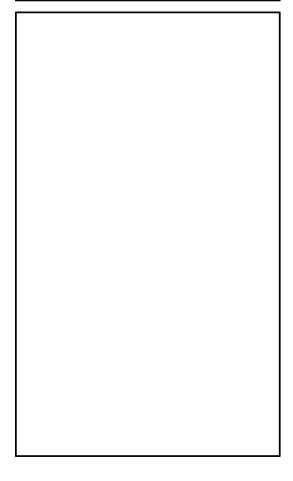

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DONNA CARTER TEXAS REGISTRATION NUMBER #8207



605 HIGHLAND RESIDENCE

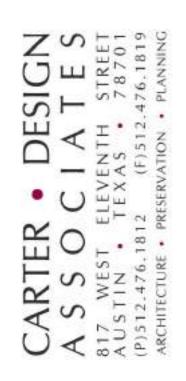DESIGN DEVELOPMEN

NUT

16'


0' 2' 4'

8'



GROUND LEVEL -DEMO PLAN



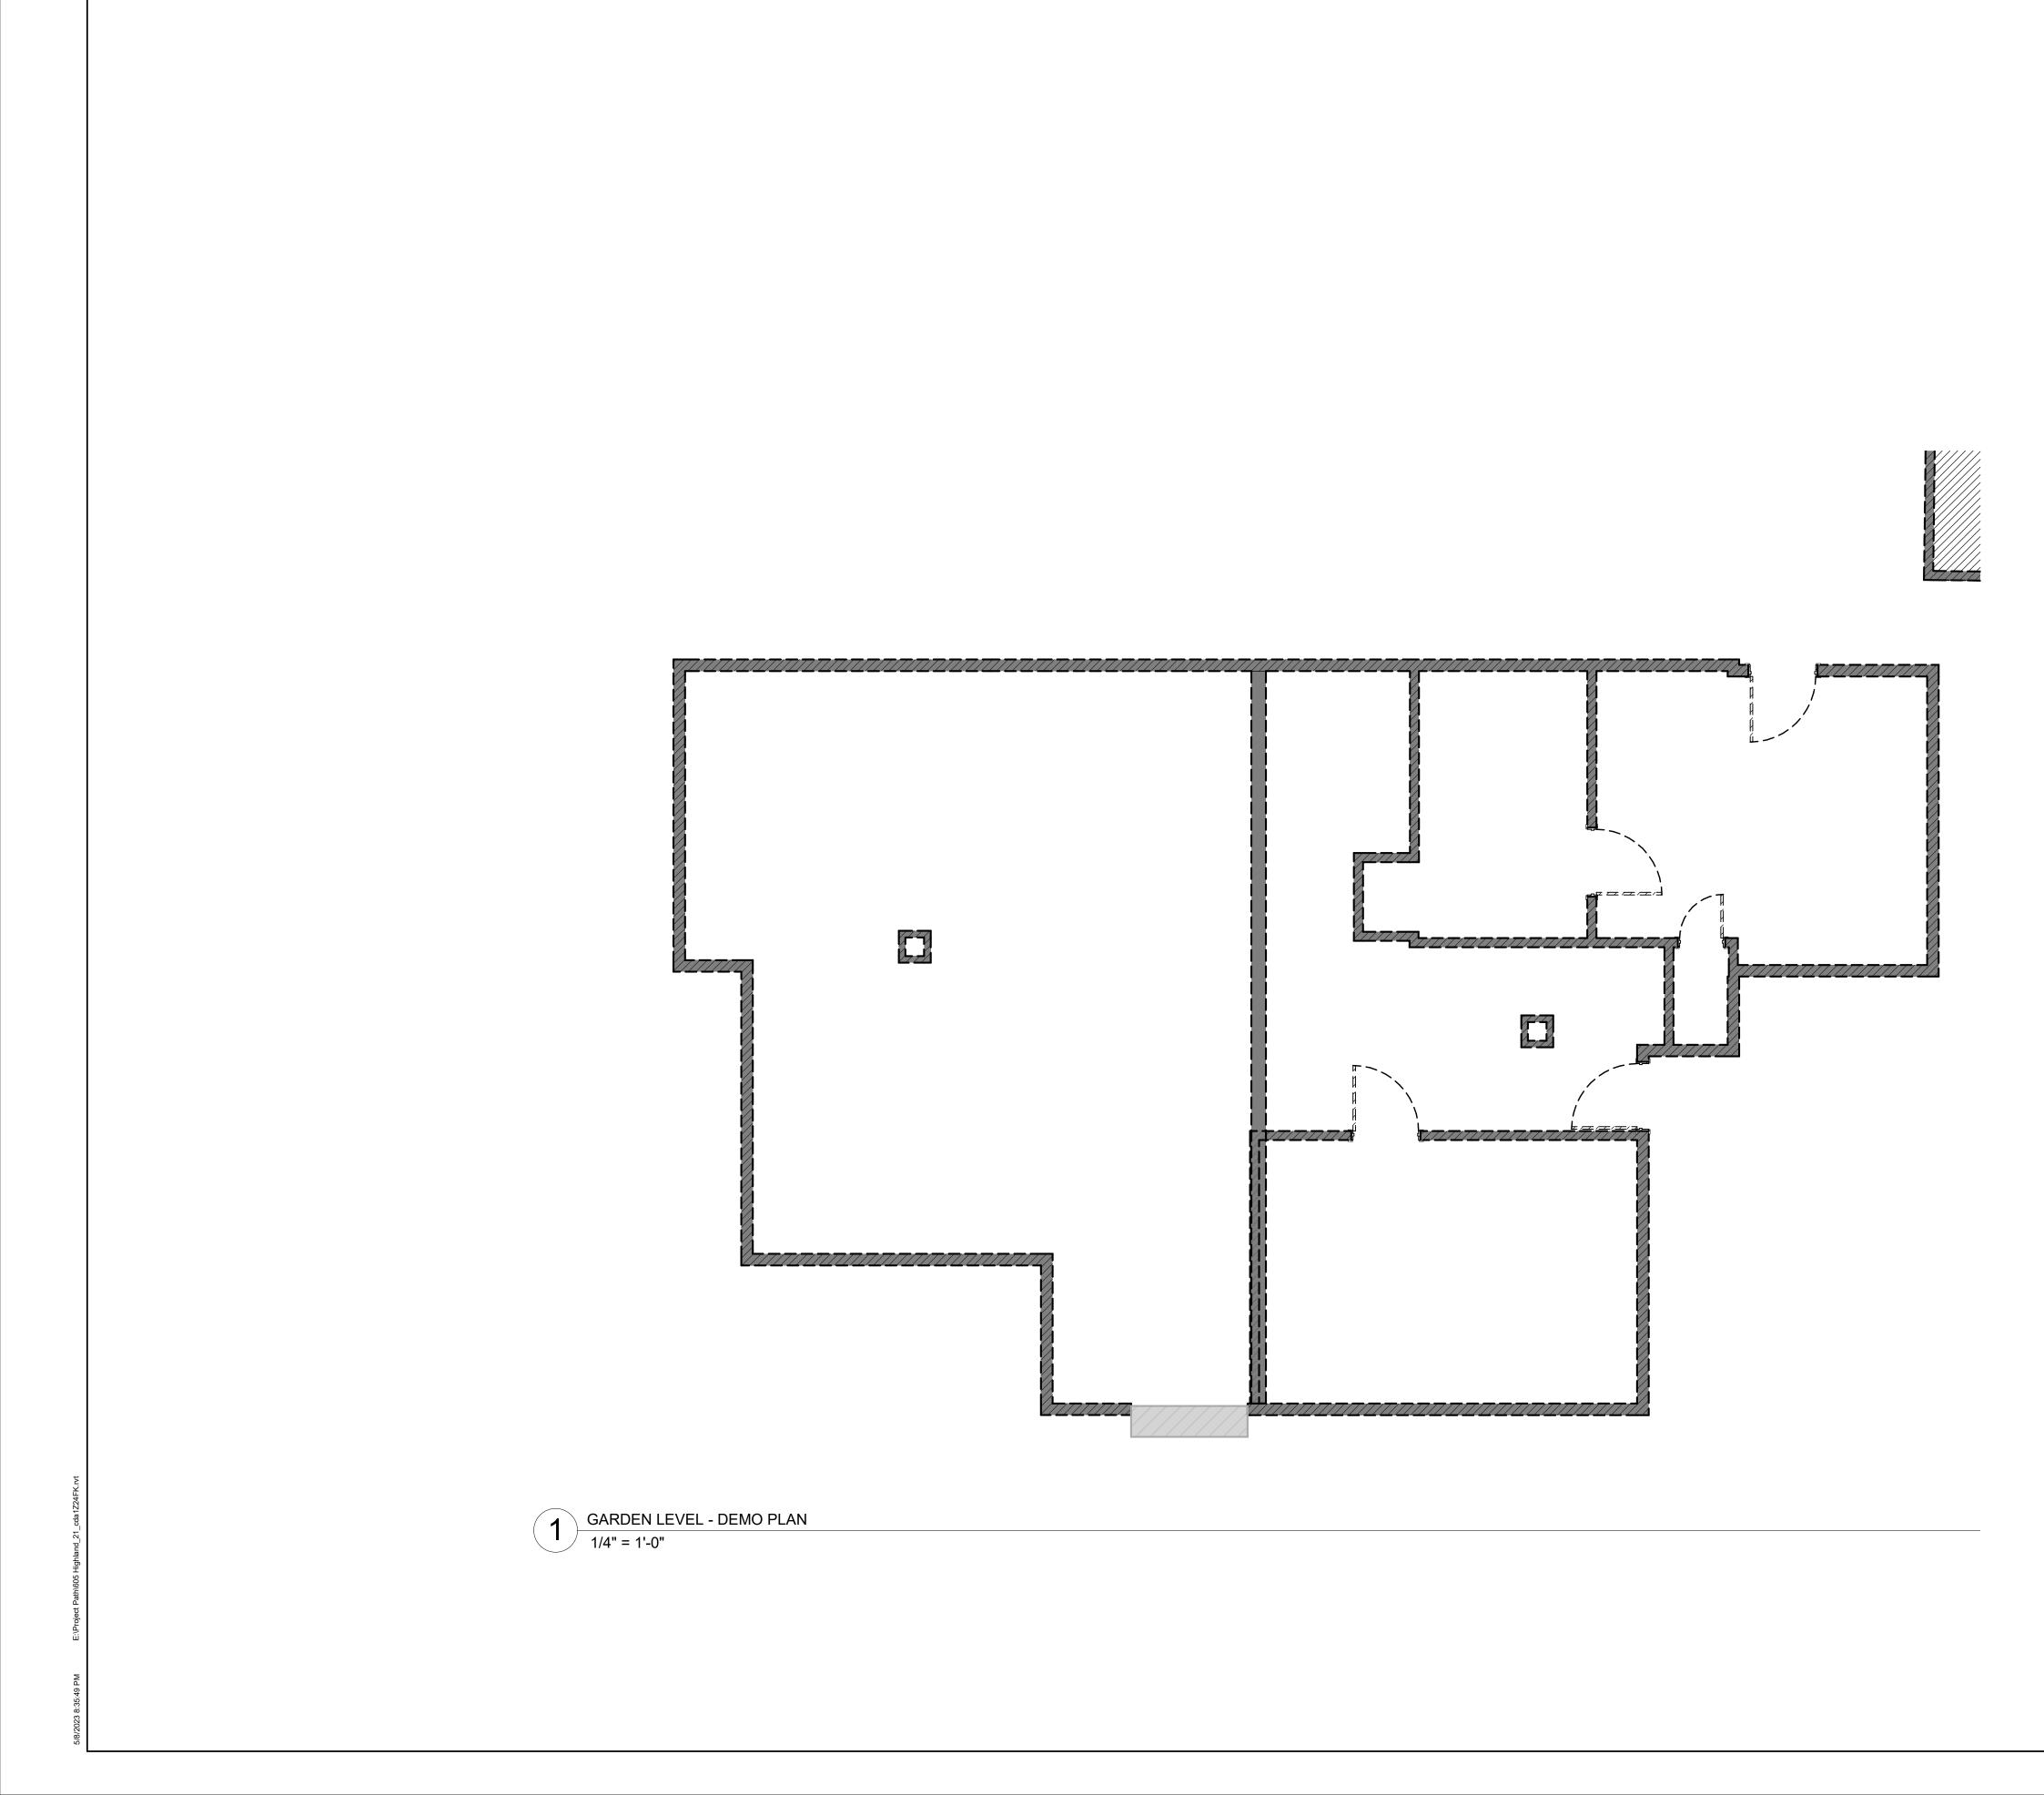


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ISSUE DATE:	04 MAY 2023
PROJECT NUMBER	R: 202221
DRAWN BY:	ZWR
CHECKED BY:	DDC

#### **REVISIONS:**


NO	REFERENCE	ISSUED

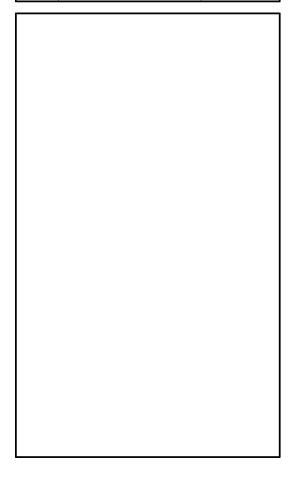

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DONNA CARTER TEXAS REGISTRATION NUMBER #8207



605 HIGHLAND RESIDENCE

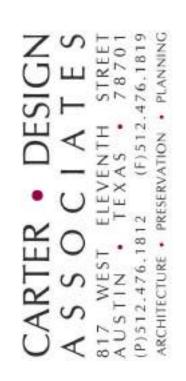HIGHLAND TIN, TEXAS


DESIGN DEVELOPMEN

NPI

16'

0' 2' 4'



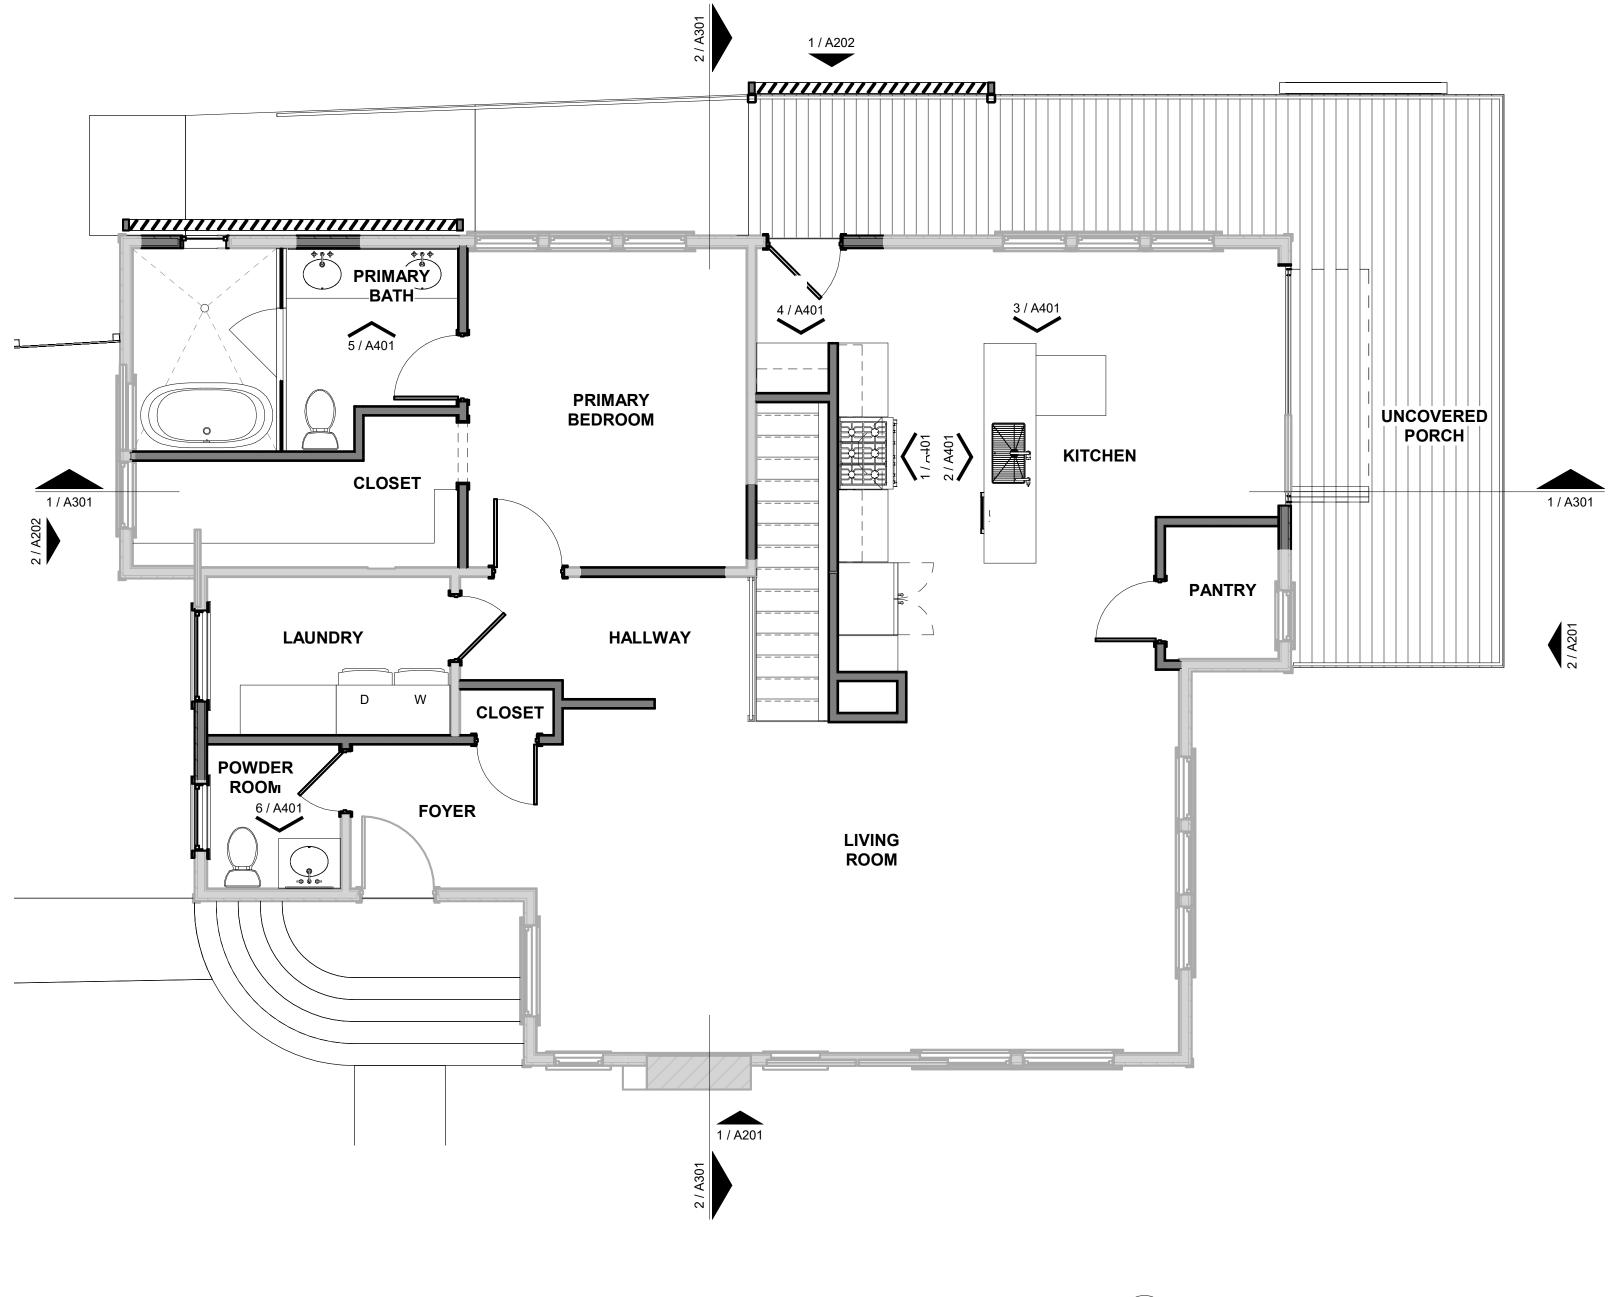

**GROUND L** 1/4" = 1'-0" **GROUND LEVEL - ANNOTATION PLAN** 

#### GENERAL NOTES

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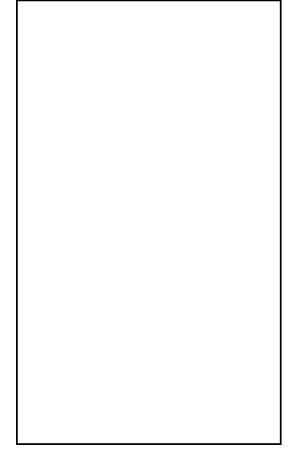
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ISSUE DATE:	04 MAY 2023
PROJECT NUMBER	R: <b>202221</b>
DRAWN BY:	ZWR
CHECKED BY:	DDC

#### **REVISIONS:**


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DONNA CARTER **TEXAS REGISTRATION NUMBER #8207** 




л И Ш 605 HIGHLAND RESIDENCE 0 SIGN DEVEL ш Copyright Carter Design Associates, **GROUND LEVEL -**

**ANNOTATION PLAN** 

LEGEND ELECTRIC SERVICE METER / WEATHERHEAD GAS METER GAS WH TANKLESS WATER HEATER GAS CONNECTION <u>~</u> HOSE BIB +---DOWNSPOUT WITH SPLASHBLOCK CONCRETE FINISH À · · · à · · NIL

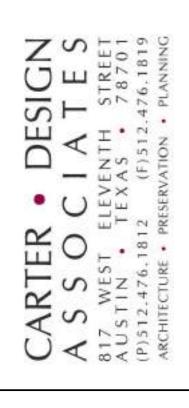16'

0' 2' 4'

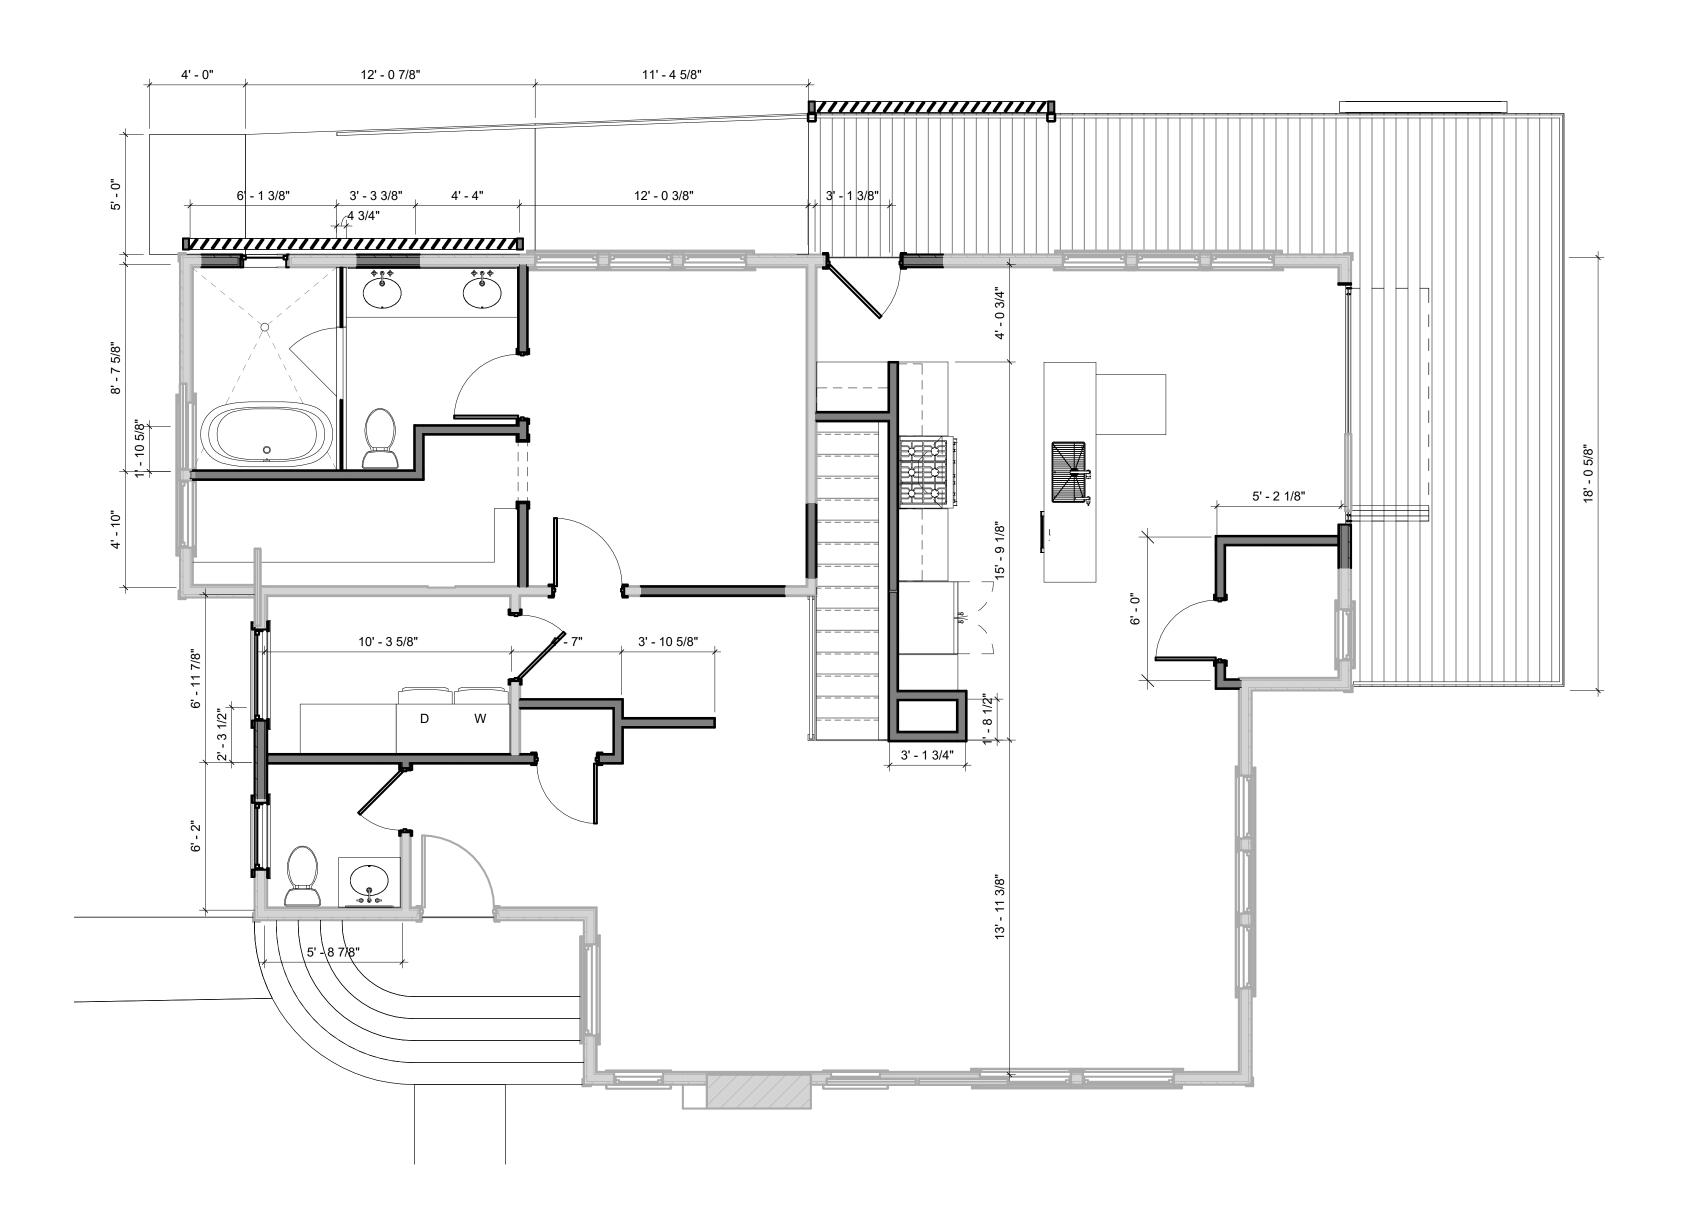

**GROUND LEVEL - DIMENSION PLAN** 1

1/4" = 1'-0"

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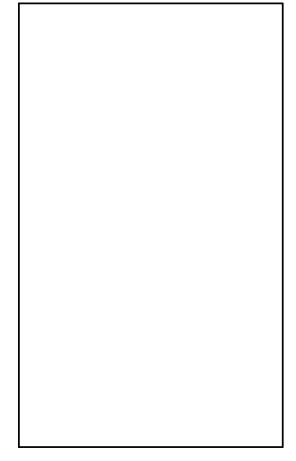
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ISSUE DATE:	04 MAY 2023
PROJECT NUMBER	R: <b>202221</b>
DRAWN BY:	ZWR
CHECKED BY:	DDC

#### **REVISIONS:**


NO	REFERENCE	ISSUED



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DONNA CARTER **TEXAS REGISTRATION NUMBER #8207** 



# **GROUND LEVEL -DIMENSION PLAN**

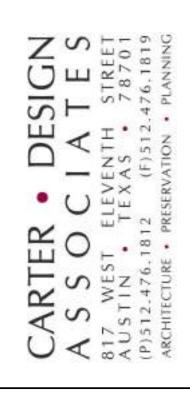605 HIGHLAND RESIDENCE

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ESIGN DEVELOPM


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16'

l **1** 0' 2' 4'





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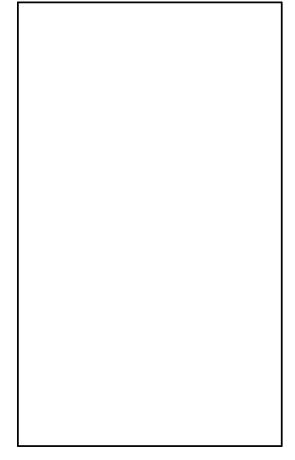
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ISSUE DATE:	04 MAY 2023
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DRAWN BY:	ZWR
CHECKED BY:	DDC
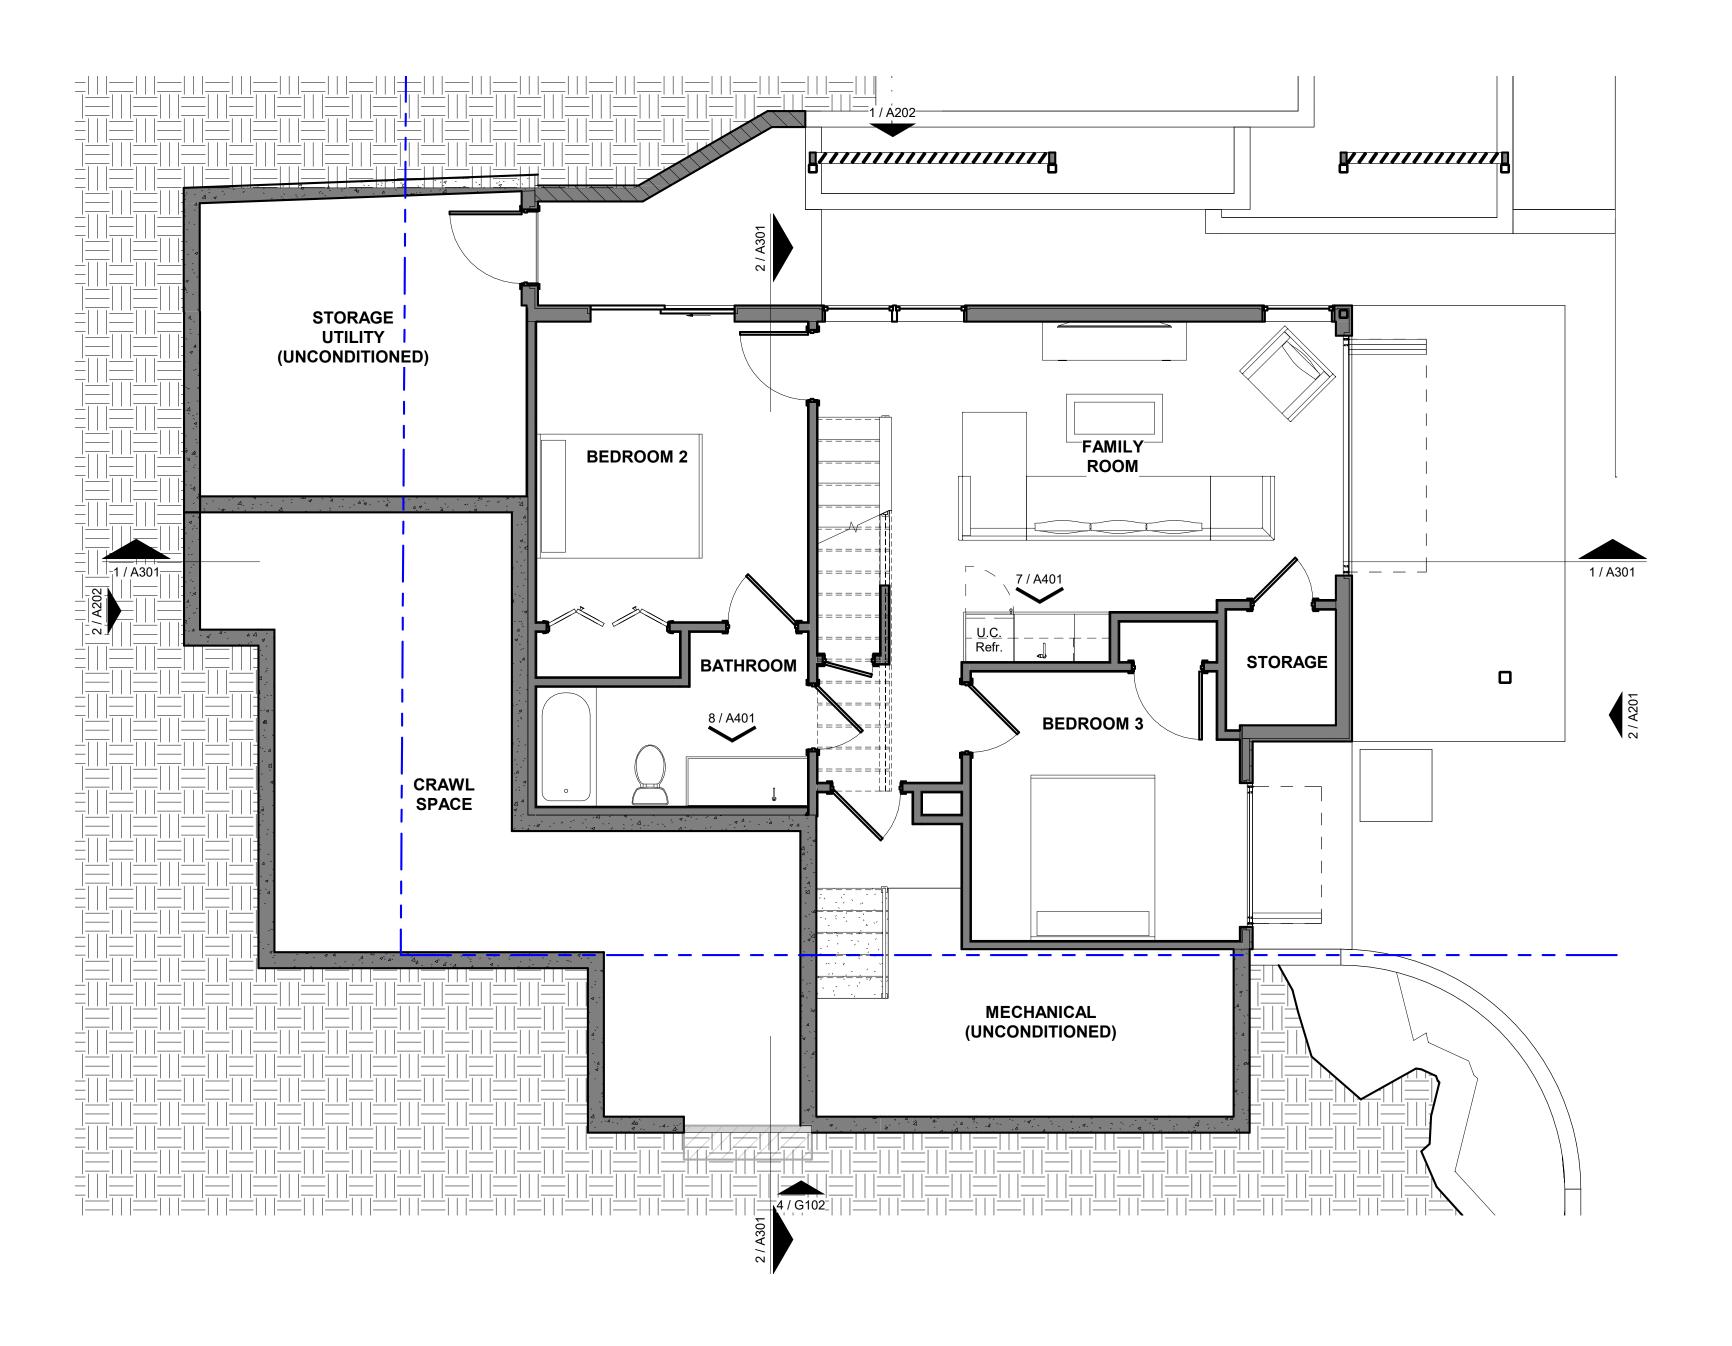
#### **REVISIONS:**


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605 HIGHLAND RESIDENCE

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**GARDEN LEVEL -**

**ANNOTATION PLAN** 

A103

SIGN DEVELOPMEN
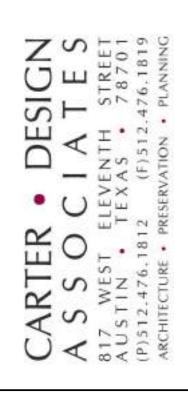
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NV Z

16'



LEGEND

GAS

0' 2' 4'

GARDEN LEVEL - ANNOTATION PLAN


1/4" = 1'-0"

GAS METER WH TANKLESS WATER HEATER GAS CONNECTION <u>~</u> +---HOSE BIB

DOWNSPOUT WITH SPLASHBLOCK

8'

CONCRETE FINISH

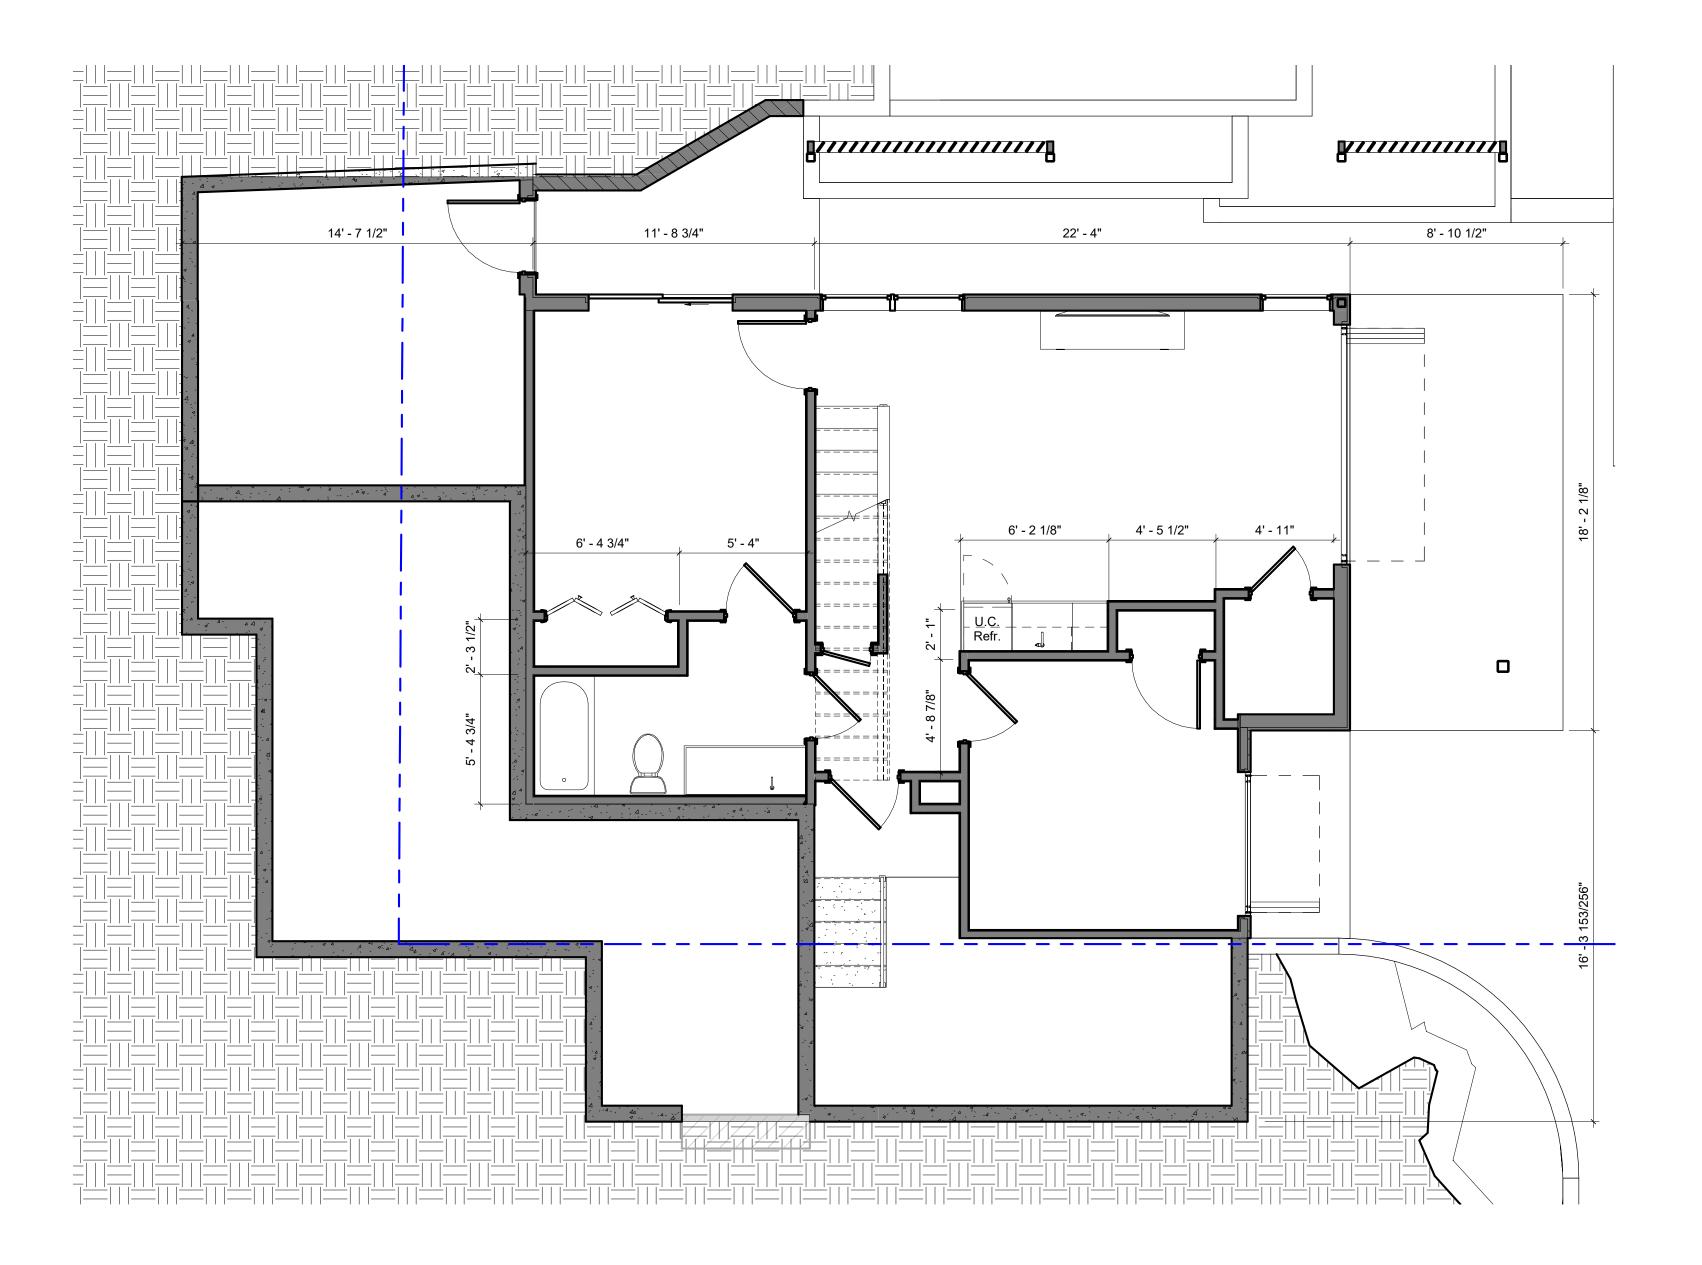

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- DETERMINED BASED ON SPECIFIC PROJECT LOCATION.
- 3. PROVIDE SAFETY GLAZING IN DOORS AND WINDOWS IN COMPLIANCE WITH IRC SECTION 308.
- 4. GUARDRAILS AND WINDOW FALL PROTECTION SHALL BE IN
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- 7. CARBON MONOXIDE ALARMS SHALL BE INSTALLED OUTSIDE SLEEPING ROOMS AND IN COMPLIANCE WITH IRC SECTION 315. mOUNT PER MANUFACTURES' RECOMMENDATION.
- 8. PROVIDE ATTIC ACCESS PULL DOWN LADDER AT EACH ATTIC SPACE. 9. PROVIDE A MIN 30" SPACE CENTERED ON WATER CLOSETS AT ALL LOCATIONS UNLESS NOTED TO BE MORE. PROVIDE A MINIMUM OF
- 21" IN FRONT OF WATER CLOSETS. 10 PROVIDE DRAFT BLOCKING BETWEEN FLOORS, BETWEEN FLOORS AND ATTIC, HORIZONTALLY AT 10' MAX INCREMENTS AND AS REQUIRED BY IRC SECTION 302.11.


#### GENERAL NOTES - FLOOR PLAN

- 1. DO NOT SCALE DRAWINGS. WRITTEN DIMENSIONS GOVERN. 2. ALL DIMENSIONS ARE TO FACE OF STUD OR FACE OF MASONRY, UNLESS OTHERWISE NOTED.
- 3. ALL EXTERIOR WALL PARTITIONS ARE 2 x 6 WOOD STUDS WITH 5/8" GYPSUM BOARD AT INTERIOR FACE, AND EXTERIOR ENVELOPE REQUIREMENTS PER IRC AND LOCAL AMENDMENTS AND EXTERIOR FINISH UNLESS OTHERWISE NOTED.
- 4. ALL EXTERIOR SIDING, PANELS, PLASTER AND STUCCO SHALL BE INSTALLED AS A RAINSCREEN SYTEM UNLESS SPECIFICALLY NOTED OTHERWISE.
- 5. ALL INTERIOR WALL PARTITIONS ARE 2 x 4 WOOD STUDS WITH SOUND BATT INSULATION AND 5/8" GYPSUM BOARD UNLESS OTHERWISE NOTED.
- 6. REFER TO SLAB PLAN FOR LAYOUT DIMENSIONS.
- 7. REFER TO STRUCTURAL SHEETS FOR FOUNDATION AND FRAMING. 8. COORDINATE ALL KITCHEN AND BATHROOM DIMENSIONS AND UTILITY REQUIREMENTS WITH OWNER'S SPECIFIC CHOICES OF FIXTURES, APPLIANCES AND CABINETS.
- 9. FIRST FLOOR ENTRANCES SHALL HAVE MAX 1/2" BEVELED THRESHOLD.
- 10. PROVIDE 2 x 6 BLOCKING AT CENTER LINE OF 34" AFF AT WALLS IN SHOWERS, BATHTUBS AND ADJACENT TO WATERCLOSETS. 11. ALL PORCH AND BALCONY FLOORS SHALL SLOPE TO DRAIN AWAY
- FROM BUILDING. 12. COORDINATE ALL FINAL OWNER CHOSEN FLOOR FINISHES WITH CONCRETE SLAB PRIOR TO PLACEMENT FOR CONINUOUS FLOOR LEVEL.

ISSUE DATE:	04 MAY 2023
PROJECT NUMBEI	R: <b>202221</b>
DRAWN BY:	ZWR
CHECKED BY:	DDC

#### **REVISIONS:**


NO	REFERENCE	ISSUED

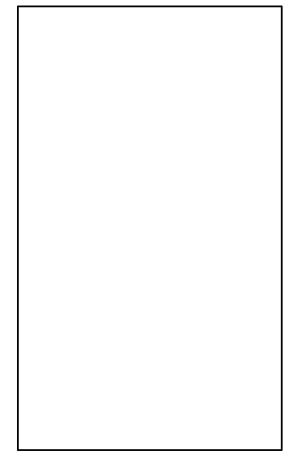

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DONNA CARTER **TEXAS REGISTRATION NUMBER #8207** 



605 HIGHLAND RESIDENCE Copyright Carter Design Associates, Inc

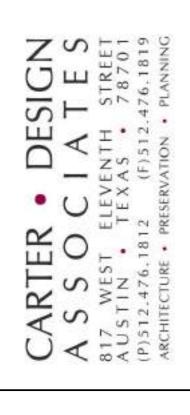**GARDEN LEVEL -**

**DIMENSION PLAN** 

A104

SIGN DEVELOPMENT

Ш 

16'

ELEC	ELECTRIC SERVICE METER / WEATHERHEAD
GAS	GAS METER
WH	TANKLESS WATER HEATER
<b>.</b>	GAS CONNECTION
+	HOSE BIB
	DOWNSPOUT WITH SPLASHBLOCK


8'


LEGEND

0' 2' 4'

GARDEN LEVEL - DIMENSION PLAN

1/4" = 1'-0"

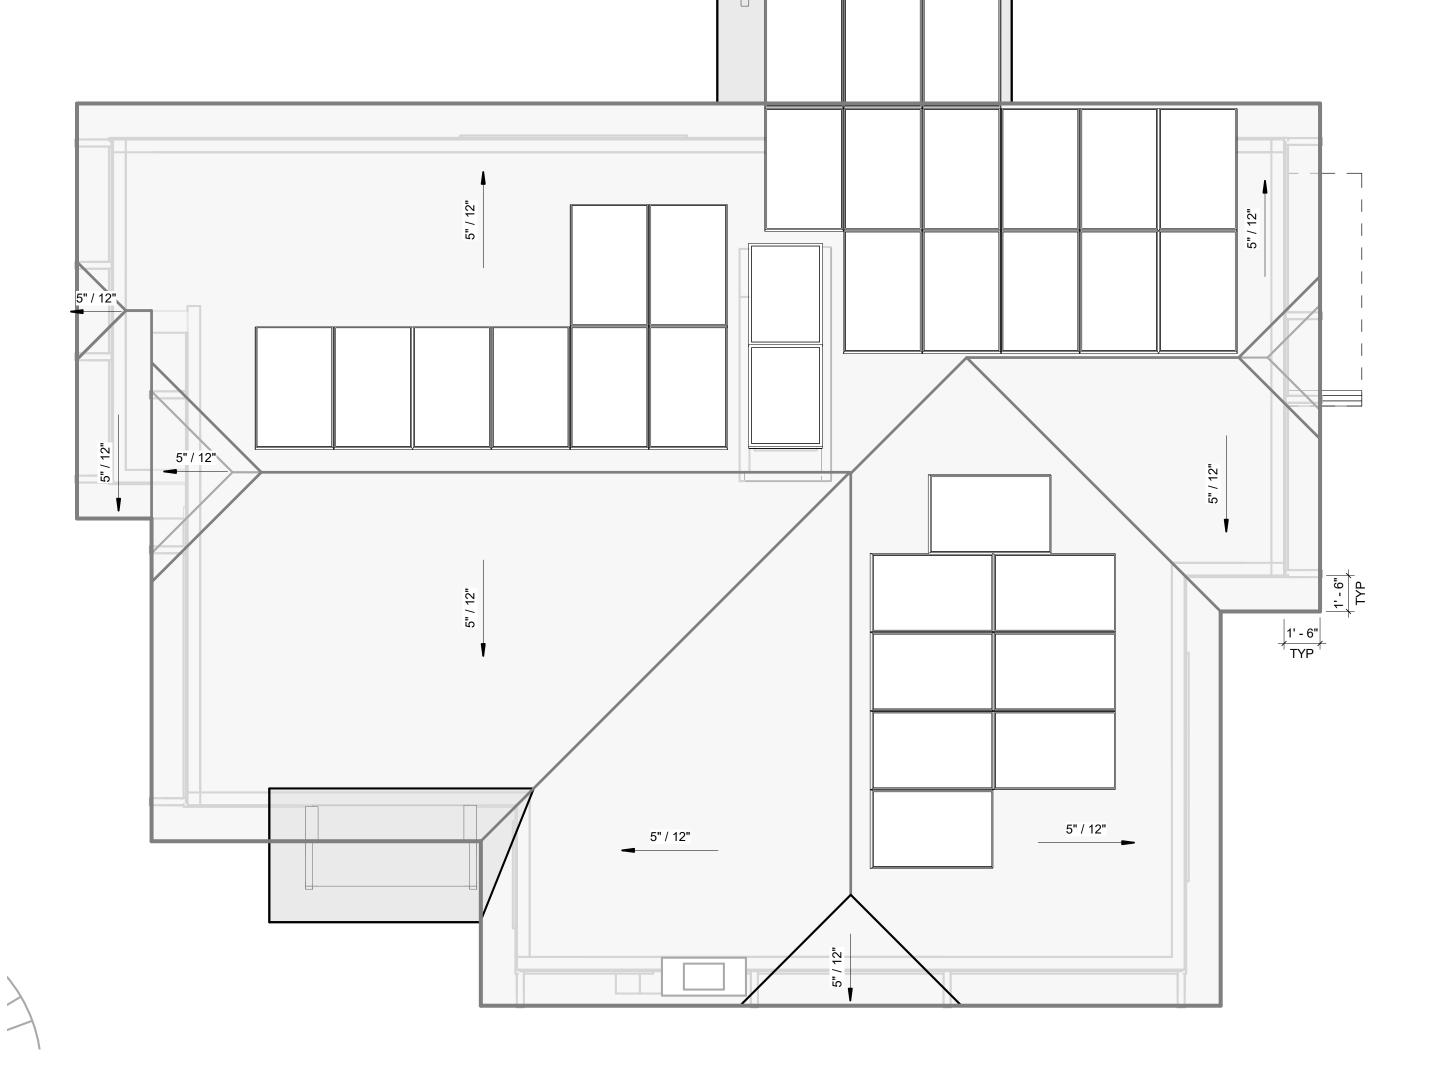

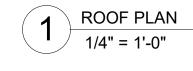

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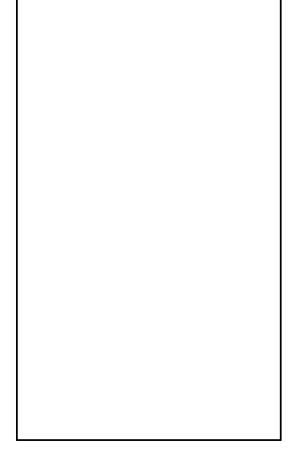
**GENERAL NOTES - ROOF** 

- 1. CONTRACTOR SHALL KEEP BUILDING WEATHER TIGHT.
- 2. ALL ROOFS SHALL SLOPE TO DRAIN.
- 3. CONTRACTOR SHALL PROVIDE ALL TRIM, FLASHING, UNDERLAYMENTS, FASTOVERS AND ACCESSORIES NECESSARY TO ENSURE A COMPLETE, WARRANTABLE, WEATHERTIGHT CONSTRUCTED ROOF.
- AT DOWNSLOPING ROOFS PROVIDE GUTTERS OVER DOORS AND NEAR DOOR APPROACHES. PROVIDE LEAVE PROTECTION AT GUTTERS NEAR TREES. SECURE ALL DOWN SPOUTS SHALL TO BUILDING, DS BOTTOM TO POINT AWAY FROM HOUSE TOWARD SPLASH BLOCK AT GRADE.

ISSUE DATE:	04 MAY 2023
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DRAWN BY:	ZWR
CHECKED BY:	DDC

#### **REVISIONS:**


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DONNA CARTER TEXAS REGISTRATION NUMBER #8207



605 HIGHLAND RESIDENCE 605 HIGHLAND AVE AUSTIN, TEXAS 78703

DESIGN DEVELOPMENT

NYI

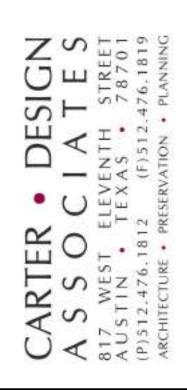16'


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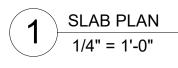
8'

ROOF PLAN

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GENERAL NOTES - SLAB LAYOUT PLAN

- 1. VERIFY ALL SLAB PENETRATION LOCATIONS WITH FLOOR PLAN DIMENSIONS, PARTITION TYPES AND EQUIPMENT
- REFER TO STRUCTURAL SHEETS FOR FOUNDATION AND FRAMING.
   FIRST FLOOR ENTRANCES SHALL HAVE MAX 1/2" BEVELED THRESHOLD. COORDINATE BLOCKOUTS AS NEEDED FOR

THRESHOLDS.

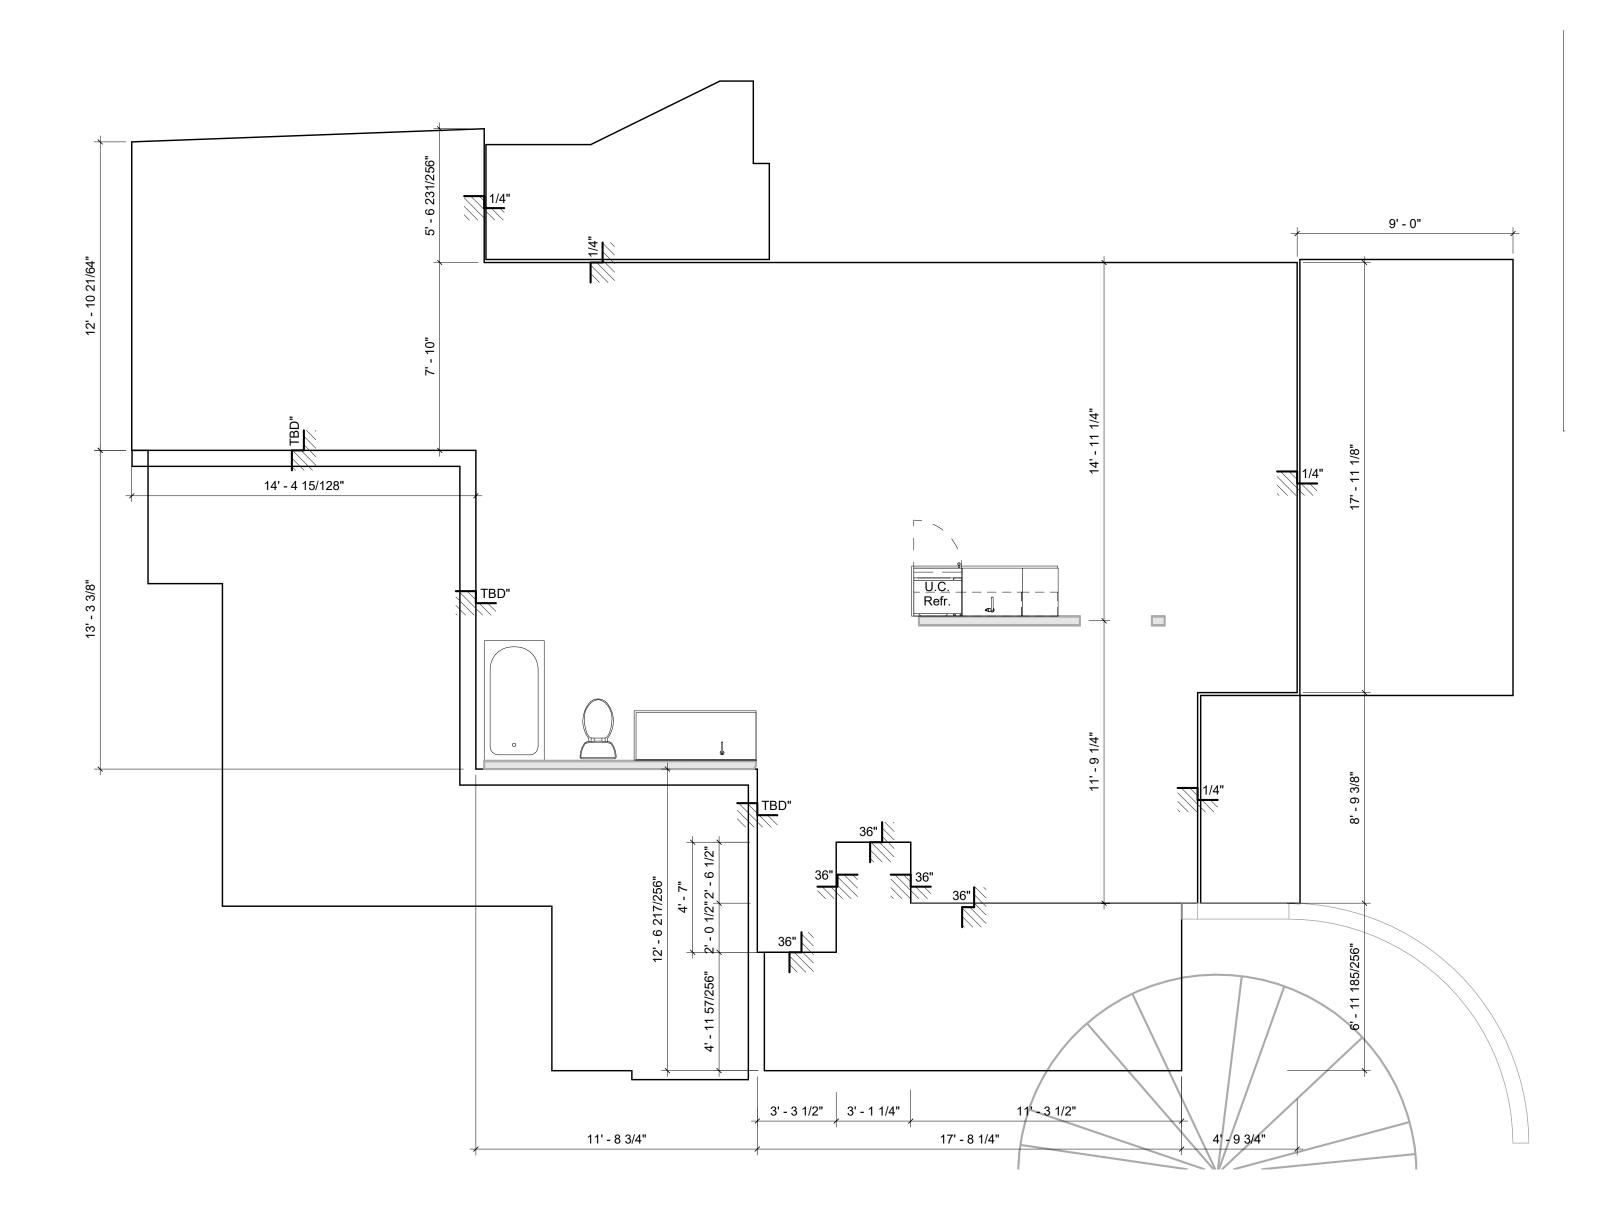
0' 2' 4'

8'

ISSUE DATE:	04 MAY 2023
PROJECT NUMBER	R: <b>202221</b>
DRAWN BY:	ZWR
CHECKED BY:	DDC

#### **REVISIONS:**


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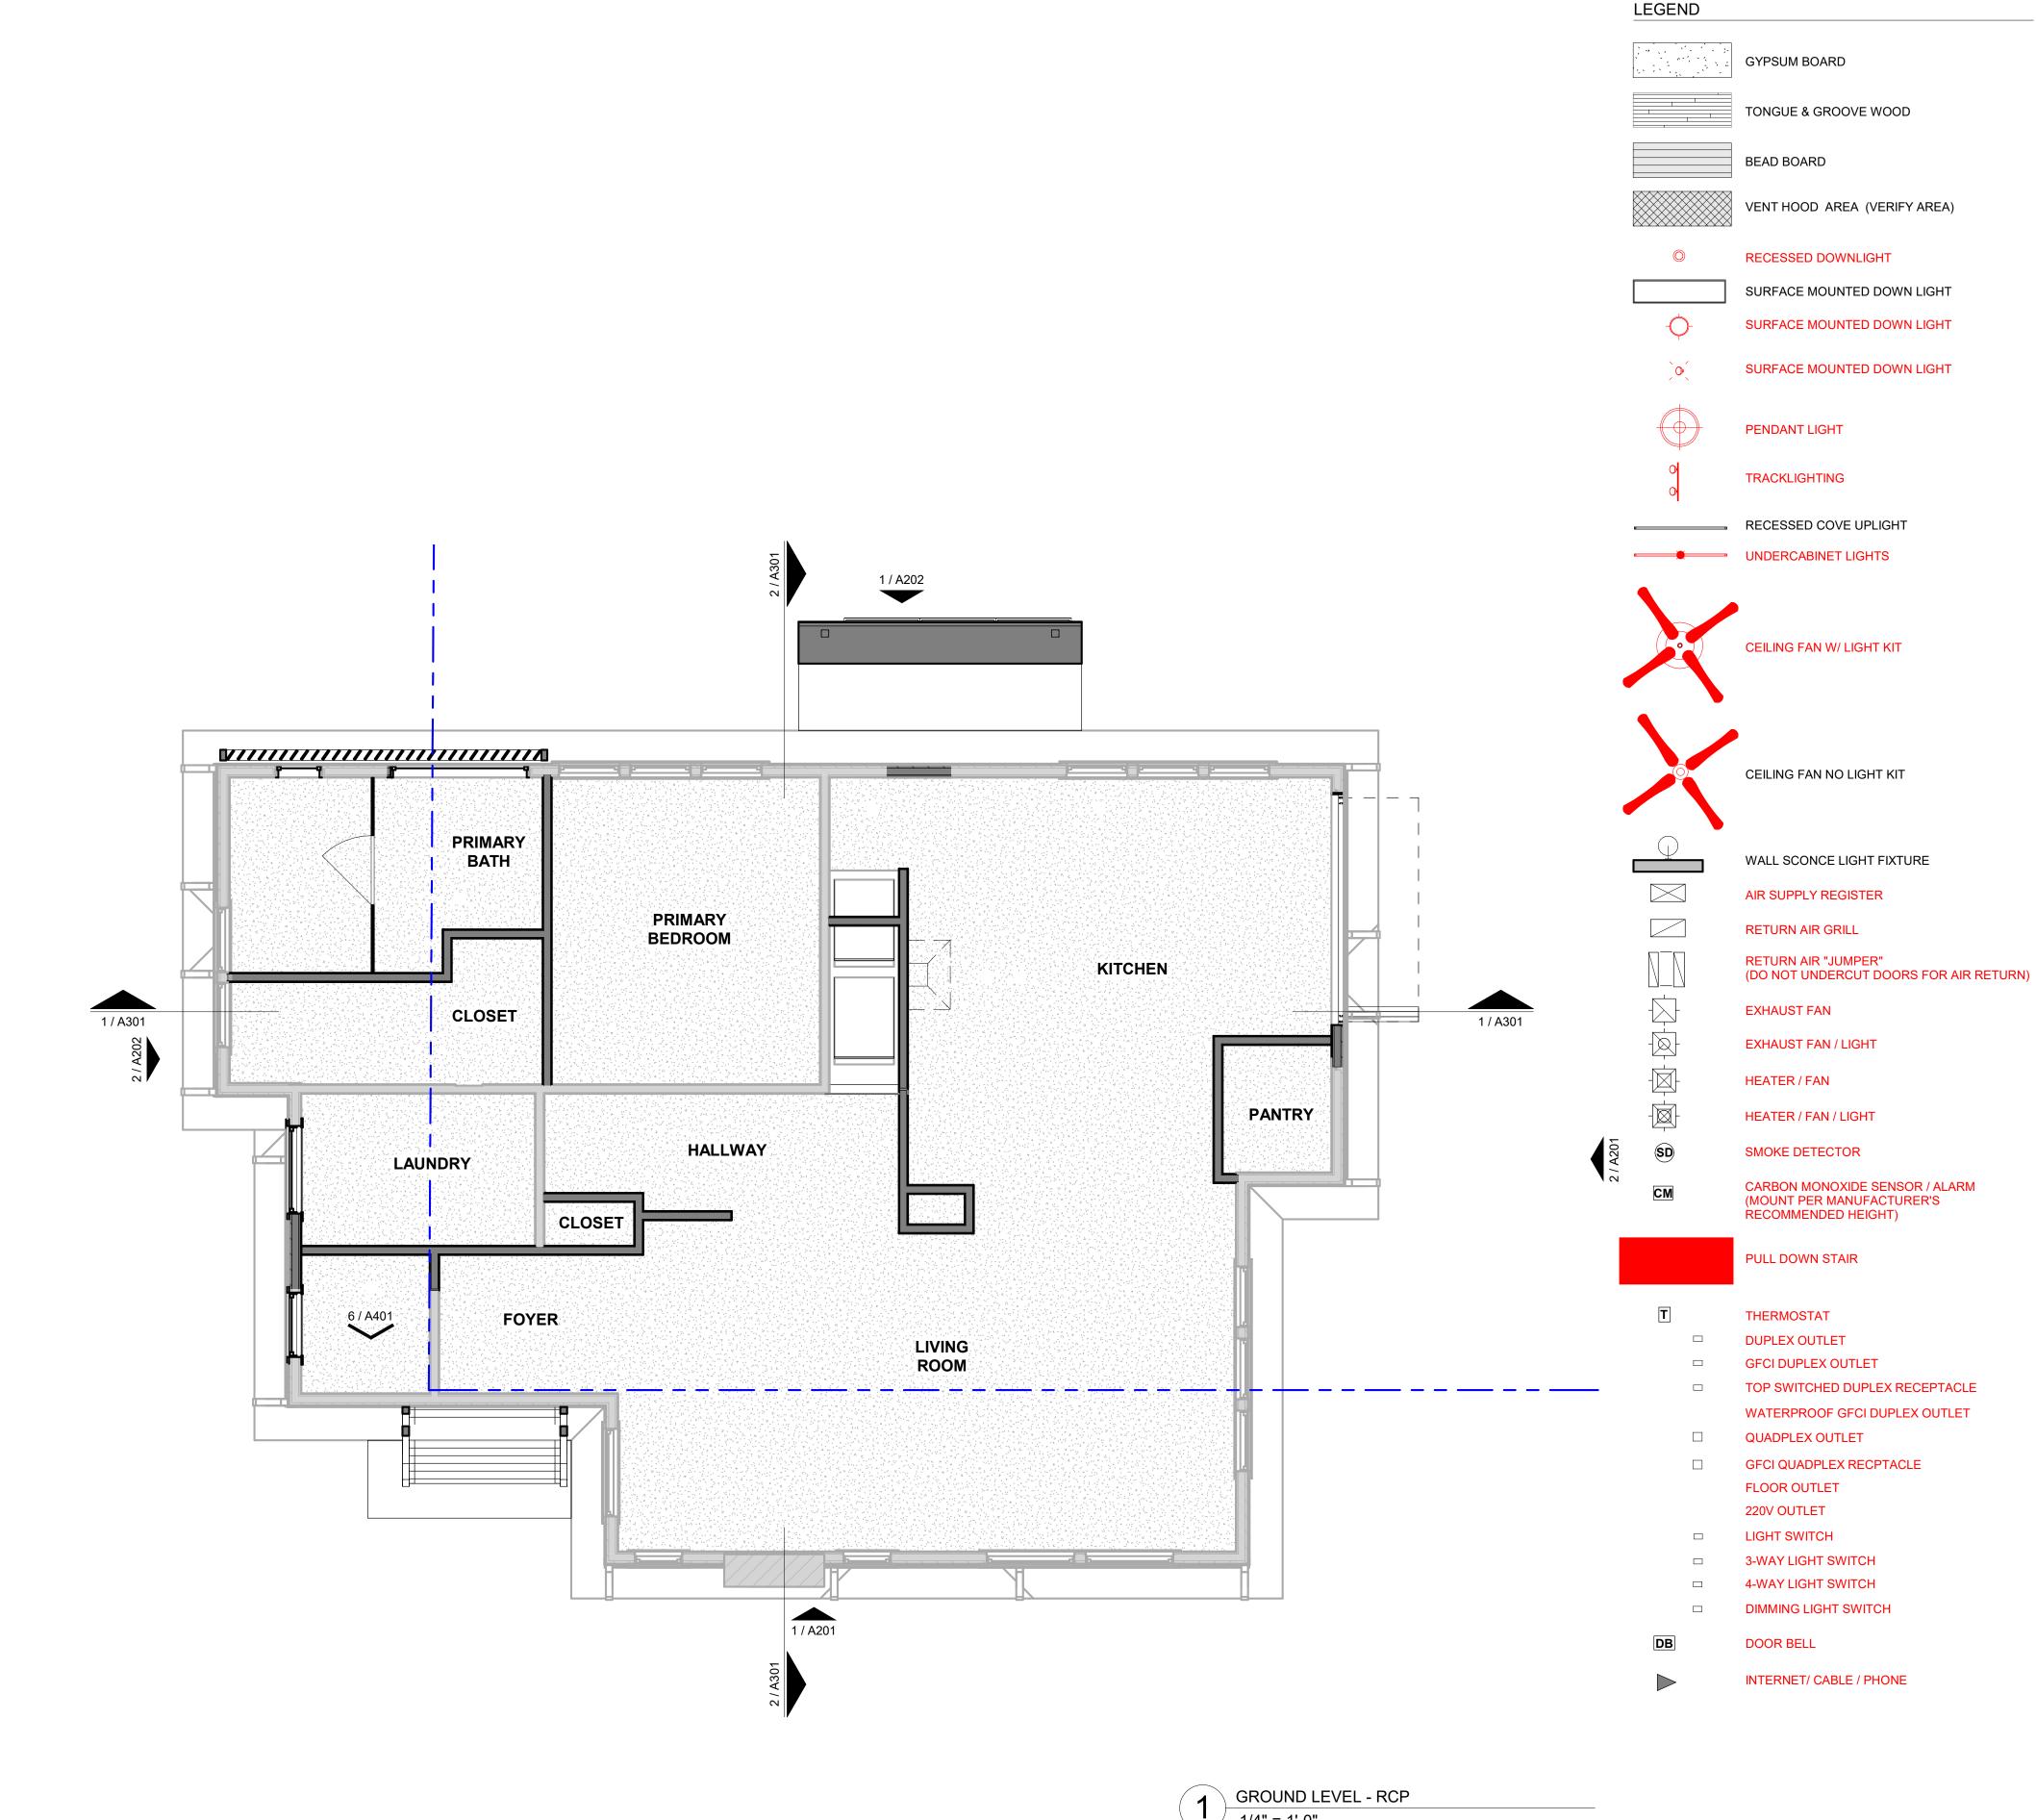
SLAB PLAN
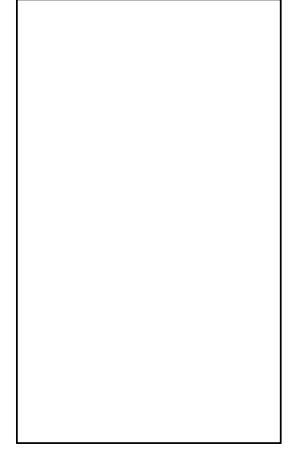
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DESIGN DEVELOPMENT

LAN PLAN





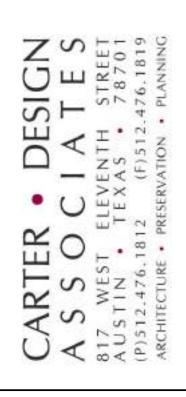

1/4" = 1'-0"

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#### **GENERAL NOTES - REFLECTED CEILING PLAN**

- 1. ALL CEILINGS TO BE 5/8" GYPSUM BOARD UNLESS NOTED
- OTHERWISE. REFER TO LIGHTING AND POWER PLAN FOR SWITCHING AND 2. FIXTURE DESIGNATIONS. IF SCHEULE IS NOT PROVIDED
- COORDINATE WITH OWNER FOR SPECIFIC FIXTURES. 3. PROVIDE ATTIC ACCESS PULL DOWN LADDER AT EACH ATTIC SPACE 4. COORDINATE CEILING HEIGHTS, FURRDOWNS AND CHASE SIZES WITH MECHANICAL TO ACCOMMODATE DUCTS PRIOR TO
- INSTALLATION. IF DISCREPENCIES MORE THAN 3" OCCUR OR CEILING DROPS BELOW 8'-0" HGT CONTACT ARCHITECT. 5. CENTER FIXTURE IN ROOM UNLESS NOTED OTHERWISE.
- 6. VERIFY CEILING HEIGHTS IN THE FIELD WHERE ATTACHED TO THE UNDERSIDE OF STRUCTURE.


GENERAL NOTES - POWER & LIGHTING PLAN

- 1. COORDINATE ALL KITCHEN AND BATHROOM DIMENSIONS AND UTILITY REQUIREMENTS WITH OWNER'S SPECIFIC CHOICES OF FIXTURES, APPLIANCES AND CABINETS.
- 2. REFER TO REFLECTED CEILING PLANS FOR FIXTURE LOCATIONS.
- 3. FURNITURE SHOWN FOR INFORMATION AND COORDINATION ONLY. IT IS NOT IN CONTRACT.
- 4. OUTLETS AND RECEPTACLES SHALL BE MOUNTED MINIMUM 15" ABOVE FINISH FLOOR.
- 5. LIGHT SWITCHED AND ENVIRONMENTAL CONTROLS SHALL BE MOUNTED 48" MAX ABOVE FINISH FLOOR.
- 6. OUTLETS AND SWITCHES SHOWN ABOVE AT COUNTERTOPS TO BE MOUNTED 6" ABOVE COUNTERTOP.
- 7. COORDINATE AND CONFIRM DATA SYSTEM, SECURITY SYSTEM AND A/V SYSTEMS WITH OWNER AND OWNER'S PROVIDER. 8. ALL LIGHTING TO HAVE NEW LAMPS.

ISSUE DATE: 04 MAY 2023 PROJECT NUMBER: 202221 DRAWN BY: ZWR CHECKED BY: DDC

#### **REVISIONS:**


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DONNA CARTER **TEXAS REGISTRATION NUMBER #8207** 

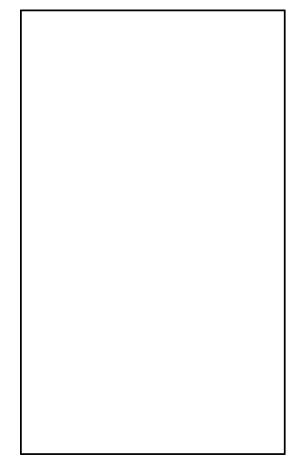

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SIGN

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LINE T

16'

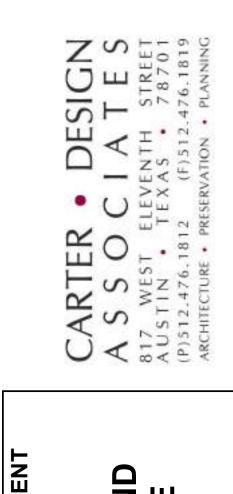0' 2' 4'


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**GROUND LEVEL -**RCP

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GENERAL NOTES

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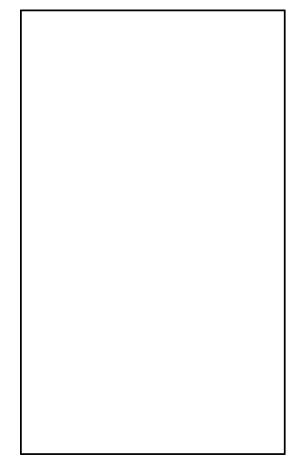
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ISSUE DATE: 04 MAY 2023 PROJECT NUMBER: 202221 DRAWN BY: ZWR CHECKED BY: DDC

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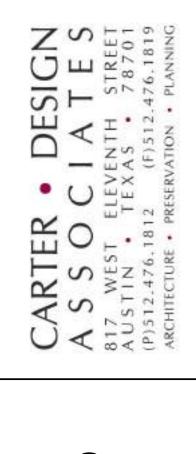
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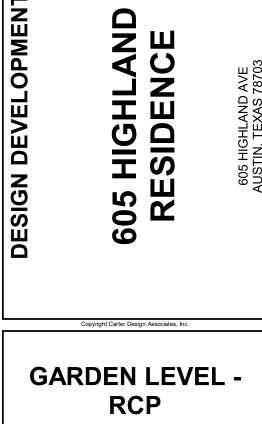


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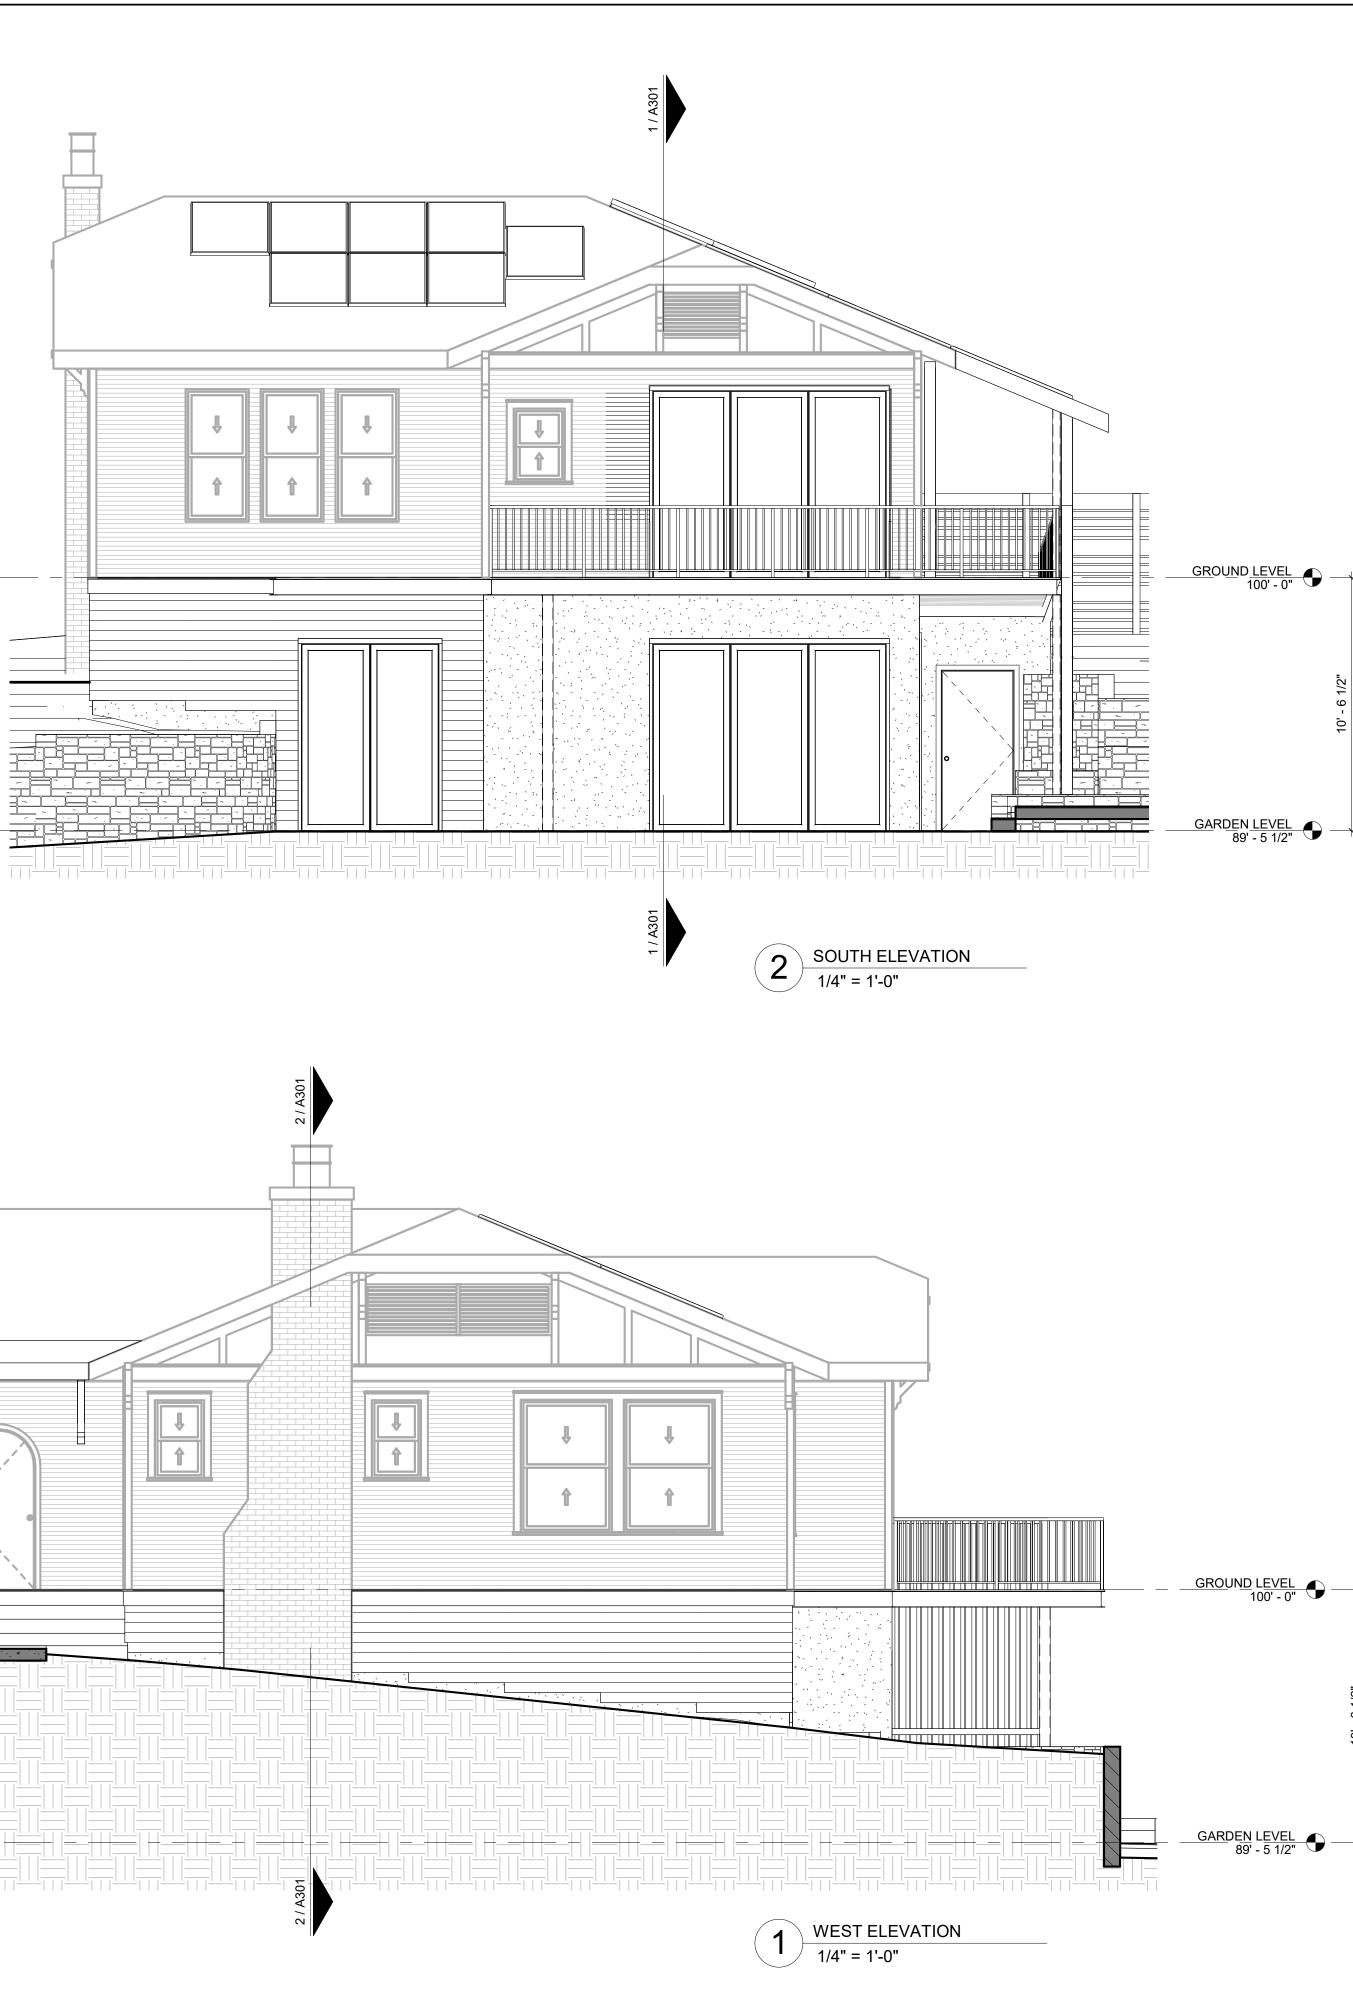


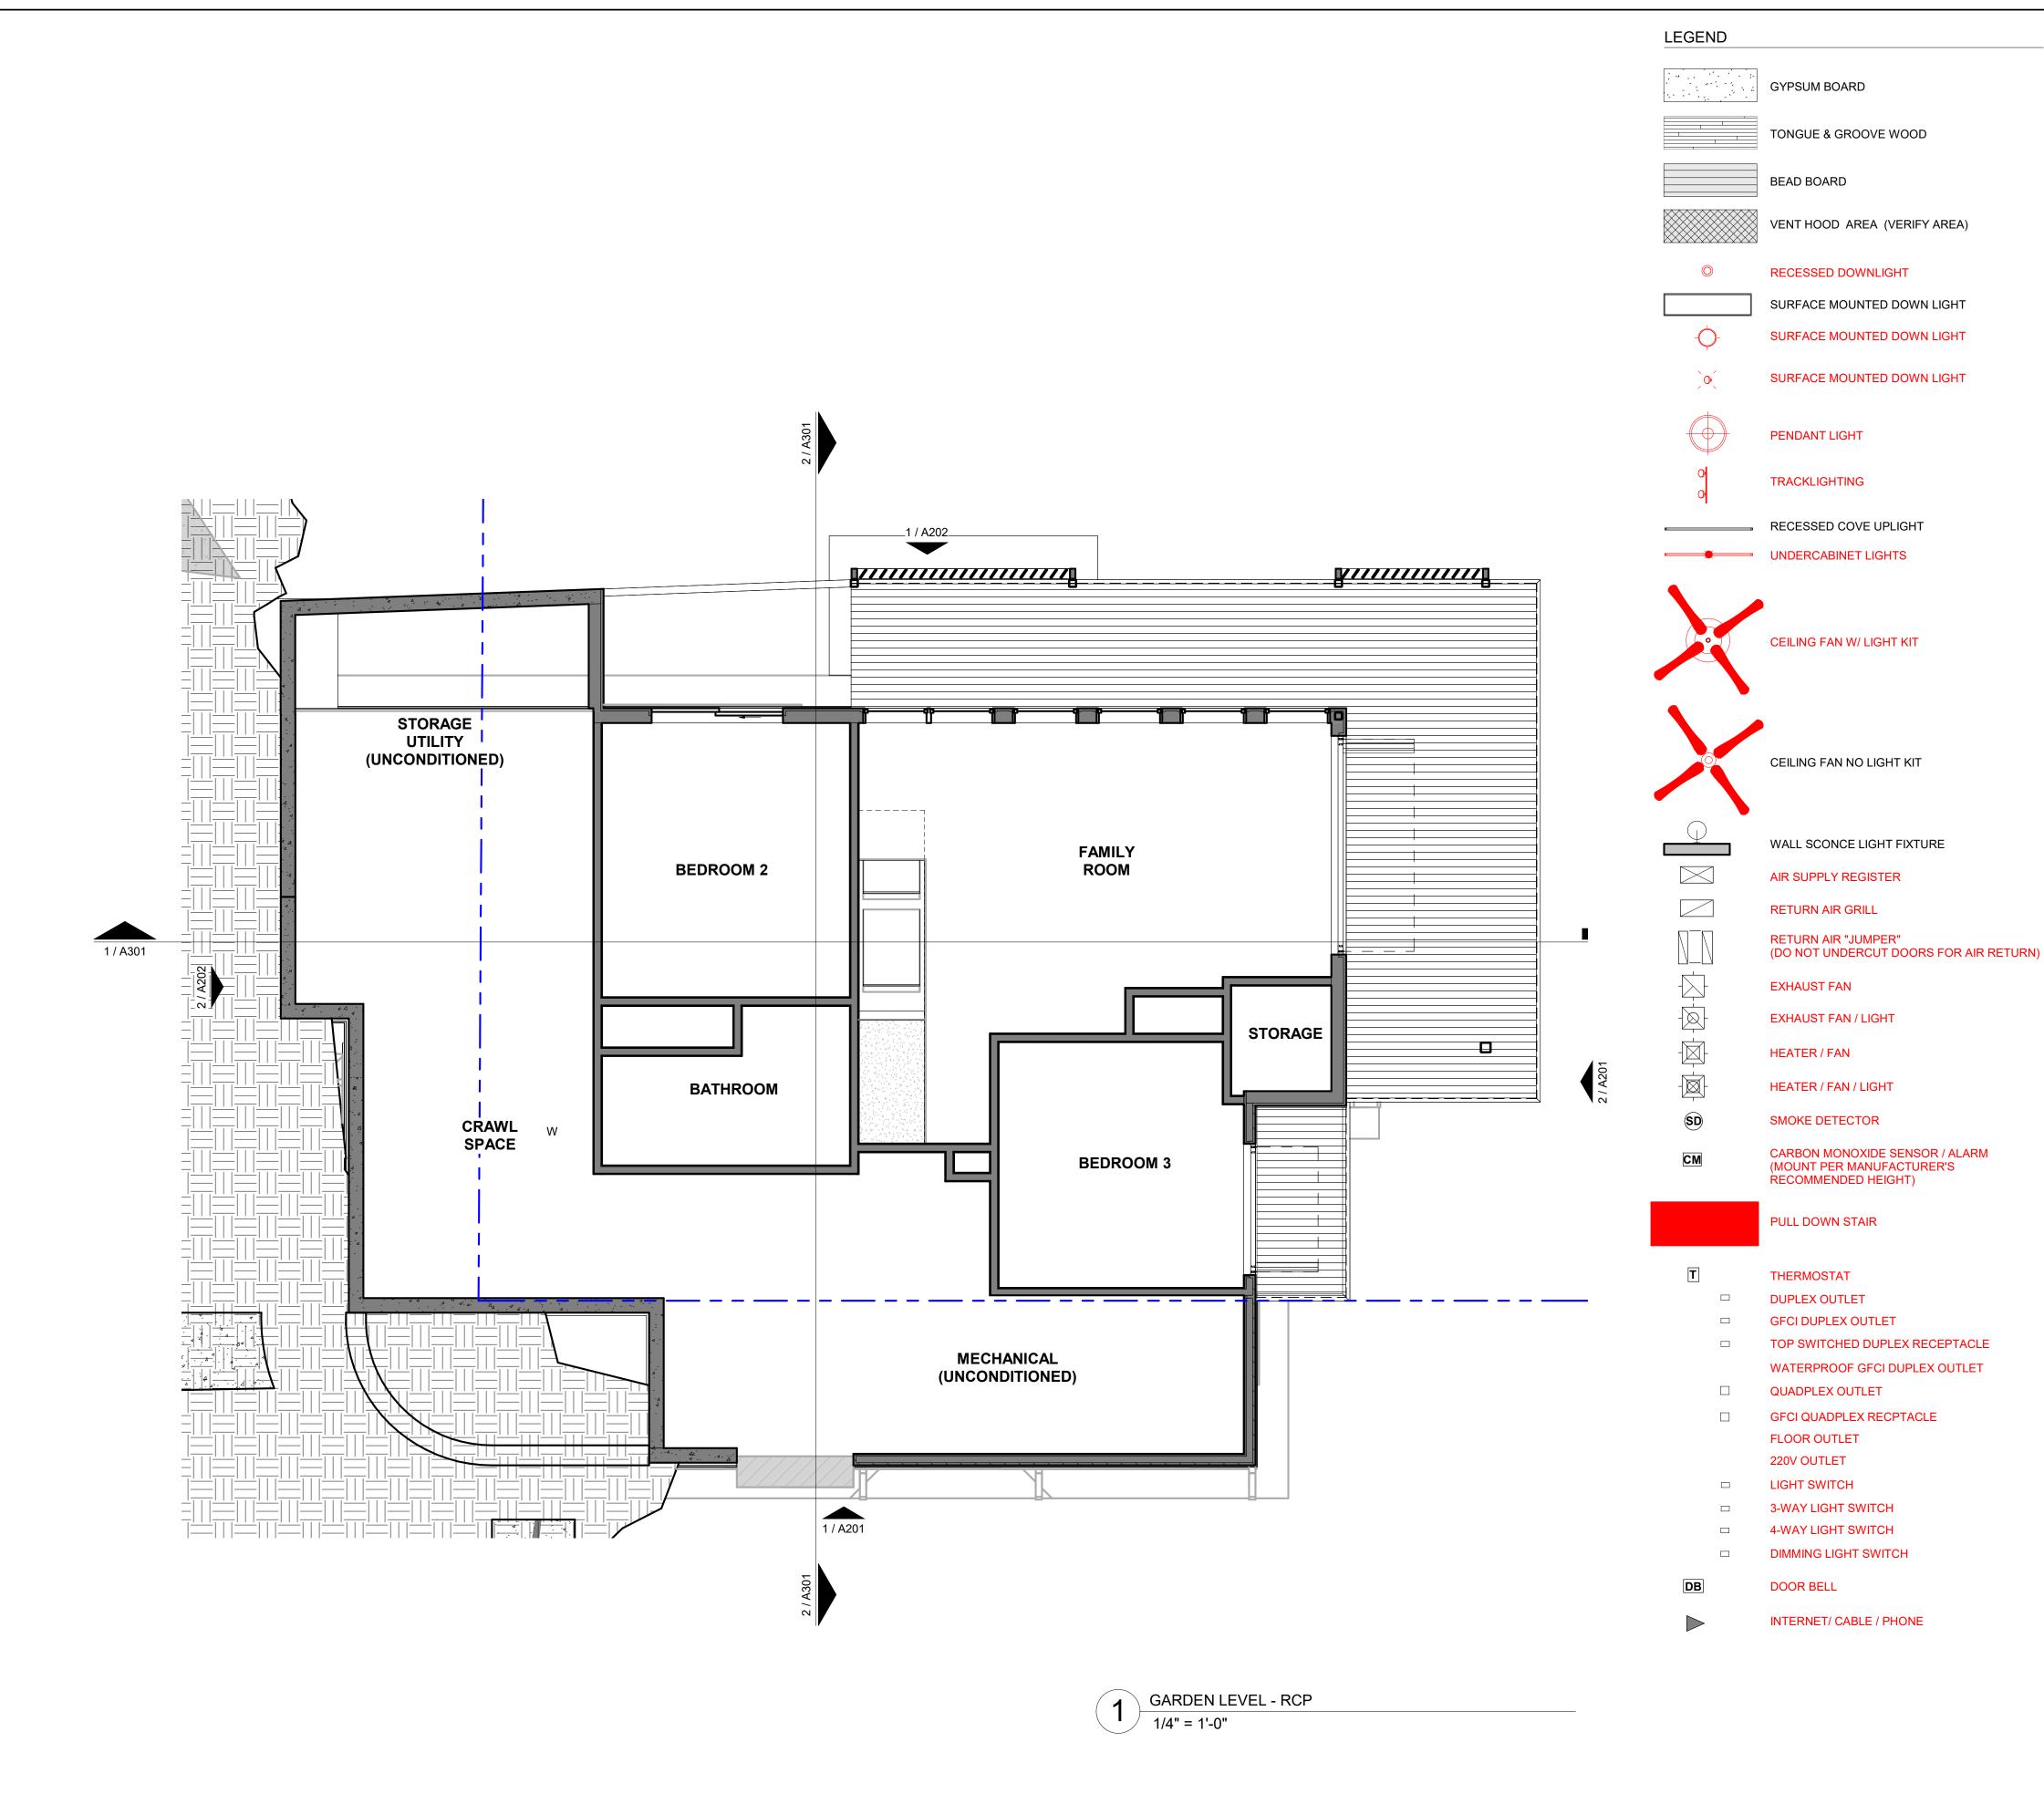


ALL ALL

16'

0' 2' 4'



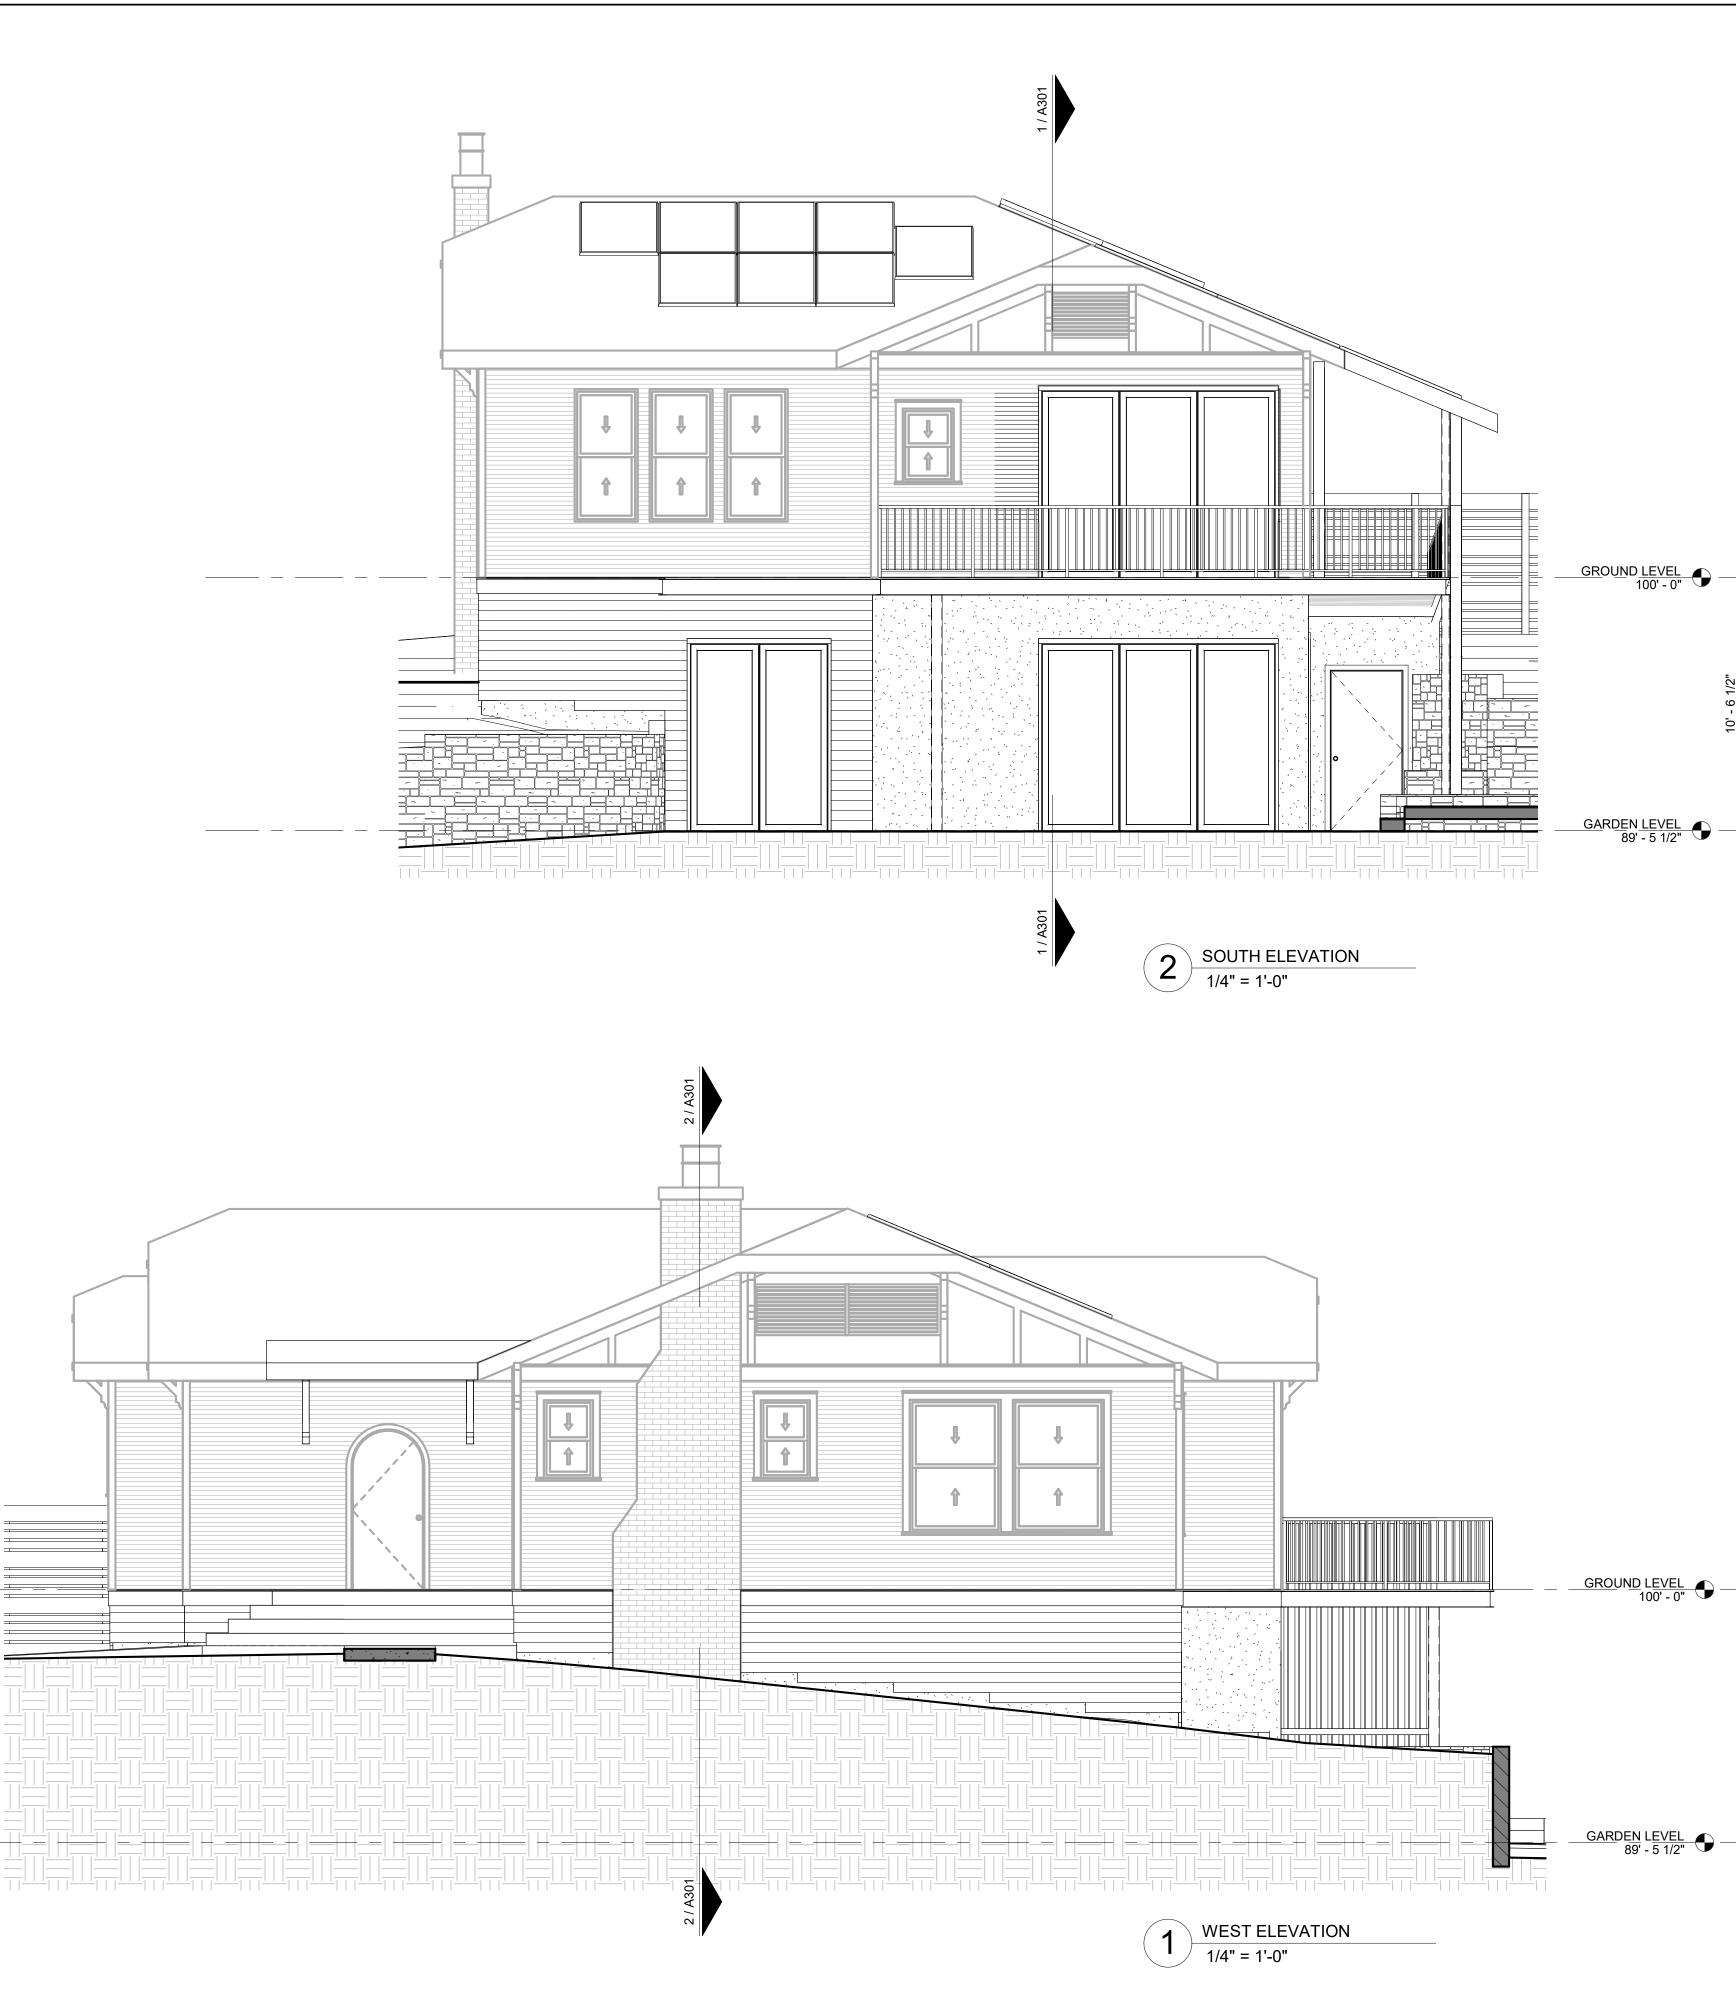

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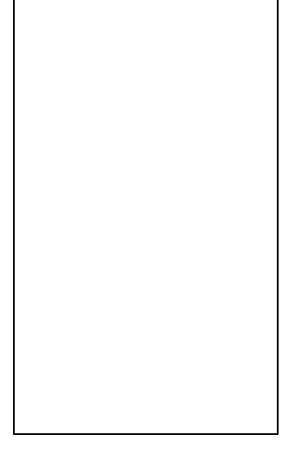
**GENERAL NOTES - EXTERIOR ELEVATIONS** 

- 1. CONTROL JOINT @ STONE TO FOLLOW STONE EDGE STARTING FROM TOP EDGE OF WINDOW/DOOR SYSTEM TO TOP OF PARAPET.
- 2. CONTROL JOINT @ STUCCO STARTING FROM TOP EDGE OF
- WINDOW/DOOR SYSTEM TO TOP OF PARAPET.
- 3. ALL EXTERIOR SIDING, PANELS, PLASTER AND STUCCO SHALL BE INSTALLED AS A RAINSCREEN SYTEM UNLESS SPECIFICALLY NOTED OTHERWISE.
- 4. PAINT TO BE A 3 COLOR SCHEME + PORCH CEILING AND FLOOR COLORS. ALL TRASPARENT FINISHES TO BE THE SAME UNLESS OTHERWISE NOTED.
- 5. ALL EXISTING SURFACES ABUTING NEW WORK SHALL BE RESTORED TO ORIGINAL CONIDITION IF NOT PART OF SCOPE.

ISSUE DATE:	04 MAY 2023
PROJECT NUMBER	R: <b>202221</b>
DRAWN BY:	ZWR
CHECKED BY:	DDC

#### **REVISIONS:**


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DONNA CARTER **TEXAS REGISTRATION NUMBER #8207** 







16'
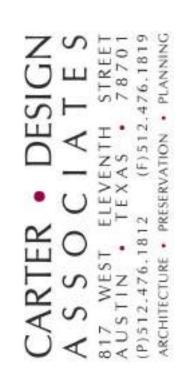
#### EXTERIOR ELEVATION LEGEND


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BOARD & BA
ASPHALT DIN
STANDING S
EARTH
GRAVEL


0' 2' 4'

STER (STUCCO) OUS SIDING 4" OUS SIDING 6" OUS SIDING 8" ATTEN SIDING 8"

IMENSIONAL SHINGLES

SEAM METAL ROOFM

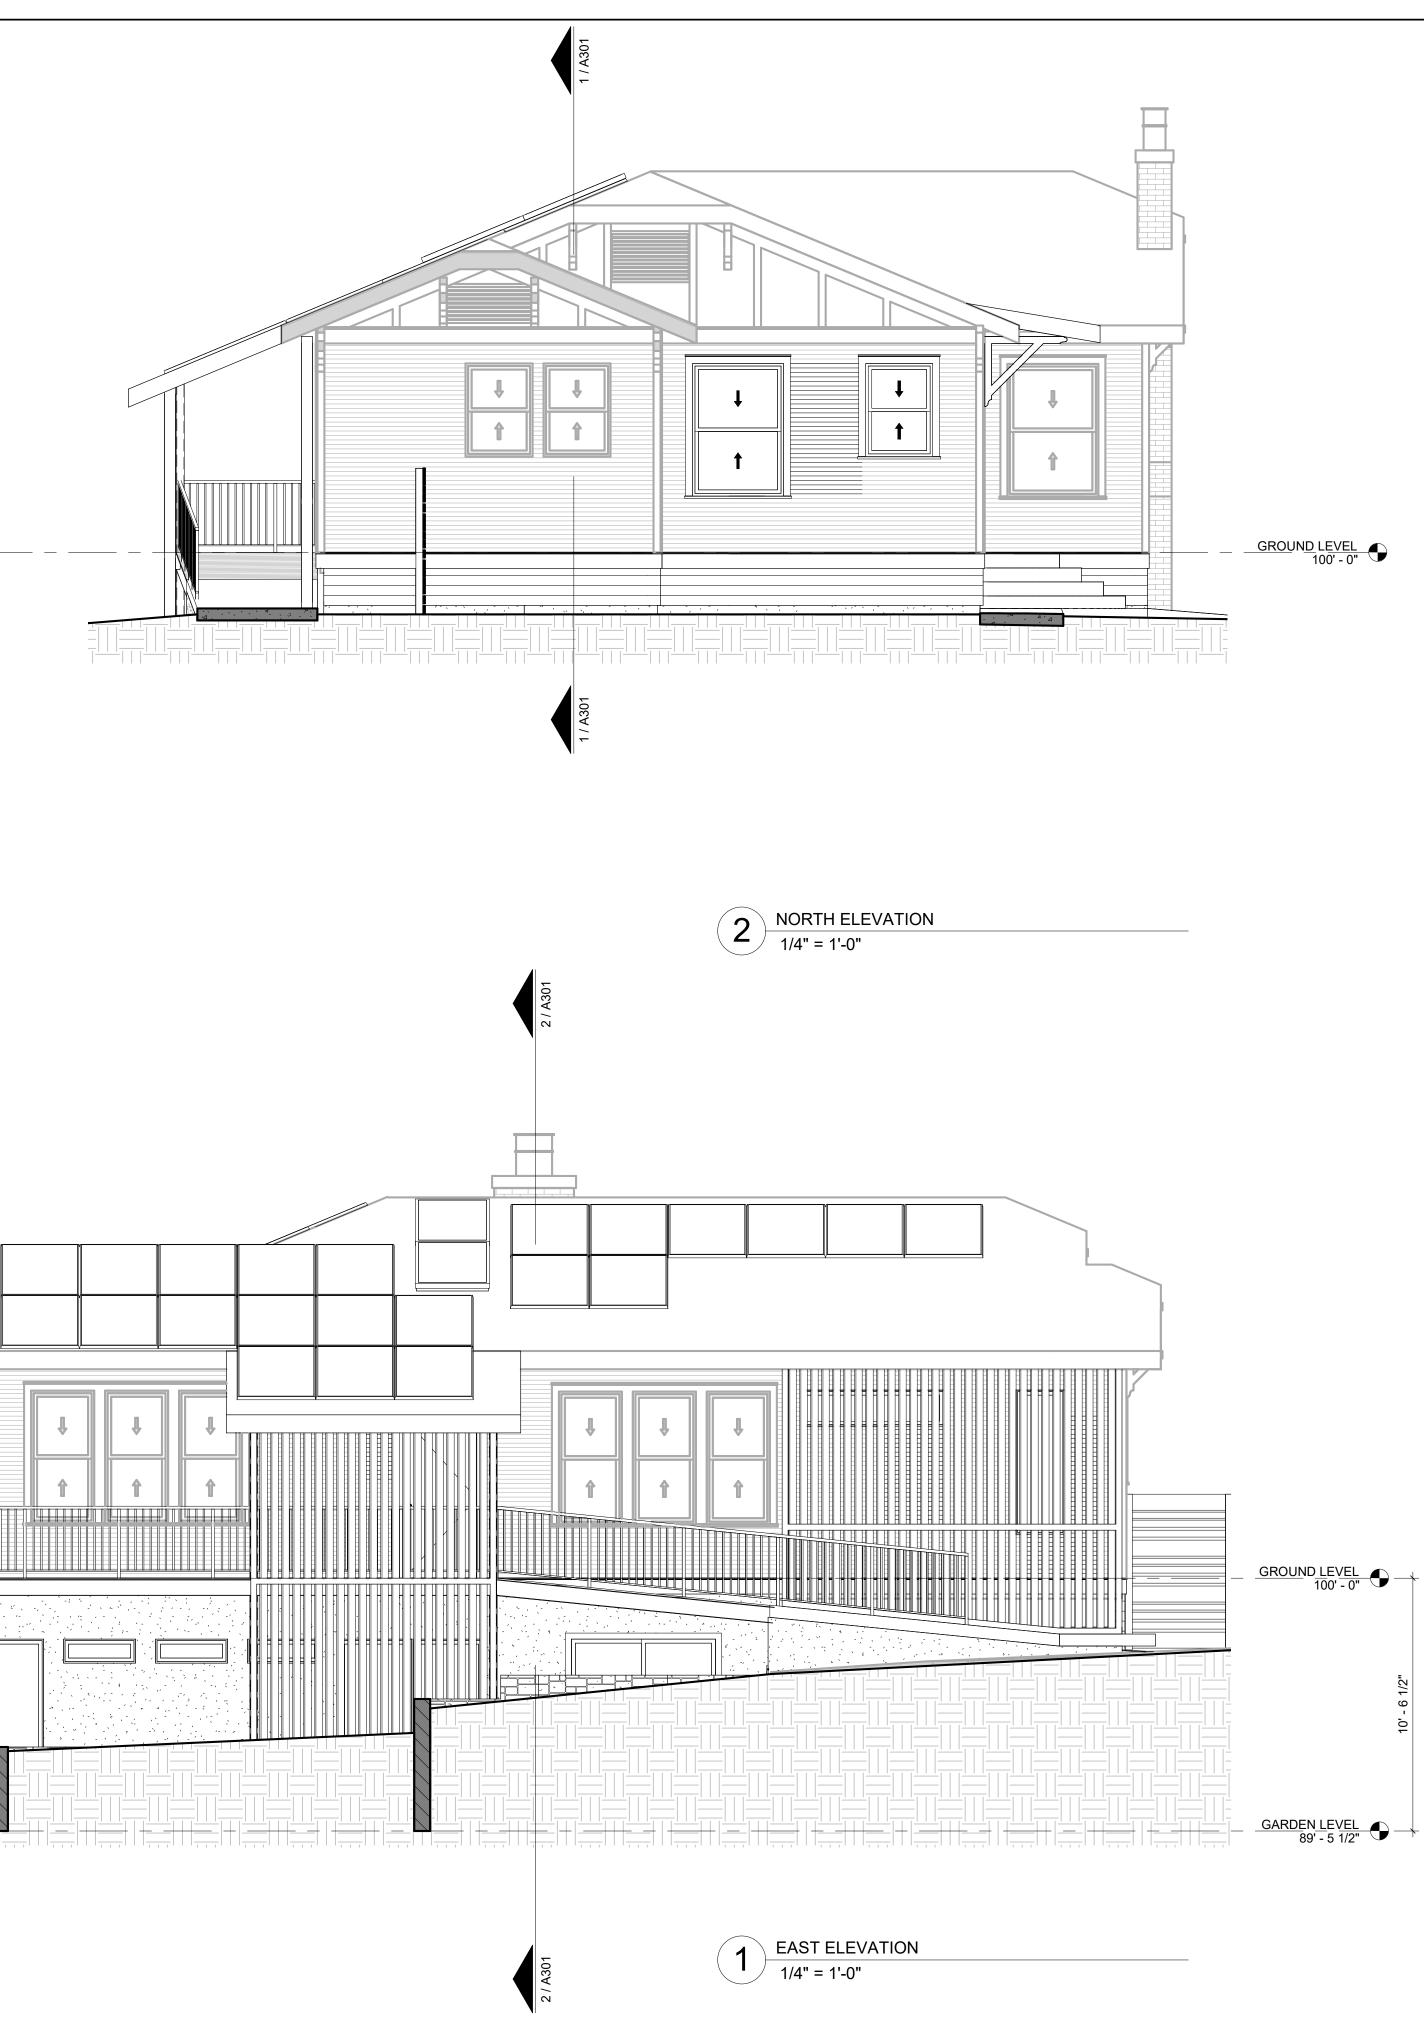

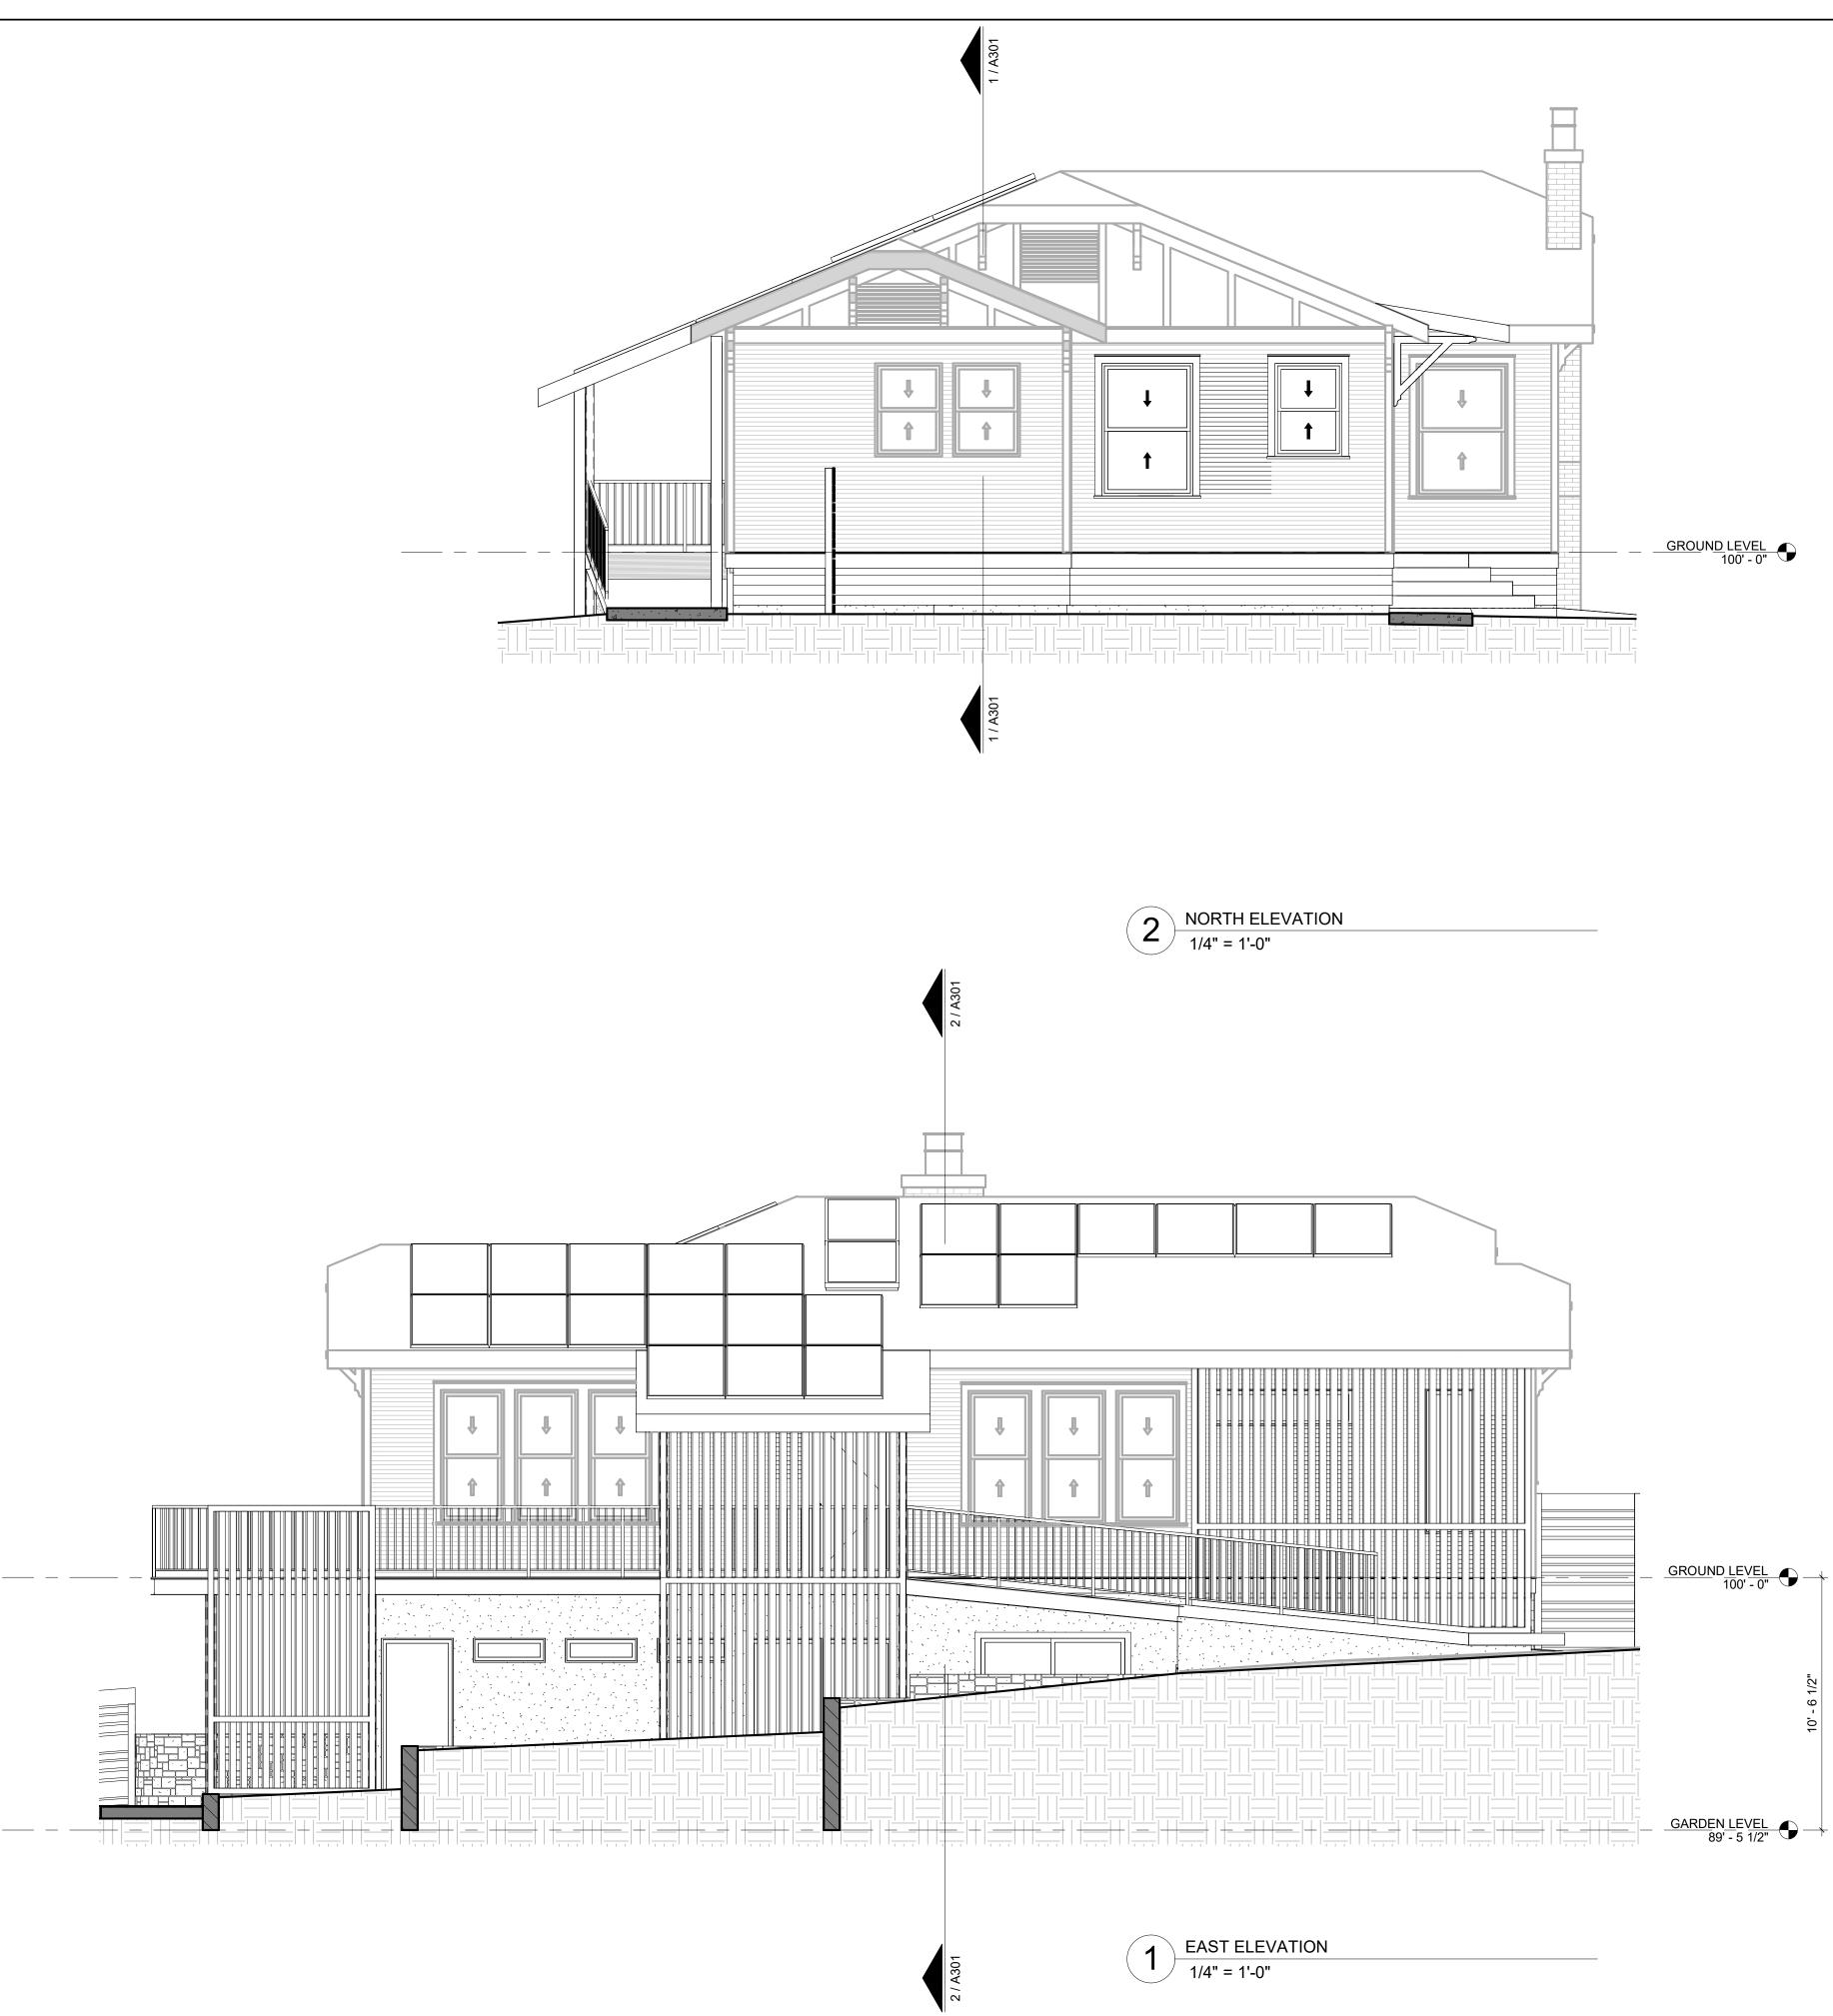

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- 8. PROVIDE ATTIC ACCESS PULL DOWN LADDER AT EACH ATTIC SPACE. 9. PROVIDE A MIN 30" SPACE CENTERED ON WATER CLOSETS AT ALL LOCATIONS UNLESS NOTED TO BE MORE. PROVIDE A MINIMUM OF
- 21" IN FRONT OF WATER CLOSETS. 10 PROVIDE DRAFT BLOCKING BETWEEN FLOORS, BETWEEN FLOORS AND ATTIC, HORIZONTALLY AT 10' MAX INCREMENTS AND AS REQUIRED BY IRC SECTION 302.11.


**GENERAL NOTES - EXTERIOR ELEVATIONS** 

- 1. CONTROL JOINT @ STONE TO FOLLOW STONE EDGE STARTING FROM TOP EDGE OF WINDOW/DOOR SYSTEM TO TOP OF PARAPET.
- 2. CONTROL JOINT @ STUCCO STARTING FROM TOP EDGE OF
- WINDOW/DOOR SYSTEM TO TOP OF PARAPET.
- 3. ALL EXTERIOR SIDING, PANELS, PLASTER AND STUCCO SHALL BE INSTALLED AS A RAINSCREEN SYTEM UNLESS SPECIFICALLY NOTED OTHERWISE.
- 4. PAINT TO BE A 3 COLOR SCHEME + PORCH CEILING AND FLOOR COLORS. ALL TRASPARENT FINISHES TO BE THE SAME UNLESS OTHERWISE NOTED.
- 5. ALL EXISTING SURFACES ABUTING NEW WORK SHALL BE RESTORED TO ORIGINAL CONIDITION IF NOT PART OF SCOPE.

ISSUE DATE:	04 MAY 2023
PROJECT NUMBER	R: <b>202221</b>
DRAWN BY:	ZWR
CHECKED BY:	DDC

#### **REVISIONS:**


NO	REFERENCE	ISSUED

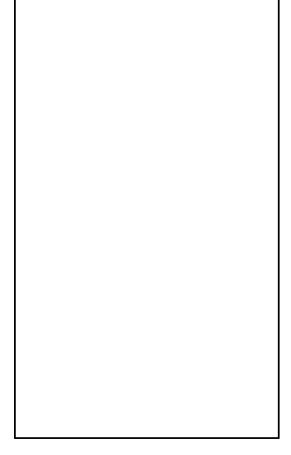

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DONNA CARTER **TEXAS REGISTRATION NUMBER #8207** 





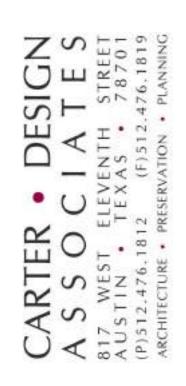


16'

#### EXTERIOR ELEVATION LEGEND

STONE
LATH & P
CEMENT
CEMENT
CEMENT
BOARD &
ASPHALT
STANDIN
EARTH
GRAVEL

l **L** l 0' 2' 4'


LATH & PLASTER (STUCCO)
CEMENTITIOUS SIDING 4"
CEMENTITIOUS SIDING 6"
CEMENTITIOUS SIDING 8"
BOARD & BATTEN SIDING 8"
ASPHALT DIMENSIONAL SHINGLES
STANDING SEAM METAL ROOFM

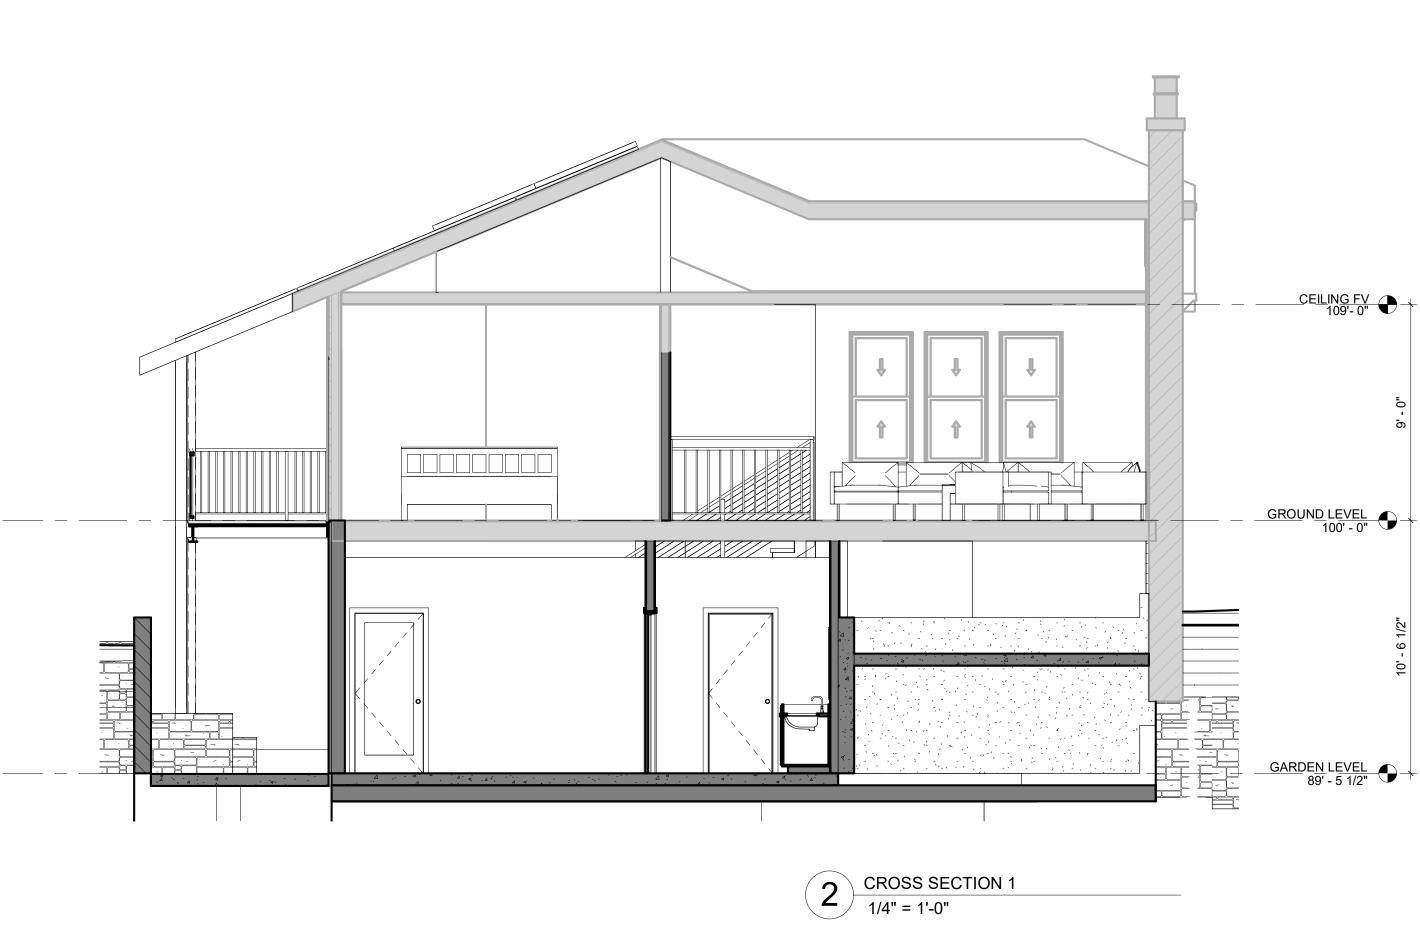






LONGITUDINAL SECTION 1 1/4" = 1'-0"

GENERAL NOTES	ISSUE DATE:         04 MAY 2023           PROJECT NUMBER:         202221
<ol> <li>ALL CONSTRUCTION SHALL COMPLY WITH THE CURRENT ADOPTED EDITION OF THE IRC INCLUDING ALL CURRENT LOCAL AMENDMENTS.</li> <li>WIND, SEISMIC AND THERMAL ENVELOPE REQUIREMENTS SHALL BE DETERMINED BASED ON SPECIFIC PROJECT LOCATION.</li> <li>PROVIDE SAFETY GLAZING IN DOORS AND WINDOWS IN COMPLIANCE WITH IRC SECTION 308.</li> <li>GUARDRAILS AND WINDOW FALL PROTECTION SHALL BE IN COMPLIANCE WITH IRC SECTION 312.</li> <li>PROVIDE FIRE SPRINKLERS IN COMPLIANCE WITH IRC SECTION 313.</li> <li>PROVIDE FIRE SPRINKLERS IN COMPLIANCE WITH IRC SECTION 314. MOUNT PER MANUFACTURE'S RECOMMENDATION.</li> <li>CARBON MONOXIDE ALARMS SHALL BE INSTALLED OUTSIDE SLEEPING AREAS IN COMPLIANCE WITH IRC SECTION 315. MOUNT PER MANUFACTURE'S RECOMMENDATION.</li> <li>PROVIDE ATTIC ACCESS PULL DOWN LADDER AT EACH ATTIC SPACE.</li> <li>PROVIDE ATTIC ACCESS PULL DOWN LADDER AT EACH ATTIC SPACE.</li> <li>PROVIDE ATTIC ACCESS PULL DOWN LADDER AT EACH ATTIC SPACE.</li> <li>PROVIDE ATTIC ACCESS NOTED TO BE MORE. PROVIDE A MINIMUM OF 21" IN FRONT OF WATER CLOSETS.</li> <li>PROVIDE DRAFT BLOCKING BETWEEN FLOORS, BETWEEN FLOORS AND ATTIC, HORIZONTALLY AT 10" MAX INCREMENTS AND AS REQUIRED BY IRC SECTION 302.11.</li> </ol>	
	DESIGNATION       DESIGNATION         DESIGNATION       ACANTER • DESIGNATION         DESIGNA • DESIGNA • DESIGNA       DESIGNATION PARAMENTER         DONA CARTER • DESIGNA • DESIGNATION NUMBER #8200       DESIGNATION NUMBER #8200         BIJ MESI • 100 ×
	BESIGN DEVELOPMENT BESIGN DEVELOPMENT BOOG HIGHLAND BOOG H
↓ ↓	BUILDING SECTIONS
0' 2' 4' 8' 16'	A301

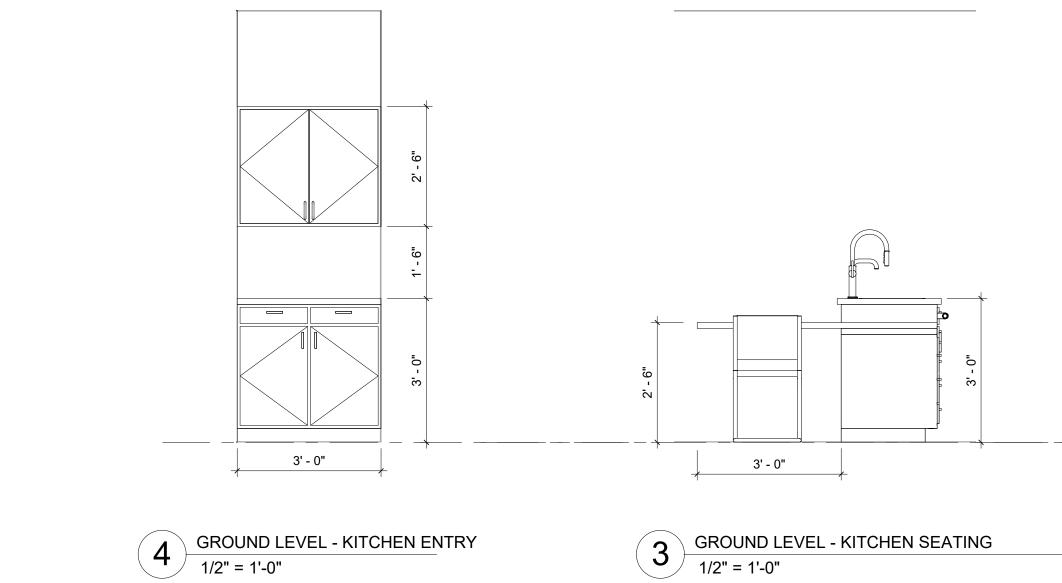

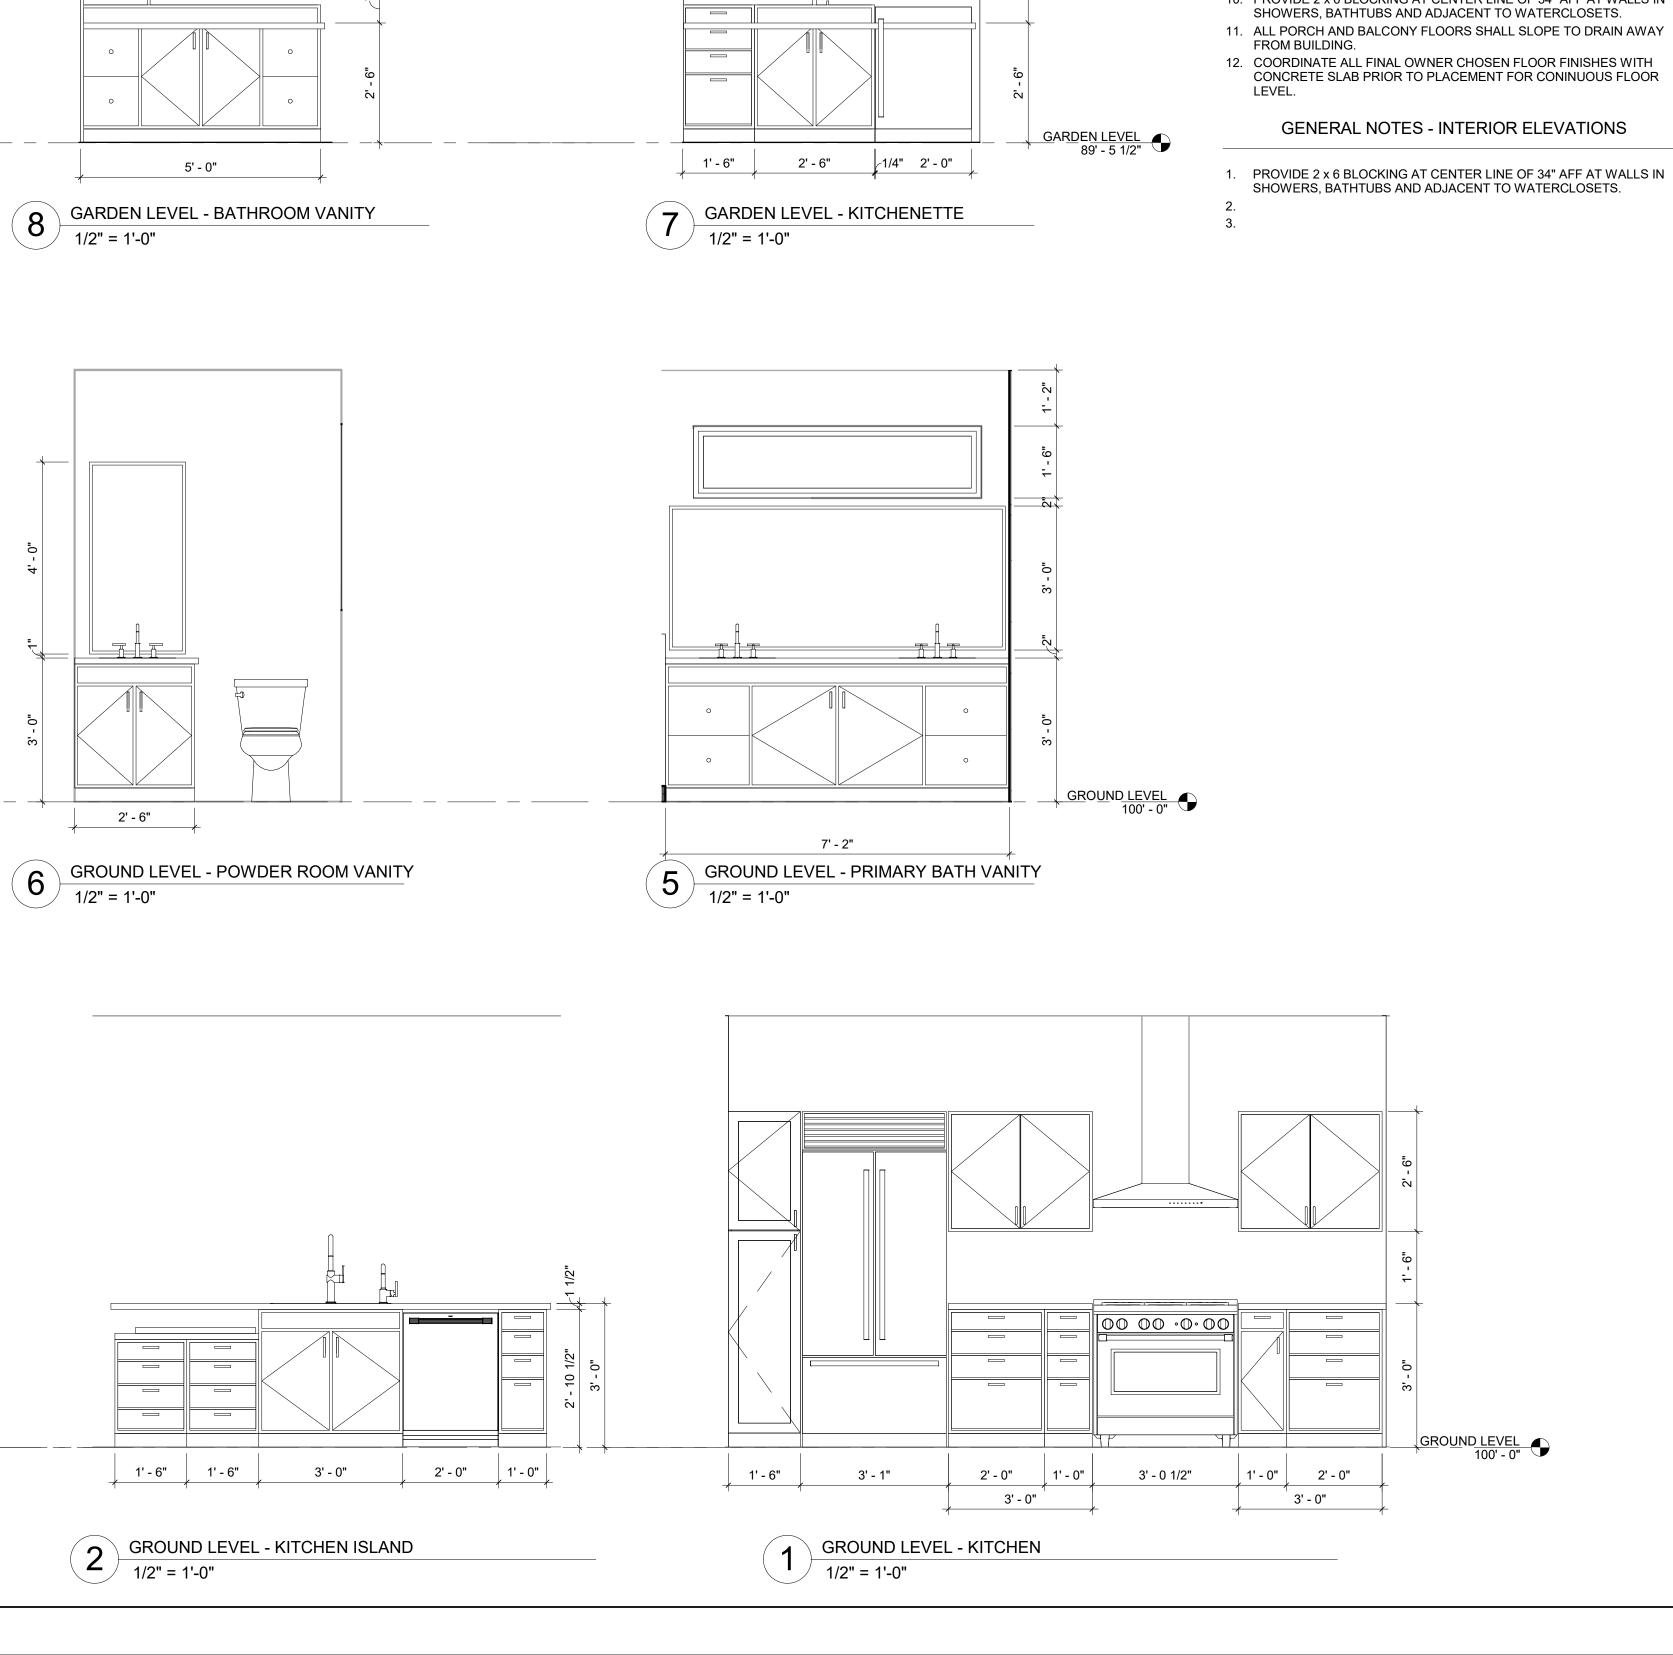

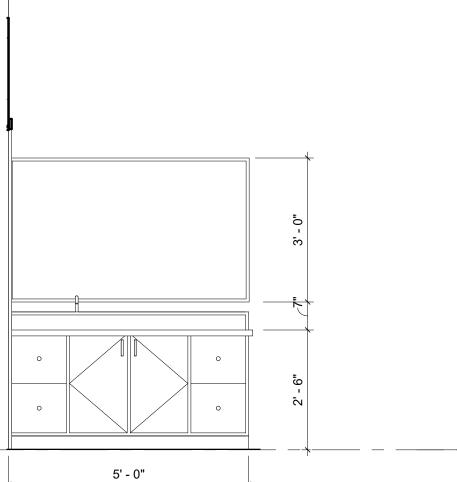

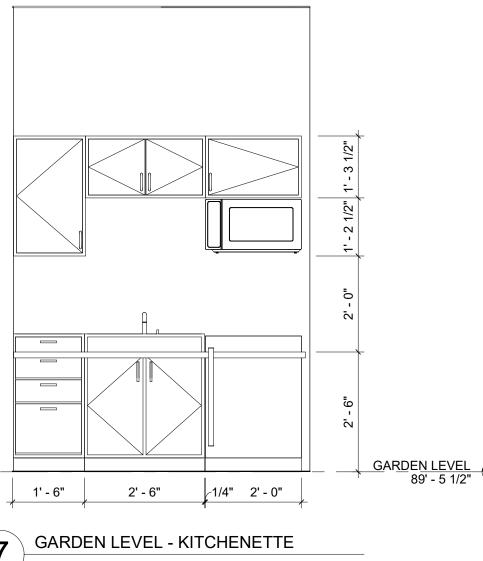


#### GENERAL NOTES - FLOOR PLAN

- 1. DO NOT SCALE DRAWINGS. WRITTEN DIMENSIONS GOVERN.
- 2. ALL DIMENSIONS ARE TO FACE OF STUD OR FACE OF MASONRY, UNLESS OTHERWISE NOTED.
- 3. ALL EXTERIOR WALL PARTITIONS ARE 2 x 6 WOOD STUDS WITH 5/8" GYPSUM BOARD AT INTERIOR FACE, AND EXTERIOR ENVELOPE REQUIREMENTS PER IRC AND LOCAL AMENDMENTS AND EXTERIOR FINISH UNLESS OTHERWISE NOTED.
- 4. ALL EXTERIOR SIDING, PANELS, PLASTER AND STUCCO SHALL BE INSTALLED AS A RAINSCREEN SYTEM UNLESS SPECIFICALLY NOTED OTHERWISE.
- 5. ALL INTERIOR WALL PARTITIONS ARE 2 x 4 WOOD STUDS WITH SOUND BATT INSULATION AND 5/8" GYPSUM BOARD UNLESS OTHERWISE NOTED.
- 6. REFER TO SLAB PLAN FOR LAYOUT DIMENSIONS.
- 7. REFER TO STRUCTURAL SHEETS FOR FOUNDATION AND FRAMING. 8. COORDINATE ALL KITCHEN AND BATHROOM DIMENSIONS AND UTILITY REQUIREMENTS WITH OWNER'S SPECIFIC CHOICES OF FIXTURES, APPLIANCES AND CABINETS.
- 9. FIRST FLOOR ENTRANCES SHALL HAVE MAX 1/2" BEVELED THRESHOLD.
- 10. PROVIDE 2 x 6 BLOCKING AT CENTER LINE OF 34" AFF AT WALLS IN SHOWERS, BATHTUBS AND ADJACENT TO WATERCLOSETS.
- 12. COORDINATE ALL FINAL OWNER CHOSEN FLOOR FINISHES WITH
- CONCRETE SLAB PRIOR TO PLACEMENT FOR CONINUOUS FLOOR


GENERAL NOTES - INTERIOR ELEVATIONS

- SHOWERS, BATHTUBS AND ADJACENT TO WATERCLOSETS.

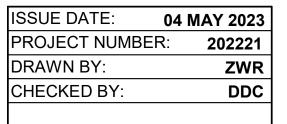

#### **REVISIONS:**

NO	REFERENCE	ISSUED

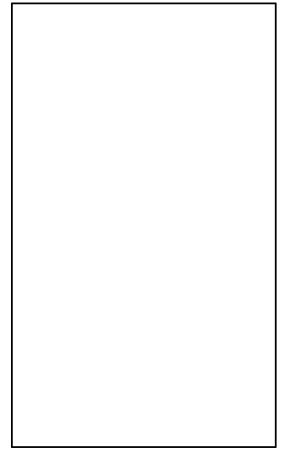

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