
605 HIGHLAND RESIDENCE

PROJECT ADDRESS: 605 HIGHLAND AVE AUSTIN, TEXAS 78703

> PROJECT NUMBER: 202221 PROJECT ISSUE DATE: 21 JULY 2023

LOCATION MAP

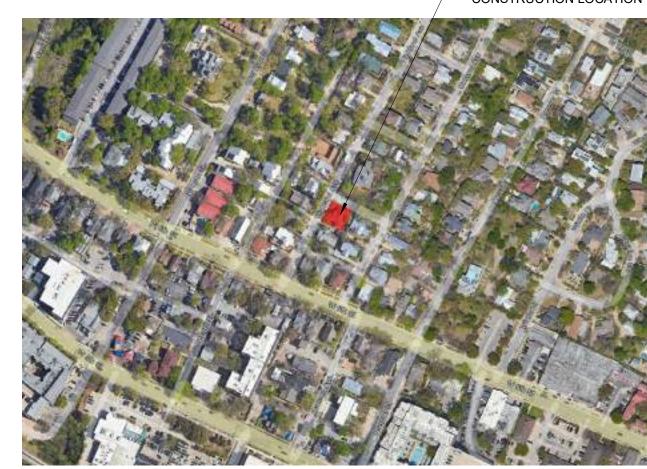



STRUCTURAL ENGINEER

STEINMAN LUEVANO STRUCTURES 5901 OLD FREDERICKBURG RD, B101 **AUSTIN, TEXAS 78749** TEL. 512-891-6766

INDEX OF SHEETS

GENERAL NOTES & ABBREVIATIONS SUBCHAPTER F TENT ANALYSIS EXISTING SITE CONDITIONS & DEMO

SITE PLAN & LDC CALCULATIONS GROUND LEVEL - DEMO PLAN GARDEN LEVEL - DEMO PLAN GROUND LEVEL - ANNOTATION PLAN **GARDEN LEVEL - ANNOTATION PLAN GARDEN LEVEL - DIMENSION PLAN**

GROUND LEVEL - RCP **GARDEN LEVEL - RCP EXTERIOR ELEVATIONS EXTERIOR ELEVATIONS**

ENLARGED FLOOR PLAN & INTERIOR ELEVATIONS SCHEDULES AND DOOR & FRAME ELEVATIONS NW CORNER VIEW FROM STREET

NE CORNER VIEW FROM STREET

THIS DOCUMENT IS RELEASED FOR THE PURPOSE OF INTERIM REVIEW. IT **USED FOR REGULATORY APPROVAL,** PERMIT, OR CONSTRUCTION.

DONNA CARTER **TEXAS REGISTRATION NUMBER #8207**

REVI	SIONS:	
NO	REFERENCE	ISSUED

ARCHITECT


CARTER • DESIGN ASSOCIATES 817 WEST ELEVENTH STREET AUSTIN TEXAS 78701 (512) 476-1812 ARCHITECTURE PLANNING PRESERVATION

ABBREVIATIONS


	7 IDDITE VIII TITOTTO				
@	AT	EWC	ELECTRIC WATER COOLER	P.P., PP	POWER POLE
@.F.F., @FF	AT FINISHED FLOOR	EXH.	EXHAUST	P.S.F.	POUNDS PER SQ. FT.
ABV.	ABOVE	EXP.	EXPANSION	P.U.E.	PUBLIC UTILITY EASEMENT
ACOUST.	ACOUSTICAL	EXT.	EXTERIOR	PC.	
ACCOUST. A/C	AIR CONDITIONING				PHOTO CELL
ADA	AMERICANS WITH DISABILITIES ACT	EXTING.	EXTINGUISHER	PG.	PAGE
ADMIN.	ADMINISTRATION	FEC	FIRE EXTINGUISHER CABINET	PL.	PLATE
A/P/F/S.	AMPS/POLES/FUSE SIZE/STARTER SIZE	F.F. (E.)	FINISHED FLOOR (ELEVATION)	PLAS. PLUM.	PLASTIC PLUMBING
A.F.F., AFF			FIRE HYDRANT	PLYWD.	PLYWOOD
A.F.F., AFF ALUM.	ABOVE FINISH FLOOR ALUMINUM	FHC	FIRE HOSE CABINET	PNT	PAINT
ARCH(L).	ARCHITECT, ARCHITECTURAL	FIN. FIX.	FINISH		
ASST.	ASSISTANT	FIX. FLR.	FIXTURE	PREFAB.	PREFABRICATED
A-V	AUDIO-VISUAL	FLR. FLUOR.	FLOOR	PRO. PVC.	PROTECTION
BD.	BOARD		FLUORESCENT	R.	POLYVINYL CHLORIDE REFRIGERATOR
BET.	BETWEEN	F.O.C. FT.	FACE OF CURB	R.O.W.	RIGHT OF WAY
BHL	BOREHOLE	FT. FURR.	FOOT, FEET	RCP., R.C.P.	REINFORCED CONCRETE PIPE
BLDG.	BUILDING		FURRING	R.D.	ROOF DRAIN
BLK.	BLOCK	FXD.	FIXED	RECOM.	RECOMMENDATION
BLKG	BLOCKING	G.C.	GENERAL CONTRACTOR	REF.	REFER TO
	BEAM(S)	GA.	GAUGE	REINF.	REINFORCED; REINFORCEMEN
BM(S). B.O.C.	BACK OF CURB	GALV.	GALVANIZED	REQD.	
		GFI.	GROUND FAULT INTERRUPT	REQU. RM.	REQUIRED
BOT.	BOTTOM	GLZ.	GLAZING	RIVI. R.R.	ROOM RESTROOM
BSMT. BTWN.	BASEMENT	G.P.M.	GALLONS PER MINUTE	K.K. S.	
DIWIN.	BETWEEN CENTER LINE	GR.	GRADE	S.B.L.	SOUTH
CL C.	CENTER LINE CONDUIT	GRND.	GROUND	S.B.L. SAN.	SETBACK LINE
	CONTROL JOINT	GYP.	GYPSUM	SAN. SC.	SANITARY SCALE
C.J., CJ C.O.A.	CITY OF AUSTIN	H.C.; H/C HORIZ.	HANDICAPPED HORIZONTAL	SCHED.	SCHEDULED
CAB.	CABINET	HR.	HOUR	SF.	SQUARE FEET
CAL.	CALIPER	HRDWD.	HARDWOOD	SHT.	SHEET
CCTS.	CIRCUITS	HT.	HEIGHT	SHWR.	SHOWER
CHAN.	CHANNEL	IN.	INCHES	SIM.	SIMILAR
CLG.	CEILING	IN. INFO	INFORMATION	SN.	SOLID NEUTRAL
CMU, C.M.U.	CONCRETE MASONRY UNIT	INSULA.; INSUL.		S.O.S.	SIMILAR OPPOSITE SIDE
COL.	COLUMN	INT.	INTERIOR	SQ.	SQUARE
COM.	COMMUNICATION	JAN.	JANITOR	STD.	STANDARD
CONC.	CONCRETE	JAN. JST		STGT.	SEALTIGHT
CONN.	CONNECTION	JT., JNT	JOIST JOINT	STIFF.	STIFFENER
CONST.	CONSTRUCTION	LAM.	LAMINATE	STL.	STEEL
CONT.	CONTINUOUS	LAV.	LAVATORY	STOR.	STORAGE
COORD	COORDINATION	LBS.	POUNDS	STRUCT.	STRUCTURAL
CORR.	CORRIDOR	LF, L.F.	LINEAR FEET	SUSP.	SUSPENDED
CTR(D).	CENTER(ED)	LT.	LIGHT	SW.	SWITCH
CU.	COPPER	MAX.	MAXIMUM	SWR	SEWER
CVR.	COVER	MANUF.	MANUFACTURER	TEL.	TELEPHONE
DET.	DETAIL	MECH.	MECHANICAL	TL.	TWIST LOCK
DIAG.	DIAGONAL(LY)	M.E.P.	MECHANICAL, ELECTRICAL, PLUMBING	T.O.B.(M.)	TOP OF BEAM
DIA.	DIAMETER	MFR.	MANUFACTURER	T.O.S.	TOP OF STEEL
DISP.	DISPENSER	MGR.	MANAGER	TOT.	TOTAL
DIV.	DIVISION	MH.	MANHOLE	TS	TUBE STEEL
DN.	DOWN	MIN.	MINIMUM	TW.	TOP OF WALL
DORM.	DORMITORY	MISC.	MISCELLANEOUS	TYP.	TYPICAL
DP.	DEEP	M.O.	MASONRY OPENING	UL	UNDERWRITER'S LABORATORY
D.S.	DOWNSPOUT	MTD.	MOUNTED	U.N.O., UNO	UNLESS NOTED OTHERWISE
DW	DISHWASHER	MTL.	METAL	VCT	VINYL COMPOSITE TILE
DWG.	DRAWING	N.	NORTH	VERT.	VERTICAL
DWLS.	DOWELS	NIC	NOT IN CONTRACT	W/	WITH
E.	EAST	N.T.S.	NOT TO SCALE	W	WEST
EA.	EACH	NF.	NON-FUSED	W.R.	WATER RESISTANT
EJ., E.J.	EXPANSION JOINT	NO.	NUMBER	W.W.F.	WOVEN WIRE FABRIC
ELEV.	ELEVATION	O.C.	ON CENTER	WD.	WOOD
ENGR.	ENGINEER	O.H.	OVERHEAD	WP.	WEATHER PROOF
EQ.	EQUAL	OPNG.	OPENING	WT.	WEIGHT
ESM'T.	EASEMENT	OPP.	OPPOSITE		

SYMBOLS View Name DRAWING TITLE PLAN TRUE NORTH ARROWS

NORTH NORTH

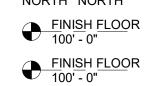

ELEVATION IDENTIFIER

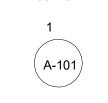


ELEVATION MARKERS

CEILING HEIGHT IDENTIFIER



DETAIL CALL-OUT MARKER

SECTION CUT MARKER

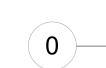

A-101

COLUMN GRID IDENTIFIER

ROOM NAME

FLOOR PLAN ROOM IDENTIFIER 100

100 RCP ROOM IDENTIFIER 8'-0"



1i

DOOR IDENTIFIER WINDOW IDENTIFIER

WALL CONSTRUCTION IDENTIFIER SLOPE ARROW

PROJECT INFORMATION

PROJECT NAME 605 HIGHLAND RESIDENCE ADDRESS 605 HIGHLAND AVE

ZONING SF-3 -HD-NP NEIGHBORHOOD CENTRAL WEST AUSTIN, OWANA, SMOOT TERRACE

SETBACKS:

LOT SIZE (SF)

FRONT YARD SETBACK (F) 25' 15' STREET SIDE YARD SETBACK (F) SIDEYARD SETBACK (F) REAR YARD SETBACK (F) 10' 40%

6000

45%

YES

MAX. BUILDING COVERAGE MAX. IMPERVIOUS COVERAGE REFER TO SHEET AS101 FOR SITE PLAN AND COVERAGE CALCULATIONS

VISITABILITY REQUIRED REFER TO SHEET G102 FOR

SUBCHAPTER F APPLICABLE REFER TO SHEET G102 FOR FAR PLANS AND CALCULATIONS


APPLICABLE CODES:

INTERNATIONAL RESIDENTIAL CODE (IRC)	202
UNIFORM PLUMBING CODE (UPC)	202
UNIFORM MECHANICAL CODE (UMC)	202
NATIONAL ELECTRICAL CODE (NEC)	202
INTERNATION FIRE CODE (IFC)	202
INTERNATIONAL ENERGY CONSERVATION CODE (IECC)	202
INTERNATIONAL WILDLAND-URBAN INTERFACE CODE (IWUIC)	201
FLOOD HAZARD AREAS (CHAPTER 25-12, ARTICLE 3)	

VISITIBILITY PLANS AND DETAILS

GENERAL PROJECT NOTES

- 1. THE ARCHITECT, ENGINEER OR OWNER SHALL NOT BE REPONSIBLE FOR, OR HAVE CONTROL OF, OR CHARGE OF CONSTRUCTION MEANS, METHODS, TECHNIQUES, SEQUENCES OR PROCEDURES, NOR FOR SAFETY PRECAUTIONS AND PROGRAMS IN CONNNECTION WITH THE WORK. THE ARCHITECT, ENGINEER OR OWNER SHALL NOT BE RESPONSIBLE NOR HAVE CONTROL OF THE CONTRACTOR, SUBCONTRACTORS OR ANY OF THEIR AGENTS OR EMPLOYEES, OR ANY OTHER PERSONS PERFORMING ANY OF THE WORK.
- WORK SHALL COMPLY WITH APPLICABLE LOCAL, STATE, AND FEDERAL CODES AND ORDINANCES AND STANDARD SPECIFICATIONS OF ALL AGENCIES HAVING THE RESPONSIBILITY OF REVIEWING PLANS AND SPECIFICATIONS FOR CONSTRUCTION OF ALL ITEMS PER THESE PLANS AND SPECIFICATIONS IN THIS LOCALITY. COMPLY WITH ALL RECOMMENDED PRACTICES AS SET FORTH BY THE FOLLOWING, BUT NOT LIMITED TO: EPA, ASME, SMACNA, ASHRAE, NFPA, ALL LOCAL BUILDING, MECHANICAL, AND PLUMBING CODE, NATIONAL ELECTRICAL CODE, OSHA, AND REGULATIONS OF ALL GOVERNING BODIES AS THEY APPLY TO THIS
- THE CONTRACTOR IS REQUIRED TO TAKE DUE PRECAUTIONARY MEASURES TO PROTECT THE UTILITIES OR STRUCTURES AT THE SITE. INTERRUPTION OF UTILITY SERVICES IS NOT PERMITTED WITHOUT FULL COORDINATION WITH OWNER. SOME AREAS MAY
- REQUIRE WORK ON WEEKENDS OR OFF HOURS. 4. IT SHALL BE THE CONTRACTOR'S RESONSIBILITY TO NOTIFY THE OWNER OF ALL UTILITIES OR STRUCTURES CONCERNED BEFORE STARTING WORK. WHEN ANY EXISTING UTILITY REQUIRES ADJUSTMENT OR RELOCATION, THE CONTRACTOR SHALL NOTIFY THE PROPER UTILITY SERVICE AND COORDINATE HIS WORK
- ACCORDINGLY. 5. THE CONTRACTOR SHALL NOTIFY THE PROPER UTILITY IMMEDIATELY UPON BREAK OR DAMAGE TO ANY UTILITY LINE OR APPURTENANCE, OR THE INTERRUPTION OF THEIR SERVICE. IF EXISTING UTILITY CONSTRUCTION CONFLICTS WITH PROJECT REQUIREMENTS, CONTRACTOR SHALL NOTIFY OWNER SO THE CONFLICT MAY BE RESOLVED.
- 6. CONTRACTOR SHALL BE RESPONSIBLE FOR DAMAGE TO EXISTING PROPERTY BY HIS STAFF OR SUBCONTACTORS.
- 7. THE CONTRACTOR SHALL OBTAIN ALL THE NECESSARY PERMITS AS REQUIRED FOR CONSTRUCTION OF THIS PROJECT.
- 8. THE DESIGN AND PROVISION OF ALL TEMPORARY SUPPORTS SUCH AS BUYING BRACES, FALSEWORK, SUPPORTS AND ANCHORS FOR SAFETY LINES, CURBBING, SHORING, OR ANY OTHER TEMPORARY ELEMENTS REQUIRED FOR THE EXECUTION OF THE CONTRACT ARE NOT INCLUDED IN THESE DRAWINGS AND SHALL BE THE RESPONIBILITY OF THE CONTRACTOR. TEMPORARY SUPPORTS SHALL NOT RESULT IN THE OVERSTRESS OR DAMAGE OF THE ELEMENTS TO BE BRACED NOR ANY ELEMENTS USED AS BRACE SUPPORTS.
- 9. CONTRACTOR SHALL MEET ALL LOCAL NOISE ORDINANCES.

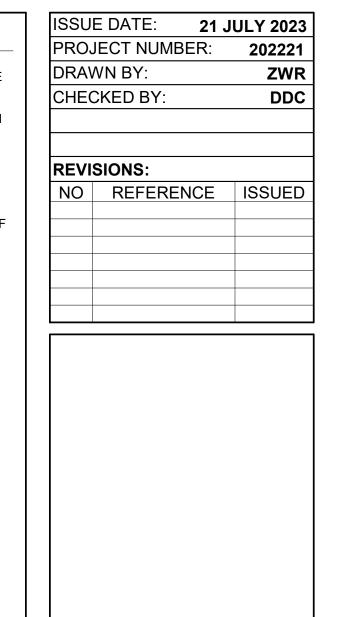

PRELIMINARY NOT FOR CONSTRUCTION


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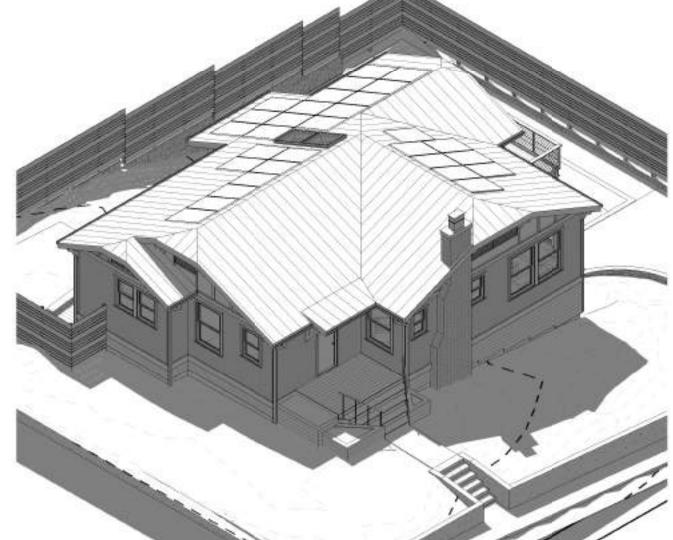
DONNA CARTER TEXAS REGISTRATION NUMBER #8207




GENERAL NOTES 8 ABBREVIATIONS





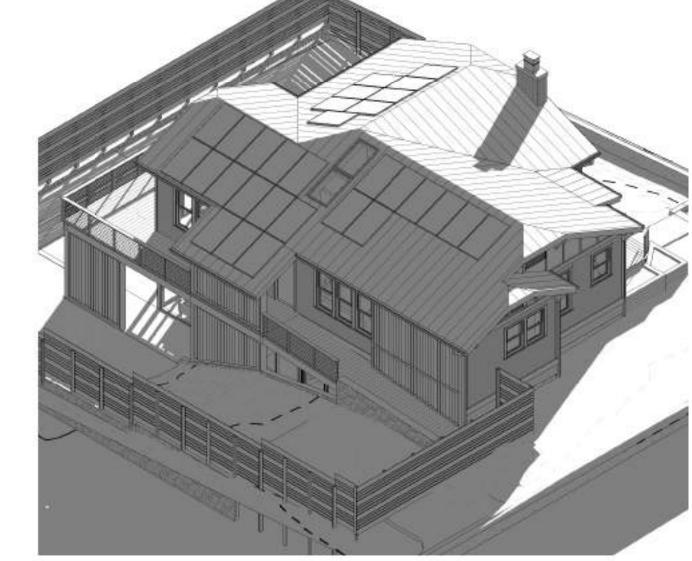

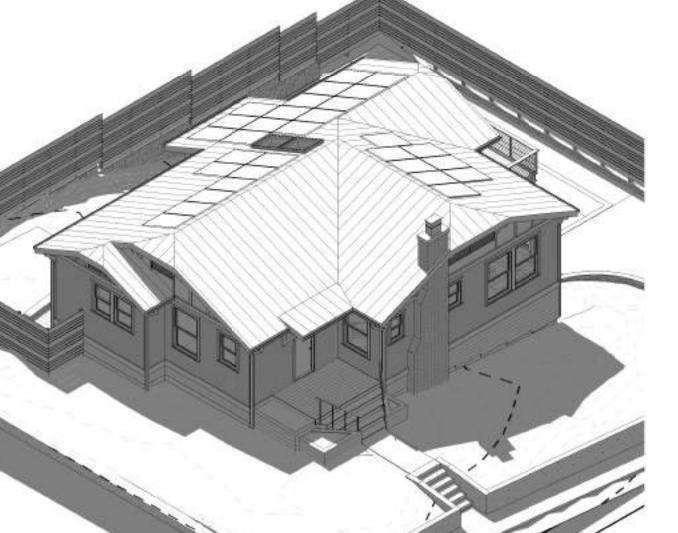







LOOKING NORTH

CRAWL SPACE AND FOUNDATION



LOOKING NORTHEAST



LOOKING NORTHWEST

HOUSE INTERIOR



KITCHEN




DINING ROOM





GARAGE

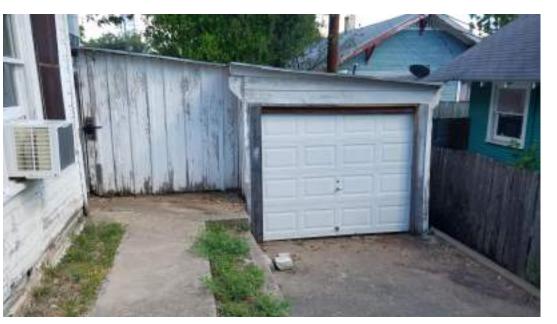

GARAGE - WEST ELEVATION



GARAGE - NORTH ELEVATION

HOUSE EXTERIOR



EAST ELEVATION



NORTH ELEVATION - 6TH 1/2 STREET



SOUTH ELEVATION




WEST ELEVATION - HIGHLAND AVENUE

ISSUE DATE: 21 JULY 2023 PROJECT NUMBER: 202221 DRAWN BY: ZWR CHECKED BY: **REVISIONS:** NO REFERENCE ISSUED


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DONNA CARTER
TEXAS REGISTRATION NUMBER #8207

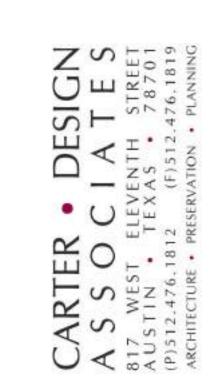


605 HIGHLAND RESIDENCE

EXISTING CONDITION **PHOTOS**

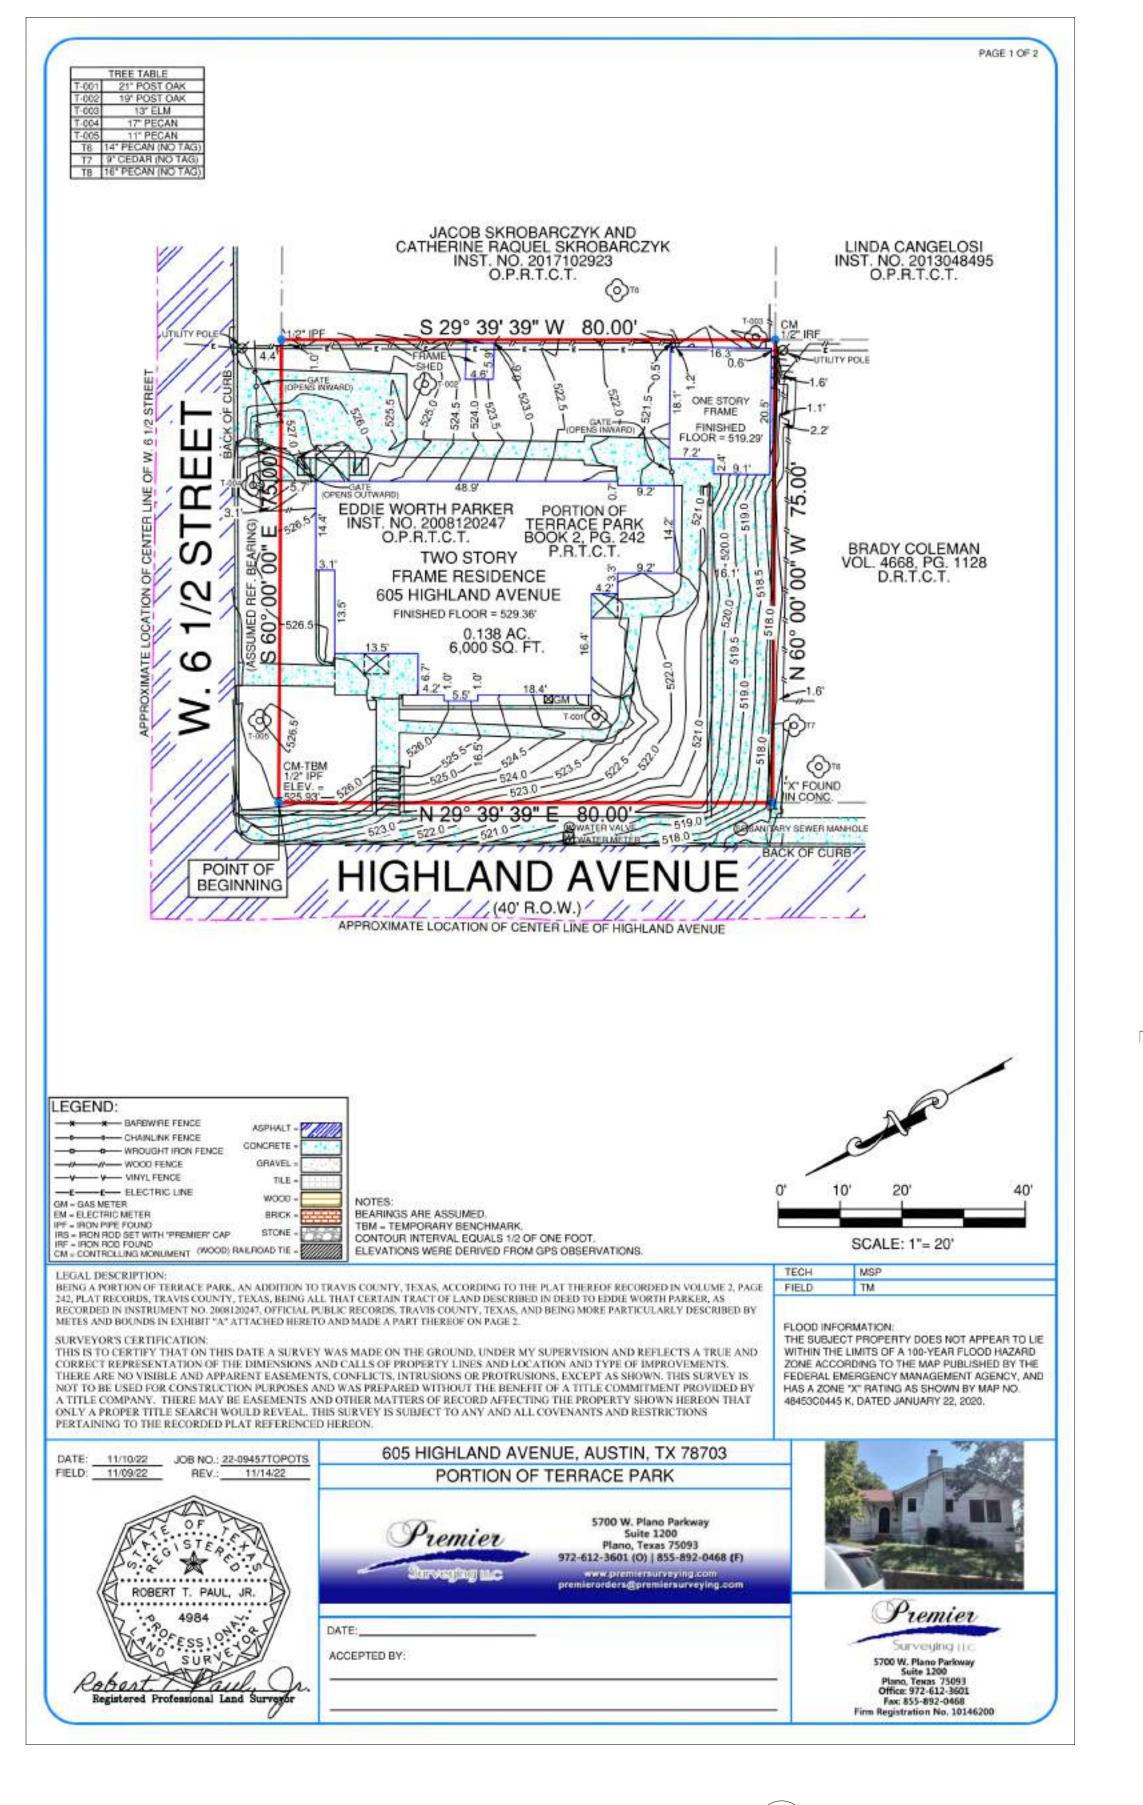

1/2" = 1'-0"

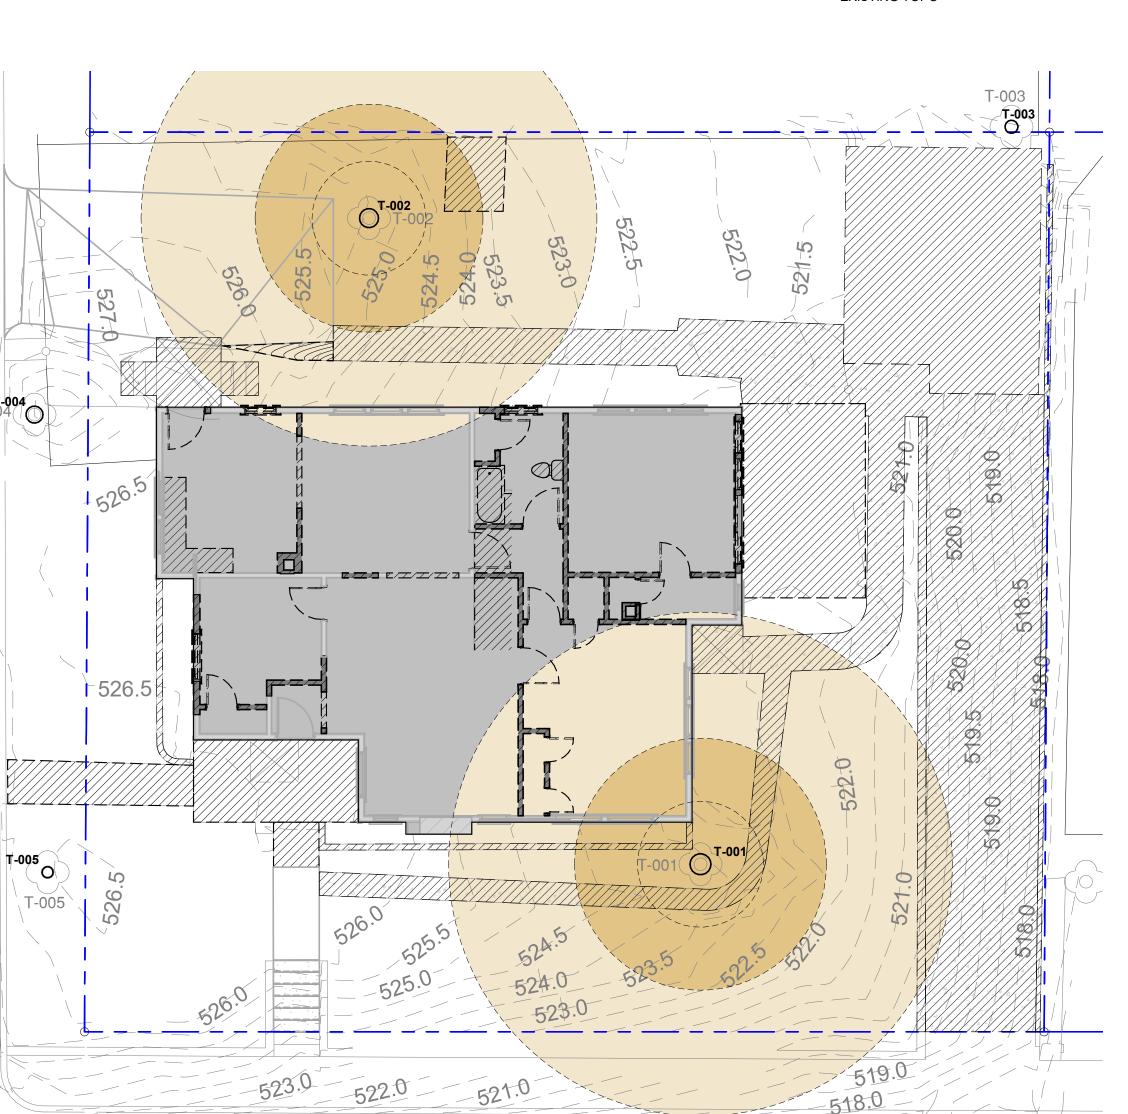

EXISTING CONCRETE TO REMAIN

CONCRETE

LEGEND

EXISTING ASPHALT TO REMAIN

ASPHALT

NEW ADDITION

PERVIOUS PLANTINGS


EXISTING BUILDING TO REMAIN

PROTECTED TREES

AREA TO BE REMODELED



1/2 AND 1/4 CRITICAL ROOT

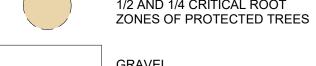

GRAVEL



AREA TO BE MULCHED

NEW TOPO LINE

572.3' — — EXISTING TOPO

SITE PLAN NOTES

- 1. EXISTINGS CONDITIONS ARE BASED ON SURVEY PERFORMED BY PREMIER SURVEYING LLC DATED 11/14/22, VISUAL INSPECTION AND OWNER PROVIDED INFORMATION.
- 2. VERIFY EXISTING SITE CONDITIONS AND REPORT ANY DISCREPANICES BETWEEN ACTUAL FIELD CONDITIONS AND THESE
- PLANS PRIOR TO COMMENCING WORK. ALL NEW SIDEWALKS TO HAVE MAX 1:20 GRADE WITH CROSS SLOPE
- TO DRAIN AT 1/4" PER FOOT AND BROOM FINISH UNLESS OTHERWISE
- 4. REFER TO SHEET G101 FOR VISITIBILITY REQUIREMENTS. 5. FIRST FLOOR ENTRANCES SHALL HAVE MAX 1/2" BEVELED
- THRESHOLDS. 6. ENSURE GRADE SLOPES AWAY FROM BUILDING ALONG ENTIRE
- 7. THE SITE PLAN SHOWS ONLY PROTECTED TREES. OTHER TREES BELOW 19" ARE SHOWN ON THE EXISTING CONDITIONS PLAN AND ARE TO REMAIN AND BE SIMILARLY PROTECTED DURING CONSTRUCTION AS REASONABLE UNLESS SPECIFICALLY LABELED TO BE REMOVED.
- 8. TREES ARE SHOWING WITH ACTUAL DIAMETER.
- 9. ALL SITE AREAS WITH NO NEW LANDSCAPE OR HARDSCAPE SHALL BE RESTORED TO EXISTING CONDITION.
- 10. FRONT YARD IMPERVIOUS COVER =

TREE PROTECTION NOTES

1 BEFORE CONSTRUCTION

PERIMETER.

- 1.1 ALL TREES AND NATURAL AREAS SHOWN ON PLAN TO BE PRESERVED SHALL BE PROTECTED PER ECM 3.6.1.
- 1.2 TREE PROTECTION SHALL BE INSTALLED PRIOR TO THE START OF ANY SITE WORK, INCLUDING DEMOLITION OR SITE PREPARATION. REFER TO ECM 3.6.1.A.
- 1.3 FENCING FOR TREE PROTECTION SHALL BE CHAIN-LINK MESH WITH A MINIMUM HEIGHT OF 5 FEET AND SHALL BE INSTALLED AROUND OR BEYOND THE CRITICAL ROOT ZONE EXCEPT AS ALLOWED IN ECM 3.6.1.B.4.
- 1.4 UNFENCED SECTIONS OF THE CRITICAL ROOT ZONE SHALL BE COVERED WITH MULCH AT A MINIMUM DEPTH OF 8 INCHES AND A MAXIMUM DEPTH OF 12 INCHES PER ECM 3.6.1.C.
- 1.5 WHERE FENCING IS LOCATED 5 FEET OR LESS FROM THE TRUNK OF A PRESERVED TREE, TRUNK WRAPPING SHALL BE INSTALLED PER
- 1.6 EROSION AND SEDIMENTATION CONTROLS SHALL BE INSTALLED AND MAINTAINED SO AS NOT TO CAUSE IMPACTS THAT EXCEED PRESERVATION CRITERIA LISTED IN ECM 3.5.3.D.
- 2 DURING CONSTRUCTION
- 2.1 TREES APPROVED FOR REMOVAL SHALL BE REMOVED IN A MANNER THAT DOES NOT EXCEED PRESERVATION CRITERIA FOR THE TREES TO REMAIN. REFER TO ECM 3.5.2 A.
- 2.2 FENCING MAY NOT BE TEMPORARILY MOVED OR REMOVED DURING DEVELOPMENT WITHOUT PRIOR AUTHORIZATION. THE FENCED CRITICAL ROOT ZONE SHALL NOT BE USED FOR TOOL OR MATERIAL STORAGE OF ANY KIND AND SHALL BE KEPT FREE OF LITTER. REFER
- 2.3 PRUNING SHALL BE IN COMPLIANCE WITH THE CURRENT ANSI A300 STANDARD FOR TREE CARE.
- 3 AFTER CONSTRUCTION
- 3.1 TREE PROTECTION SHALL BE REMOVED AT THE END OF THE PROJECT AFTER ALL CONSTRUCTION AND FINAL GRADING IS COMPLETE, BUT BEFORE FINAL INSPECTION. REFER TO ECM 3.6.1.A
- 3.2 LANDSCAPE INSTALLATION WITHIN THE CRZ OF PRESERVED TREES, INCLUDING IRRIGATION, SOIL AND PLANTINGS, SHALL NOT EXCEED PRESERVATION CRITERIA LISTED IN ECM 3.5.2.
- 3.3 DOCUMENTATION OF TREE WORK PERFORMED MUST BE PROVIDED TO INSPECTOR PER ECM APPENDIX P-6.
- 3.4 THIS LIST IS NOT EXHAUSTIVE. REFER TO APPROPRIATE ECM SECTIONS FOR FULL REQUIREMENTS.

TREE LIST

T-001 21" POST OAK T-002 19" POST OAK

T-003 13" ELM T-004 17" PECAN T-005 11" PECAN

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ISSUE DATE:

DRAWN BY:

REVISIONS:

CHECKED BY:

PROJECT NUMBER:

NO REFERENCE ISSUED

21 JULY 2023

202221

ZWR

DDC

DONNA CARTER **TEXAS REGISTRATION NUMBER #8207**



HIGHLAND

EXISTING SITE CONDITIONS &

DEMO

EXISTING SITE CONDITIONS & DEMO

1/8" = 1'-0"

PLAN Z

Site Development Information		ing to nain	New/	Added	Tota	I SF
Permit Application page 2	Bldg 1	Bldg 2	Bldg 1	Bldg 2	Bldg 1	Bldg 2
a) 1st Floor Conditioned Area	1469	0	0	0	1469	(
b) 2nd Floor Conditioned Area	0	0	0	0	0	(
c) 3rd Floor Conditioned Area	0	0	0	0	0	(
d) Basement	463.77	0	604.59	0	1068	(
e) Covered Parking (garage or carport)	0	0	0	0	0	(
f) Covered patio, deck, porch and balconies	0	0	445.65	0	445.65	(
g) Other covered or roofed areas	0	0	36.1	0	36.1	(
h) Uncovered Wood Decks (counts at 50%)	0	0	77.29	0	77.29	
Total Building Area (a through h)	1932	0	1163	0	3096	(
i) Pool	0	0	199.11	0		
j) Spa	0	0	0	0		
k) Remodeled Floor Area, excluding Addition/ New construction	0	0				

Calculation Aid				
Permit Application page 7		Existing SF	New/Added SF	Total SF
		•		
a) 1st Floor Conditioned Are	а	1469.22	0	1469.22
b) 2nd Floor Conditioned Are	ea	0	0	0
c) 3rd Floor Conditioned Are	a	0	0	0
d) Basement		463.77	604.59	1068.36
e) Attached Covered Parking	g (garage or	0	0	0
f) Detached Covered Parkir	ng (garage or	0	0	0
g) Covered Wood Decks (co	unt at 100%)	0	0	0
h) Covered Patio		0	445.65	445.65
i) Covered Porch		0	0	0
j) Balcony		0	0	0
k) Other: Specifiy	Extended	0	76.02	76.02
Total Building Area (TBA) (ad	ld a thru k)	1932.99	1126.26	3059.25
Total Building Coverage (TBC				
(TBA minus, if applicable: b,	c,d and j)	1469.22	521.67	1990.89
I) Driveway		255.87	0	255.87
m) Sidewalks		0	110	110
n) Uncovered Patio		0	0	0
o) Uncovered Wood Decks ((counted at 50%)	0	38.645	38.645
p) AC pads & other Flatwork		0	18	18
q) Other (Pool coping & Reta	aining Walls)	0	224.34	224.34
Total Site Impervious Covera	ge			
(sum TBC + I thru q)		1725.09	912.655	2637.745
r) Pool		0	199.11	199.11
s) Spa		0	0	0

Existing Building Coverage	24%	
Final Building Coverage		33%
pervious Coverage Calculation		
Existing Impervious Coverage	29%	

Existing

LEGEND

Building Coverage Calculation



CONCRETE

EXISTING ASPHALT TO REMAIN





NEW ADDITION



EXISTING BUILDING TO REMAIN

AREA TO BE REMODELED



CRITICAL ROOT ZONES OF PROTECTED TREES



1/2 AND 1/4 CRITICAL ROOT ZONES OF PROTECTED TREES



AREA TO BE MULCHED



NEW TOPO LINE

<u>572.3'</u>____ EXISTING TOPO

GENERAL NOTES

- 1. ALL CONSTRUCTION SHALL COMPLY WITH THE CURRENT ADOPTED
- EDITION OF THE IRC INCLUDING ALL CURRENT LOCAL AMENDMENTS. 2. WIND, SEISMIC AND THERMAL ENVELOPE REQUIREMENTS SHALL BE DETERMINED BASED ON SPECIFIC PROJECT LOCATION.
- 3. PROVIDE SAFETY GLAZING IN DOORS AND WINDOWS IN
- COMPLIANCE WITH IRC SECTION 308. 4. GUARDRAILS AND WINDOW FALL PROTECTION SHALL BE IN COMPLIANCE WITH IRC SECTION 312.
- 5. PROVIDE FIRE SPRINKLERS IN COMPLIANCE WITH IRC SECTION 313. 6. PROVIDE SMOKE DETECTORS IN AND OUTSIDE ALL BEDROOMS AND SLEEPING AREAS IN COMPLIANCE WITH IRC PER SECTION 314. MOUNT PER MANUFACTUER'S RECOMMENDATION.
- 7. CARBON MONOXIDE ALARMS SHALL BE INSTALLED OUTSIDE SLEEPING ROOMS AND IN COMPLIANCE WITH IRC SECTION 315. mount per manufactures' recommendation.
- 8. PROVIDE ATTIC ACCESS PULL DOWN LADDER AT EACH ATTIC SPACE. 9. PROVIDE A MIN 30" SPACE CENTERED ON WATER CLOSETS AT ALL LOCATIONS UNLESS NOTED TO BE MORE. PROVIDE A MINIMUM OF 21" IN FRONT OF WATER CLOSETS.
- 10 PROVIDE DRAFT BLOCKING BETWEEN FLOORS, BETWEEN FLOORS AND ATTIC, HORIZONTALLY AT 10' MAX INCREMENTS AND AS REQUIRED BY IRC SECTION 302.11.

SITE PLAN NOTES

- 1. EXISTINGS CONDITIONS ARE BASED ON SURVEY PERFORMED BY PREMIER SURVEYING LLC DATED 11/14/22, VISUAL INSPECTION AND OWNER PROVIDED INFORMATION.
- 2. VERIFY EXISTING SITE CONDITIONS AND REPORT ANY DISCREPANICES BETWEEN ACTUAL FIELD CONDITIONS AND THESE PLANS PRIOR TO COMMENCING WORK.
- 3. ALL NEW SIDEWALKS TO HAVE MAX 1:20 GRADE WITH CROSS SLOPE TO DRAIN AT 1/4" PER FOOT AND BROOM FINISH UNLESS OTHERWISE
- 4. REFER TO SHEET G101 FOR VISITIBILITY REQUIREMENTS. 5. FIRST FLOOR ENTRANCES SHALL HAVE MAX 1/2" BEVELED
- THRESHOLDS. 6. ENSURE GRADE SLOPES AWAY FROM BUILDING ALONG ENTIRE PERIMETER.
- 7. THE SITE PLAN SHOWS ONLY PROTECTED TREES. OTHER TREES BELOW 19" ARE SHOWN ON THE EXISTING CONDITIONS PLAN AND ARE TO REMAIN AND BE SIMILARLY PROTECTED DURING CONSTRUCTION AS REASONABLE UNLESS SPECIFICALLY LABELED TO BE REMOVED.
- 8. TREES ARE SHOWING WITH ACTUAL DIAMETER.
- 9. ALL SITE AREAS WITH NO NEW LANDSCAPE OR HARDSCAPE SHALL BE RESTORED TO EXISTING CONDITION.
- 10. FRONT YARD IMPERVIOUS COVER = _____

TREE PROTECTION NOTES

1 BEFORE CONSTRUCTION

Total

- 1.1 ALL TREES AND NATURAL AREAS SHOWN ON PLAN TO BE PRESERVED SHALL BE PROTECTED PER ECM 3.6.1.
- 1.2 TREE PROTECTION SHALL BE INSTALLED PRIOR TO THE START OF ANY SITE WORK, INCLUDING DEMOLITION OR SITE PREPARATION. REFER TO ECM 3.6.1.A.
- 1.3 FENCING FOR TREE PROTECTION SHALL BE CHAIN-LINK MESH WITH A MINIMUM HEIGHT OF 5 FEET AND SHALL BE INSTALLED AROUND OR BEYOND THE CRITICAL ROOT ZONE EXCEPT AS ALLOWED IN ECM 3.6.1.B.4.
- 1.4 UNFENCED SECTIONS OF THE CRITICAL ROOT ZONE SHALL BE COVERED WITH MULCH AT A MINIMUM DEPTH OF 8 INCHES AND A
- MAXIMUM DEPTH OF 12 INCHES PER ECM 3.6.1.C. 1.5 WHERE FENCING IS LOCATED 5 FEET OR LESS FROM THE TRUNK OF A PRESERVED TREE, TRUNK WRAPPING SHALL BE INSTALLED PER
- ECM 3.6.1.D. 1.6 EROSION AND SEDIMENTATION CONTROLS SHALL BE INSTALLED AND MAINTAINED SO AS NOT TO CAUSE IMPACTS THAT EXCEED PRESERVATION CRITERIA LISTED IN ECM 3.5.3.D.
- 2 DURING CONSTRUCTION
- 2.1 TREES APPROVED FOR REMOVAL SHALL BE REMOVED IN A MANNER THAT DOES NOT EXCEED PRESERVATION CRITERIA FOR THE TREES TO REMAIN. REFER TO ECM 3.5.2 A.
- 2.2 FENCING MAY NOT BE TEMPORARILY MOVED OR REMOVED DURING DEVELOPMENT WITHOUT PRIOR AUTHORIZATION. THE FENCED CRITICAL ROOT ZONE SHALL NOT BE USED FOR TOOL OR MATERIAL STORAGE OF ANY KIND AND SHALL BE KEPT FREE OF LITTER. REFER TO ECM 3.6.1.B.3.
- 2.3 PRUNING SHALL BE IN COMPLIANCE WITH THE CURRENT ANSI A300 STANDARD FOR TREE CARE.
- 3 AFTER CONSTRUCTION
- 3.1 TREE PROTECTION SHALL BE REMOVED AT THE END OF THE PROJECT AFTER ALL CONSTRUCTION AND FINAL GRADING IS COMPLETE, BUT BEFORE FINAL INSPECTION. REFER TO ECM 3.6.1.A.
- 3.2 LANDSCAPE INSTALLATION WITHIN THE CRZ OF PRESERVED TREES, INCLUDING IRRIGATION, SOIL AND PLANTINGS, SHALL NOT EXCEED PRESERVATION CRITERIA LISTED IN ECM 3.5.2.
- 3.3 DOCUMENTATION OF TREE WORK PERFORMED MUST BE PROVIDED TO INSPECTOR PER ECM APPENDIX P-6.
- 3.4 THIS LIST IS NOT EXHAUSTIVE. REFER TO APPROPRIATE ECM SECTIONS FOR FULL REQUIREMENTS.

TREE LIST

T-001 21" POST OAK T-002 19" POST OAK T-003 13" ELM


T-004 17" PECAN T-005 11" PECAN

ISSUE DATE: 21 JULY 2023 PROJECT NUMBER: 202221 DRAWN BY: **ZWR** CHECKED BY: **REVISIONS:** NO REFERENCE ISSUED

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DONNA CARTER **TEXAS REGISTRATION NUMBER #8207**



HIGHI SIDE 605 RE

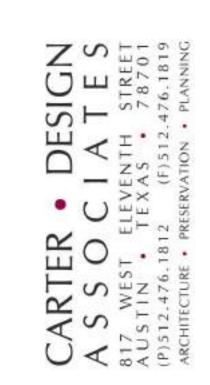SITE PLAN & LDC

CALCULATIONS

1/8" = 1'-0"

ARCHITECTURAL SITE PLAN


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GROUND LEVEL FFE 529.36'

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U.C.



9 GROUND LI
1/4" = 1'-0"

GROUND LEVEL - ANNOTATION PLAN

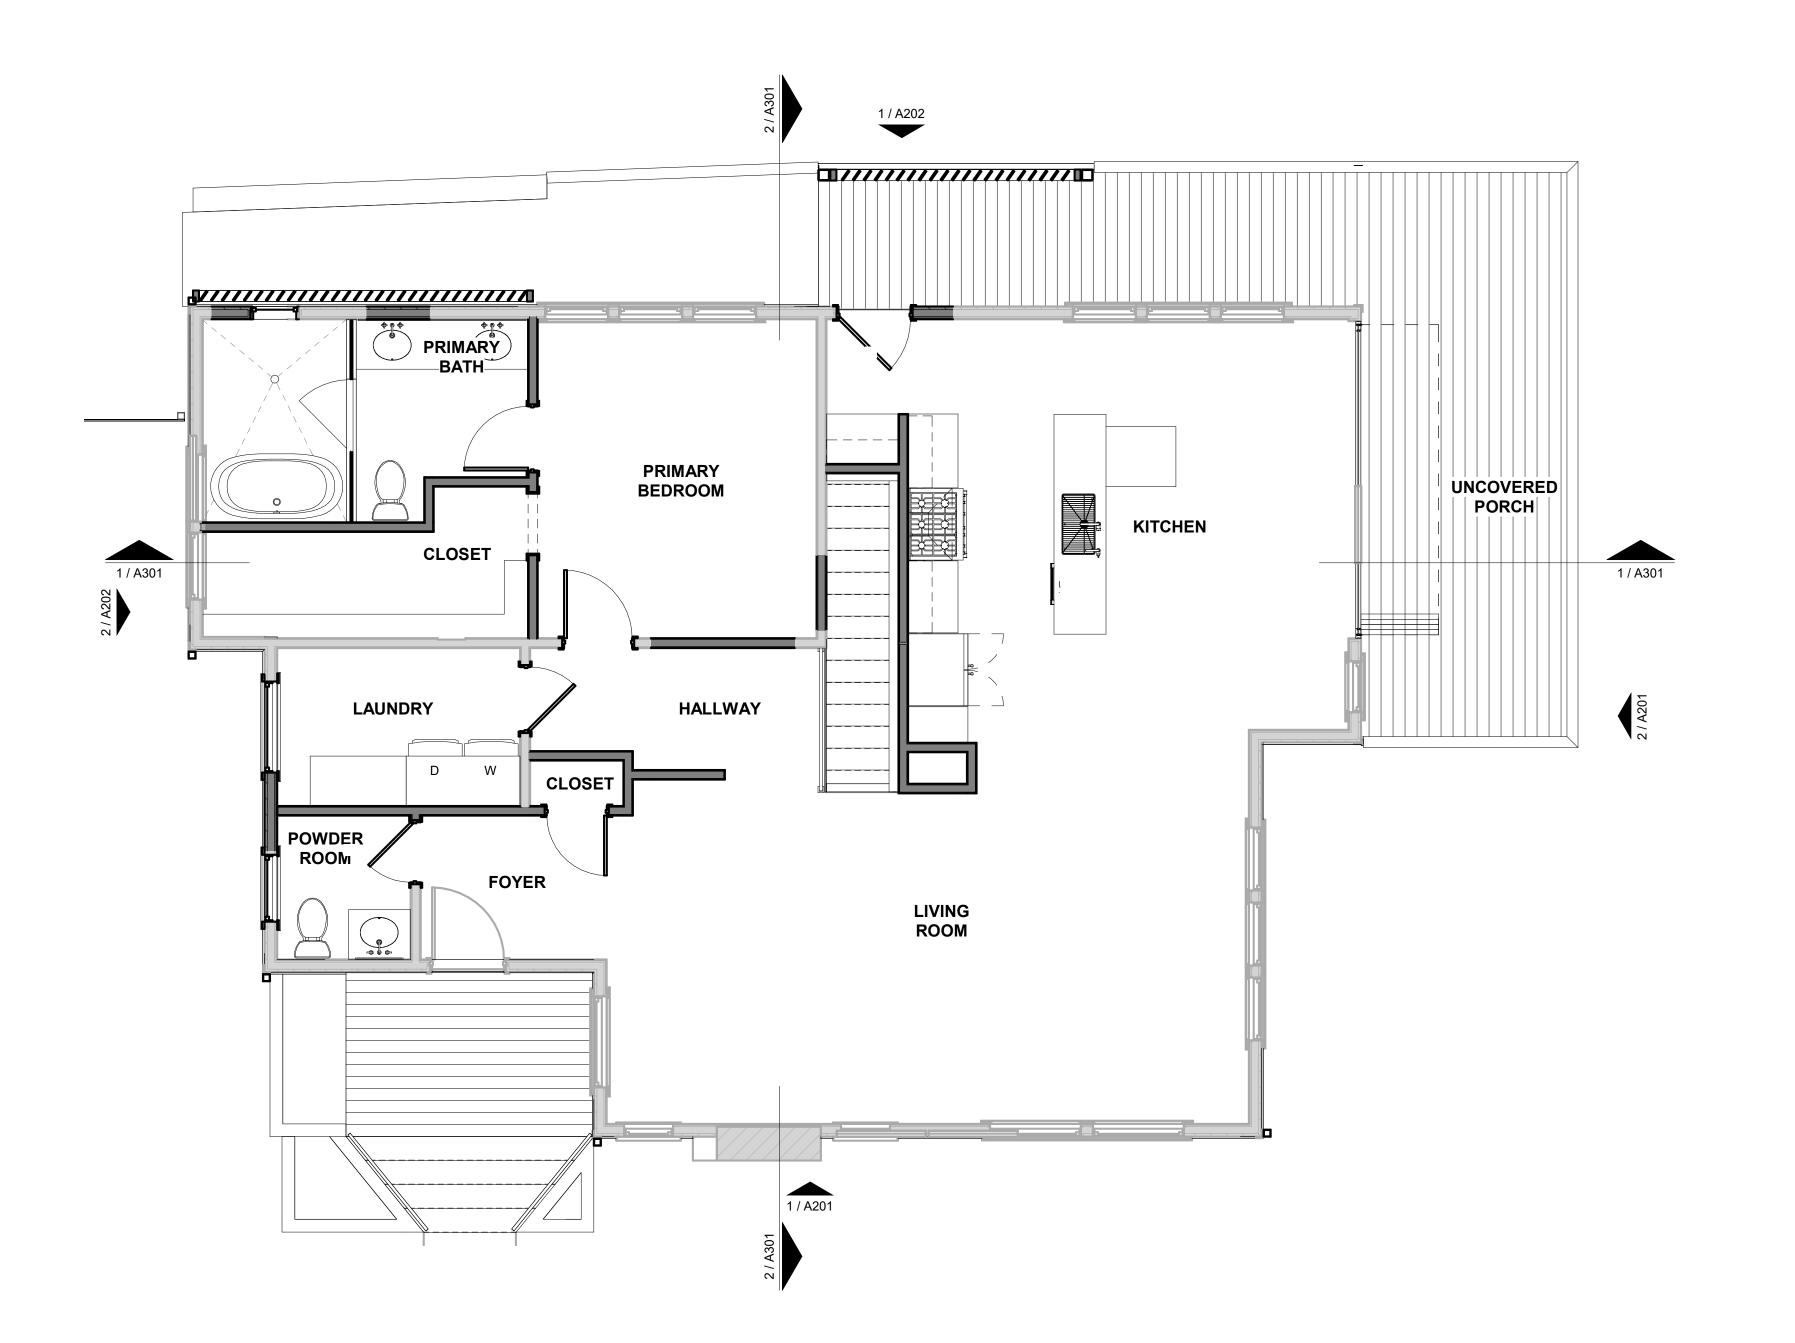GENERAL NOTES

- 1. ALL CONSTRUCTION SHALL COMPLY WITH THE CURRENT ADOPTED EDITION OF THE IRC INCLUDING ALL CURRENT LOCAL AMENDMENTS.
- 2. WIND, SEISMIC AND THERMAL ENVELOPE REQUIREMENTS SHALL BE
- DETERMINED BASED ON SPECIFIC PROJECT LOCATION. 3. PROVIDE SAFETY GLAZING IN DOORS AND WINDOWS IN
- COMPLIANCE WITH IRC SECTION 308. 4. GUARDRAILS AND WINDOW FALL PROTECTION SHALL BE IN
- COMPLIANCE WITH IRC SECTION 312.
- 5. PROVIDE FIRE SPRINKLERS IN COMPLIANCE WITH IRC SECTION 313. 6. PROVIDE SMOKE DETECTORS IN AND OUTSIDE ALL BEDROOMS AND SLEEPING AREAS IN COMPLIANCE WITH IRC PER SECTION 314. MOUNT PER MANUFACTUER'S RECOMMENDATION.
- 7. CARBON MONOXIDE ALARMS SHALL BE INSTALLED OUTSIDE SLEEPING ROOMS AND IN COMPLIANCE WITH IRC SECTION 315. mOUNT PER MANUFACTURES' RECOMMENDATION.
- 8. PROVIDE ATTIC ACCESS PULL DOWN LADDER AT EACH ATTIC SPACE. 9. PROVIDE A MIN 30" SPACE CENTERED ON WATER CLOSETS AT ALL LOCATIONS UNLESS NOTED TO BE MORE. PROVIDE A MINIMUM OF 21" IN FRONT OF WATER CLOSETS.
- 10 PROVIDE DRAFT BLOCKING BETWEEN FLOORS, BETWEEN FLOORS AND ATTIC, HORIZONTALLY AT 10' MAX INCREMENTS AND AS REQUIRED BY IRC SECTION 302.11.

GENERAL NOTES - FLOOR PLAN


- 1. DO NOT SCALE DRAWINGS. WRITTEN DIMENSIONS GOVERN. 2. ALL DIMENSIONS ARE TO FACE OF STUD OR FACE OF MASONRY, UNLESS OTHERWISE NOTED.
- 3. ALL EXTERIOR WALL PARTITIONS ARE 2 x 6 WOOD STUDS WITH 5/8" GYPSUM BOARD AT INTERIOR FACE, AND EXTERIOR ENVELOPE REQUIREMENTS PER IRC AND LOCAL AMENDMENTS AND EXTERIOR FINISH UNLESS OTHERWISE NOTED.
- 4. ALL EXTERIOR SIDING, PANELS, PLASTER AND STUCCO SHALL BE INSTALLED AS A RAINSCREEN SYTEM UNLESS SPECIFICALLY NOTED OTHERWISE.
- 5. ALL INTERIOR WALL PARTITIONS ARE 2 x 4 WOOD STUDS WITH SOUND BATT INSULATION AND 5/8" GYPSUM BOARD UNLESS OTHERWISE NOTED.
- 6. REFER TO SLAB PLAN FOR LAYOUT DIMENSIONS.
- 7. REFER TO STRUCTURAL SHEETS FOR FOUNDATION AND FRAMING. 8. COORDINATE ALL KITCHEN AND BATHROOM DIMENSIONS AND
- UTILITY REQUIREMENTS WITH OWNER'S SPECIFIC CHOICES OF FIXTURES, APPLIANCES AND CABINETS.
- 9. FIRST FLOOR ENTRANCES SHALL HAVE MAX 1/2" BEVELED THRESHOLD.
- 10. PROVIDE 2 x 6 BLOCKING AT CENTER LINE OF 34" AFF AT WALLS IN SHOWERS, BATHTUBS AND ADJACENT TO WATERCLOSETS.
- 11. ALL PORCH AND BALCONY FLOORS SHALL SLOPE TO DRAIN AWAY FROM BUILDING.
- 12. COORDINATE ALL FINAL OWNER CHOSEN FLOOR FINISHES WITH CONCRETE SLAB PRIOR TO PLACEMENT FOR CONINUOUS FLOOR

	ISSUE DATE: 21	JULY 2023
	PROJECT NUMBER:	202221
	DRAWN BY:	ZWR
S.	CHECKED BY:	DDC
	REVISIONS:	
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DONNA CARTER TEXAS REGISTRATION NUMBER #8207



GROUND LEVEL -ANNOTATION PLAN


LEGEND

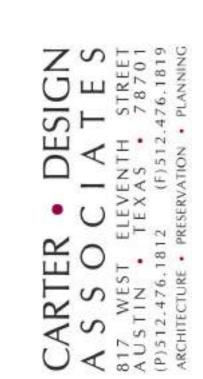ELECTRIC SERVICE METER / WEATHERHEAD


TANKLESS WATER HEATER

GAS CONNECTION

CONCRETE FINISH

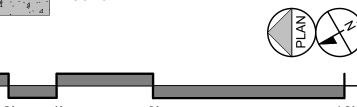

DOWNSPOUT WITH SPLASHBLOCK

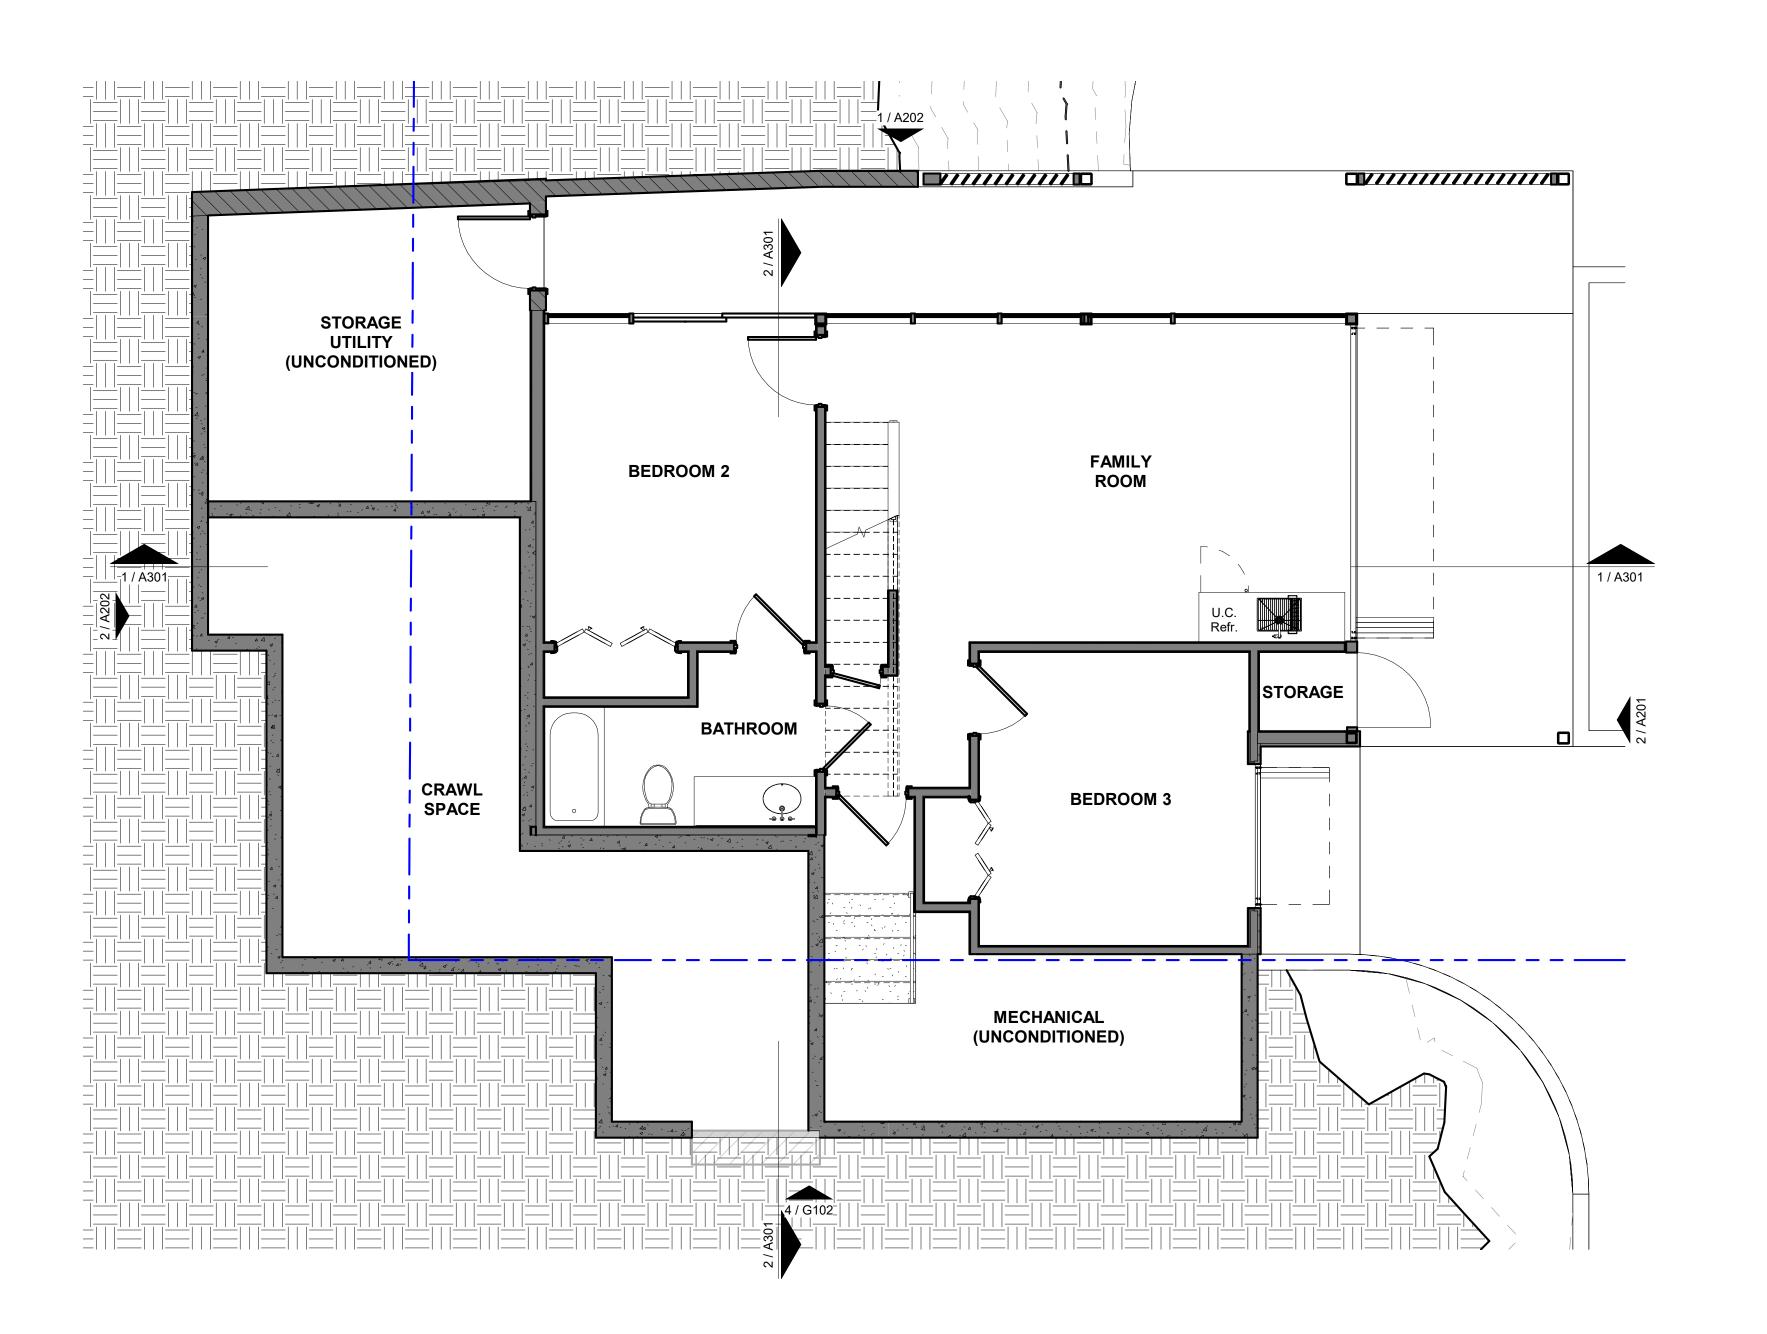

GENERAL NOTES

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- 7. CARBON MONOXIDE ALARMS SHALL BE INSTALLED OUTSIDE SLEEPING ROOMS AND IN COMPLIANCE WITH IRC SECTION 315. **MOUNT PER MANUFACTURES' RECOMMENDATION.**
- 8. PROVIDE ATTIC ACCESS PULL DOWN LADDER AT EACH ATTIC SPACE. 9. PROVIDE A MIN 30" SPACE CENTERED ON WATER CLOSETS AT ALL LOCATIONS UNLESS NOTED TO BE MORE. PROVIDE A MINIMUM OF 21" IN FRONT OF WATER CLOSETS.
- 10 PROVIDE DRAFT BLOCKING BETWEEN FLOORS, BETWEEN FLOORS AND ATTIC, HORIZONTALLY AT 10' MAX INCREMENTS AND AS REQUIRED BY IRC SECTION 302.11.

GENERAL NOTES - FLOOR PLAN


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ISSUE	E DATE: 21 .	JULY 202
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DONNA CARTER TEXAS REGISTRATION NUMBER #8207



605 HIGHLAND RESIDENCE

LEGEND

ELECTRIC SERVICE METER / WEATHERHEAD

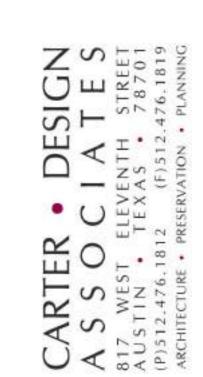GAS METER

TANKLESS WATER HEATER


GAS CONNECTION HOSE BIB

DOWNSPOUT WITH SPLASHBLOCK

GARDEN LEVEL - ANNOTATION PLAN


1/4" = 1'-0"

CONCRETE FINISH

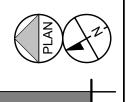

GARDEN LEVEL -

ANNOTATION PLAN

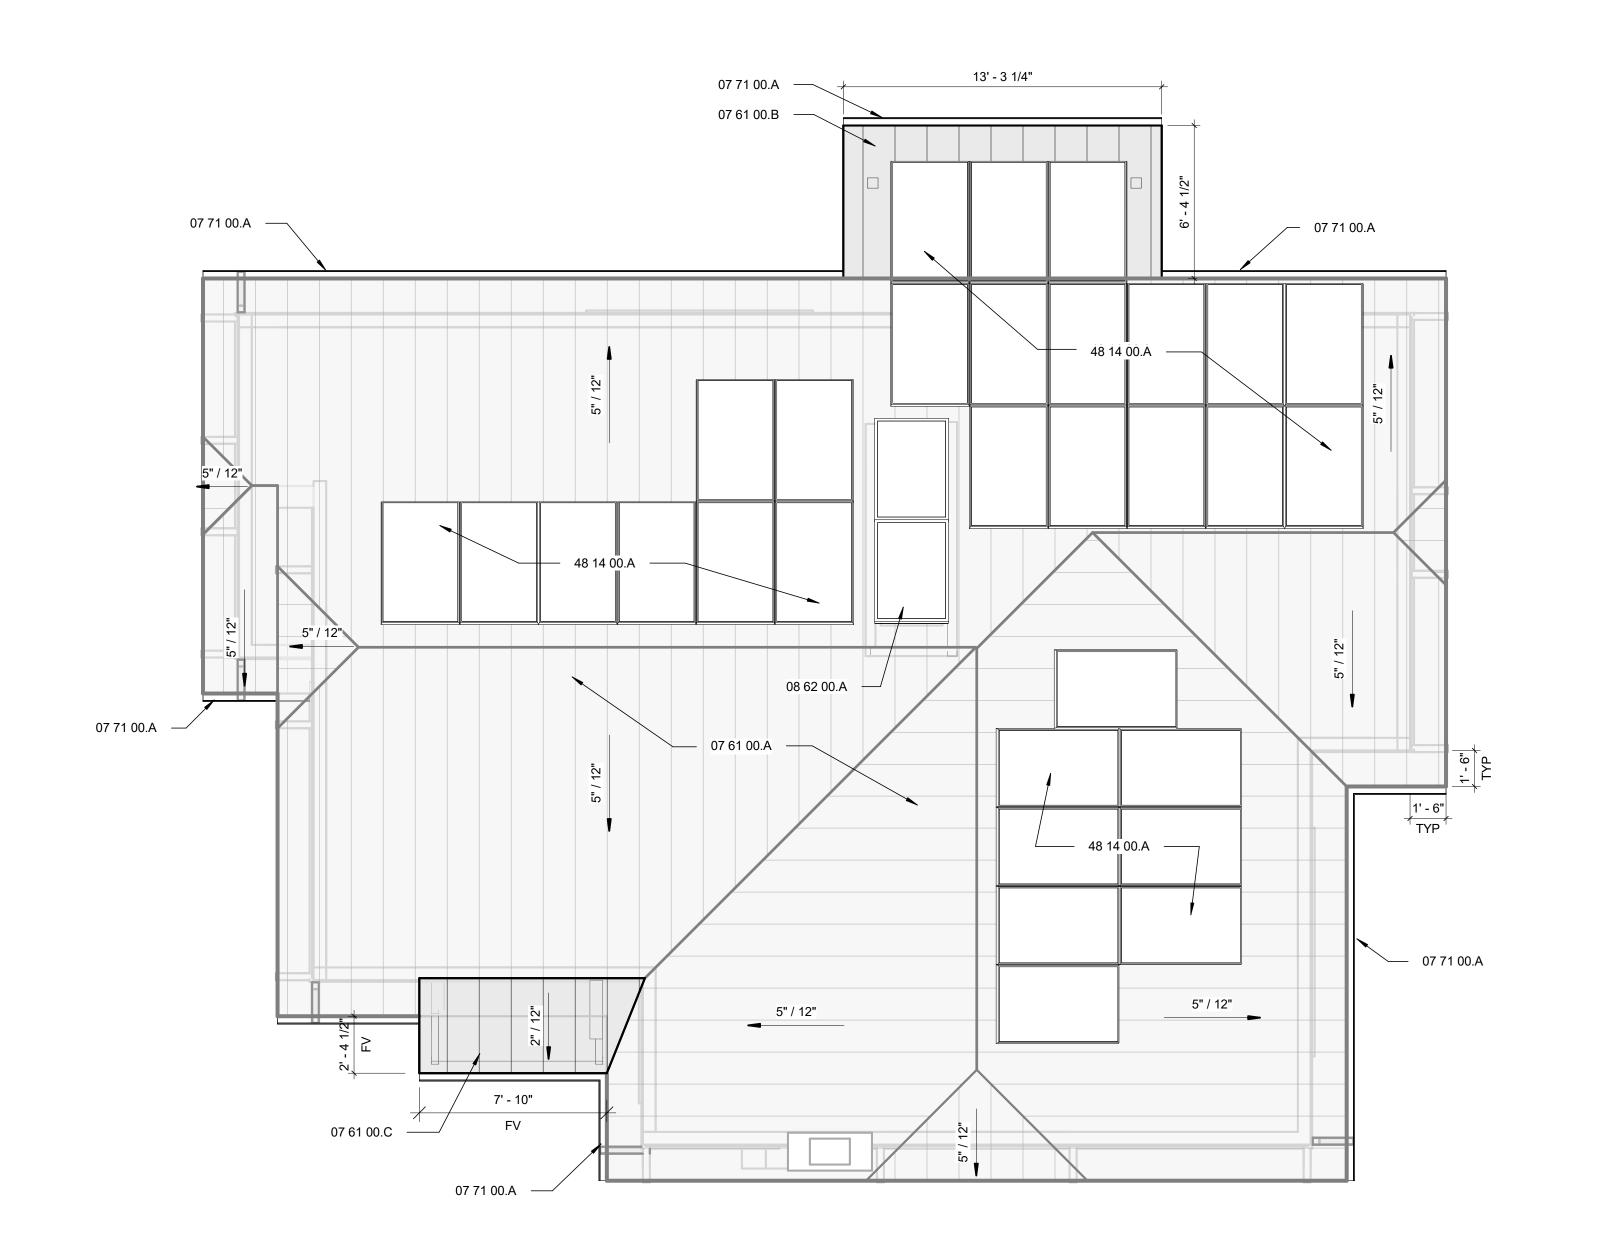



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- 10 PROVIDE DRAFT BLOCKING BETWEEN FLOORS, BETWEEN FLOORS AND ATTIC, HORIZONTALLY AT 10' MAX INCREMENTS AND AS REQUIRED BY IRC SECTION 302.11.

GENERAL NOTES - ROOF

- 1. CONTRACTOR SHALL KEEP BUILDING WEATHER TIGHT.
- 2. ALL ROOFS SHALL SLOPE TO DRAIN.
- 3. CONTRACTOR SHALL PROVIDE ALL TRIM, FLASHING, UNDERLAYMENTS, FASTOVERS AND ACCESSORIES NECESSARY TO ENSURE A COMPLETE, WARRANTABLE, WEATHERTIGHT CONSTRUCTED ROOF.
- 4. AT DOWNSLOPING ROOFS PROVIDE GUTTERS OVER DOORS AND NEAR DOOR APPROACHES. PROVIDE LEAVE PROTECTION AT GUTTERS NEAR TREES. SECURE ALL DOWN SPOUTS SHALL TO BUILDING, DS BOTTOM TO POINT AWAY FROM HOUSE TOWARD SPLASH BLOCK AT GRADE.

KEYNOTES

07 61 00.A STANDING SEAM METAL ROOF OVER EXISTING ROOF DECK 07 61 00.B STANDING SEAM METAL ROOF OVER PORCH

07 61 00.C FRONT ENTRY ROOF. MAINTAIN ORIGINAL FOOTPRINT AND ALIGN WITH ADJACENT FASCIA. REMOVE AND SALVAGE ORIGINAL SUPPORT BRACKETS. REINSTALL BRACKET AT HIGHER ELEVATION TO SUPPORT THE OVERHANG.

07 71 00.A GUTTER AND DOWNSPOUT 08 62 00.A SKYLIGHT

48 14 00.A ROOFTOP SOLAR PANELS

CHECKED BY: **REVISIONS:** NO REFERENCE ISSUED

ISSUE DATE:

DRAWN BY:

PROJECT NUMBER: 202221

21 JULY 2023

ZWR

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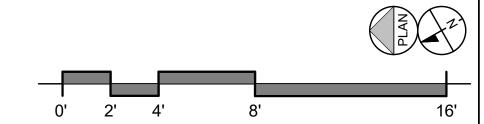
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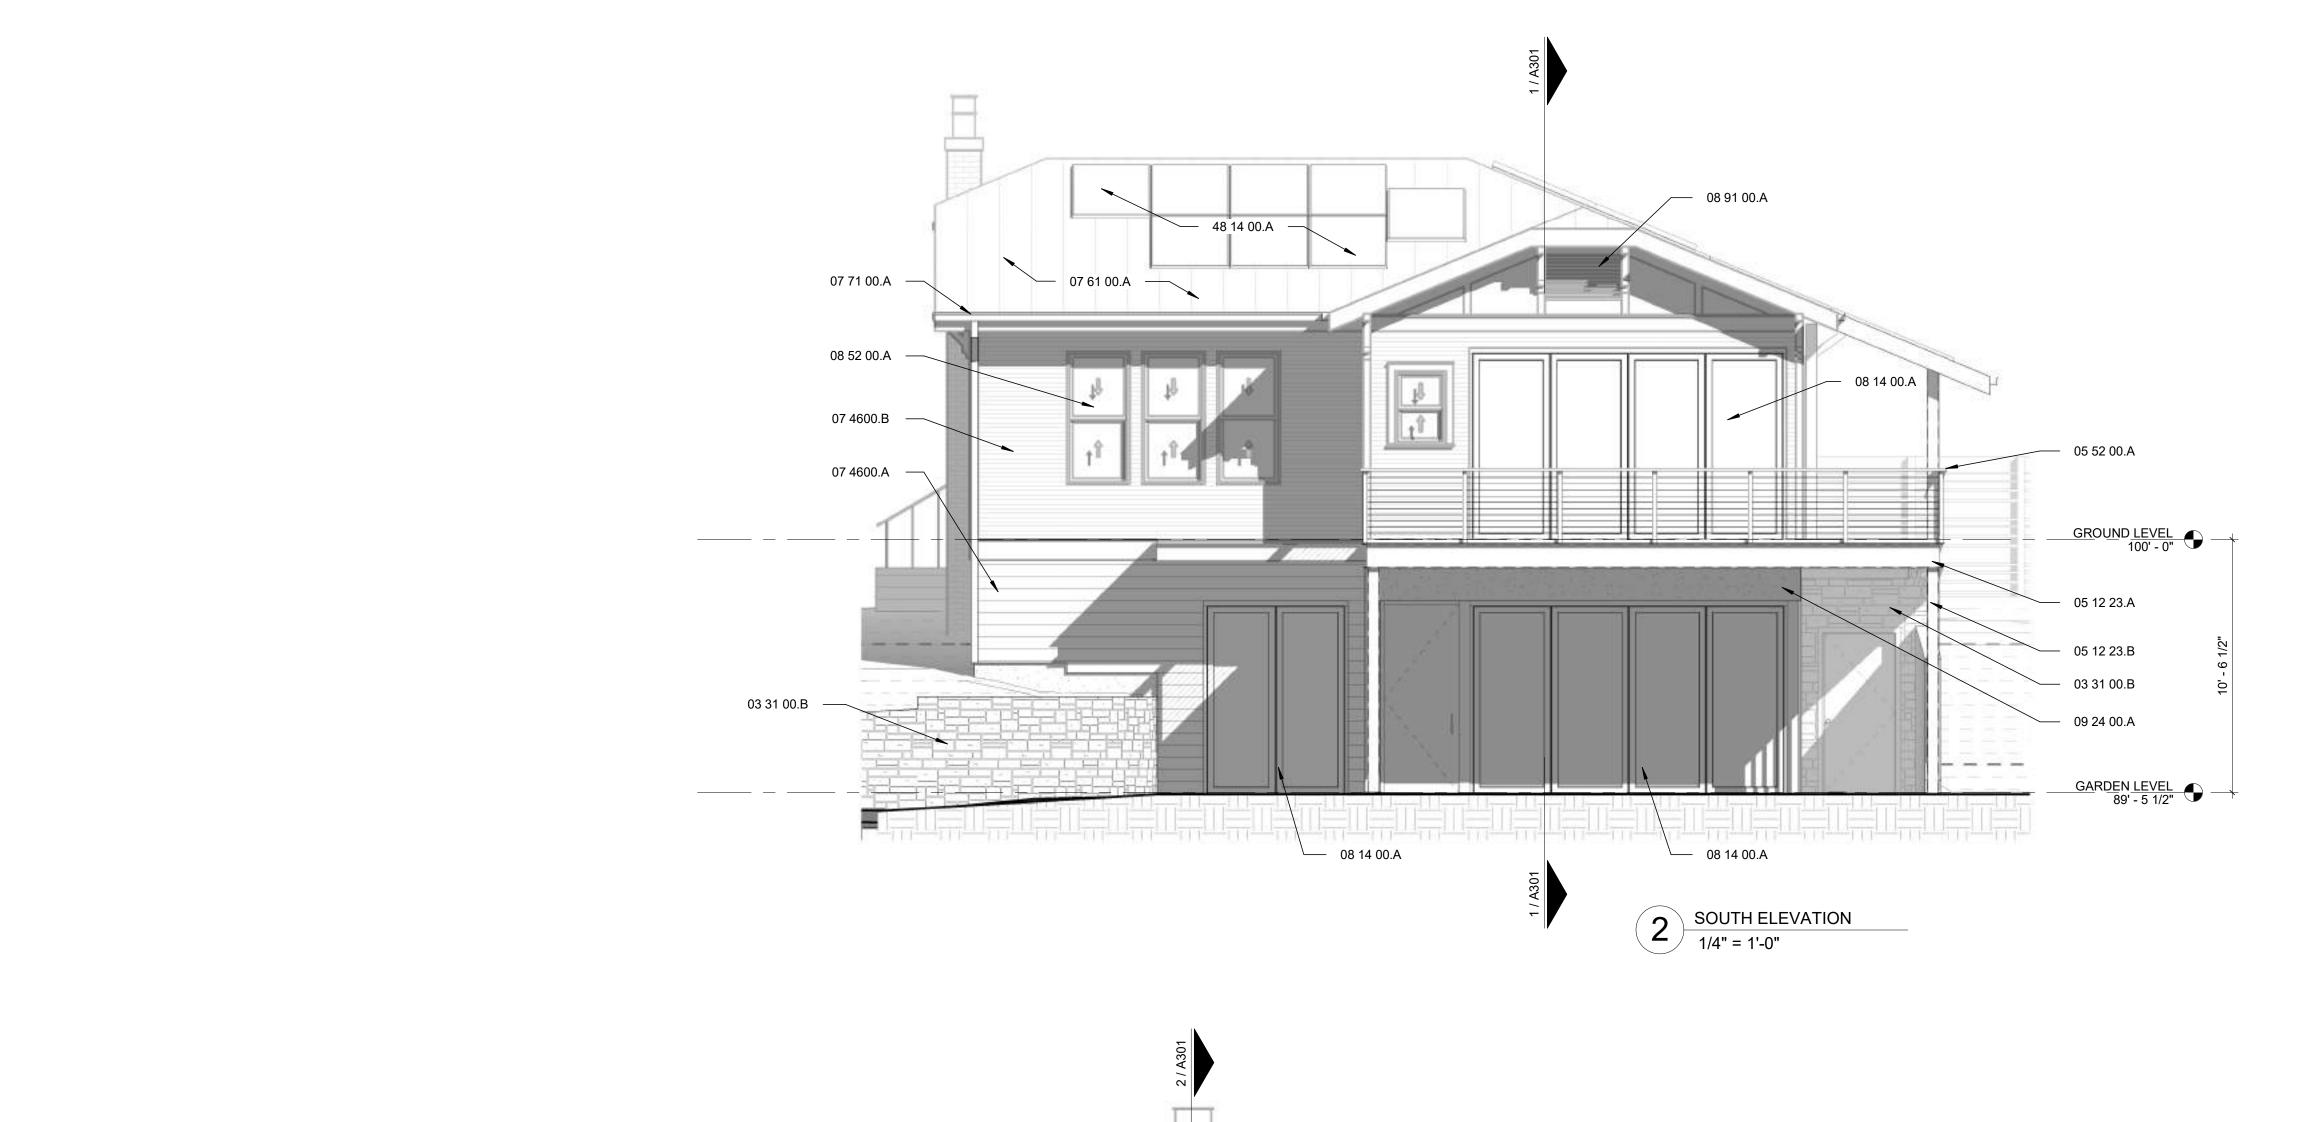
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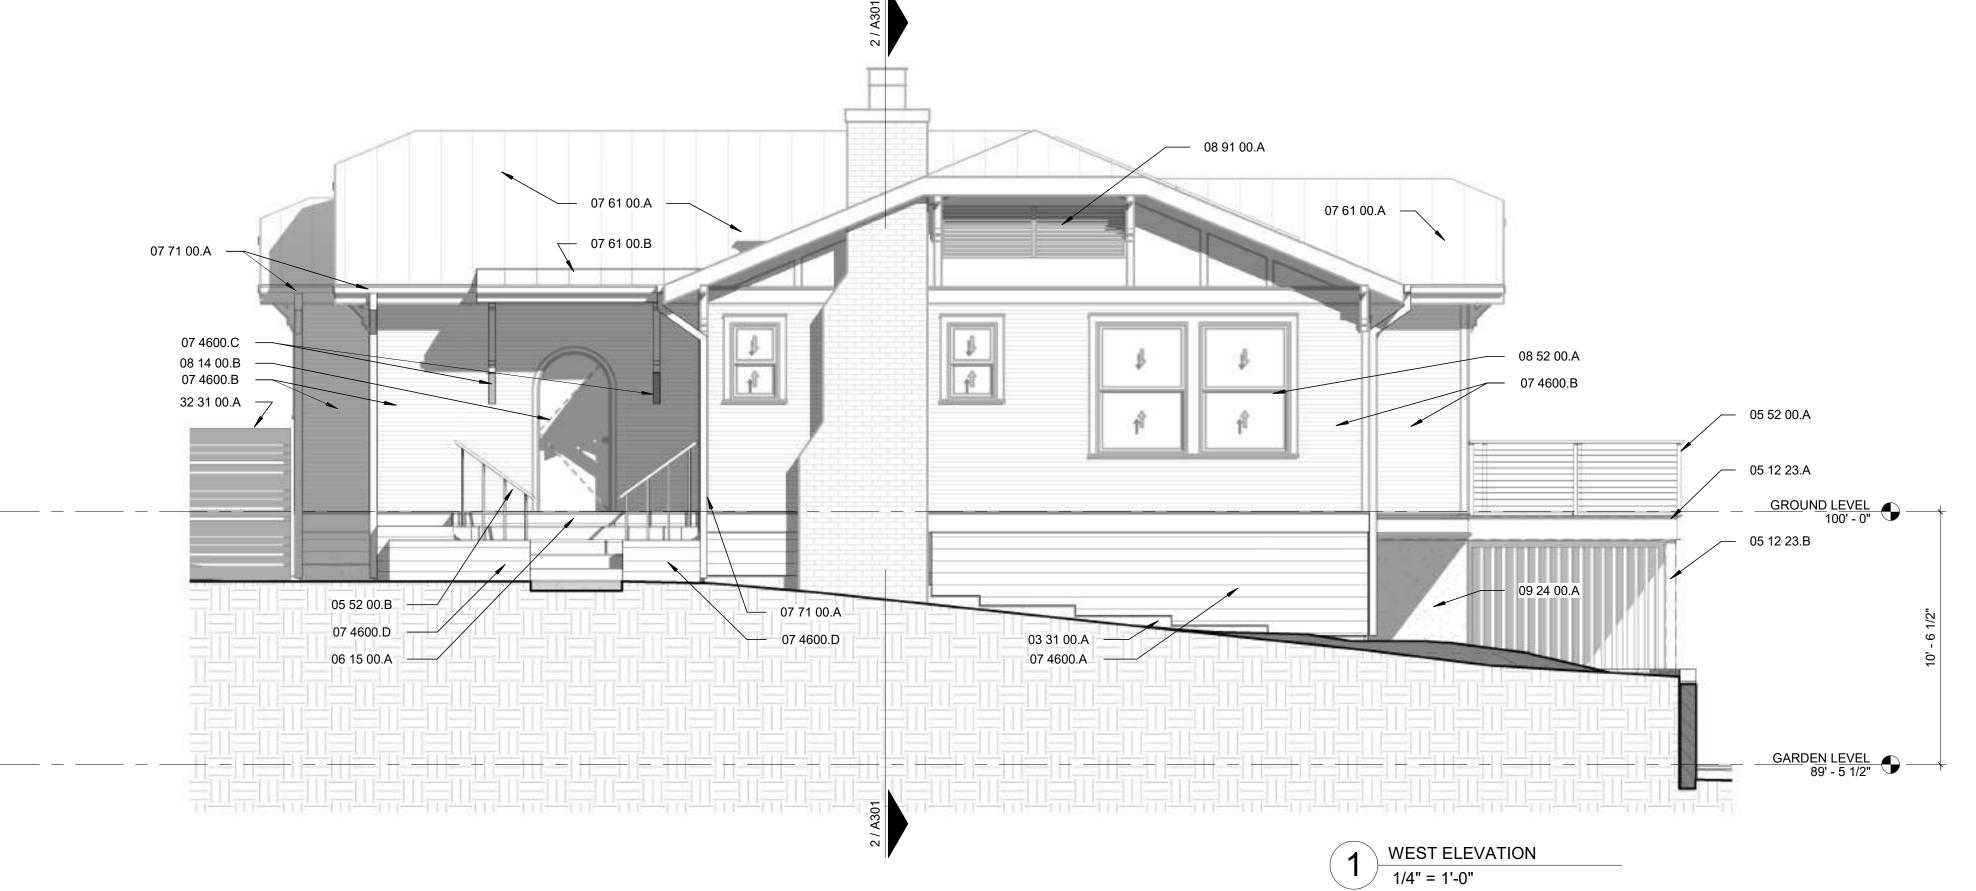


605 HIGHLAND RESIDENCE

ROOF PLAN







GENERAL NOTES

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- 7. CARBON MONOXIDE ALARMS SHALL BE INSTALLED OUTSIDE SLEEPING ROOMS AND IN COMPLIANCE WITH IRC SECTION 315. mount per manufactures' recommendation.

21" IN FRONT OF WATER CLOSETS.

- 8. PROVIDE ATTIC ACCESS PULL DOWN LADDER AT EACH ATTIC SPACE. 9. PROVIDE A MIN 30" SPACE CENTERED ON WATER CLOSETS AT ALL LOCATIONS UNLESS NOTED TO BE MORE. PROVIDE A MINIMUM OF
- 10 PROVIDE DRAFT BLOCKING BETWEEN FLOORS, BETWEEN FLOORS AND ATTIC, HORIZONTALLY AT 10' MAX INCREMENTS AND AS REQUIRED BY IRC SECTION 302.11.

GENERAL NOTES - EXTERIOR ELEVATIONS


- 1. CONTROL JOINT @ STONE TO FOLLOW STONE EDGE STARTING FROM TOP EDGE OF WINDOW/DOOR SYSTEM TO TOP OF PARAPET.
- 2. CONTROL JOINT @ STUCCO STARTING FROM TOP EDGE OF WINDOW/DOOR SYSTEM TO TOP OF PARAPET.
- 3. ALL EXTERIOR SIDING, PANELS, PLASTER AND STUCCO SHALL BE INSTALLED AS A RAINSCREEN SYTEM UNLESS SPECIFICALLY NOTED
- 4. PAINT TO BE A 3 COLOR SCHEME + PORCH CEILING AND FLOOR COLORS. ALL TRASPARENT FINISHES TO BE THE SAME UNLESS OTHERWISE NOTED.
- 5. ALL EXISTING SURFACES ABUTING NEW WORK SHALL BE RESTORED TO ORIGINAL CONIDITION IF NOT PART OF SCOPE.

KEYNOTES

- 03 31 00.A CAST IN PLACE CONTINUOUS CONCRETE STEM WALL AND FOOTING. EXTEND STEM WALL A MINIMUM OF 6" ABOVE
- 03 31 00.B CAST IN PLACE CONCRETE RETAINING WALL WITH STONE VENEER.
- 05 12 23.A STEEL FRAMED DECK

05 52 00.B METAL HANDRAIL

- 05 12 23.B SQUARE TUBE STEEL COLUMN
- 05 52 00.A GUARDRAIL WITH TUBE STEEL POSTS, CABLE RAILS, AND WOOD TOP RAIL.
- 06 15 00.A THERMALLY MODIFIED WOOD DECKING AND STAIRS. STAIN AND FINISH.
- 07 61 00.A STANDING SEAM METAL ROOF OVER EXISTING ROOF DECK
- 07 61 00.B STANDING SEAM METAL ROOF OVER PORCH
- 07 71 00.A GUTTER AND DOWNSPOUT
- 07 4600.A V-JOINT TONGUE AND GROOVE SKIRT TO MATCH ORIGINAL. 07 4600.B RESTORE EXISTING 117 PROFILE WOOD SIDING. REMOVE
- LOOSE PAINT, PRIME AND PAINT. 07 4600.C 117 PROFILE WOOD SIDING TO MATCH EXISTING. PRIME
- AND PAINT. 07 4600.D THERMALLY MODIFIED WOOD SKIRT. STAIN AND SEAL. 08 14 00.A MULTI BI-FOLD ALUMINUM CLAD WOOD DOORS. BASIS OF
 - DESIGN: MARVIN ULTIMATE BI-FOLD DOOR OR APPROVED
- 08 14 00.B RESTORE WOOD FRONT DOOR. PAINT.
- 08 52 00.A RESTORE ORIGINAL WOOD WINDOW AND TRIM. PAINT.
- 08 91 00.A RESTORE ORIGINAL WOOD LOUVER. PAINT.
- 09 24 00.A STUCCO
- 32 31 00.A HORIZONTAL SLAT WOOD FENCE 48 14 00.A ROOFTOP SOLAR PANELS

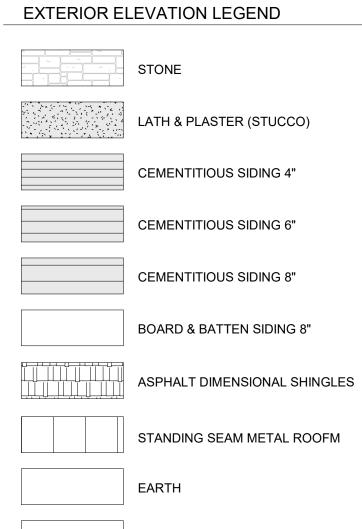


GRAVEL

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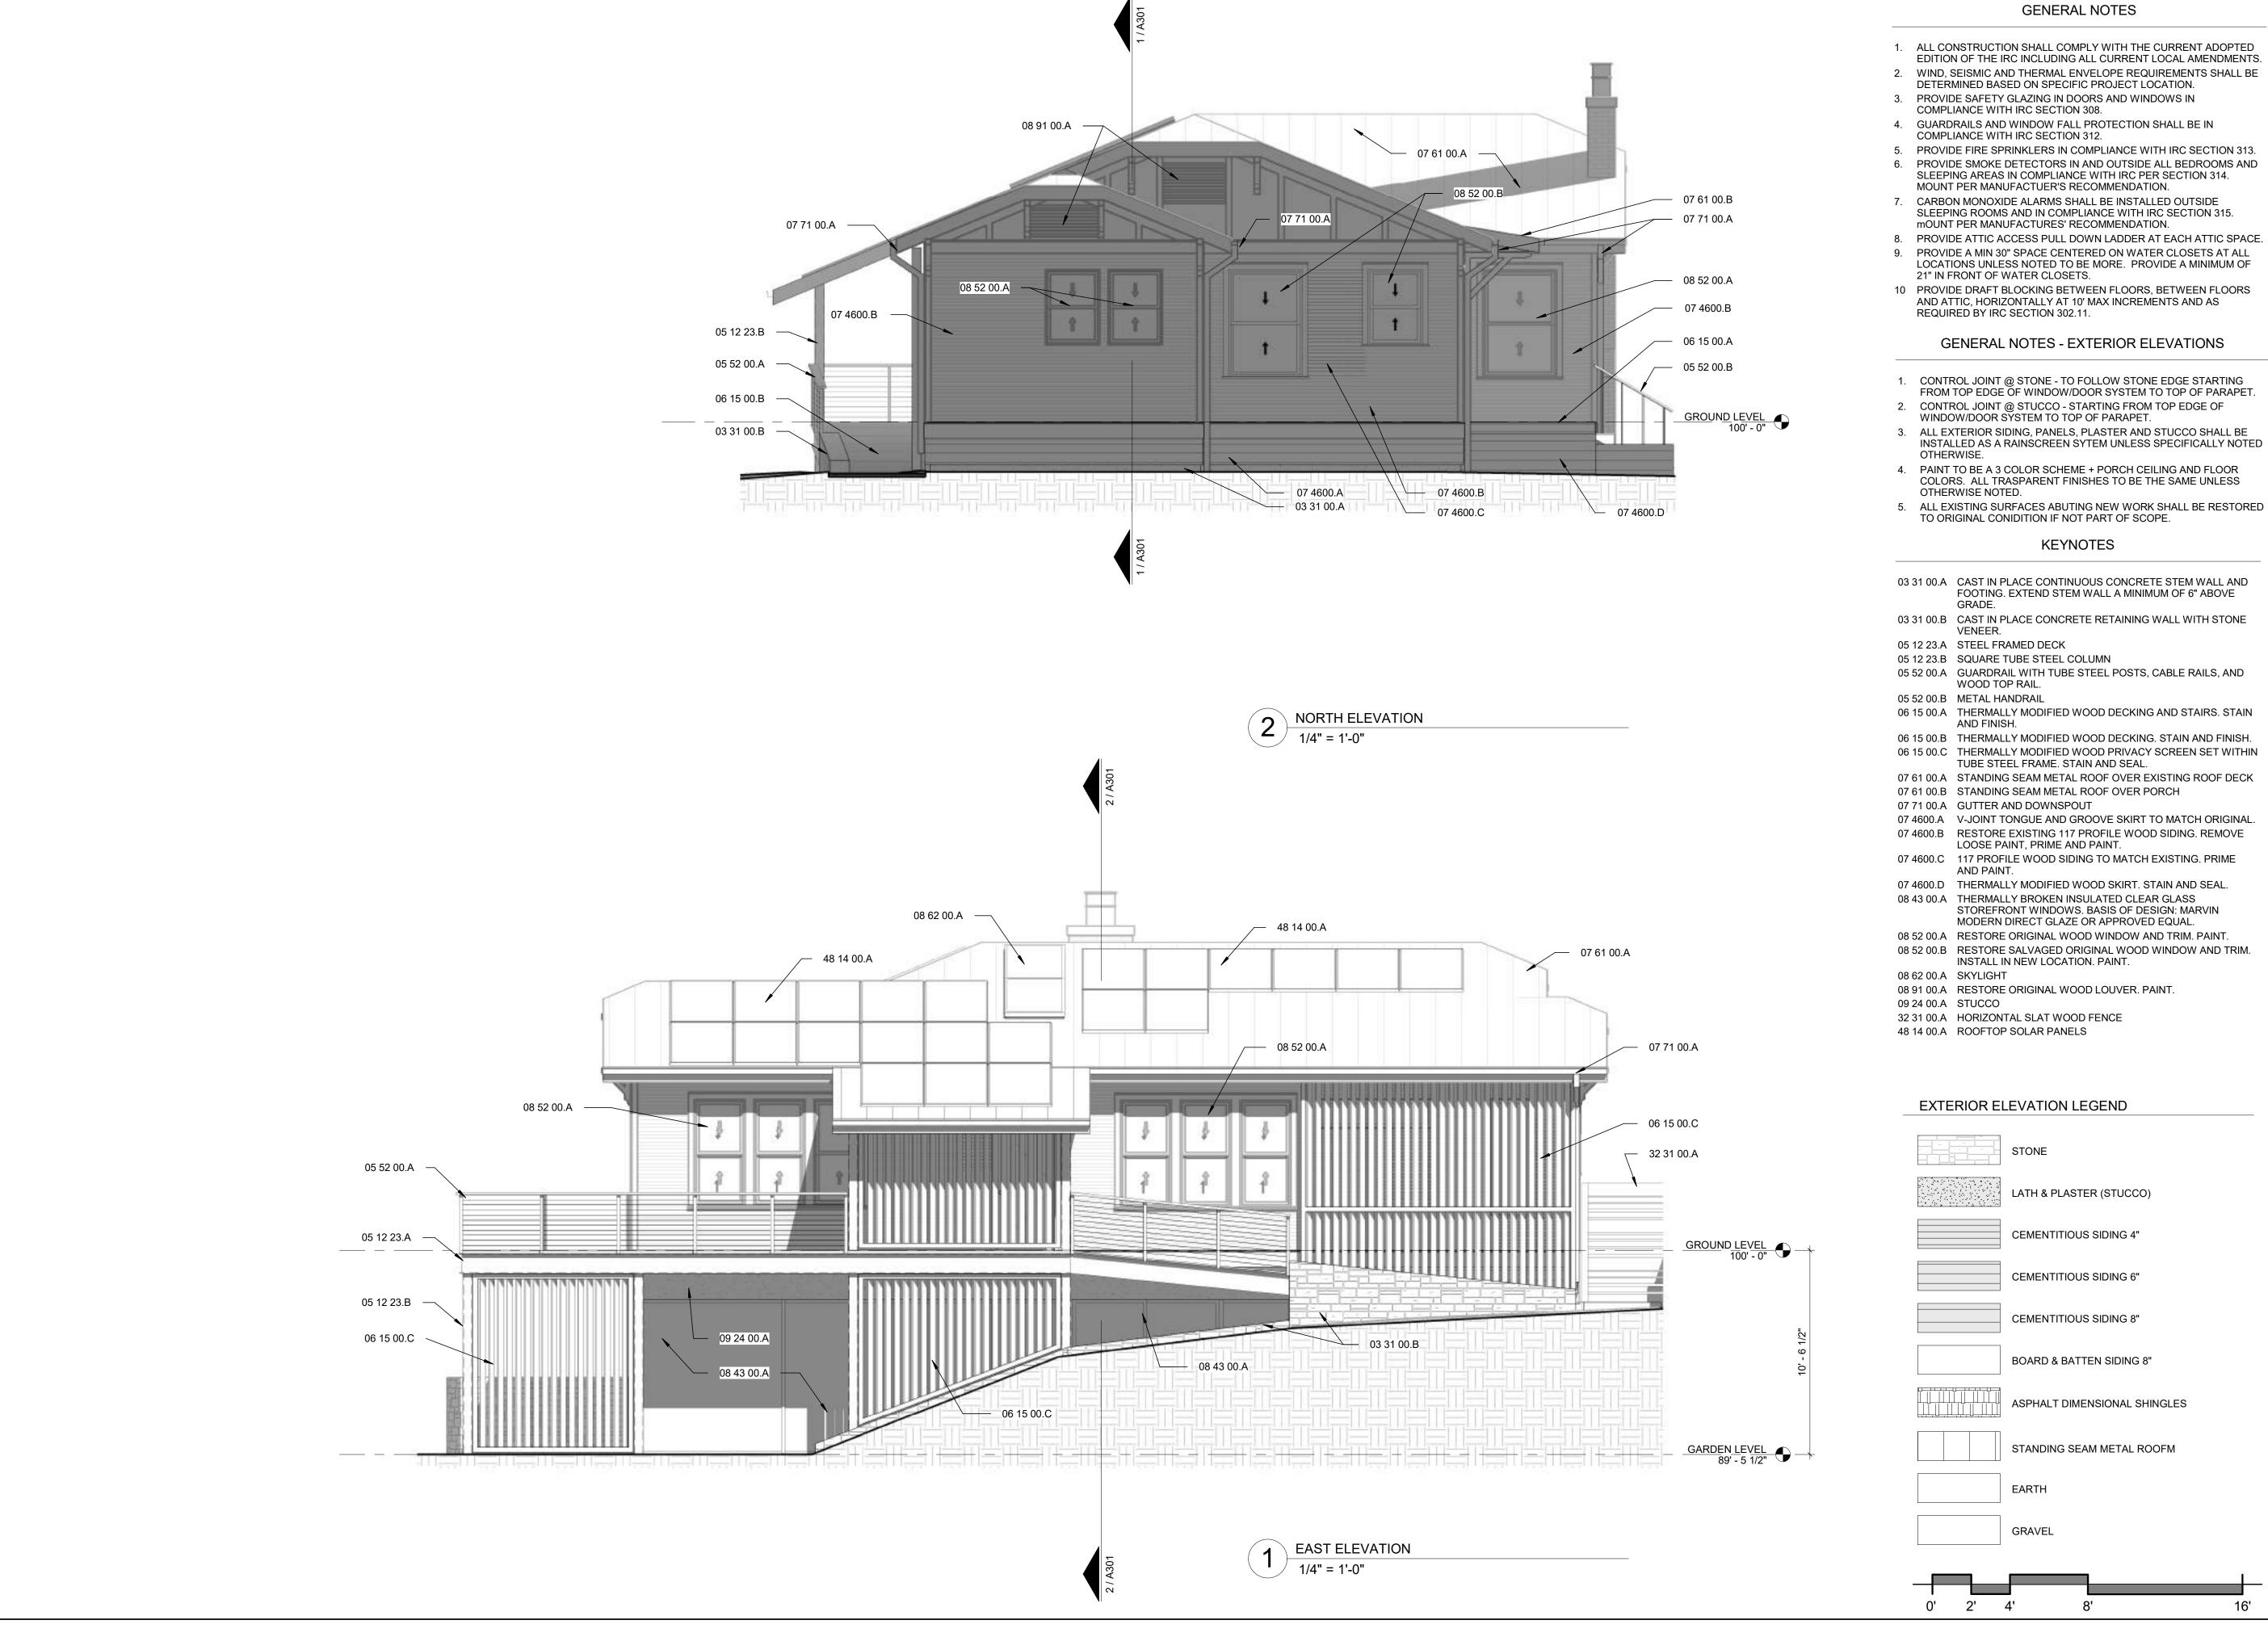
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TEXAS REGISTRATION NUMBER #8207



605 HIGHLAND RESIDENCE

EXTERIOR ELEVATIONS

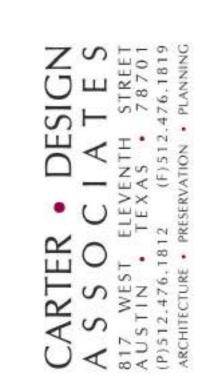

ISSUE DATE: 21 JULY 2023
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DRAWN BY: ZWR
CHECKED BY: DDC

REVISIONS:
NO REFERENCE ISSUED

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EXTERIOR ELEVATIONS

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