

© 2023 DAVEY MCEATHRON ARCHITECTURE

NOTES - SITE PLAN

DIMENSIONS GOVERN. VERIFY EXISTING SITE CONDITIONS & REPORT TO ARCHITECT ANY DISCREPANCIES

BETWEEN ACTUAL FIELD CONDITIONS & THESE PLANS PRIOR TO COMMENCING

GRADE WITH CROSS SLOPE TO DRAIN AT 1/4" PER FOOT. SEAL CONCRETE & PROVIDE A BROOM FINISH UNLESS OTHERWISE NOTED. CONTRACTOR TO TIE INTO EXISTING UTILITIES. SOME UTILITIES MAY REQUIRE UPGRADING, CONTRACTOR TO VERIFY.

VERIFY METER & UTILITY SERVICE LOCATIONS PRIOR TO INSTALLATION. 5. CONTRACTOR TO UTILIZE TEMPORARY

EROSION & SEDIMENTATION CONTROL MEASURES AS REQUIRED BY CODE. 6. PROVIDE TREE PROTECTION FOR ALL TREES

NOT MARKED FOR REMOVAL. 7. TREES TO BE REMOVED SHALL BE REMOVED FROM THE SOIL TO A DEPTH OF 12" BELOW

THE SURFACE OF THE GROUND IN THE AREA OF THE BUILDING. 8. SELECTIVELY CLEAR OR PRUNE ANY UNWANTED TREES OR THOSE IMPEDING CONSTRUCTION WITH CONSENT OF OWNER. COORDINATE REMOVAL & DISPOSAL OF

UNWANTED TREES & OTHER LANDSCAPING

MATERIALS WITH OWNER. 9. EXISTING UTILITY LINE LOCATIONS ARE APPROXIMATED. CONTRACTOR TO VERIFY LOCATIONS PRIOR TO CONSTRUCTION.

10. ENSURE ALL GRADING SLOPES AWAY FROM

BUILDING FOR AT LEAST 10'-0". 11. CONTRACTOR TO STORE ALL NEW MATERIALS IN DRY & SECURE LOCATION ON

SITE AS SPECIFIED BY OWNER.

12. EXTERIOR HVAC EQUIPMENT SHALL BE SCREENED IN COMPLIANCE WITH ANY CITY OF AUSTIN REGULATIONS &/OR LOCAL DEED RESTRICTIONS.

13. PROVIDE CONTROL & EXPANSION JOINTS AS REQUIRED ON CONCRETE DRIVES, WALKS & PATIOS.

14. PROVIDE NEW GUTTERS & DOWNSPOUTS TO DRAIN ON SITE. DOWNSPOUTS TO DRAIN AWAY FROM BUILDING. CONFIRM DOWNSPOUT LOCATIONS WITH ARCHITECT PRIOR TO INSTALLATION.



PERMIT

512-599-0660

ISSUE D	ATE:	JULY	5TH 2023
PROJEC	T NUMBER:	D	M210901
DRAWN	BY:		SB
REVISIO	NS:		
NO	REFERENCE		ISSUED

PRELIMINARY NOT FOR CONSTRUCTION

THIS DOCUMENT IS RELEASED FOR THE PURPOSE OF INTERIM REVIEW. IT IS INCOMPLETE AND MAY NOT BE USED FOR REGULATORY APPROVAL, PERMIT, OR CONSTRUCTION.

DAVID MCEATHRON **TEXAS REGISTRATION NUMBER #23964** JULY 51H 2023

SOUTH SECOND ADU

2009 SOUTH 2ND, AUSTIN, TEXAS 78704

SITE PLAN - HOUSE & ADU

TOPOGRAPHIC, TREE & BOUNDARY SURVEY OF LOT 9-A, BLOCK F RESUBDIVISION OF PART OF LOT 9, BLOCK F J.E. BOULDIN ADDITION VOLUME 56, PAGE 49 PLAT RECORDS, TRAVIS COUNTY, TX

	TREE TABLE	
No.	Туре	Diameter
3000	PECAN	20 " (P)
3001	PECAN	20 " (P)
3652	PECAN	17 "
3653	PECAN	16.5 "
3654	PECAN	29.5 "(H)
3655	AMERICAN ELM	27 "(M) - 19"(P), 8", 8"
3657	PECAN	33.5 "(H)
3658	AMERICAN ELM	12 "
3689	LIVE OAK	6 "
3690	PECAN	28.5 "(H)
3691	PECAN	23.5 "(H)
3692	AMERICAN ELM	7.5 "

DEREK KINSAUL 6356

FLOOD INFORMATION

PER WWW.FEMA.GOV, THIS PROPERTY APPEARS TO BE LOCATED IN ZONE X (UNSHADED). THIS PROPERTY WAS FOUND IN MAP NUMBER 48453C0585H, DATED 09/26/2008

SCALE: 1" = 20'

DATUM & BEARING BASIS

TEXAS STATE PLANE COORDINATE SYSTEM, ELEVATION DATA NAVD 88, GEOID 12B. DISTANCES IN US SURVEY FEET (GRID).

GENERAL NOTES:

1) THIS PROPERTY IS SUBJECT TO ANY AND ALL RECORDED AND UNRECORDED EASEMENTS. SURVEYOR
HAS MADE NO INVESTIGATION FOR EASEMENTS OF RECORD, ENCUMBRANCES, RESTRICTIVE COVENANTS OR OWNERSHIP TITLE EVIDENCE. 2) THIS SURVEY ONLY SHOWS ABOVE GROUND IMPROVEMENTS. 3) SUBJECT TO ALL APPLICABLE DEVELOPMENT CODES

AND ZONING ORDINANCES.
4) DUE TO DIFFERING BUILDING PRACTICES, BUILDING DIMENSIONS ARE APPROXIMATE. 5) ANY UTILITIES SHOWN HEREON MAY BE EXAGGERATED FOR GRAPHIC REPRESENTATION ONLY. 6) OWNERSHIP DEED RECORDED IN DOCUMENT NO.

2021082312, OFFICIAL PUBLIC RECORDS, TRAVIS COUNTY, TEXAS. 7) TREE TYPES TO BE VERIFIED BY CERTIFIED ARBORIST.

I CERTIFY THAT THIS SURVEY HAS BEEN COMPLETED IN ACCORDANCE WITH THE CURRENT REQUIREMENTS OF THE STANDARDS OF PRACTICE FOR SURVEYING IN THE STATE OF TEXAS TO THE BEST OF MY KNOWLEDGE AND BELIEF.

DATE OF LAST FIELD WORK: 10/26/2021

DEREK KINSAUL, R.P.L.S. NO. 6356 NOVEMBER 23, 2021

FIELD CREW: JAD REVISION #:

DRAWN BY:PDW REVIEWED BY: DJK

WEST JOHANNA ST. (60' R.O.W., PER PLAT) ø 3001 \$71°36'09'E 158.80') +529.4' MEASURED ACREAGE 3690 EAST 50' OF LOT 9
WEST 58.8' OF LOT 9
BLOCK F
VOL. 01, PG. 71
P.R.T.C. -RAILROAD THE O (16' R.O.W., PER PLAT) (N69°01'W 158.80') 3689 3691 O TEMPORARY BENCHMARK SET - COTTON GIN SPINDLE IN POWER POLE ELEVATION: 531.43' RAILROAD TIE

LEGEND

1/2" IRON ROD FOUND (UNLESS NOTED)

1/2" IRON PIPE FOUND

GAS METER

ELECTRIC METER WATER METER

CLEAN OUT POWER POLE

LIGHT POLE

WASTE WATER MANHOLE

GUY ANCHOR

AIR CONDITIONING UNIT

OHU —— OVERHEAD UTILITY — WOOD FENCE

PROPERTY LINE EDGE OF PAVEMENT

— – – — ADJOINER LINE CONCRETE AREA

CONCRETE WALL (UNLESS NOTED)

WOOD DECK

GRAVEL AREA

STONE AREA

BRICK AREA

P.U.E. PUBLIC UTILITY EASEMENT VOLUME AND PAGE VOL. PG. PLAT RECORDS TRAVIS COUNTY

FENCELINE ON/OFF SUBJECT PROPERTY R.O.W. RIGHT OF WAY RECORD INFORMATION

FINISHED FLOOR ELEVATION SPOT ELEVATION + 100' TOP OF WALL BOTTOM OF WALL

FFE

TEMPORARY BENCHMARK SET — MAG NAIL IN ASPHALT

CRITICAL ROOT ZONE = DIAMETER EQUAL IN FEET TO TWICE THE NUMBER OF INCHES OF THE TREE'S TRUNK DIAMETER PROTECTED TREE (DIAMETER ≥ 19") HERITAGE TREE (DIAMETER ≥ 24")


MULTIPLE TRUNK

SURVEYED FOR: MCEATHRON PROJECT NO. 21-0322 2009 SOUTH 2ND ST. AUSTIN, TX 78704



SURVEYWORKS.COM 1207 UPLAND DRIVE AUSTIN, TX 78741 FIRM #10194157 (512) 599-8067

1 of 1

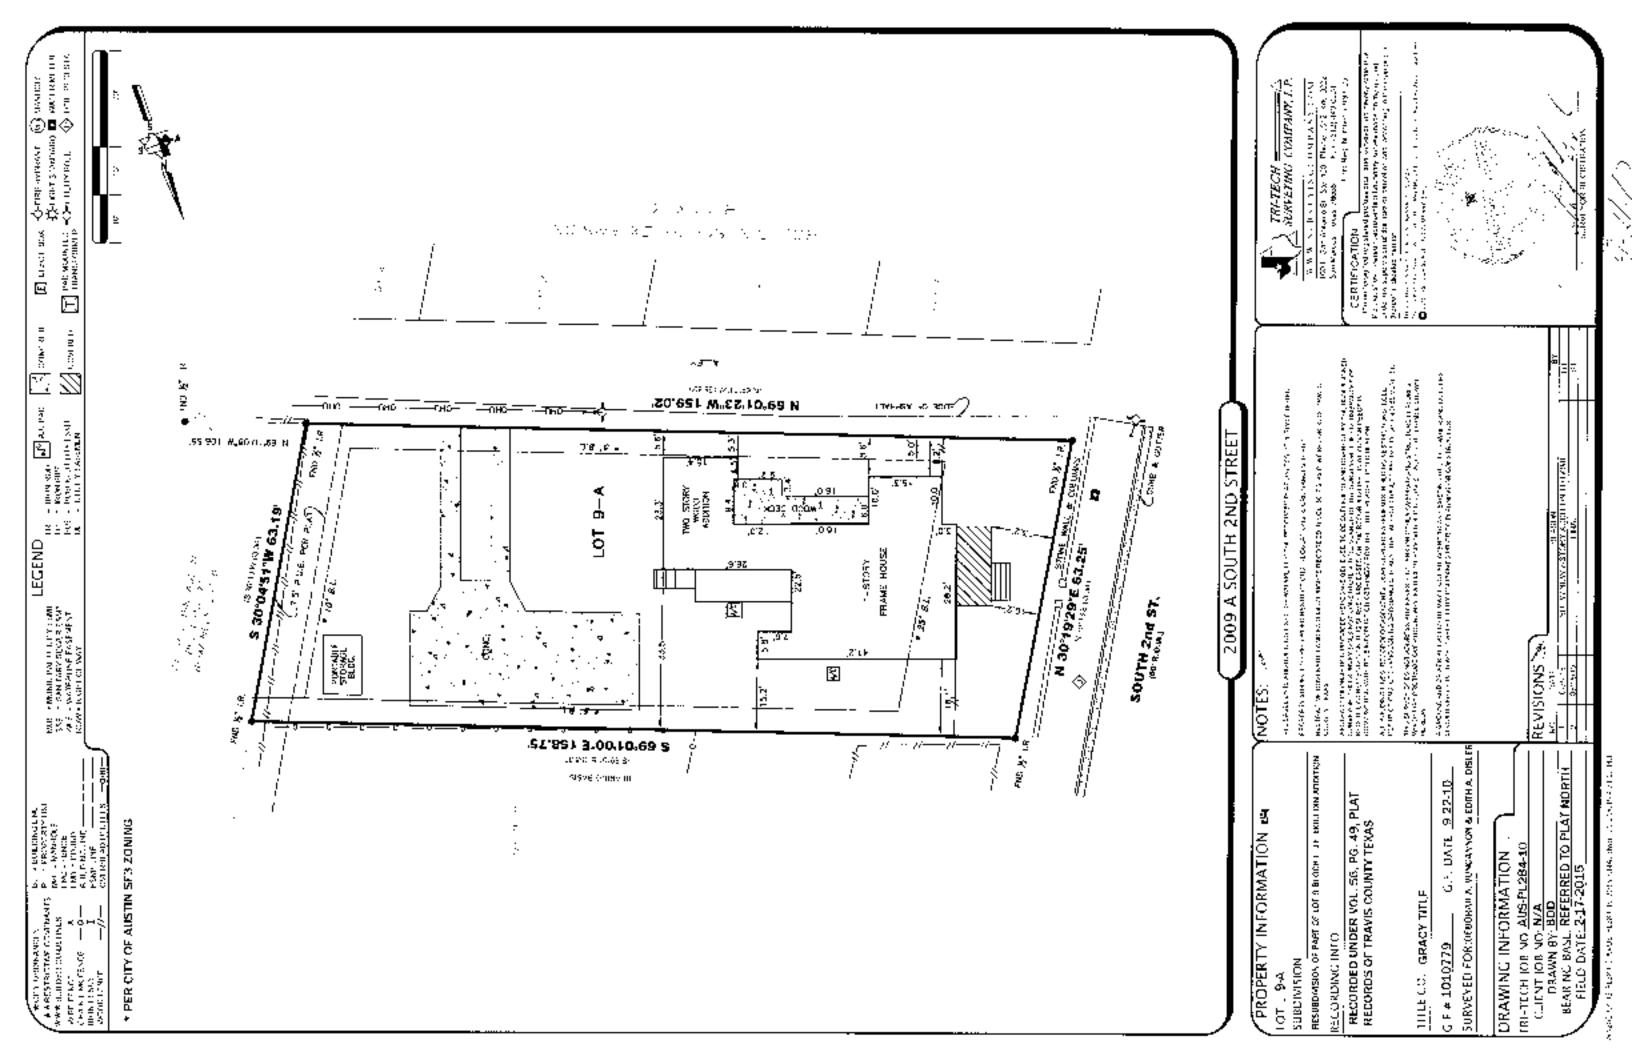

SOUTH 2ND RENO.

2009 SOUTH 2ND, AUSTIN, TEXAS 78704
PERMIT
JULY 6TH 2023

ADU HEATED: 1,091 SF

1-CAR GARAGE: 267

BUILDING COVERAGE: 3,265 SF

TOTAL IMPERVIOUS
COVERAGE ON LOT: 3,636 SF

TOTAL IMPERVIOUS

ALLOWED: 4,455 SF







PROJECT NO:

DM210901

SHEET INDEX:

A001 COVERSHEET-HOUSE

A100 SITE PLAN - HOUSE & ADU
A110 HOUSE - FLOOR 01 & 02 DEMO PLAN
A111 HOUSE - FLOOR 01 & 02 REFERENCE PLAN

A121 HOUSE - FLOOR 1 & 02 RCP A201 EXTERIOR ELEVATIONS - HOUSE

A601 HOUSE - SCHEDULES
A703 HOUSE & ADU - TREE PROTECTION PLAN

PROJECT TEAM:

ARCHITECT

DAVEY MCEATHRON ARCHITECTURE 1402 W N LOOP BLVD AUSTIN, TEXAS 78756 TEL. (512) 599-0660

STRUCTURAL

SEC SOLUTIONS 407 FOREST STREET LIBERTY HILL, TX 78642 TEL. (512) 215-4364


<u>SURVEY</u>

TRI-TECH SURVEYING COMPANY, L.P. 100 E. SAN ANTONIO ST., STE. 100 SAN MARCOS, TEXAS 78666 TEL. (512) 440-0224



JULY 61H 20

REVI	SIONS	
NO	REFERENCE	ISSUED

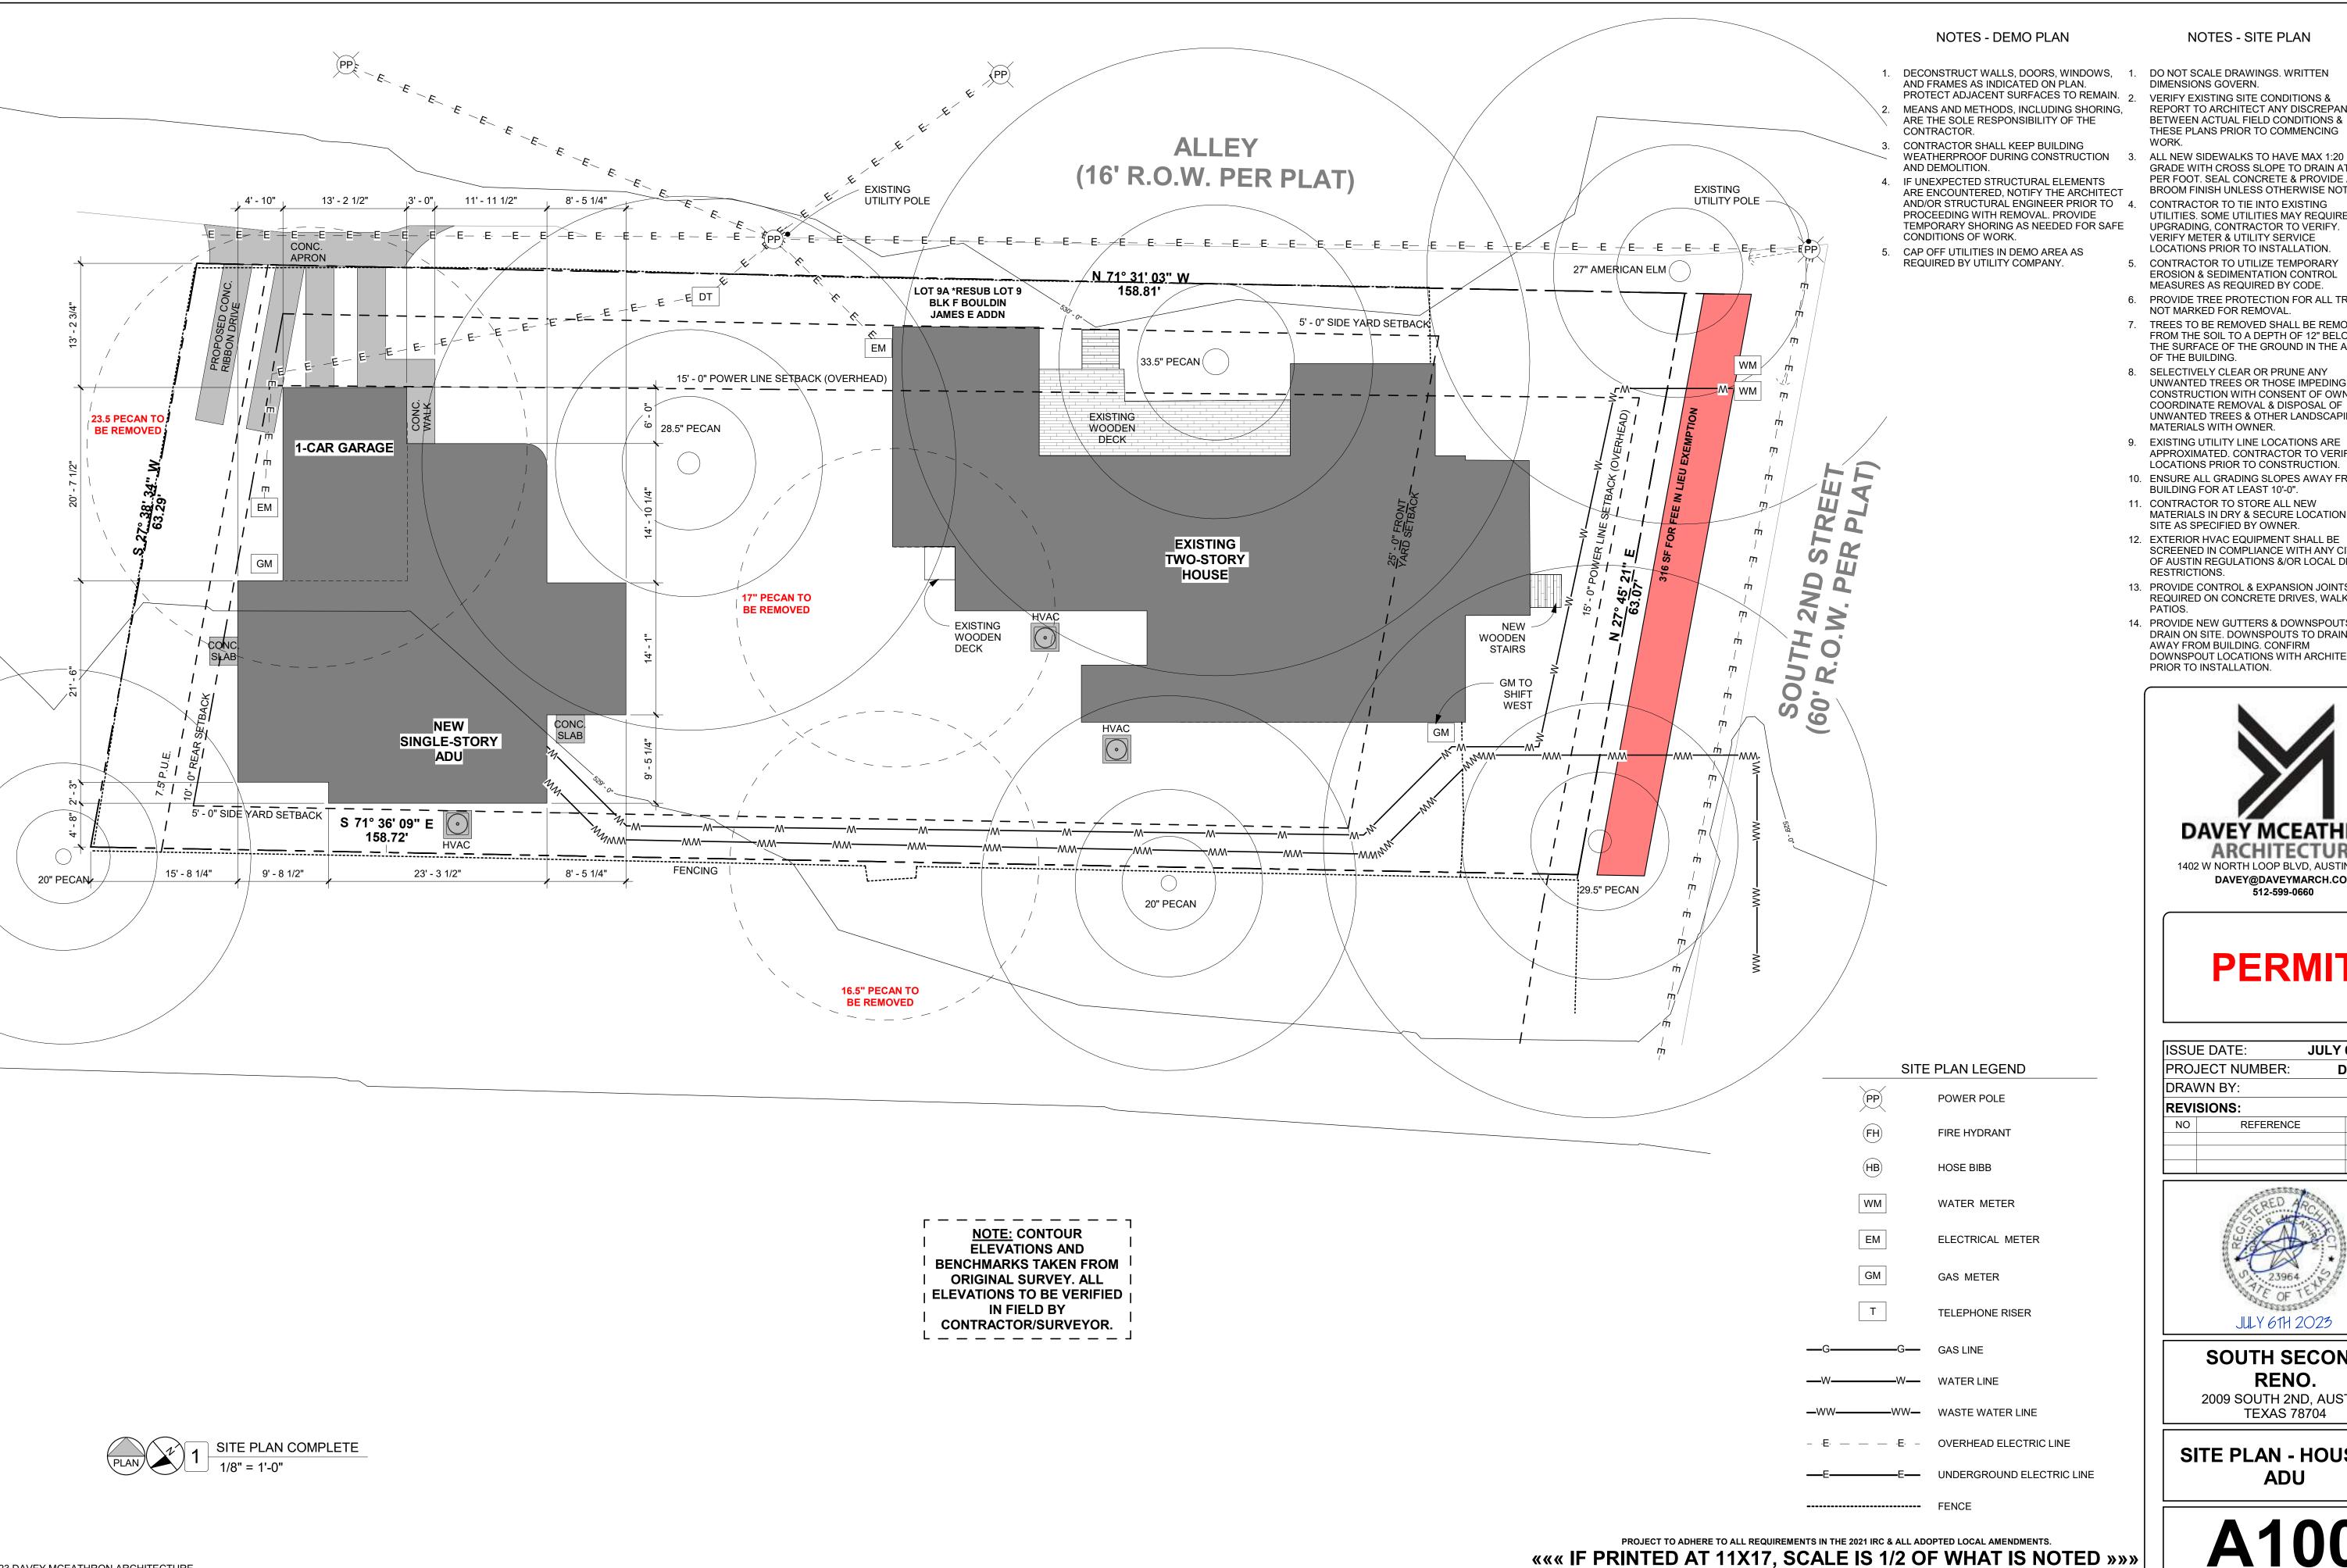

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NOTES - SITE PLAN

- DIMENSIONS GOVERN.
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PERMIT


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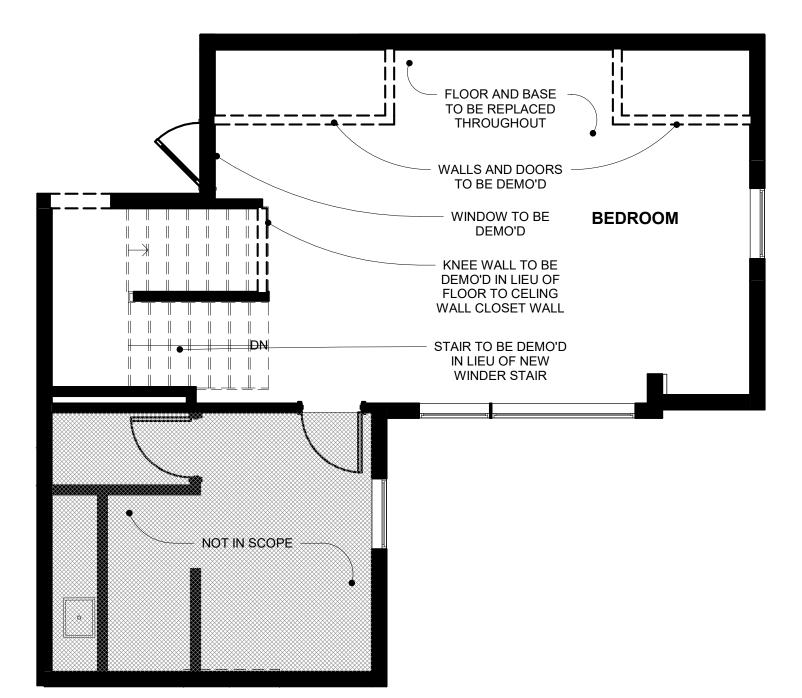



SOUTH SECOND RENO.

2009 SOUTH 2ND, AUSTIN, TEXAS 78704

SITE PLAN - HOUSE & ADU



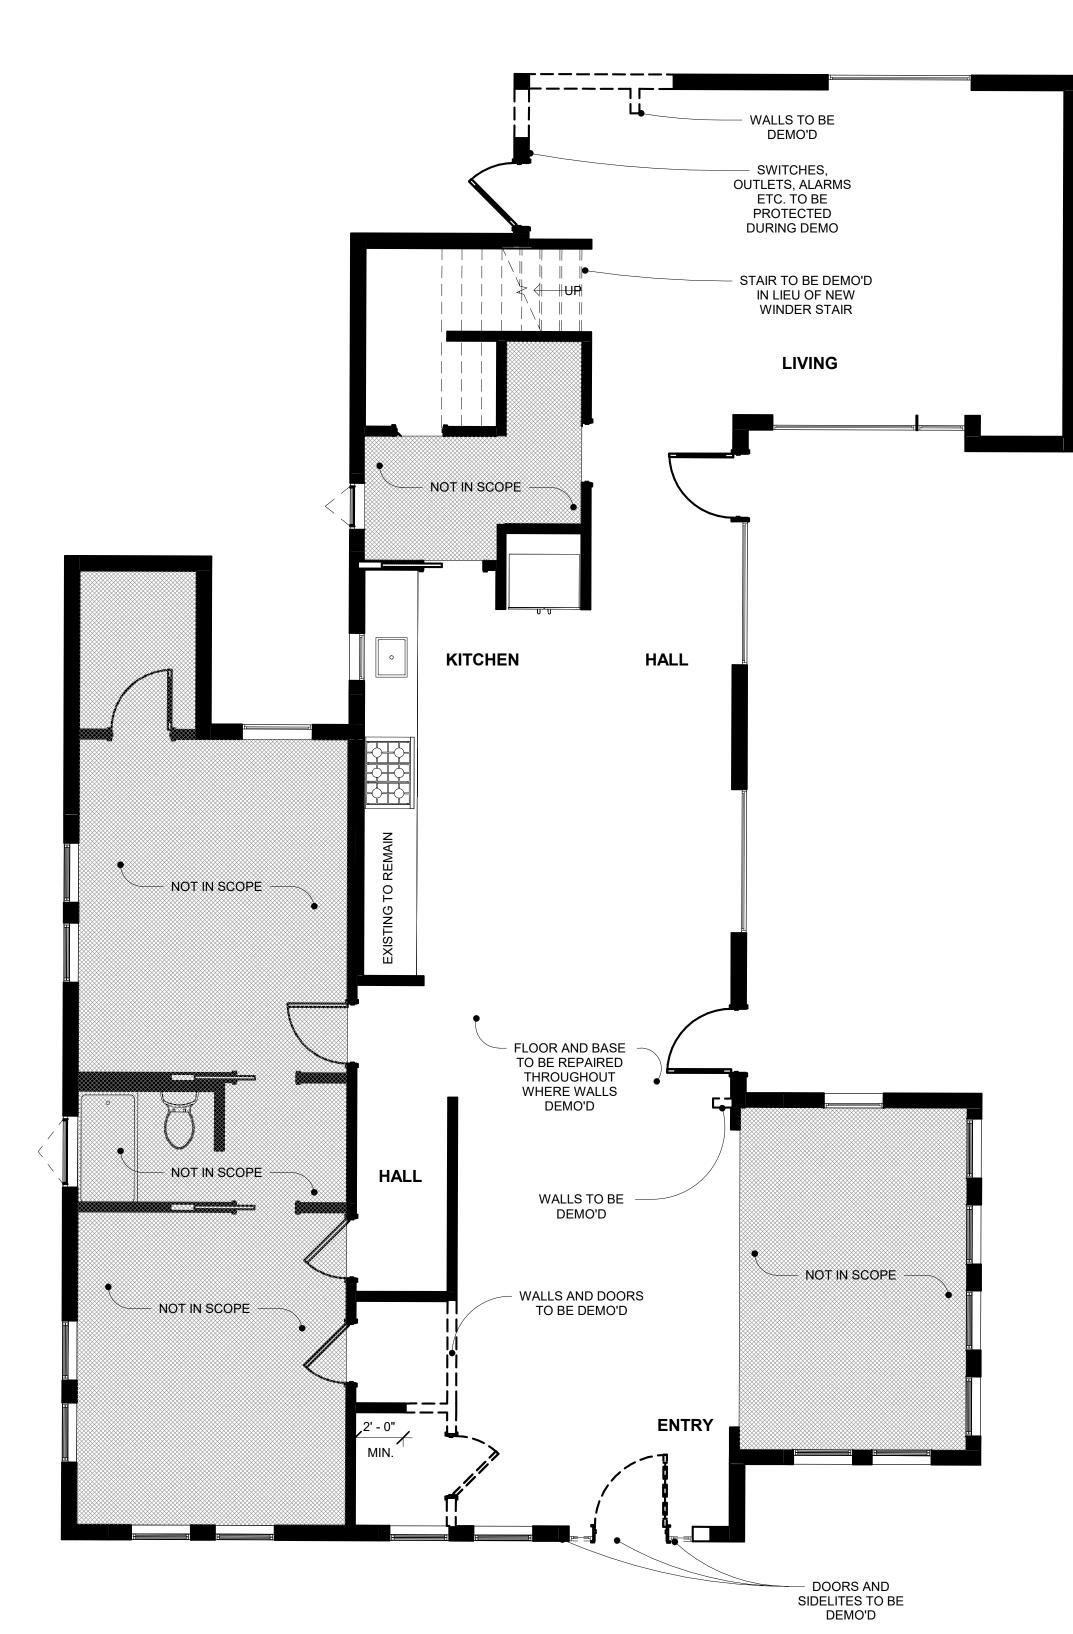


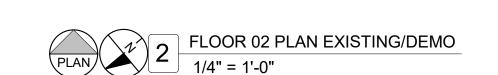

NOTES - DEMO PLAN

- 1. DECONSTRUCT WALLS, DOORS, WINDOWS, 1. DO NOT SCALE DRAWINGS. WRITTEN AND FRAMES AS INDICATED ON PLAN. DIMENSIONS GOVERN. PROTECT ADJACENT SURFACES TO REMAIN. 2. ALL DIMENSIONS ARE TO FINISH FACE,
- 2. MEANS AND METHODS, INCLUDING SHORING, ARE THE SOLE RESPONSIBILITY OF THE 3. PROVIDE FIRE BLOCKING AT ALL PLUMBING
- CONTRACTOR. 3. CONTRACTOR SHALL KEEP BUILDING WEATHERPROOF DURING CONSTRUCTION AND DEMOLITION.
- 4. IF UNEXPECTED STRUCTURAL ELEMENTS ARE ENCOUNTERED, NOTIFY THE ARCHITECT 5. PROVIDE BLOCKING IN WALLS BEHIND & AND/OR STRUCTURAL ENGINEER PRIOR TO PROCEEDING WITH REMOVAL. PROVIDE TEMPORARY SHORING AS NEEDED FOR SAFE 6 CONDITIONS OF WORK.
- 5. CAP OFF UTILITIES IN DEMO AREA AS REQUIRED BY UTILITY COMPANY.

FLOOR PLAN LEGEND

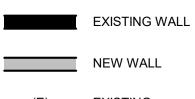

EXISTING

WALLS TO BE DEMOLISHED

UNLESS NOTED OTHERWISE.

NOTES - FLOOR PLAN

OPENINGS. 4. ALL INTERIOR WALL PARTITIONS TO BE 2X4'S AT 16" O.C., EXCEPT TOILET PLUMBING WALLS, WHICH ARE TO BE 2X6'S, UNLESS

NOTED OTHERWISE. ADJACENT TO ALL TUBS & TOILETS FOR FUTURE GRAB BAR INSTALLATION. CABINET MATERIALS & ADHESIVES TO HAVE NO ADDED UREA-FORMALDEHYDE. INTERIOR

PAINTS TO BE LOW-VOC. 7. ALL NEW STAIRS, STEPS, & RAILINGS TO MEET CURRENT CODES AT THE TIME OF CONSTRUCTION.

8. SHOWER HEADS SHALL BE MOUNTED 7'-0" AFF UNLESS NOTED OTHERWISE.

9. ALL ELECTRICAL AND PLUMBING FIXTURES ARE TO BE INSTALLED PER CODE, INCLUDING LOCATION, OPERABLE COMPONENTS, & TYPE.

10. CONFIRM ALL PLUMBING CONNECTION LOCATIONS WITH ACTUAL FIXTURES. 11. PROTECT WOOD & WOOD-BASED PRODUCTS


FROM DECAY & TERMITES PER CODE. 12. FROM INTERIOR FINISH FLOOR TO ANY EXTERIOR FINISH FLOOR, THE DROP SHALL BE A MINIMUM OF 2", UNLESS OTHERWISE NOTED OR VISITABLE ENTRANCE. CONTRACTOR TO VERIFY MATERIALS USED FOR DECK CONSTRUCTION & FINISH FLOORING TO MAINTAIN MINIMUM DROP.

13. GARAGE TO BE SEPARATED FROM HOUSE BY 5/8" TYPE 'X' GYP ON WALLS & CEILINGS IN COMMON WITH THE HOUSE. DOOR TO BE 20 MIN. RATED WITH A SELF CLOSER.



PERMIT


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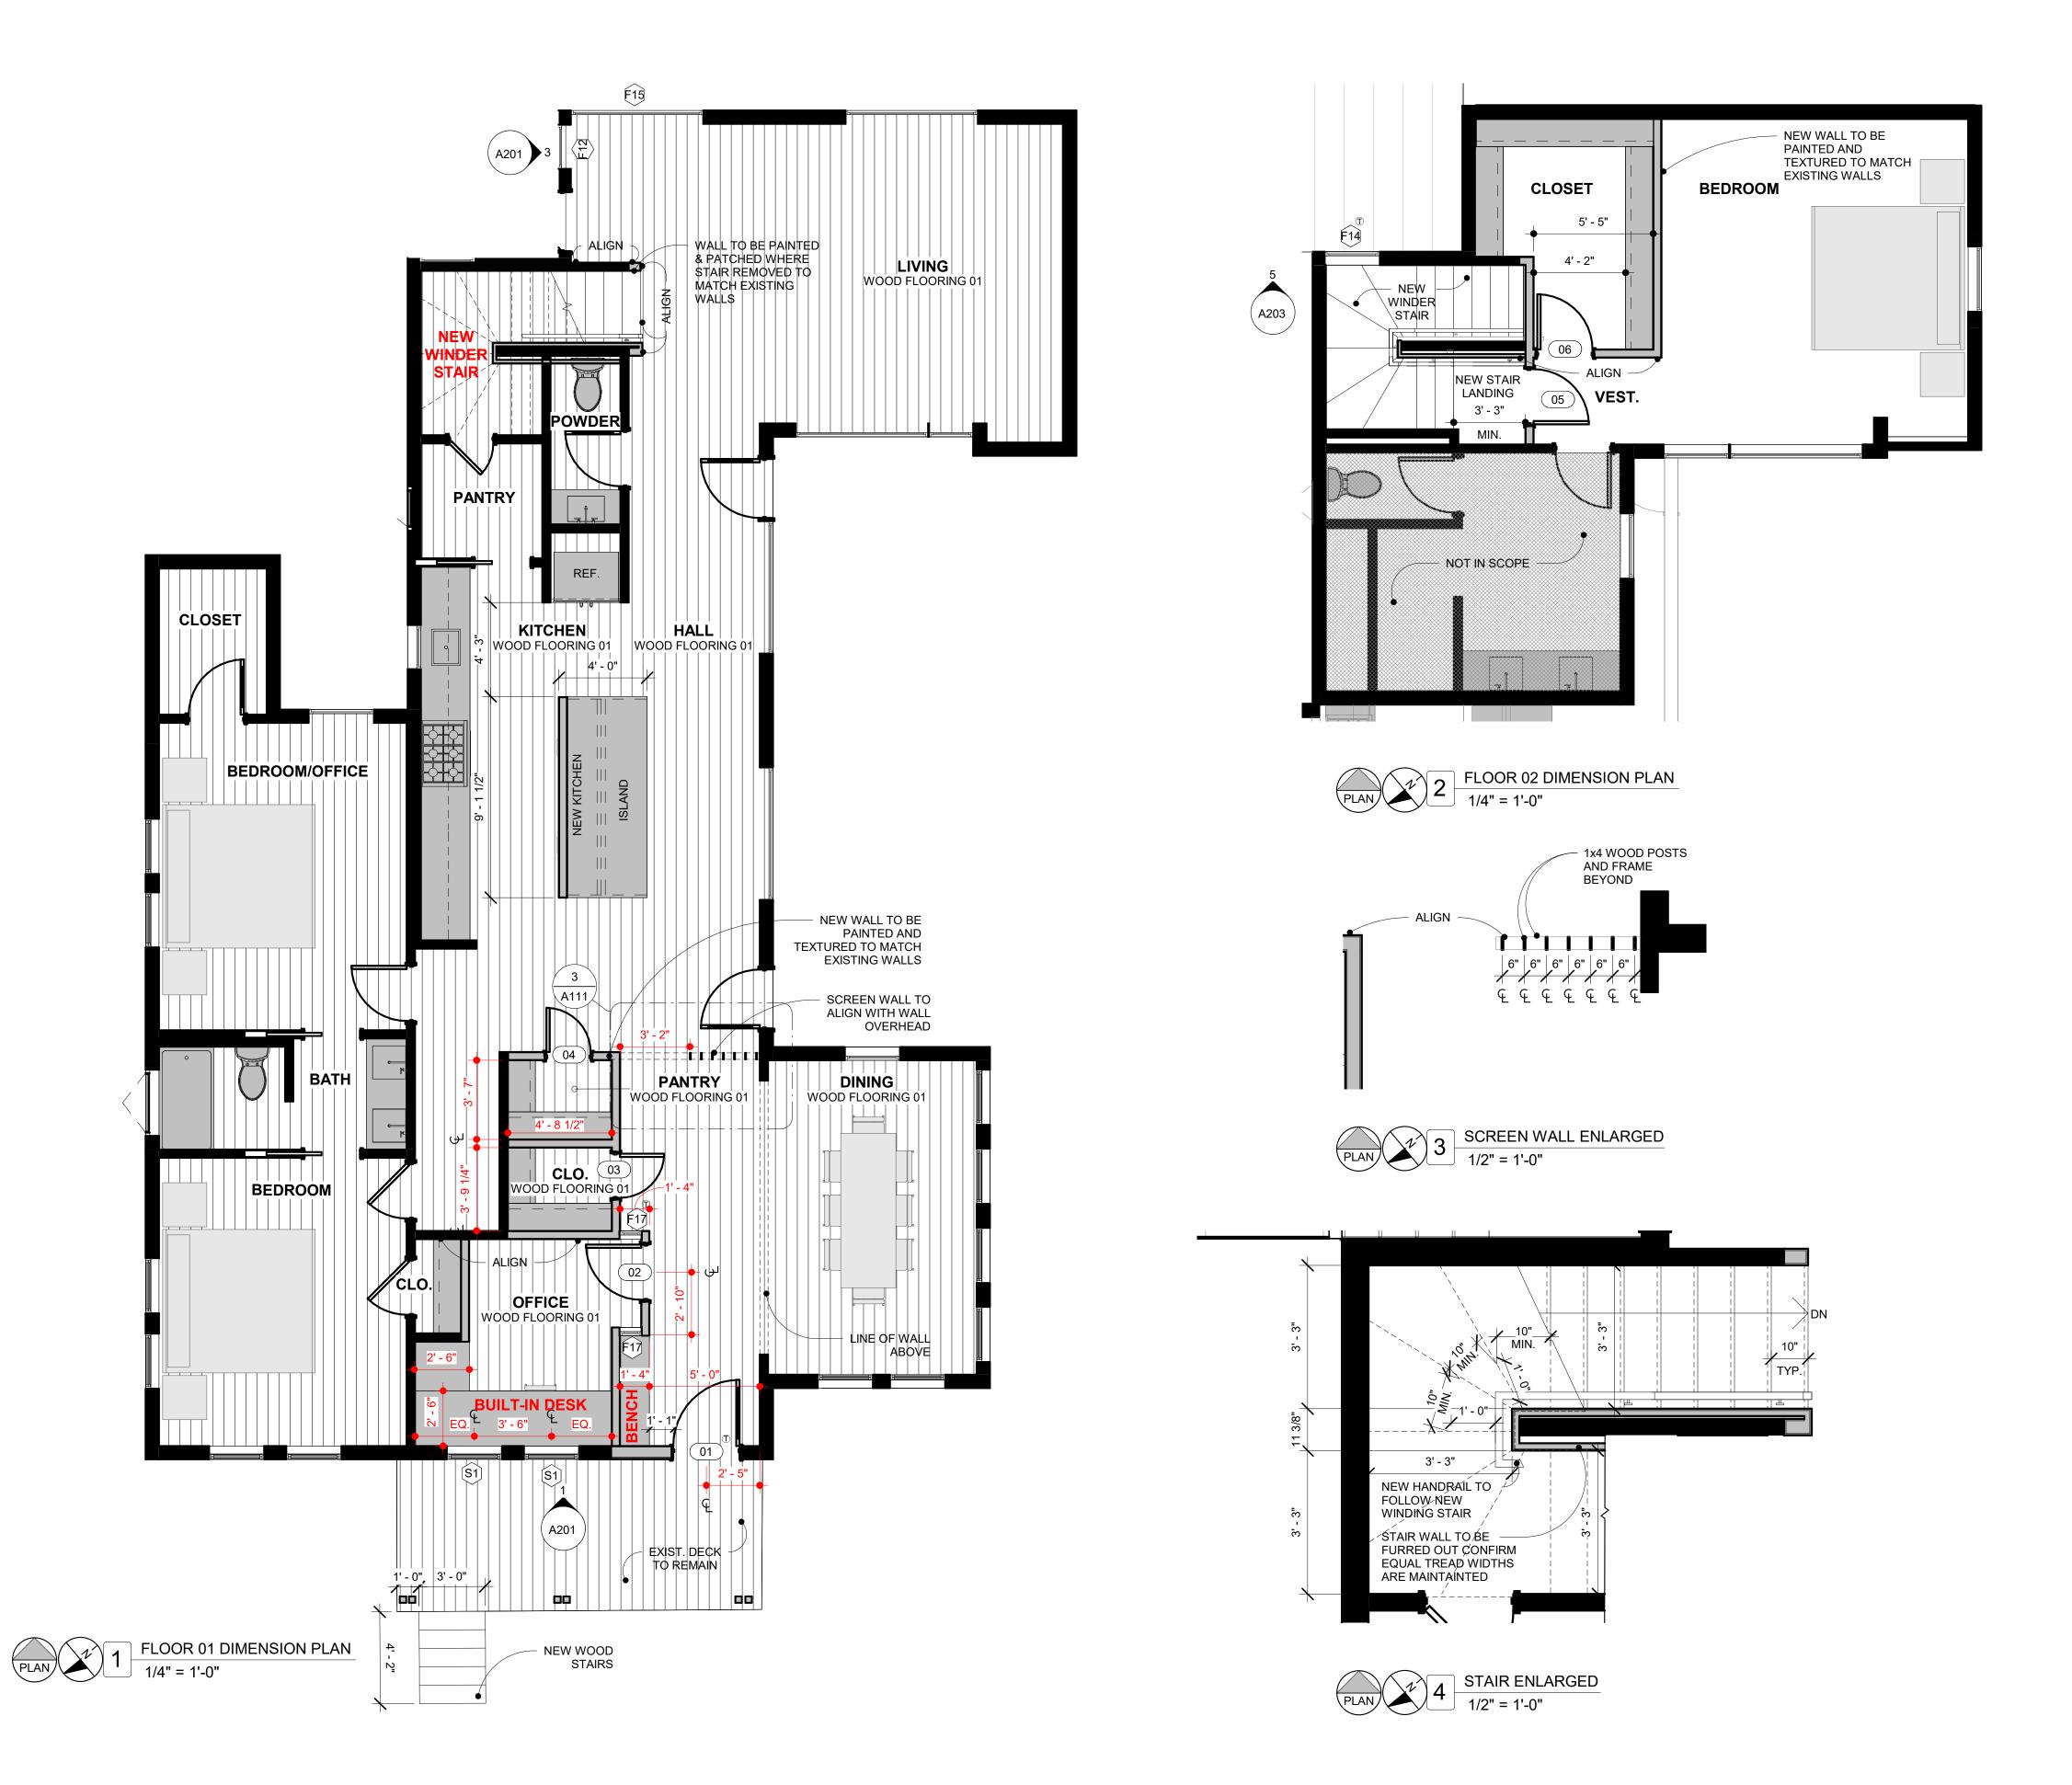


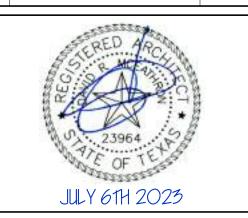SOUTH SECOND RENO.

2009 SOUTH 2ND, AUSTIN, TEXAS 78704

HOUSE - FLOOR 01 & 02 DEMO PLAN



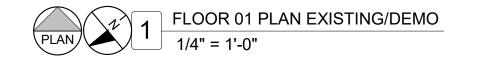

FLOOR PLAN LEGEND

EXISTING WALL

NEW WA

(E) EXISTING

WALLS TO BE DEMOLISHED

NOTES - FLOOR PLAN

- 1. DO NOT SCALE DRAWINGS. WRITTEN
- DIMENSIONS GOVERN.
 2. ALL DIMENSIONS ARE TO FINISH FACE,
- UNLESS NOTED OTHERWISE.

 3. PROVIDE FIRE BLOCKING AT ALL PLUMBING
- OPENINGS.
 4. ALL INTERIOR WALL PARTITIONS TO BE 2X4'S
- AT 16" O.C., EXCEPT TOILET PLUMBING WALLS, WHICH ARE TO BE 2X6'S, UNLESS NOTED OTHERWISE.
- 5. PROVIDE BLOCKING IN WALLS BEHIND & ADJACENT TO ALL TUBS & TOILETS FOR FUTURE GRAB BAR INSTALLATION.
- CABINET MATERIALS & ADHESIVES TO HAVE NO ADDED UREA-FORMALDEHYDE. INTERIOR PAINTS TO BE LOW-VOC.
- ALL NEW STAIRS, STEPS, & RAILINGS TO MEET CURRENT CODES AT THE TIME OF CONSTRUCTION.
- 8. SHOWER HEADS SHALL BE MOUNTED 7'-0" AFF UNLESS NOTED OTHERWISE.
- 9. ALL ELECTRICAL AND PLUMBING FIXTURES ARE TO BE INSTALLED PER CODE, INCLUDING LOCATION, OPERABLE COMPONENTS, & TYPE.
- 10. CONFIRM ALL PLUMBING CONNECTION LOCATIONS WITH ACTUAL FIXTURES.
- 11. PROTECT WOOD & WOOD-BASED PRODUCTS FROM DECAY & TERMITES PER CODE.
- 12. FROM INTERIOR FINISH FLOOR TO ANY EXTERIOR FINISH FLOOR, THE DROP SHALL BE A MINIMUM OF 2", UNLESS OTHERWISE NOTED OR VISITABLE ENTRANCE.


 CONTRACTOR TO VERIFY MATERIALS USED FOR DECK CONSTRUCTION & FINISH FLOORING TO MAINTAIN MINIMUM DROP.
- 13. GARAGE TO BE SEPARATED FROM HOUSE BY 5/8" TYPE 'X' GYP ON WALLS & CEILINGS IN COMMON WITH THE HOUSE. DOOR TO BE 20 MIN. RATED WITH A SELF CLOSER.



PERMIT

512-599-0660

ISSUE DATE: JULY 6TH 2023
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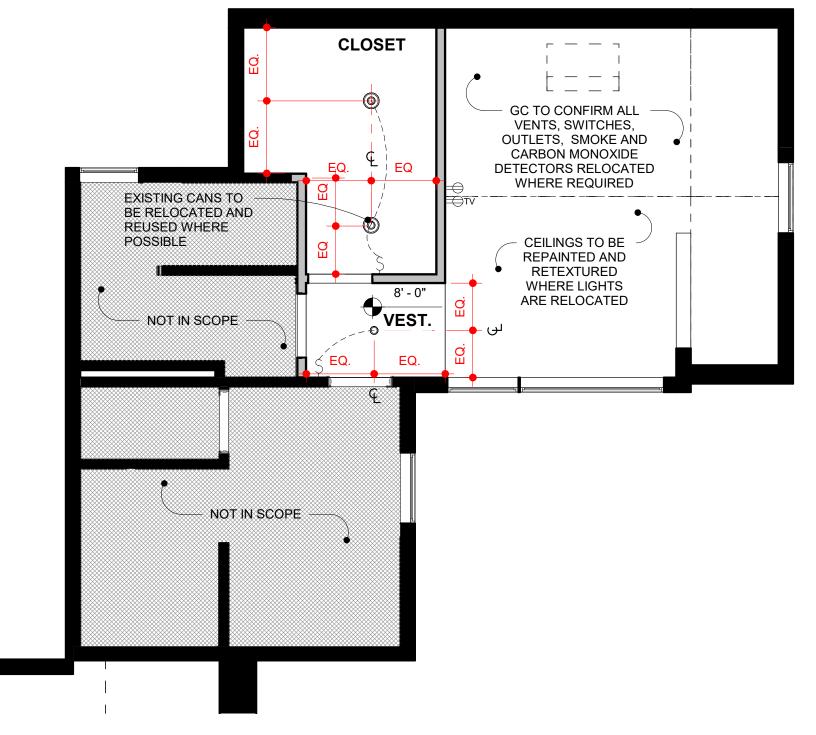


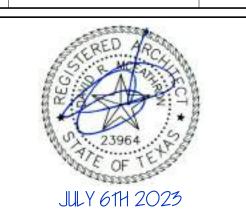
SOUTH SECOND RENO.

2009 SOUTH 2ND, AUSTIN, TEXAS 78704

HOUSE - FLOOR 01 & 02 REFERENCE PLAN

NOTE: ALL CEILINGS SHOWN TO BE SLOPED GYP. UNLESS OTHERWISE NOTED.



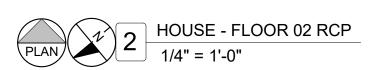

NOT IN SCOPE

PENDANTS TO

BE CENTERED

- NEW -

ISLAND -

PANTRY

CLO.

CEILINGS TO BE

REPAINTED AND

RETEXTURED

ARE RELOCATED

WHERE LIGHTS

MITTE

CEILINGS TO BE

RETEXTURED

WHERE LIGHTS

ARE RELOCATED

EQ. /

ENTRY

REPAINTED AND

OVER NEW

ISLAND

NOT IN SCOPE --

EXISTING CANS TO

POSSIBLE

BE RELOCATED AND REUSED WHERE

EXISTING PENDANT

TO BE RELOCATED

4" RECESSED DOWNLIGHT 4" WET-RATED RECESSED DOWNLIGHT SMOKE / CO DETECTOR SMOKE DETECTOR **EXHAUST FAN** EXHAUST FAN/LIGHT COMBO CEILING LIGHT FIXTURE/CHANDELIER \searrow **HVAC SUPPLY REGISTER HVAC RETURN REGISTER** DUPLEX FLOOR OUTLET \bigoplus SURFACE MOUNT POP-UP OUTLET \Rightarrow DUPLEX OUTLET \Longrightarrow c **DUPLEX OUTLET @ COUNTER HEIGHT** GFCI DUPLEX OUTLET ⇒GFI DEDICATED CIRCUIT \Longrightarrow D ₩TV TV OUTLET @ 60" A.F.F. REFRIGERATOR OUTLET DISHWASHER OUTLET \Longrightarrow DW → MICRO MICROWAVE OUTLET CAR CHARGER (50 AMP MIN.) ⇒CAR OUTLET 30" ABOVE FINISH FLOOR +30" SWITCH DIMMER SWITCH $-\bigcirc$ D -(√)3 THREE-WAY SWITCH SCONCE PENDANT

NOTES - REFLECTED CEILING PLAN

- 1. ALL WORK EXECUTED UNDER THIS SECTION 1. CONTRACTOR SHALL KEEP BUILDING SHALL COMPLY WITH THE MOST CURRENT NATIONAL ELECTRICAL CODE & LOCAL CODE 2. ALL ROOFS SHALL SLOPE TO DRAIN. REGULATIONS. CONTRACTOR SHALL PERFORM ALL WORK IN COMPLIANCE WITH THESE REGULATIONS WHETHER OR NOT SUCH WORK IS SPECIFICALLY SHOWN ON DRAWINGS.
- 2. ALL SMOKE DETECTORS & CARBON MONOXIDE DETECTORS ARE TO BE HARDWIRED WITH A BATTERY BACKUP & INTERCONNECTED PER CODE.
- 3. INSTALL SMOKE DETECTORS IN ALL SLEEPING ROOMS, AT AREAS ADJACENT TO SLEEPING ROOMS, & AT CEILING HEIGHT CHANGES GREATER THAN 24", PER IRC R314. 6. NEW ROOFS TO INCLUDE A RADIANT
- 4. CONTRACTOR SHALL VERIFY SMOKE DETECTORS ARE LOCATED AT LEAST 36" AWAY FROM HORIZONTAL PATH OF MECHANICAL AIR FLOW. PER 2007 NFPA 72 CHAPTER 11.
- 5. INSTALL CARBON MONOXIDE DETECTORS IN THE AREA ADJACENT TO ALL SLEEPING ROOMS, PER IRC R315.
- 6. DUCTWORK TO BE SEALED/MASKED OFF DURING CONSTRUCTION TO PREVENT CONTAMINATION FROM CONSTRUCTION **DUST & DEBRIS.**
- 7. ALL LIGHTS & RECEPTACLES IN WET OR EXTERIOR LOCATIONS TO BE GFCI & WEATHERPROOF, PER CODE.
- 8. ELECTRICAL RECEPTACLE DISTRIBUTION AS REQUIRED BY IRC 2021 E3901.2 9. 100% OF ALL INSTALLED LIGHT FIXTURES ARE REQUIRED TO HAVE HIGH EFFICIENCY
- 10. ALL EXTERIOR LIGHT FIXTURES TO BE 11. THE ENTIRE EXTERIOR ENVELOPE TO BE SHIELDED FROM ABOVE TO PREVENT LIGHT POLLUTION.
- 11 SWITCHES & ENVIRONMENTAL CONTROLS 12. INSTALL ALL BUILDING ENVELOPE MAY BE NO HIGHER THAN 48" AFF ON THE FIRST FLOOR.
- 12. GROUP ALL SWITCHES & OUTLETS WHERE POSSIBLE.
- 13. SWITCHES SHALL NOT BE LOCATED WITHIN 5'-0" OF A TUB OR SHOWER.
- 14. OUTLETS WITHIN 36" OF A SINK OR LAVATORY SHALL BE ON A GFCI CIRCUIT. ADDITIONAL GFCI SHALL BE PROVIDED AS REQUIRED BY CODE.
- 15. OUTLETS & RECEPTACLES TO BE 15" MIN ABOVE INTERIOR FINISH FLOOR LEVEL EXCEPT FOR FLOOR OUTLETS. THIS NOTE PERTAINS TO LEVEL 01 ONLY.
- 16. PROVIDE BLOCKING FOR CEILING FANS AS REQUIRED. 17. PROVIDE BLOCKING FOR WALL MOUNTED
- TVS IF INDICATED ON THE DRAWINGS. VIF LOCATION & HEIGHT WITH OWNER OR ARCHITECT.
- 18. PROVIDE MAKE UP AIR AS NEEDED FOR VENTILATION FANS.
- 19. RECESSED LIGHT FIXTURES TO BE 3000K UNLESS NOTED OTHERWISE.

NOTE: NO BEAM DOWN THE CENTER OF A HALLWAY. LIGHT FIXTURES SHALL BE CENTERED ON HALLWAY.

NOTE: DIMENSIONS SHOWN ON ROOF PLANS ARE TO **EXTERIOR FACE OF FRAMING UNLESS NOTED OTHERWISE**

WINDOW KEY

A AWNING C CASEMENT E EXISTING F FIXED

H HUNG S SLIDER SK SKYLIGHT

T TRANSOM

JULY 61H 2023

REFERENCE

NOTES - ROOF

CONTRACTOR SHALL PROVIDE ALL TRIM,

WEATHERTIGHT CONSTRUCTED ROOF.

4. ALL ROOF PENETRATIONS TO BE PROPERLY

NEW ROOF SRI VALUE: IF SLOPE IS >2:12,

BARRIER WITH AN EMITTANCE OF .05 OR

LESS, UNLESS ROOF IS COVERED WITH A

MATERIAL HAVING A SOLAR REFLECTANCE

AIR IMPERMEABLE INSULATION OF R-25 OF

GREATER MAY BE USED IF MECHANICAL

EQUIPMENT & AIR DISTRIBUTION SYSTEM

BUILDING THERMAL ENVELOPE. SEE AUSTIN

OTHERWISE, ROOFING INSULATION TO BE A

ENVELOPE SHALL BE INSULATED AS R-8 MIN.

CURBS TO PREVENT WATER INTRUSION & TO

9. SKYLIGHTS: USE APPROPRIATE FLASHING &

10. SKYLIGHTS TO INCLUDE 10 YEAR, NO-LEAK

20 YEAR SEAL WARRANTY.

MOISTURE INTRUSION.

AWAY FROM BUILDING.

ACHIEVE MANUFACTURER'S WARRANTY.

WARRANTY, 10 YEAR IMPACT WARRANTY &

PROPERLY SEALED & FLASHED TO PREVENT

RECOMMENDATIONS & STANDARD DETAILS

(WHERE AVAILABLE). ASSEMBLIES INCLUDE,

RADIANT BARRIER, SKYLIGHTS, WINDOWS,

DOORS, SIDING, FLASHING, INSULATION,

13. PROVIDE NEW GUTTERS & DOWNSPOUTS TO

DRAIN ON SITE. DOWNSPOUTS TO DRAIN

DAVEY MCEATHRON

ARCHITECTURE

DAVEY@DAVEYMARCH.COM

512-599-0660

PERMIT

JULY 6TH 2023

DM210901

ISSUED

ISSUE DATE:

DRAWN BY:

REVISIONS:

PROJECT NUMBER:

1402 W NORTH LOOP BLVD, AUSTIN, TX 78756

WEATHER BARRIERS, SEALANTS, ETC.

ASSEMBLIES AS PER MANUFACTURER'S

WEATHER PROTECTION & WARRANTIES

TO ALLOW FOR PROPER FUNCTION,

BUT ARE NOT LIMITED TO, ROOFING,

ARE LOCATED ENTIRELY WITHIN THE

AMENDMENTS TO THE BUILDING CODE.

8. SUPPLY & RETURN DUCTS LOCATED IN

ATTICS OR OUTSIDE THE THERMAL

ROOFING MATERIALS SHALL HAVE A

FLASHED & SEALED TO PREVENT WATER

COMPLETE, WARRANTABLE, &

FLASHING, UNDERLAYMENTS, FASTENERS &

ACCESSORIES NECESSARY TO ENSURE A

WEATHERTIGHT.

INTRUSION.

MINIMUM SRI OF 29.


OF 0.5 OR GREATER.

MINIMUM OF R-38.

SOUTH SECOND RENO.

2009 SOUTH 2ND, AUSTIN, **TEXAS 78704**

HOUSE - FLOOR 1 & 02

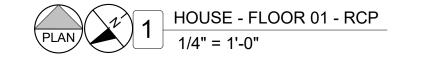


© 2023 DAVEY MCEATHRON ARCHITECTURE

NOT IN SCOPE

 $-\!\!-\!\!-$ NOT IN SCOPE $-\!\!-$

NOT IN SCOPE

PROJECT TO ADHERE TO ALL REQUIREMENTS IN THE 2021 IRC & ALL ADOPTED LOCAL AMENDMENTS. **««« IF PRINTED AT 11X17, SCALE IS 1/2 OF WHAT IS NOTED »»»**

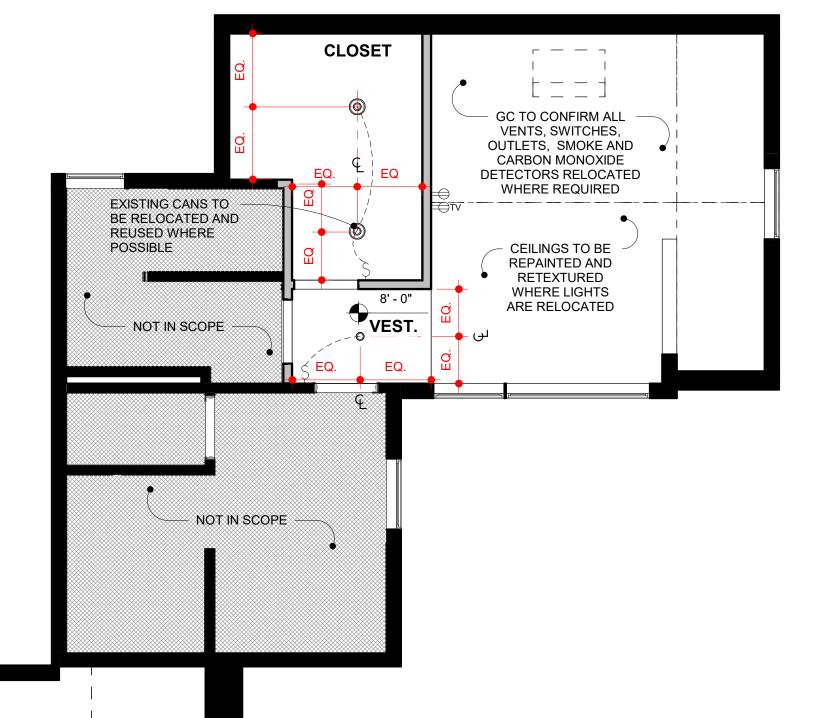

SURFACE MOUNTED LIGHT

RCP/POWER LEGEND

DATA / TELE

DOORBELL DOORBELL CHIME

SECURITY CAMERA - CAT6 DROP

THERMOSTAT

WINDOW KEY

- A AWNING
- C CASEMENT
- E EXISTING F FIXED
- H HUNG S SLIDER
- SK SKYLIGHT T TRANSOM
- SLOPE GRADE AWAY FROM BUILDING & FOUNDATION FOR 10'-0" MIN. WHERE POSSIBLE.

1. CONTRACTOR SHALL KEEP BUILDING

2. VERIFY ALL MATERIALS & FINISHES WITH

ARCHITECT OR OWNER PRIOR TO


WEATHERTIGHT.


INSTALLATION.

4. ALL EXPOSED FASTENERS ON WOOD SIDING TO BE STAINLESS STEEL.

NOTES - EXTERIOR ELEVATIONS

- 5. THE ENTIRE EXTERIOR ENVELOPE TO BE PROPERLY SEALED & FLASHED TO PREVENT MOISTURE INTRUSION.
- ALL PLUMBING, APPLIANCE & GAS VENTS SHALL VENT TO REAR OF ROOF RIDGE WHEREVER POSSIBLE. ALL VENTS SHALL BE GROUPED TO MINIMIZE ROOF PENETRATIONS.

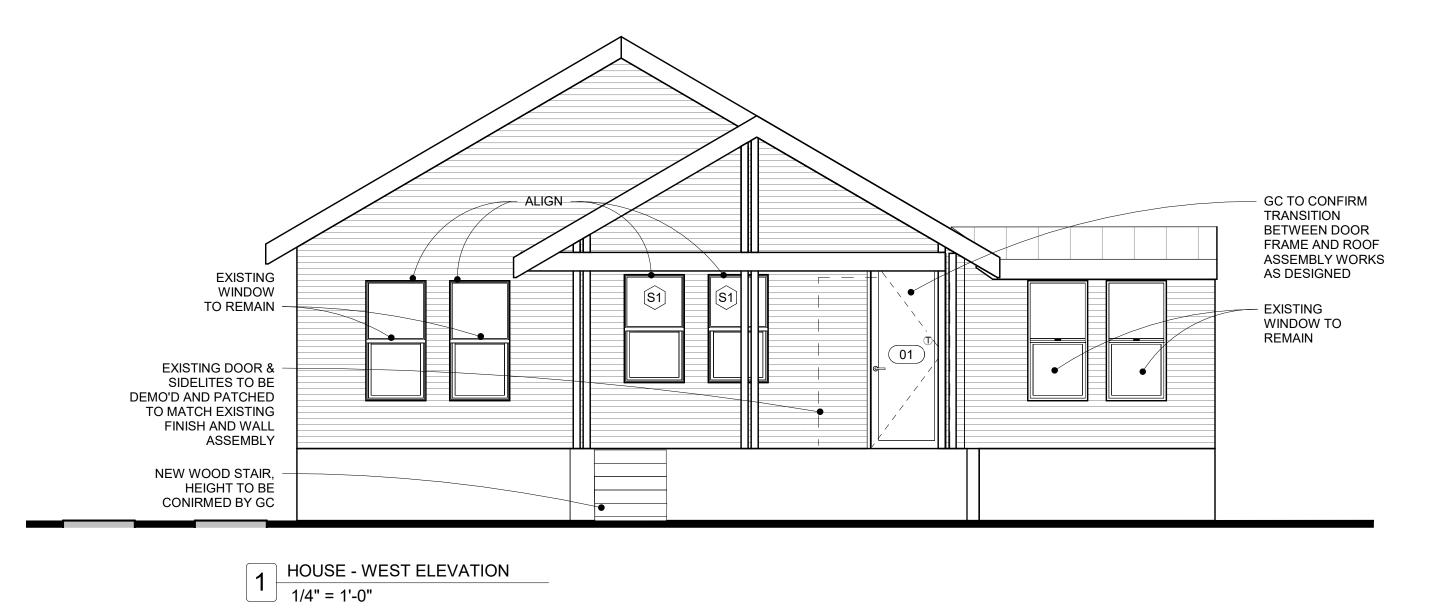

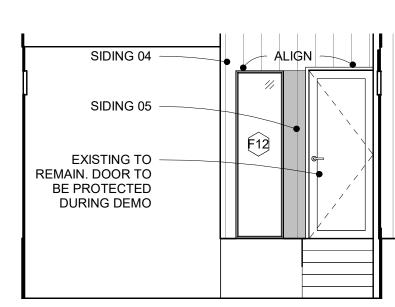


3 HOUSE - NORTH WALL
1/4" = 1'-0"



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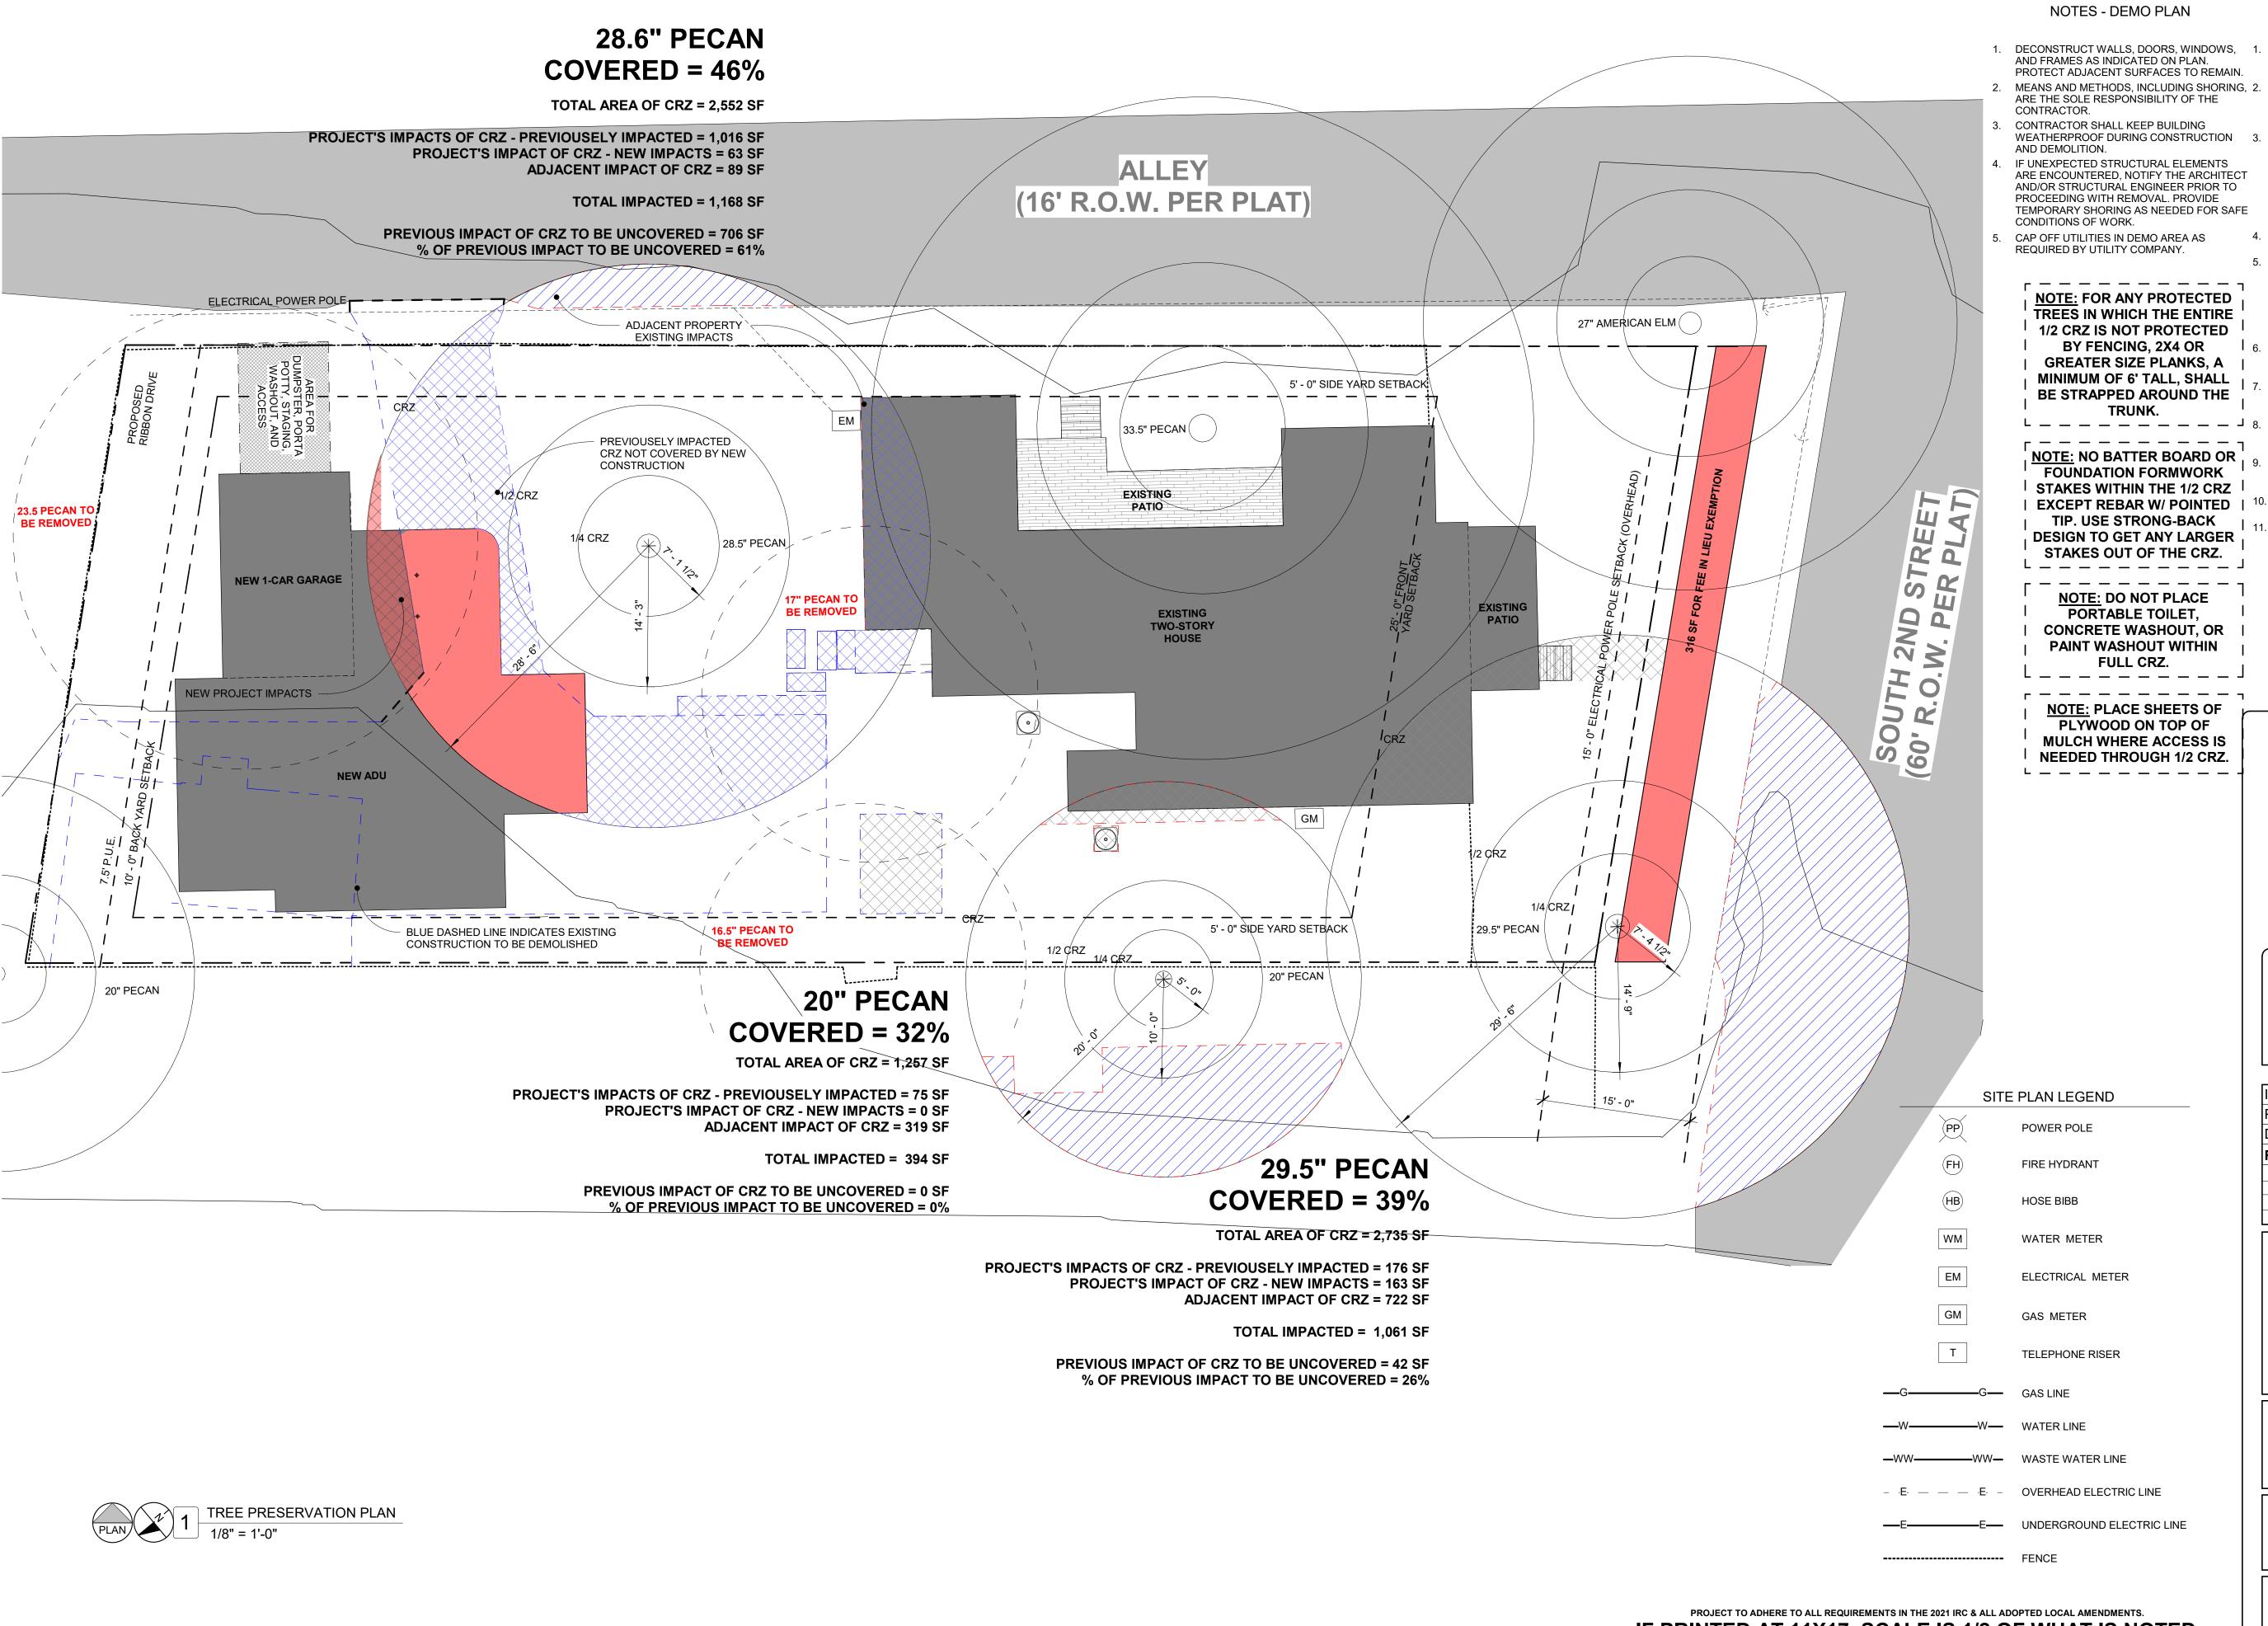
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SOUTH SECOND RENO.

2009 SOUTH 2ND, AUSTIN, TEXAS 78704

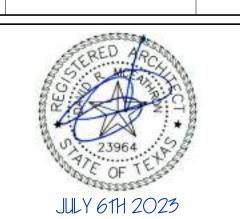EXTERIOR ELEVATIONS - HOUSE



NOTES - TREE PRESERVATION

OWS, 1. TREE PROTECTION FENCING IS REQUIRED FOR ALL PROTECTED/HERITAGE TREES

WITHIN THE LIMITS OF CONSTRUCTION.
FENCING SHOULD BE INDICATED TO
PROTECT THE ENTIRE CRITICAL ROOT ZONE
(CRZ) AREA OR AS MUCH OF THE CRZ AS IS
PRACTICAL.

WHEN THE TREE PROTECTION FENCING CANNOT INCORPORATE THE ENTIRE ½ CRITICAL ROOT ZONE, AN EIGHT INCH LAYER OF MULCH WITHIN THE ENTIRE AVAILABLE ROOT ZONE AREA IS REQUIRED FOR ALL TREES WHICH HAVE ANY DISTURBANCE INDICATED WITHIN ANY PORTION OF THE

CRITICAL ROOT ZONE.

FENCING IS REQUIRED TO BE CHAIN-LINK MESH AT A MINIMUM OF 5'-0" HIGH.
 2X4 OR GREATER SIZE PLANKS (6'-0" TALL MIN) ARE REQUIRED TO BE STRAPPED SECURELY AROUND PROTECTED TREES TRUNKS & ROOT FLARES WHEN PROTECTIVE FENCING DOES NOT INCORPORATE THE ENTIRE ½ CRZ FOR ANY REASON AT ANY TIME IN THE PROJECT.

NO CUT OR FILL GREATER THAN 4" ALLOWED WITHIN THE $\frac{1}{2}$ CRZ OF PROTECTED TREES & NO IMPACT IS ALLOWED IN THE $\frac{1}{4}$ CRZ.

ALL DEMOLITION IN THE 1/4 & 1/2 CRZ OF PROTECTED TREES MUST BE PERFORMED WITH HAND TOOLS.

PROTECTED TREES ARE NOTED AS 19"

DIAMETER OR GREATER & HERITAGE TREES ARE 24" OR GREATER. 50% MIN. OF THE CRZ MUST BE PRESERVED AT NATURAL GRADE WITH NATURAL GROUND

AT NATURAL GRADE WITH NATURAL GROUND COVER.
ALL UTILITY LINES & TRENCHING TO STAY

CLEAR OF ½ CRZ OF ALL PROTECTED TREES.
CONTRACTOR TO KEEP STAGING,
DUMPSTER, & PORTA POTTY CLEAR OF ½
CRZ OF ALL PROTECTED TREES.

DAVEY MCEATHRON
ARCHITECTURE


1402 W NORTH LOOP BLVD, AUSTIN, TX 78756
DAVEY@DAVEYMARCH.COM

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512-599-0660

ISSUE DATE: JULY 6TH 2023
PROJECT NUMBER: DM210901
DRAWN BY: Author
REVISIONS:

NO REFERENCE ISSUED

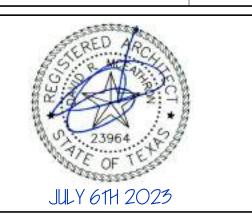

SOUTH SECOND RENO.

2009 SOUTH 2ND, AUSTIN, TEXAS 78704

HOUSE & ADU - TREE PROTECTION PLAN

SOUTH 2ND ADU

2009 SOUTH 2ND, AUSTIN, TEXAS 78704
PERMIT
JULY 6TH 2023



PROJECT NO:

1,091 SF

3,265 SF

3,636 SF

4,455 SF

BUILDING COVERAGE:

TOTAL IMPERVIOUS COVERAGE ON LOT:

TOTAL IMPERVIOUS

ALLOWED:

DM210901

SHEET INDEX:

A002 COVERSHEET-ADU

A100 SITE PLAN - HOUSE & ADU

A112 ADU FLOOR PLAN A122 ADU RCP

A132 ADU ROOF PLAN

A202 EXTERIOR ELEVATIONS - ADU

A600 ADU - SCHEDULES
A700 ADU - VISITABILITY EXHIBIT

A703 HOUSE & ADU - TREE PROTECTION PLAN

A704 ADU - SOLAR READY EXHIBIT





ARCHITECT

DAVEY MCEATHRON ARCHITECTURE 1402 W N LOOP BLVD AUSTIN, TEXAS 78756 TEL. (512) 599-0660

STRUCTURAL

SEC SOLUTIONS 407 FOREST STREET LIBERTY HILL, TX 78642 TEL. (512) 215-4364

<u>SURVEY</u>

TRI-TECH SURVEYING COMPANY, L.P. 100 E. SAN ANTONIO ST., STE. 100 SAN MARCOS, TEXAS 78666 TEL. (512) 440-0224




JULY 61H 2023

REVISIONS							
NO	REFERENCE	ISSUED					

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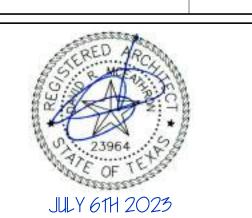
NOTES - SITE PLAN

- DIMENSIONS GOVERN. VERIFY EXISTING SITE CONDITIONS &
- REPORT TO ARCHITECT ANY DISCREPANCIES BETWEEN ACTUAL FIELD CONDITIONS & THESE PLANS PRIOR TO COMMENCING
- GRADE WITH CROSS SLOPE TO DRAIN AT 1/4" PER FOOT. SEAL CONCRETE & PROVIDE A BROOM FINISH UNLESS OTHERWISE NOTED. CONTRACTOR TO TIE INTO EXISTING
- UTILITIES. SOME UTILITIES MAY REQUIRE UPGRADING, CONTRACTOR TO VERIFY. VERIFY METER & UTILITY SERVICE LOCATIONS PRIOR TO INSTALLATION.
- 5. CONTRACTOR TO UTILIZE TEMPORARY **EROSION & SEDIMENTATION CONTROL** MEASURES AS REQUIRED BY CODE.
- 6. PROVIDE TREE PROTECTION FOR ALL TREES NOT MARKED FOR REMOVAL.
- 7. TREES TO BE REMOVED SHALL BE REMOVED FROM THE SOIL TO A DEPTH OF 12" BELOW THE SURFACE OF THE GROUND IN THE AREA OF THE BUILDING.
- 8. SELECTIVELY CLEAR OR PRUNE ANY UNWANTED TREES OR THOSE IMPEDING CONSTRUCTION WITH CONSENT OF OWNER. COORDINATE REMOVAL & DISPOSAL OF **UNWANTED TREES & OTHER LANDSCAPING** MATERIALS WITH OWNER.
- 9. EXISTING UTILITY LINE LOCATIONS ARE APPROXIMATED. CONTRACTOR TO VERIFY LOCATIONS PRIOR TO CONSTRUCTION.
- 10. ENSURE ALL GRADING SLOPES AWAY FROM BUILDING FOR AT LEAST 10'-0".
- 11. CONTRACTOR TO STORE ALL NEW MATERIALS IN DRY & SECURE LOCATION ON SITE AS SPECIFIED BY OWNER.
- 12. EXTERIOR HVAC EQUIPMENT SHALL BE SCREENED IN COMPLIANCE WITH ANY CITY OF AUSTIN REGULATIONS &/OR LOCAL DEED RESTRICTIONS.
- 13. PROVIDE CONTROL & EXPANSION JOINTS AS REQUIRED ON CONCRETE DRIVES, WALKS & PATIOS.
- 14. PROVIDE NEW GUTTERS & DOWNSPOUTS TO DRAIN ON SITE. DOWNSPOUTS TO DRAIN AWAY FROM BUILDING. CONFIRM DOWNSPOUT LOCATIONS WITH ARCHITECT PRIOR TO INSTALLATION.

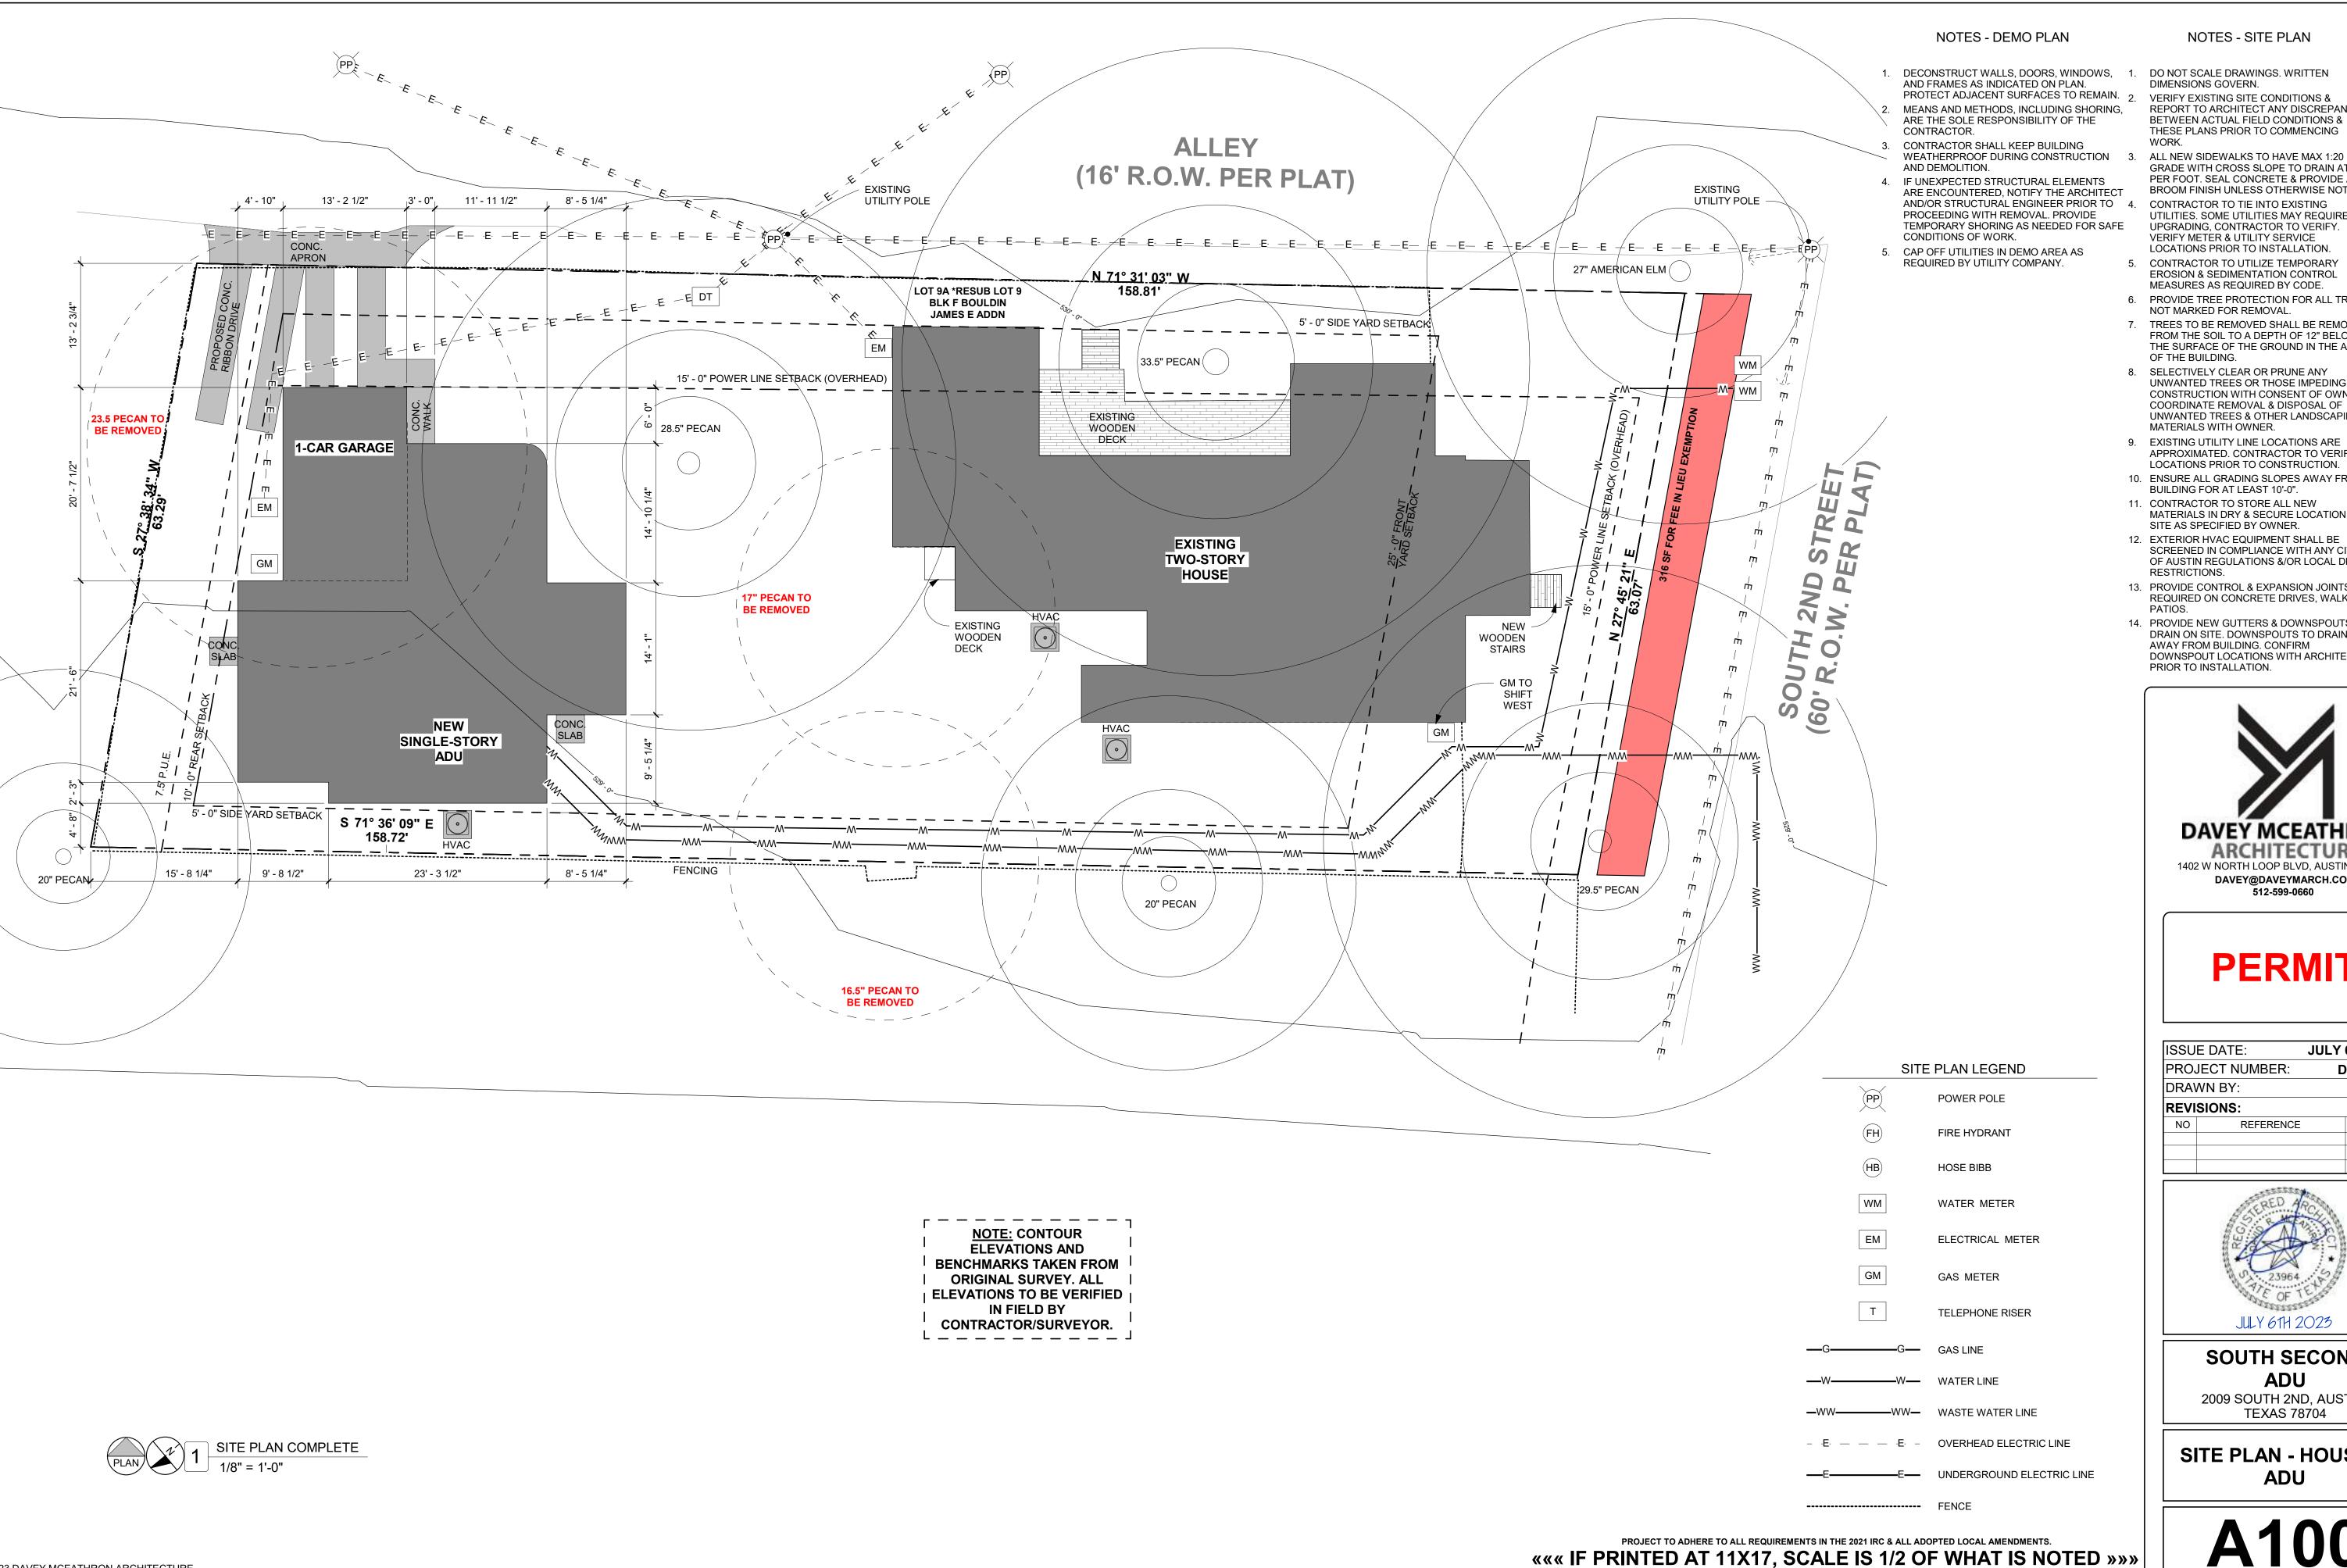

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ISSU	E DATE:	JULY 6TH	1 2023
PRO	JECT NUMBER:	DM2	10901
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NO	REFERENCE	IS	SUED



SOUTH SECOND ADU

2009 SOUTH 2ND, AUSTIN, TEXAS 78704

SITE PLAN - HOUSE & ADU

NOTES - FLOOR PLAN

- DO NOT SCALE DRAWINGS. WRITTEN DIMENSIONS GOVERN.
- 2. ALL DIMENSIONS ARE TO FINISH FACE,
- UNLESS NOTED OTHERWISE.

 3. PROVIDE FIRE BLOCKING AT ALL PLUMBING
- 4. ALL INTERIOR WALL PARTITIONS TO BE 2X4'S AT 16" O.C., EXCEPT TOILET PLUMBING WALLS, WHICH ARE TO BE 2X6'S, UNLESS NOTED OTHERWISE.
- 5. PROVIDE BLOCKING IN WALLS BEHIND & ADJACENT TO ALL TUBS & TOILETS FOR FUTURE GRAB BAR INSTALLATION.
- CABINET MATERIALS & ADHESIVES TO HAVE NO ADDED UREA-FORMALDEHYDE. INTERIOR PAINTS TO BE LOW-VOC.
- ALL NEW STAIRS, STEPS, & RAILINGS TO MEET CURRENT CODES AT THE TIME OF CONSTRUCTION.
- 8. SHOWER HEADS SHALL BE MOUNTED 7'-0" AFF UNLESS NOTED OTHERWISE.9. ALL ELECTRICAL AND PLUMBING FIXTURES
- ALL ELECTRICAL AND PLUMBING FIXTURE ARE TO BE INSTALLED PER CODE, INCLUDING LOCATION, OPERABLE COMPONENTS, & TYPE.
- 10. CONFIRM ALL PLUMBING CONNECTION LOCATIONS WITH ACTUAL FIXTURES.
- 11. PROTECT WOOD & WOOD-BASED PRODUCTS
- FROM DECAY & TERMITES PER CODE.

 12. FROM INTERIOR FINISH FLOOR TO ANY EXTERIOR FINISH FLOOR, THE DROP SHALL BE A MINIMUM OF 2", UNLESS OTHERWISE NOTED OR VISITABLE ENTRANCE.

 CONTRACTOR TO VERIFY MATERIALS USED FOR DECK CONSTRUCTION & FINISH FLOORING TO MAINTAIN MINIMUM DROP.
- 13. GARAGE TO BE SEPARATED FROM HOUSE BY 5/8" TYPE 'X' GYP ON WALLS & CEILINGS IN COMMON WITH THE HOUSE. DOOR TO BE 20 MIN. RATED WITH A SELF CLOSER.



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NO	REFERENCE		ISSUED




SOUTH SECOND ADU

2009 SOUTH 2ND, AUSTIN, TEXAS 78704

ADU FLOOR PLAN

A112

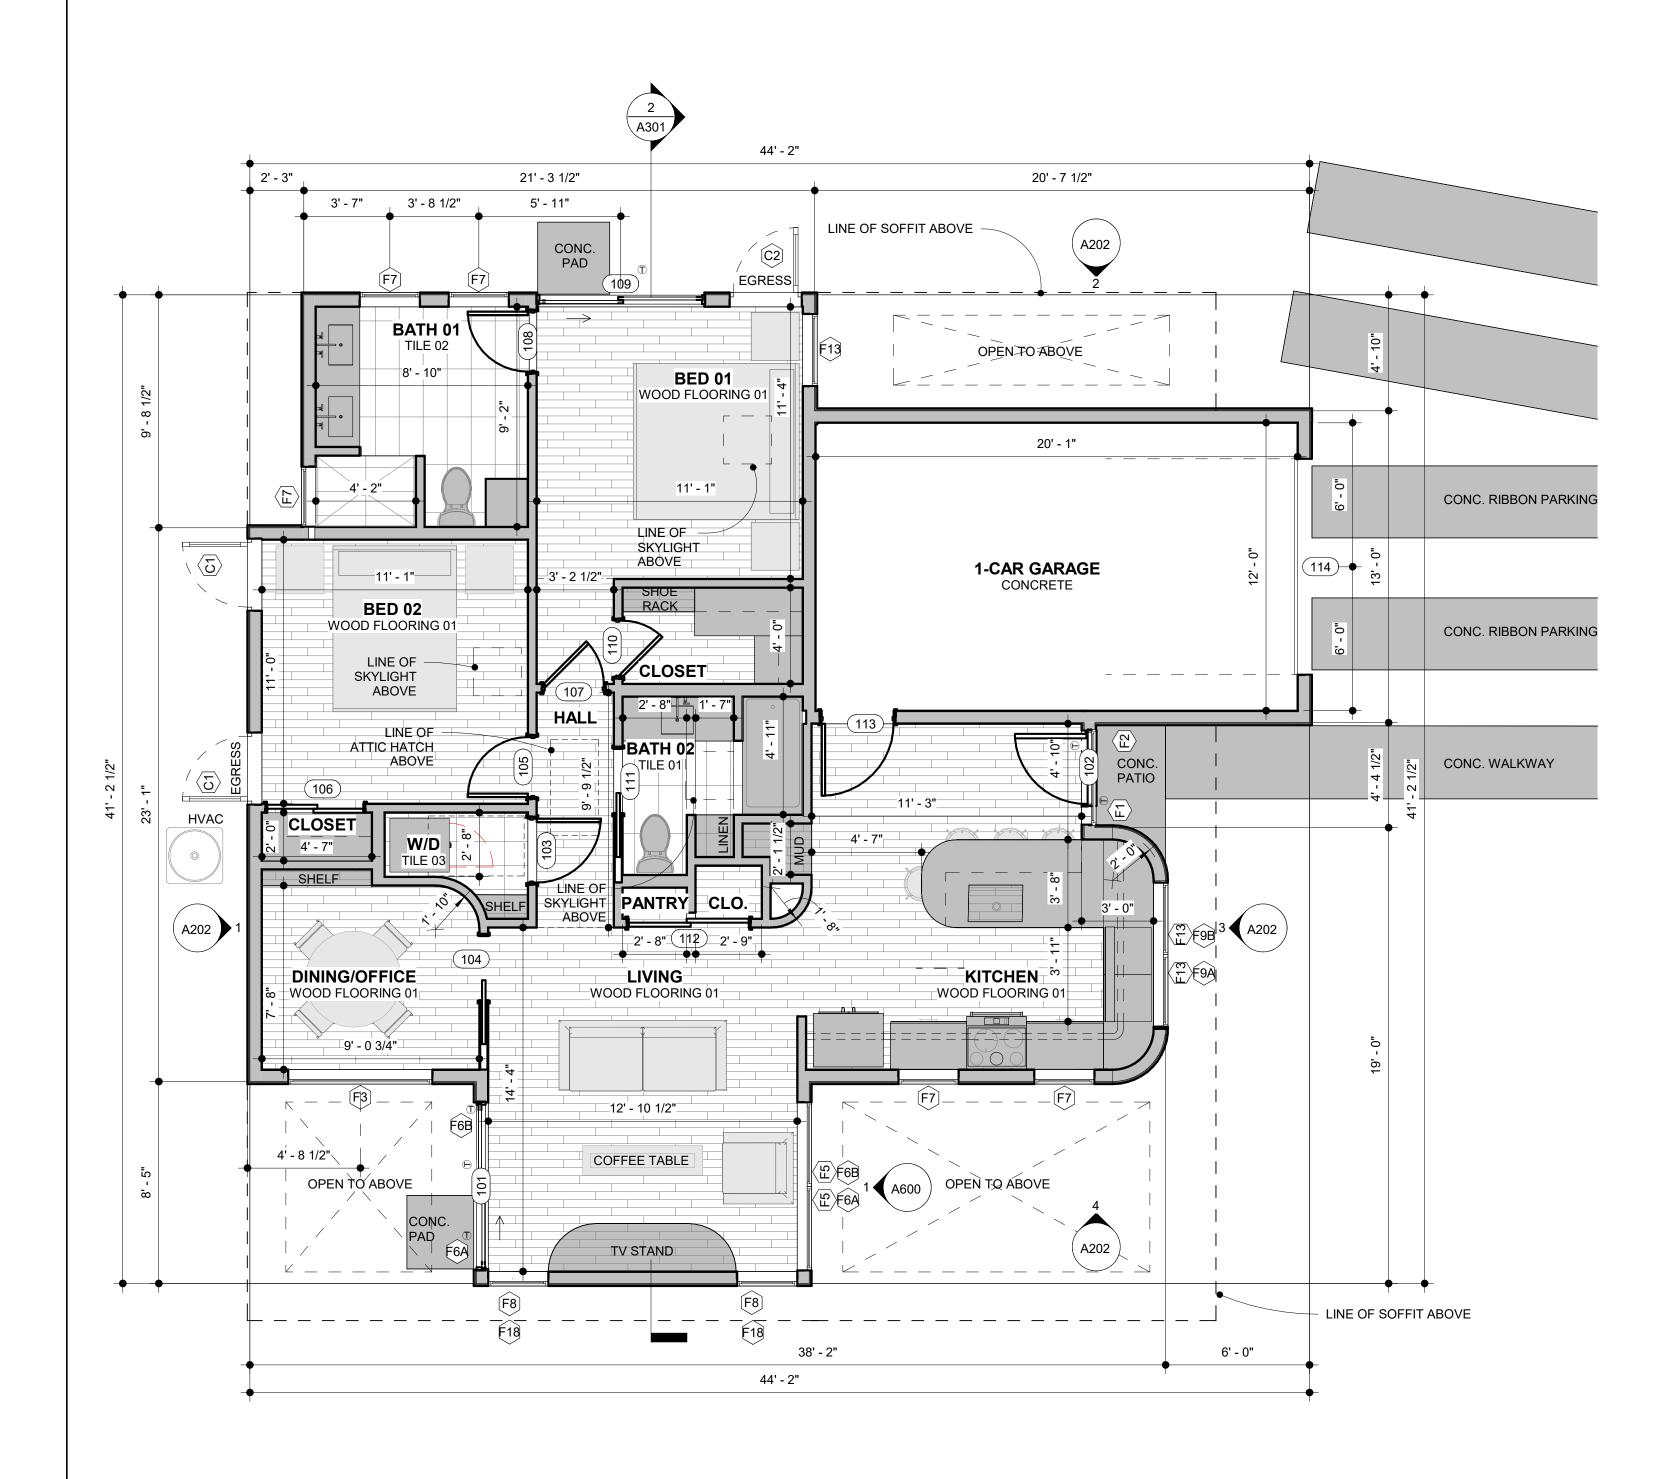

WINDOW KEY

A AWNING
C CASEMENT
E EXISTING

E EXISTING F FIXED

H HUNG S SLIDER

S SLIDER SK SKYLIGHT T TRANSOM

FLOOR PLAN LEGEND

EXISTING WALL


NEW WALL


(E) EXISTING

WALLS TO BE DEMOLISHED

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ADU FLOOR 01 DIMENSION PLAN



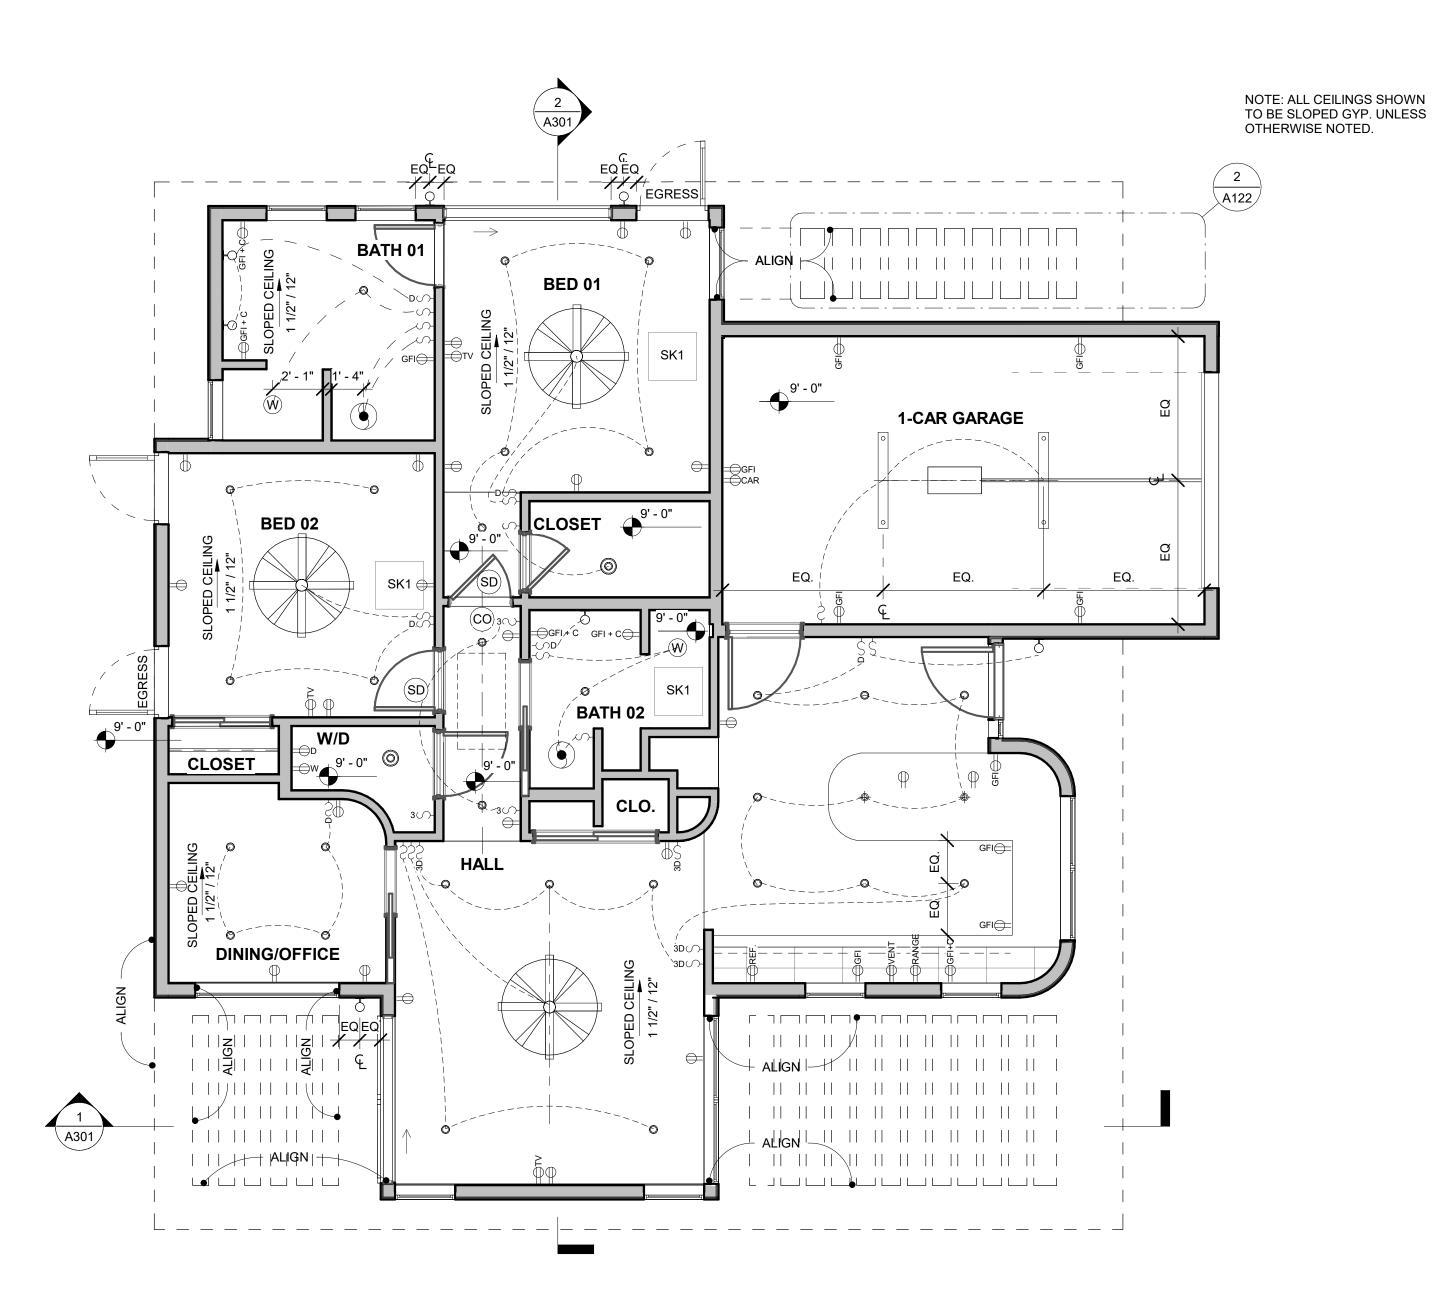

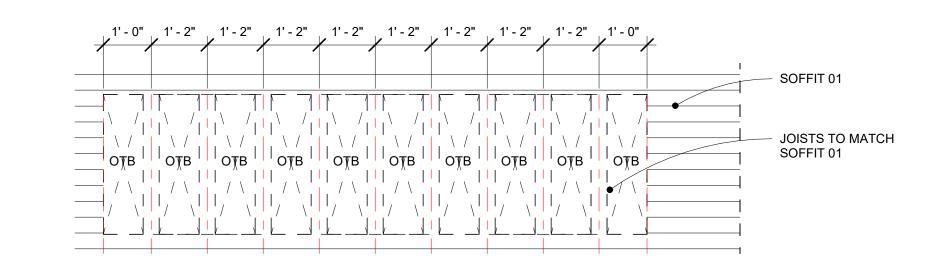(CO)

 \searrow

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⊕c

⇒GFI

 \Longrightarrow D

₩TV

⇒REF

 \Longrightarrow DW

→ MICRO

⇒CAR

====+30"

-(√D

TYP. SOFFIT VOID @ JOISTS

1/2" = 1'-0"

RCP/POWER LEGEND

SMOKE DETECTOR

EXHAUST FAN/LIGHT COMBO

EXHAUST FAN

CEILING LIGHT

FIXTURE/CHANDELIER

HVAC SUPPLY REGISTER

HVAC RETURN REGISTER

DUPLEX FLOOR OUTLET

GFCI DUPLEX OUTLET

DEDICATED CIRCUIT

TV OUTLET @ 60" A.F.F.

DISHWASHER OUTLET

MICROWAVE OUTLET

DIMMER SWITCH

THREE-WAY SWITCH

SWITCH

SCONCE

PENDANT

DATA / TELE

DOORBELL

DOORBELL CHIME

SECURITY CAMERA - CAT6 DROP

REFRIGERATOR OUTLET

CAR CHARGER (50 AMP MIN.)

OUTLET 30" ABOVE FINISH FLOOR

DUPLEX OUTLET

SURFACE MOUNT POP-UP OUTLET

DUPLEX OUTLET @ COUNTER HEIGHT

SURFACE MOUNTED LIGHT 4" RECESSED DOWNLIGHT REGULATIONS. CONTRACTOR SHALL 4" WET-RATED RECESSED DOWNLIGHT THESE REGULATIONS WHETHER OR NOT SUCH WORK IS SPECIFICALLY SHOWN ON DRAWINGS. SMOKE / CO DETECTOR

> MONOXIDE DETECTORS ARE TO BE INTERCONNECTED PER CODE.

3. INSTALL SMOKE DETECTORS IN ALL SLEEPING ROOMS, AT AREAS ADJACENT TO SLEEPING ROOMS, & AT CEILING HEIGHT CHANGES GREATER THAN 24", PER IRC R314.

4. CONTRACTOR SHALL VERIFY SMOKE DETECTORS ARE LOCATED AT LEAST 36" AWAY FROM HORIZONTAL PATH OF MECHANICAL AIR FLOW. PER 2007 NFPA 72

THE AREA ADJACENT TO ALL SLEEPING ROOMS, PER IRC R315.

8. ELECTRICAL RECEPTACLE DISTRIBUTION AS REQUIRED BY IRC 2021 E3901.2

11 SWITCHES & ENVIRONMENTAL CONTROLS MAY BE NO HIGHER THAN 48" AFF ON THE

12. GROUP ALL SWITCHES & OUTLETS WHERE

14. OUTLETS WITHIN 36" OF A SINK OR

15. OUTLETS & RECEPTACLES TO BE 15" MIN ABOVE INTERIOR FINISH FLOOR LEVEL EXCEPT FOR FLOOR OUTLETS. THIS NOTE PERTAINS TO LEVEL 01 ONLY.

16. PROVIDE BLOCKING FOR CEILING FANS AS

REQUIRED. 17. PROVIDE BLOCKING FOR WALL MOUNTED TVS IF INDICATED ON THE DRAWINGS. VIF LOCATION & HEIGHT WITH OWNER OR ARCHITECT.

19. RECESSED LIGHT FIXTURES TO BE 3000K UNLESS NOTED OTHERWISE.

NOTES - REFLECTED CEILING PLAN

1. ALL WORK EXECUTED UNDER THIS SECTION SHALL COMPLY WITH THE MOST CURRENT NATIONAL ELECTRICAL CODE & LOCAL CODE PERFORM ALL WORK IN COMPLIANCE WITH

2. ALL SMOKE DETECTORS & CARBON HARDWIRED WITH A BATTERY BACKUP &

CHAPTER 11.

5. INSTALL CARBON MONOXIDE DETECTORS IN

6. DUCTWORK TO BE SEALED/MASKED OFF DURING CONSTRUCTION TO PREVENT CONTAMINATION FROM CONSTRUCTION DUST & DEBRIS.

7. ALL LIGHTS & RECEPTACLES IN WET OR EXTERIOR LOCATIONS TO BE GFCI & WEATHERPROOF, PER CODE.

9. 100% OF ALL INSTALLED LIGHT FIXTURES ARE REQUIRED TO HAVE HIGH EFFICIENCY

10. ALL EXTERIOR LIGHT FIXTURES TO BE SHIELDED FROM ABOVE TO PREVENT LIGHT

FIRST FLOOR.

POSSIBLE.

13. SWITCHES SHALL NOT BE LOCATED WITHIN 5'-0" OF A TUB OR SHOWER.

LAVATORY SHALL BE ON A GFCI CIRCUIT. ADDITIONAL GFCI SHALL BE PROVIDED AS REQUIRED BY CODE.

18. PROVIDE MAKE UP AIR AS NEEDED FOR VENTILATION FANS.

SOUTH SECOND ADU 2009 SOUTH 2ND, AUSTIN,

ADU RCP

JULY 61H 2023

TEXAS 78704

DAVEY MCEATHRON

ARCHITECTURE

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512-599-0660

PERMIT

REFERENCE

ISSUE DATE:

DRAWN BY:

REVISIONS:

PROJECT NUMBER:

JULY 6TH 2023

DM210901

Author

ISSUED

1402 W NORTH LOOP BLVD, AUSTIN, TX 78756

NOTE: NO OUTLET IN WATERFALL FACE OF A AWNING ISLAND. ELECTRICIAN TO **GET APPROVAL FROM** E EXISTING ARCHITECT FOR OUTLET F FIXED NOTE: NO BEAM DOWN THE H HUNG CENTER OF A HALLWAY. LOCATIONS IN ISLAND AND S SLIDER LIGHT FIXTURES SHALL BE **ALL OTHER SPECIALTY** SK SKYLIGHT CENTERED ON HALLWAY. AREAS PRIOR TO INSTALL

WINDOW KEY C CASEMENT

T TRANSOM

PROJECT TO ADHERE TO ALL REQUIREMENTS IN THE 2021 IRC & ALL ADOPTED LOCAL AMENDMENTS. **««« IF PRINTED AT 11X17, SCALE IS 1/2 OF WHAT IS NOTED »»»**



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г — — — — — — ¬ | NOTE: DIMENSIONS SHOWN | ON ROOF PLANS ARE TO EXTERIOR FACE OF FRAMING UNLESS NOTED OTHERWISE

WINDOW KEY

- A AWNING
- C CASEMENT E EXISTING

T TRANSOM

- F FIXED
- H HUNG
- S SLIDER SK SKYLIGHT
- ROOFING MATERIALS SHALL HAVE A MINIMUM SRI OF 29. 6. NEW ROOFS TO INCLUDE A RADIANT
- BARRIER WITH AN EMITTANCE OF .05 OR LESS, UNLESS ROOF IS COVERED WITH A MATERIAL HAVING A SOLAR REFLECTANCE OF 0.5 OR GREATER.

5. NEW ROOF SRI VALUE: IF SLOPE IS >2:12,

NOTES - ROOF

CONTRACTOR SHALL KEEP BUILDING

2. ALL ROOFS SHALL SLOPE TO DRAIN.

COMPLETE, WARRANTABLE, & WEATHERTIGHT CONSTRUCTED ROOF. 4. ALL ROOF PENETRATIONS TO BE PROPERLY FLASHED & SEALED TO PREVENT WATER

3. CONTRACTOR SHALL PROVIDE ALL TRIM,

FLASHING, UNDERLAYMENTS, FASTENERS &

ACCESSORIES NECESSARY TO ENSURE A

WEATHERTIGHT.

INTRUSION.

- 7. AIR IMPERMEABLE INSULATION OF R-25 OF GREATER MAY BE USED IF MECHANICAL **EQUIPMENT & AIR DISTRIBUTION SYSTEM** ARE LOCATED ENTIRELY WITHIN THE BUILDING THERMAL ENVELOPE. SEE AUSTIN AMENDMENTS TO THE BUILDING CODE. OTHERWISE, ROOFING INSULATION TO BE A MINIMUM OF R-38.
- 8. SUPPLY & RETURN DUCTS LOCATED IN ATTICS OR OUTSIDE THE THERMAL ENVELOPE SHALL BE INSULATED AS R-8 MIN.
- 9. SKYLIGHTS: USE APPROPRIATE FLASHING & CURBS TO PREVENT WATER INTRUSION & TO ACHIEVE MANUFACTURER'S WARRANTY.
- 10. SKYLIGHTS TO INCLUDE 10 YEAR, NO-LEAK WARRANTY, 10 YEAR IMPACT WARRANTY & 20 YEAR SEAL WARRANTY. 11. THE ENTIRE EXTERIOR ENVELOPE TO BE

PROPERLY SEALED & FLASHED TO PREVENT

MOISTURE INTRUSION. 12. INSTALL ALL BUILDING ENVELOPE ASSEMBLIES AS PER MANUFACTURER'S RECOMMENDATIONS & STANDARD DETAILS TO ALLOW FOR PROPER FUNCTION, WEATHER PROTECTION & WARRANTIES (WHERE AVAILABLE). ASSEMBLIES INCLUDE,


BUT ARE NOT LIMITED TO, ROOFING, RADIANT BARRIER, SKYLIGHTS, WINDOWS, DOORS, SIDING, FLASHING, INSULATION,

WEATHER BARRIERS, SEALANTS, ETC. 13. PROVIDE NEW GUTTERS & DOWNSPOUTS TO DRAIN ON SITE. DOWNSPOUTS TO DRAIN AWAY FROM BUILDING.



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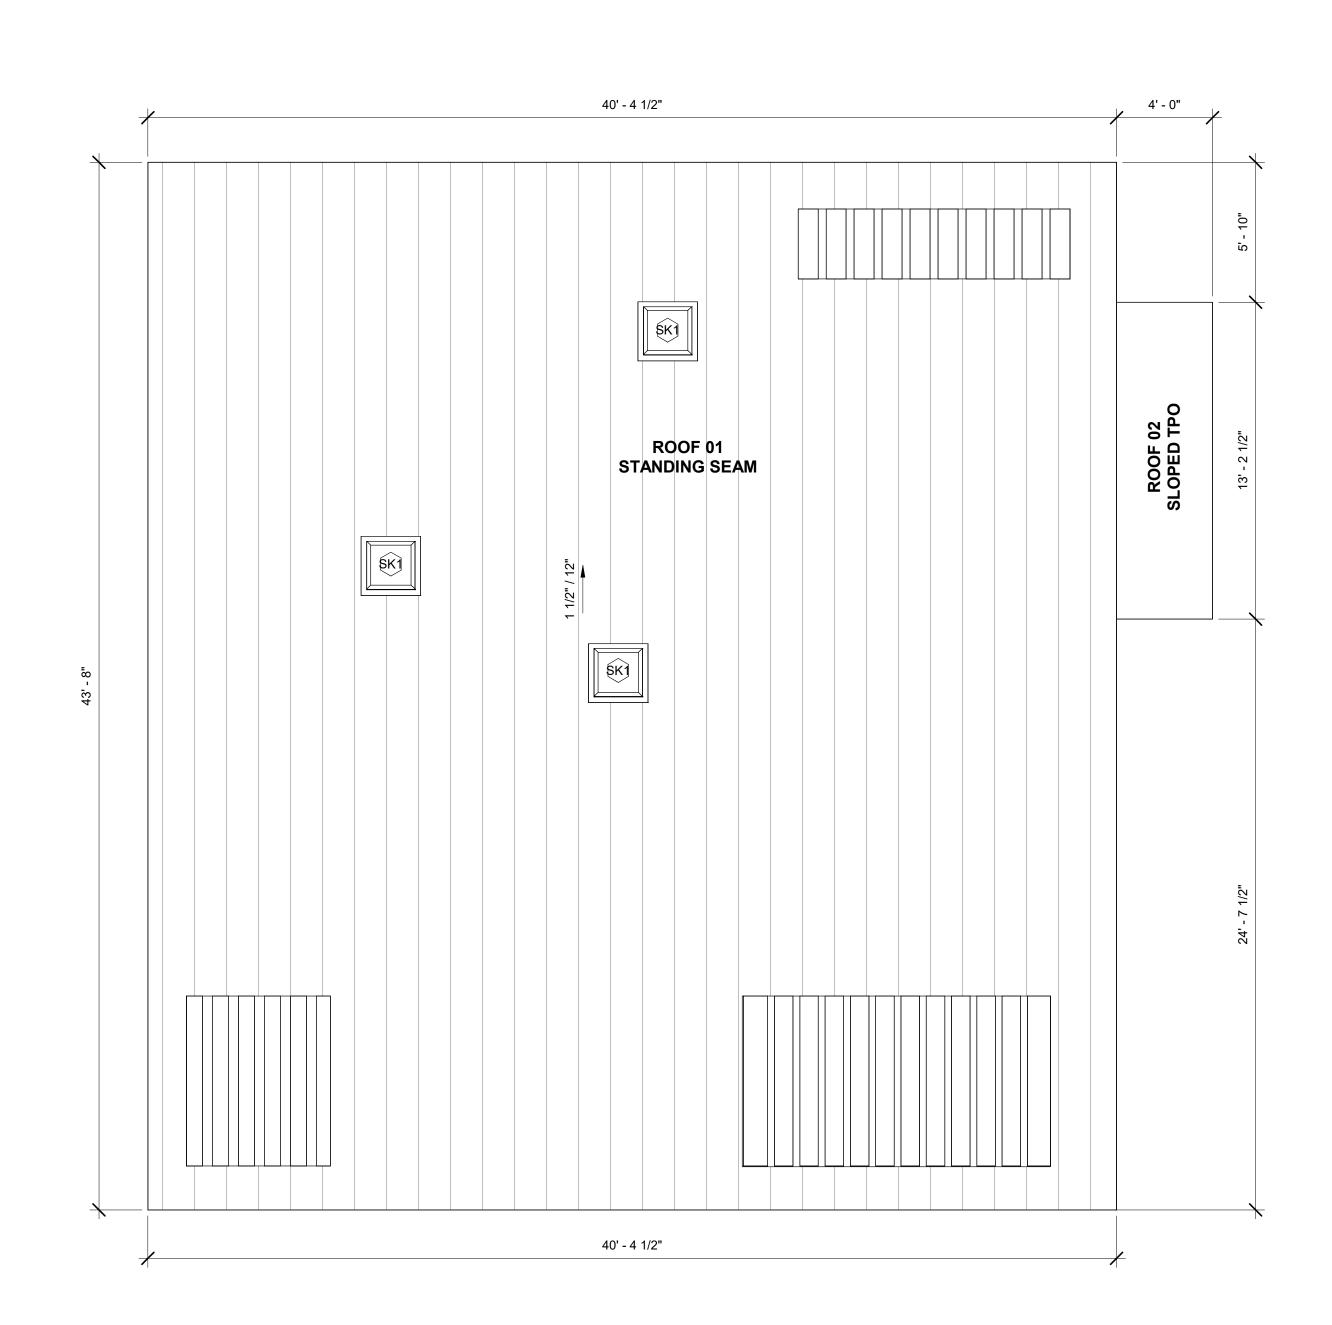
ISSUE D	ATE:	JULY	6TH 2023
PROJEC	T NUMBER:	D	M210901
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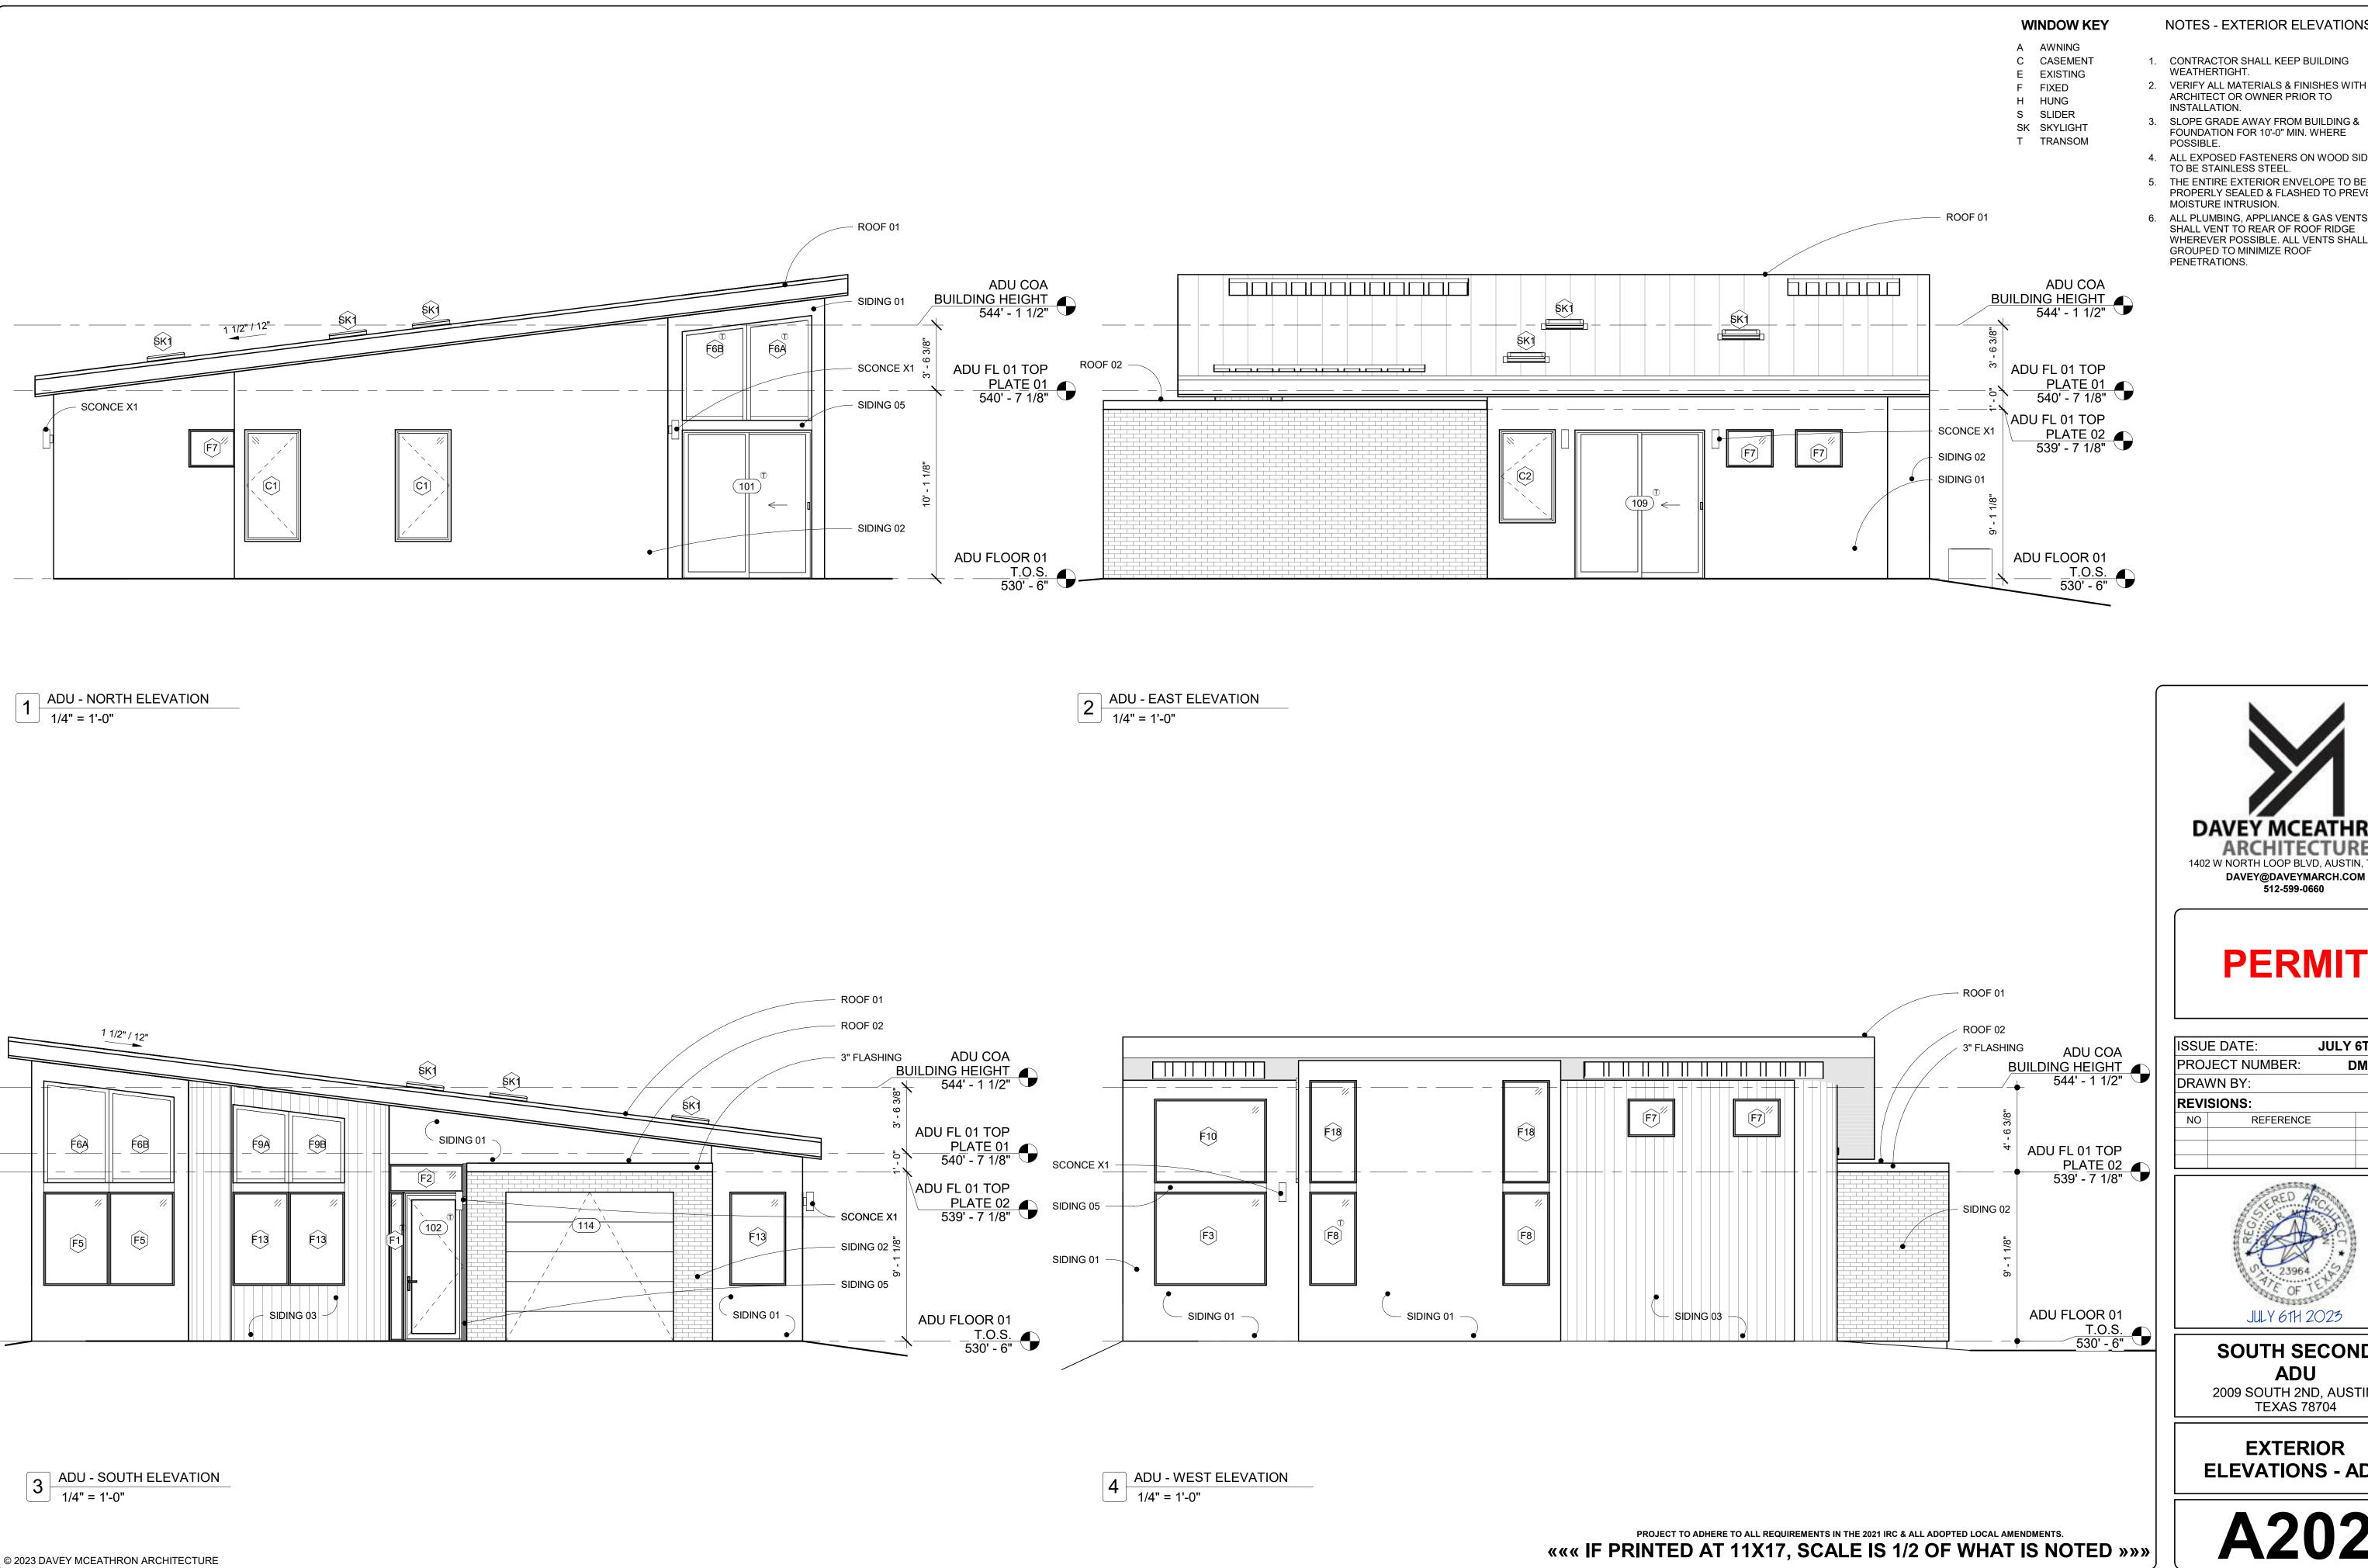


SOUTH SECOND ADU

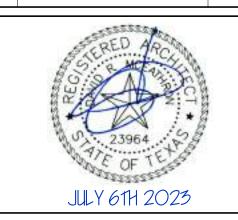2009 SOUTH 2ND, AUSTIN, TEXAS 78704

ADU ROOF PLAN





NOTES - EXTERIOR ELEVATIONS

2. VERIFY ALL MATERIALS & FINISHES WITH ARCHITECT OR OWNER PRIOR TO

4. ALL EXPOSED FASTENERS ON WOOD SIDING

TO BE STAINLESS STEEL.

5. THE ENTIRE EXTERIOR ENVELOPE TO BE PROPERLY SEALED & FLASHED TO PREVENT MOISTURE INTRUSION.

6. ALL PLUMBING, APPLIANCE & GAS VENTS SHALL VENT TO REAR OF ROOF RIDGE WHEREVER POSSIBLE. ALL VENTS SHALL BE GROUPED TO MINIMIZE ROOF



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JULY 6TH 2023 PROJECT NUMBER: DM210901 REFERENCE ISSUED




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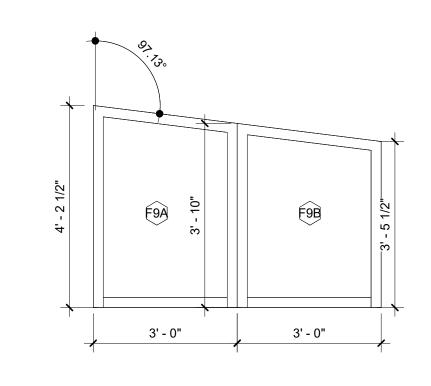
TEXAS 78704


EXTERIOR ELEVATIONS - ADU


					WINDC	W SCHEDUL	-E - ADU			
ROOM NAME	NET WIDTH	FRAME HEIGHT	ROUGH WIDTH	OPENING HEIGHT	SILL HEIGHT	HEAD HEIGHT	GLAZING	EGRESS REQ'D	COMMENTS	Level
CASEMENT C1										
BED 02	3' - 0"	6' - 0"	3' - 0 1/2"	6' - 0 1/2"	2' - 0"	8' - 0"	-	EGRESS		ADU FLOOR 01 T.O.S.
BED 02	3' - 0"	6' - 0"	3' - 0 1/2"	6' - 0 1/2"	2' - 0"	8' - 0"	-	-		ADU FLOOR 01 T.O.S.
C2			-	1						-
BED 01	3' - 0"	5' - 0"	3' - 0 1/2"	5' - 0 1/2"	3' - 0"	8' - 0"	-	EGRESS		ADU FLOOR 01 T.O.S.
FIXED F1										
KITCHEN	9"	8' - 0"	9 1/2"	8' - 0 1/2"	0"	8' - 0"	TEMPERED			ADU FLOOR 01 T.O.S.
F2 KITCHEN	4' - 0"	1' - 6"	4' - 0 1/2"	1' - 6 1/2"	8' - 0"	9' - 6"	-			ADU FLOOR 01 T.O.S.
F3		1. 0	. 0 ./2	1 0 1/2	0 0					7.0012001101110.0.
DINING/OFFICE	6' - 0"	5' - 0"	6' - 0 1/2"	5' - 0 1/2"	3' - 0"	8' - 0"	-			ADU FLOOR 01 T.O.S.
F5										
LIVING	3' - 6"	5' - 0"	3' - 6 1/2"	5' - 0 1/2"	3' - 0"	8' - 0"	-			ADU FLOOR 01 T.O.S.
LIVING	3' - 6"	5' - 0"	3' - 6 1/2"	5' - 0 1/2"	3' - 0"	8' - 0"	-			ADU FLOOR 01 T.O.S.
F6A								<u> </u>		-
LIVING	3' - 5"	REF: ELEV.	3' - 5 1/2"	REF: ELEV.	8' - 6"	10' - 6"	-			ADU FLOOR 01 T.O.S.
F6B										
LIVING	3' - 5"	REF: ELEV.	3' - 5 1/2"	REF: ELEV.	8' - 6"	10' - 6"	-			ADU FLOOR 01 T.O.S.
F7							_			
BATH 01	2' - 6"	2' - 0"	2' - 6 1/2"	2' - 0 1/2"	6' - 0"	8' - 0"	-			ADU FLOOR 01 T.O.S.
BATH 01	2' - 6"	2' - 0"	2' - 6 1/2"	2' - 0 1/2"	6' - 0"	8' - 0"	-			ADU FLOOR 01 T.O.S.
BATH 01	2' - 6"	2' - 0"	2' - 6 1/2"	2' - 0 1/2"	6' - 0"	8' - 0"	-			ADU FLOOR 01 T.O.S.
KITCHEN	2' - 6"	2' - 0"	2' - 6 1/2"	2' - 0 1/2"	11' - 0"	13' - 0"	-			ADU FLOOR 01 T.O.S.
KITCHEN	2' - 6"	2' - 0"	2' - 6 1/2"	2' - 0 1/2"	11' - 0"	13' - 0"	-			ADU FLOOR 01 T.O.S.
F8										
LIVING	2' - 6"	5' - 0"	2' - 6 1/2"	5' - 0 1/2"	3' - 0"	8' - 0"	TEMPERED			ADU FLOOR 01 T.O.S.
LIVING	2' - 6"	5' - 0"	2' - 6 1/2"	5' - 0 1/2"	3' - 0"	8' - 0"	-			ADU FLOOR 01 T.O.S.
F9A							_			
KITCHEN	3' - 0"	REF: ELEV.	3' - 0 1/2"	REF: ELEV.	8' - 6"	10' - 6"	-			ADU FLOOR 01 T.O.S.
F9B	Ta::		Ta		12. 5"	1.5::	T	T.		
KITCHEN	3' - 0"	REF: ELEV.	3' - 0 1/2"	REF: ELEV.	8' - 6"	10' - 6"	-			ADU FLOOR 01 T.O.S.
F13		T=1 C''	Tot. 6 : :5::	EL 6 //5"	01 5"			T		
BED 01	3' - 0"	5' - 0"	3' - 0 1/2"	5' - 0 1/2"	3' - 0"	8' - 0"	-			ADU FLOOR 01 T.O.S.
KITCHEN	3' - 0"	5' - 0"	3' - 0 1/2"	5' - 0 1/2"	3' - 0"	8' - 0"	-			ADU FLOOR 01 T.O.S.
KITCHEN	3' - 0"	5' - 0"	3' - 0 1/2"	5' - 0 1/2"	3' - 0"	8' - 0"	-			ADU FLOOR 01 T.O.S.
F18	Ta. a	T	Ta. a //		1	1				1.22
LIVING	2' - 6"	5' - 6"	2' - 6 1/2"	5' - 6 1/2"	8' - 6"	14' - 0"	-			ADU FLOOR 01 T.O.S.
LIVING	2' - 6"	5' - 6"	2' - 6 1/2"	5' - 6 1/2"	8' - 6"	14' - 0"	-			ADU FLOOR 01 T.O.S.


				DOOR SO	CHEDULE - AD	U		
				PA	ANEL			
DOOR#	ROOM NAME	TYPE	WIDTH	HEIGHT	THICKNESS	GLAZING	COMMENTS	Level
101	LIVING	SLIDING	7' - 0"	8' - 0"	4 1/2"	TEMPERED		ADU FLOOR 0 T.O.S.
102	KITCHEN	SWING - GLASS	3' - 2"	8' - 0"	4 1/2"	TEMPERED	VISITABLE ENTRANCE DOOR, COMMERCIAL SILL	ADU FLOOR 0 T.O.S.
103	W/D	SWING	2' - 8"	8' - 0"	1 3/4"			ADU FLOOR 0 T.O.S.
104	DINING/OFFICE	POCKET	2' - 8"	8' - 0"	1 3/4"			ADU FLOOR 0 T.O.S.
105	HALL	SWING	2' - 6"	8' - 0"	1 3/4"			ADU FLOOR 0 T.O.S.
106	BED 02	SLIDING	4' - 0"	8' - 0"	2"			ADU FLOOR 0 T.O.S.
107	HALL	SWING	2' - 6"	7' - 0"	1 3/4"			ADU FLOOR 0 T.O.S.
108	BED 01	SWING	2' - 6"	7' - 0"	1 3/4"			ADU FLOOR 0 T.O.S.
109	BED 01	SLIDING	7' - 0"	8' - 0"	4 1/2"	TEMPERED		ADU FLOOR 0 T.O.S.
110	BED 01	SWING	2' - 4"	8' - 0"	1 3/4"			ADU FLOOR 0 T.O.S.
111	BATH 02	POCKET	2' - 8"	8' - 0"	1 3/4"		VISITABLE BATHROOM DOOR	ADU FLOOR 0 T.O.S.
112	LIVING	SLIDING	5' - 0"	8' - 0"	2"			ADU FLOOR 0 T.O.S.
113	1-CAR GARAGE	SWING	3' - 0"	8' - 0"	1 3/4"			ADU FLOOR 0 T.O.S.
114	1-CAR GARAGE	OVERHEAD	9' - 0"	8' - 0"	1 1/2"			ADU FLOOR 0 T.O.S.



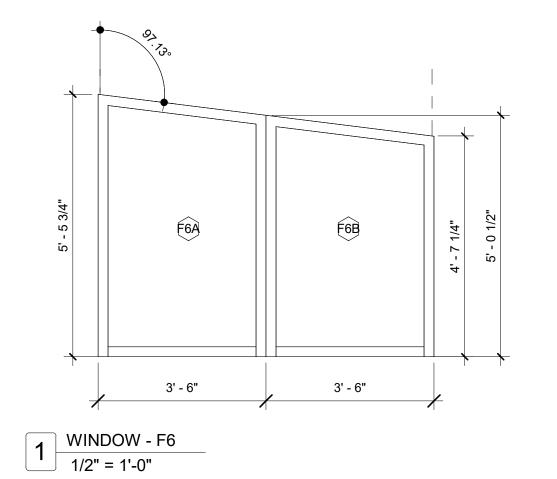

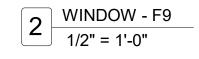

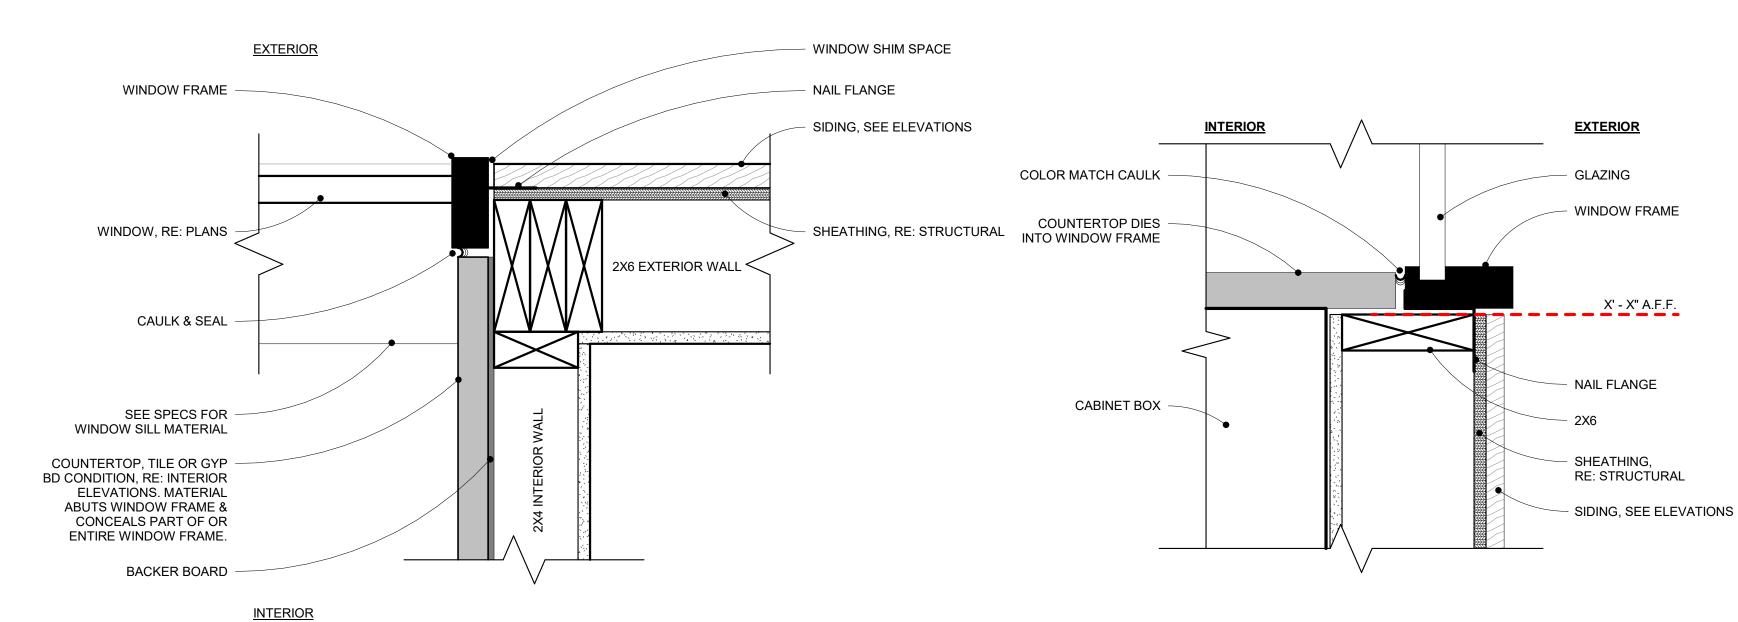

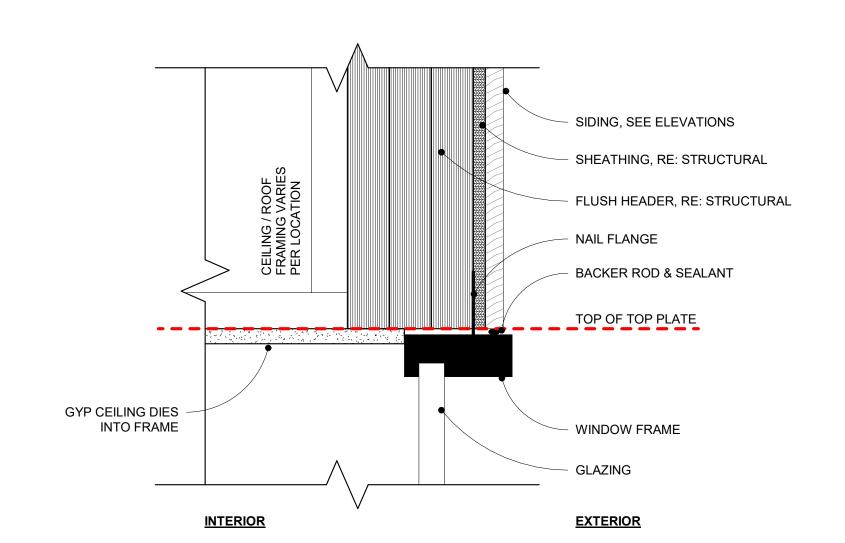

3 WINDOW HEAD @ FLUSH HEADER
3" = 1'-0"

WINDOW JAMB @ WALL INTERSECTION

3" = 1'-0"

PROJECT TO ADHERE TO ALL REQUIREMENTS IN THE 2021 IRC & ALL ADOPTED LOCAL AMENDMENTS.

««« IF PRINTED AT 11X17, SCALE IS 1/2 OF WHAT IS NOTED »»»

5 WINDOW SILL @ COUNTERTOP
3" = 1'-0"

DAVEY MCEATHRON
ARCHITECTURE
1402 W NORTH LOOP BLVD, AUSTIN, TX 78756

NOTES - DOOR SCHEDULE

REQUIREMENTS & ALL AMENDMENTS AS ADOPTED BY THE CITY OF AUSTIN.

2. ALL GLAZING IN DOORS & WITHIN A 24" ARC OF THE VERTICAL EDGE OF DOORS MUST BE

3. CONTRACTOR TO COORDINATE WITH DOOR SUPPLIER TO ENSURE DOORS MEET

CURRENT CODES.


1. WINDOWS & DOORS TO MEET IRC 2021

PERMIT

DAVEY@DAVEYMARCH.COM

512-599-0660


ISSU	E DATE:	JULY 6	TH 2023
PRO.	JECT NUMBER:	DN	1210901
DRA	WN BY:		Author
REVI	SIONS:		
NO	REFERENCE		ISSUED
1			

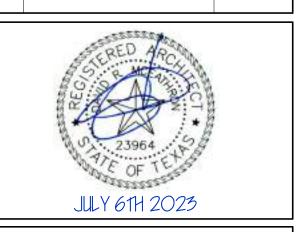


SOUTH SECOND ADU 2009 SOUTH 2ND, AUSTIN, TEXAS 78704

ADU - SCHEDULES

- LIGHT SWITCH & ENVIRONMENTAL CONTROLS NO HIGHER THAN 48" ABOVE INTERIOR FINISH FLOOR LEVEL. THIS NOTE PERTAINS TO LEVEL 01 ONLY.
- 2. OUTLETS & RECEPTACLES MINIMUM 15"
 ABOVE INTERIOR FINISH FLOOR LEVEL
 EXCEPT FOR FLOOR OUTLETS. THIS NOTE
 PERTAINS TO LEVEL 01 ONLY.
- CONTRACTOR TO PROVIDE BLOCKING, CENTERED AT 34" ABOVE FINISH FLOOR ALONG ALL WALLS, EXCEPT BEHIND LAVATORIES, IN ALL BATHROOMS.

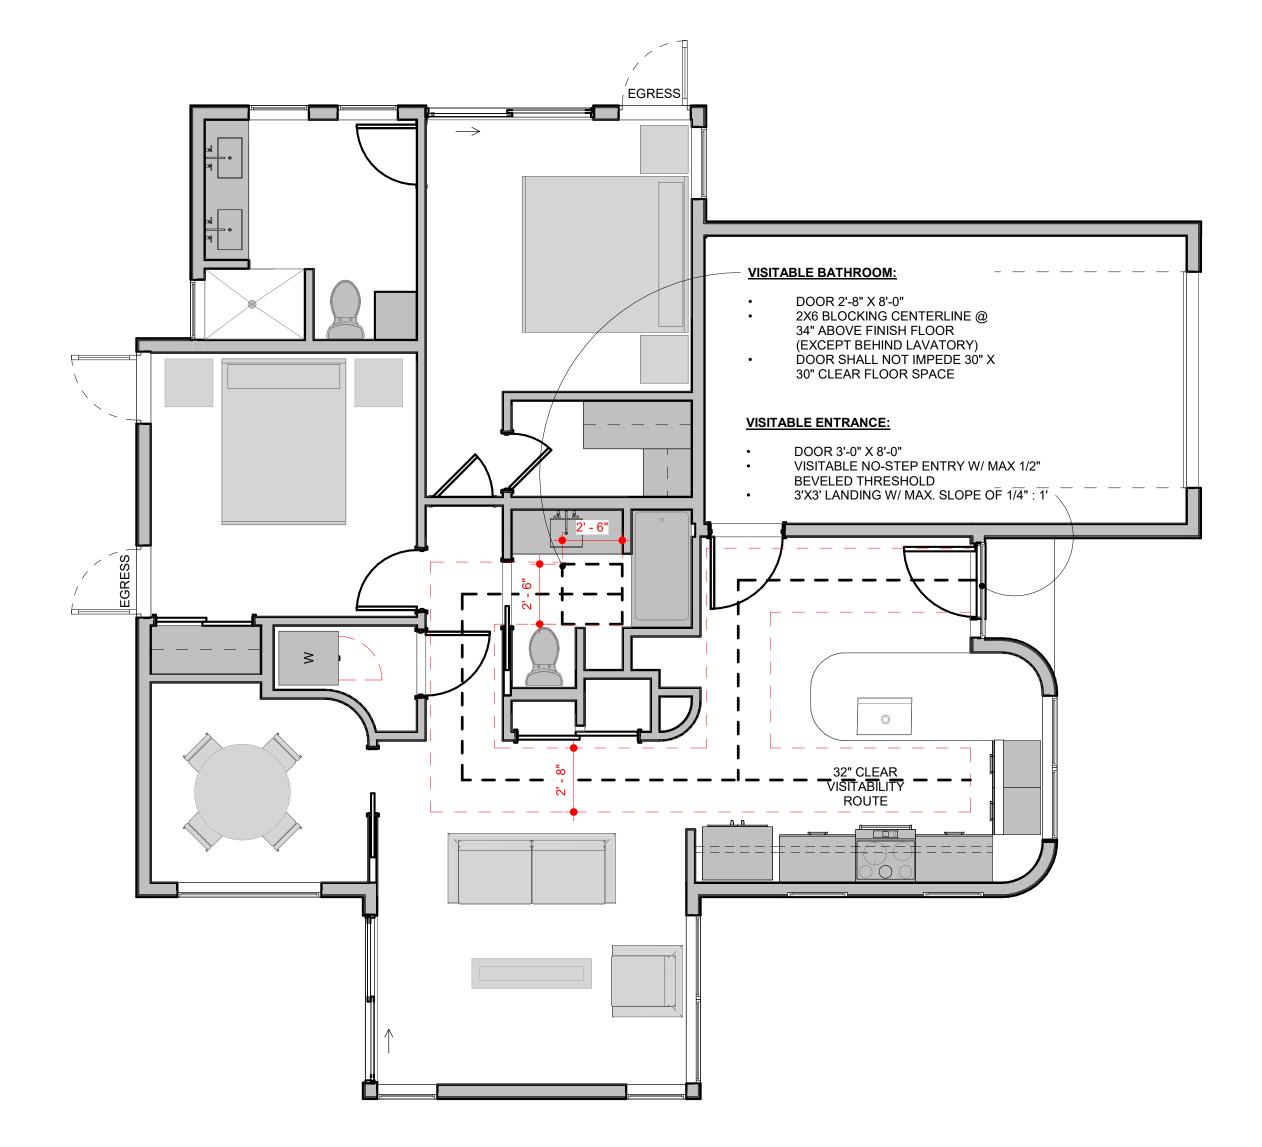

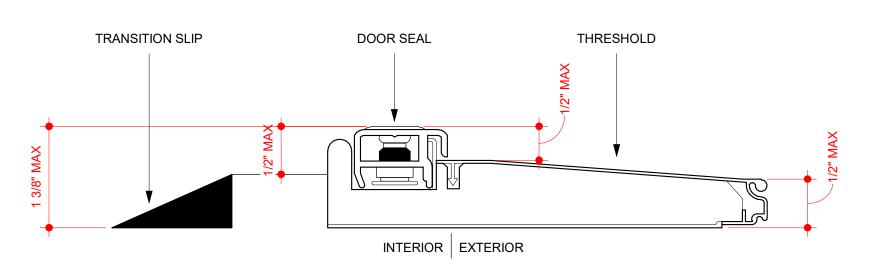

APPROVED THRESHOLD DETAIL

N.T.S.

REFER TO CODE INTERPRETATION C12013-0002 FOR ADDITIONAL INFORMATION


PROJECT TO ADHERE TO ALL REQUIREMENTS IN THE 2021 IRC & ALL ADOPTED LOCAL AMENDMENTS.

««« IF PRINTED AT 11X17, SCALE IS 1/2 OF WHAT IS NOTED »»»



PERMIT


ISSU	E DATE:	JULY 6	STH 2023
PRO	JECT NUMBER:	D	M210901
DRAV	NN BY:		Author
REVI	SIONS:		
NO	REFERENCE		ISSUED

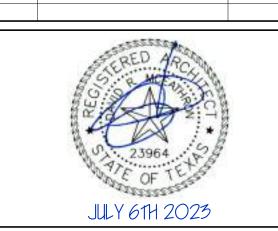


SOUTH SECOND ADU

2009 SOUTH 2ND, AUSTIN, TEXAS 78704

ADU - VISITABILITY EXHIBIT

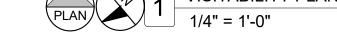

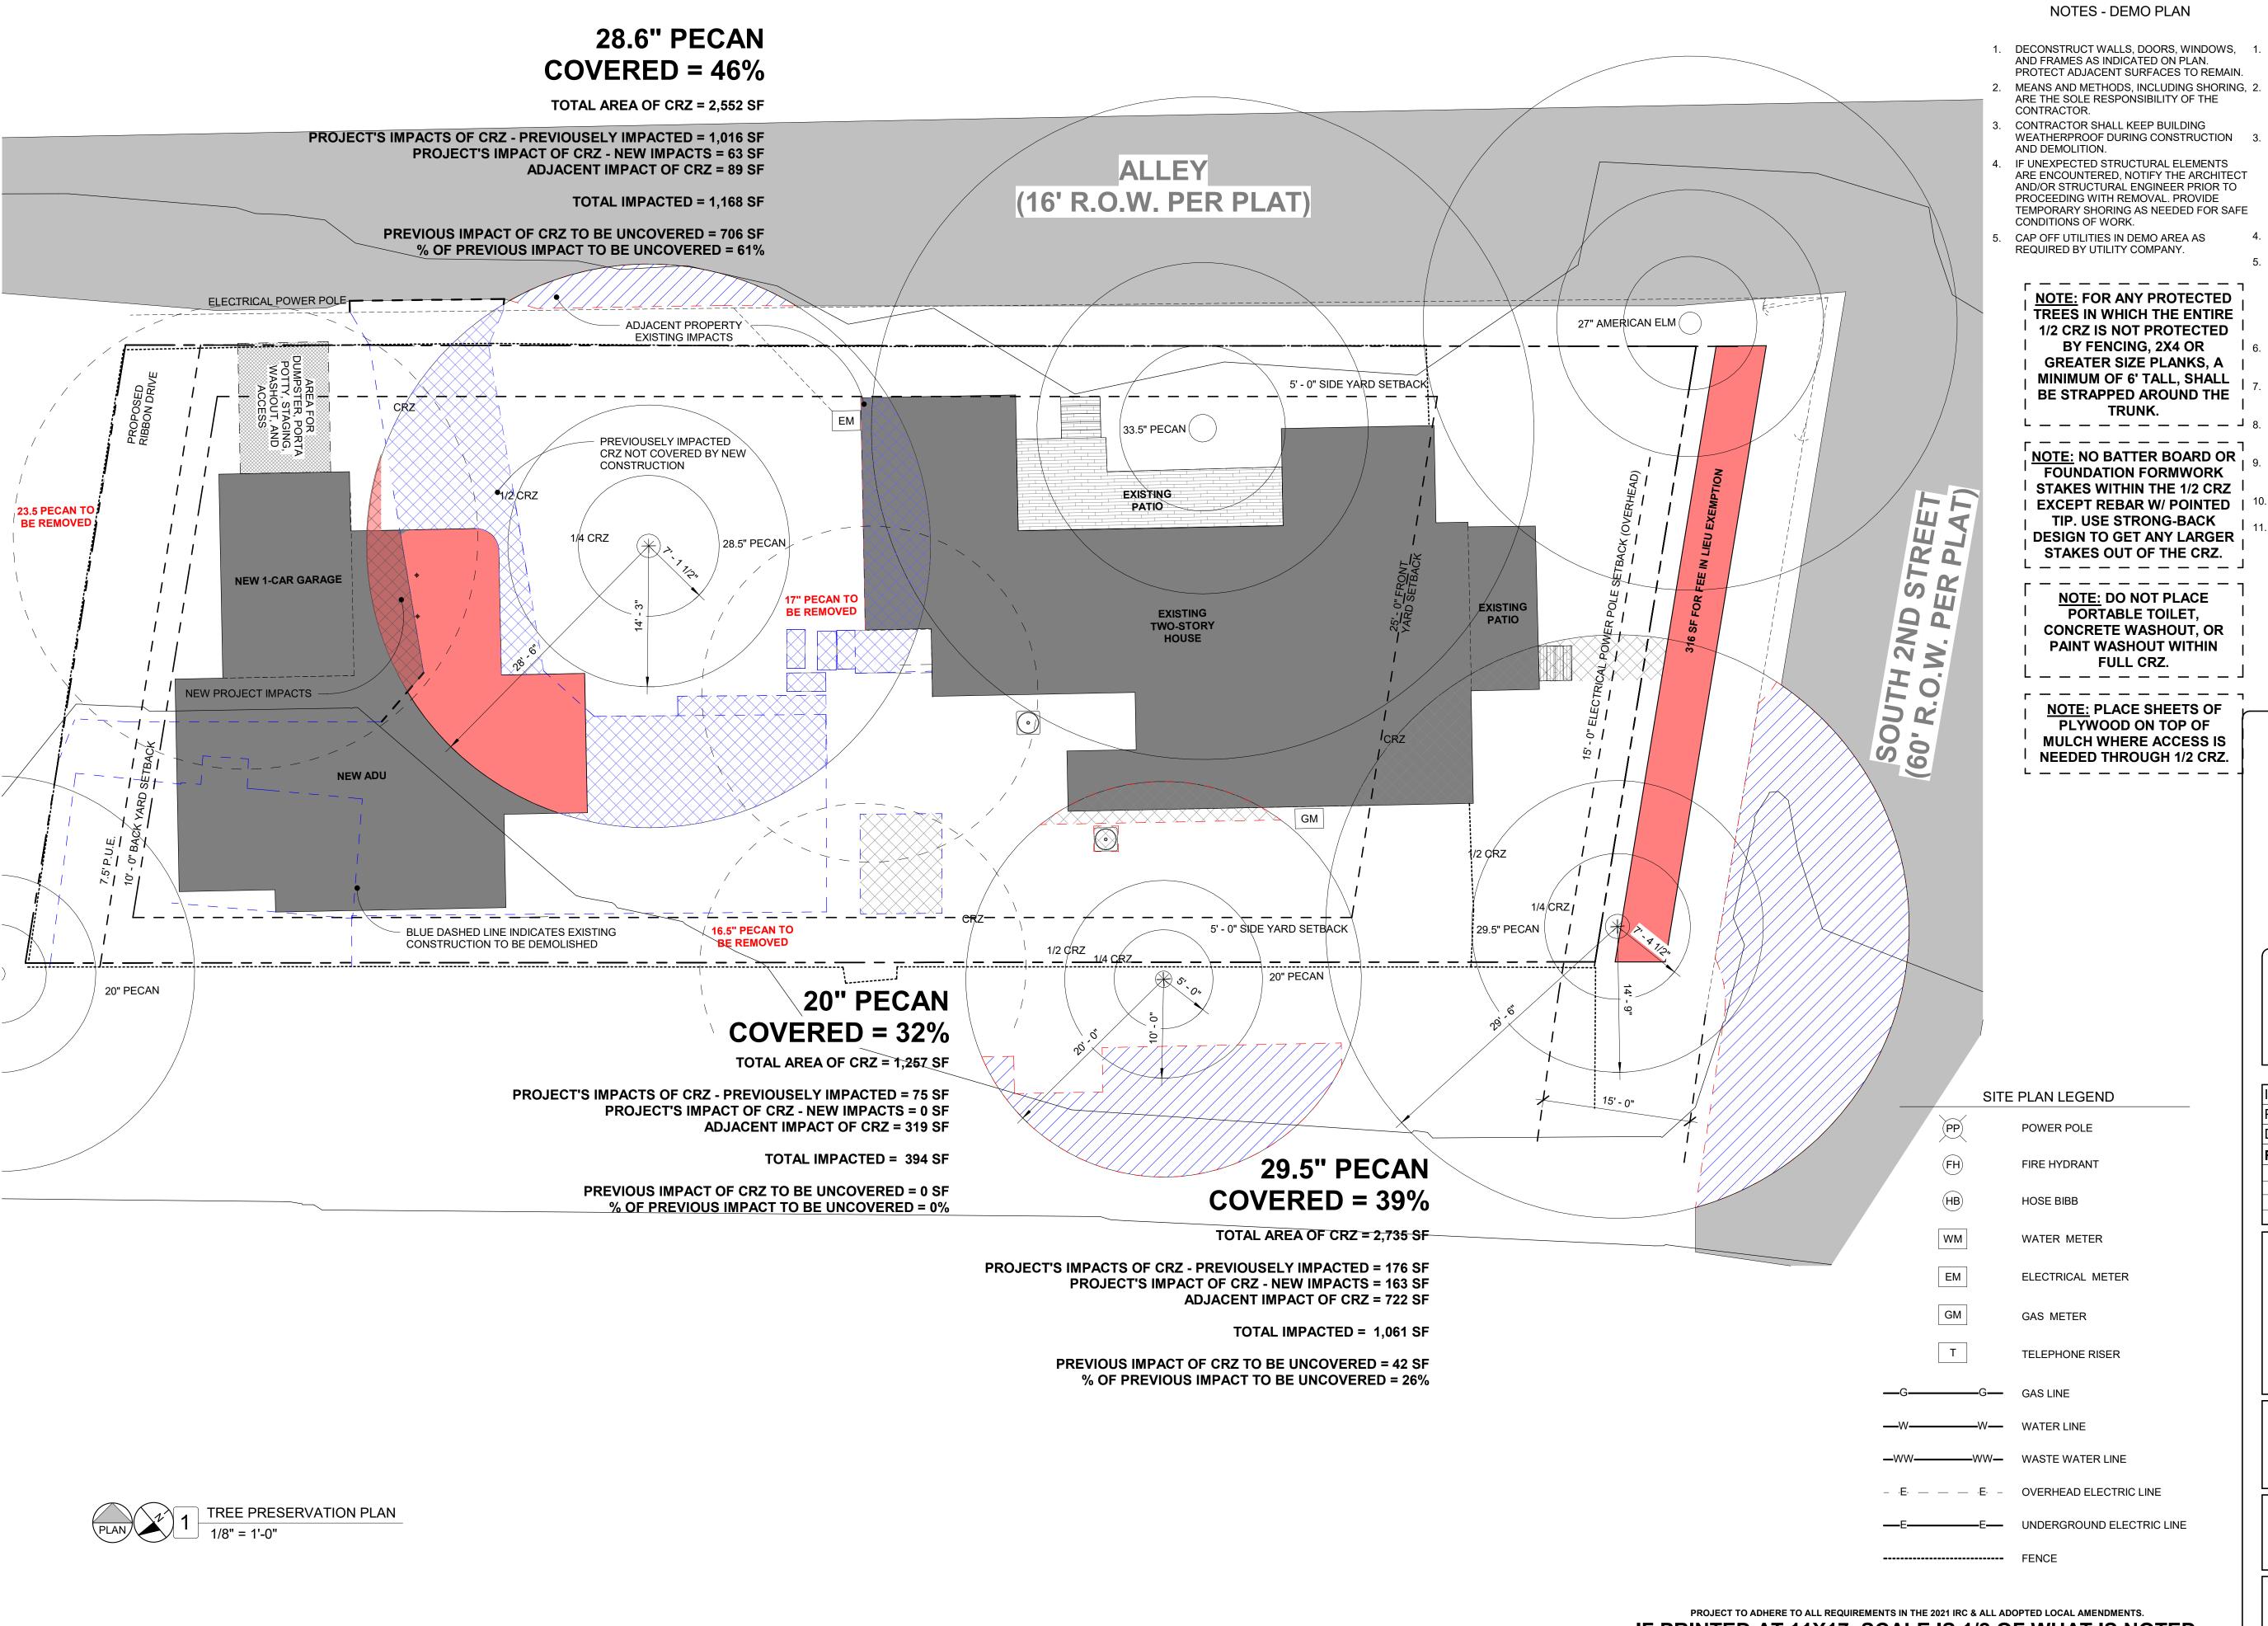

NOTES - TREE PRESERVATION

TREE PROTECTION FENCING IS REQUIRED FOR ALL PROTECTED/HERITAGE TREES WITHIN THE LIMITS OF CONSTRUCTION.

FENCING SHOULD BE INDICATED TO PROTECT THE ENTIRE CRITICAL ROOT ZONE (CRZ) AREA OR AS MUCH OF THE CRZ AS IS

WHEN THE TREE PROTECTION FENCING CANNOT INCORPORATE THE ENTIRE ½ CRITICAL ROOT ZONE, AN EIGHT INCH LAYER OF MULCH WITHIN THE ENTIRE AVAILABLE ROOT ZONE AREA IS REQUIRED FOR ALL TREES WHICH HAVE ANY DISTURBANCE INDICATED WITHIN ANY PORTION OF THE CRITICAL ROOT ZONE.

FENCING IS REQUIRED TO BE CHAIN-LINK MESH AT A MINIMUM OF 5'-0" HIGH.
 2X4 OR GREATER SIZE PLANKS (6'-0" TALL MIN) ARE REQUIRED TO BE STRAPPED SECURELY AROUND PROTECTED TREES TRUNKS & ROOT FLARES WHEN PROTECTIVE FENCING DOES NOT INCORPORATE THE ENTIRE ½ CRZ FOR ANY REASON AT ANY

TIME IN THE PROJECT.

NO CUT OR FILL GREATER THAN 4" ALLOWED WITHIN THE ½ CRZ OF PROTECTED TREES & NO IMPACT IS ALLOWED IN THE ¼ CRZ.

ALL DEMOLITION IN THE ¼ & ½ CRZ OF

PROTECTED TREES MUST BE PERFORMED WITH HAND TOOLS.
PROTECTED TREES ARE NOTED AS 19"

DIAMETER OR GREATER & HERITAGE TREES ARE 24" OR GREATER. 50% MIN. OF THE CRZ MUST BE PRESERVED

AT NATURAL GRADE WITH NATURAL GROUND COVER.
ALL UTILITY LINES & TRENCHING TO STAY

CLEAR OF ½ CRZ OF ALL PROTECTED TREES. CONTRACTOR TO KEEP STAGING, DUMPSTER, & PORTA POTTY CLEAR OF ½ CRZ OF ALL PROTECTED TREES.

DAVEY MCEATHRON
ARCHITECTURE


1402 W NORTH LOOP BLVD, AUSTIN, TX 78756
DAVEY@DAVEYMARCH.COM

PERMIT

512-599-0660

ISSUE DATE: JULY 6TH 2023
PROJECT NUMBER: DM210901
DRAWN BY: Author
REVISIONS:

NO REFERENCE ISSUED

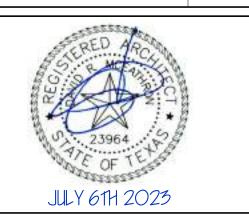


SOUTH SECOND ADU

2009 SOUTH 2ND, AUSTIN, TEXAS 78704

HOUSE & ADU - TREE PROTECTION PLAN


- AREAS DESIGNATED AS SOLAR-READY ARE TO BE FREE & CLEAR OF ANY & ALL ROOF PENETRATIONS OR OBSTRUCTIONS.
- NO SOLAR-READY ZONES ARE TO BE LESS THAN 6' 0" ON A SIDE.

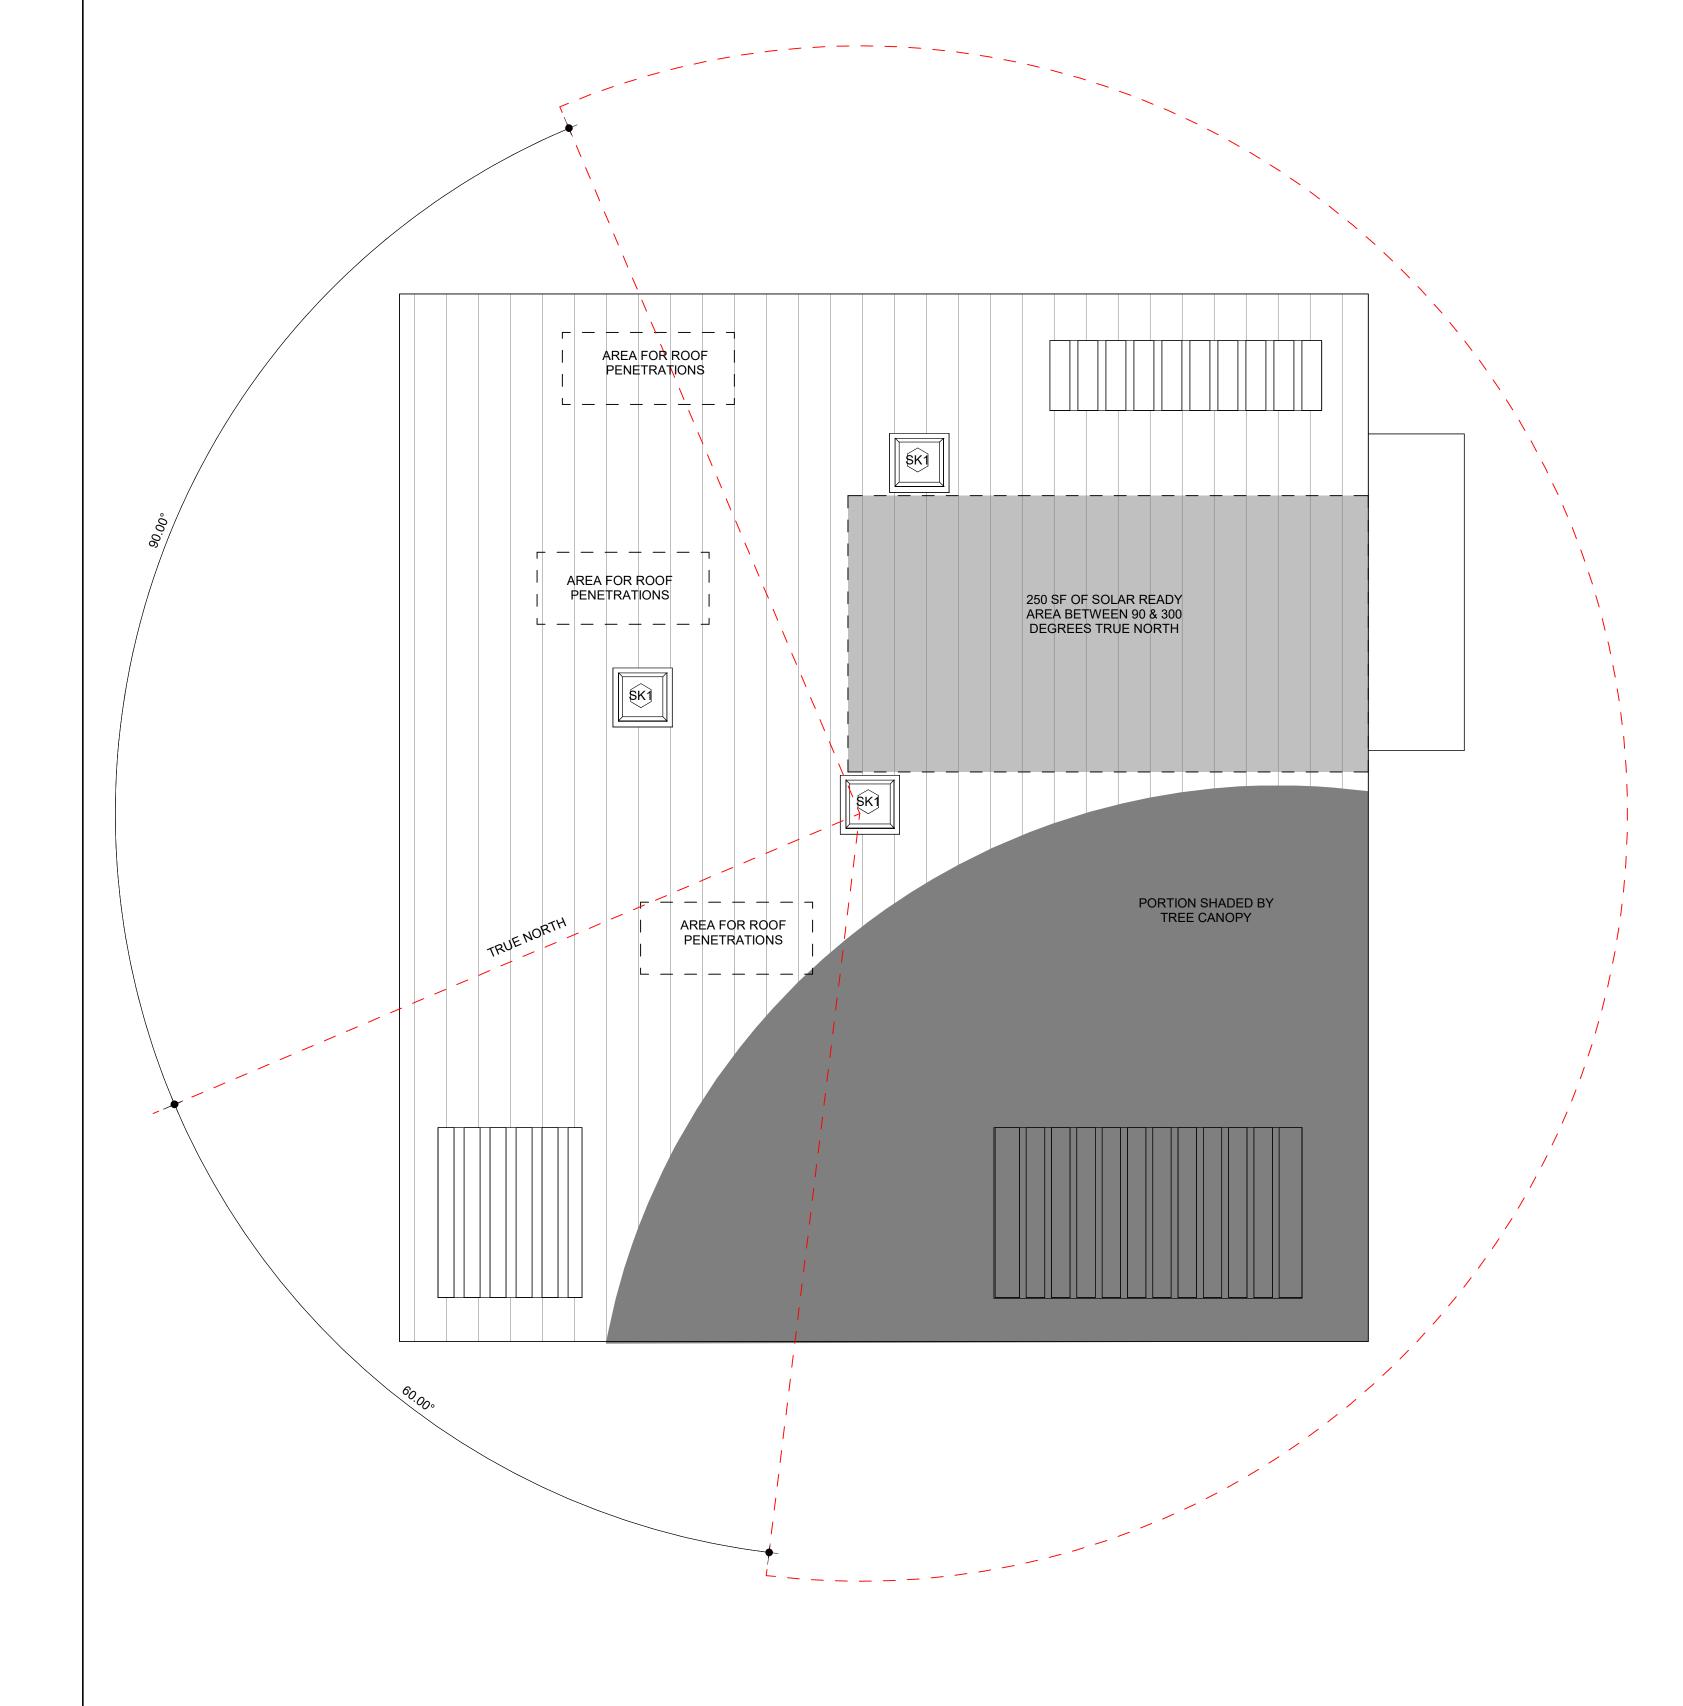



PERMIT

ISSUE DATE: J	JULY 6TH 2023
IOOOL DATE.	
PROJECT NUMBER:	DM210901
DRAWN BY:	Author
REVISIONS:	
NO REFERENCE	ISSUED

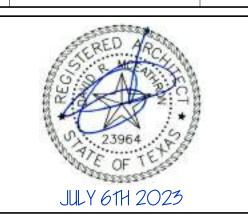

SOUTH SECOND **ADU** 2009 SOUTH 2ND, AUSTIN, TEXAS 78704

ADU - SOLAR READY EXHIBIT



City of Austin / Travis County 911 ADDRESSING VERIFICATION

911 Addressing Website: http://austintexas.gov/911addressing
Email: addressing@austintexas.gov

Date: May 18, 2023

The Following Is A Valid Address: 2009 S 2ND ST

*Please contact the <u>United States Postal Service</u> to verify the correct zip code assigned for this address.

Legal Description: LOT 9-A BLK F BOULDIN ADDN 1900

Geographic ID: 0401021017

Property ID: 302941

Jurisdiction: AUSTIN FULL PURPOSE

Verify your jurisdiction with our new Jurisdictions Web Map

County: TRAVIS

Parent Address Place Id: 241450


This address is a valid 9-1-1 Address, assigned by Address Management Staff

Disclaimer: The assignment and/or verification of this address does not authorize a change in land use or constitute the City of Austin's approval of any division of real property. The assignment and/or verification of this address does not supersede any requirements of the City of Austin's Land Development Code, the Texas Local Government Code, or any other state or municipal regulations.



AUSTIN FIRE DEPARTMENT

FIRE PREVENTION DIVISION

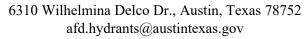



		Hyd	lrant Flo	w Test Re	epo	rt	
TEST DATE	09/30/2022		FIRE BOX	603		COMPANY	PREVENTION
TIME	1245 HRS	M	IAP GRID ID	H20		AFD STAFF	PADILLA, AJ
]	RESIDUA	L HYDRAN	Γ		
-	RESIDUAL HYDRANT	# 167616				MAIN SIZE (in.)	6
BL	K # DIRECTIO	N I		STREET NAME			ТҮРЕ
23	00			OAK CREST	Γ		AVE
CT	ATIC DRESSIDE (DSI)	(0)		DECIDI	TATT	DECCLIDE (DCI)	[c4
517	ATIC PRESSURE (PSI)	69		KESIDO	JAL	PRESSURE (PSI)	64
			FLOW	HYDRANT			
	FLOW HYDRANT	# 166817			Τ	MAIN SIZE (in.)	6
BLI		N		STREET NAME			TYPE
22	00 S						
				3RD			ST
S	TATIC PRESSURE (PS	I) 67			OUAL	PRESSURE (PSI)	Ī
S	TATIC PRESSURE (PS	I) 67			OUAL	PRESSURE (PSI)	Ī
Somments	TATIC PRESSURE (PS	I) 67		RESID dc = di str.	ischarg	PRESSURE (PSI) ge coefficient 2½" butt = 0.9 elbow = 0.75	Ī

NOTE: This information represents the water supply characteristics in the immediate area on the date and time tested. The City of Austin does not guarantee this data will be representative of the water supply characteristics at any time in the future. It is the requesting party's responsibility to ensure that this test information is appropriate to the location of the project in question and that any differences in elevation between the test location and project are accounted for and included in the hydraulic calculations.

2300 BLK OAK CREST AVEBOX 603	REF# 16254379	09/21/2022	
2007 2006 2007 2008 2008 2008 2008 2008 2008 2008 2009 2009 2004 2004 2004 2004 2004	708 706 704 702 40 166368 700 ANNA ST	614	607
906 904 900 3 2011 2006 2008 2005 2005	707 705 703 701 615 613	612 608 60	1924
913 907 905 901 * 6"CI WLIVE OAK ST	2006	609 607 605	2000
809 6 6 712 710	2008	2006	04 2005
717 715 715 713 2203 709 707	2101 614 612 610		2009
2206 2208 2207	608 617 615 613 611 609	06 604 446223 2104 00 23	2101
570510 Box 00-0603 2208	2205	603 601 2201	VLIVE 508
2300 2215 712 710 708 706 2211 2211 2300 2211		210 2205 0	5 07
2310 2309 2304 CO 2305 709 707 705 704 167648 2305	10 608 2214	/// 2209	
902 900 6 7 2313 2310 2308 2300 7703 7703 7703	Si Coll K	2213 2215	77
2400 2 528402 12" 808 806 0 2312 2311 2308 5 2313 2310 2310	167835	} "	
2402 0 815 813 2412 0 PVC WOLTORF ST 12" 2314 0 2312 2311 2418 0 2411 6 GRF ST 12" 2317 704 709	2306	301	784222
2406	2310	Author:	

TAX CERTIFICATE Bruce Elfant Travis County Tax Assessor-Collector P.O. Box 1748 Austin, Texas 78767 (512) 854-9473

ACCOUNT NUMBER: 04-0102-1017-0000

PROPERTY OWNER:

CHRISTIE BRANDON & AND ANNA WAN 2009 S 2ND ST AUSTIN, TX 78704-4170 LOT 9A *RESUB LOT 9 BLK F BOULDIN

DESCRIPTION:

JAMES E ADDN

PROPERTY

ACRES

.2326 MIN%

.00000000000 TYPE

SITUS INFORMATION: 2009 S 2

SI

This is to certify that after a careful check of tax records of this office, the following taxes, delinquent taxes, penalties and interests are due on the described property of the following tax unit(s):

YEAR ENTITY
2022 AUSTIN ISD
CITY OF AUSTIN (TRAV)
TRAVIS COUNTY
TRAVIS CENTRAL HEALTH
ACC (TRAVIS)

TOTAL SEQUENCE 0

ALL PAID
ALL PAID
ALL PAID
ALL PAID

TOTAL

ALL PAID

ALL PAID

TOTAL TAX:
UNPAID FEES:
INTEREST ON FEES:
COMMISSION:
TOTAL DUE ==>

ALL PAID

* NONE *

* NONE *

* NONE *

ALL PAID

TAXES PAID FOR YEAR 2022

\$31,303.90

ALL TAXES PAID IN FULL PRIOR TO AND INCLUDING THE YEAR 2022 EXCEPT FOR UNPAID YEARS LISTED ABOVE. The above described property may be subject to special valuation based on its use, and additional rollback taxes may become due. (Section 23.55, State Property Tax Code). Pursuant to Section 31.08 of the State Property Tax Code, there is a fee of \$10.00 for all Tax Certificates.

GIVEN UNDER MY HAND AND SEAL OF OFFICE ON THIS DATE OF 04/05/2023

Fee Paid: \$10.00

Bruce Elfant Tax Assessor-Collector

By:

Page# 1

WATER SERVICE PERMIT Austin, Texas

Nº 39935

Received of	N. 125, 19 N. N.	Date
Address 2009 South Amount Plumber		TUANU MANAGEMENTAL PROPERTY OF THE PROPERTY OF
Date of Connection //-/6-65 Size of Tap Made Size Service Made Size Main Tapped Size Main Tapped From Front Prop. Line to Curb Cock 8 From Sour Prop. Line to Curb Cock /3 Location of Meter Flour Type of Box Depth of Main in St. 9 Depth of Service Line From Curb Cock to Tap on Main 25 Checked by Engr. Dept.	Size	Service Clamp Valve Weter Box Lock Lid Drain Tile Drain Tile Lid Stop & Drain Job. No. 82/32201 - 70/935 Foreman # Lock Lock

The Hydrant Flow Test Calculator measures the rated capacity at 20 psi of a fire hydrant. The rated capacity calculation is useful in determining the total water supply at a given point in the hydrant or water main. The calculation offers more useful information than the test flow by itself and is used by insurance underwriters. For more information see NFPA 291, AWWA M-17, or our web page on Hydrant Flow Testing.

67	
Residu	ual Pressure (PSI):
51	
Total T	est Flow Rate (GPM):

GPM at 20 psi: 1785

Class: AA

Marking color: Light Blue

% Pressure Drop: 24%