
TOPOGRAPHIC AND TREE SURVEY

BUYER: TRANSOM PROPERTIES LLC

LEGAL DESCRIPTION: LOT 59, OKIE HEIGHTS, A SUBDIVISION IN TRAVIS COUNTY, TEXAS, ACCORDING TO THE MAP OR PLAT THEREOF, RECORDED IN VOLUME 3, PAGE 255, PLAT RECORDS, TRAVIS COUNTY, TEXAS, ALSO LOCALLY KNOWN AS 1406 JULIET STREET, AUSTIN, TEXAS.

BLUFF VIEW (4/257)


LOT 1, BLOCK "B"

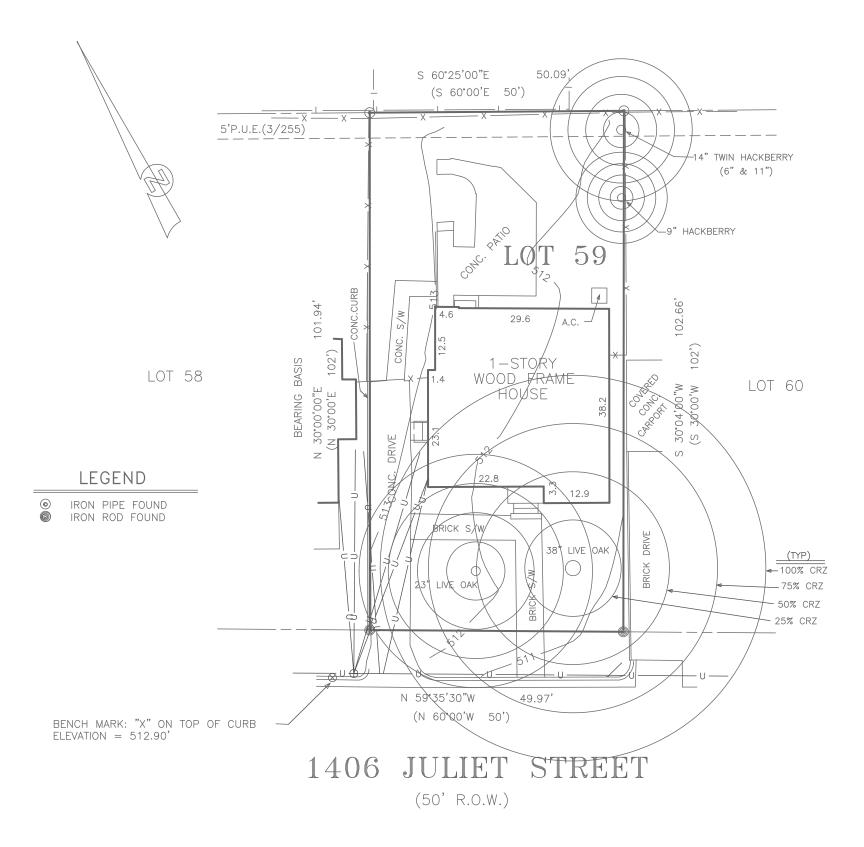

LOT AREA = 5,118 SQ.FT.



G.F.	2331383-ROL
DATE	September 4, 2023
SCALE	1" = 20'
FB/PG	342/04
	000707 T0
J.O.#	090323 TS

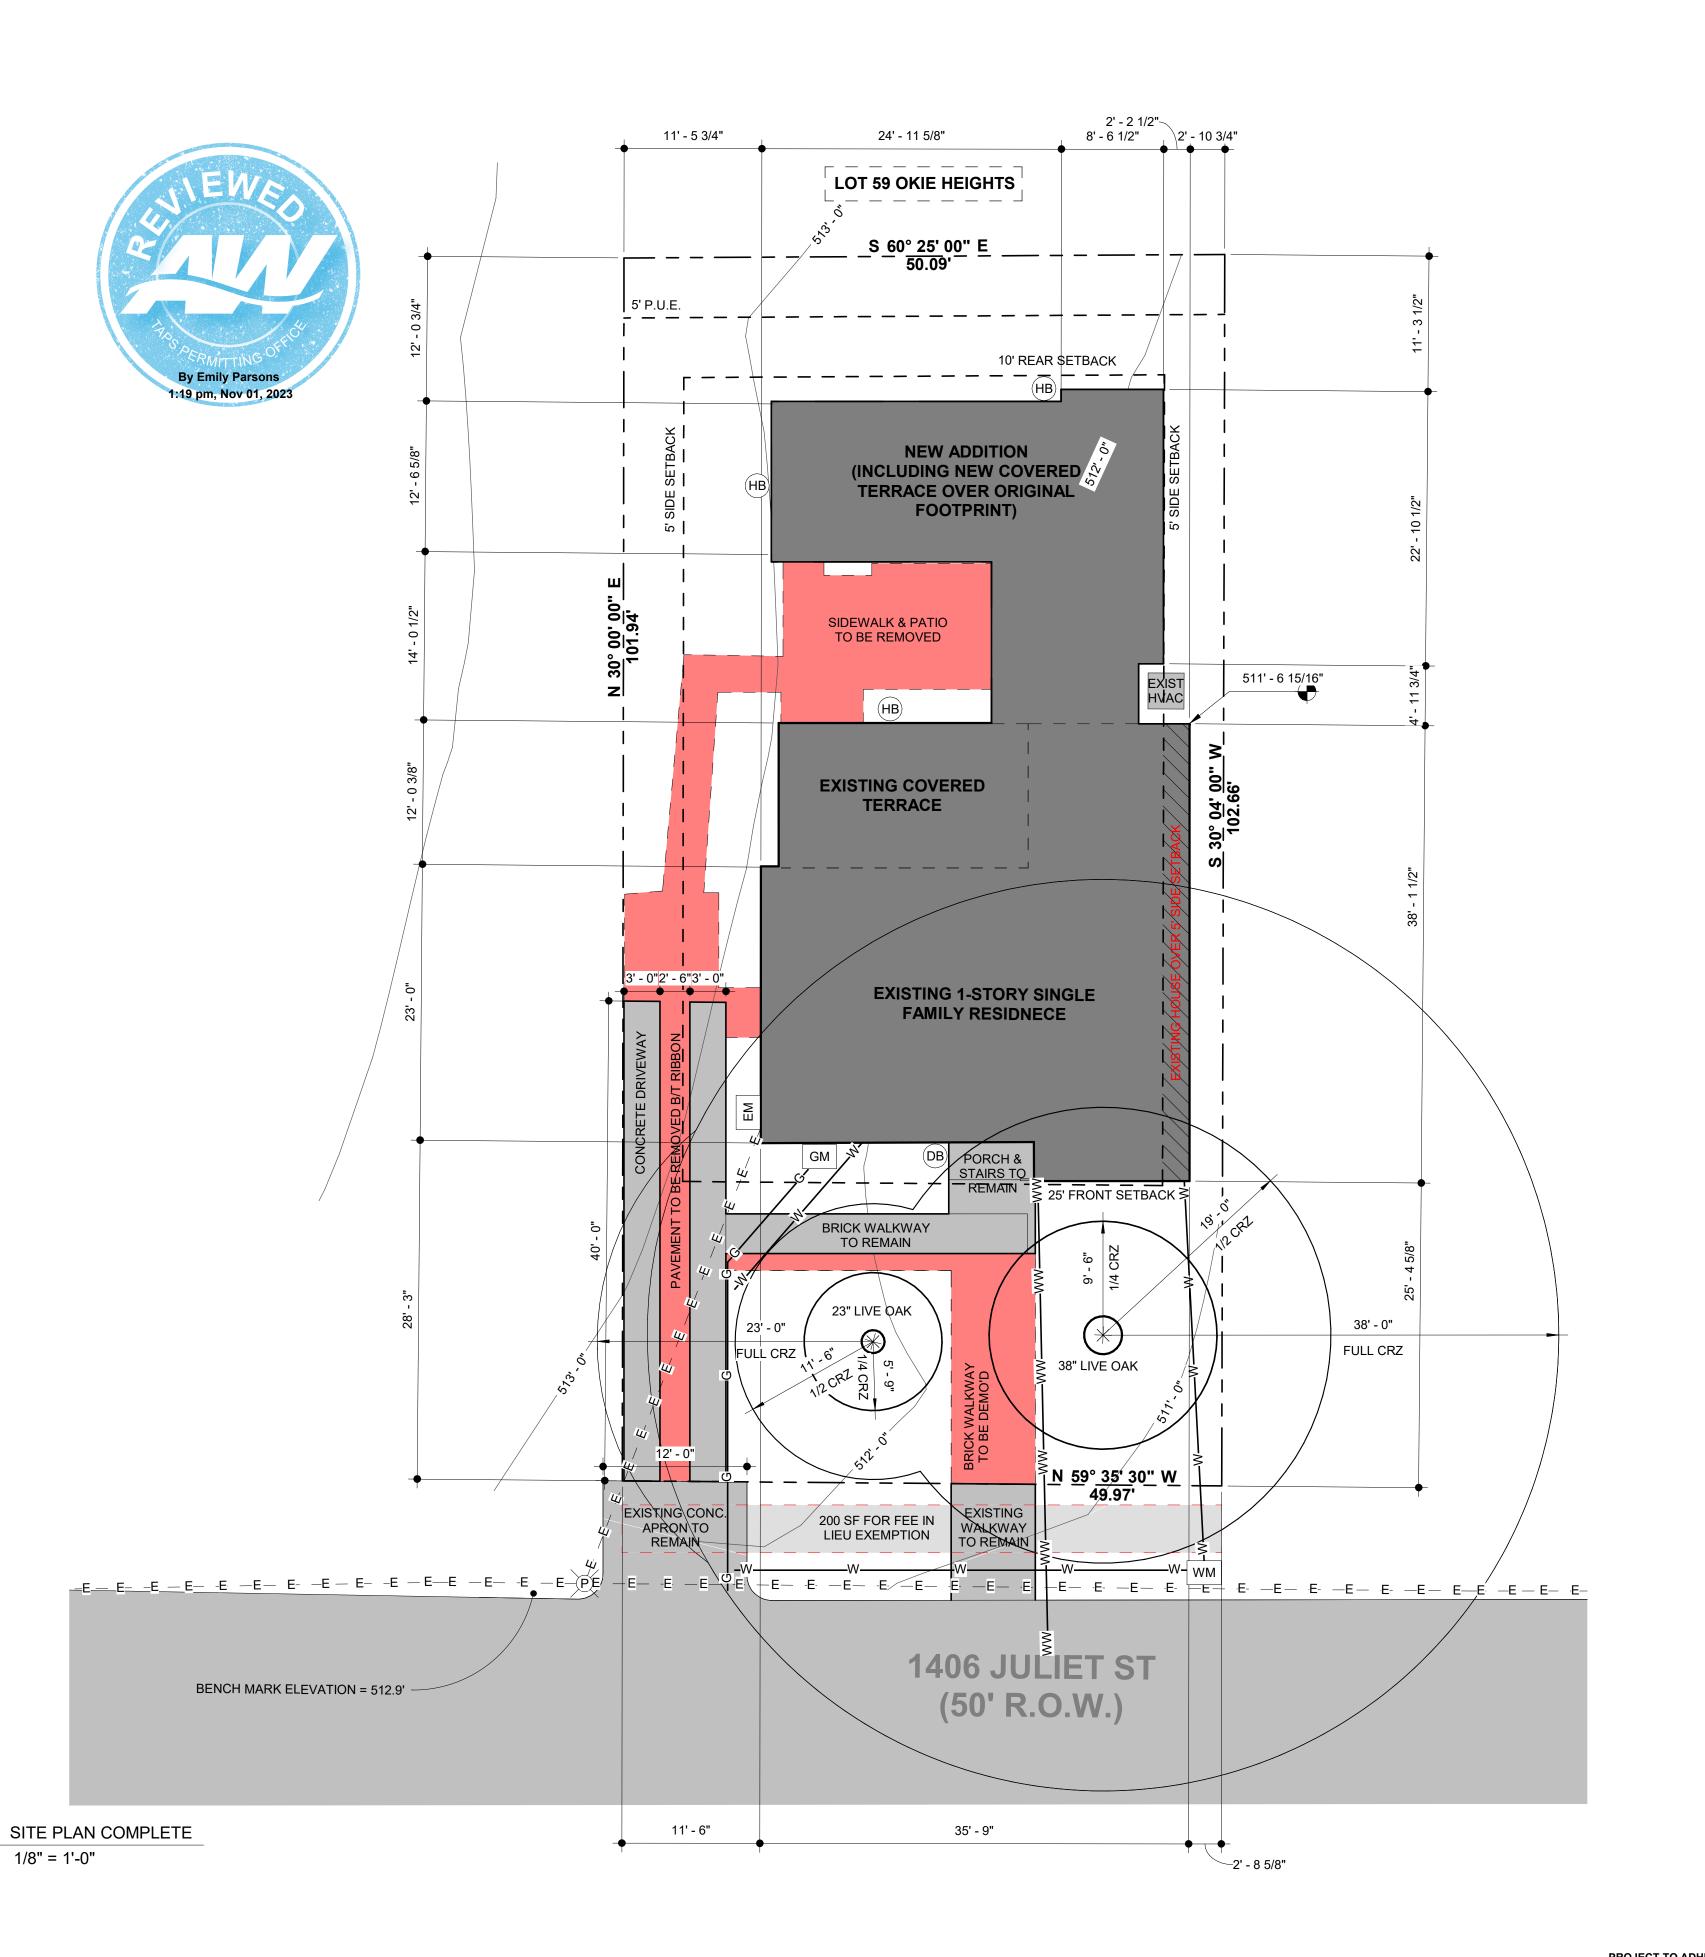

NOTES - DEMO PLAN

- DECONSTRUCT WALLS, DOORS, WINDOWS, AND FRAMES AS INDICATED ON PLAN.
- PROTECT ADJACENT SURFACES TO REMAIN.

 2. MEANS AND METHODS, INCLUDING SHORING, ARE THE SOLE RESPONSIBILITY OF THE CONTRACTOR.
- 3. CONTRACTOR SHALL KEEP BUILDING WEATHERPROOF DURING CONSTRUCTION AND DEMOLITION.
- 4. IF UNEXPECTED STRUCTURAL ELEMENTS
 ARE ENCOUNTERED, NOTIFY THE ARCHITECT
 AND/OR STRUCTURAL ENGINEER PRIOR TO
 PROCEEDING WITH REMOVAL. PROVIDE
 TEMPORARY SHORING AS NEEDED FOR SAFE
 CONDITIONS OF WORK.
- 5. CAP OFF UTILITIES IN DEMO AREA AS REQUIRED BY UTILITY COMPANY.

NOTE: CONTOUR
ELEVATIONS AND
BENCHMARKS TAKEN FROM
ORIGINAL SURVEY. ALL
ELEVATIONS TO BE VERIFIED
IN FIELD BY
CONTRACTOR/SURVEYOR.

SITE PLAN LEGEND

POWER POLE

FIRE HYDRANT

WATER METER

GAS METER

—G— GAS LINE

__ _ _ ★ _ 6'-0" TALL FENCE

-W--- WATER LINE

WW— WASTE WATER LINE

-E- - OVERHEAD ELECTRIC LINE

E— UNDERGROUND ELECTRIC LINE

(UNLESS NOTED OTHERWISE)

ELECTRICAL METER

TELEPHONE RISER

HOSE BIBB

WM

EM

GM

NOTES - SITE PLAN

- DO NOT SCALE DRAWINGS. WRITTEN DIMENSIONS GOVERN.
- VERIFY EXISTING SITE CONDITIONS &
 REPORT TO ARCHITECT ANY DISCREPANCIES
 BETWEEN ACTUAL FIELD CONDITIONS &
 THESE PLANS PRIOR TO COMMENCING
 WORK.
- 3. ALL NEW SIDEWALKS TO HAVE MAX 1:20 GRADE WITH CROSS SLOPE TO DRAIN AT 1/4" PER FOOT. SEAL CONCRETE & PROVIDE A BROOM FINISH UNLESS OTHERWISE NOTED.
- 4. CONTRACTOR TO TIE INTO EXISTING
 UTILITIES. SOME UTILITIES MAY REQUIRE
 UPGRADING, CONTRACTOR TO VERIFY.
 VERIFY METER & UTILITY SERVICE
 LOCATIONS PRIOR TO INSTALL ATION
- LOCATIONS PRIOR TO INSTALLATION.
 CONTRACTOR TO UTILIZE TEMPORARY EROSION & SEDIMENTATION CONTROL
- MEASURES AS REQUIRED BY CODE.

 6. PROVIDE TREE PROTECTION FOR ALL TREES NOT MARKED FOR REMOVAL.
- 7. TREES TO BE REMOVED SHALL BE REMOVED FROM THE SOIL TO A DEPTH OF 12" BELOW THE SURFACE OF THE GROUND IN THE AREA OF THE BUILDING.
- 8. SELECTIVELY CLEAR OR PRUNE ANY UNWANTED TREES OR THOSE IMPEDING CONSTRUCTION WITH CONSENT OF OWNER. COORDINATE REMOVAL & DISPOSAL OF UNWANTED TREES & OTHER LANDSCAPING MATERIALS WITH OWNER.
- 9. EXISTING UTILITY LINE LOCATIONS ARE APPROXIMATED. CONTRACTOR TO VERIFY LOCATIONS PRIOR TO CONSTRUCTION.
- LOCATIONS PRIOR TO CONSTRUCTION.


 10. ENSURE ALL GRADING SLOPES AWAY FROM BUILDING FOR AT LEAST 10'-0".
- 11. CONTRACTOR TO STORE ALL NEW MATERIALS IN DRY & SECURE LOCATION ON SITE AS SPECIFIED BY OWNER.
- 12. EXTERIOR HVAC EQUIPMENT SHALL BE SCREENED IN COMPLIANCE WITH ANY CITY OF AUSTIN REGULATIONS &/OR LOCAL DEED RESTRICTIONS.
- 13. PROVIDE CONTROL & EXPANSION JOINTS AS REQUIRED ON CONCRETE DRIVES, WALKS & PATIOS.
- 14. PROVIDE NEW GUTTERS & DOWNSPOUTS TO DRAIN ON SITE. DOWNSPOUTS TO DRAIN AWAY FROM BUILDING. CONFIRM DOWNSPOUT LOCATIONS WITH ARCHITECT PRIOR TO INSTALLATION.



512-599-0660

PERMIT

ISSUE D	ATE:	03 N	NOV 2023
PROJEC	T NUMBER:	D	M230902
DRAWN	BY:	ADI	DISON C
REVISIO	NS:		
NO	REFERENCE		ISSUED

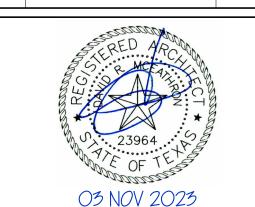

JULIET RESIDENCE

1406 JULIET ST, AUSTIN, TX 78704

SITE PLAN

JULIET REMODEL/ADD'N

1406 JULIET ST, AUSTIN, TX 78704
PERMIT
06 NOV 2023



PROJECT NO:

DM230902

SHEET INDEX:

A100 SITE PLAN

A109 FLOOR 01 DEMO PLAN A110 FLOOR 01 REFERENCE PLAN

A112 FLOOR 01 RCP

A130 ROOF PLAN

A200 EXTERIOR ELEVATIONS A600 SCHEDULES

A703 TREE PROTECTION PLAN



PROJECT TEAM:

ARCHITECT

DAVEY MCEATHRON ARCHITECTURE 1402 W N LOOP BLVD AUSTIN, TEXAS 78756 TEL. (512) 599-0660

STRUCTURAL

SEC SOLUTIONS, LLC 407 FOREST ST. LIBERTY HILL, TX, 78642 TEL. (512) 215-4364

SURVEY


MR. MINN LAND SURVEYING COMPANY 4008 GREENMOUNTAIN LANE AUSTIN, TX, 78759 TEL. (512) 343-1970





REVISIONS

NO REFERENCE ISSUED

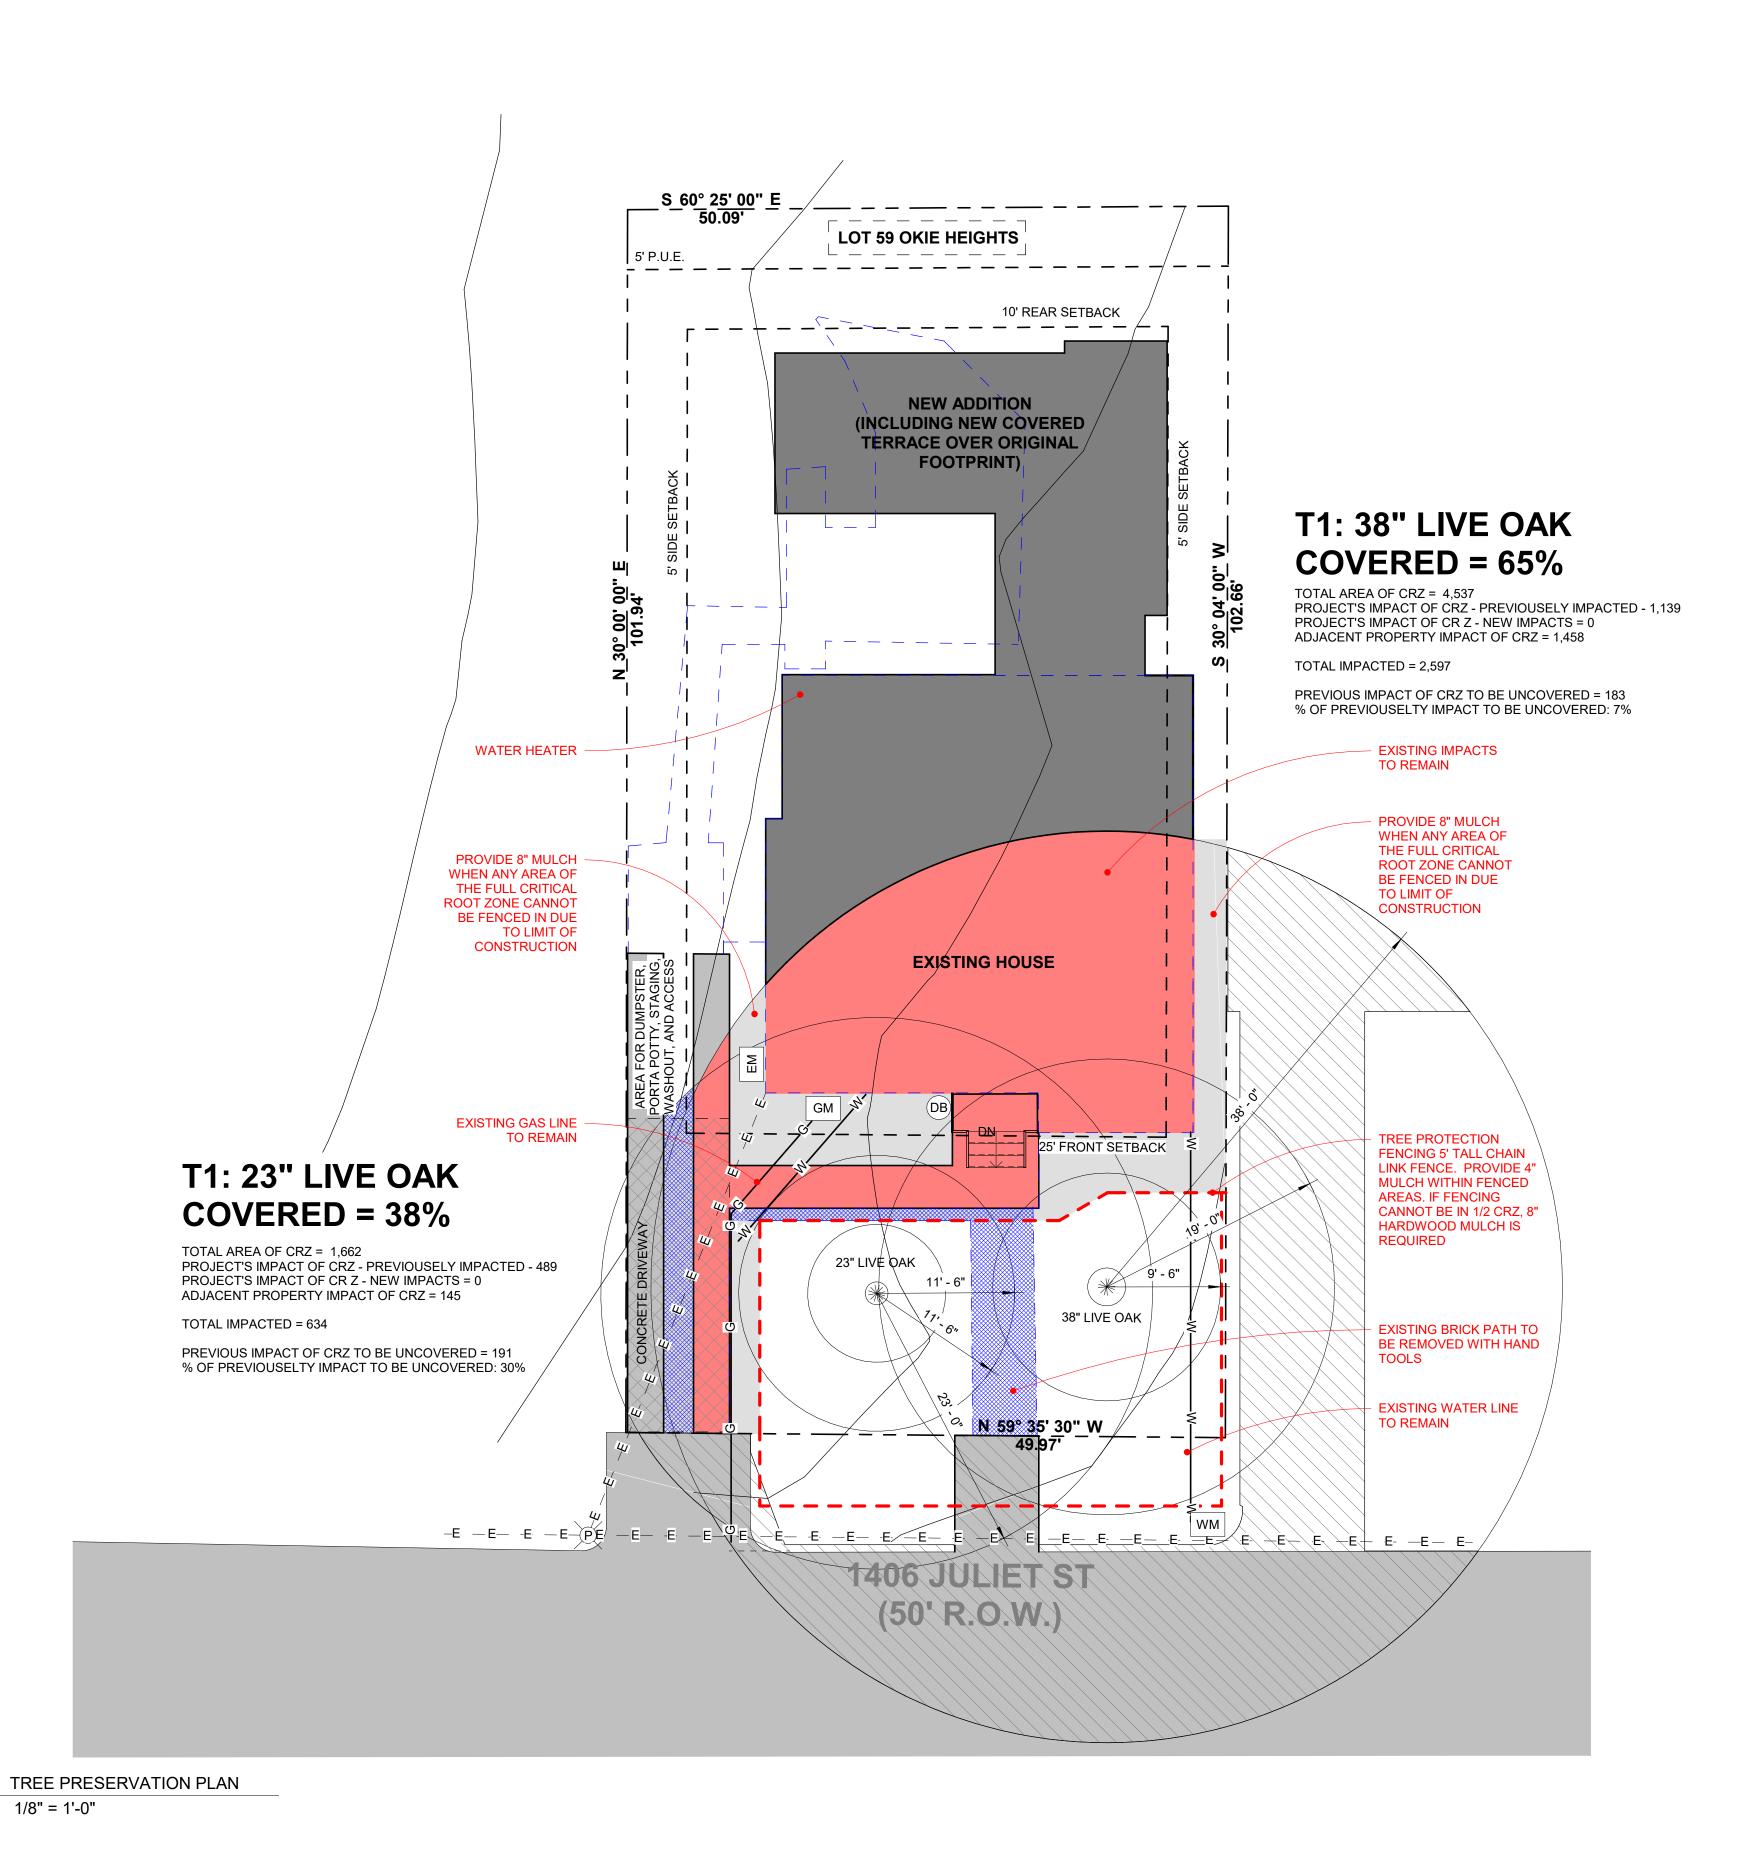

NOTES - DEMO PLAN

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- PROTECT ADJACENT SURFACES TO REMAIN.

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- 4. IF UNEXPECTED STRUCTURAL ELEMENTS ARE ENCOUNTERED, NOTIFY THE ARCHITECT AND/OR STRUCTURAL ENGINEER PRIOR TO PROCEEDING WITH REMOVAL. PROVIDE TEMPORARY SHORING AS NEEDED FOR SAFE CONDITIONS OF WORK.
- 5. CAP OFF UTILITIES IN DEMO AREA AS REQUIRED BY UTILITY COMPANY.

NOTE: FOR ANY PROTECTED
TREES IN WHICH THE ENTIRE
1/2 CRZ IS NOT PROTECTED
BY FENCING, 2X4 OR
GREATER SIZE PLANKS, A
MINIMUM OF 6' TALL, SHALL
BE STRAPPED AROUND THE
TRUNK.

NOTE: NO BATTER BOARD OR FOUNDATION FORMWORK STAKES WITHIN THE 1/2 CRZ EXCEPT REBAR W/ POINTED TIP. USE STRONG-BACK

DESIGN TO GET ANY LARGER
STAKES OUT OF THE CRZ.

NOTE: DO NOT PLACE
PORTABLE TOILET,
CONCRETE WASHOUT, OR
PAINT WASHOUT WITHIN
FULL CRZ.

NOTE: PLACE SHEETS OF
PLYWOOD ON TOP OF
MULCH WHERE ACCESS IS
NEEDED THROUGH 1/2 CRZ.

SITE PLAN LEGEND

POWER POLE FIRE HYDRANT HOSE BIBB WM WATER METER EM ELECTRICAL METER GM GAS METER TELEPHONE RISER —G— GAS LINE −W−− WATER LINE -WW- WASTE WATER LINE ·E· — — ·E· – OVERHEAD ELECTRIC LINE —E— UNDERGROUND ELECTRIC LINE 6'-0" TALL FENCE (UNLESS NOTED OTHERWISE)

TO BE DEMO'D

NOTES - TREE PRESERVATION

- TREE PROTECTION FENCING IS REQUIRED FOR ALL PROTECTED/HERITAGE TREES
- WITHIN THE LIMITS OF CONSTRUCTION.

 2. FENCING SHOULD BE INDICATED TO PROTECT THE ENTIRE CRITICAL ROOT ZONE (CRZ) AREA OR AS MUCH OF THE CRZ AS IS PRACTICAL.
- 3. WHEN THE TREE PROTECTION FENCING CANNOT INCORPORATE THE ENTIRE ½ CRITICAL ROOT ZONE, AN EIGHT INCH LAYER OF MULCH WITHIN THE ENTIRE AVAILABLE ROOT ZONE AREA IS REQUIRED FOR ALL TREES WHICH HAVE ANY DISTURBANCE INDICATED WITHIN ANY PORTION OF THE CRITICAL ROOT ZONE.
- 4. FENCING IS REQUIRED TO BE CHAIN-LINK MESH AT A MINIMUM OF 5'-0" HIGH.
- 5. 2X4 OR GREATER SIZE PLANKS (6'-0" TALL MIN) ARE REQUIRED TO BE STRAPPED SECURELY AROUND PROTECTED TREES TRUNKS & ROOT FLARES WHEN PROTECTIVE FENCING DOES NOT INCORPORATE THE ENTIRE ½ CRZ FOR ANY REASON AT ANY

TIME IN THE PROJECT.


- 6. NO CUT OR FILL GREATER THAN 4" ALLOWED WITHIN THE ½ CRZ OF PROTECTED TREES & NO IMPACT IS ALLOWED IN THE ¼ CRZ.
- 7. ALL DEMOLITION IN THE ¼ & ½ CRZ OF PROTECTED TREES MUST BE PERFORMED
- WITH HAND TOOLS.
 PROTECTED TREES ARE NOTED AS 19"
 DIAMETER OR GREATER & HERITAGE TREES
 ARE 24" OR GREATER.
- 9. 50% MIN. OF THE CRZ MUST BE PRESERVED AT NATURAL GRADE WITH NATURAL GROUND COVER.
- 10. ALL UTILITY LINES & TRENCHING TO STAY CLEAR OF ½ CRZ OF ALL PROTECTED TREES.
- 11. CONTRACTOR TO KEEP STAGING, DUMPSTER, & PORTA POTTY CLEAR OF ½ CRZ OF ALL PROTECTED TREES.



PERMIT

512-599-0660

ISSUE DATE: 06 NOV 2023
PROJECT NUMBER: DM230902
DRAWN BY: Author
REVISIONS:
NO REFERENCE ISSUED

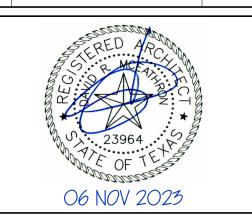

JULIET REMODEL/ADD'N 1406 JULIET ST, AUSTIN, TX

78704

TREE PROTECTION

PLAN

NOTES - DEMO PLAN

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IN FIELD BY
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SITE PLAN LEGEND

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FIRE HYDRANT

WATER METER

GAS METER

—G— GAS LINE

★ - - - ★ - 6'-0" TALL FENCE

-W--- WATER LINE

-WW— WASTE WATER LINE

-E- - OVERHEAD ELECTRIC LINE

E— UNDERGROUND ELECTRIC LINE

(UNLESS NOTED OTHERWISE)

ELECTRICAL METER

TELEPHONE RISER

HOSE BIBB

WM

EM

GM

NOTES - SITE PLAN

- 1. DO NOT SCALE DRAWINGS. WRITTEN
- DIMENSIONS GOVERN.

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- 3. ALL NEW SIDEWALKS TO HAVE MAX 1:20
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12. EXTERIOR HVAC EQUIPMENT SHALL BE

OF AUSTIN REGULATIONS &/OR LOCAL DEED RESTRICTIONS.

13. PROVIDE CONTROL & EXPANSION JOINTS AS REQUIRED ON CONCRETE DRIVES, WALKS &

SCREENED IN COMPLIANCE WITH ANY CITY

- PATIOS.


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- DRAIN ON SITE. DOWNSPOUTS TO DRAIN AWAY FROM BUILDING. CONFIRM DOWNSPOUT LOCATIONS WITH ARCHITECT PRIOR TO INSTALLATION.



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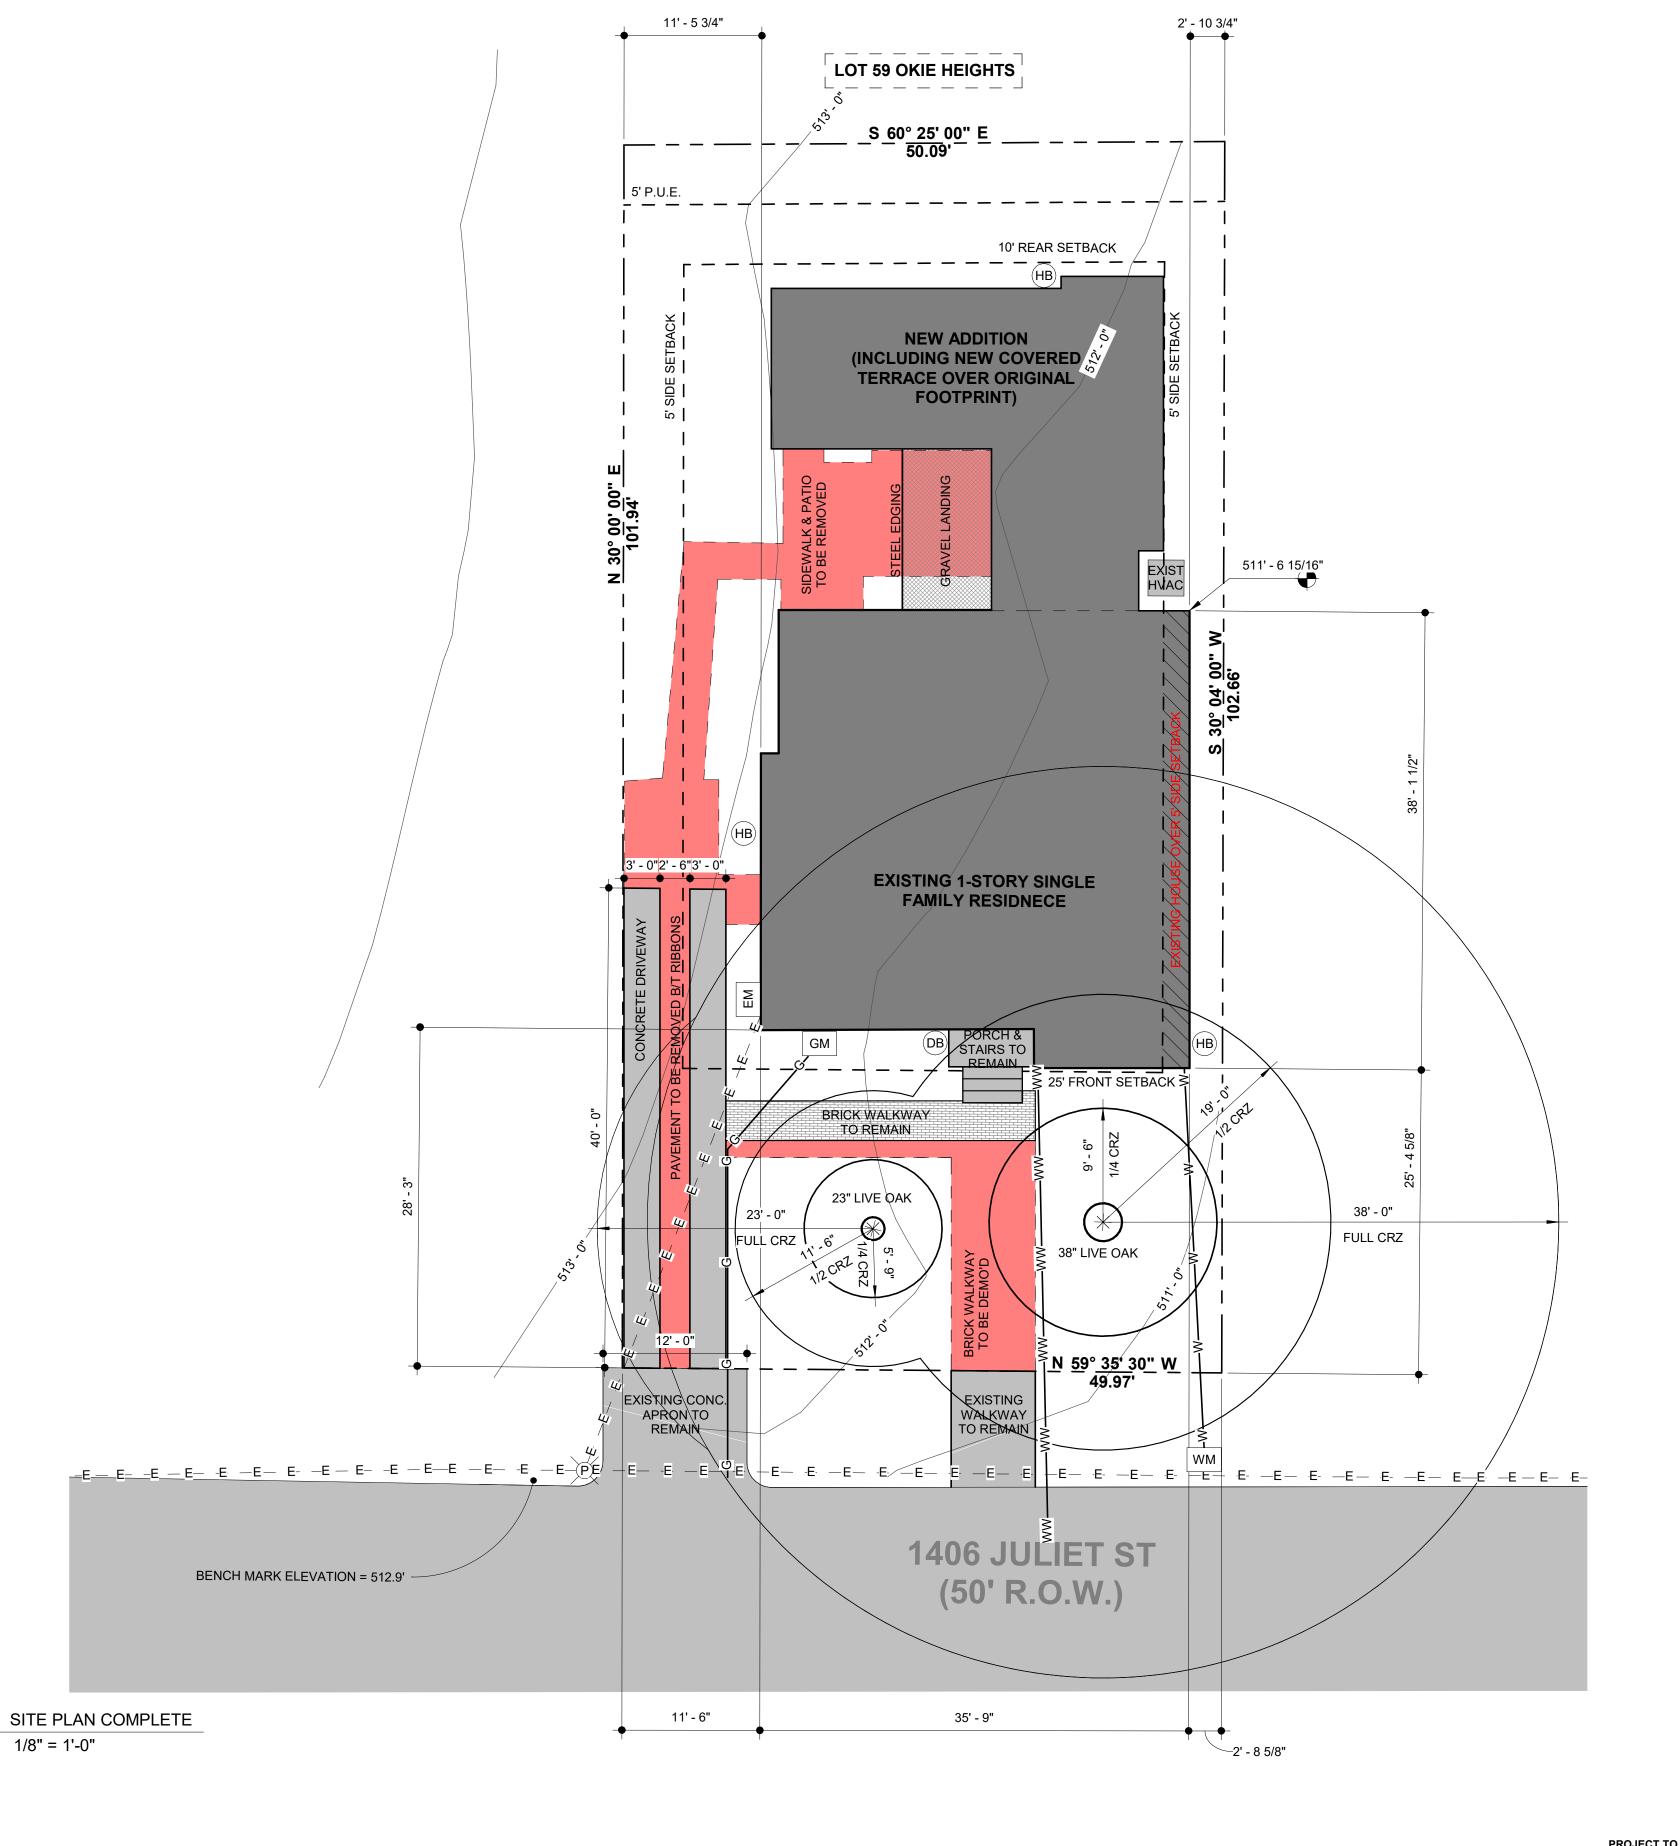
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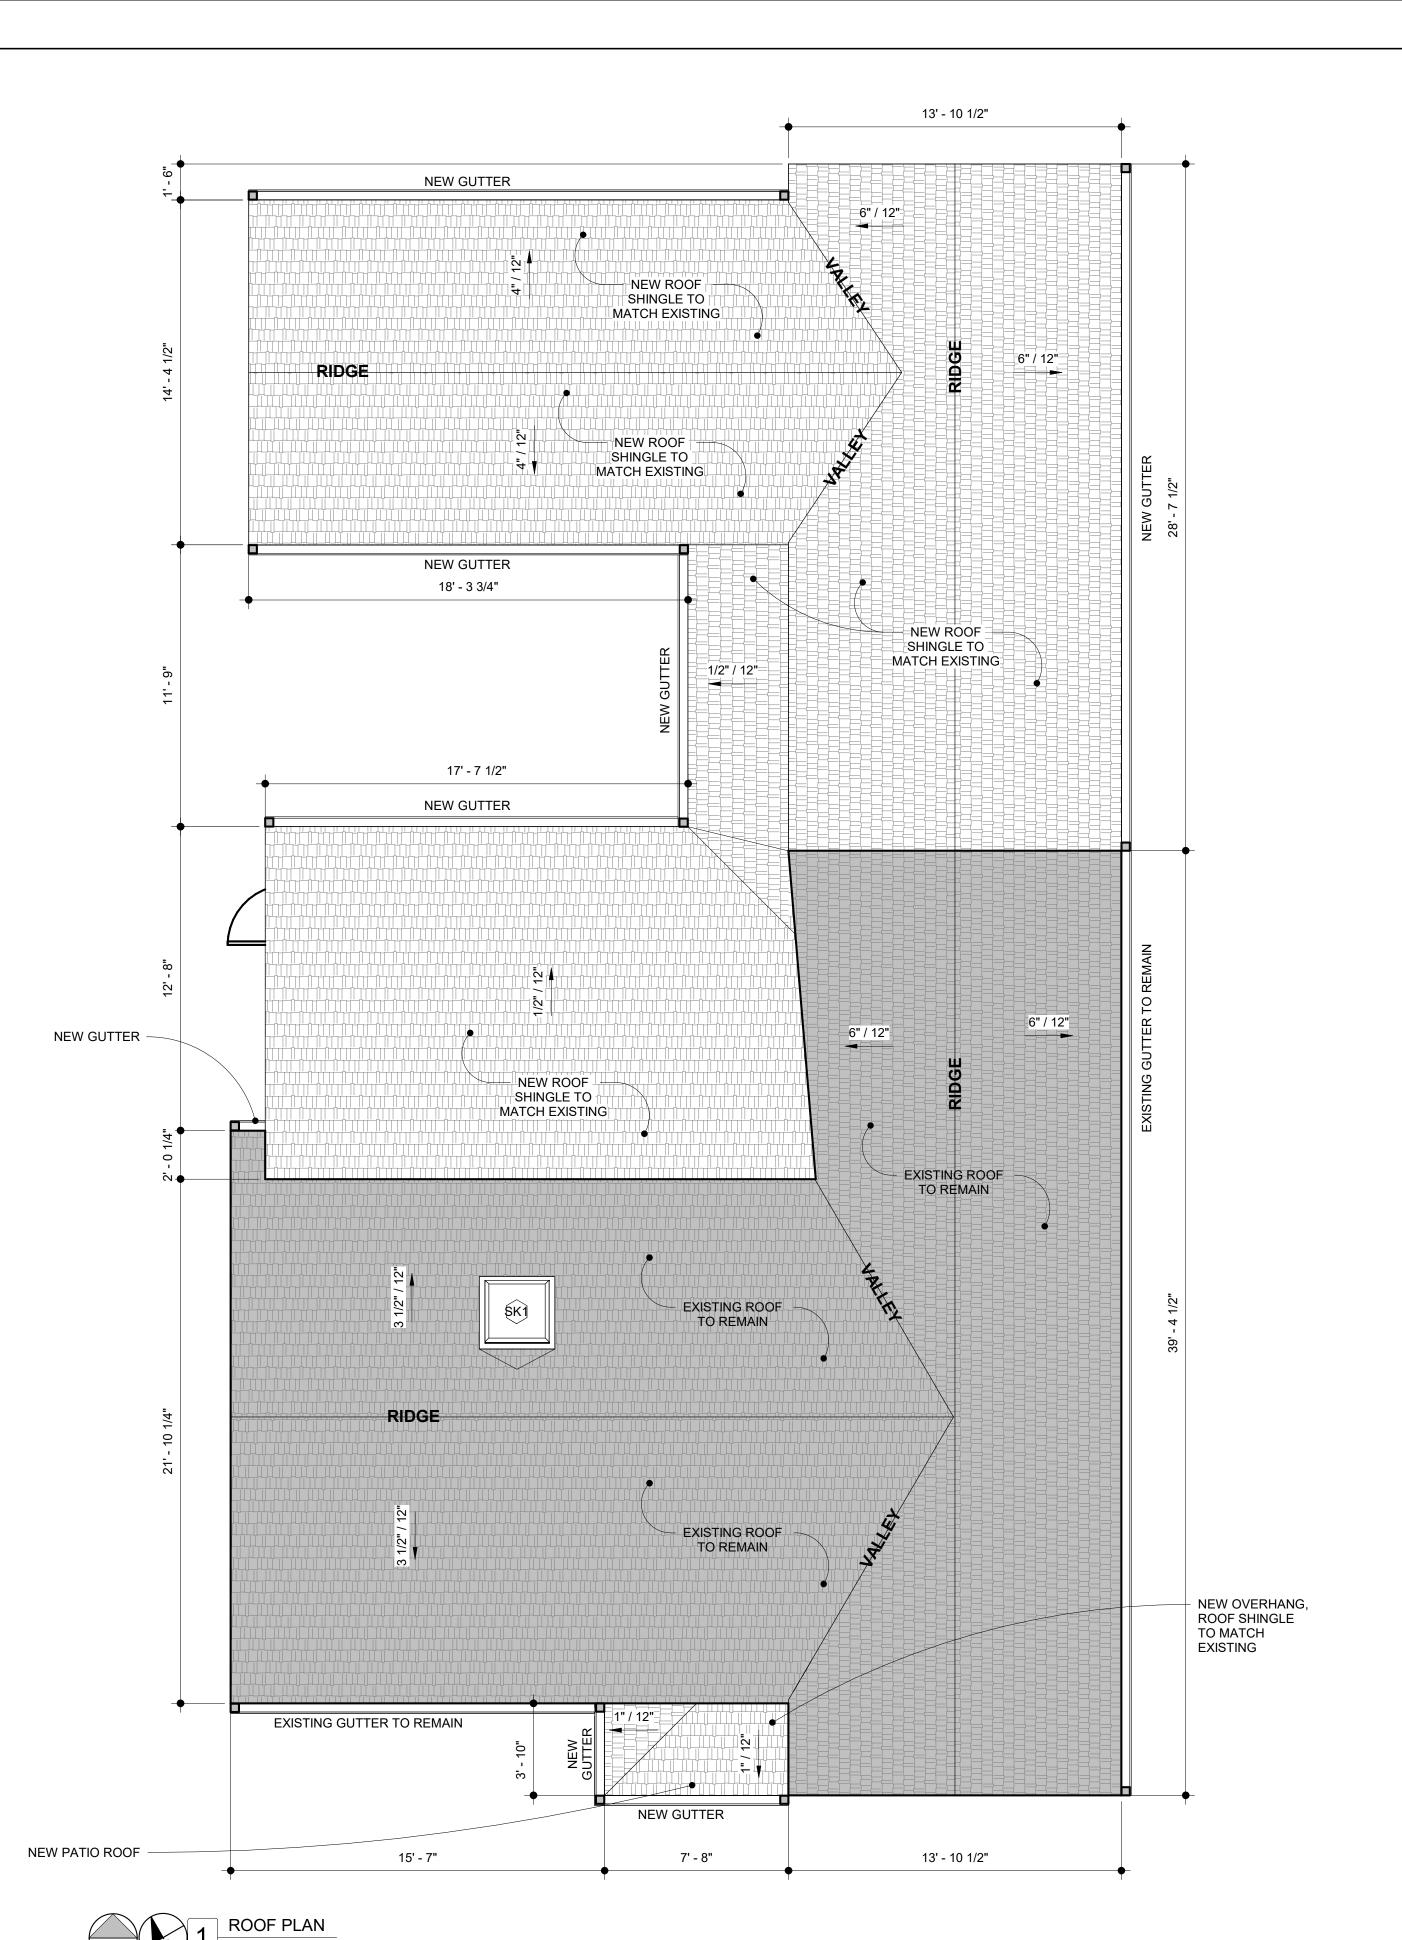


JULIET REMODEL/ADD'N

1406 JULIET ST, AUSTIN, TX 78704

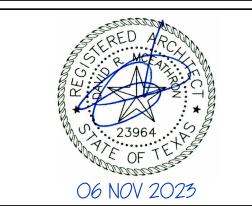SITE PLAN





NOTES - ROOF

FLASHING, UNDERLAYMENTS, FASTENERS &

ACCESSORIES NECESSARY TO ENSURE A

WEATHERTIGHT CONSTRUCTED ROOF.

4. ALL ROOF PENETRATIONS TO BE PROPERLY

5. NEW ROOF SRI VALUE: IF SLOPE IS >2:12,

ROOFING MATERIALS SHALL HAVE A

BARRIER WITH AN EMITTANCE OF .05 OR

LESS, UNLESS ROOF IS COVERED WITH A

MATERIAL HAVING A SOLAR REFLECTANCE

6. NEW ROOFS TO INCLUDE A RADIANT

FLASHED & SEALED TO PREVENT WATER

1. CONTRACTOR SHALL KEEP BUILDING

2. ALL ROOFS SHALL SLOPE TO DRAIN.

COMPLETE, WARRANTABLE, &

3. CONTRACTOR SHALL PROVIDE ALL TRIM,

WEATHERTIGHT.

INTRUSION.

MINIMUM SRI OF 29.

OF 0.5 OR GREATER.

NOTE: DIMENSIONS SHOWN |
ON ROOF PLANS ARE TO

EXTERIOR FACE OF FRAMING
UNLESS NOTED OTHERWISE

WINDOW KEY

- A AWNING
 C CASEMENT
- E EXISTING
- F FIXED
- H HUNG
- S SLIDER SK SKYLIGHT T TRANSOM
- 7. AIR IMPERMEABLE INSULATION OF R-25 OF GREATER MAY BE USED IF MECHANICAL EQUIPMENT & AIR DISTRIBUTION SYSTEM ARE LOCATED ENTIRELY WITHIN THE BUILDING THERMAL ENVELOPE. SEE AUSTIN AMENDMENTS TO THE BUILDING CODE. OTHERWISE, ROOFING INSULATION TO BE A MINIMUM OF R-38.
- 8. SUPPLY & RETURN DUCTS LOCATED IN ATTICS OR OUTSIDE THE THERMAL ENVELOPE SHALL BE INSULATED AS R-8 MIN.
- 9. SKYLIGHTS: USE APPROPRIATE FLASHING & CURBS TO PREVENT WATER INTRUSION & TO ACHIEVE MANUFACTURER'S WARRANTY.
- 10. SKYLIGHTS TO INCLUDE 10 YEAR, NO-LEAK WARRANTY, 10 YEAR IMPACT WARRANTY & 20 YEAR SEAL WARRANTY.
- 11. THE ENTIRE EXTERIOR ENVELOPE TO BE PROPERLY SEALED & FLASHED TO PREVENT MOISTURE INTRUSION.
- 12. INSTALL ALL BUILDING ENVELOPE
 ASSEMBLIES AS PER MANUFACTURER'S
 RECOMMENDATIONS & STANDARD DETAILS
 TO ALLOW FOR PROPER FUNCTION,
 WEATHER PROTECTION & WARRANTIES
 (WHERE AVAILABLE). ASSEMBLIES INCLUDE,
 BUT ARE NOT LIMITED TO, ROOFING,
 RADIANT BARRIER, SKYLIGHTS, WINDOWS,
 DOORS, SIDING, FLASHING, INSULATION,
 WEATHER BARRIERS, SEALANTS, ETC.
- 13. PROVIDE NEW GUTTERS & DOWNSPOUTS TO DRAIN ON SITE. DOWNSPOUTS TO DRAIN AWAY FROM BUILDING.




1402 W NORTH LOOP BLVD, AUSTIN, TX 78756

DAVEY@DAVEYMARCH.COM

512-599-0660

PERMIT

ISSUE DATE: 06 NOV 2023
PROJECT NUMBER: DM230902
DRAWN BY: Author
REVISIONS:
NO REFERENCE ISSUED

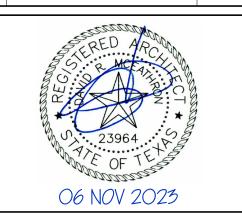


JULIET REMODEL/ADD'N

1406 JULIET ST, AUSTIN, TX 78704

ROOF PLAN



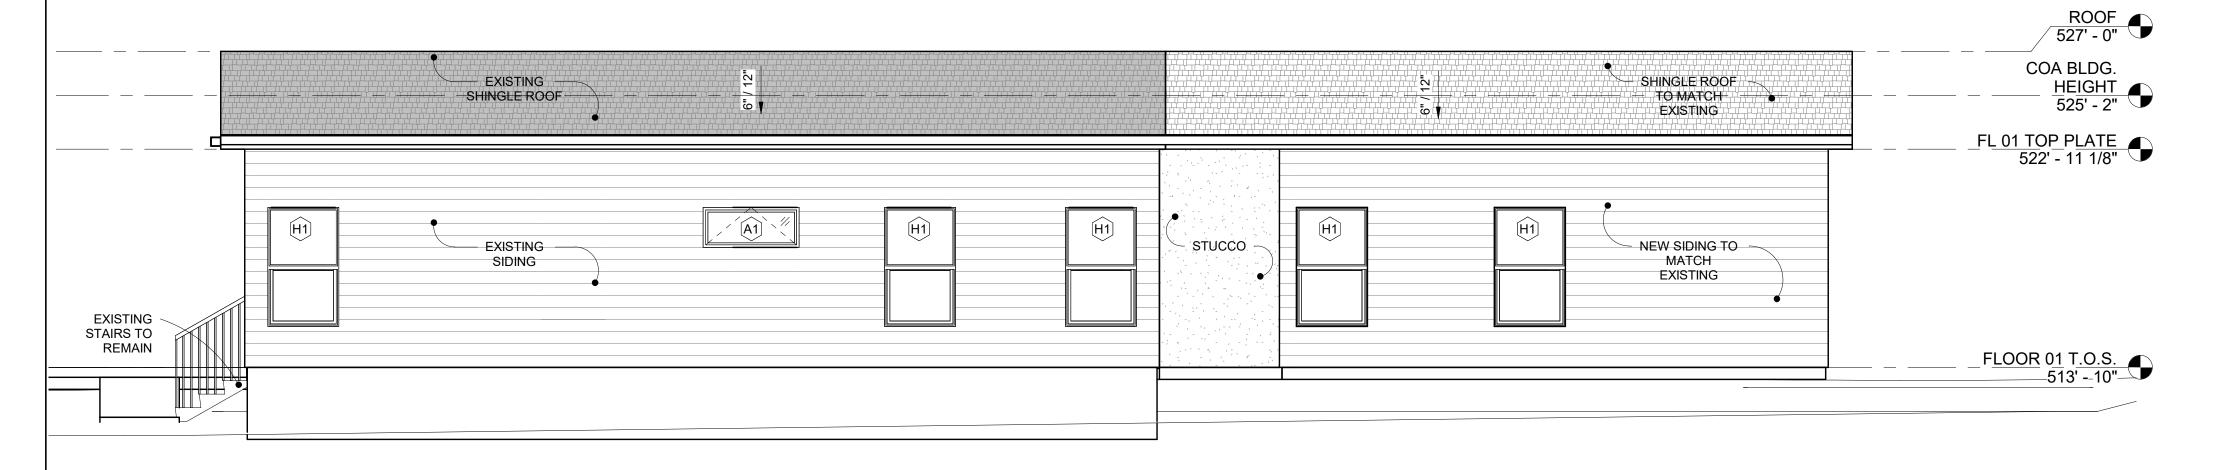

4 EAST ELEVATION 1/4" = 1'-0"

© 2023 DAVEY MCEATHRON ARCHITECTURE

PROJECT TO ADHERE TO ALL REQUIREMENTS IN THE 2021 IRC & ALL ADOPTED LOCAL AMENDMENTS. **««« IF PRINTED AT 11X17, SCALE IS 1/2 OF WHAT IS NOTED »»»**

NOTES - EXTERIOR ELEVATIONS

- 1. CONTRACTOR SHALL KEEP BUILDING WEATHERTIGHT.
- 2. VERIFY ALL MATERIALS & FINISHES WITH ARCHITECT OR OWNER PRIOR TO INSTALLATION.
- SLOPE GRADE AWAY FROM BUILDING & FOUNDATION FOR 10'-0" MIN. WHERE
- 4. ALL EXPOSED FASTENERS ON WOOD SIDING TO BE STAINLESS STEEL.
- 5. THE ENTIRE EXTERIOR ENVELOPE TO BE PROPERLY SEALED & FLASHED TO PREVENT
- 6. ALL PLUMBING, APPLIANCE & GAS VENTS SHALL VENT TO REAR OF ROOF RIDGE WHEREVER POSSIBLE. ALL VENTS SHALL BE GROUPED TO MINIMIZE ROOF PENETRATIONS.

WINDOW KEY


- A AWNING C CASEMENT
- E EXISTING
- F FIXED
- H HUNG
- S SLIDER
- SK SKYLIGHT
- T TRANSOM



512-599-0660

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ISSUE D	ATE:	1 80	NOV 2023	
PROJEC	OJECT NUMBER: DM2309			
DRAWN	BY:		Author	
REVISIO	NS:			
NO	REFERENCE		ISSUED	

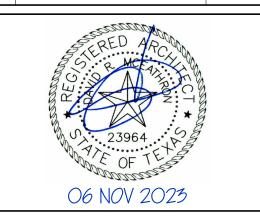

JULIET REMODEL/ADD'N 1406 JULIET ST, AUSTIN, TX 78704

EXTERIOR ELEVATIONS

	WINDOW SCHEDULE										
		NET	NET FRAME		ROUGH OPENING		HEAD		EGRESS	SCREEN	
LEVEL	ROOM NAME	WIDTH	HEIGHT	WIDTH	HEIGHT	HEIGHT	HEIGHT	GLAZING	REQ'D	OPTION	COMMENTS
AWNING											
A1											
FLOOR 01 T.O.S.	BATH 01	4' - 0"	1' - 8"	4' - 0 1/2"	1' - 8 1/2"	5' - 0"	6' - 8"	-	-	SCREEN	
FLOOR 01 T.O.S.	BATH 02	4' - 0"	1' - 8"	4' - 0 1/2"	1' - 8 1/2"	5' - 0"	6' - 8"	-	-	SCREEN	WINDOW TO BE FROSTED FOR PRIVACY
FIXED											
F1											
FLOOR 01 T.O.S.	KITCHEN	3' - 6"	1' - 6"	3' - 6 1/2"	1' - 6 1/2"	3' - 0"	4' - 6"	-			
FLOOR 01 T.O.S.	KITCHEN	3' - 6"	1' - 6"	3' - 6 1/2"	1' - 6 1/2"	3' - 0"	4' - 6"	_			
FLOOR 01 T.O.S. FLOOR 01 T.O.S. FLOOR 01 T.O.S. FLOOR 01 T.O.S.	BEDROOM 01 BEDROOM 02 BEDROOM 02 BEDROOM 03	2' - 11 1/2" 2' - 11 1/2" 2' - 11 1/2" 2' - 11 1/2"	4' - 11 1/2" 4' - 11 1/2" 4' - 11 1/2" 4' - 11 1/2"	3' - 0" 3' - 0" 3' - 0" 3' - 0"	5' - 0" 5' - 0" 5' - 0" 5' - 0"	1' - 8 1/2" 1' - 8 1/2" 1' - 8 1/2" 1' - 8 1/2"	6' - 8" 6' - 8" 6' - 8" 6' - 8"	- - -	EGRESS EGRESS - EGRESS	- - - -	
FLOOR 01 T.O.S.	BEDROOM 03	2' - 11 1/2"	4' - 11 1/2"	3' - 0"	5' - 0"	1' - 8 1/2"	6' - 8"	-	-	_	
FLOOR 01 T.O.S.	BEDROOM 04	2' - 11 1/2"	4' - 11 1/2"	3' - 0"	5' - 0"	1' - 8 1/2"	6' - 8"	-	-	-	
FLOOR 01 T.O.S.	BEDROOM 04	2' - 11 1/2"	4' - 11 1/2"	3' - 0"	5' - 0"	1' - 8 1/2"	6' - 8"	-	-	-	
FLOOR 01 T.O.S.	BEDROOM 04	2' - 11 1/2"	4' - 11 1/2"	3' - 0"	5' - 0"	1' - 8 1/2"	6' - 8"	-	EGRESS	-	
FLOOR 01 T.O.S.	BEDROOM 04	2' - 11 1/2"	4' - 11 1/2"	3' - 0"	5' - 0"	1' - 8 1/2"	6' - 8"	-	-	-	
	BEDROOM 04	2' - 11 1/2"	4' - 11 1/2"	3' - 0"	5' - 0"	1' - 8 1/2"	6' - 8"	-	-	-	
	HALL	2' - 11 1/2"	4' - 11 1/2"	3' - 0"	5' - 0"	1' - 8 1/2"	6' - 8"	-	-	-	
FLOOR 01 T.O.S.		2' - 11 1/2"	4' - 11 1/2"	3' - 0"	5' - 0"	1' - 8 1/2"	6' - 8"	-	-	-	
FLOOR 01 T.O.S. FLOOR 01 T.O.S. FLOOR 01 T.O.S.	HALL		4! 44.4/0"	3' - 0"	5' - 0"	1' - 8 1/2"	6' - 8"	-	-	-	
FLOOR 01 T.O.S. FLOOR 01 T.O.S. FLOOR 01 T.O.S. FLOOR 01 T.O.S.	LIVING	2' - 11 1/2"	4' - 11 1/2"				01 011		_		
FLOOR 01 T.O.S. FLOOR 01 T.O.S.		2' - 11 1/2" 2' - 11 1/2"	4' - 11 1/2"	3' - 0"	5' - 0"	1' - 8 1/2"	6' - 8"	-	-	-	
FLOOR 01 T.O.S. FLOOR 01 T.O.S. FLOOR 01 T.O.S. FLOOR 01 T.O.S.	LIVING				5' - 0"	1' - 8 1/2"	6 8	-	<u> </u>	-	

1' - 6 1/2" 5' - 2"

WINDOW TO BE FROSTED FOR PRIVACY

					DOOR S	CHEDULE			
			PANEL					SCREEN	
DOOR#	ROOM NAME	TYPE	WIDTH	HEIGHT	THICKNESS	MATERIAL	GLAZING	OPTION	COMMENTS
'			1						
100		SWING	3' - 0"	6' - 8"	4.2/4"				
122		SWING	3 - 0	6 - 8	1 3/4"				
FLOOR 01 T	.O.S.								
	VEST.	SWING	2' - 0"	6' - 8"	1 3/4"				
	PANTRY	SWING	2' - 0"	6' - 8"	1 3/4"				
102	KITCHEN	SWING	2' - 8"	6' - 8"	1 3/4"		TEMPERED		
103	POWDER	SWING	2' - 8"	6' - 8"	1 3/4"				
104	WH	SWING	2' - 6"	6' - 8"	1 3/4"				
105	DINING	SLIDING	6' - 0"	6' - 8"	4 1/2"		TEMPERED	-	
106	HALL	SWING	2' - 6"	6' - 8"	1 3/4"				
107	BATH 02	SWING	2' - 6"	6' - 8"	1 3/4"				
108	W/C	SWING	2' - 4"	6' - 8"	1 3/4"				
109	BATH 02	POCKET	2' - 4"	6' - 8"	1 3/4"				
110	HALL	SWING	2' - 6"	6' - 8"	1 3/4"				
111	BEDROOM 03	SLIDING	5' - 0"	6' - 8"	1 3/4"				
112	CLOSET 02	SLIDING	5' - 0"	6' - 8"	1 3/4"				
113	LIVING	POCKET	2' - 6"	6' - 8"	1 3/4"				
114	HALL	POCKET	2' - 4"	6' - 8"	1 3/4"				
115	LAUNDRY	BIFOLD	5' - 0"	6' - 8"	1 1/2"				
116	HALL	SWING	2' - 6"	6' - 8"	1 3/4"				
117	BEDROOM 01	SWING	2' - 0"	6' - 8"	1 3/4"				
118	BEDROOM 04	SLIDING	6' - 0"	6' - 8"	4 1/2"		TEMPERED	-	
120	HALL	SWING	2' - 6"	6' - 8"	1 3/4"				
121	LINEN	SWING	2' - 0"	6' - 8"	1 3/4"				



NOTES - DOOR SCHEDULE


 WINDOWS & DOORS TO MEET IRC 2021 REQUIREMENTS & ALL AMENDMENTS AS ADOPTED BY THE CITY OF AUSTIN.

2. ALL GLAZING IN DOORS & WITHIN A 24" ARC OF DOORS MUST BE

3. CONTRACTOR TO COORDINATE WITH DOOR SUPPLIER TO ENSURE DOORS MEET CURRENT CODES.

PERMIT


ISSUE [DATE:	1 80	06 NOV 2023		
PROJEC	CT NUMBER:	DM230902			
DRAWN	IBY:	SHANE B			
REVISIO	ONS:				
NO	REFERENCE		ISSUED		

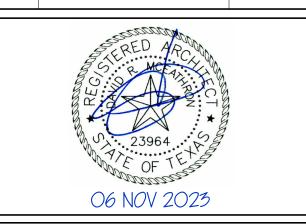

JULIET REMODEL/ADD'N 1406 JULIET ST, AUSTIN, TX 78704

SCHEDULES

A600

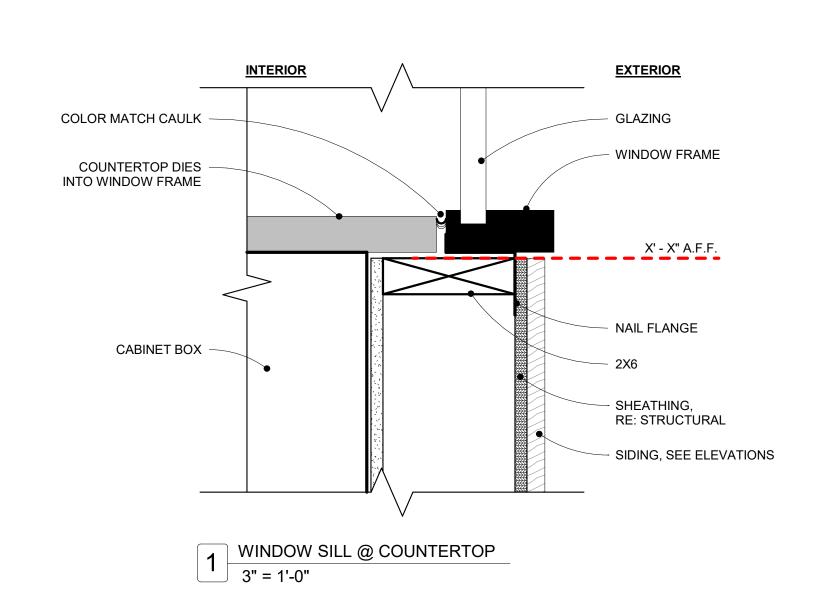

PROJECT TO ADHERE TO ALL REQUIREMENTS IN THE 2021 IRC & ALL ADOPTED LOCAL AMENDMENTS.

««« IF PRINTED AT 11X17, SCALE IS 1/2 OF WHAT IS NOTED »»»

FLOOR 01 T.O.S. POWDER