GENERAL NOTES



N.T.S

1. ALL WORK SHALL BE PERFORMED IN ACCORDANCE WITH ALL APPLICABLE CODES, REGULATIONS, ORDINANCES AND STANDARDS HAVING JURISDICTION. IF THERE ARE ANY QUESTIONS OR CONFLICTS CONCERNING COMPLIANCE WITH SUCH CODES, ORDINANCES, OR STANDARDS, THE CONTRACTOR IS RESPONSIBLE FOR NOTIFYING THE ARCHITECT BEFORE PROCEEDING WITH THE WORK IN QUESTION. ALL NECESSARY PERMITS, LICENSES, CERTIFICATES, TESTS, ETC. SHALL BE PROCURED AND PAID FOR BY THE CONTRACTOR (OR OWNER IF HE DESIGNATES). REFER TO SPECIFICATION "GENERAL CONDITIONS" SECTION FOR CLARIFICATION ON FEE RESPONSIBILITIES.

2. CONTRACTOR IS RESPONSIBLE FOR CHECKING ALL CONTRACT DOCUMENTS, FIELD CONDITIONS AND DIMENSIONS FOR ACCURACY AND CONFIRMING THAT THE WORK IS BUILDABLE AS SHOWN AND MEETS ALL APPLICABLE CODES BEFORE PROCEEDING WITH CONSTRUCTION. IF THERE ARE ANY QUESTIONS REGARDING THESE OR OTHER COORDINATION ISSUES, THE CONTRACTOR IS RESPONSIBLE FOR OBTAINING A CLARIFICATION FROM THE ARCHITECT BEFORE PROCEEDING WITH THE WORK IN QUESTION OR RELATED WORK.

3. THE CONTRACTOR SHALL CERTIFY SIZE AND LOCATION OF ALL REQUIRED OPENINGS FOR STRUCTURAL, MECHANICAL, ELECTRICAL, AND PLUMBING WORK AND EQUIPMENT WITH TRADES INVOLVED.

4. THE GENERAL CONTRACTOR AND EACH SUBCONTRACTOR SHALL BE RESPONSIBLE FOR CHECKING EXISTING CONDITIONS AT THE JOB SITE BEFORE SUBMITTING PROPOSALS. SUBMISSION OF PROPOSALS SHALL BE TAKEN AS EVIDENCE THAT SUCH INSPECTIONS HAVE BEEN MADE. CLAIMS FOR EXTRA COMPENSATION FOR WORK THAT COULD HAVE BEEN FORESEEN BY SUCH INSPECTION, WHETHER SHOWN ON CONTRACT DOCUMENTS OR NOT. SHALL NOT BE ACCEPTED OR PAID.

5. ALL MATERIALS FURNISHED UNDER THIS CONTRACT SHALL BE NEW UNLESS OTHERWISE NOTED. ALL WORK SHALL BE GUARANTEED AGAINST DEFECTIVE MATERIALS AND WORKMANSHIP FOR A PERIOD OF (1) YEAR AFTER THE DATE OF SUBSTANTIAL COMPLETION OR ACCEPTANCE OF THE WORK. THE CONTRACTOR SHALL REPAIR OR REPLACE, AT HIS OWN EXPENSE WHEN ORDERED TO DO SO, ALL WORK THAT MAY DEVELOP DEFECTS IN MATERIAL OR WORKMANSHIP WITHIN SAID PERIOD TIME.

6. ALL EQUIPMENT SHALL BE INSTALLED IN ACCORDANCE WITH MANUFACTURER'S PUBLISHED RECOMMENDATIONS FOR SERVICE INTENDED. THE INSTALLATION OF ALL EQUIPMENT SHALL BE MADE BY EXPERIENCED CRAFTSMEN IN A NEAT, WORKMANLIKE MANNER. ALL MATERIALS, TOOLS, COSTS, AND SERVICES NECESSARY TO COMPLETELY INSTALL ALL MECHANICAL, ELECTRICAL, AND PLUMBING WORK SHALL BE PROVIDED BY THE CONTRACTOR.

7. CONTRACTOR SHALL BE RESPONSIBLE FOR ADEQUATELY BRACING AND PROTECTING ALL WORK DURING CONSTRUCTION AGAINST DAMAGE, BREAKAGE, COLLAPSE, AND MISALIGNMENT ACCORDING TO APPLICABLE CODES, STANDARDS, AND GOOD CONSTRUCTION PRACTICES. CONTRACTOR SHALL TAKE PROPER PRECAUTIONS TO PROTECT ALL EXISTING OPERATIONS AND PROPERTY ADJACENT. WITH WHICH WORK COMES IN CONTACT, OR OVER OR UNDER WHICH HE MAY TRANSPORT, HOIST, OR MOVE MATERIALS EQUIPMENT, DEBRIS, ETC., AND SHALL REPAIR SATISFACTORILY ALL DAMAGES CAUSED BY HIM DURING CONSTRUCTION.

8. THE CONTRACTOR SHALL VERIFY AND COORDINATE SIZES, LOCATIONS AND CHARACTERISTICS OF ALL WORK AND EQUIPMENT TO BE FURNISHED BY THE OWNER. OR OTHERS WITH THE MANUFACTURER OR SUPPLIER BEFORE ANY CONSTRUCTION IS BEGUN. 9. THE CONTRACTOR SHALL SUBMIT TO THE ARCHITECT CONFIRMATIONS OF ORDERS,

THE CONSTRUCTION SCHEDULE.

DRAWING PERMIT LIST

A0 GENERAL NOTES / SITE

AU GLINEINAL NO	
A0.0	GENERAL NOTE
A0.1	SITE PLAN
A0.2	CRZ AND STAGI
CONSTRUCTION	PLAN BLDG 01
CH A1.0	DEMO AND ROO
CH A1.1	FLOOR PLAN BL
CH A1.2	FLOOR PLAN BL
CH A2.0	EXTERIOR ELEV
CH A2.1	EXTERIOR ELEV
CH A7.0	WINDOW SCHE
CH A7.1	DOORS SCHEDU
CONSTRUCTION	PLAN BLDG 02
PH A1.0	DEMO AND ROO
PH A1.1	FLOOR PLAN BL
PH A2.0	EXTERIOR ELEV
PH A2.1	EXTERIOR ELEV
PH A7.0	WINDOW SCHE
PH A7.1	DOORS SCHEDU

INCLUDING DELIVERY DATES, FOR ALL MATERIALS AND EQUIPMENT WHOSE TIMELY DELIVERY IS REQUIRED TO AVOID CHANGES IN THE CONSTRUCTION DOCUMENTS OR IN

GING AREA

OOF PLAN BLDG 01 DG 01 LDG 01 VATIONS BLDG 01 ATIONS BLDG 01 EDULES BLDG 01 ULES BLDG 01

OOF PLAN BLDG 02 DG 02 VATIONS BLDG 02 ATIONS BLDG 02 IEDULES BLDG 02 DULES BLDG 02

10. THE CONTRACTOR MUST SUBMIT SHOP DRAWINGS TO THE ARCHITECT FOR APPROVAL BEFORE PROCEEDING WITH FABRICATION. THE CONTRACTOR REMAINS RESPONSIBLE FOR DETAILS AND ACCURACY, FOR CONFIRMING AND CORRELATING ALL QUANTITIES AND DIMENSIONS, FOR SELECTING FABRICATION PROCESSES, FOR TECHNIQUES OR ASSEMBLY, FOR PERFORMING THE WORK IN A SAFE MANNER, AND FOR ADHERING TO ALL APPLICABLE CODES AND STANDARDS.

11. LOCATION OF ALL CEILING MOUNTED ITEMS ON THE ARCHITECTURAL DRAWINGS HAVE PRECEDENCE OVER MEP DRAWINGS. ARCHITECT SHOULD BE NOTIFIED OF ANY CONFLICTS PRIOR TO CONSTRUCTION.

12. IT IS THE INTENT AND MEANING OF THE CONTRACT DOCUMENTS THAT THE CONTRACTOR SHALL PROVIDE A MECHANICAL, ELECTRICAL, AND PLUMBING INSTALLATION THAT IS COMPLETE. ALL ITEMS AND APPURTENANCES NECESSARY, REASONABLY INCIDENTAL, OR CUSTOMARILY INCLUDED, EVEN THOUGH EACH ITEM IS NOT SPECIFICALLY CALLED OUT OR SHOWN IN THE CONSTRUCTION DOCUMENTS SHALL BE PROVIDED.

13. ALL MEP RELATED ITEMS SHOULD BE REVIEWED BY THE ENGINEER IF APPLICABLE AND MAY BE ADJUSTED PENDING NOTICE TO AND APPROVAL OF THE ARCHITECT.

14. WRITTEN DIMENSIONS SHALL HAVE PRECEDENCE. DO NOT SCALE DIMENSIONS. IF NO DIMENSION IS LISTED, CONTACT ARCHITECT FOR CLARIFICATION.

15. ALL WORK NOTED "N.I.C." OR "NOT IN THE CONTRACT" IS TO BE ACCOMPLISHED BY A CONTRACTOR OTHER THAN THE GENERAL CONTRACTOR AND IS NOT TO BE PART OF THE CONSTRUCTION AGREEMENT.

16. "ALIGN" AS USED IN THESE DOCUMENTS SHALL MEAN TO ACCURATELY LOCATE FINISH FACES IN THE SAME PLANE.

17. "TYPICAL" OR "TYP." AS USED IN THESE DOCUMENTS SHALL MEAN THAT THE CONDITION IS THE SAME OR REPRESENTATIVE FOR ALL SIMILAR CONDITIONS THROUGHOUT, UNLESS OTHERWISE NOTED.

18. "SIMILAR" OR "SIM." AS USED IN THESE DOCUMENTS SHALL MEAN THAT THE CONDITION IS SIMILAR TO A CONDITION DETAILED FOR ANOTHER LOCATION.

19. THE CONTRACTOR SHALL PROVIDE UPDATED RECORD DOCUMENTS OF AS-BUILT CONDITIONS ON-SITE WHEN DIFFERENT FROM CONSTRUCTION DOCUMENTS AND SHALL PROVIDE SAID DOCUMENTATION TO ARCHITECT UPON COMPLETION OF CONSTRUCTION.

20. THIS COVER SHEET IS A MASTER INDEX. NOT ALL SYMBOLS/ITEMS WILL BE INCLUDED IN DRAWINGS.

21. DO NOT DISASSEMBLE THIS SET OR DISTRIBUTE PARTIAL SETS TO SUBCONTRACTORS. COVER SHEET CONTAINS DATA PERTINENT TO ALL SHEETS.

PROJECT DATA	
PROJECT ADDRESS:	
1711 NEWTON STREET	
AUSTIN, TX 78704	
ZONED: SF-3	
LEGAL DESCRIPTION: LOT 7 BLK 28 SWSHER ADDN	
LOT AREA (sq ft): 6,961.59	

AREA TABULATIONS

GROSS FLOOR AREAS

	<u>EXISTING</u>	<u>NEW</u>	APPLIED EXEMPTION	<u>TOTAL</u>
1ST FLOOR	2,380.48	245.50	0 SF	2,625.98 SF
BASEMENT	746.12	0	746.12 SF	0 SF
SUBTOTAL*				2,625.98 SF

F.A.R = (TOTAL GROSS FLOOR AREA / LOT AREA) x 100

= (2,625.98 SF /6,961.59) x 100 = 37.7

COVERAGE CALCULATIONS

EXISTING LOT AREA	6,961.59 SF
BUILDING COVERAGE	
ALLOWABLE BUILDING COVERAGE @ 40%	2,784.6 SF
TOTAL BUILDING COVERAGE ON LOT	2,745.98 SF
PERCENTAGE IMPERVIOUS COVERAGE	39.40 %
IMPERVIOUS COVERAGE	
ALLOWABLE IMPERVIOUS COVERAGE @ 45%	3,132.70 SF
TOTAL IMPERVIOUS COVERAGE ON LOT	3,069.98 SF
PERCENTAGE IMPERVIOUS COVERAGE	44.10 %
PARKING	
<u></u>	
SPACES PROVIDED	2

SUBMITTAL INFORMATION

GENERAL NOTE: THE FOLLOWING IS A LIST OF REQUIREMENTS THAT DIG: A EXPECTS FROM THE CONTRACTOR ON THIS IOB. REFERENCE BOOK OF SPECIFICATIONS FOR FURTHER DETAIL REGARDING GENERAL CONDITIONS. THIS IS WORKING DOCUMENT THAT IS MEANT TO BE DISCUSSED AND FINALIZED WITH THE CONTRACTOR PRIOR TO THE ASSIGNMENT OF THE CONSTRUCTION CONTRACT.

CONSTRUCTION SCHEDULE: A COMPREHENSIVE, FULLY DEVELOPED, HORIZONTAL BAR-CHART-TYPE, CONTRACTOR'S CRITICAL PATH CONSTRUCTION SCHEDULE.

1. SUBMIT THE SCHEDULE WITHIN 7 DAYS AFTER SIGNING THE CONTRACT. 2. PROVIDE A SEPARATE TIME BAR FOR EACH SIGNIFICANT CONSTRUCTION ACTIVITY AS INDICATED IN THE SCHEDULE OF VALUES. PROVIDE A CONTINUOUS VERTICAL LINE TO IDENTIFY THE FIRST WORKING DAY OF EACH WEEK. 3. WITHIN EACH TIME BAR, INDICATE ESTIMATED COMPLETION PERCENTAGE IN 10

PERCENT INCREMENTS. AS WORK PROGRESSES, PLACE A CONTRASTING MARK IN EACH BAR TO INDICATE ACTUAL COMPLETION PERCENTAGE 4. PREPARE THE SCHEDULE ON A SHEET, OR SERIES OF SHEETS OF SUFFICIENT WIDTH TO SHOW DATA FOR THE ENTIRE CONSTRUCTION PERIOD

5. COORDINATE THE CONTRACTOR'S CONSTRUCTION SCHEDULE WITH THE SCHEDULE OF VALUES, LIST OF SUBCONTRACTS, SUBMITTALS, PROGRESS REPORTS, PAYMENT REQUESTS, AND REPORTS.

6. INDICATE COMPLETION IN ADVANCE OF THE DATE ESTABLISHED FOR SUBSTANTIAL COMPLETION. INDICATE SUBSTANTIAL COMPLETION ON THE SCHEDULE TO ALLOW TIME FOR THE ARCHITECT'S ADMINISTRATIVE PROCEDURES NECESSARY FOR CERTIFICATION OF SUBSTANTIAL COMPLETION.

SCHEDULE OF VALUES: PROVIDE AT LEAST ONE LINE ITEM FOR EACH MAJOR COMPONENT OF CONSTRUCTION AS IDENTIFIED IN THE CONSTRUCTION SCHEDULE

1.PROVIDE A SEPARATE LINE ITEM IN THE SCHEDULE OF VALUES FOR EACH PART OF THE WORK WHERE APPLICATIONS FOR PAYMENT MAY INCLUDE MATERIALS OR EQUIPMENT PURCHASED OR FABRICATED AND STORED, BUT NOT YET INSTALLED. 2. INCLUDE TOTAL COST AND PROPORTIONATE SHARE OF GENERAL OVERHEAD AND PROFIT FOR EACH ITEM.

TEMPORARY FACILITIES AND OTHER MAJOR COST ITEMS THAT ARE NOT DIRECT COST OF ACTUAL WORK-IN-PLACE MAY BE SHOWN EITHER AS SEPARATE LINE ITEMS IN THE SCHEDULE OF VALUES OR DISTRIBUTED AS GENERAL OVERHEAD EXPENSE, AT CONTRACTOR'S OPTION.

3. INCLUDE THE FOLLOWING PROJECT IDENTIFICATION ON THE SCHEDULE OF VALUES:

- PROJECT NAME AND LOCATION.
- NAME OF OWNER. CONTRACTOR'S NAME AND ADDRESS.
- DATE OF SUBMITTAL

4. UPDATE AND RESUBMIT THE SCHEDULE OF VALUES BEFORE THE NEXT APPLICATIONS FOR PAYMENT WHEN CHANGE ORDERS OR CONSTRUCTION CHANGE DIRECTIVES RESULT IN A CHANGE IN THE CONTRACT SUM. 5. ARRANGE THE SCHEDULE OF VALUES IN TABULAR FORM WITH SEPARATE COLUMNS TO INDICATE THE FOLLOWING FOR EACH ITEM LISTED:

- RELATED SPECIFICATION SECTION OR DIVISION, IF APPLICABLE.
- DESCRIPTION OF THE WORK
- NAME OF SUBCONTRACTOR. NAME OF MANUFACTURER OR FABRICATOR
- NAME OF SUPPLIER.
- CHANGE ORDERS (NUMBERS) THAT AFFECT VALUE.
- DOLLAR VALUE (ROUND AMOUNTS TO NEAREST WHOLE DOLLAR); TOTAL OF ALL ITEMS SHALL EQUAL THE CONTRACT SUM. PERCENTAGE OF THE CONTRACT SUM TO NEAREST ONE-HUNDREDTH PERCENT;
- TOTAL OF ALL ITEMS SHALL EQUAL 100%.

6. SUBMIT THE SCHEDULE OF VALUES TO THE ARCHITECT AT EARLIEST POSSIBLE DATE BUT NO LATER THAN FOURTEEN DAYS BEFORE THE DATE SCHEDULED FOR SUBMITTAL OF INITIAL APPLICATIONS FOR PAYMENT.

LIST OF SUBCONTRACTS: PROVIDE A COMPLETE LIST OF ALL SUBCONTRACTS ASSOCIATED WITH THE JOB, INCLUDING THE WORK INVOLVED WITH SAID SUBCONTRACT, AND THE SUBCONTRACTORS: NAME, PRIMARY CONTACT, ADDRESS, TELEPHONE, AND FAX.

SUBMITTAL SCHEDULE AND SUBMITTALS/SHOP DRAWINGS/SAMPLES: ONCE THE CONSTRUCTION SCHEDULE IS APPROVED, THE CONTRACTOR SHALL PROVIDE A LIST OF ALL SUBMITTALS/SHOP DRAWINGS/SAMPLES THEY INTEND TO SUBMIT FOR THE JOB AND THEIR ASSOCIATED SUBMITTAL DATES. IN ADDITION. THE CONTRACTOR SHALL IDENTIFY ALL OWNER SUPPLIED SUBMITTALS (FF&E) THAT WILL BE REQUIRED AND THE DEADLINE FOR THESE SUBMITTALS

1. COORDINATE THE SUBMITTAL DATES WITH THE CONSTRUCTION SCHEDULE AND ALLOW ENOUGH TIME FOR A (2) WEEK REVIEW PERIOD AND THE NEED FOR RESUBMITTING IF NOT INITIALLY ACCEPTED

2. COLLECT INFORMATION INTO A SINGLE SUBMITTAL FOR EACH ELEMENT OF CONSTRUCTION AND TYPE OF PRODUCT OR EQUIPMENT INCLUDING BUT NOT LIMITED TO b. ROOFING, WATERPROOFING, DOORS AND DOOR HARDWARE, WINDOW SYSTEMS, FINISHES (INTERIOR AND EXTERIOR), MILLWORK, TOILET PARTITIONS, WINDOW TREATMENTS, ALL MECHANICAL EQUIPMENT AND AIR DEVICES, ALL LIGHT FIXTURES AND CONTROL DEVICES, ALL PLUMBING FIXTURES. PROVIDE (5) COPIES OF EACH SUBMITTAL. OR (1) DIGITAL COPY. INCLUDING THE FOLLOWING INFORMATION WITH EACH SUBMITTAL (AS APPLICABLE):

DATE OF SUBMITTAL

ETC.

- MANUFACTURER'S WRITTEN RECOMMENDATIONS
- MANUFACTURER'S PRODUCT SPECIFICATIONS. MANUFACTURER'S INSTALLATION INSTRUCTION.
- STANDARD COLOR/FINISH CHARTS.
- MANUFACTURER'S CATALOG CUT SHEETS
- STANDARD OPERATING AND MAINTENANCE MANUALS. COMPLIANCE WITH RECOGNIZED TRADE ASSOCIATION STANDARDS.
- COMPLIANCE WITH RECOGNIZED TESTING AGENCY STANDARDS. WARRANTY INFORMATION

3. PREPARE PROJECT-SPECIFIC SHOP-DRAWINGS SHOWING ALL RELEVANT INFORMATION. DRAWN ACCURATELY TO SCALE WITH FIELD-VERIFIED DIMENSIONS. SHOP-DRAWINGS SHALL BE PRODUCED FOR ALL COMPONENTS OF THE WORK REQUIRING ASSEMBLY INCLUDED, BUT NOT LIMITED TO METAL FABRICATIONS (STRUCTURAL STEEL, STAIRS, GUARDRAILS, HANDRAILS, GATES, AWNINGS, ETC.), WOOD FABRICATIONS (MILLWORK WOOD PANELING, FIXED SEATING, SCREEN WALLS, ETC.), ELEVATORS OR PLATFORM LIFTS,

- DO NOT BASE SHOP DRAWINGS ON REPRODUCTIONS OF THE CONTRACT а.
- DOCUMENTS. VERIFY ALL DIMENSIONS IN FIELD.
- SUBMIT 5 COPIES ON SHEETS BETWEEN 8-1/2" X 11" AND 24" X 36", EXCEPT FOR FULL-SIZE TEMPLATES. PATTERNS. OR OTHER SIMILAR DRAWINGS.

4. IN ADDITION TO THE SUBMITTALS AND SHOP DRAWINGS DESCRIBED ABOVE, THE CONTRACTOR SHALL PROVIDE SAMPLES/MOCK-UPS OF THE FOLLOWING:

- WINDOW SYSTEM, INCLUDING GLAZING.
- SUSPENDED CEILING SYSTEMS.
- MILLWORK, SHOWING A TYPICAL CORNER AND CABINET FACE. ALL FINISHES: GWB WITH TEXTURE, TILES (WITH GROUT CHOICES), WALL PANELING WITH ASSOCIATED FINISHES, COUNTERTOPS INCLUDING EDGE
- CONDITION, WALLPAPER, PAINT COLORS, FLOOR STAINS/SEALERS, CARPET, ETC. MASONRY UNIT WALLS, SHOWING PATTERN. FIXED SEATING
- SCREEN WALLS, SHOWING ALL JOINTS AND METHOD OF ATTACHMENT.

SUBSTANTIALLY COMPLETE.

- AGENCY.

- с. d.

5. IT IS THE CONTRACTOR'S RESPONSIBILITY TO REVIEW EACH SUBMITTAL BEFORE GIVING IT TO DIG: A. IF A SUBMITTAL IS NOT STAMPED OR OTHERWISE INDICATED AS REVIEWED BY THE CONTRACTOR, DIG: A WILL RETURN IT TO THE CONTRACTOR WITHOUT REVIEWING

6. THE CONTRACTOR IS ULTIMATELY RESPONSIBLE FOR INSTALLED WORK THAT DOES NOT MEET CODE. IT IS NOT THE RESPONSIBILITY OF THE OWNER OR ANY OF THEIR CONSULTANTS, INCLUDING DIG: A TO VERIFY THAT INSTALLED WORK MEETS ALL APPLICABLE CODES.

PROGRESS REPORTS

ON A MONTHLY BASIS. THE CONTRACTOR SHALL PREPARE A PROGRESS REPORT FOR THE OWNER THAT SHALL CONTAIN THE INFORMATION DESCRIBED BELOW.

DATE OF PROGRESS REPORT

ANY OUTSTANDING ITEMS FROM THE PREVIOUS PROGRESS REPORT. THE STATUS OF ALL WORK, IN ACCORDANCE WITH THE SCHEDULE OF VALUES, ASSOCIATED WITH THE JOB, INCLUDING ITEMS TO COMMENCE PRIOR TO THE

NEXT PROGRESS REPORT.

ALL ISSUES WITH THE WORK AS PLANNED. ALL OUTSTANDING DECISIONS/ACTION ITEMS/SUBMITTALS FROM THE

- CONTRACTOR AND ITS SUBCONTRACTORS.
- ALL OUTSTANDING DECISIONS/ACTION ITEMS FROM THE OWNER. ALL OUTSTANDING DECISIONS/SUBMITTAL REVIEWS/ACTION ITEMS FROM DIG:

ANY CHANGES TO THE CONSTRUCTION SCHEDULE, INCLUDING IDEAS TO MAKE-UP TIME (IF NEEDED) AND MAINTAIN THE CONSTRUCTION SCHEDULE.

PAYMENT REQUESTS: EACH APPLICATION FOR PAYMENT SHALL BE CONSISTENT WITH PREVIOUS APPLICATIONS AND PAYMENTS AS CERTIFIED BY ARCHITECT AND PAID FOR BY OWNER. INITIAL APPLICATION FOR PAYMENT. APPLICATION FOR PAYMENT AT TIME OF SUBSTANTIAL COMPLETION, AND FINAL APPLICATION FOR PAYMENT INVOLVE ADDITIONAL REQUIREMENTS.

L. THE DATE FOR EACH PROGRESS PAYMENT IS THE 25TH DAY OF EACH MONTH. THE PERIOD COVERED BY FACH APPLICATION FOR PAYMENT STARTS ON THE DAY FOLLOWING THE END OF THE PRECEDING PERIOD AND ENDS ON THE 25TH DAY OF THE MONTH FOR EACH PROGRESS PAYMENT. 2. USE AIA DOCUMENT G702 AND AIA DOCUMENT G703 CONTINUATION SHEETS AS FORM

FOR APPLICATIONS FOR PAYMENT. 3. COMPLETE EVERY ENTRY ON FORM. NOTARIZE AND EXECUTE BY A PERSON

AUTHORIZED TO SIGN LEGAL DOCUMENTS ON BEHALF OF CONTRACTOR. THE ARCHITECT WILL RETURN INCOMPLETE APPLICATIONS WITHOUT ACTION. 4. ENTRIES SHALL MATCH DATA ON THE SCHEDULE OF VALUES AND CONTRACTOR'S

CONSTRUCTION SCHEDULE. USE UPDATED SCHEDULES IF REVISIONS WERE MADE. 5. INCLUDE AMOUNTS OF CHANGE ORDERS AND CONSTRUCTION CHANGE DIRECTIVES ISSUED BEFORE LAST DAY OF CONSTRUCTION PERIOD COVERED BY APPLICATION. 6. SUBMIT 4 SIGNED AND NOTARIZED ORIGINAL COPIES OF EACH APPLICATION FOR PAYMENT TO OWNER (DIG: A) BY A METHOD ENSURING RECEIPT WITHIN 24 HOURS. ONE COPY SHALL INCLUDE WAIVERS OF LIEN AND SIMILAR ATTACHMENTS IF REQUIRED. INCLUDE ITEMIZED RECEIPTS FOR ANY MATERIAL STORED OFF-SITE FOR WHICH PAYMENT IS BEING REQUESTED. TRANSMIT EACH COPY WITH A TRANSMITTAL FORM LISTING ATTACHMENTS AND RECORDING APPROPRIATE INFO. ABOUT APPLICATION. 7. SUBMIT PARTIAL WAIVERS ON EACH ITEM FOR AMOUNT REQUESTED, BEFORE DEDUCTION FOR RETAINAGE, ON EACH ITEM.

8. WHEN AN APPLICATION SHOWS COMPLETION OF AN ITEM, SUBMIT FINAL OR FULL WAIVERS. 9.ADMINISTRATIVE ACTIONS AND SUBMITTALS THAT MUST PRECEDE OR COINCIDE WITH SUBMITTAL OF FIRST APPLICATION FOR PAYMENT INCLUDE THE FOLLOWING:

- CONTRACTOR'S CONSTRUCTION SCHEDULE. SCHEDULE OF VALUES.
- LIST OF SUBCONTRACTS.
- SUBMITTAL SCHEDULE (PRELIMINARY IF NOT FINAL). LIST OF CONTRACTOR'S STAFF ASSIGNMENTS.
- COPIES OF BUILDING PERMITS.
- COPIES OF AUTHORIZATIONS AND LICENSES FROM AUTHORITIES HAVING JURISDICTION FOR PERFORMANCE OF THE WORK.

INITIAL PROGRESS REPORT. REPORT OF PRE-CONSTRUCTION CONFERENCE.

CERTIFICATES OF INSURANCE AND INSURANCE POLICIES.

PERFORMANCE AND PAYMENT BONDS RECORDED IN TRAVIS COUNTY BY THE GENERAL CONTRACTOR.

DATA NEEDED TO ACQUIRE OWNER'S INSURANCE.

10. AFTER ISSUING THE CERTIFICATE OF SUBSTANTIAL COMPLETION. APPLY FOR PAYMENT SHOWING 100% COMPLETION OF THE PORTION OF THE WORK CLAIMED AS

11. SUBMIT FINAL APPLICATION FOR PAYMENT WITH SUBMIT FINAL APPLICATION FOR PAYMENT WITH RELEASES AND SUPPORTING DOCUMENTATION NOT PREVIOUSLY SUBMITTED AND ACCEPTED, INCLUDING, BUT NOT LIMITED, TO THE FOLLOWING:

> EVIDENCE OF COMPLETION OF PROJECT CLOSEOUT REQUIREMENTS. INSURANCE CERTIFICATES FOR PRODUCTS AND COMPLETED OPERATIONS WHERE REQUIRED AND PROOF THAT TAXES, FEES, AND SIMILAR OBLIGATIONS

- WFRF PAID. UPDATED FINAL STATEMENT, ACCOUNTING FOR FINAL CHANGES TO THE CONTRACT SUM.
- AIA DOCUMENT G706, "CONTRACTOR'S AFFIDAVIT OF PAYMENT OF DEBTS AND

AIA DOCUMENT G706A, "CONTRACTOR'S AFFIDAVIT OF RELEASE OF LIENS." AIA DOCUMENT G707. "CONSENT OF SURETY TO FINAL PAYMENT." EVIDENCE THAT CLAIMS HAVE BEEN SETTLED, IF APPLICABLE. FINAL METER READINGS FOR UTILITIES, AND SIMILAR DATA AS OF DATE OF

SUBSTANTIAL COMPLETION OR WHEN OWNER TOOK POSSESSION OF AND ASSUMED RESPONSIBILITY FOR CORRESPONDING ELEMENTS OF THE WORK. FINAL WAIVERS FROM EVERY ENTITY INVOLVED WITH PERFORMANCE OF THE WORK COVERED BY THE APPLICATION WHO IS LAWELLLY ENTITLED TO A LIEN TESTING REPORTS, RECORD DRAWINGS, AND OWNER AND MAINTENANCE MANUALS.

TESTING REPORTS: IMMEDIATELY UPON RECEIPT, THE CONTRACTOR SHALL SUBMIT ALL TESTING REPORTS TO DIG: A. ALL TESTING SHALL BE DONE BY AN INDEPENDENT TESTING

RECORD DRAWINGS: CONTRACTOR SHALL MAINTAIN A SET OF DRAWINGS SHOWING 'AS-BUILT' CONDITIONS THAT VARY FROM THE CONSTRUCTION DOCUMENTS. UPON COMPLETION OF THE JOB, THE CONTRACTOR SHALL PROVIDE THE OWNER WITH (1) COMPLETE SET OF SAID DRAWINGS.


OWNER AND MAINTENANCE MANUALS: THE CONTRACTOR SHALL COMPILE A BINDER FOR THE OWNER OF ALL EQUIPMENT, PRODUCTS/FINISHES, ETC. USED ON THE JOB.

1. THE BINDER SHALL CONTAIN:

- TABLE OF CONTENTS, THE BINDER SHALL BE ORGANIZED INTO SECTIONS
- ASSOCIATED WITH THE SCHEDULE OF VALUES LIST OF SUBCONTRACTS


ALL INFORMATION FOR THE PROPER MAINTENANCE AND OPERATION FOR THE ENTIRE PROJECT ALL WARRANTIES, INCLUDING THE WARRANTY FROM THE CONTRACTOR.

2. WITHIN (14) DAYS OF RECEIVING THIS INFORMATION, THE OWNER MAY REQUEST A MEETING ON-SITE WITH THE CONTRACTOR TO REVIEW THE INFORMATION.

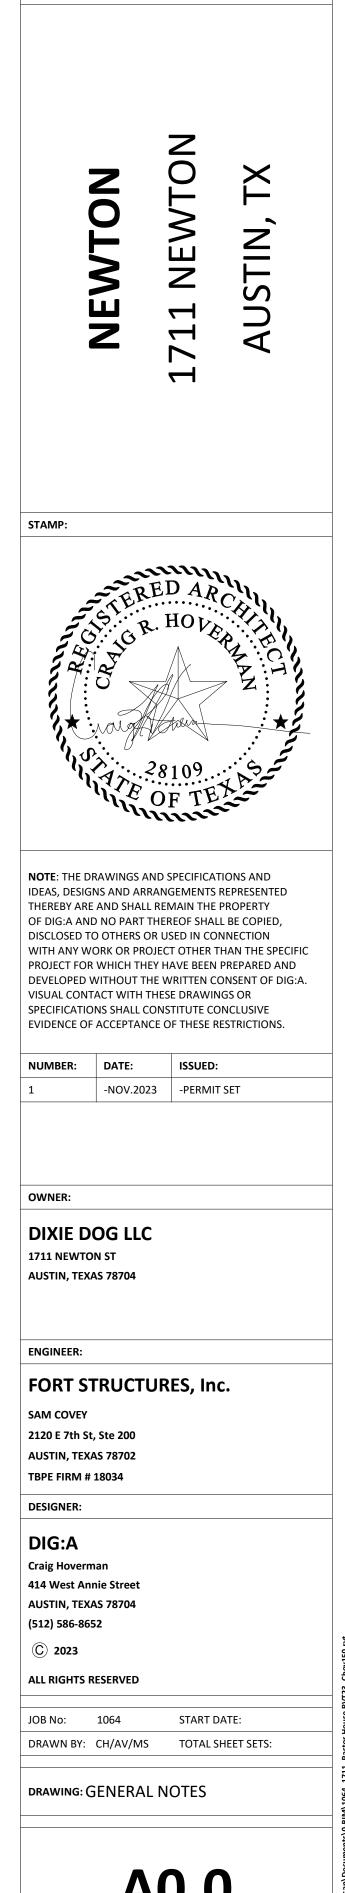


PROJECT:



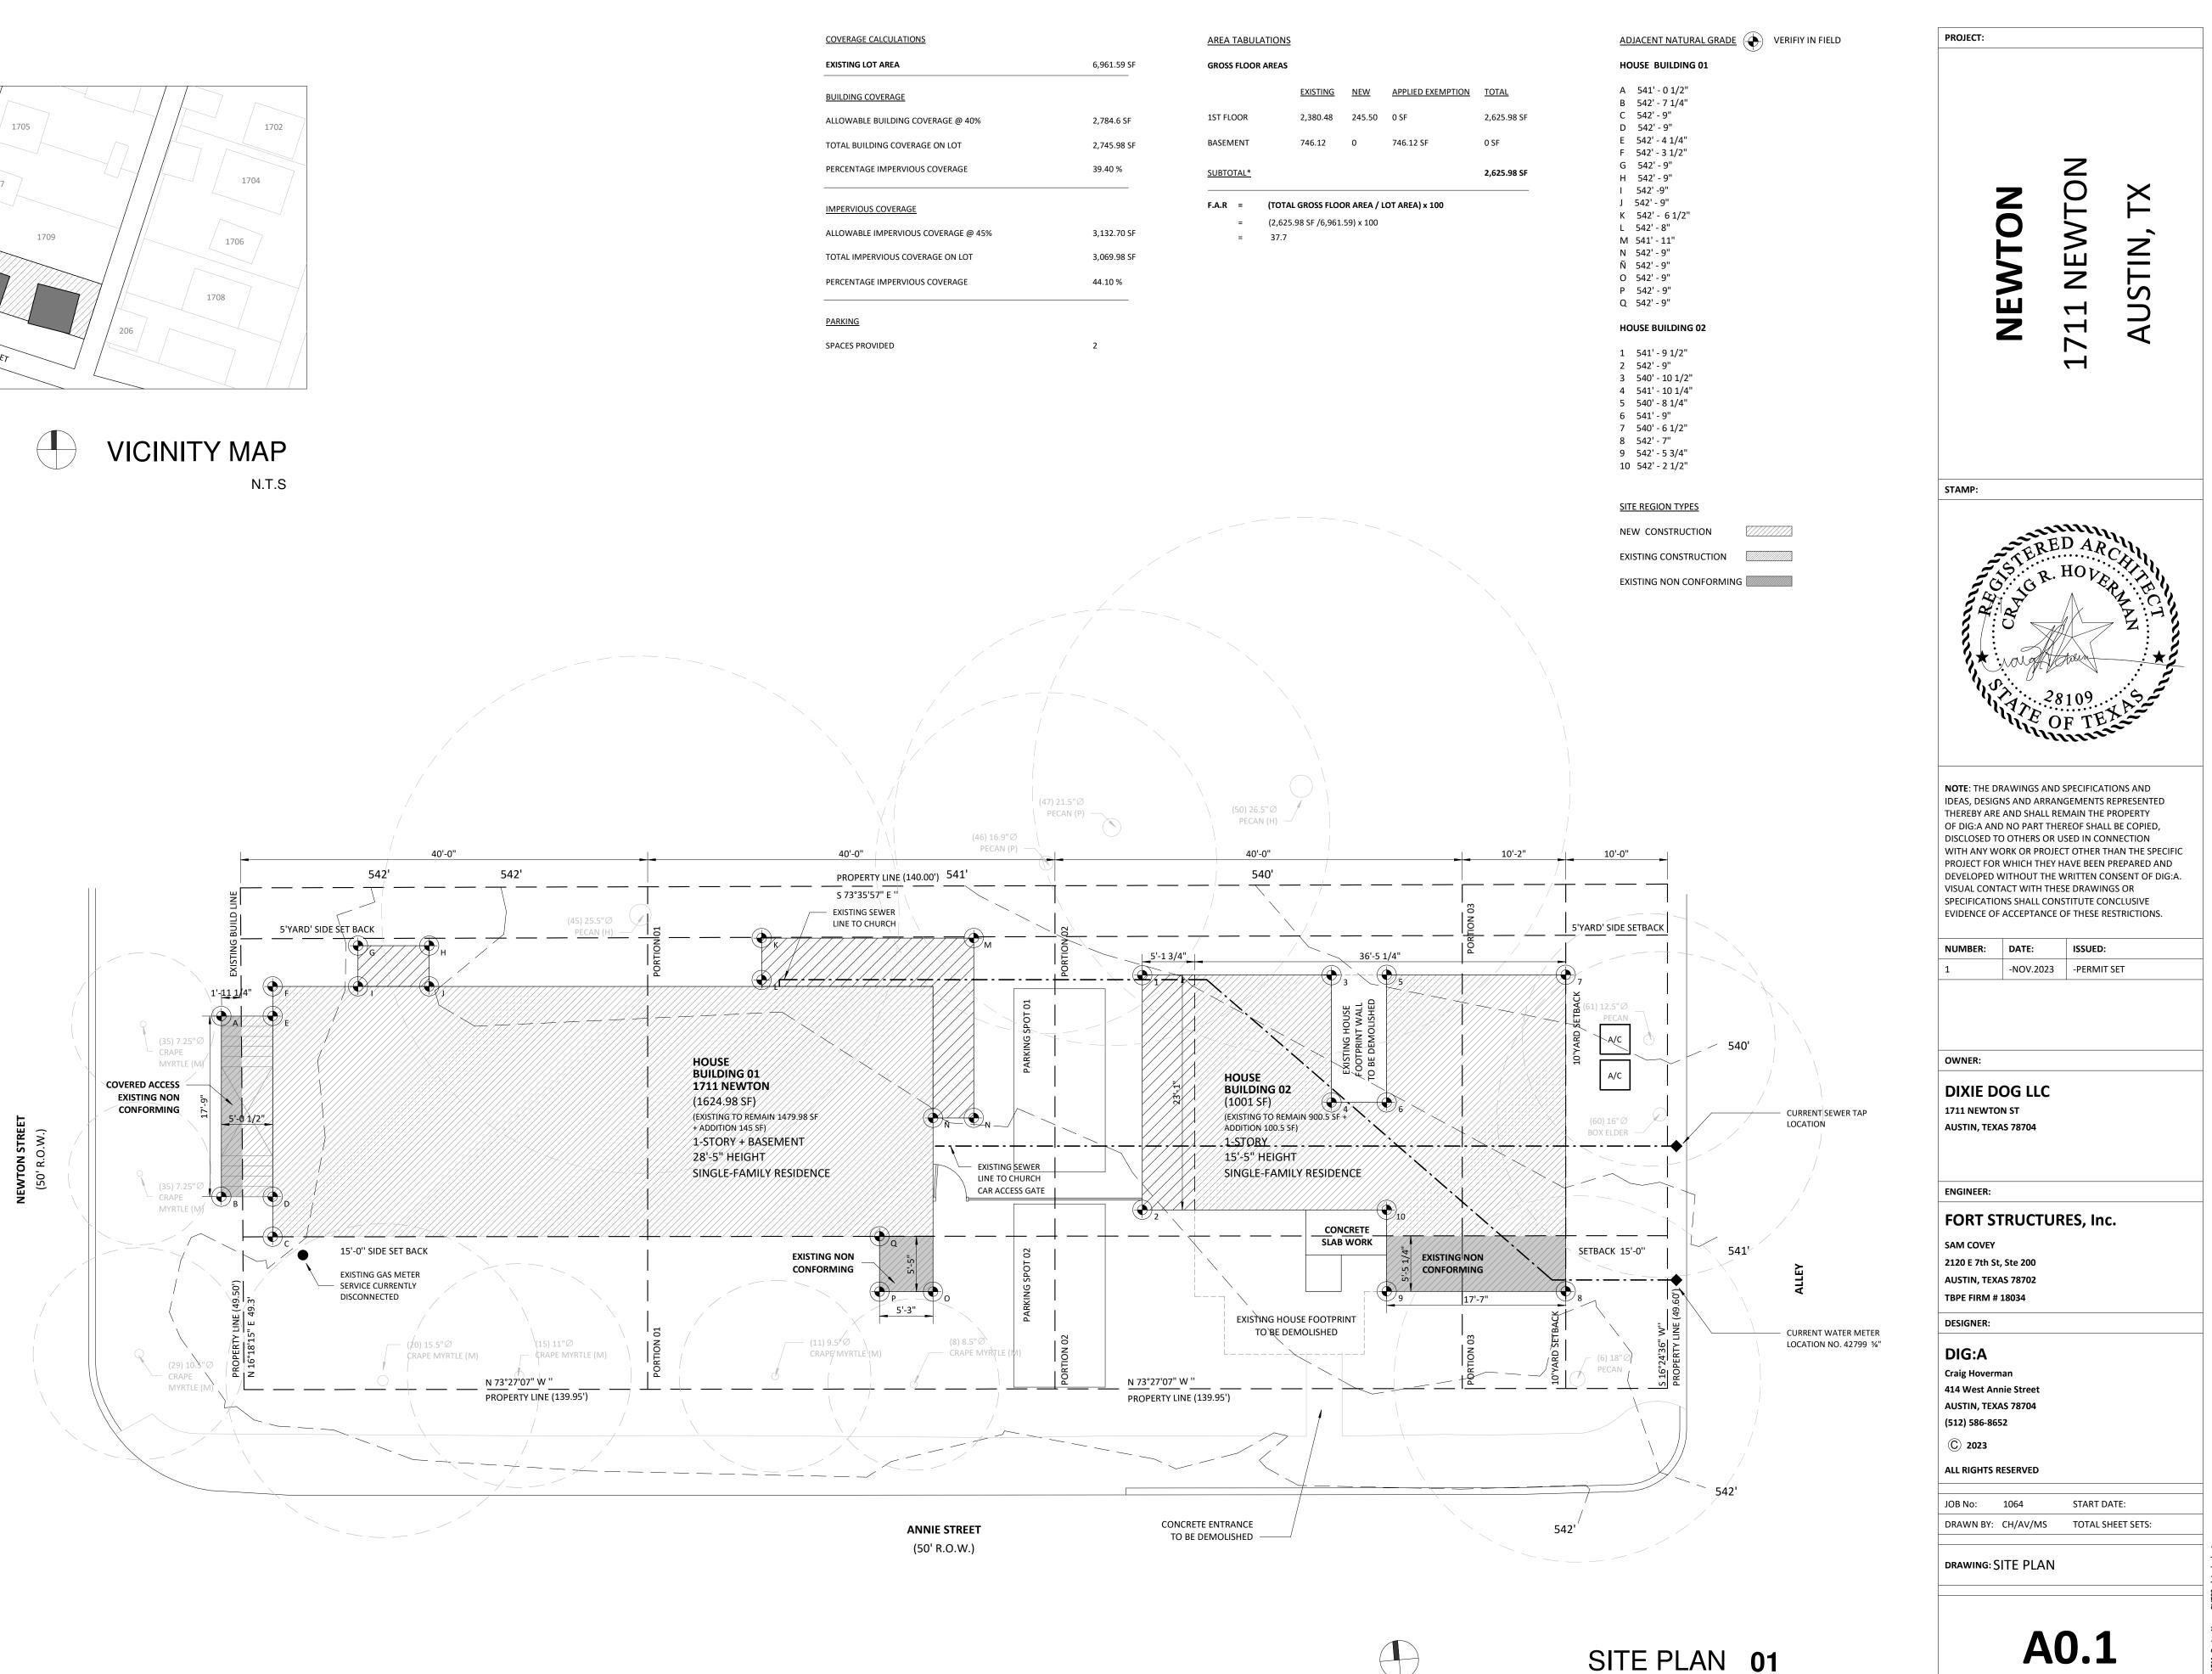

		EXISTING	<u>NEW</u>	APPLIED EXEMPTION	<u>TOTAL</u>
ST FLOOI	R	2,380.48	245.50	0 SF	2,625.98 SF
ASEMEN	IT	746.12	0	746.12 SF	0 SF
JBTOTAI	<u>L*</u>				2,625.98 SF
A.R =	(тот/	AL GROSS FLOC	DR AREA / L	OT AREA) x 100	
=	(2,62	5.98 SF /6,961.	59) x 100		
_	27 7				

SCALE 1/8" = 1'-0"

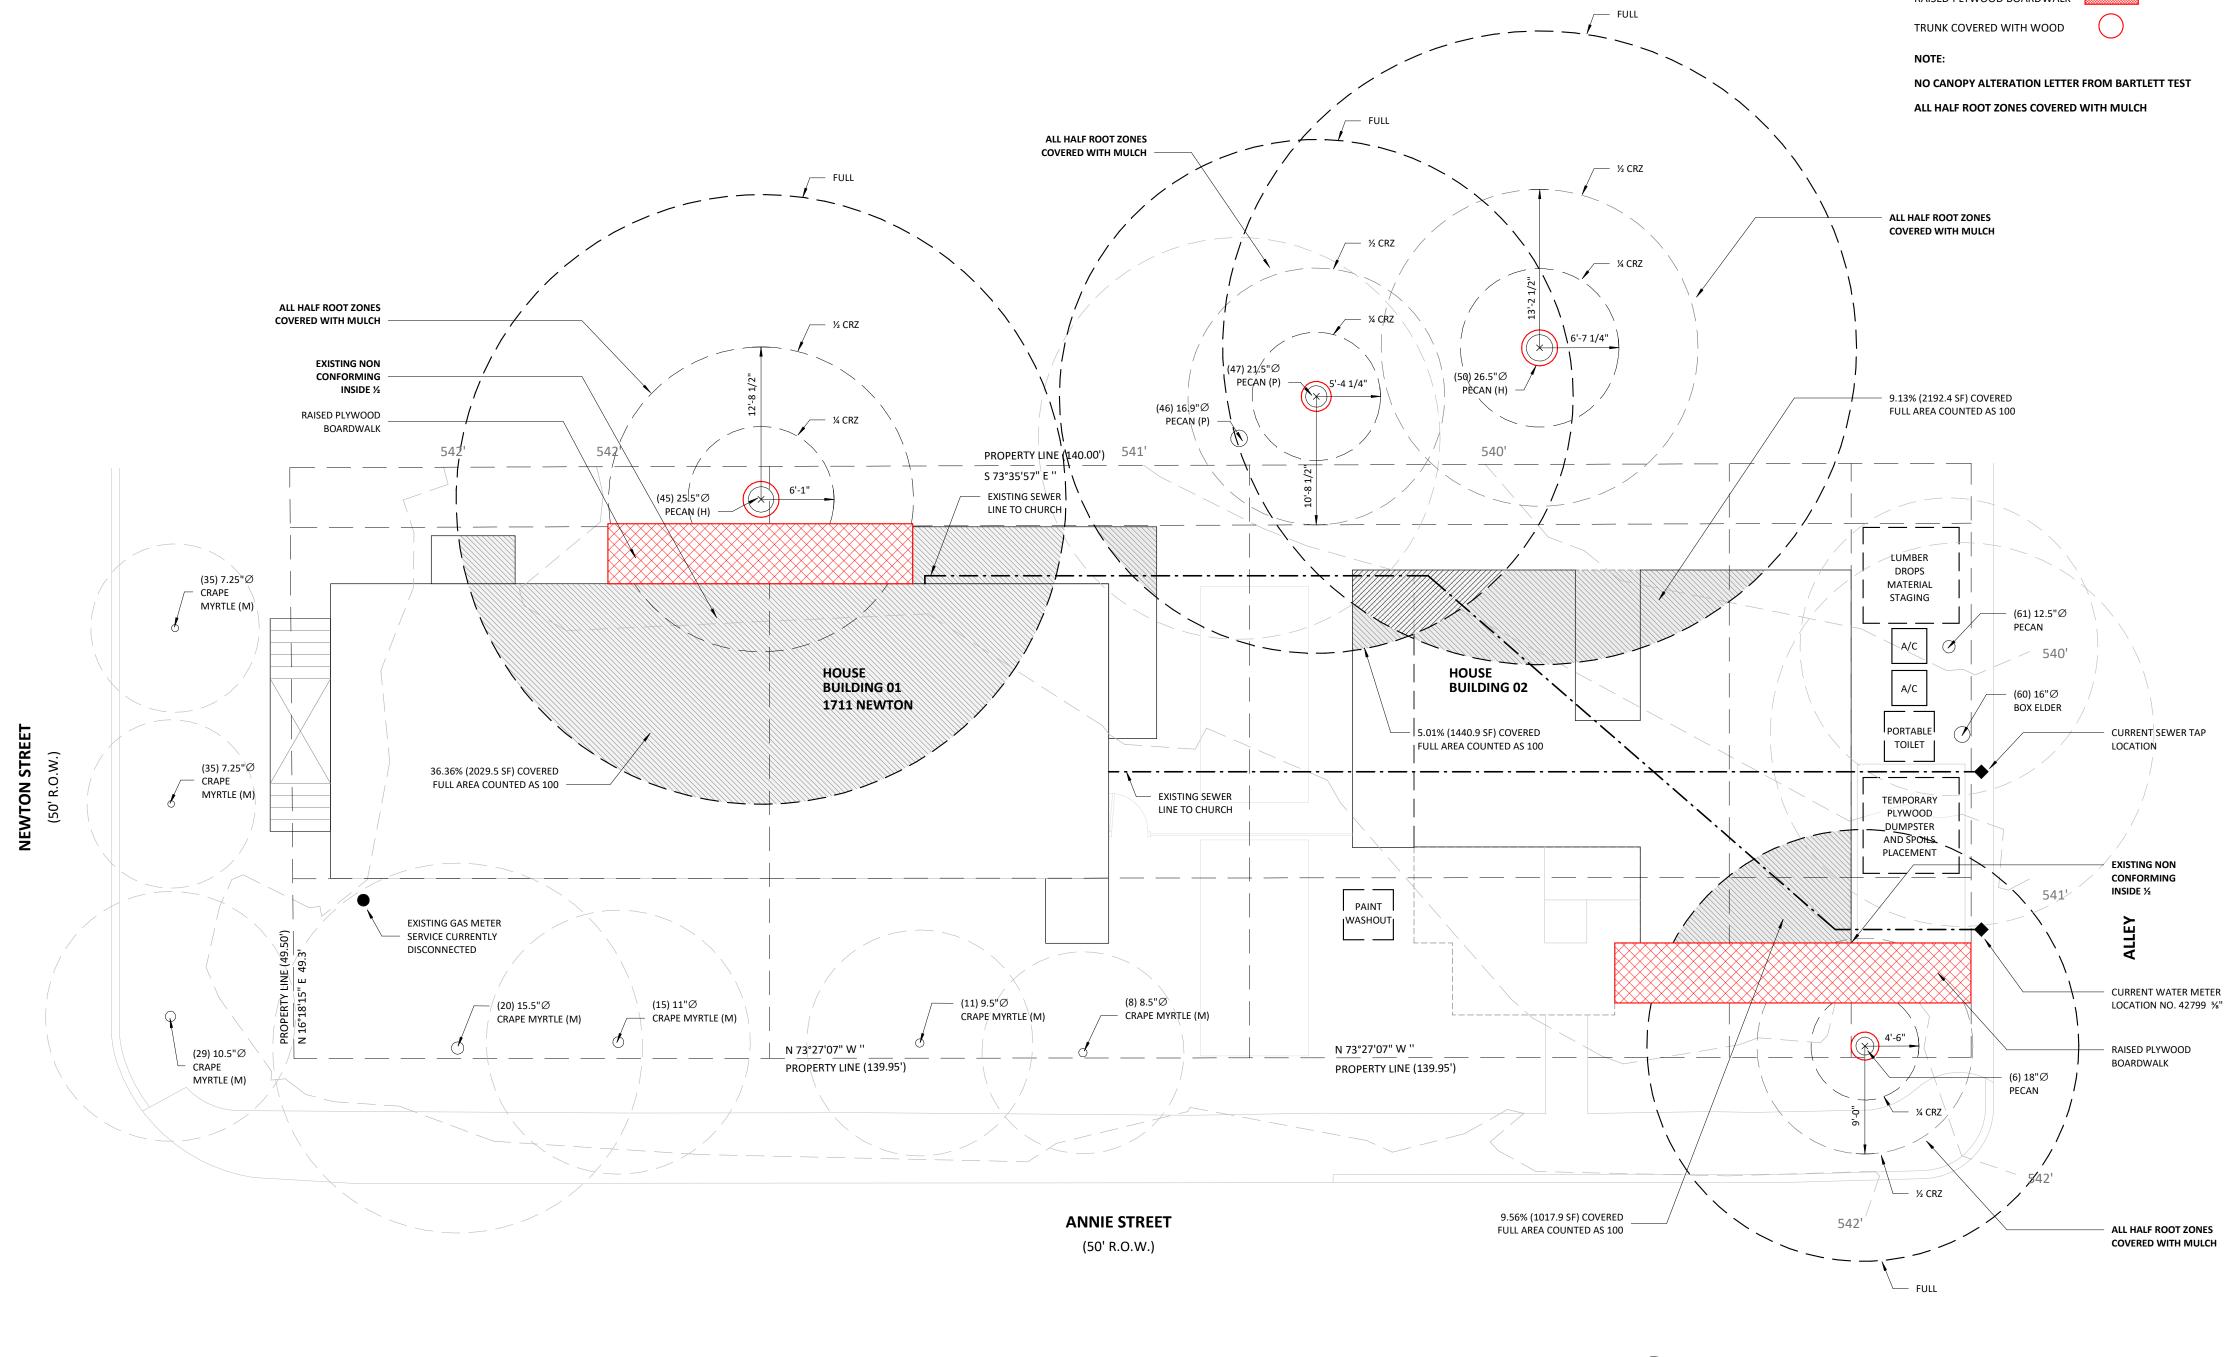

CRZ & STAGING AREA 01


SCALE 1/8" = 1'-0"


PERCENTAGE OF CRZ COVERAGE

PERCENTAGE OF CRZ COVERAGE							
(45) 25.5"Ø PECAN (H)							
CRZ	2029.5 SF						
<u>COVERAGE</u>	738.07 SF						
PERCENTAGE COVERAGE	36.36 %						
(47) 21.5"Ø PECAN (P)							
<u>CRZ</u>	1440.9 SF						
<u>COVERAGE</u>	72.30 SF						
PERCENTAGE COVERAGE	5.01 %						
(50) 26.5"Ø PECAN (H)							
CRZ	2192.4 SF						
<u>COVERAGE</u>	200.29 SF						
PERCENTAGE COVERAGE	9.13 %						
(6) 18"Ø PECAN							
CRZ	1017.9 SF						
COVERAGE	97.38 SF						
PERCENTAGE COVERAGE	9.56 %						

ROOT ZONE PROTECTION FENCE

RAISED PLYWOOD BOARDWALK

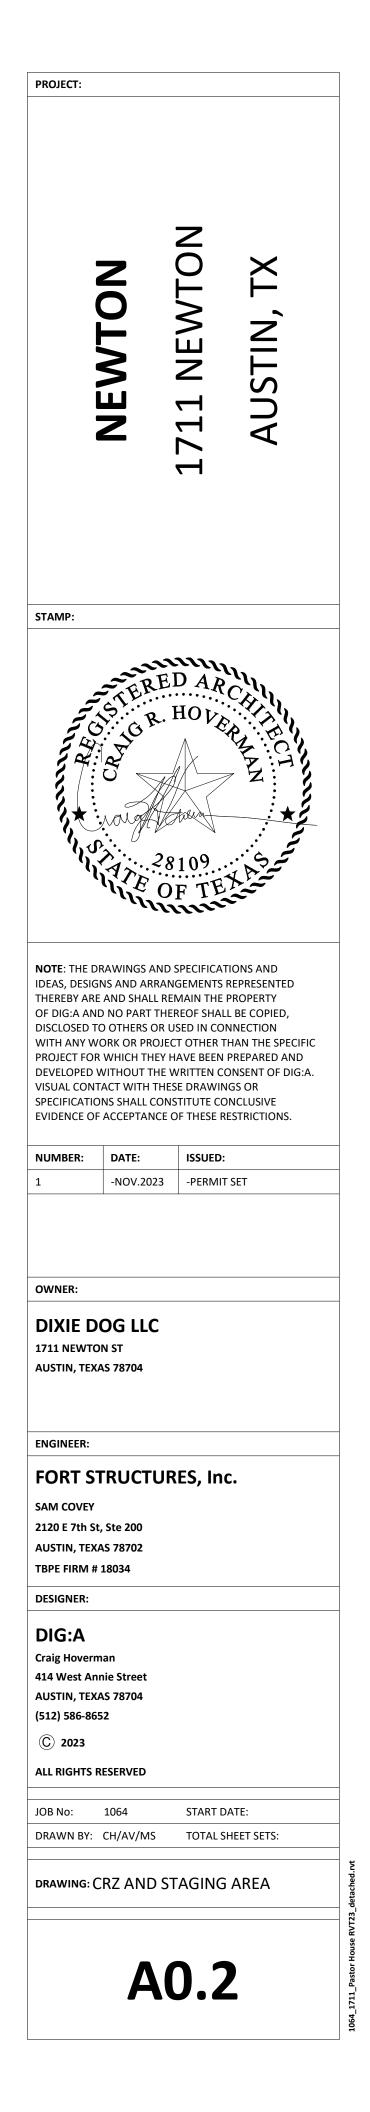

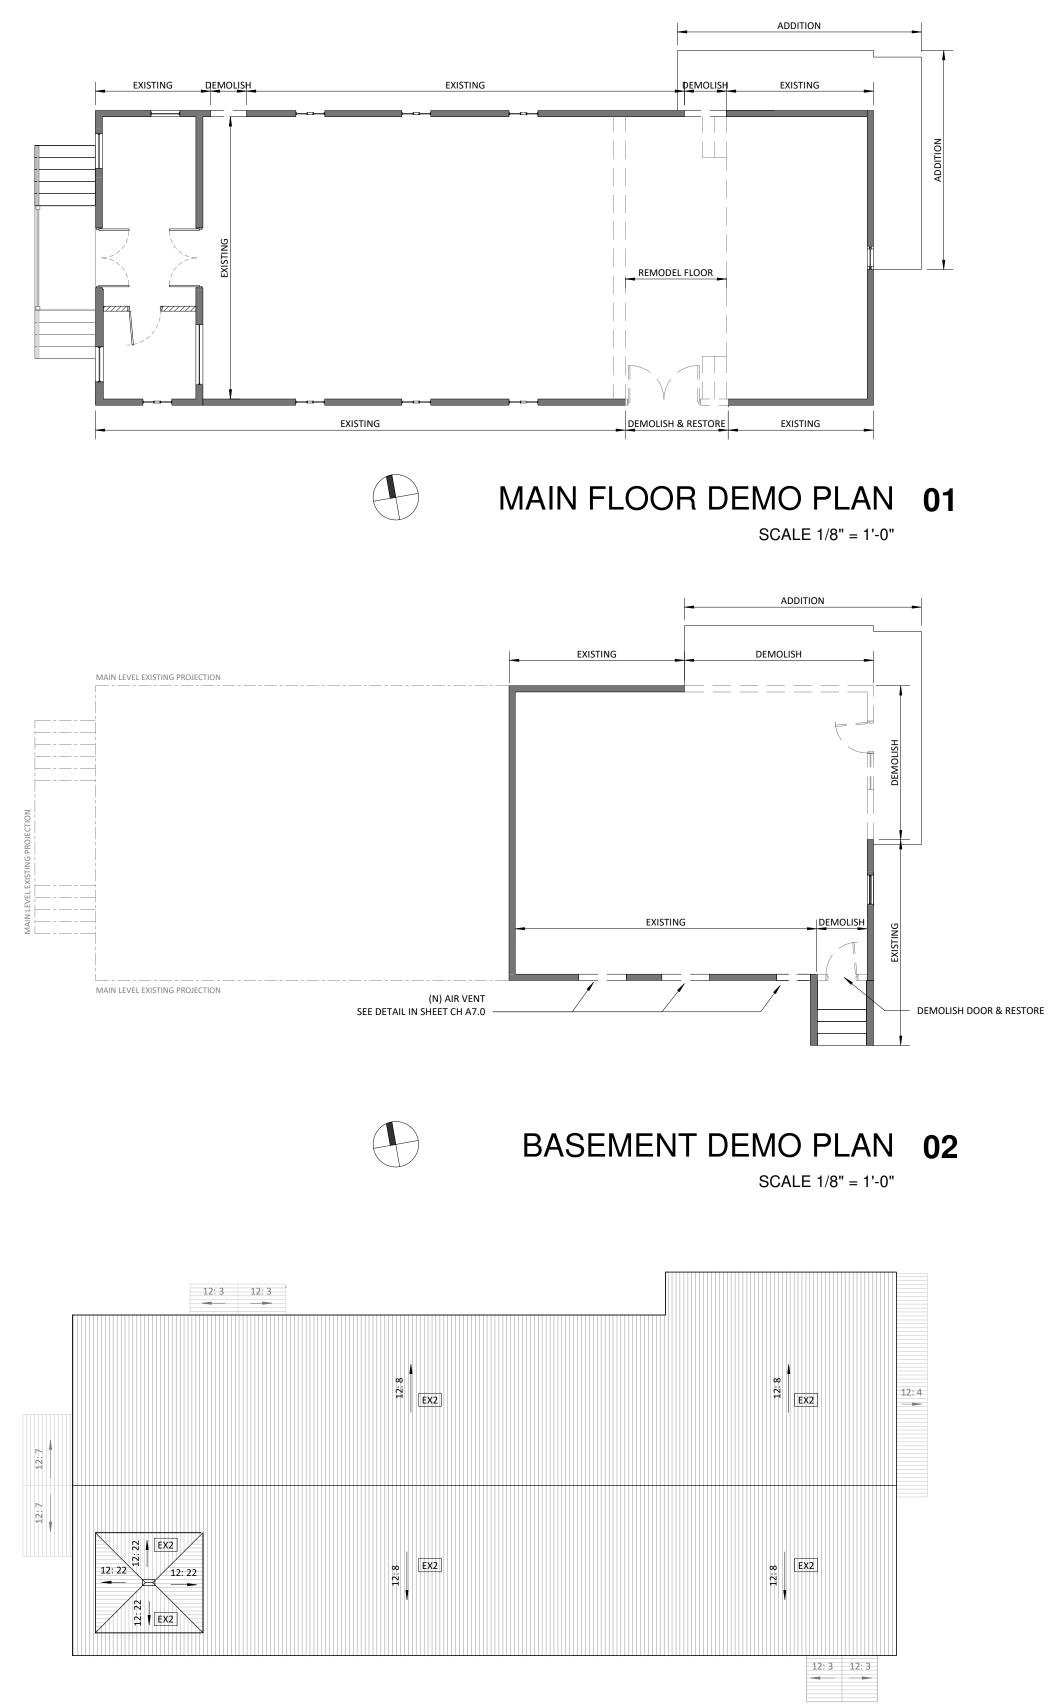

DEMOLITION NOTES

PROTECT AREAS ADJACENT TO DEMOLITION ZONES.

SEAL OFF AREAS OF DEMOLITION FROM MAIN STRUCTURE.

CAREFULLY STORE ALL MATERIALS NOTED FOR RE-USE.

REMOVE ALL DEBRIS FROM SITE.

PROTECT AREAS EXPOSED BY DEMOLITION FROM WEATHER IMPACT.

REMOVE ALL PLUMBING FIXTURES

REMOVE ALL DUCTING

REMOVE ALL DOORS - INTERIOR AND EXTERIOR

REMOVE ALL WINDOWS

REMOVE ALL FLOORING THROUGHOUT - WOOD & TILE

LOCATE ALL UTILITIES INCLUDING BUT NOT LIMITED TO GAS, ELECTRIC, PLUMBING, HVAC AND SECURITY SYSTEM -IDENTIFY UTILITIES COORDINATION PRIOR TO CONSTRUCTION

REMOVE ROOFING MATERIAL AND ROOF JOISTS. BRACE AS NEEDED

REMOVE WALL WHERE NOTED TO ACCOMMODATE NEW WINDOWS AND DOORS AS SHOWN

DEMOLITION PARTITION TYPES

EXISTING WALL	
NEW WALL	
DEMOLITION WALL	

FINISH SCHEDULE ROOF

TYPE DESCRIPTION EX2 STANDING SEAM METAL




PROJECT:								
NEWTON	1711 NEWTON	AUSTIN, TX						
STAMP:								
CINERED AR CINER. HOVE CINER. HOVE Z Z Z Z Z Z Z Z Z Z Z Z Z Z Z Z Z Z Z								
NOTE: THE DRAWINGS AND SPECIFICATIONS AND IDEAS, DESIGNS AND ARRANGEMENTS REPRESENTED THEREBY ARE AND SHALL REMAIN THE PROPERTY OF DIG:A AND NO PART THEREOF SHALL BE COPIED, DISCLOSED TO OTHERS OR USED IN CONNECTION WITH ANY WORK OR PROJECT OTHER THAN THE SPECIFIC PROJECT FOR WHICH THEY HAVE BEEN PREPARED AND DEVELOPED WITHOUT THE WRITTEN CONSENT OF DIG:A. VISUAL CONTACT WITH THESE DRAWINGS OR SPECIFICATIONS SHALL CONSTITUTE CONCLUSIVE EVIDENCE OF ACCEPTANCE OF THESE RESTRICTIONS.								
NUMBER: DATE:	ISSUED							
1 -NOV.2023 -PERMIT SET OWNER: DIXIE DOG LLC 1711 NEWTON ST AUSTIN, TEXAS 78704								
ENGINEER:	TURES							
SAM COVEY 2120 E 7th St, Ste 200 AUSTIN, TEXAS 78702 TBPE FIRM # 18034 DESIGNER:	2120 E 7th St, Ste 200 AUSTIN, TEXAS 78702							
DIG:A								
Craig Hoverman 414 West Annie Street AUSTIN, TEXAS 78704 (512) 586-8652	t							
© 2023 ALL RIGHTS RESERVED)							

JOB No: 1076 START DATE: DRAWN BY: CH/AV/MS TOTAL SHEET SETS:

DRAWING: DEMO AND ROOF PLAN BLDG 01

CH A1.0

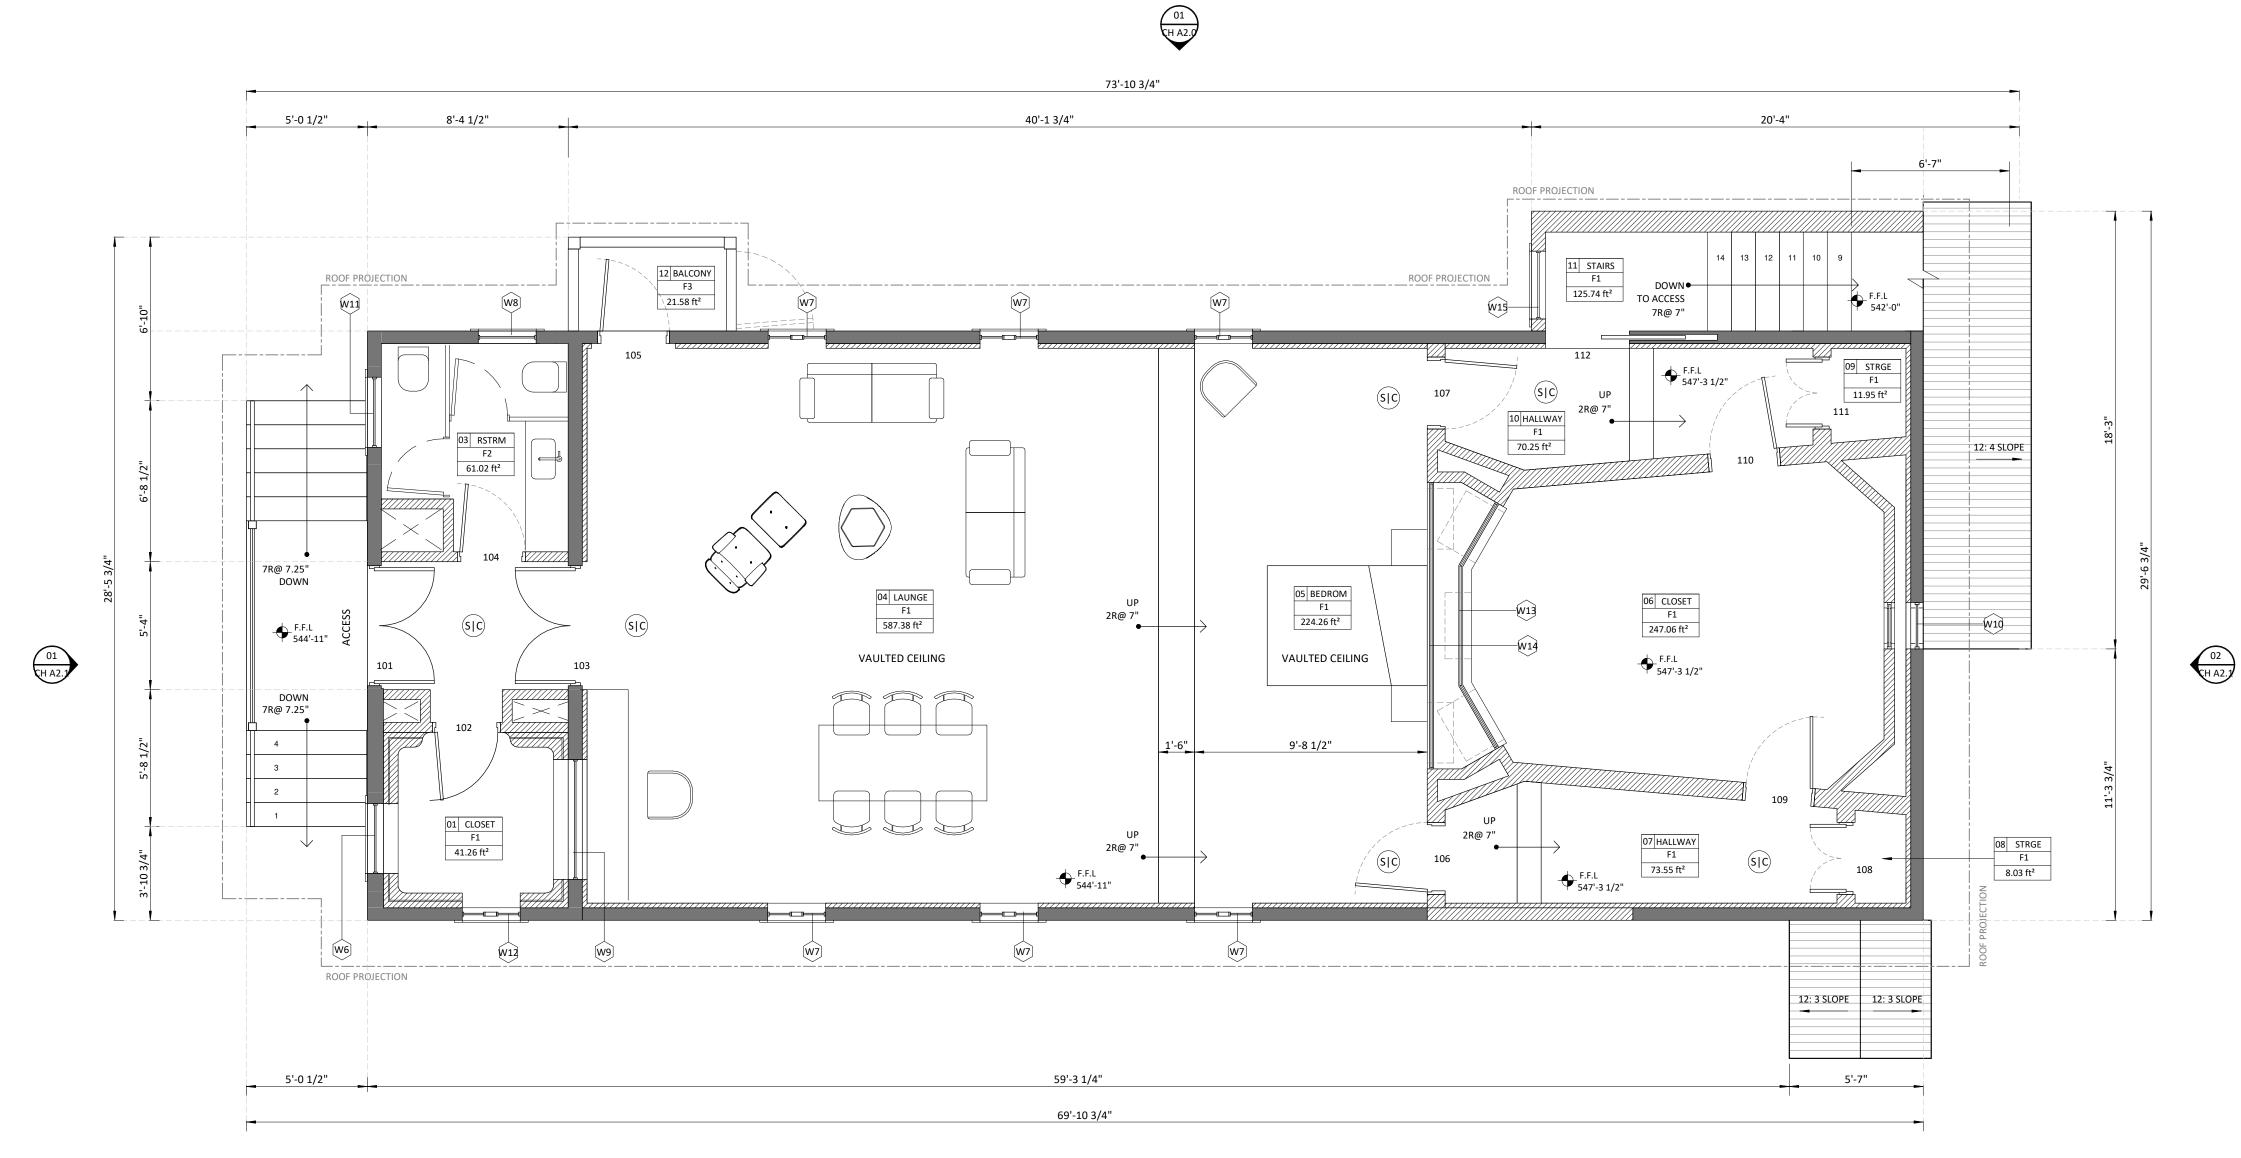





MAIN FLOOR PLAN 01 SCALE 1/4" = 1'-0"

ARCHITECTURAL SYMBOLS

ALL DIMENSIONS RELEVANT TO FRAMING ARE TO FACE OF STUD UNLESS NOTED OTHERWISE

DOORS INDICATED THUS: XXX

REFER DOOR SCHEDULE

DOOR SWINGS AS INDICATED ON PLAN

WINDOWS INDICATED THUS: XX REFER FOR WINDOW SCHEDULE

XXX ROOM FINISH INDICATED THUS: SCHEDULE THIS PAGE

SMOKE AND CARBON DETECTORS (S|C)

ALL FLOOR MATERIAL DIFFERENTIALS TO BE 1/2" MAX

FINISH SCHEDULE NOTES

OWNER AND ARCHITECT TO REVIEW COLOR & MATERIAL SAMPLES PRIOR TO FINAL INSTALL

DETAIL NUMBER SHEET NUMBER

00 A.00 SECTION NUMBER 00

SHEET NUMBER LEVEL NUMBER

+ XXXX FIN.FL 00' 00" SHEET NUMBER ELEVATION NUMBER

ROOM NUMBER FINISH FLOOR FOOT SQUARE



FINISH SCHEDULE WALLS

- TYPE DESCRIPTION
- EX1 WOODEN SIDING (EXISTING) AND MATCH EXISTING EX3 EXTERIOR CONCRETE EXPOSED
- W1 PAINT WHITE
- W3 WOONDEN DOUGLAS FIR 3/4" THICKNESS
- WOONDEN DOUGLAS FIR 3/4" THICKNESS W4
- W5 PAINT WHITE DRYWALL W6 WOONDEN DOUGLAS FIR 3/4" THICKNESS
- FINISH SCHEDULE CEILING

- TYPE DESCRIPTION C1.1 DRYWALL DROPPED 1/2" THICKNESS
- C2.1 WOONDEN DOUGLAS FIR 3/4" THICKNESS

FINISH SCHEDULE FLOOR

- TYPE DESCRIPTION
- F1 WOODEN FLOOR 3/4" THINKNESS
- F2 TILE 6X6"
- CONCRETE SLAB F3
- CONCRETE EXPOSED F4

FINISH SCHEDULE ROOF

TYPE DESCRIPTION

EX2 STANDING SEAM METAL

PROJECT: Ζ NEWTO \mathbf{X} NEWTON TIN Ś Τ -4 -STAMP: WE OF TEX NOTE: THE DRAWINGS AND SPECIFICATIONS AND IDEAS, DESIGNS AND ARRANGEMENTS REPRESENTED THEREBY ARE AND SHALL REMAIN THE PROPERTY OF DIG:A AND NO PART THEREOF SHALL BE COPIED, DISCLOSED TO OTHERS OR USED IN CONNECTION WITH ANY WORK OR PROJECT OTHER THAN THE SPECIFIC PROJECT FOR WHICH THEY HAVE BEEN PREPARED AND DEVELOPED WITHOUT THE WRITTEN CONSENT OF DIG:A. VISUAL CONTACT WITH THESE DRAWINGS OR SPECIFICATIONS SHALL CONSTITUTE CONCLUSIVE EVIDENCE OF ACCEPTANCE OF THESE RESTRICTIONS. ISSUED: NUMBER: DATE: -NOV.2023 -PERMIT SET OWNER: DIXIE DOG LLC AUSTIN, TEXAS 78704 ENGINEER: FORT STRUCTURES

1711 NEWTON ST

SAM COVEY 2120 E 7th St, Ste 200 AUSTIN, TEXAS 78702 TBPE FIRM # 18034

DESIGNER:

DIG:A Craig Hoverman

cruig novermun						
414 West Annie Street						
AUSTIN, TEXAS 78704						
(512) 586-8652						
© 2023						


ALL RIGHTS RESERVED

JOB No:	1076	START DATE:
DRAWN BY:	CH/AV/MS	TOTAL SHEET SETS:

DRAWING: FLOOR PLAN BLDG 01





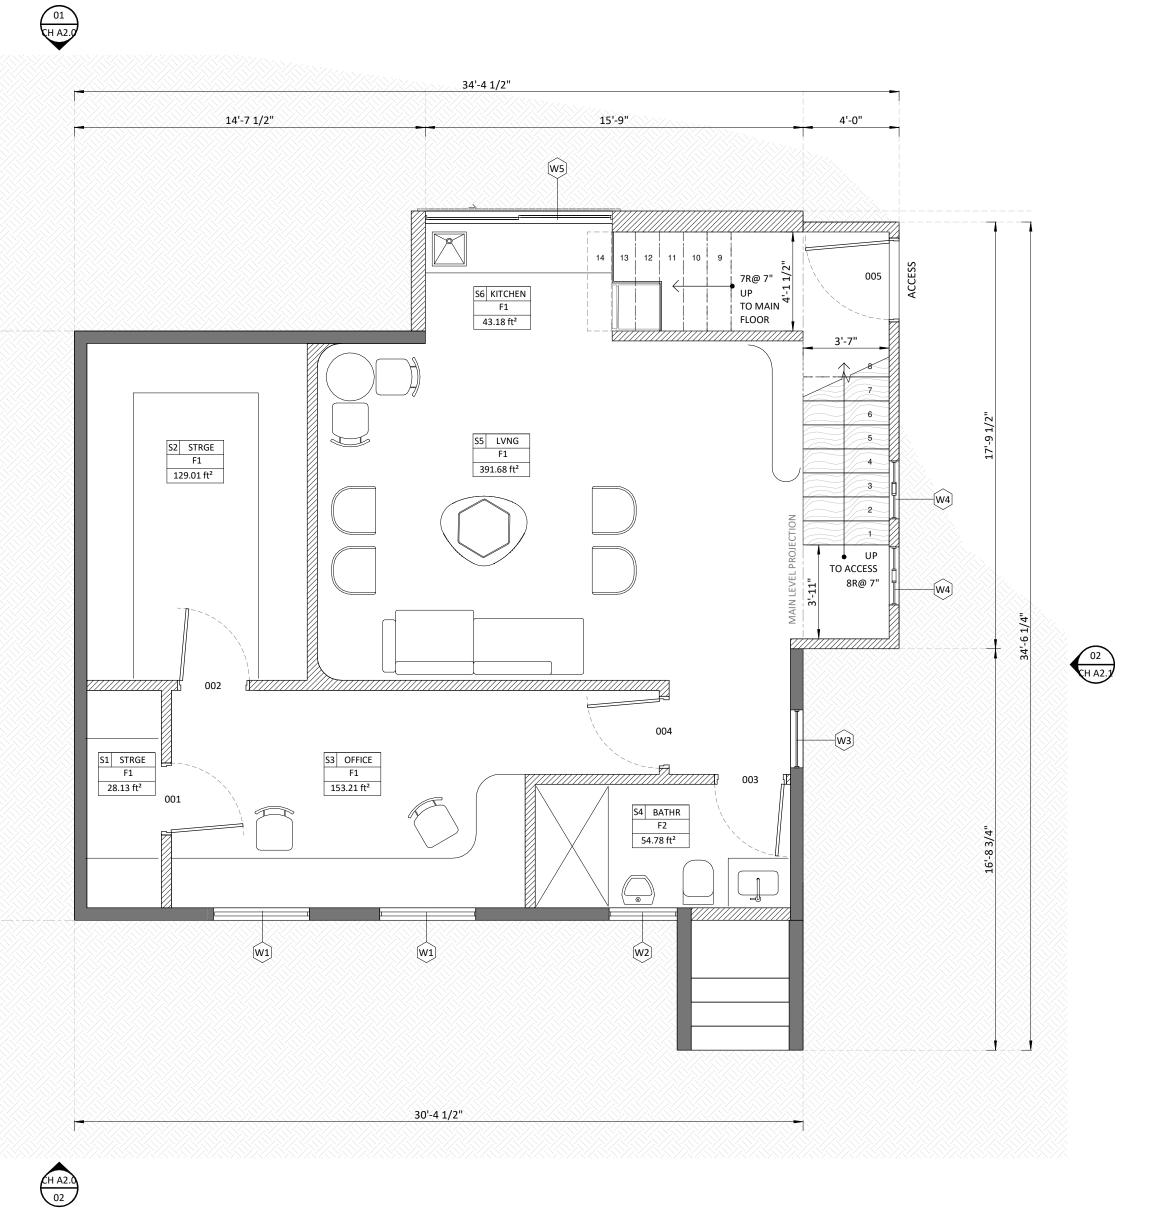



ARCHITECTURAL SYMBOLS

ALL DIMENSIONS RELEVANT TO FRAMING ARE TO FACE OF STUD UNLESS NOTED OTHERWISE

DOORS INDICATED THUS: XXX

REFER DOOR SCHEDULE

DOOR SWINGS AS INDICATED ON PLAN

WINDOWS INDICATED THUS: XX REFER FOR WINDOW SCHEDULE

ROOM FINISH INDICATED THUS: SCHEDULE THIS PAGE

SMOKE AND CARBON DETECTORS

ALL FLOOR MATERIAL DIFFERENTIALS TO BE 1/2" MAX

FINISH SCHEDULE NOTES

OWNER AND ARCHITECT TO REVIEW COLOR & MATERIAL SAMPLES PRIOR TO FINAL INSTALL

DETAIL NUMBER SHEET NUMBER

00 A.00 SECTION NUMBER 00

SHEET NUMBER LEVEL NUMBER

+ XXXX FIN.FL 00' 00" SHEET NUMBER ELEVATION NUMBER

ROOM NUMBER FINISH FLOOR FOOT SQUARE



FINISH SCHEDULE WALLS

- TYPE DESCRIPTION
- EX1 WOODEN SIDING (EXISTING) AND MATCH EXISTING EX3 EXTERIOR CONCRETE EXPOSED
- W1 PAINT WHITE
- WOONDEN DOUGLAS FIR 3/4" THICKNESS W3
- W4 WOONDEN DOUGLAS FIR 3/4" THICKNESS
- W5 PAINT WHITE DRYWALL
- W6 WOONDEN DOUGLAS FIR 3/4" THICKNESS

FINISH SCHEDULE CEILING

- TYPE DESCRIPTION
- C1.1 DRYWALL DROPPED 1/2" THICKNESS C2.1 WOONDEN DOUGLAS FIR 3/4" THICKNESS

FINISH SCHEDULE FLOOR

- TYPE DESCRIPTION
- WOODEN FLOOR 3/4" THINKNESS F1
- F2 TILE 6X6"
- CONCRETE SLAB F3
- F4 CONCRETE EXPOSED

FINISH SCHEDULE ROOF

TYPE DESCRIPTION

EX2 STANDING SEAM METAL

PROJECT: Ζ NEWTO \mathbf{X} NEWTON **N** Ś Τ -4 -STAMP: ~~~~ When TEAM NOTE: THE DRAWINGS AND SPECIFICATIONS AND IDEAS, DESIGNS AND ARRANGEMENTS REPRESENTED THEREBY ARE AND SHALL REMAIN THE PROPERTY OF DIG:A AND NO PART THEREOF SHALL BE COPIED, DISCLOSED TO OTHERS OR USED IN CONNECTION WITH ANY WORK OR PROJECT OTHER THAN THE SPECIFIC PROJECT FOR WHICH THEY HAVE BEEN PREPARED AND DEVELOPED WITHOUT THE WRITTEN CONSENT OF DIG:A. VISUAL CONTACT WITH THESE DRAWINGS OR SPECIFICATIONS SHALL CONSTITUTE CONCLUSIVE EVIDENCE OF ACCEPTANCE OF THESE RESTRICTIONS. NUMBER: DATE: ISSUED: -NOV.2023 -PERMIT SET OWNER: DIXIE DOG LLC 1711 NEWTON ST AUSTIN, TEXAS 78704 ENGINEER:

FORT STRUCTURES

SAM COVEY 2120 E 7th St, Ste 200 AUSTIN, TEXAS 78702 TBPE FIRM # 18034

DESIGNER:

DIG:A Craig Hoverman 414 West Annie Street AUSTIN, TEXAS 78704 (512) 586-8652

C 2023

ALL RIGHTS RESERVED

JOB No:	1076	START DATE:
DRAWN BY:	CH/AV/MS	TOTAL SHEET SETS:

CH A1.2

DRAWING: FLOOR PLAN BLDG 01



SOUTH ELEVATION 02 SCALE 1/4" = 1'-0"

ARCHITECTURAL SYMBOLS

ALL DIMENSIONS RELEVANT TO FRAMING ARE TO FACE OF STUD UNLESS NOTED OTHERWISE

DOORS INDICATED THUS: XXX REFER DOOR SCHEDULE

DOOR SWINGS AS INDICATED ON PLAN

WINDOWS INDICATED THUS: (XX) REFER FOR WINDOW SCHEDULE

ROOM FINISH INDICATED THUS: (XXX) SCHEDULE THIS PAGE

SMOKE AND CARBON DETECTORS (S|C)

ALL FLOOR MATERIAL DIFFERENTIALS TO BE 1/2" MAX

FINISH SCHEDULE NOTES

OWNER AND ARCHITECT TO REVIEW COLOR & MATERIAL SAMPLES PRIOR TO FINAL INSTALL

00

DETAIL NUMBER SHEET NUMBER

A.00 SECTION NUMBER 00 SHEET NUMBER

LEVEL NUMBER

SHEET NUMBER ELEVATION NUMBER

ROOM NUMBER FINISH FLOOR FOOT SQUARE



+ XXXX FIN.FL 00' 00"

FINISH SCHEDULE WALLS

- TYPE DESCRIPTION
- EX1 WOODEN SIDING (EXISTING) AND MATCH EXISTING EXTERIOR CONCRETE EXPOSED EX3
- W1 PAINT WHITE
- WOONDEN DOUGLAS FIR 3/4" THICKNESS W3
- W4 WOONDEN DOUGLAS FIR 3/4" THICKNESS
- W5 PAINT WHITE DRYWALL W6 WOONDEN DOUGLAS FIR 3/4" THICKNESS

FINISH SCHEDULE CEILING

- TYPE DESCRIPTION
- C1.1 DRYWALL DROPPED 1/2" THICKNESS C2.1 WOONDEN DOUGLAS FIR 3/4" THICKNESS

FINISH SCHEDULE FLOOR

- TYPE DESCRIPTION
- WOODEN FLOOR 3/4" THINKNESS F1
- F2 TILE 6X6"
- F3 CONCRETE SLAB
- CONCRETE EXPOSED F4

FINISH SCHEDULE ROOF

TYPE DESCRIPTION

EX2 STANDING SEAM METAL

Ζ NEWTO X NEWTON Z Ś Τ Τ 4 -STAMP: ~~~~ WWW IE A OF ' **NOTE:** THE DRAWINGS AND SPECIFICATIONS AND IDEAS, DESIGNS AND ARRANGEMENTS REPRESENTED THEREBY ARE AND SHALL REMAIN THE PROPERTY OF DIG:A AND NO PART THEREOF SHALL BE COPIED, DISCLOSED TO OTHERS OR USED IN CONNECTION WITH ANY WORK OR PROJECT OTHER THAN THE SPECIFIC PROJECT FOR WHICH THEY HAVE BEEN PREPARED AND DEVELOPED WITHOUT THE WRITTEN CONSENT OF DIG:A. VISUAL CONTACT WITH THESE DRAWINGS OR SPECIFICATIONS SHALL CONSTITUTE CONCLUSIVE EVIDENCE OF ACCEPTANCE OF THESE RESTRICTIONS. ISSUED: NUMBER: DATE: -NOV.2023 -PERMIT SET OWNER: DIXIE DOG LLC

PROJECT:

ENGINEER:

1711 NEWTON ST AUSTIN, TEXAS 78704

FORT STRUCTURES

SAM COVEY 2120 E 7th St, Ste 200 AUSTIN, TEXAS 78702 TBPE FIRM # 18034

DESIGNER:

DIG:A

Craig Hoverman 414 West Annie Street AUSTIN, TEXAS 78704 (512) 586-8652 C 2023

ALL RIGHTS RESERVED

START DATE: JOB No: 1076 DRAWN BY: CH/AV/MS TOTAL SHEET SETS:

DRAWING: EXTERIOR ELEVATIONS BLDG 01



ENTRY L. CEILING HEIGHT 548'-8" 🔶

MAIN AREA F.F.L 544'-11"

ENTRY LANDING F.F.L

(E) BASEMENT F.F.L 539'-8 1/4"


BASEMENT F.F.L 537'-4" •


CEILING F.F.L 555'-7 1/4"

ENTRY L. CEILING HEIGHT 548'-8"

MAIN AREA F.F.L 544'-11"

ENTRY LANDING F.F.L 542'-0"

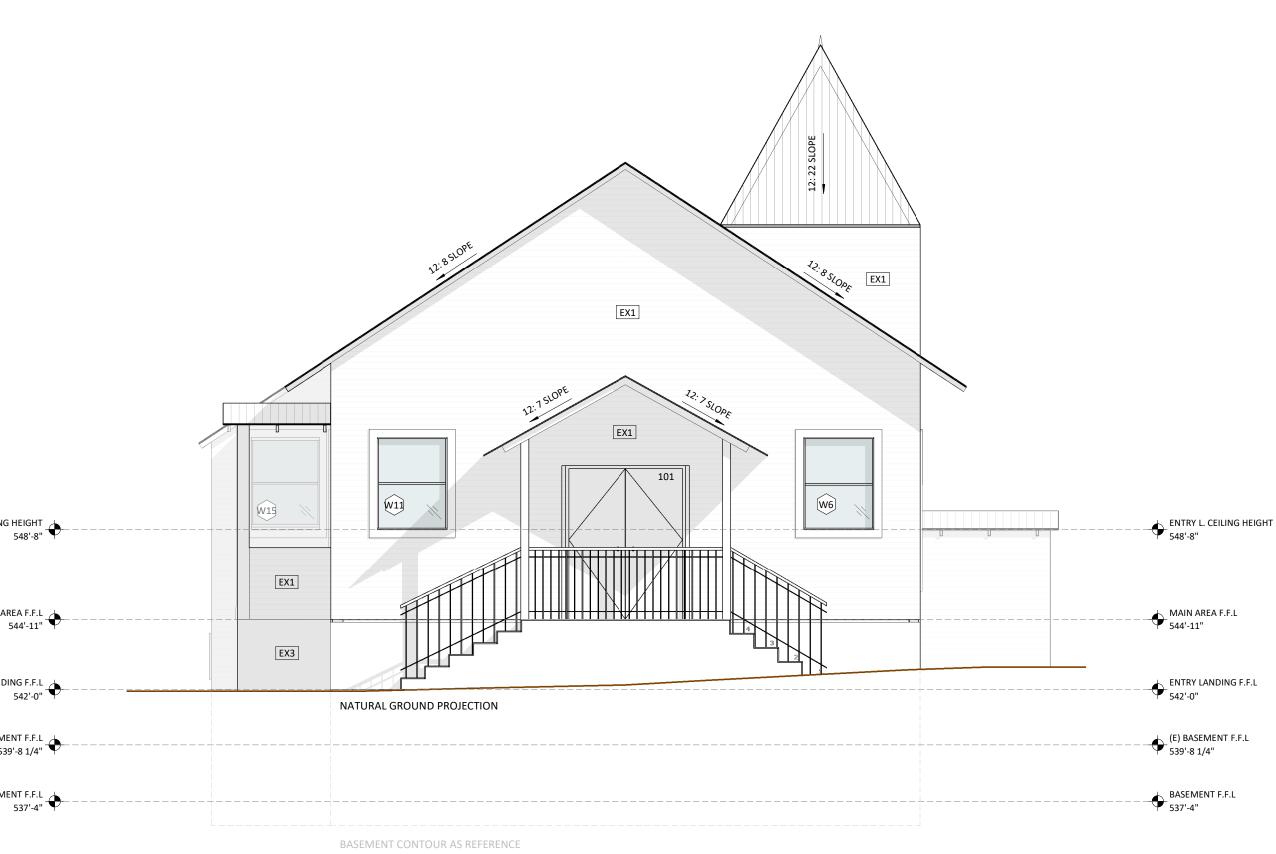

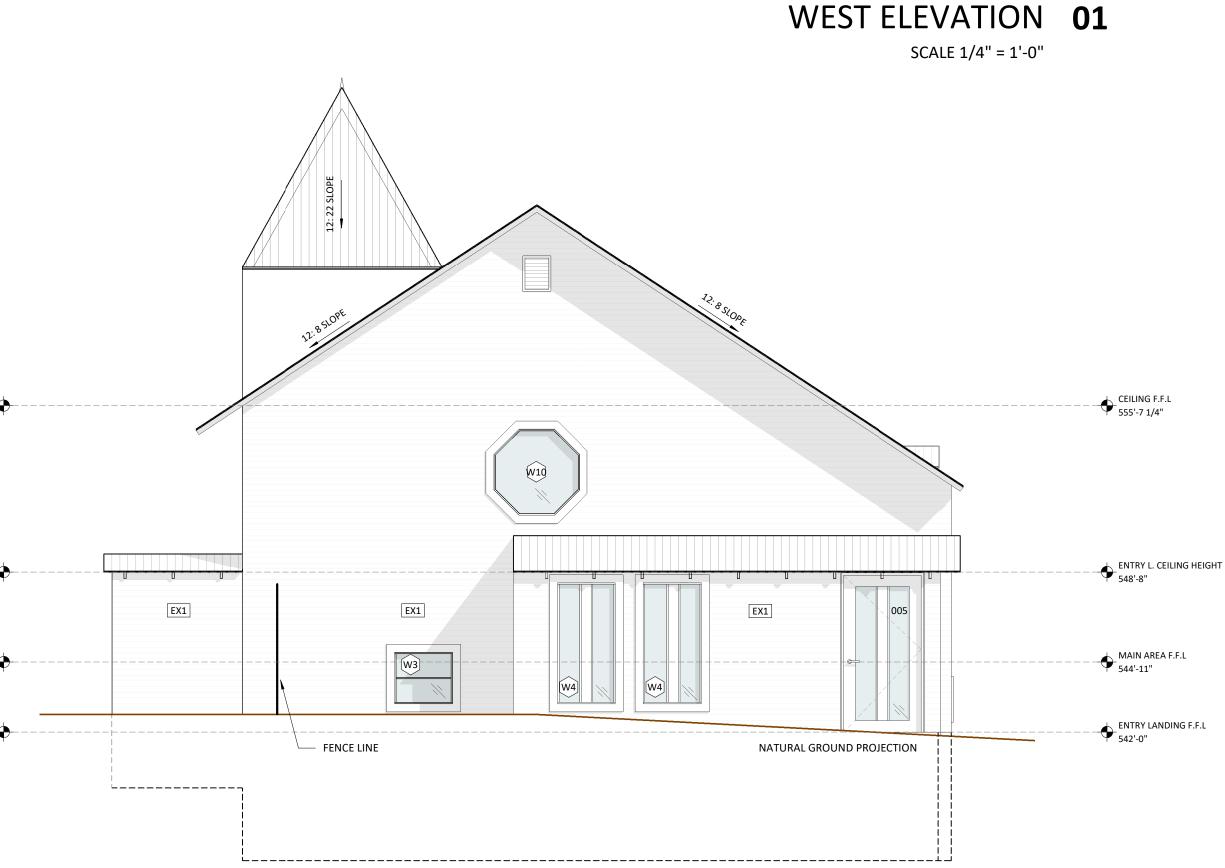

BASEMENT CONTOUR AS REFERENCE



ARCHITECTURAL SYMBOLS

ALL DIMENSIONS RELEVANT TO FRAMING ARE TO FACE OF STUD UNLESS NOTED OTHERWISE

DOORS INDICATED THUS: XXX

REFER DOOR SCHEDULE

DOOR SWINGS AS INDICATED ON PLAN

WINDOWS INDICATED THUS: XX REFER FOR WINDOW SCHEDULE

ROOM FINISH INDICATED THUS: (XXX) SCHEDULE THIS PAGE

SMOKE AND CARBON DETECTORS (S|C)

ALL FLOOR MATERIAL DIFFERENTIALS TO BE 1/2" MAX

FINISH SCHEDULE NOTES

OWNER AND ARCHITECT TO REVIEW COLOR & MATERIAL SAMPLES PRIOR TO FINAL INSTALL

00

DETAIL NUMBER SHEET NUMBER

LEVEL NUMBER

A.00 SECTION NUMBER 00 SHEET NUMBER

+ XXXX FIN.FL 00' 00" SHEET NUMBER ELEVATION NUMBER

ROOM NUMBER FINISH FLOOR FOOT SQUARE



FINISH SCHEDULE WALLS

- TYPE DESCRIPTION
- EX1 WOODEN SIDING (EXISTING) AND MATCH EXISTING
- EX3 EXTERIOR CONCRETE EXPOSED
- W1 PAINT WHITE
- WOONDEN DOUGLAS FIR 3/4" THICKNESS W3 WOONDEN DOUGLAS FIR 3/4" THICKNESS W4
- W5 PAINT WHITE DRYWALL
- W6 WOONDEN DOUGLAS FIR 3/4" THICKNESS

FINISH SCHEDULE CEILING

- TYPE DESCRIPTION
- C1.1 DRYWALL DROPPED 1/2" THICKNESS C2.1 WOONDEN DOUGLAS FIR 3/4" THICKNESS

FINISH SCHEDULE FLOOR

- TYPE DESCRIPTION
- WOODEN FLOOR 3/4" THINKNESS F1
- F2 TILE 6X6"
- CONCRETE SLAB F3 CONCRETE EXPOSED F4

FINISH SCHEDULE ROOF

- TYPE DESCRIPTION
- EX2 STANDING SEAM METAL

Ζ NEWTO X NEWTON **N** Ś Τ Τ 4 \sim Η STAMP: ~~~~ WIN OF THAT NOTE: THE DRAWINGS AND SPECIFICATIONS AND IDEAS, DESIGNS AND ARRANGEMENTS REPRESENTED THEREBY ARE AND SHALL REMAIN THE PROPERTY OF DIG:A AND NO PART THEREOF SHALL BE COPIED, DISCLOSED TO OTHERS OR USED IN CONNECTION WITH ANY WORK OR PROJECT OTHER THAN THE SPECIFIC PROJECT FOR WHICH THEY HAVE BEEN PREPARED AND DEVELOPED WITHOUT THE WRITTEN CONSENT OF DIG:A. VISUAL CONTACT WITH THESE DRAWINGS OR SPECIFICATIONS SHALL CONSTITUTE CONCLUSIVE EVIDENCE OF ACCEPTANCE OF THESE RESTRICTIONS. ISSUED: NUMBER: DATE: -NOV.2023 -PERMIT SET OWNER: DIXIE DOG LLC 1711 NEWTON ST

PROJECT:

ENGINEER:

FORT STRUCTURES

SAM COVEY 2120 E 7th St, Ste 200 AUSTIN, TEXAS 78702 TBPE FIRM # 18034

AUSTIN, TEXAS 78704

DESIGNER:

DIG:A


Craig Hoverman 414 West Annie Street AUSTIN, TEXAS 78704 (512) 586-8652 © 2023


ALL RIGHTS RESERVED


START DATE: JOB No: 1076 DRAWN BY: CH/AV/MS TOTAL SHEET SETS:


DRAWING: EXTERIOR ELEVATIONS BLDG 01




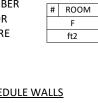

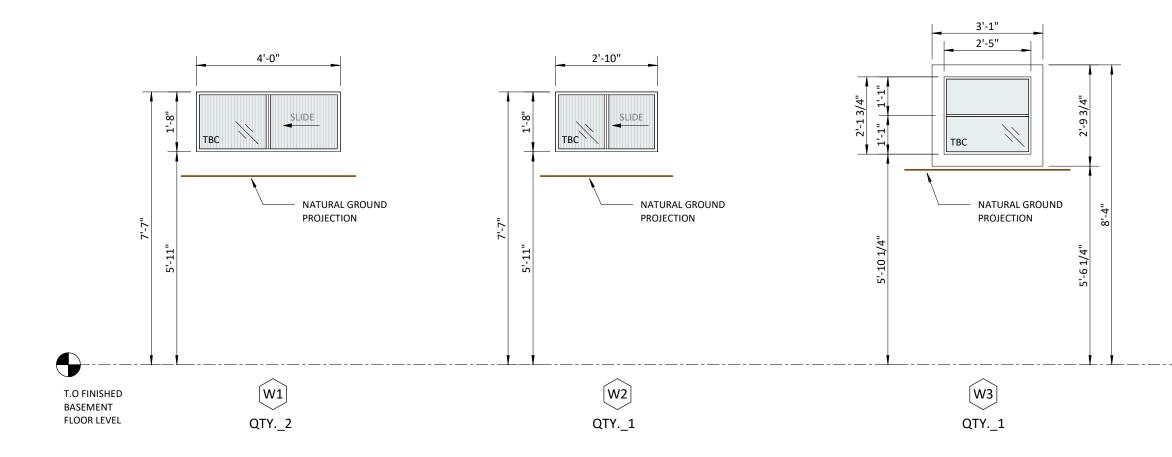


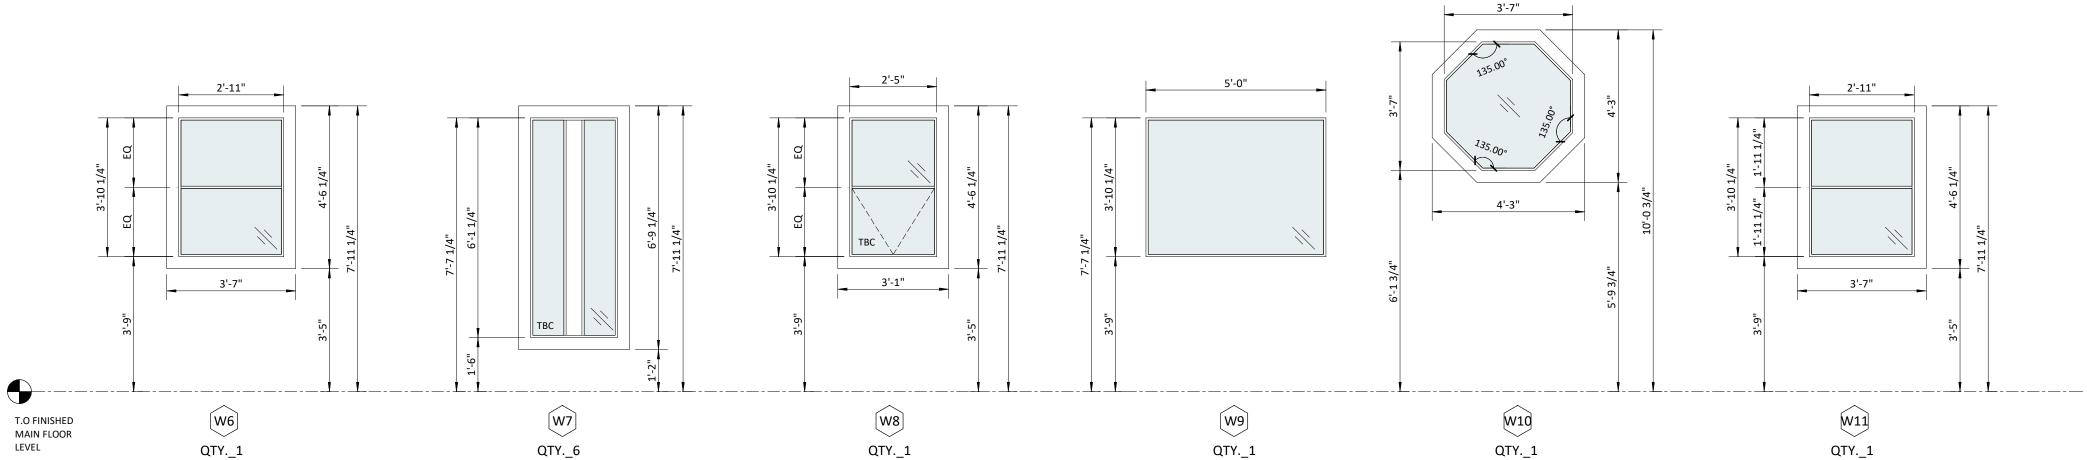

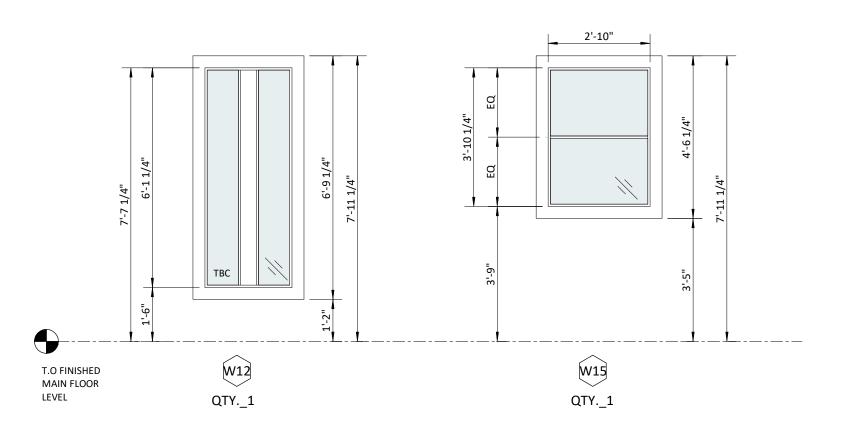

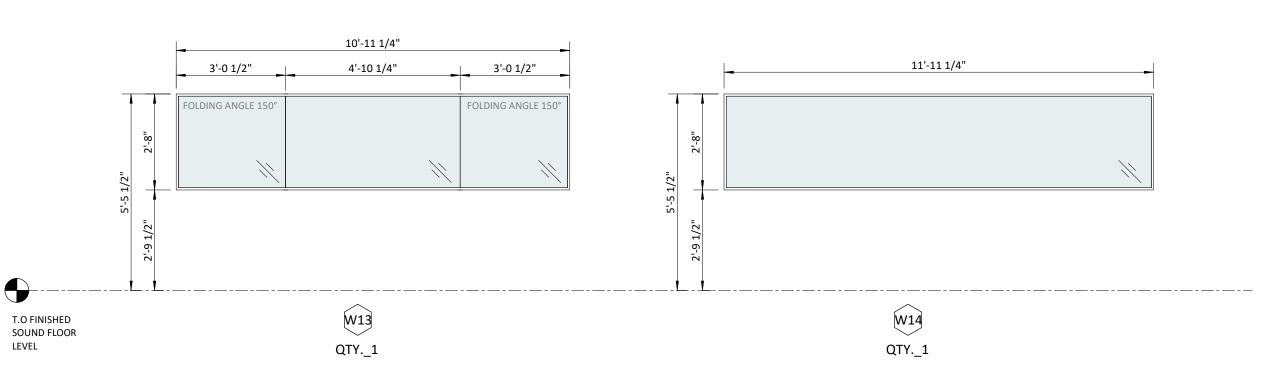

WINDOW SCHEDULE														
ТҮРЕ	AMOUNT	WIDTH	HEIGHT	TYPE WINDOW	GLAZING	FRAME	COLOR	MFGR	U-FACTOR	SHGC	HEAD DETAIL	JAMB DETAIL	SILL DETAIL	NOTES
W1	2	4'-0"	1'-8"	SLIDING	DUAL GLAZED	ALUMINUM	BLACK ANODIZED	FLEETWOOD & MILGARD	XX/XX	XX/XX	XX/XX	XX/XX	XX/XX	(1) PANEL OPERABLE (1) PANEL FIXED W/ METAL BARS. TEMPERED PER CODE. REEDED GLAZED
/2	1	2'-10"	1'-8"	SLIDING	DUAL GLAZED	ALUMINUM	BLACK ANODIZED	FLEETWOOD & MILGARD	XX/XX	XX/XX	XX/XX	XX/XX	XX/XX	(1) PANEL OPERABLE (1) PANEL FIXED W/ METAL BARS. TEMPERED PER CODE. REEDED GLAZED
/3	1	2'-5"	2'-1 3/4"	EXISTING	EXISTING	EXISTING	EXISTING	EXISTING	XX/XX	XX/XX	XX/XX	XX/XX	XX/XX	EXISTING WINDOW TO BE REFURBISH. TEMPERED PER CODE.
/4	2	2'-5"	5'-0 1/2"	FIXED	DUAL GLAZED	ALUMINUM	BLACK ANODIZED	FLEETWOOD & MILGARD	XX/XX	XX/XX	XX/XX	XX/XX	XX/XX	(2) PANEL FIXED. TEMPERED PER CODE.
/5	1	7'-9 1/2"	1'-3"	SLIDING	DUAL GLAZED	ALUMINUM	BLACK ANODIZED	FLEETWOOD & MILGARD	XX/XX	XX/XX	XX/XX	XX/XX	XX/XX	(1) PANEL OPERABLE. TEMPERED PER CODE.
6	1	2'-11"	3'-10 1/4"	EXISTING	ACCUSTIC DOUBLE GLASS	EXISTING	EXISTING	EXISTING	XX/XX	XX/XX	XX/XX	XX/XX	XX/XX	EXISTING WINDOW TO BE REFURBISH. ACCUSTIC SPEC
7	6	2'-5"	6'-1 1/4"	EXISTING	EXISTING	EXISTING	EXISTING	EXISTING	XX/XX	XX/XX	XX/XX	XX/XX	XX/XX	EXISTING WINDOW TO BE REFURBISH. TEMPERED PER CODE.
8	1	2'-5"	3'-10 1/4"	CASEMENT	DUAL GLAZED	ALUMINUM	BLACK ANODIZED	FLEETWOOD & MILGARD	XX/XX	XX/XX	XX/XX	XX/XX	XX/XX	(1) PANEL OPERABLE (1) PANEL FIXED. TEMPERED PER CODE.
9	1	5'-0"	3'-10 1/4"	FIXED	ACCUSTIC DOUBLE GLASS	ALUMINUM	BLACK ANODIZED	FLEETWOOD & MILGARD	XX/XX	XX/XX	XX/XX	XX/XX	XX/XX	(1) PANEL FIXED. ACCUSTIC SPEC
10	1	3'-7"	3'-7"	FIXED	ACCUSTIC DOUBLE GLASS	ALUMINUM	BLACK ANODIZED	FLEETWOOD & MILGARD	XX/XX	XX/XX	XX/XX	XX/XX	XX/XX	(1) PANEL FIXED. ACCUSTIC SPEC
11	1	2'-11"	3'-10 1/4"	EXISTING	EXISTING	EXISTING	EXISTING	EXISTING	XX/XX	XX/XX	XX/XX	XX/XX	XX/XX	EXISTING WINDOW TO BE REFURBISH. TEMPERED PER CODE.
/12	1	2'-5"	6'-1 1/4"	EXISTING	ACCUSTIC DOUBLE GLASS	EXISTING	EXISTING	EXISTING	XX/XX	XX/XX	XX/XX	XX/XX	XX/XX	EXISTING WINDOW TO BE REFURBISH. ACCUSTIC SPEC
13	1	10'-11 1/4"	2'-8"	FIXED	ACCUSTIC DOUBLE GLASS	ALUMINUM	BLACK ANODIZED	FLEETWOOD & MILGARD	XX/XX	XX/XX	XX/XX	XX/XX	XX/XX	(1) PANEL FIXED
14	1	11'-11 1/4"	2'-8"	FIXED	ACCUSTIC DOUBLE GLASS	ALUMINUM	BLACK ANODIZED	FLEETWOOD & MILGARD	XX/XX	XX/XX	XX/XX	XX/XX	XX/XX	(1) PANEL FIXED
/15	1	2'-10"	3'-10 1/4"	FIXED	DUAL GLAZED	ALUMINUM	BLACK ANODIZED	FLEETWOOD & MILGARD	XX/XX	XX/XX	XX/XX	XX/XX	XX/XX	(1) PANEL FIXED

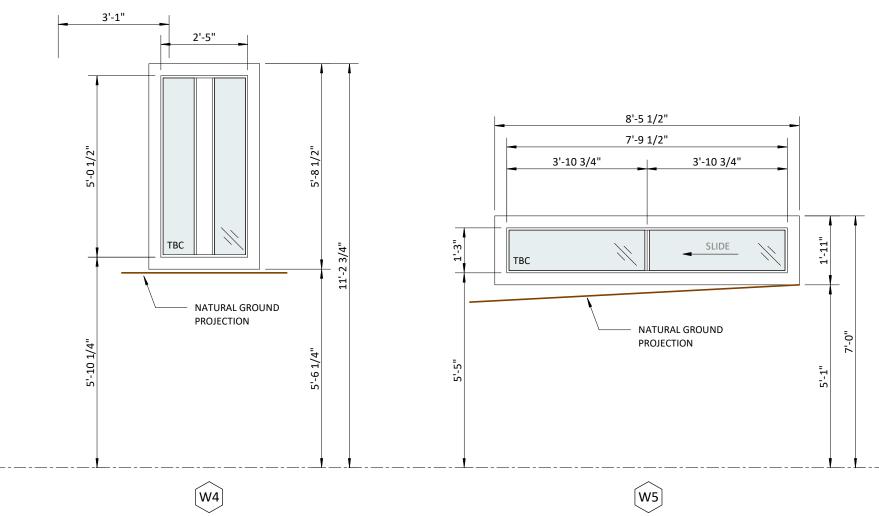







NOTES WINDOW SCHEDULE

FIELD VERIFY ALL WINDOW DIMENSIONS

ALL ALUMINUM FRAMES TO BE ACCORDING TO SCHEDULE SPEC. DOOR SWINGS AS INDICATED ON PLAN

ALL OPERABLE WINDOWS TO HAVE SCREENS

ALL INSULATED GLASS TO BE LOW-E

FENESTRATIONS MUST HAVE TEMPORARY AND PERMANENT LABELS.

GLAZING IN THE FOLLOWING LOCATIONS SHALL BE SAFETY GLAZING CONFORMING TO THE HUMAN IMPACT LOADS OF SECTION R308.3 (SEE EXCEPTIONS) (R308.4):

- FIXED AND OPERABLE PANELS OF SWINGING SLIDING Α. AND BIFOLD DOOR ASSEMBLIES
- B. GLAZING IN AN INDIVIDUAL FIXED OR OPERABLE PANEL ADJACENT TO A DOOR WHERE THE NEAREST VERTICAL EDGE IS WITHIN A 24" ARC OF THE DOOR IN A CLOSED POSITION AND WHOSE BOTTOM EDGE IS LESS THAN 60" ABOVE THE FLOOR OR WALKING SURFACE.
- GLAZING IN AN INDIVIDUAL FIXED OR OPERABLE PANEL C. THAT MEETS ALL OF THE FOLLOWING CONDITIONS
 - EXPOSED AREA OF AN INDIVIDUAL PANE • GREATER THAN 9 SQUARE FEET.
 - BOTTOM EDGE LESS THAT 18" ABOVE FLOOR • TOP EDGE GREATER THAN 36" ABOVE THE •
 - FLOOR. ONE OR MORE WALKING SURFACES WITHIN 36" HORIZONTALLY OF THE GLAZING.
- D. GLAZING IN RAILS

GLAZING IN ENCLOSURES FOR OR FACING HOT TUBS, WHIRLPOOLS, SAUNAS, STEAM ROOMS, BATHTUBS AND SHOWERS WHERE TO BOTTOM EDGE OF THE GLAZING IS LESS THAN 60" MEASURED VERTICALLY ABOVE ANY STANDING OR WALKING SURFACE.

F.

Ε.

GLAZING IN FENCES AND WALLS ADJACENT TO INDOOR AND OUTDOOR SWIMMING POOLS, HOT TUBS, AND SPAS WHERE THE BOTTOM EDGE OF THE GLAZING IS LESS THAN 60" ABOVE A WALKING SURFACE AND WITHIN 60" MEASURED HORIZONTALLY MEASURED IN A STRAIGHT LINE OF THE WATERS EDGE.


G.

GLAZING ADJACENT TO STAIRWAYS LANDINGS AND RAMPS WITHIN 36" HORIZONTALLY OF A WALKING SURFACE WHEN THE SURFACE OF THE GLAZING IS LESS THAN 60" ABOVE THE ADJACENT WALKING SURFACE

Н.


GLAZING ADJACENT TO STAIRWAYS WITHIN 60 INCHES HORIZONTALLY OF THE BOTTOM TREAD OF A STAIRWAY IN ANY DIRECTION WHEN THE EXPOSED SURFACE OF THE GLAZING IS LESS THAN 60" ABOVE THE NOSE OF THE TREAD.

	NEWTON	1711 NEWTON	AUSTIN, TX
The All All All All All All All All All Al	ACCER AC	ED AR HOV	CHITECT +
IDEAS, DESI THEREBY AF OF DIG:A AI DISCLOSED WITH ANY N PROJECT FC	GNS AND ARF RE AND SHALL ND NO PART TO OTHERS C WORK OR PRC DR WHICH THI	REMAIN THE THEREOF SHAI OR USED IN CO DJECT OTHER EY HAVE BEEN	REPRESENTED PROPERTY LL BE COPIED, NNECTION THAN THE SPECIFIC PREPARED AND
IDEAS, DESI THEREBY AF OF DIG:A AF DISCLOSED WITH ANY V PROJECT FC DEVELOPEE VISUAL CON SPECIFICAT EVIDENCE C	GNS AND ARF RE AND SHALL ND NO PART TO OTHERS C WORK OR PRC OR WHICH THI OWITHOUT TH NTACT WITH T IONS SHALL C	RANGEMENTS REMAIN THE THEREOF SHAI OR USED IN CO DJECT OTHER T EY HAVE BEEN HE WRITTEN C THESE DRAWIN ONSTITUTE CO CE OF THESE F	REPRESENTED PROPERTY LL BE COPIED, INNECTION THAN THE SPECIFIC PREPARED AND ONSENT OF DIG:A. NGS OR DNCLUSIVE RESTRICTIONS.
IDEAS, DESI THEREBY AF OF DIG:A AN DISCLOSED WITH ANY A PROJECT FO DEVELOPED VISUAL CON SPECIFICAT EVIDENCE O NUMBER: 1 1 OWNER: 1 1 OWNER: 1 1 OWNER: 1 1 I I I I I I I I I I I I I I I I I	GNS AND ARI RE AND SHALL ND NO PART TO OTHERS CO WORK OR PRO DR WHICH THI DWITHOUT TH INTACT WITH T IONS SHALL CO F ACCEPTAN DATE: -NOV.202 OOG LLC TON ST XAS 78704 STRUCTION S	RANGEMENTS REMAIN THE THEREOF SHAI OR USED IN CO DJECT OTHER T EY HAVE BEEN THESE DRAWIN ONSTITUTE CO CE OF THESE F ISSUED 23 -PERMIT	REPRESENTED PROPERTY LL BE COPIED, INNECTION THAN THE SPECIFIC PREPARED AND ONSENT OF DIG:A. NGS OR DNCLUSIVE RESTRICTIONS.

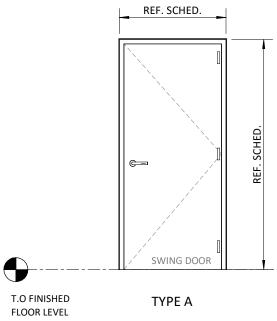


QTY._6

 \bigcirc

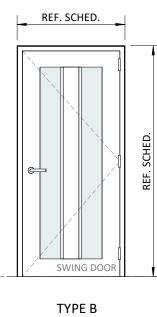


QTY._6

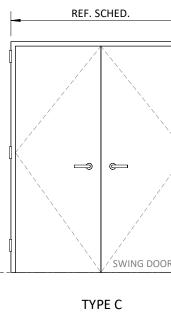

QTY._4

DOOR SCHEDULE													
IUMBER	TYPE DOOR	WIDTH	HEIGHT	THICKNESS	DOOR MATERIAL	FRAME MATERIAL	HARDWARE SET	HINGES	DOOR STOP	HEAD DETAIL	DOOR HANDED	SILL DETAIL	NOTES
01	A	3'-0"	6'-8"	0'-1 3/4"	SINGLE HINGED DOOR SOLID CORE WOOD	WOOD	BY OWNER	N/A	N/A	N/A	RIGHT HANDED	N/A	SINGLE HINGED DOOR
02	A	3'-0"	6'-8"	0'-1 3/4"	SINGLE HINGED DOOR SOLID CORE WOOD	WOOD	BY OWNER	N/A	N/A	N/A	LEFT HANDED	N/A	SINGLE HINGED DOOR
03	A	3'-0"	6'-5"	0'-1 3/4"	SINGLE HINGED DOOR SOLID CORE WOOD	WOOD	BY OWNER	N/A	N/A	N/A	LEFT HANDED	N/A	SINGLE HINGED DOOR
04	A	3'-0"	6'-8"	0'-1 3/4"	SINGLE HINGED DOOR SOLID CORE WOOD	WOOD	BY OWNER	N/A	N/A	N/A	RIGHT HANDED	N/A	SINGLE HINGED DOOR
05	В	3'-6"	6'-8"	0'-0 1/2"	SINGLE HINGED DOOR GLASS	WOOD/GLASS	BY OWNER	N/A	N/A	N/A	RIGHT HANDED	N/A	SINGLE HINGED GLASS TEMPERED PER CODE & WOOD DOOR
.01	С	5'-0"	6'-5"	0'-1 3/4"	DOUBLE HINGED DOOR SOLID CORE WOOD	WOOD	BY OWNER	N/A	N/A	N/A	DOUBLE HANDED	N/A	DOUBLE HINGED DOOR
.02	R	2'-10"	6'-5"	0'-1 3/4"	SINGLE HINGED DOOR GLASS	WOOD/GLASS	BY OWNER	N/A	N/A	N/A	RIGHT HANDED	N/A	SINGLE HINGED GLASS & WOOD DOOR
.03	С	5'-0"	6'-5"	0'-1 3/4"	DOUBLE HINGED DOOR SOLID CORE WOOD	WOOD	BY OWNER	N/A	N/A	N/A	DOUBLE HANDED	N/A	DOUBLE HINGED DOOR
.04	Q	2'-10"	6'-5"	0'-1 3/4"	SINGLE HINGED DOOR SOLID CORE WOOD	WOOD	BY OWNER	N/A	N/A	N/A	LEFT HANDED	N/A	SINGLE HINGED DOOR
.05	A	3'-0"	6'-5"	0'-1 3/4"	SINGLE HINGED DOOR SOLID CORE WOOD	WOOD	BY OWNER	N/A	N/A	N/A	RIGHT HANDED	N/A	SINGLE HINGED DOOR
.06	0	3'-0"	6'-8"	0'-1 3/4"	SINGLE HINGED DOOR GLASS	WOOD/GLASS	BY OWNER	N/A	N/A	N/A	RIGHT HANDED	N/A	SINGLE HINGED GLASS & WOOD DOOR
.07	0	3'-0"	6'-8"	0'-1 3/4"	SINGLE HINGED DOOR GLASS	WOOD/GLASS	BY OWNER	N/A	N/A	N/A	LEFT HANDED	N/A	SINGLE HINGED GLASS & WOOD DOOR
.08	С	3'-0"	6'-8"	0'-1 3/4"	DOUBLE HINGED DOOR SOLID CORE WOOD	WOOD	BY OWNER	N/A	N/A	N/A	DOUBLE HANDED	N/A	DOUBLE HINGED DOOR
.09	В	3'-0"	6'-8"	0'-0 1/2"	SINGLE HINGED DOOR GLASS	WOOD/GLASS	BY OWNER	N/A	N/A	N/A	RIGHT HANDED	N/A	SINGLE HINGED GLASS & WOOD DOOR
.10	В	3'-0"	6'-8"	0'-0 1/2"	SINGLE HINGED DOOR GLASS	WOOD/GLASS	BY OWNER	N/A	N/A	N/A	RIGHT HANDED	N/A	SINGLE HINGED GLASS & WOOD DOOR
.11	С	3'-0"	6'-8"	0'-1 3/4"	DOUBLE HINGED DOOR SOLID CORE WOOD	WOOD	BY OWNER	N/A	N/A	N/A	DOUBLE HANDED	N/A	DOUBLE HINGED DOOR
12	D	3'-6"	6'-5"	0'-1 3/4"	POCKET DOOR SOLID CORE WOOD	WOOD	BY OWNER	N/A	N/A	N/A	SLIDER	N/A	CONCEALED SLIDING DOOR

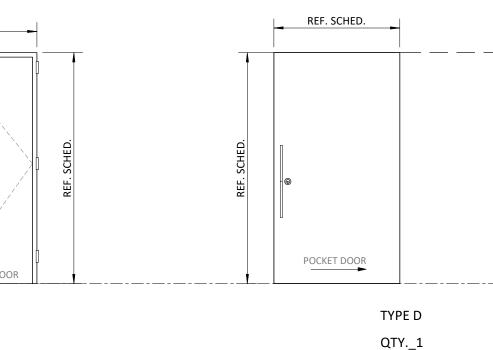

NOTES DOOR SCHEDULE

NOTES: REFER TO FLOOR PLANS FOR DIRECTION OF DOOR SWING- TYPICAL

ALL ACCESSIBLE DOORS TO BE 32" MIN WIDTH

DOORS BETWEEN GARAGE AND DWELLING UNIT SHALL BE SELF CLOSING AND SELF LATCHING, SOLID WOOD OR SOLID HONEYCOMB CORE STEEL NOT LESS THAN 1 3/8" THICK OR HAVE A MINIMUM FIRE PROTECTION RATING OF 20 MINUTES.

FENESTRATIONS MUST HAVE TEMPORARY AND PERMANENT LABELS

GLAZING IN THE FOLLOWING LOCATIONS SHALL BE SAFETY GLAZING CONFORMING TO THE HUMAN IMPACT LOADS OF SECTION R308.3 (SEE EXCEPTIONS) (R308.4):

A. FIXED AND OPERABLE PANELS OF SWINGING SLIDING AN BIFOLD DOOR ASSEMBLIES FIXED AND OPERABLE PANELS OF SWINGING SLIDING AN BIFOLD DOOR ASSEMBLIES

B. GLAZING IN AN INDIVIDUAL FIXED OR OPERABLE PANEL ADJACENT TO A DOOR WHERE THE NEAREST VERTICAL EDGE IS WITHIN A 24" ARC OF THE DOOR IN A CLOSED POSITION AND WHOSE BOTTOM EDGE IS LESS THAN 60" ABOVE THE FLOOR OR WALKING SURFACE. GLAZING IN AN INDIVIDUAL FIXED OR OPERABLE PANEL ADJACENT TO A DOOR WHERE THE NEAREST VERTICAL EDGE IS WITHIN A 24" ARC OF THE DOOR IN A CLOSED POSITION AND WHOSE BOTTOM EDGE IS LESS THAN 60" ABOVE THE FLOOR OR WALKING SURFACE. THE NEAREST VERTICAL EDGE IS WITHIN A 24" ARC OF THE DOOR IN A CLOSED POSITION AND WHOSE BOTTOM EDGE IS LESS THAN 60" ABOVE THE FLOOR OR WALKING SURFACE.

C. GLAZING IN AN INDIVIDUAL FIXED OR OPERABLE PANEL THAT MEETS ALL OF THE FOLLOWING CONDITIONS:

GLAZING IN AN INDIVIDUAL FIXED OR OPERABLE PANEL THAT MEETS ALL OF THE FOLLOWING CONDITIONS:

1.1. EXPOSED AREA OF AN INDIVIDUAL PANE GREATER THAN 9 SQUARE FEET. EXPOSED AREA OF AN INDIVIDUAL PANE GREATER THAN 9 SQUARE FEET.

1.2. BOTTOM EDGE LESS THAT 18" ABOVE FLOOR. BOTTOM EDGE LESS THAT 18" ABOVE FLOOR.

1.3. TOP EDGE GREATER THAN 36" ABOVE THE FLOOR. TOP EDGE GREATER THAN 36" ABOVE THE FLOOR.

1.4. ONE OR MORE WALKING SURFACES WITHIN 36" HORIZONTALLY OF THE GLAZING. ONE OR MORE WALKING SURFACES WITHIN 36" HORIZONTALLY OF THE GLAZING.


D. GLAZING IN RAILS GLAZING IN RAILS

E. GLAZING IN ENCLOSURES FOR OR FACING HOT TUBS, WHIRLPOOLS, SAUNAS, STEAM ROOMS, BATHTUBS AND SHOWERS WHERE TO BOTTOM EDGE OF THE GLAZING IS LESS THAN 60" MEASURED VERTICALLY ABOVE ANY STANDING OR WALKING SURFACE. GLAZING IN ENCLOSURES FOR OR FACING HOT TUBS, WHIRLPOOLS, SAUNAS, STEAM ROOMS, BATHTUBS AND SHOWERS WHERE TO BOTTOM EDGE OF THE GLAZING IS LESS THAN 60" MEASURED VERTICALLY ABOVE ANY STANDING OR WALKING SURFACE.

F. GLAZING IN FENCES AND WALLS ADJACENT TO INDOOR AND OUTDOOR SWIMMING POOLS, HOT TUBS, AND SPAS WHERE THE BOTTOM EDGE OF THE GLAZING IS LESS THAN 60" ABOVE A WALKING SURFACE AND WITHIN 60" MEASURED HORIZONTALLY MEASURED IN A STRAIGHT LINE OF THE WATERS EDGE. GLAZING IN FENCES AND WALLS ADJACENT TO INDOOR AND OUTDOOR SWIMMING POOLS, HOT TUBS, AND SPAS WHERE THE BOTTOM EDGE OF THE GLAZING IS LESS THAN 60" ABOVE A WALKING SURFACE AND WITHIN 60" MEASURED HORIZONTALLY MEASURED IN A STRAIGHT LINE OF THE WATERS EDGE.

G. GLAZING ADJACENT TO STAIRWAYS LANDINGS AND RAMPS WITHIN 36" HORIZONTALLY OF A WALKING SURFACE WHEN THE SURFACE OF THE GLAZING IS LESS THAN 60" ABOVE THE ADJACENT WALKING SURFACE. GLAZING ADJACENT TO STAIRWAYS LANDINGS AND RAMPS WITHIN 36" HORIZONTALLY OF A WALKING SURFACE WHEN THE SURFACE OF THE GLAZING IS LESS THAN 60" ABOVE THE ADJACENT WALKING SURFACE.

H. GLAZING ADJACENT TO STAIRWAYS WITHIN 60 INCHES HORIZONTALLY OF THE BOTTOM TREAD OF A STAIRWAY IN ANY DIRECTION WHEN THE EXPOSED SURFACE OF THE GLAZING IS LESS THAN 60" ABOVE THE NOSE OF THE TREAD.GLAZING ADJACENT TO STAIRWAYS WITHIN 60 INCHES HORIZONTALLY OF THE BOTTOM TREAD OF A STAIRWAY IN ANY DIRECTION WHEN THE EXPOSED SURFACE OF THE GLAZING IS LESS THAN 60" ABOVE THE NOSE OF THE TREAD.

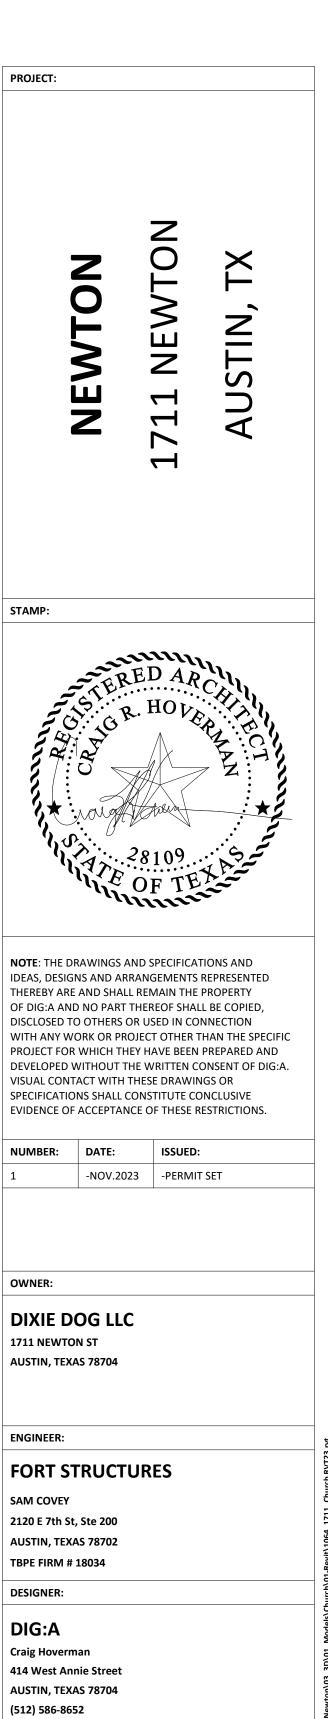

(C) 2023

ALL RIGHTS RESERVED


JOB No: 1076

START DATE:

DRAWN BY: CH/AV/MS TOTAL SHEET SETS:


DRAWING: DOORS SCHEDULES BLDG 01

CH A7.1

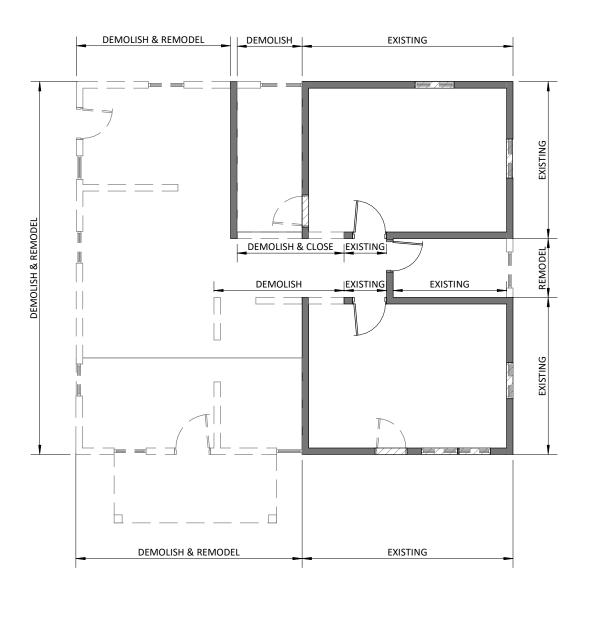



DEMO PLAN 02 SCALE 1/8" = 1'-0"

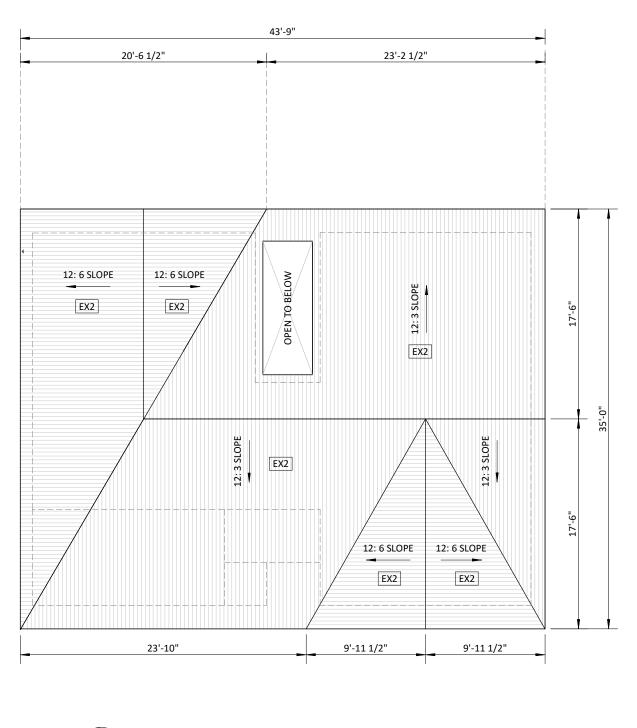

ROOF PLAN 01 SCALE 1/8" = 1'-0"

DEMOLITION NOTES

PROTECT AREAS ADJACENT TO DEMOLITION ZONES.

SEAL OFF AREAS OF DEMOLITION FROM MAIN STRUCTURE.

CAREFULLY STORE ALL MATERIALS NOTED FOR RE-USE.

REMOVE ALL DEBRIS FROM SITE.

PROTECT AREAS EXPOSED BY DEMOLITION FROM WEATHER IMPACT.

REMOVE ALL PLUMBING FIXTURES

REMOVE ALL DUCTING

REMOVE ALL DOORS - INTERIOR AND EXTERIOR

REMOVE ALL WINDOWS

REMOVE ALL FLOORING THROUGHOUT - WOOD & TILE

LOCATE ALL UTILITIES INCLUDING BUT NOT LIMITED TO GAS, ELECTRIC, PLUMBING, HVAC AND SECURITY SYSTEM -IDENTIFY UTILITIES COORDINATION PRIOR TO CONSTRUCTION

REMOVE ROOFING MATERIAL AND ROOF JOISTS. BRACE AS NEEDED

REMOVE WALL WHERE NOTED TO ACCOMMODATE NEW WINDOWS AND DOORS AS SHOWN


DEMOLITION PARTITION TYPES

EXISTING WALL	
NEW WALL	
DEMOLITION WALL	

FINISH SCHEDULE ROOF

TYPE DESCRIPTION EX2 STANDING SEAM METAL

PROJECT:			-
NEWTON	1711 NEWTON	AUSTIN, TX	
STAMP:	ED AR ED AR HOVE	CANAR CT	-
NOTE: THE DRAWINGS AIDEAS, DESIGNS AND ARITHEREBY ARE AND SHALLOF DIG:A AND NO PARTDISCLOSED TO OTHERS CWITH ANY WORK OR PROPROJECT FOR WHICH THIDEVELOPED WITHOUT THVISUAL CONTACT WITH TSPECIFICATIONS SHALL CEVIDENCE OF ACCEPTANNUMBER:DATE:1-NOV.202	RANGEMENTS REMAIN THE THEREOF SHAL OR USED IN CO DJECT OTHER T EY HAVE BEEN HE WRITTEN CO THESE DRAWIN ONSTITUTE CO CE OF THESE R	REPRESENTED PROPERTY L BE COPIED, NNECTION 'HAN THE SPECIFIC PREPARED AND ONSENT OF DIG:A. IGS OR DNCLUSIVE ESTRICTIONS.	-
OWNER: DIXIE DOG LLC 1711 NEWTON ST AUSTIN, TEXAS 78704			-
ENGINEER: FORT STRUCTION SAM COVEY 2120 E 7th St, Ste 200 AUSTIN, TEXAS 78702 TBPE FIRM # 18034 DESIGNER: DIG:A Craig Hoverman	URES, In	C.	-
414 West Annie Street AUSTIN, TEXAS 78704 (512) 586-8652 © 2023 ALL RIGHTS RESERVED JOB No: 1064 DRAWN BY: CH/AV/MS DRAWING: DEMO A		HEET SETS:	C:\Users\mtsan\Documents\0-BIM\1064_1711_Pastor House RVT23_Chov150.rvt
PH	A1	0	C:\Users\mtsan\Documents\0-BIM\1

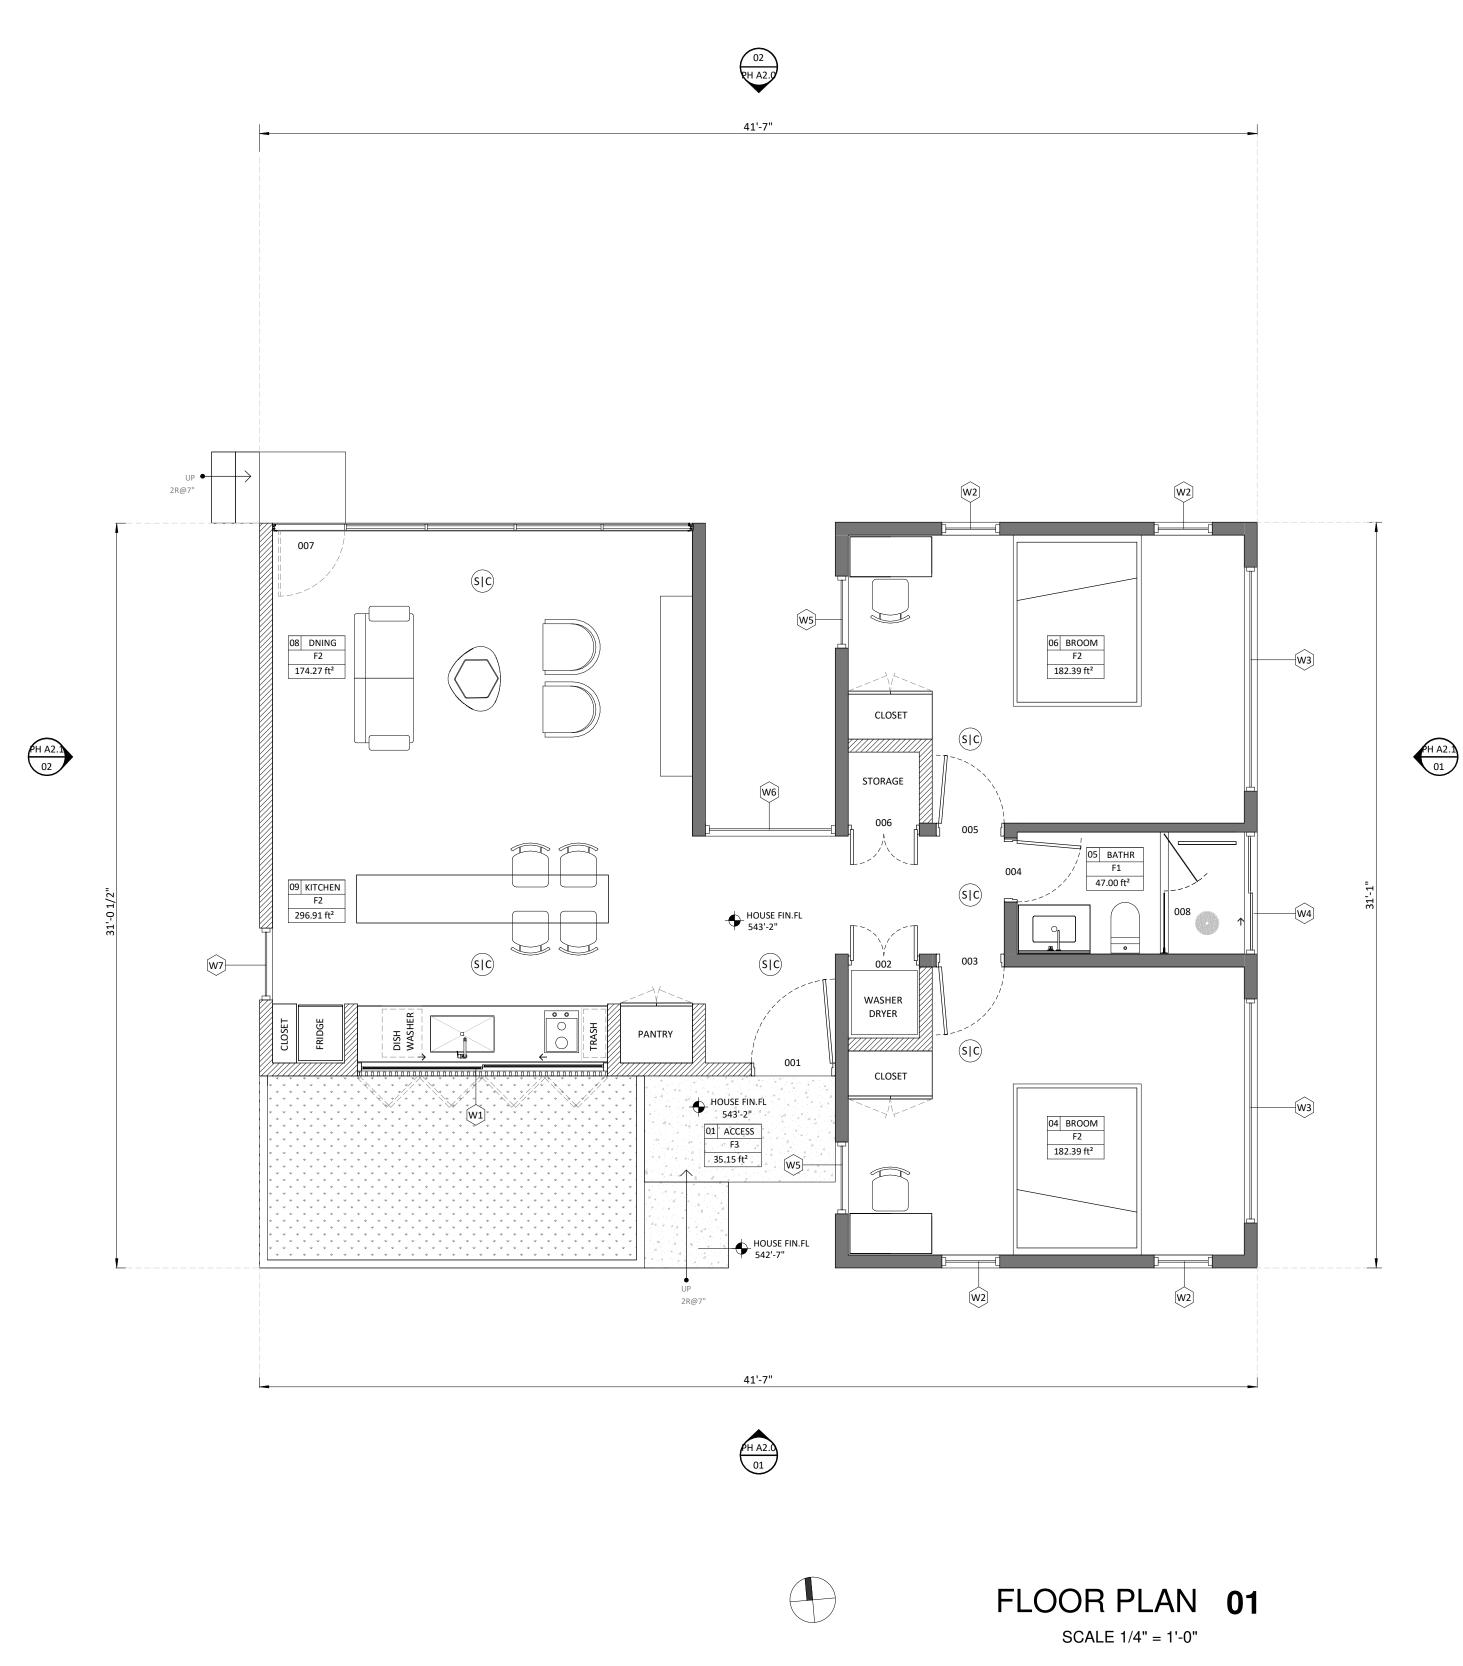

ARCHITECTURAL SYMBOLS

ALL DIMENSIONS RELEVANT TO FRAMING ARE TO FACE OF STUD UNLESS NOTED OTHERWISE

DOORS INDICATED THUS: XXX

REFER DOOR SCHEDULE

DOOR SWINGS AS INDICATED ON PLAN

WINDOWS INDICATED THUS:
REFER FOR WINDOW SCHEDULEXXROOM FINISH INDICATED THUS:XXX

SCHEDULE THIS PAGE

SMOKE AND CARBON DETECTORS

ALL FLOOR MATERIAL DIFFERENTIALS TO BE 1/2" MAX FINISH SCHEDULE NOTES

OWNER AND ARCHITECT TO REVIEW COLOR & MATERIAL SAMPLES PRIOR TO FINAL INSTALL

DETAIL NUMBER SHEET NUMBER

SHEET NUMBER

SECTION NUMBER

LEVEL NUMBER SHEET NUMBER ELEVATION NUMBER

ROOM NUMBER FINISH FLOOR FOOT SQUARE



WALL SCHEDULE TYPES

- TYPE DESCRIPTION
- 001 WOOD STUD 2x6" AND TRACK
- 002 WOOD STUD 2x4" AND TRACK
- 003 CONCRETE WALL THICKNESS 4"
- 004 CONCRETE WALL THICKNESS 1 3/4"005 WIRE METAL MESH
- 006 VERTICAL WOOD LOUVERS 2x1" @ 3"

FINISH SCHEDULE WALLS

- TYPE DESCRIPTION
- EX1 WOODEN SIDING (EXISTING) AND MATCH EXISTING
 EX3 EXTERIOR CONCRETE EXPOSED
 W1 DRYWALL WHITE
 W2 TILE
 W3 WOOD 3/4" THICKNESS
 W4 WOOD 3/4" THICKNESS
 W5 TILE

FINISH SCHEDULE CEILING

TYPE DESCRIPTION

- C1 DRYWALL DROPPED 1/2" THICKNESS
- C2 WOODEN DOUGLAS FIR 3/4" THICKNESS
- C3 WOODEN DOUGLAS FIR 3/4" THICKNESSC4 LONGLEAVE W/ EXPOSED STRUCTURE 3/4" THICKNESS

FINISH SCHEDULE FLOOR

- TYPE DESCRIPTION
- F1TILEF2WOODEN FLOOR THICKNESS 3/4"
- F3 DECK
- F4 CONCRETE SLAB EXPOSED

FINISH SCHEDULE ROOF

- TYPE DESCRIPTION
- EX2 STANDING SEAM METAL

PROJECT: Ζ NEWTO NEWTON X TIN Ś Τ \mathbf{H} 4 -STAMP: Winner NOTE: THE DRAWINGS AND SPECIFICATIONS AND IDEAS, DESIGNS AND ARRANGEMENTS REPRESENTED THEREBY ARE AND SHALL REMAIN THE PROPERTY OF DIG:A AND NO PART THEREOF SHALL BE COPIED, DISCLOSED TO OTHERS OR USED IN CONNECTION WITH ANY WORK OR PROJECT OTHER THAN THE SPECIFIC PROJECT FOR WHICH THEY HAVE BEEN PREPARED AND DEVELOPED WITHOUT THE WRITTEN CONSENT OF DIG:A. VISUAL CONTACT WITH THESE DRAWINGS OR SPECIFICATIONS SHALL CONSTITUTE CONCLUSIVE EVIDENCE OF ACCEPTANCE OF THESE RESTRICTIONS. ISSUED: NUMBER: DATE: -NOV.2023 -PERMIT SET OWNER: DIXIE DOG LLC 1711 NEWTON ST AUSTIN, TEXAS 78704 ENGINEER: FORT STRUCTURES, Inc. SAM COVEY

SAM COVEY 2120 E 7th St, Ste 200 AUSTIN, TEXAS 78702 TBPE FIRM # 18034

DESIGNER:


DIG:A Craig Hoverman 414 West Annie Street AUSTIN, TEXAS 78704 (512) 586-8652 © 2023


ALL RIGHTS RESERVED

JOB No:	1064	START DATE:
DRAWN BY:	CH/AV/MS	TOTAL SHEET SETS:

DRAWING: FLOOR PLAN BLDG 02



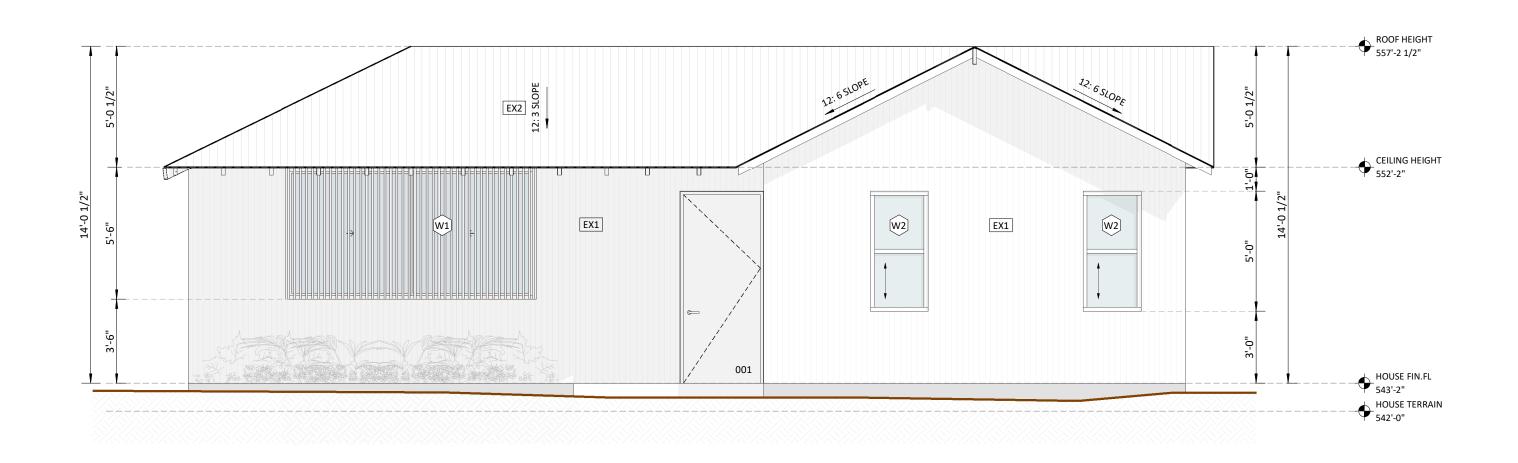

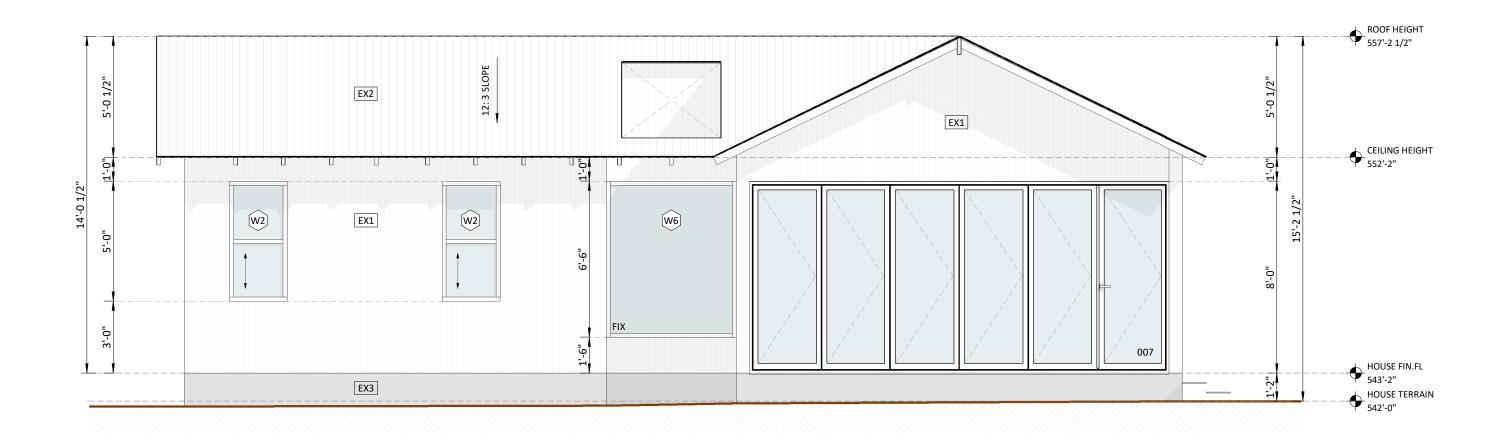

FRONT ELEVATION **01** SCALE 1/4" = 1'-0"

BACK ELEVATION 02 SCALE 1/4" = 1'-0"

ARCHITECTURAL SYMBOLS

ALL DIMENSIONS RELEVANT TO FRAMING ARE TO FACE OF STUD UNLESS NOTED OTHERWISE

DOORS INDICATED THUS: XXX

REFER DOOR SCHEDULE DOOR SWINGS AS INDICATED ON PLAN

WINDOWS INDICATED THUS: XX

REFER FOR WINDOW SCHEDULE ROOM FINISH INDICATED THUS: SCHEDULE THIS PAGE

SMOKE AND CARBON DETECTORS

ALL FLOOR MATERIAL DIFFERENTIALS TO BE 1/2" MAX

FINISH SCHEDULE NOTES

OWNER AND ARCHITECT TO REVIEW COLOR & MATERIAL SAMPLES PRIOR TO FINAL INSTALL

DETAIL NUMBER SHEET NUMBER

00 A.00 SECTION NUMBER 00

SHEET NUMBER LEVEL NUMBER

• XXXX FIN.FL 00' 00" SHEET NUMBER ELEVATION NUMBER

ROOM

F ft2

ROOM NUMBER FINISH FLOOR FOOT SQUARE



WALL SCHEDULE TYPES

- TYPE DESCRIPTION
- 001 WOOD STUD 2x6" AND TRACK
- 002 WOOD STUD 2x4" AND TRACK
- CONCRETE WALL THICKNESS 4" 003 004
- CONCRETE WALL THICKNESS 1 3/4" WIRE METAL MESH 005
- 006 VERTICAL WOOD LOUVERS 2x1" @ 3"

FINISH SCHEDULE WALLS

- TYPE DESCRIPTION
- EX1 WOODEN SIDING (EXISTING) AND MATCH EXISTING EX3 EXTERIOR CONCRETE EXPOSED W1 DRYWALL WHITE W2 TILE WOOD 3/4" THICKNESS W3 WOOD 3/4" THICKNESS W4 W5 TILE

FINISH SCHEDULE CEILING

TYPE DESCRIPTION

- DRYWALL DROPPED 1/2" THICKNESS C1
- WOODEN DOUGLAS FIR 3/4" THICKNESS C2
- WOODEN DOUGLAS FIR 3/4" THICKNESS C3 C4 LONGLEAVE W/ EXPOSED STRUCTURE 3/4" THICKNESS

FINISH SCHEDULE FLOOR

- TYPE DESCRIPTION
- TILE F1 WOODEN FLOOR THICKNESS 3/4" F2
- F3 DECK
- CONCRETE SLAB EXPOSED F4

FINISH SCHEDULE ROOF

- TYPE DESCRIPTION
- EX2 STANDING SEAM METAL

PROJECT: Ζ NEWTO X NEWTON TIN Ś Τ T 4 \sim Η STAMP: min Winner NOTE: THE DRAWINGS AND SPECIFICATIONS AND IDEAS, DESIGNS AND ARRANGEMENTS REPRESENTED THEREBY ARE AND SHALL REMAIN THE PROPERTY OF DIG:A AND NO PART THEREOF SHALL BE COPIED, DISCLOSED TO OTHERS OR USED IN CONNECTION WITH ANY WORK OR PROJECT OTHER THAN THE SPECIFIC PROJECT FOR WHICH THEY HAVE BEEN PREPARED AND DEVELOPED WITHOUT THE WRITTEN CONSENT OF DIG:A. VISUAL CONTACT WITH THESE DRAWINGS OR SPECIFICATIONS SHALL CONSTITUTE CONCLUSIVE EVIDENCE OF ACCEPTANCE OF THESE RESTRICTIONS. NUMBER: DATE: ISSUED: -NOV.2023 -PERMIT SET OWNER: DIXIE DOG LLC 1711 NEWTON ST AUSTIN, TEXAS 78704 ENGINEER: FORT STRUCTURES, Inc. SAM COVEY 2120 E 7th St, Ste 200

AUSTIN, TEXAS 78702 TBPE FIRM # 18034

DESIGNER:

DIG:A

© 2023

ALL RIGHTS RESERVED

JOB No: 1064


START DATE:


DRAWN BY: CH/AV/MS TOTAL SHEET SETS:

DRAWING: EXTERIOR ELEVATIONS BLDG 02


PH A2.0

Craig Hoverman 414 West Annie Street AUSTIN, TEXAS 78704 (512) 586-8652

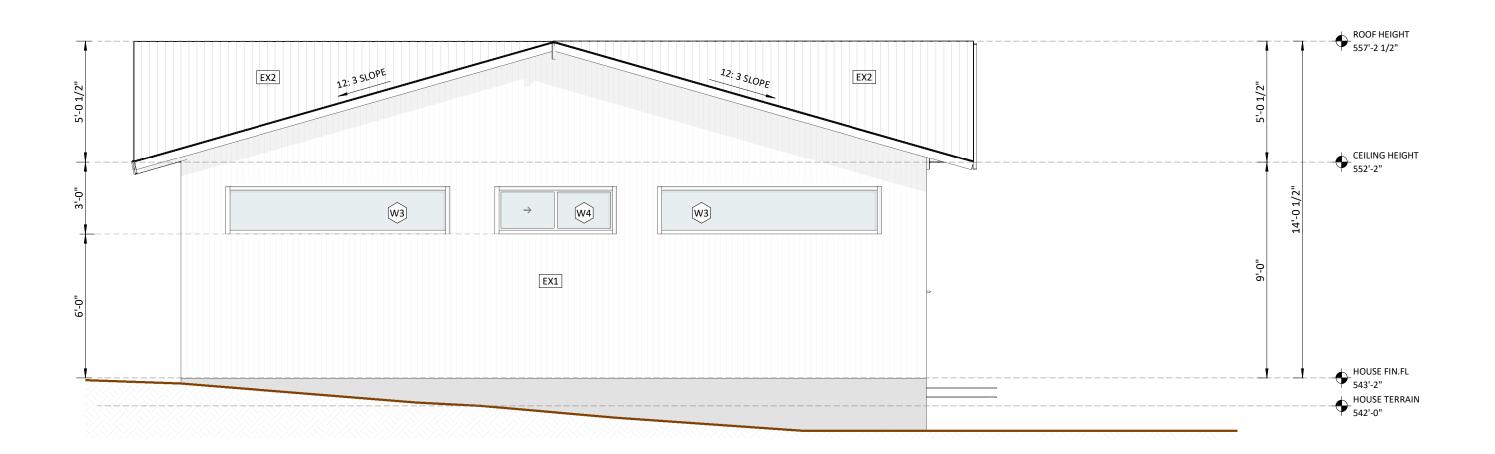

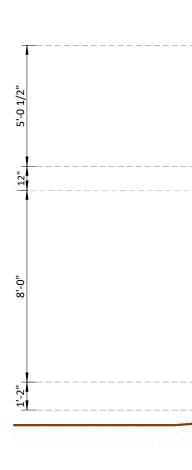

LEFT ELEVATION **01** SCALE 1/4" = 1'-0"

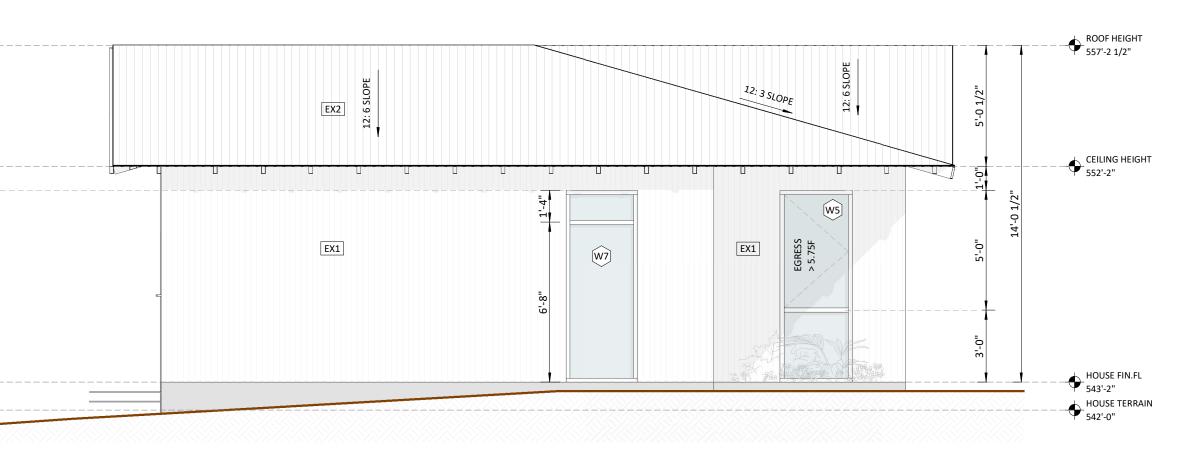

RIGHT ELEVATION 02 SCALE 1/4" = 1'-0"

ARCHITECTURAL SYMBOLS

ALL DIMENSIONS RELEVANT TO FRAMING ARE TO FACE OF STUD UNLESS NOTED OTHERWISE

DOORS INDICATED THUS: XXX

REFER DOOR SCHEDULE DOOR SWINGS AS INDICATED ON PLAN

WINDOWS INDICATED THUS: XX

REFER FOR WINDOW SCHEDULE ROOM FINISH INDICATED THUS: SCHEDULE THIS PAGE

SMOKE AND CARBON DETECTORS

ALL FLOOR MATERIAL DIFFERENTIALS TO BE 1/2" MAX

FINISH SCHEDULE NOTES

OWNER AND ARCHITECT TO REVIEW COLOR & MATERIAL SAMPLES PRIOR TO FINAL INSTALL

DETAIL NUMBER SHEET NUMBER

00 A.00 00 SECTION NUMBER

SHEET NUMBER LEVEL NUMBER

+ XXXX FIN.FL 00' 00" SHEET NUMBER ELEVATION NUMBER

ROOM

ROOM NUMBER FINISH FLOOR FOOT SQUARE



WALL SCHEDULE TYPES

TYPE DESCRIPTION

- 001 WOOD STUD 2x6" AND TRACK
- WOOD STUD 2x4" AND TRACK 002
- CONCRETE WALL THICKNESS 4" 003 004
- CONCRETE WALL THICKNESS 1 3/4" WIRE METAL MESH 005
- 006 VERTICAL WOOD LOUVERS 2x1" @ 3"

FINISH SCHEDULE WALLS

- TYPE DESCRIPTION
- EX1 WOODEN SIDING (EXISTING) AND MATCH EXISTING EX3 EXTERIOR CONCRETE EXPOSED W1 DRYWALL WHITE W2 TILE WOOD 3/4" THICKNESS W3 WOOD 3/4" THICKNESS W4 W5 TILE

FINISH SCHEDULE CEILING

TYPE DESCRIPTION

- DRYWALL DROPPED 1/2" THICKNESS C1
- WOODEN DOUGLAS FIR 3/4" THICKNESS C2
- WOODEN DOUGLAS FIR 3/4" THICKNESS C3 C4 LONGLEAVE W/ EXPOSED STRUCTURE 3/4" THICKNESS

FINISH SCHEDULE FLOOR

- TYPE DESCRIPTION
- F1 TILE WOODEN FLOOR THICKNESS 3/4" F2
- F3 DECK
- F4 CONCRETE SLAB EXPOSED

FINISH SCHEDULE ROOF

- TYPE DESCRIPTION
- EX2 STANDING SEAM METAL

PROJECT: Ζ NEWTO \mathbf{X} NEWTON TIN Ś Τ T 4 \sim Η STAMP: , mm Will UF TEAM NOTE: THE DRAWINGS AND SPECIFICATIONS AND IDEAS, DESIGNS AND ARRANGEMENTS REPRESENTED THEREBY ARE AND SHALL REMAIN THE PROPERTY OF DIG:A AND NO PART THEREOF SHALL BE COPIED, DISCLOSED TO OTHERS OR USED IN CONNECTION WITH ANY WORK OR PROJECT OTHER THAN THE SPECIFIC PROJECT FOR WHICH THEY HAVE BEEN PREPARED AND DEVELOPED WITHOUT THE WRITTEN CONSENT OF DIG:A. VISUAL CONTACT WITH THESE DRAWINGS OR SPECIFICATIONS SHALL CONSTITUTE CONCLUSIVE EVIDENCE OF ACCEPTANCE OF THESE RESTRICTIONS. NUMBER: DATE: ISSUED: -NOV.2023 -PERMIT SET OWNER: DIXIE DOG LLC 1711 NEWTON ST AUSTIN, TEXAS 78704 ENGINEER: FORT STRUCTURES, Inc. SAM COVEY 2120 E 7th St, Ste 200

AUSTIN, TEXAS 78702 TBPE FIRM # 18034

DESIGNER:

DIG:A

Craig Hoverman 414 West Annie Street AUSTIN, TEXAS 78704

(512) 586-8652

ALL RIGHTS RESERVED

JOB No: 1064


START DATE:


DRAWN BY: CH/AV/MS TOTAL SHEET SETS:

DRAWING: EXTERIOR ELEVATIONS BLDG 02

PH A2.1

© 2023

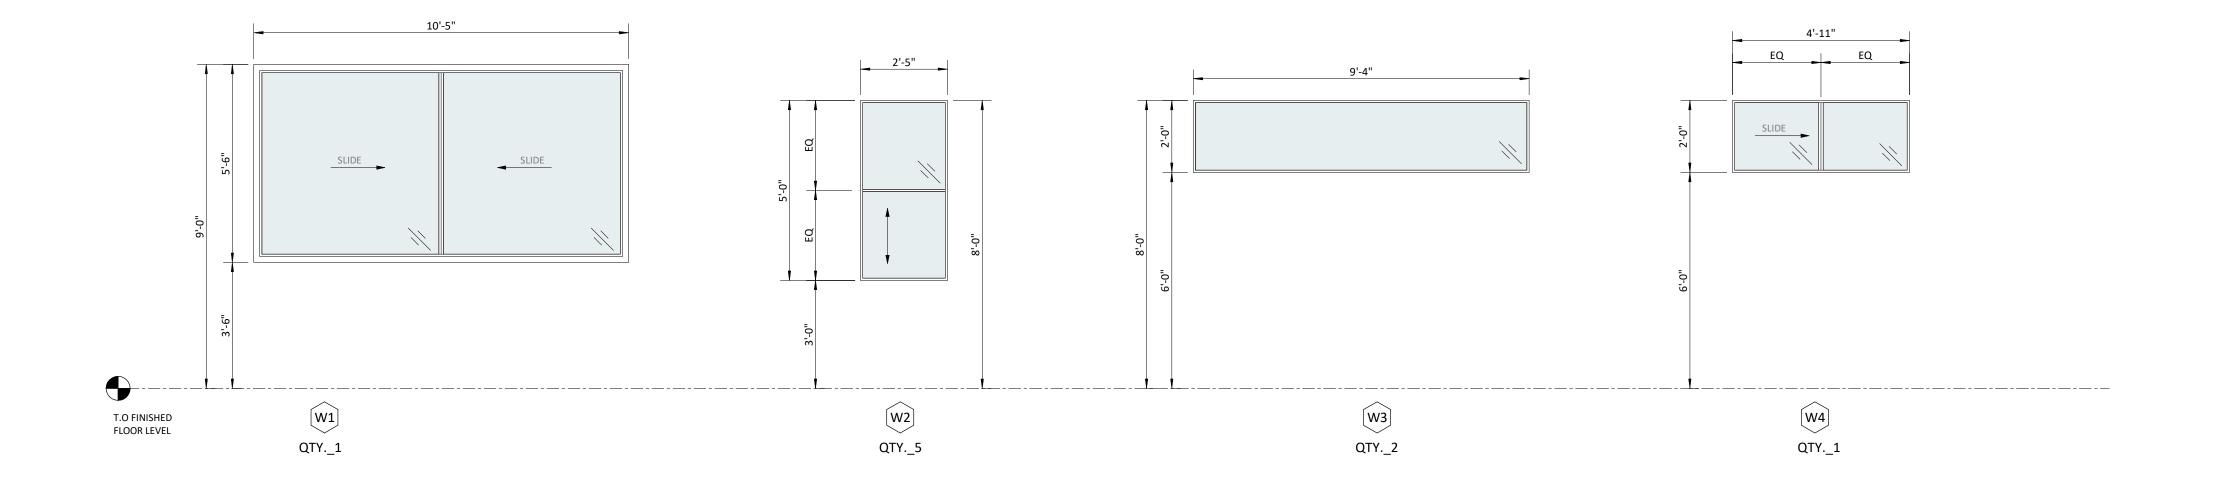

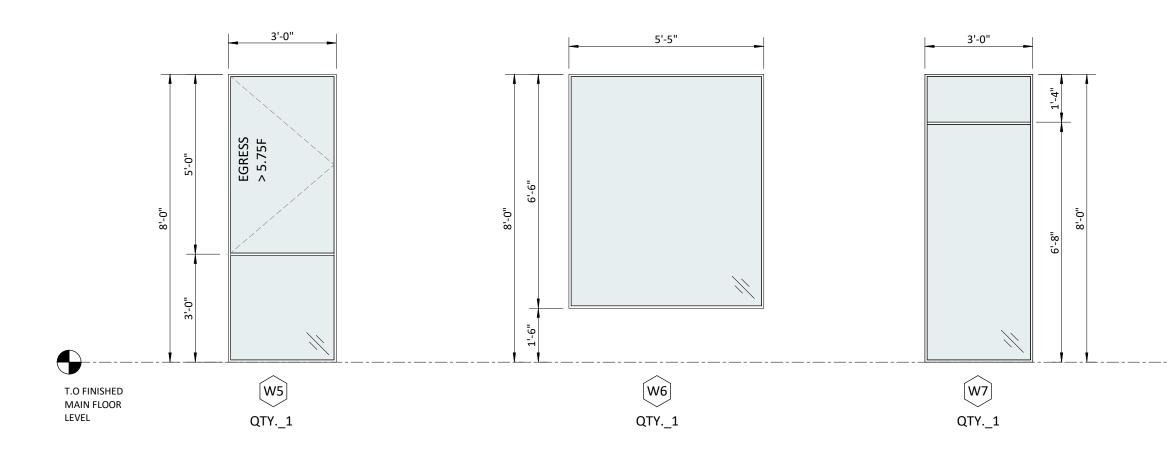

	WINDOW SCHEDULE													
ТҮРЕ	AMOUNT	WIDTH	HEIGHT	TYPE WINDOW	GLAZING	FRAME	COLOR	MFGR	U-FACTOR	SHGC	HEAD DETAIL	JAMB DETAIL	SILL DETAIL	NOTES
W1	1	10'-5"	5'-6"	SLIDING	DUAL GLAZED	ALUMINUM	BLACK ANODIZED	FLEETWOOD & MILGARD	.5	.25	XX/XX	XX/XX	XX/XX	(2) PANEL OPERABLE SLIDING
W2	4	2'-5"	5'-0"	FIXED / CASEMENT	DUAL GLAZED	ALUMINUM	BLACK ANODIZED	FLEETWOOD & MILGARD	.5	.25	XX/XX	XX/XX	XX/XX	(1) PANEL FIXED (1) OPERABLE PANEL
W3	2	9'-4"	2'-0"	FIXED	DUAL GLAZED	ALUMINUM	BLACK ANODIZED	FLEETWOOD & MILGARD	.5	.25	XX/XX	XX/XX	XX/XX	(1) PANEL FIXED
W4	1	5'-1"	2'-0"	SLIDING	DUAL GLAZED	ALUMINUM	BLACK ANODIZED	FLEETWOOD & MILGARD	.5	.25	XX/XX	XX/XX	XX/XX	(1) PANEL FIXED (1) OPERABLE PANEL SLIDING
W5	2	3'-0"	8'-0"	FIXED / CASEMENT	DUAL GLAZED	ALUMINUM	BLACK ANODIZED	FLEETWOOD & MILGARD	.5	.25	XX/XX	XX/XX	XX/XX	(2) PANEL FIXED (1) OPERABLE PANEL EGRESS TO EXTERIOR
W6	1	5'-5"	6'-6"	FIXED	DUAL GLAZED	ALUMINUM	BLACK ANODIZED	FLEETWOOD & MILGARD	.5	.25	XX/XX	XX/XX	XX/XX	(1) PANEL FIXED
W7	1	3'-0"	8'-0"	SLIDING	DUAL GLAZED	ALUMINUM	BLACK ANODIZED	FLEETWOOD & MILGARD	.5		XX/XX	XX/XX	XX/XX	(2) PANEL OPERABLE SLIDING

NOTES WINDOW SCHEDULE

FIELD VERIFY ALL WINDOW DIMENSIONS

ALL ALUMINUM FRAMES TO BE ACCORDING TO SCHEDULE SPEC. DOOR SWINGS AS INDICATED ON PLAN

ALL OPERABLE WINDOWS TO HAVE SCREENS

ALL INSULATED GLASS TO BE LOW-E

FENESTRATIONS MUST HAVE TEMPORARY AND PERMANENT LABELS.

GLAZING IN THE FOLLOWING LOCATIONS SHALL BE SAFETY GLAZING CONFORMING TO THE HUMAN IMPACT LOADS OF SECTION R308.3 (SEE EXCEPTIONS) (R308.4):

- A. FIXED AND OPERABLE PANELS OF SWINGING SLIDING AND BIFOLD DOOR ASSEMBLIES
- B. GLAZING IN AN INDIVIDUAL FIXED OR OPERABLE PANEL
 ADJACENT TO A DOOR WHERE THE NEAREST VERTICAL
 EDGE IS WITHIN A 24" ARC OF THE DOOR IN A CLOSED
 POSITION AND WHOSE BOTTOM EDGE IS LESS THAN 60"
 ABOVE THE FLOOR OR WALKING SURFACE.
- C. GLAZING IN AN INDIVIDUAL FIXED OR OPERABLE PANEL THAT MEETS ALL OF THE FOLLOWING CONDITIONS
 - EXPOSED AREA OF AN INDIVIDUAL PANE GREATER THAN 9 SQUARE FEET.
 - BOTTOM EDGE LESS THAT 18" ABOVE FLOOR
 TOP EDGE GREATER THAN 36" ABOVE THE
 - FLOOR.
 ONE OR MORE WALKING SURFACES WITHIN 36" HORIZONTALLY OF THE GLAZING.
- D. GLAZING IN RAILS

GLAZING IN ENCLOSURES FOR OR FACING HOT TUBS, WHIRLPOOLS, SAUNAS, STEAM ROOMS, BATHTUBS AND SHOWERS WHERE TO BOTTOM EDGE OF THE GLAZING IS LESS THAN 60" MEASURED VERTICALLY ABOVE ANY STANDING OR WALKING SURFACE.

F.


E.

GLAZING IN FENCES AND WALLS ADJACENT TO INDOOR AND OUTDOOR SWIMMING POOLS, HOT TUBS, AND SPAS WHERE THE BOTTOM EDGE OF THE GLAZING IS LESS THAN 60" ABOVE A WALKING SURFACE AND WITHIN 60" MEASURED HORIZONTALLY MEASURED IN A STRAIGHT LINE OF THE WATERS EDGE.

- G.
- GLAZING ADJACENT TO STAIRWAYS LANDINGS AND RAMPS WITHIN 36" HORIZONTALLY OF A WALKING SURFACE WHEN THE SURFACE OF THE GLAZING IS LESS THAN 60" ABOVE THE ADJACENT WALKING SURFACE
- Н.

GLAZING ADJACENT TO STAIRWAYS WITHIN 60 INCHES HORIZONTALLY OF THE BOTTOM TREAD OF A STAIRWAY IN ANY DIRECTION WHEN THE EXPOSED SURFACE OF THE GLAZING IS LESS THAN 60" ABOVE THE NOSE OF THE TREAD.

	NEWTON	1711 NEWTON	AUSTIN, TX
ALA ALA	JERI STERI STERI STOR STOR	ED AR HOVE	CRATTECT +
IDEAS, DESI THEREBY AF OF DIG:A AI DISCLOSED WITH ANY N PROJECT FC DEVELOPED	OR WHICH THEY	ANGEMENTS REMAIN THE HEREOF SHAL USED IN CO ECT OTHER T (HAVE BEEN E WRITTEN CO	REPRESENTED PROPERTY L BE COPIED, NNECTION 'HAN THE SPECIFIC PREPARED AND ONSENT OF DIG:A.
IDEAS, DESI THEREBY AR OF DIG:A AN DISCLOSED WITH ANY V PROJECT FC DEVELOPED VISUAL CON SPECIFICAT	GNS AND ARRA RE AND SHALL ND NO PART TH TO OTHERS OF WORK OR PROJ OR WHICH THE WITHOUT THI	ANGEMENTS REMAIN THE HEREOF SHAL USED IN COU ECT OTHER T HAVE BEEN WRITTEN CO HESE DRAWIN INSTITUTE CO E OF THESE R	REPRESENTED PROPERTY L BE COPIED, NNECTION HAN THE SPECIFIC PREPARED AND ONSENT OF DIG:A. IGS OR DNCLUSIVE ESTRICTIONS.
IDEAS, DESI THEREBY AF OF DIG:A AI DISCLOSED WITH ANY V PROJECT FC DEVELOPED VISUAL CON SPECIFICAT EVIDENCE C NUMBER: 1 0 0 0 0 0 0 0 0 0 0 0 0 0 0 0 0 0 0	GNS AND ARRA RE AND SHALL IN ND NO PART TH TO OTHERS OF WORK OR PROJ OR WHICH THEN OWITHOUT THIN NTACT WITH TH IONS SHALL CO DF ACCEPTANC DATE: -NOV.2023 DATE: -NOV.2023 COOG LLC TON ST XAS 78704 STRUCTU Y St, Ste 200 XAS 78702 # 18034	ANGEMENTS REMAIN THE HEREOF SHAL USED IN COU ECT OTHER T HAVE BEEN WRITTEN CO HESE DRAWIN INSTITUTE CO E OF THESE R ISSUED: -PERMIT	REPRESENTED PROPERTY L BE COPIED, NNECTION 'HAN THE SPECIFIC PREPARED AND ONSENT OF DIG:A. IGS OR DNCLUSIVE ESTRICTIONS.
DIEAS, DESI THEREBY AF OF DIG:A AI DISCLOSED WITH ANY V PROJECT FC DEVELOPED VISUAL CON SPECIFICAT EVIDENCE C NUMBER: 1 DIXIE I AUSTIN, TE ENGINEER: FORT S SAM COVEV 2120 E 7th S AUSTIN, TE TBPE FIRM DESIGNER: DIG:A Craig Hoven 414 West A AUSTIN, TE (512) 586-8 © 2023	GNS AND ARRA RE AND SHALL IN ND NO PART TH TO OTHERS OF WORK OR PROJ OR WHICH THEN OWITHOUT THIN NTACT WITH TH IONS SHALL CO DF ACCEPTANC DATE: -NOV.2023 DATE: -NOV.2023 COOG LLC TON ST XAS 78704 STRUCTU Y St, Ste 200 XAS 78702 # 18034	ANGEMENTS REMAIN THE HEREOF SHAL USED IN COU ECT OTHER T HAVE BEEN WRITTEN CO HESE DRAWIN INSTITUTE CO E OF THESE R ISSUED: -PERMIT	REPRESENTED PROPERTY L BE COPIED, NNECTION 'HAN THE SPECIFIC PREPARED AND ONSENT OF DIG:A. IGS OR DNCLUSIVE ESTRICTIONS. SET C.

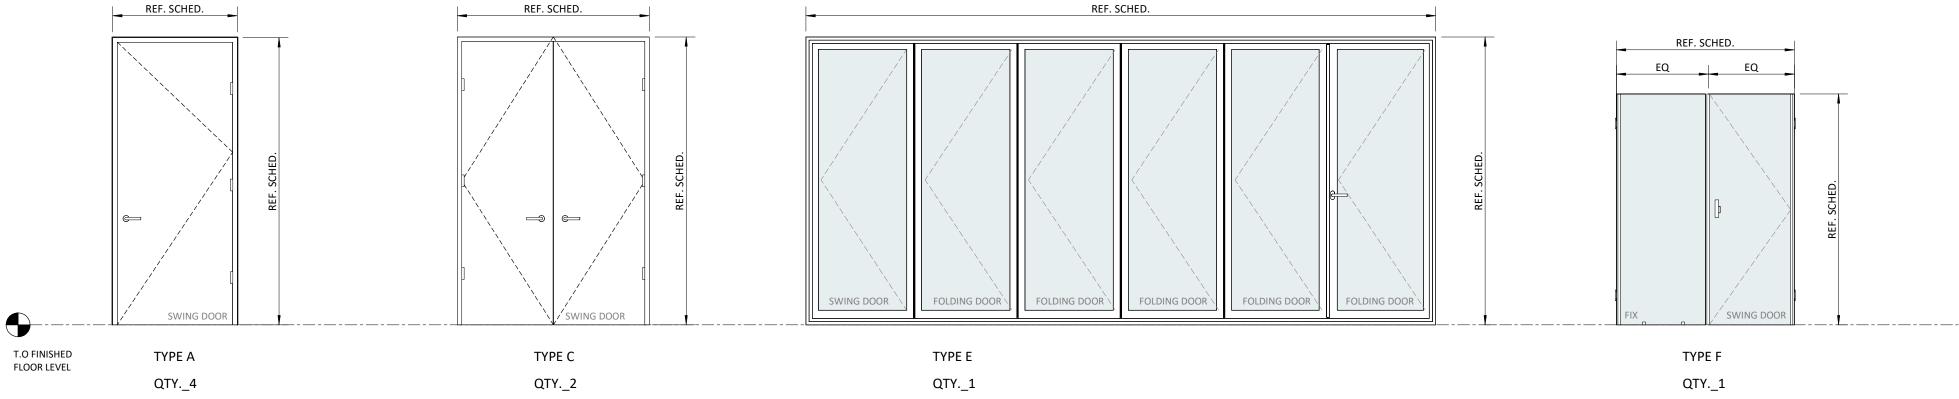

DOOR SCHEDULE													
UMBER	TYPE DOOR	WIDTH	HEIGHT	THICKNESS	DOOR MATERIAL	FRAME MATERIAL	HARDWARE SET	HINGES	DOOR STOP	HEAD DETAIL	DOOR HANDED	SILL DETAIL	NOTES
1	A	3'-6"	8'-0"	0'-1 3/4"	SINGLE HINGED DOOR SOLID CORE WOOD	WOOD	BY OWNER	N/A	N/A	N/A	RIGHT HANDED	N/A	SINGLE HINGED DOOR TO MAIN ENTRANCE
2	С	2'-11 1/2"	8'-0"	0'-1 3/4"	DOUBLE HINGED DOOR SOLID CORE WOOD	WOOD	BY OWNER	N/A	N/A	N/A	DOUBLE HANDED	N/A	DOUBLE HINGED DOOR TO CLOSET
3	A	2'-10"	8'-0"	0'-1 3/4"	SINGLE HINGED DOOR SOLID CORE WOOD	WOOD	BY OWNER	N/A	N/A	N/A	RIGHT HANDED	N/A	SINGLE HINGED DOOR TO BEDROOM
4	A	2'-8"	8'-0"	0'-1 3/4"	SINGLE HINGED DOOR SOLID CORE WOOD	WOOD	BY OWNER	N/A	N/A	N/A	LEFT HANDED	N/A	SINGLE HINGED DOOR TO BATHROOM
5	A	2'-10"	8'-0"	0'-1 3/4"	SINGLE HINGED DOOR SOLID CORE WOOD	WOOD	BY OWNER	N/A	N/A	N/A	LEFT HANDED	N/A	SINGLE HINGED DOOR TO BEDROOM
6	С	2'-11 1/2"	8'-0"	0'-1 3/4"	DOUBLE HINGED DOOR SOLID CORE WOOD	WOOD	BY OWNER	N/A	N/A	N/A	DOUBLE HANDED	N/A	DOUBLE HINGED DOOR TO CLOSET
7	0	17'-6"	8'-0"	0'-0 1/2"	(6 PANELS) FOLDING GLASS DOOR, LEFT OPENING	ANODIZED BLACK	BY OWNER	N/A	N/A	N/A	RIGHT HANDED	N/A	FOLDING DOOR
8	F	5'-0"	6'-5"	0'-0 1/2"	TEMPERED GLASS SHOWER DOOR	-	BY OWNER	N/A	N/A	N/A	LEFT HANDED	N/A	TEMPERED GLASS SHOWER DOOR - SITE MEASURE

NOTES DOOR SCHEDULE

NOTES: REFER TO FLOOR PLANS FOR DIRECTION OF DOOR SWING- TYPICAL

ALL ACCESSIBLE DOORS TO BE 32" MIN WIDTH

DOORS BETWEEN GARAGE AND DWELLING UNIT SHALL BE SELF CLOSING AND SELF LATCHING, SOLID WOOD OR SOLID HONEYCOMB CORE STEEL NOT LESS THAN 1 3/8" THICK OR HAVE A MINIMUM FIRE PROTECTION RATING OF 20 MINUTES.

FENESTRATIONS MUST HAVE TEMPORARY AND PERMANENT LABELS

GLAZING IN THE FOLLOWING LOCATIONS SHALL BE SAFETY GLAZING CONFORMING TO THE HUMAN IMPACT LOADS OF SECTION R308.3 (SEE EXCEPTIONS) (R308.4):

A. FIXED AND OPERABLE PANELS OF SWINGING SLIDING AN BIFOLD DOOR ASSEMBLIES FIXED AND OPERABLE PANELS OF SWINGING SLIDING AN BIFOLD DOOR ASSEMBLIES

B. GLAZING IN AN INDIVIDUAL FIXED OR OPERABLE PANEL ADJACENT TO A DOOR WHERE THE NEAREST VERTICAL EDGE IS WITHIN A 24" ARC OF THE DOOR IN A CLOSED POSITION AND WHOSE BOTTOM EDGE IS LESS THAN 60" ABOVE THE FLOOR OR WALKING SURFACE. GLAZING IN AN INDIVIDUAL FIXED OR OPERABLE PANEL ADJACENT TO A DOOR WHERE THE NEAREST VERTICAL EDGE IS WITHIN A 24" ARC OF THE DOOR IN A CLOSED POSITION AND WHOSE BOTTOM EDGE IS LESS THAN 60" ABOVE THE FLOOR OR WALKING SURFACE. THE NEAREST VERTICAL EDGE IS WITHIN A 24" ARC OF THE DOOR IN A CLOSED POSITION AND WHOSE BOTTOM EDGE IS LESS THAN 60" ABOVE THE FLOOR OR WALKING SURFACE.

C. GLAZING IN AN INDIVIDUAL FIXED OR OPERABLE PANEL THAT MEETS ALL OF THE FOLLOWING CONDITIONS:

GLAZING IN AN INDIVIDUAL FIXED OR OPERABLE PANEL THAT MEETS ALL OF THE FOLLOWING CONDITIONS:

1.1. EXPOSED AREA OF AN INDIVIDUAL PANE GREATER THAN 9 SQUARE FEET. EXPOSED AREA OF AN INDIVIDUAL PANE GREATER THAN 9 SQUARE FEET.

1.2. BOTTOM EDGE LESS THAT 18" ABOVE FLOOR. BOTTOM EDGE LESS THAT 18" ABOVE FLOOR.

1.3. TOP EDGE GREATER THAN 36" ABOVE THE FLOOR. TOP EDGE GREATER THAN 36" ABOVE THE FLOOR.

1.4. ONE OR MORE WALKING SURFACES WITHIN 36" HORIZONTALLY OF THE GLAZING. ONE OR MORE WALKING SURFACES WITHIN 36" HORIZONTALLY OF THE GLAZING.


D. GLAZING IN RAILS GLAZING IN RAILS

E. GLAZING IN ENCLOSURES FOR OR FACING HOT TUBS, WHIRLPOOLS, SAUNAS, STEAM ROOMS, BATHTUBS AND SHOWERS WHERE TO BOTTOM EDGE OF THE GLAZING IS LESS THAN 60" MEASURED VERTICALLY ABOVE ANY STANDING OR WALKING SURFACE. GLAZING IN ENCLOSURES FOR OR FACING HOT TUBS, WHIRLPOOLS, SAUNAS, STEAM ROOMS, BATHTUBS AND SHOWERS WHERE TO BOTTOM EDGE OF THE GLAZING IS LESS THAN 60" MEASURED VERTICALLY ABOVE ANY STANDING OR WALKING SURFACE.

F. GLAZING IN FENCES AND WALLS ADJACENT TO INDOOR AND OUTDOOR SWIMMING POOLS, HOT TUBS, AND SPAS WHERE THE BOTTOM EDGE OF THE GLAZING IS LESS THAN 60" ABOVE A WALKING SURFACE AND WITHIN 60" MEASURED HORIZONTALLY MEASURED IN A STRAIGHT LINE OF THE WATERS EDGE. GLAZING IN FENCES AND WALLS ADJACENT TO INDOOR AND OUTDOOR SWIMMING POOLS, HOT TUBS, AND SPAS WHERE THE BOTTOM EDGE OF THE GLAZING IS LESS THAN 60" ABOVE A WALKING SURFACE AND WITHIN 60" MEASURED HORIZONTALLY MEASURED IN A STRAIGHT LINE OF THE WATERS EDGE.

G. GLAZING ADJACENT TO STAIRWAYS LANDINGS AND RAMPS WITHIN 36" HORIZONTALLY OF A WALKING SURFACE WHEN THE SURFACE OF THE GLAZING IS LESS THAN 60" ABOVE THE ADJACENT WALKING SURFACE. GLAZING ADJACENT TO STAIRWAYS LANDINGS AND RAMPS WITHIN 36" HORIZONTALLY OF A WALKING SURFACE WHEN THE SURFACE OF THE GLAZING IS LESS THAN 60" ABOVE THE ADJACENT WALKING SURFACE.

H. GLAZING ADJACENT TO STAIRWAYS WITHIN 60 INCHES HORIZONTALLY OF THE BOTTOM TREAD OF A STAIRWAY IN ANY DIRECTION WHEN THE EXPOSED SURFACE OF THE GLAZING IS LESS THAN 60" ABOVE THE NOSE OF THE TREAD.GLAZING ADJACENT TO STAIRWAYS WITHIN 60 INCHES HORIZONTALLY OF THE BOTTOM TREAD OF A STAIRWAY IN ANY DIRECTION WHEN THE EXPOSED SURFACE OF THE GLAZING IS LESS THAN 60" ABOVE THE NOSE OF THE TREAD.

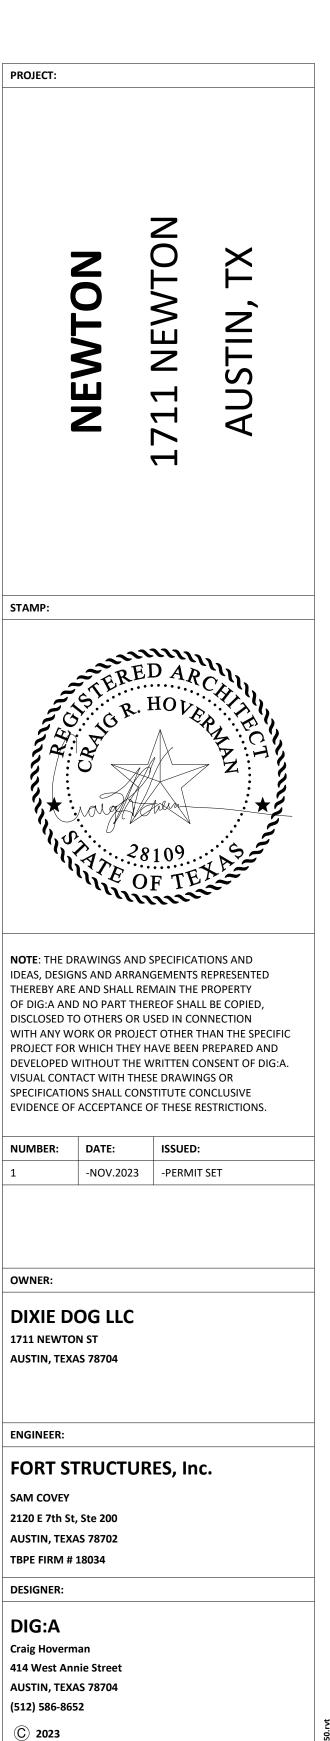

ALL RIGHTS RESERVED

JOB No:	1064	START DATE:
DRAWN BY:	CH/AV/MS	TOTAL SHEET SETS:

DRAWING: DOORS SCHEDULES BLDG 02

PH A7.1